
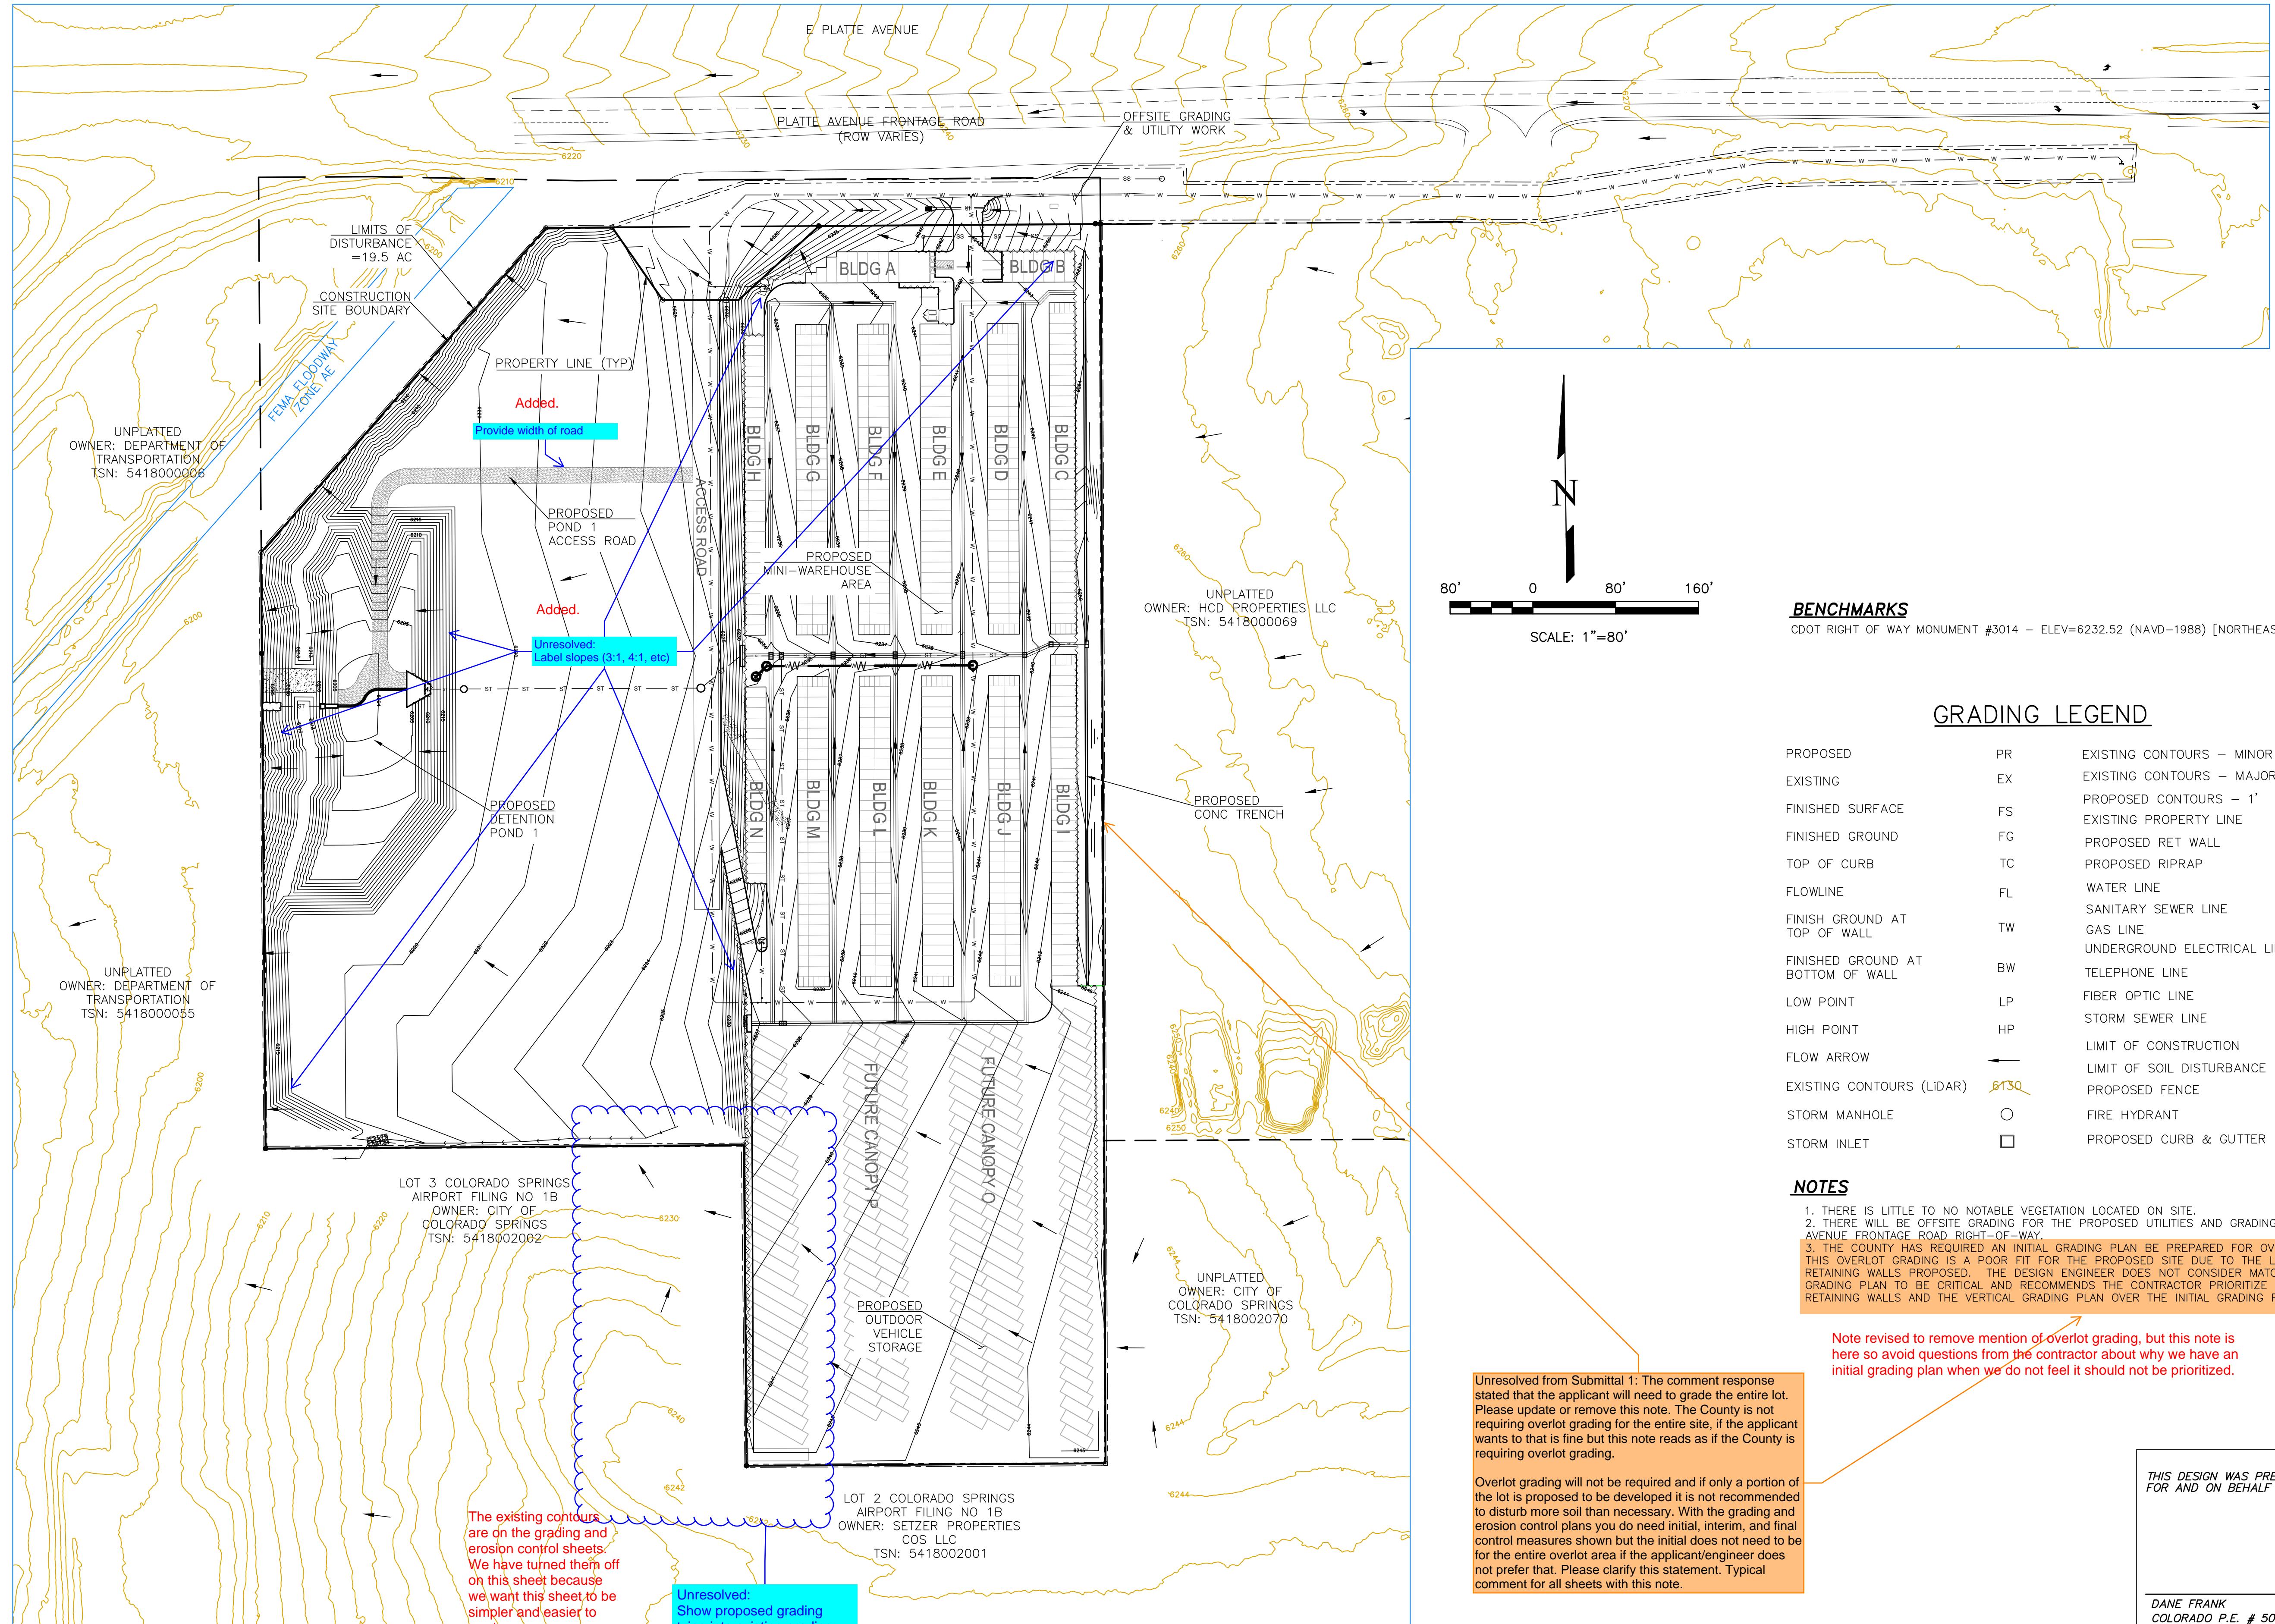


# PLATTE SELF STORAGE

## GRADING AND EROSION CONTROL PLAN

### OVERVIEW SHEET

AUGUST 2024

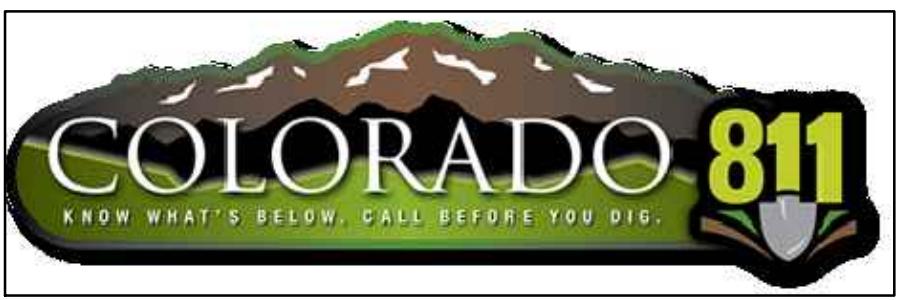




# PLATTE SELF STORAGE GRADING AND EROSION CONTROL PLAN INITIAL GRADING & EROSION CONTROL - NORTH SIDE AUGUST 2024

## BENCHMARKS

CDOT RIGHT OF WAY MONUMENT #3014 – ELEV=6232.52 (NAVD-1988) [NORTHEAST OF SITE ENTRANCE]

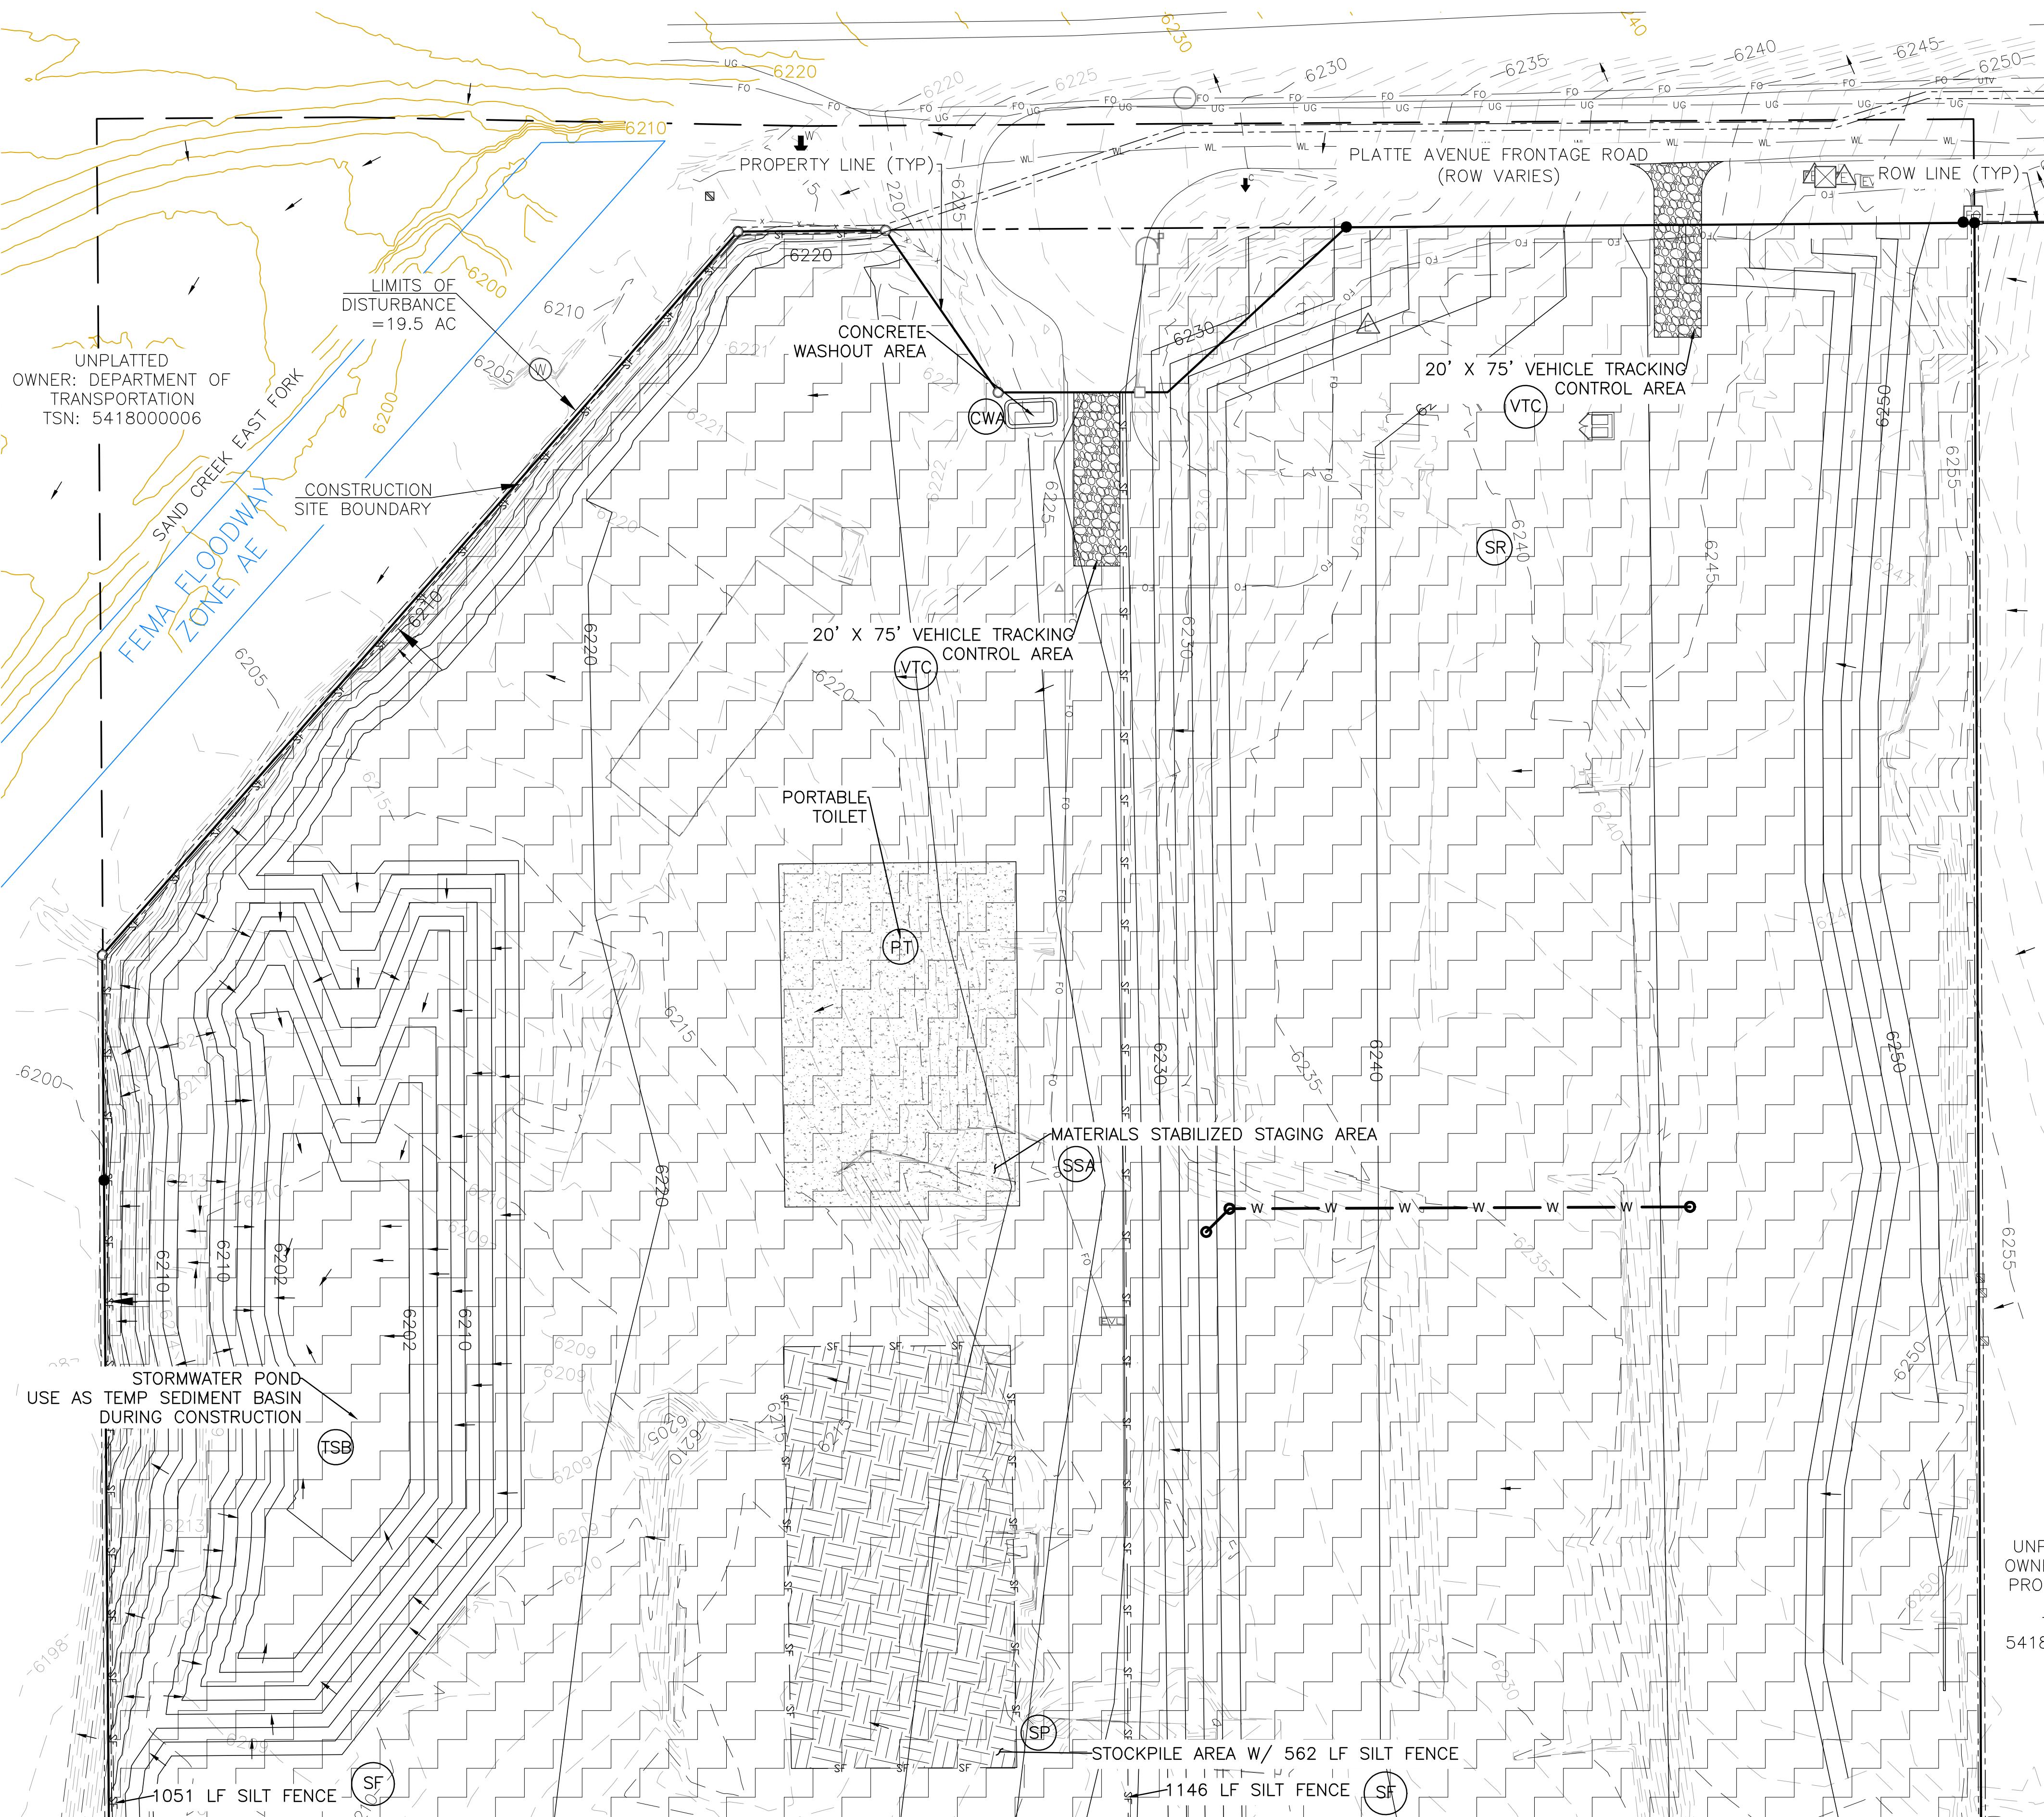

## GRADING LEGEND

PR	EXISTING CONTOURS – MINOR	— 6231 —
EX	EXISTING CONTOURS – MAJOR	— 6230 —
FS	PROPOSED CONTOURS – 1'	6231
FG	EXISTING PROPERTY LINE	~~~~~
TC	PROPOSED RET WALL	██████████
FL	PROPOSED RIPRAP	~~~~~
WL	WATER LINE	— v —
UG	SANITARY SEWER LINE	— ss —
UE	GAS LINE	— ug —
UE	UNDERGROUND ELECTRICAL LINE	— ue —
UT	TELEPHONE LINE	— ue —
FD	FIBER OPTIC LINE	— fd —
LP	STORM SEWER LINE	— st —
HP	LIMIT OF CONSTRUCTION	— st —
LSQ	LIMIT OF SOIL DISTURBANCE	— st —
SR	PROPOSED FENCE	— o —
SM	STORM MANHOLE	○
SI	STORM INLET	□
PT	PROPOSED CURB & GUTTER	— ss —

## NOTES


1. THERE IS LITTLE TO NO NOTABLE EXISTING VEGETATION LOCATED ON SITE.
2. THERE WILL BE OFFSITE GRADING FOR THE PROPOSED UTILITIES AND GRADING WITHIN THE PLATTE AVENUE FRONTAGE ROAD RIGHT-OF-WAY.
3. THE COUNTY HAS REQUIRED AN INITIAL GRADING PLAN BE PREPARED FOR OVERLOT GRADING ONLY. THIS OVERLOT GRADING IS A POOR FIT FOR THE PROPOSED SITE DUE TO THE LARGE NUMBER OF TALL RETAINING WALLS PROPOSED. THE DESIGN ENGINEER DOES NOT CONSIDER MATCHING THE INITIAL GRADING PLAN TO BE CRITICAL AND RECOMMENDS THE CONTRACTOR PRIORITIZE CONSTRUCTION OF THE RETAINING WALLS AND THE VERTICAL GRADING PLAN OVER THE INITIAL GRADING PLAN.
4. SEED AND MULCH DISTURBED AREAS ONLY.
5. SEDIMENT CONTROL LOGS MAY BE SUBSTITUTED FOR SILT FENCE AND VICE VERSA.

## EROSION CONTROL LEGEND

KEY	TITLE	SYMBOL	IMPLEMENTATION PHASE
SF	SILT FENCE	— SF —	INITIAL
SSA	STABILIZED STAGING AREA	[ ]	INITIAL
VTC	VEHICLE TRACKING CONTROL	[ ]	INITIAL
SP	STOCKPILE MANAGEMENT WITH PROTECTION	[ ]	INITIAL
CWA	CONCRETE WASHOUT AREA	[ ]	INITIAL
SR	SURFACE ROUGHENING	[ ]	INITIAL
TBB	TEMPORARY SEDIMENT BASIN	NONE	INITIAL
PT	PORTABLE TOILET	NONE	INITIAL

Please include full limits of construction within the view, it appears to extend further to the east.

NO GRADING IS BEING DONE IN THIS AREA THAT ISN'T SHOWN ON THE DETAIL SHEETS. THIS AREA IS SHOWN ON THE OVERVIEW PLAN, BUT IS NOT SHOWN ON THESE DETAIL SHEETS BECAUSE IT IS ONLY UTILITY WORK.

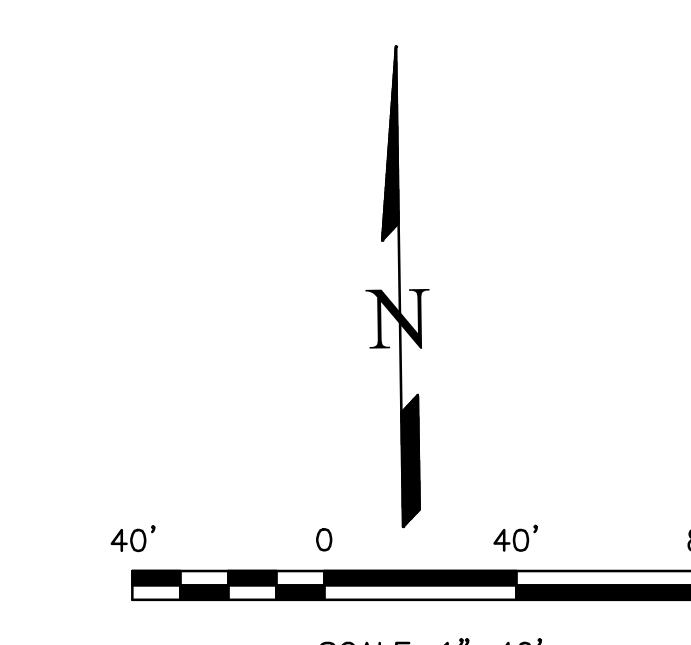


THIS DESIGN WAS PREPARED UNDER MY DIRECT SUPERVISION FOR AND ON BEHALF OF TERRA NOVA ENGINEERING, INC.

DANE FRANK  
COLORADO P.E. # 50207

PREPARED FOR:	RMG-ROCKY MOUNTAIN GROUP
ATTN:	5085 LIST DR, #200
	COLORADO SPRINGS, CO 80919
	719.548.0600
REVISIONS	UNTIL SUCH TIME AS THESE DRAWINGS ARE APPROVED BY THE APPROPRIATE REVIEWING AGENCIES, INC. APPROVES THEIR USE ONLY FOR THE PURPOSES DESIGNATED BY WRITTEN AUTHORIZATION.
DESIGNED BY JF	
DRAWN BY JF	
CHECKED BY DF	
H-SCALE AS SHOWN	
V-SCALE N/A	
JOB NO. 2419.00	
DATE ISSUED 08/14/24	
SHEET NO. 8 OF 25	

**PLATTE SELF STORAGE**  
**GRADING AND EROSION CONTROL PLAN**  
**INTERIM EC PLAN - NORTH SIDE**  
AUGUST 2024

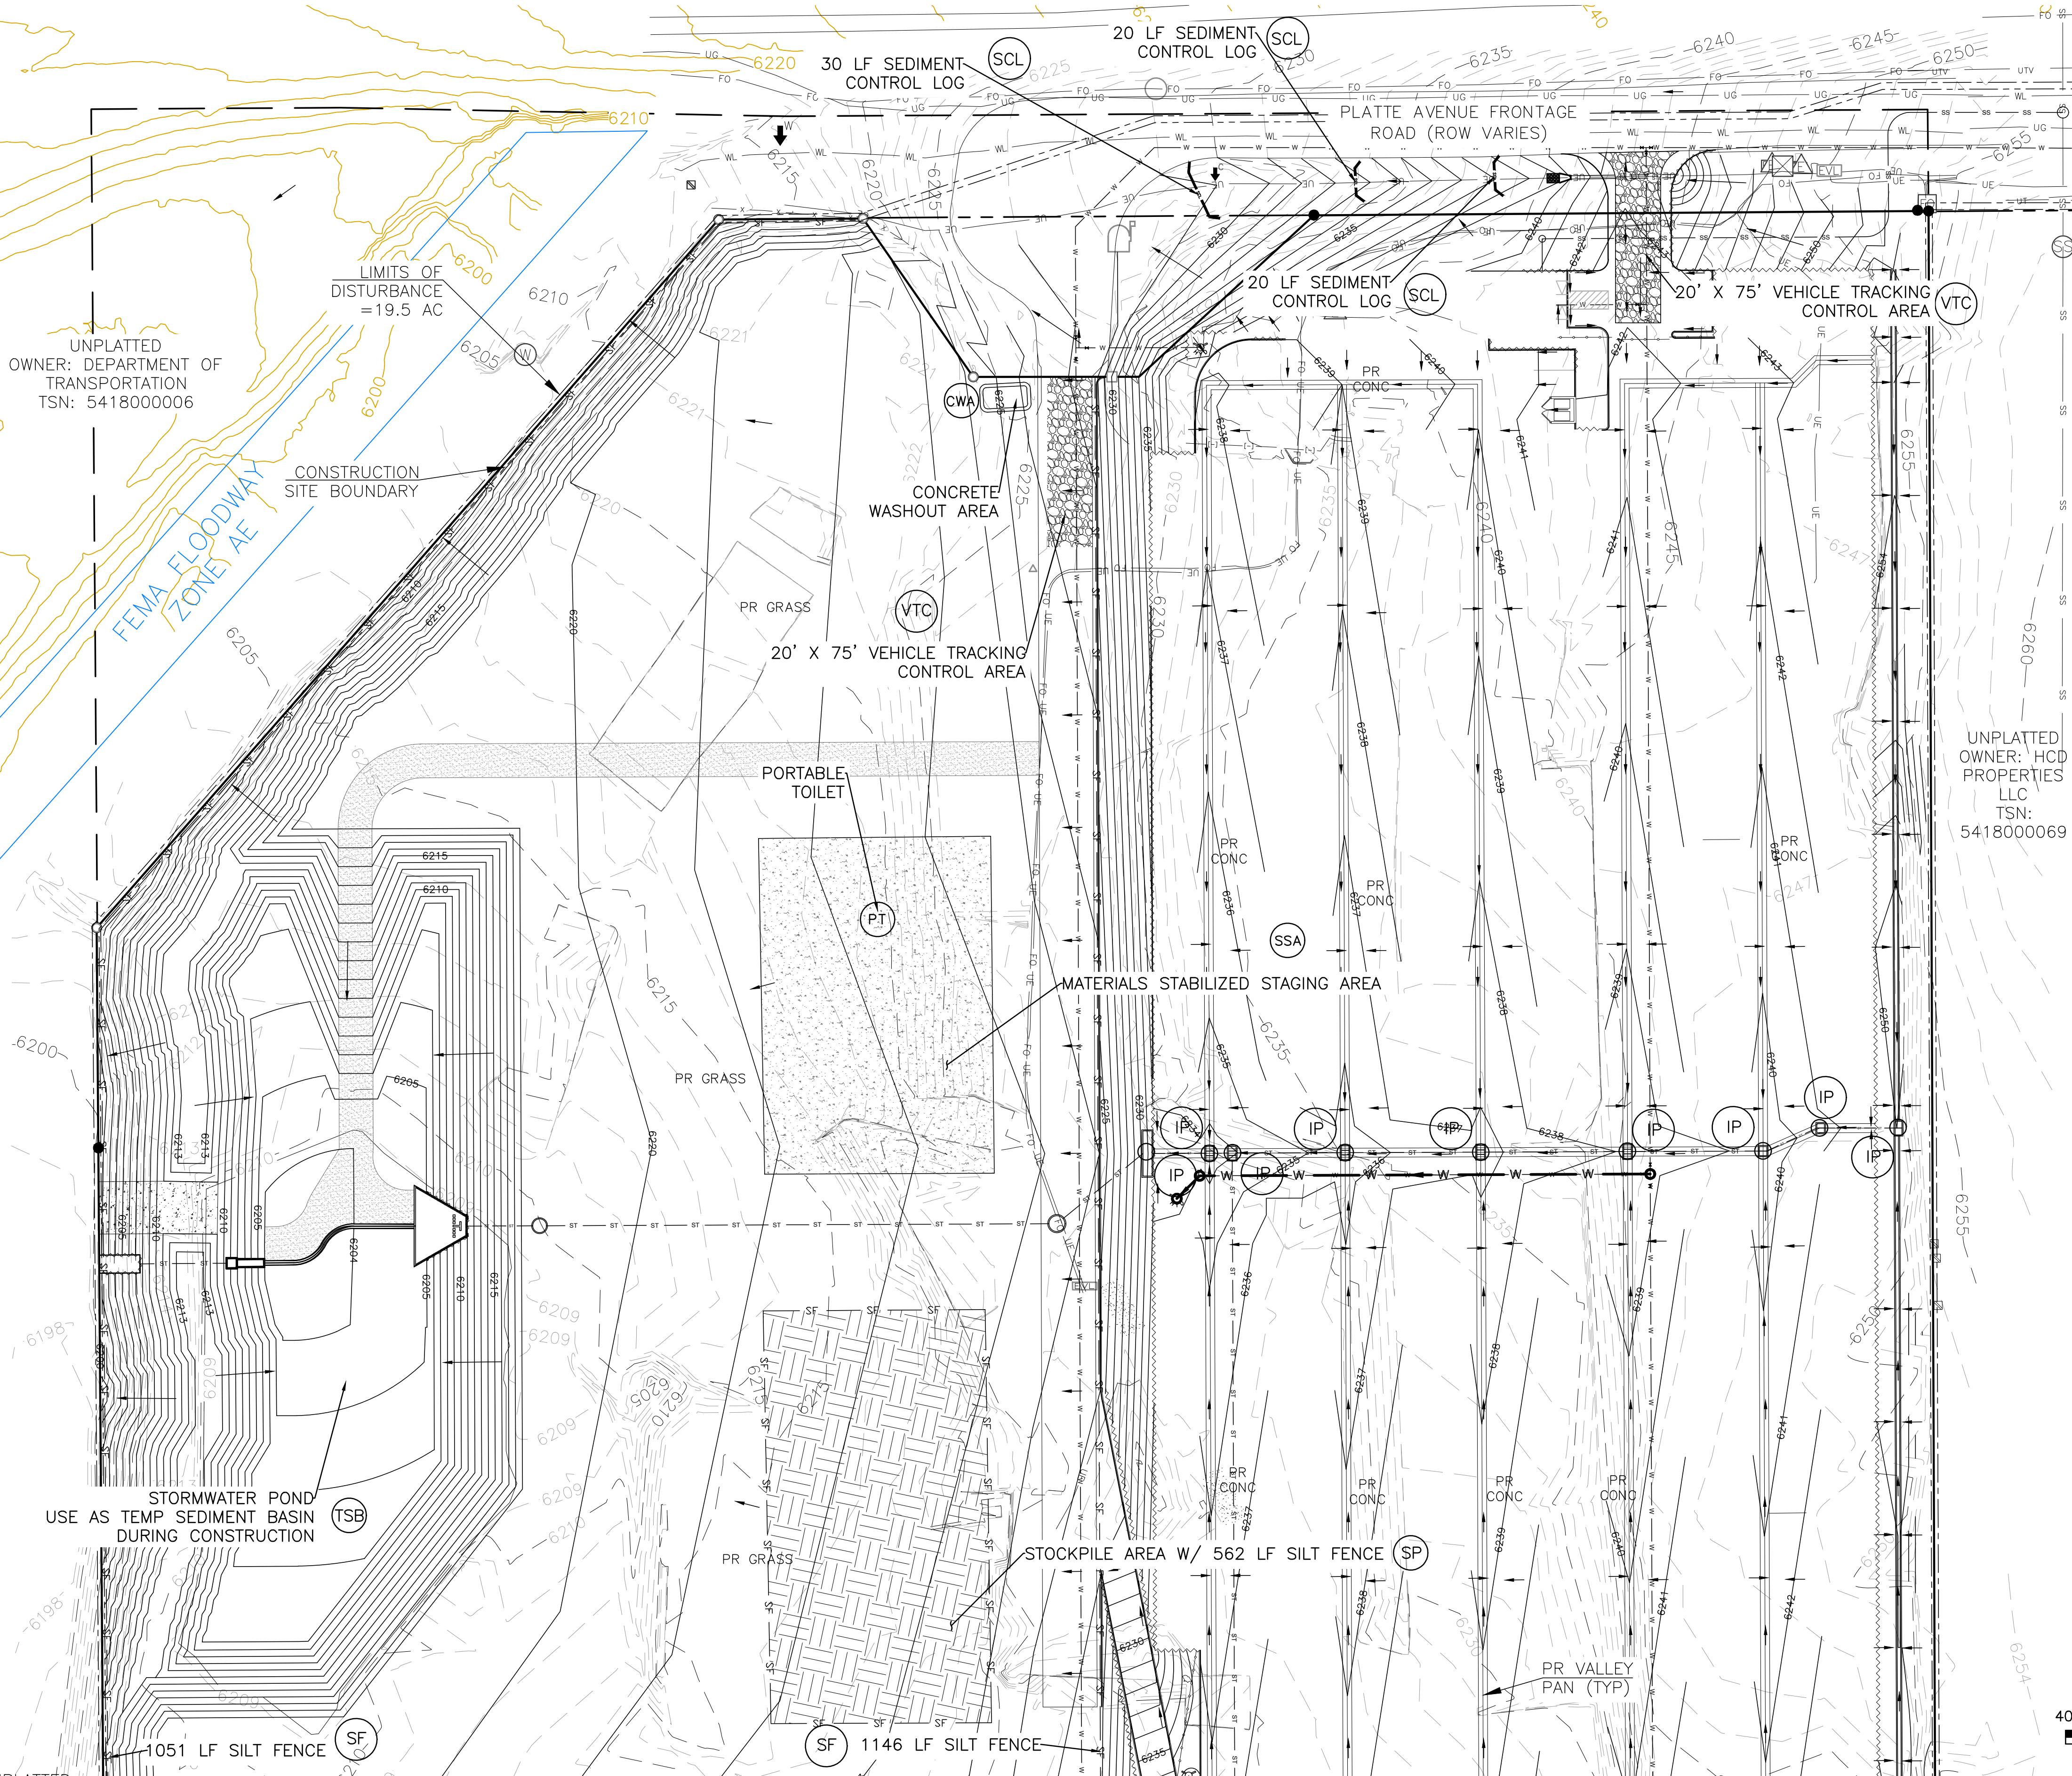

**GRADING LEGEND**

PR	EXISTING CONTOURS – MINOR	— 6231 —
EX	EXISTING CONTOURS – MAJOR	— 6230 —
FS	PROPOSED CONTOURS – 1'	— 6231 —
FG	EXISTING PROPERTY LINE	~~~~~
TC	PROPOSED RET WALL	—
FL	PROPOSED RIPRAP	—
WL	WATER LINE	— v —
SS	SANITARY SEWER LINE	— ss —
UG	GAS LINE	— ug —
UE	UNDERGROUND ELECTRICAL LINE	— ue —
UT	TELEPHONE LINE	— ut —
LP	FIBER OPTIC LINE	— st —
HP	STORM SEWER LINE	—
FC	LIMIT OF CONSTRUCTION	← —
LS	LIMIT OF SOIL DISTURBANCE	—
PF	PROPOSED FENCE	○ —
FH	STORM MANHOLE	□ —
VTC	Fire Hydrant	x —
SCL	Proposed Curb & Gutter	—

Unresolved:  
Show cut/fill limits

**EROSION CONTROL LEGEND**


KEY	TITLE	SYMBOL	IMPLEMENTATION PHASE
SF	SILT FENCE	— SF —	INITIAL
SSA	STABILIZED STAGING AREA	[hatched rectangle]	INITIAL
VTC	VEHICLE TRACKING CONTROL	[hatched area]	INITIAL
SP	STOCKPILE MANAGEMENT WITH PROTECTION	[hatched rectangle with border]	INITIAL
CWA	CONCRETE WASHOUT AREA	[hatched irregular shape]	INITIAL
TSB	TEMPORARY SEDIMENT BASIN	None	INITIAL
PT	PORTABLE TOILET	None	INITIAL
SCL	SEDIMENT CONTROL LOG	— SCL —	INTERIM
IP	INLET PROTECTION	□	INTERIM

1. SEDIMENT CONTROL LOGS MAY BE SUBSTITUTED FOR SILT FENCE AND VICE VERSA.
2. SEED AND MULCH DISTURBED AREAS ONLY.
3. THERE IS LITTLE TO NO NOTABLE EXISTING VEGETATION LOCATED ON SITE.
4. THERE WILL BE OFFSITE GRADING FOR THE PROPOSED UTILITIES AND GRADING WITHIN THE PLATTE AVENUE FRONTAGE ROAD RIGHT-OF-WAY.

THIS DESIGN WAS PREPARED UNDER MY DIRECT SUPERVISION FOR AND ON BEHALF OF TERRA NOVA ENGINEERING, INC.

DANE FRANK  
COLORADO P.E. # 50207

SCALE: 1"=40'  
40' 0' 40' 80'

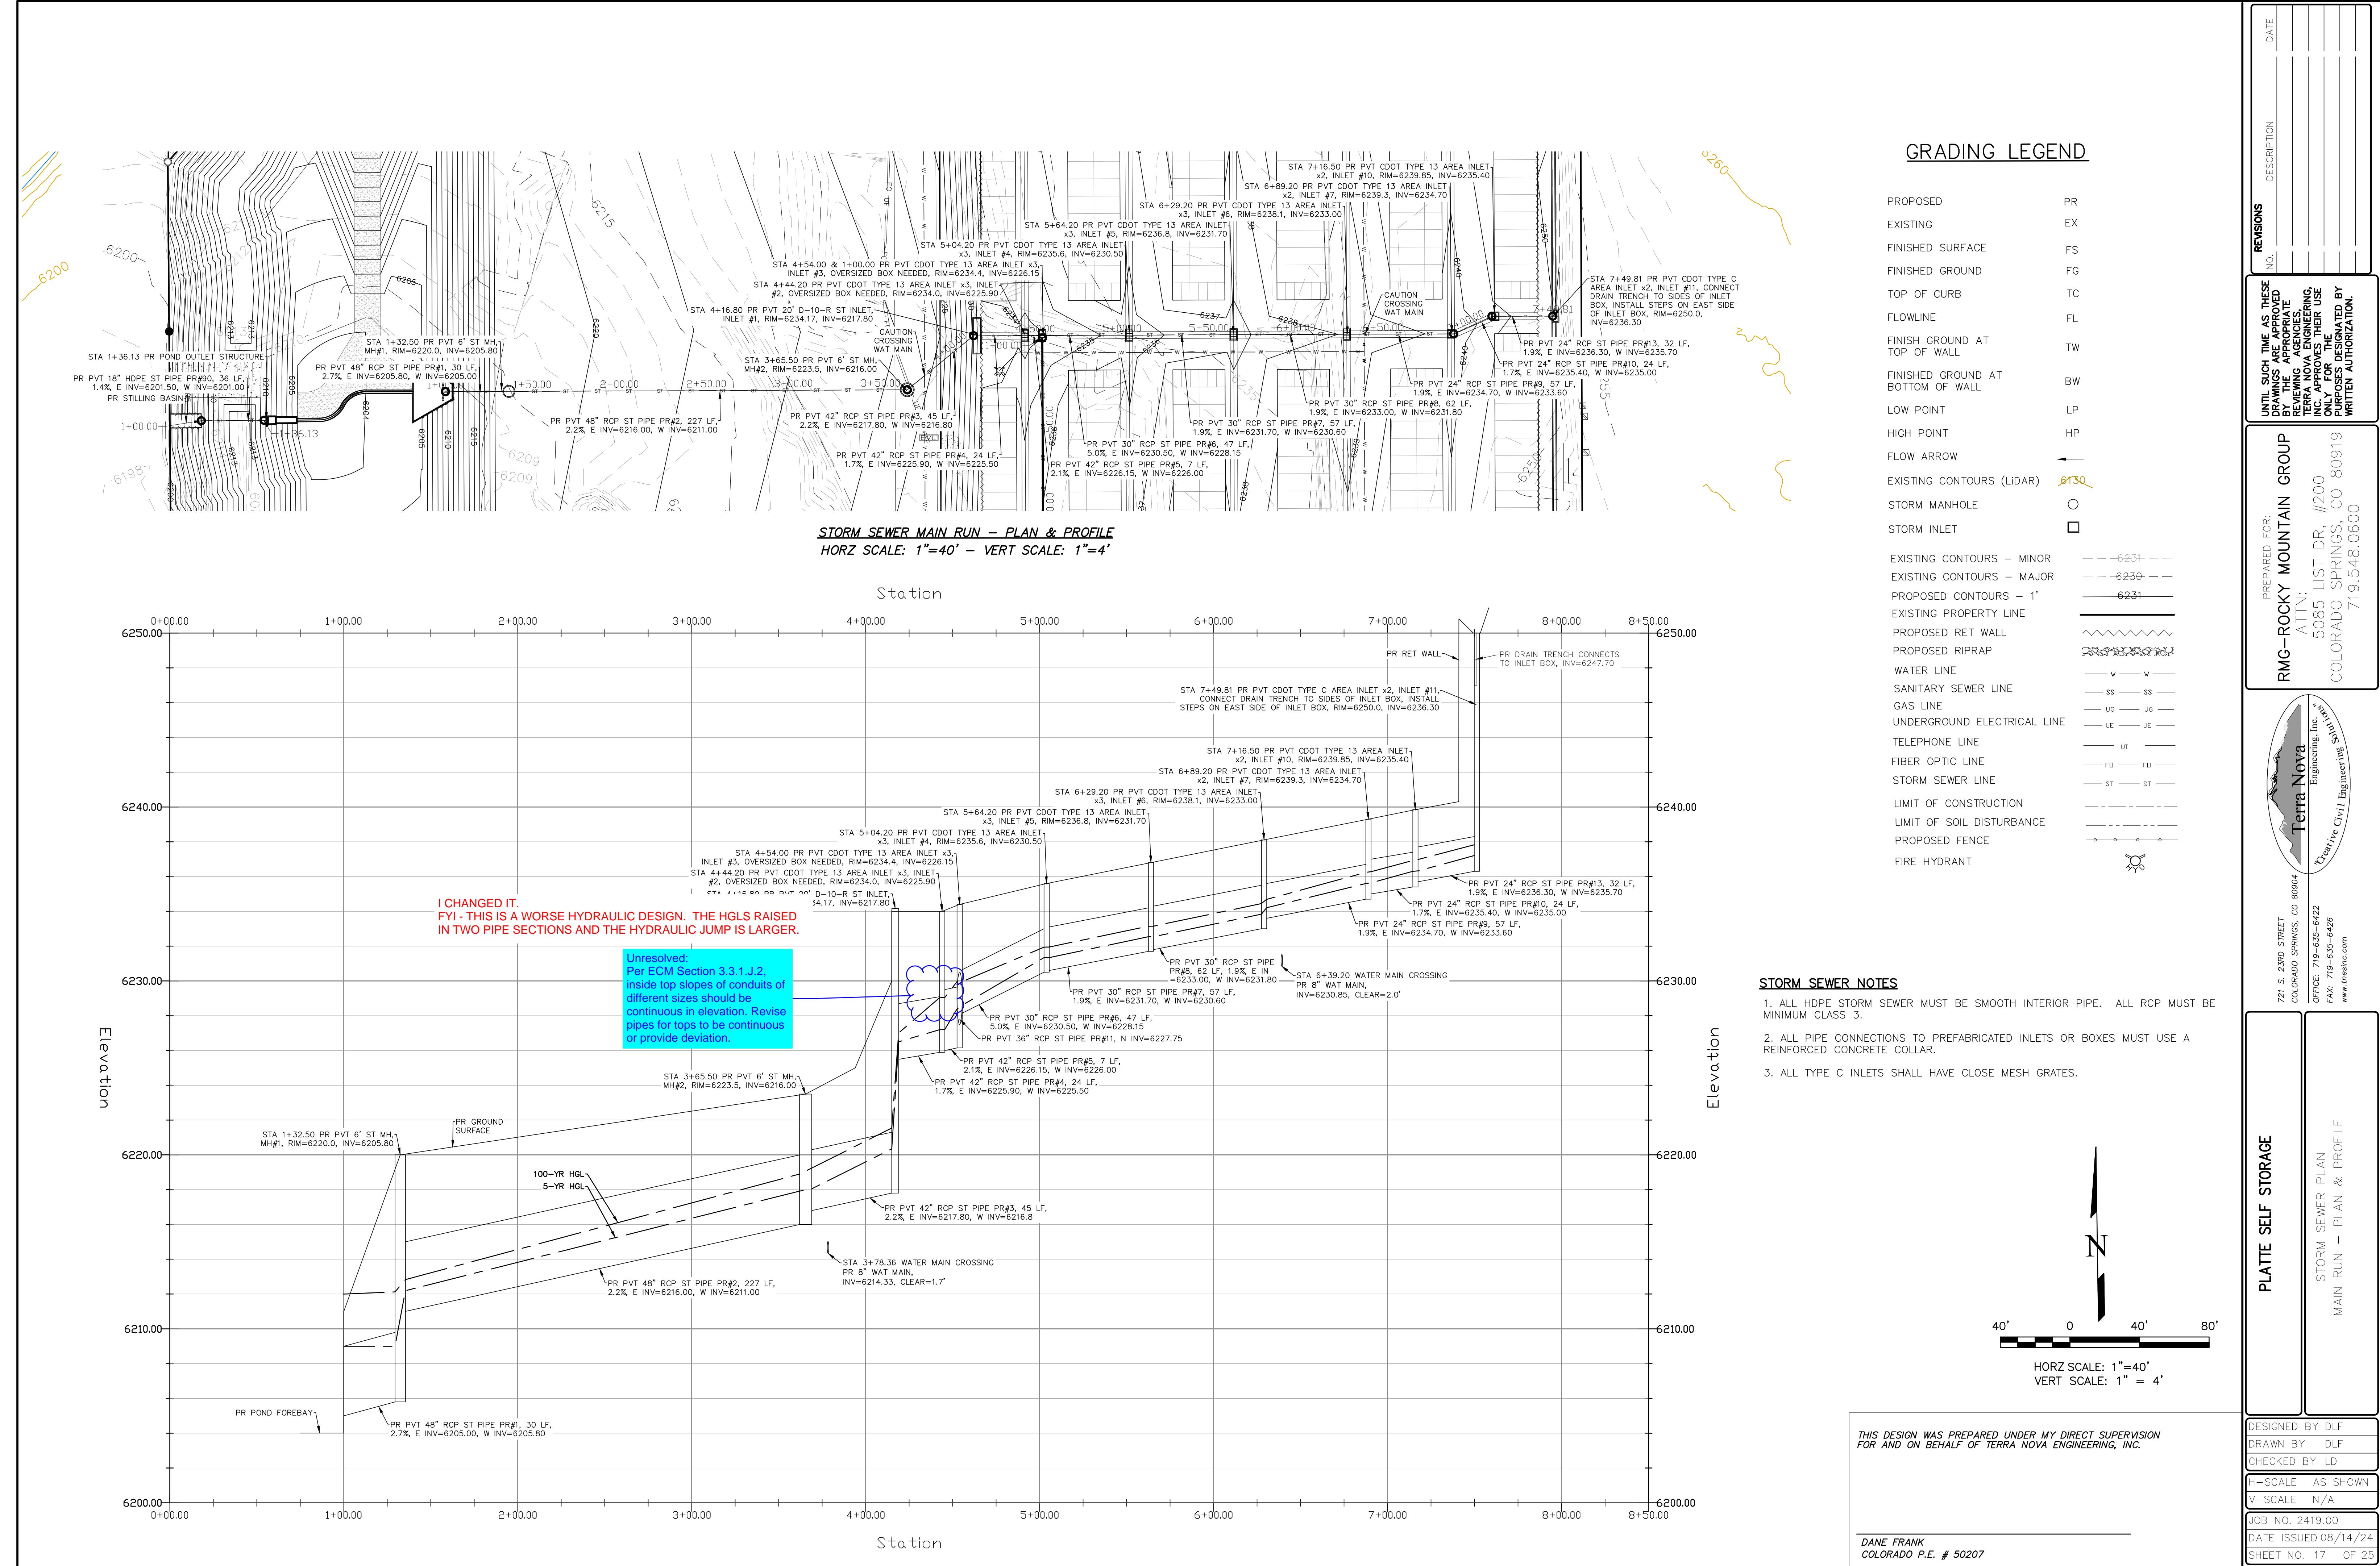

# PLATTE SELF STORAGE


## GRADING AND EROSION CONTROL PLAN

### EXTENDED DETENTION BASIN PLAN


AUGUST 2024

#### GRADING LEGEND


PROPOSED	PR	EXISTING CONTOURS - MINOR	— 6231 —
EXISTING	EX	EXISTING CONTOURS - MAJOR	— 6230 —
FINISHED SURFACE	FS	PROPOSED CONTOURS - 1'	6231
FINISHED GROUND	FG	EXISTING PROPERTY LINE	————
TOP OF CURB	TC	PROPOSED RET WALL	~~~~~
FLOWLINE	FL	WATER LINE	vv
FISH GROUND AT TOP OF WALL	TW	SANITARY SEWER LINE	ss
FISH GROUND AT BOTTOM OF WALL	BW	UNDERGROUND ELECTRICAL LINE	ug
LOW POINT	LP	TELEPHONE LINE	ue
HIGH POINT	HP	FIBER OPTIC LINE	fd
LIMIT OF CONSTRUCTION		STORM SEWER LINE	st
LIMIT OF SOIL DISTURBANCE			— - -
PROPOSED FENCE			- - -
FIRE HYDRANT			○ ○ ○

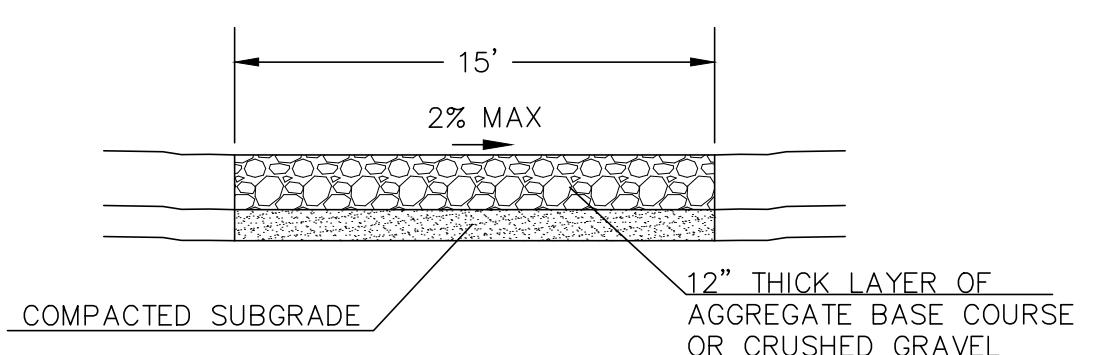


15' MAINTENANCE ACCESS ROAD SECTION  
NOT TO SCALE

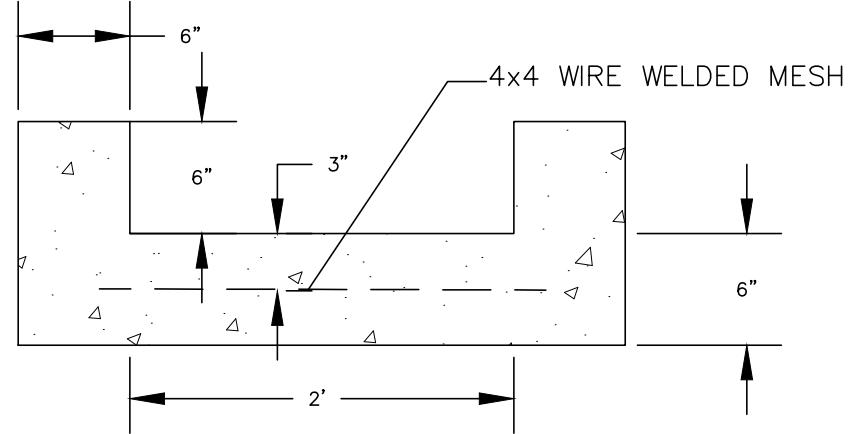



2' CONCRETE TRICKLE CHANNEL  
NOT TO SCALE

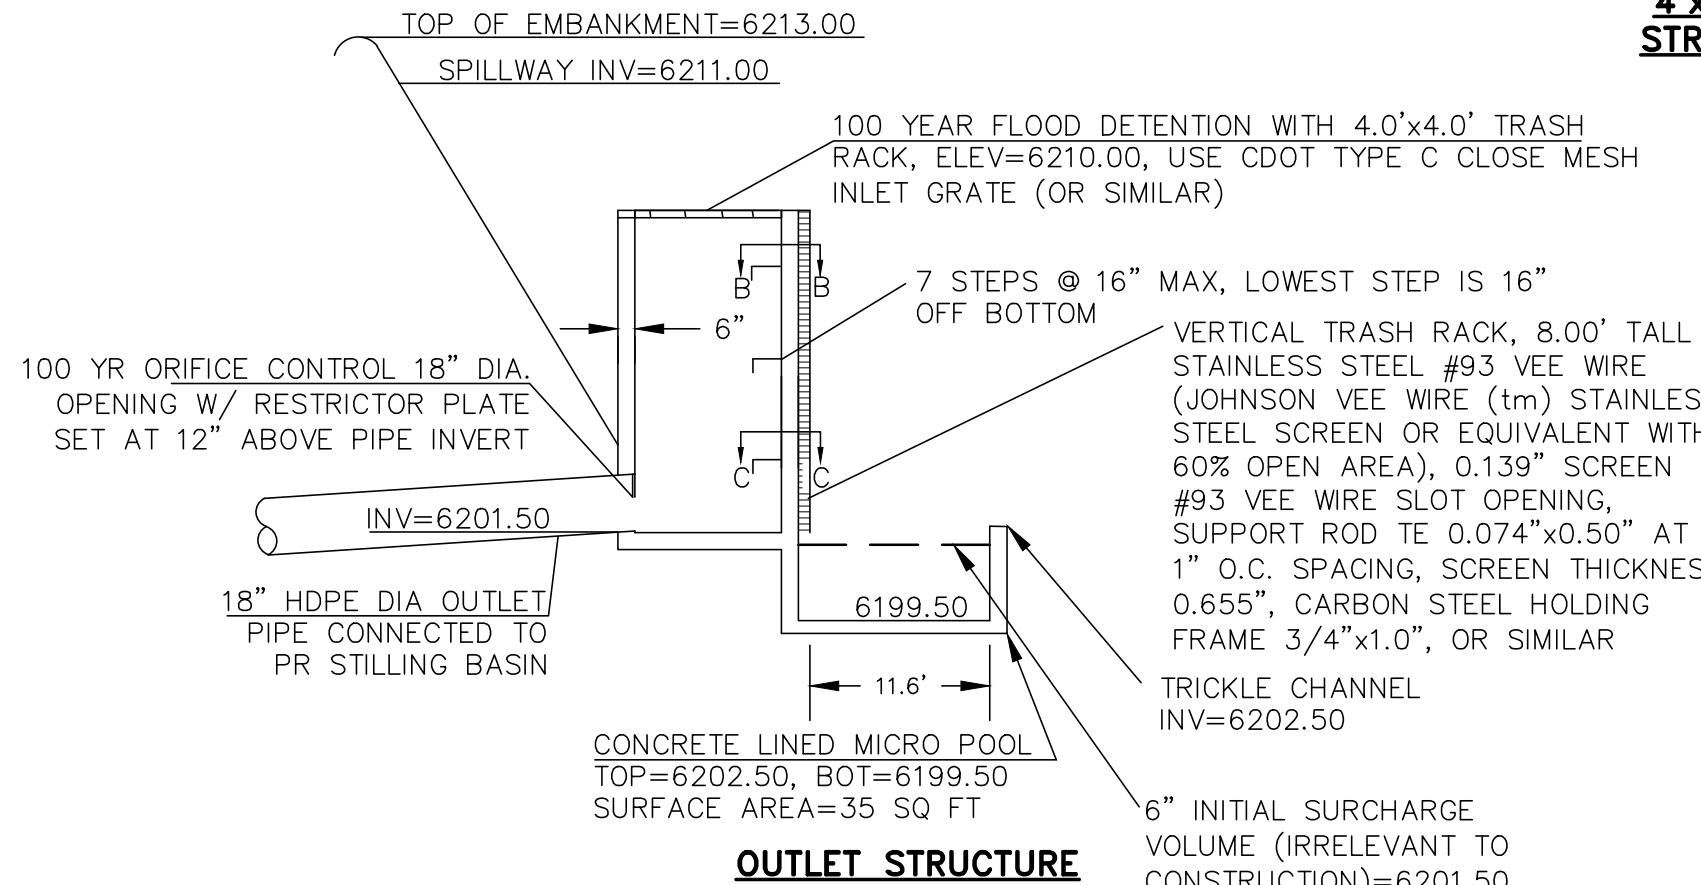

OUTLET STRUCTURE  
NOT TO SCALE

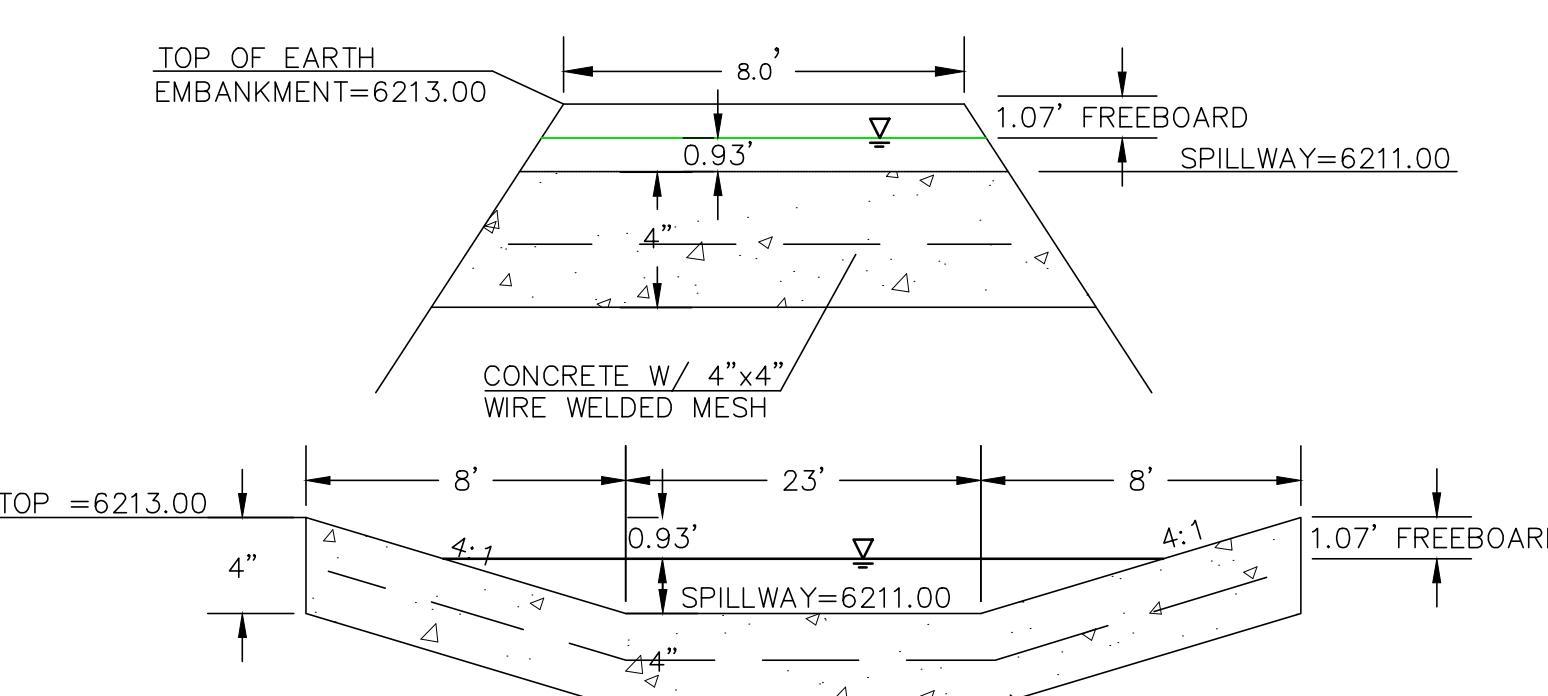


EDB EMERGENCY WEIR  
NOT TO SCALE

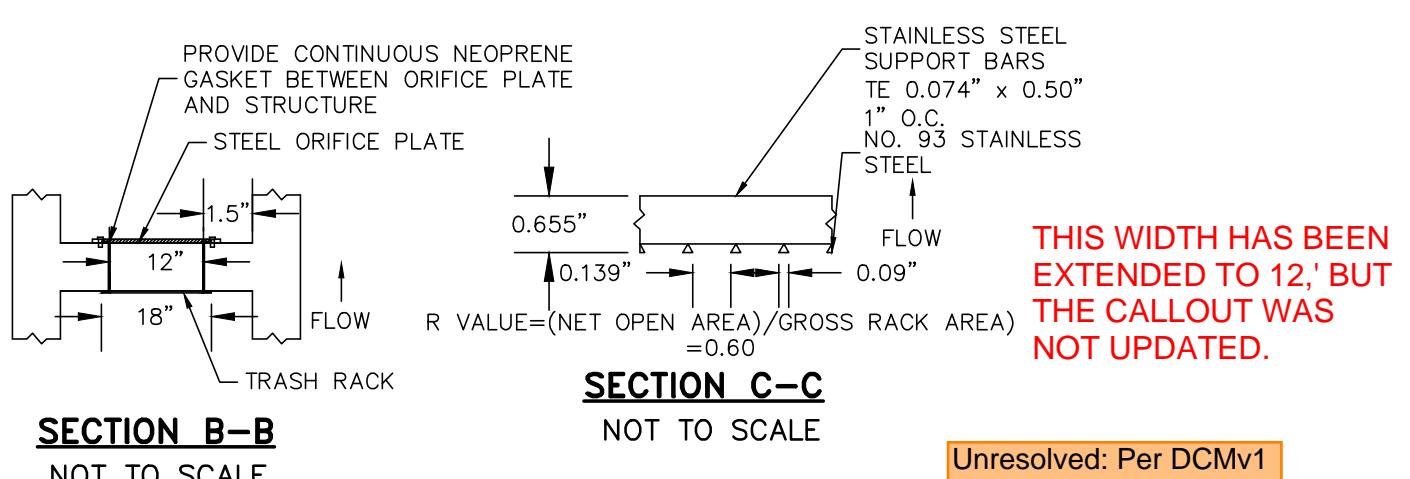
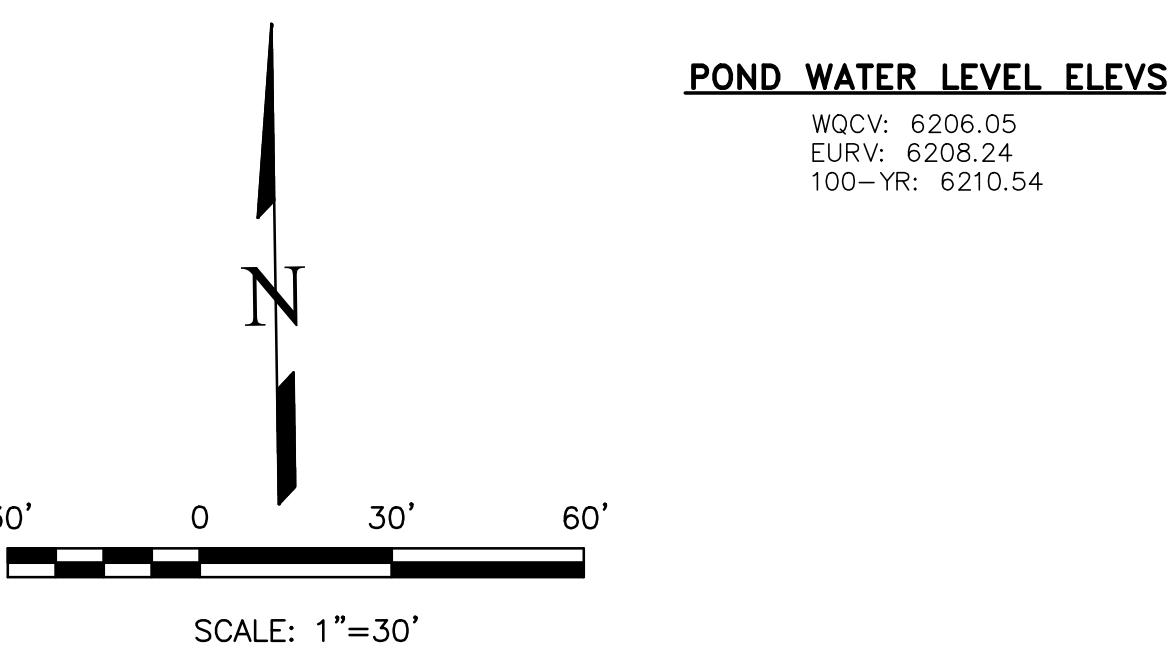


SECTION C-C  
NOT TO SCALE


THIS WIDTH HAS BEEN EXTENDED TO 12'; BUT THE CALLOUT WAS NOT UPDATED.

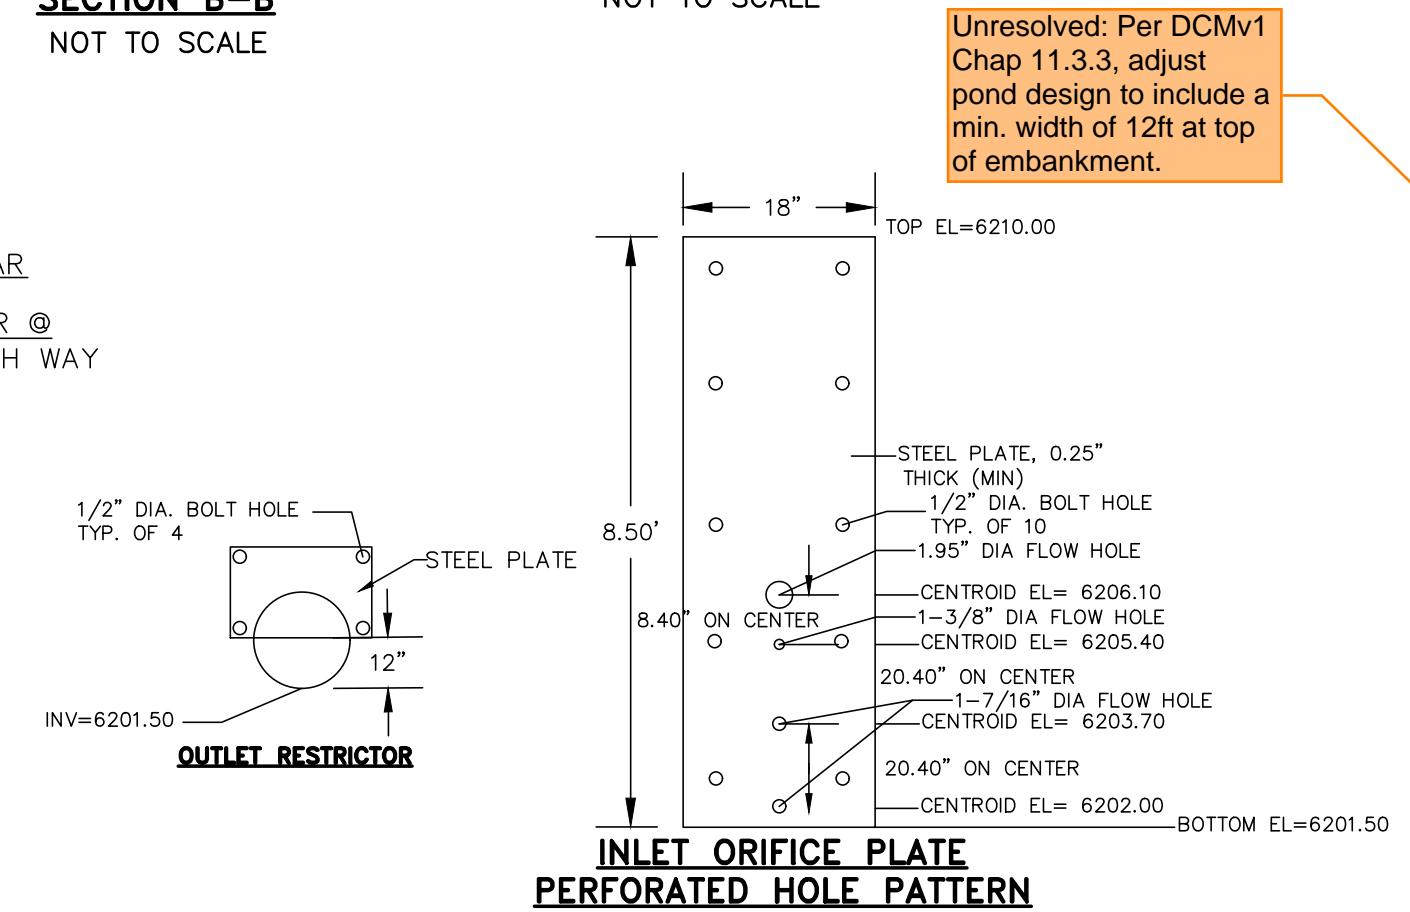

4x4' OUTLET BOX  
STRUCTURAL DETAIL  
NOT TO SCALE

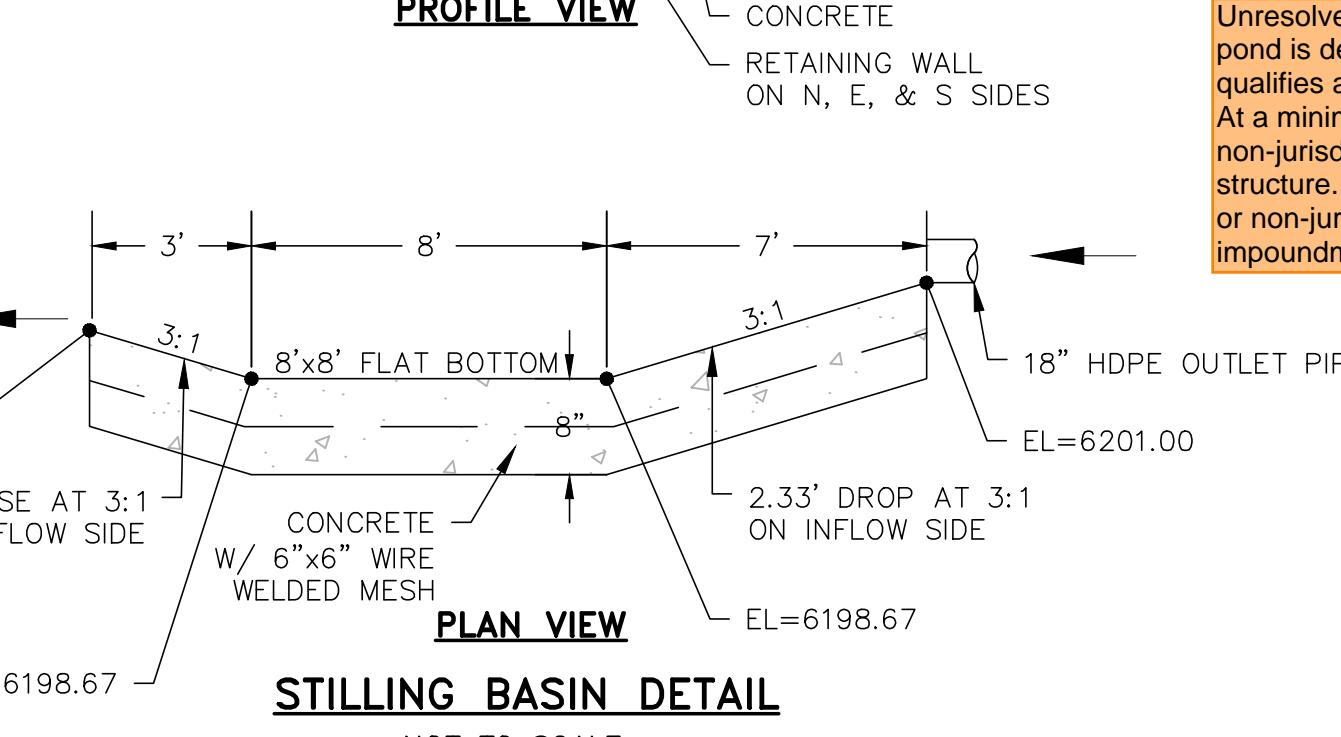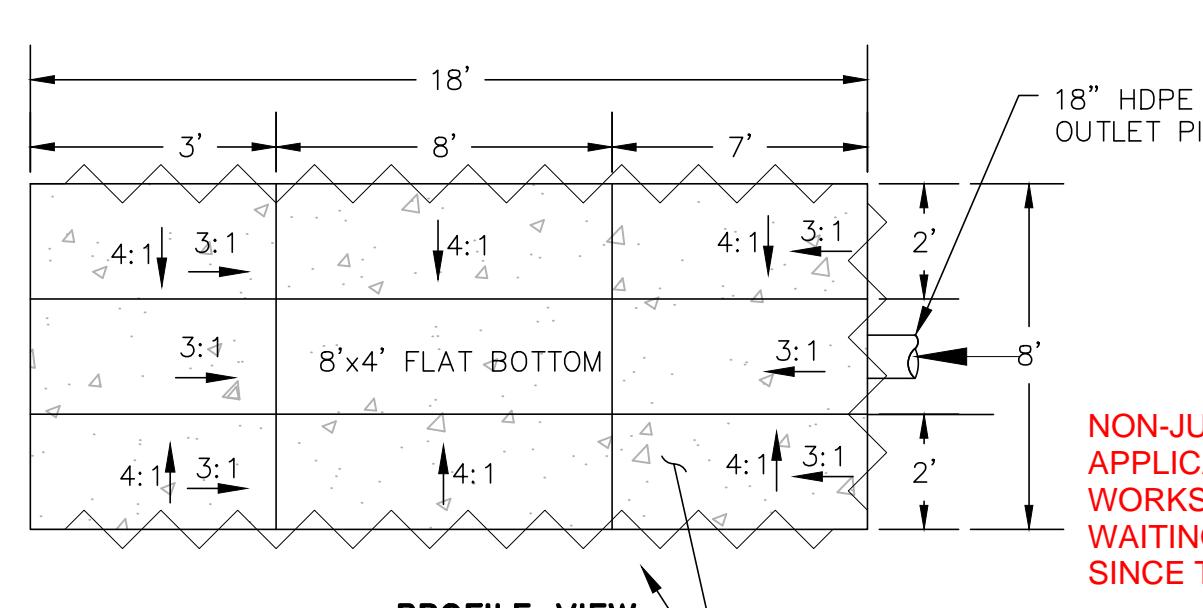

STILLING BASIN DETAIL  
NOT TO SCALE

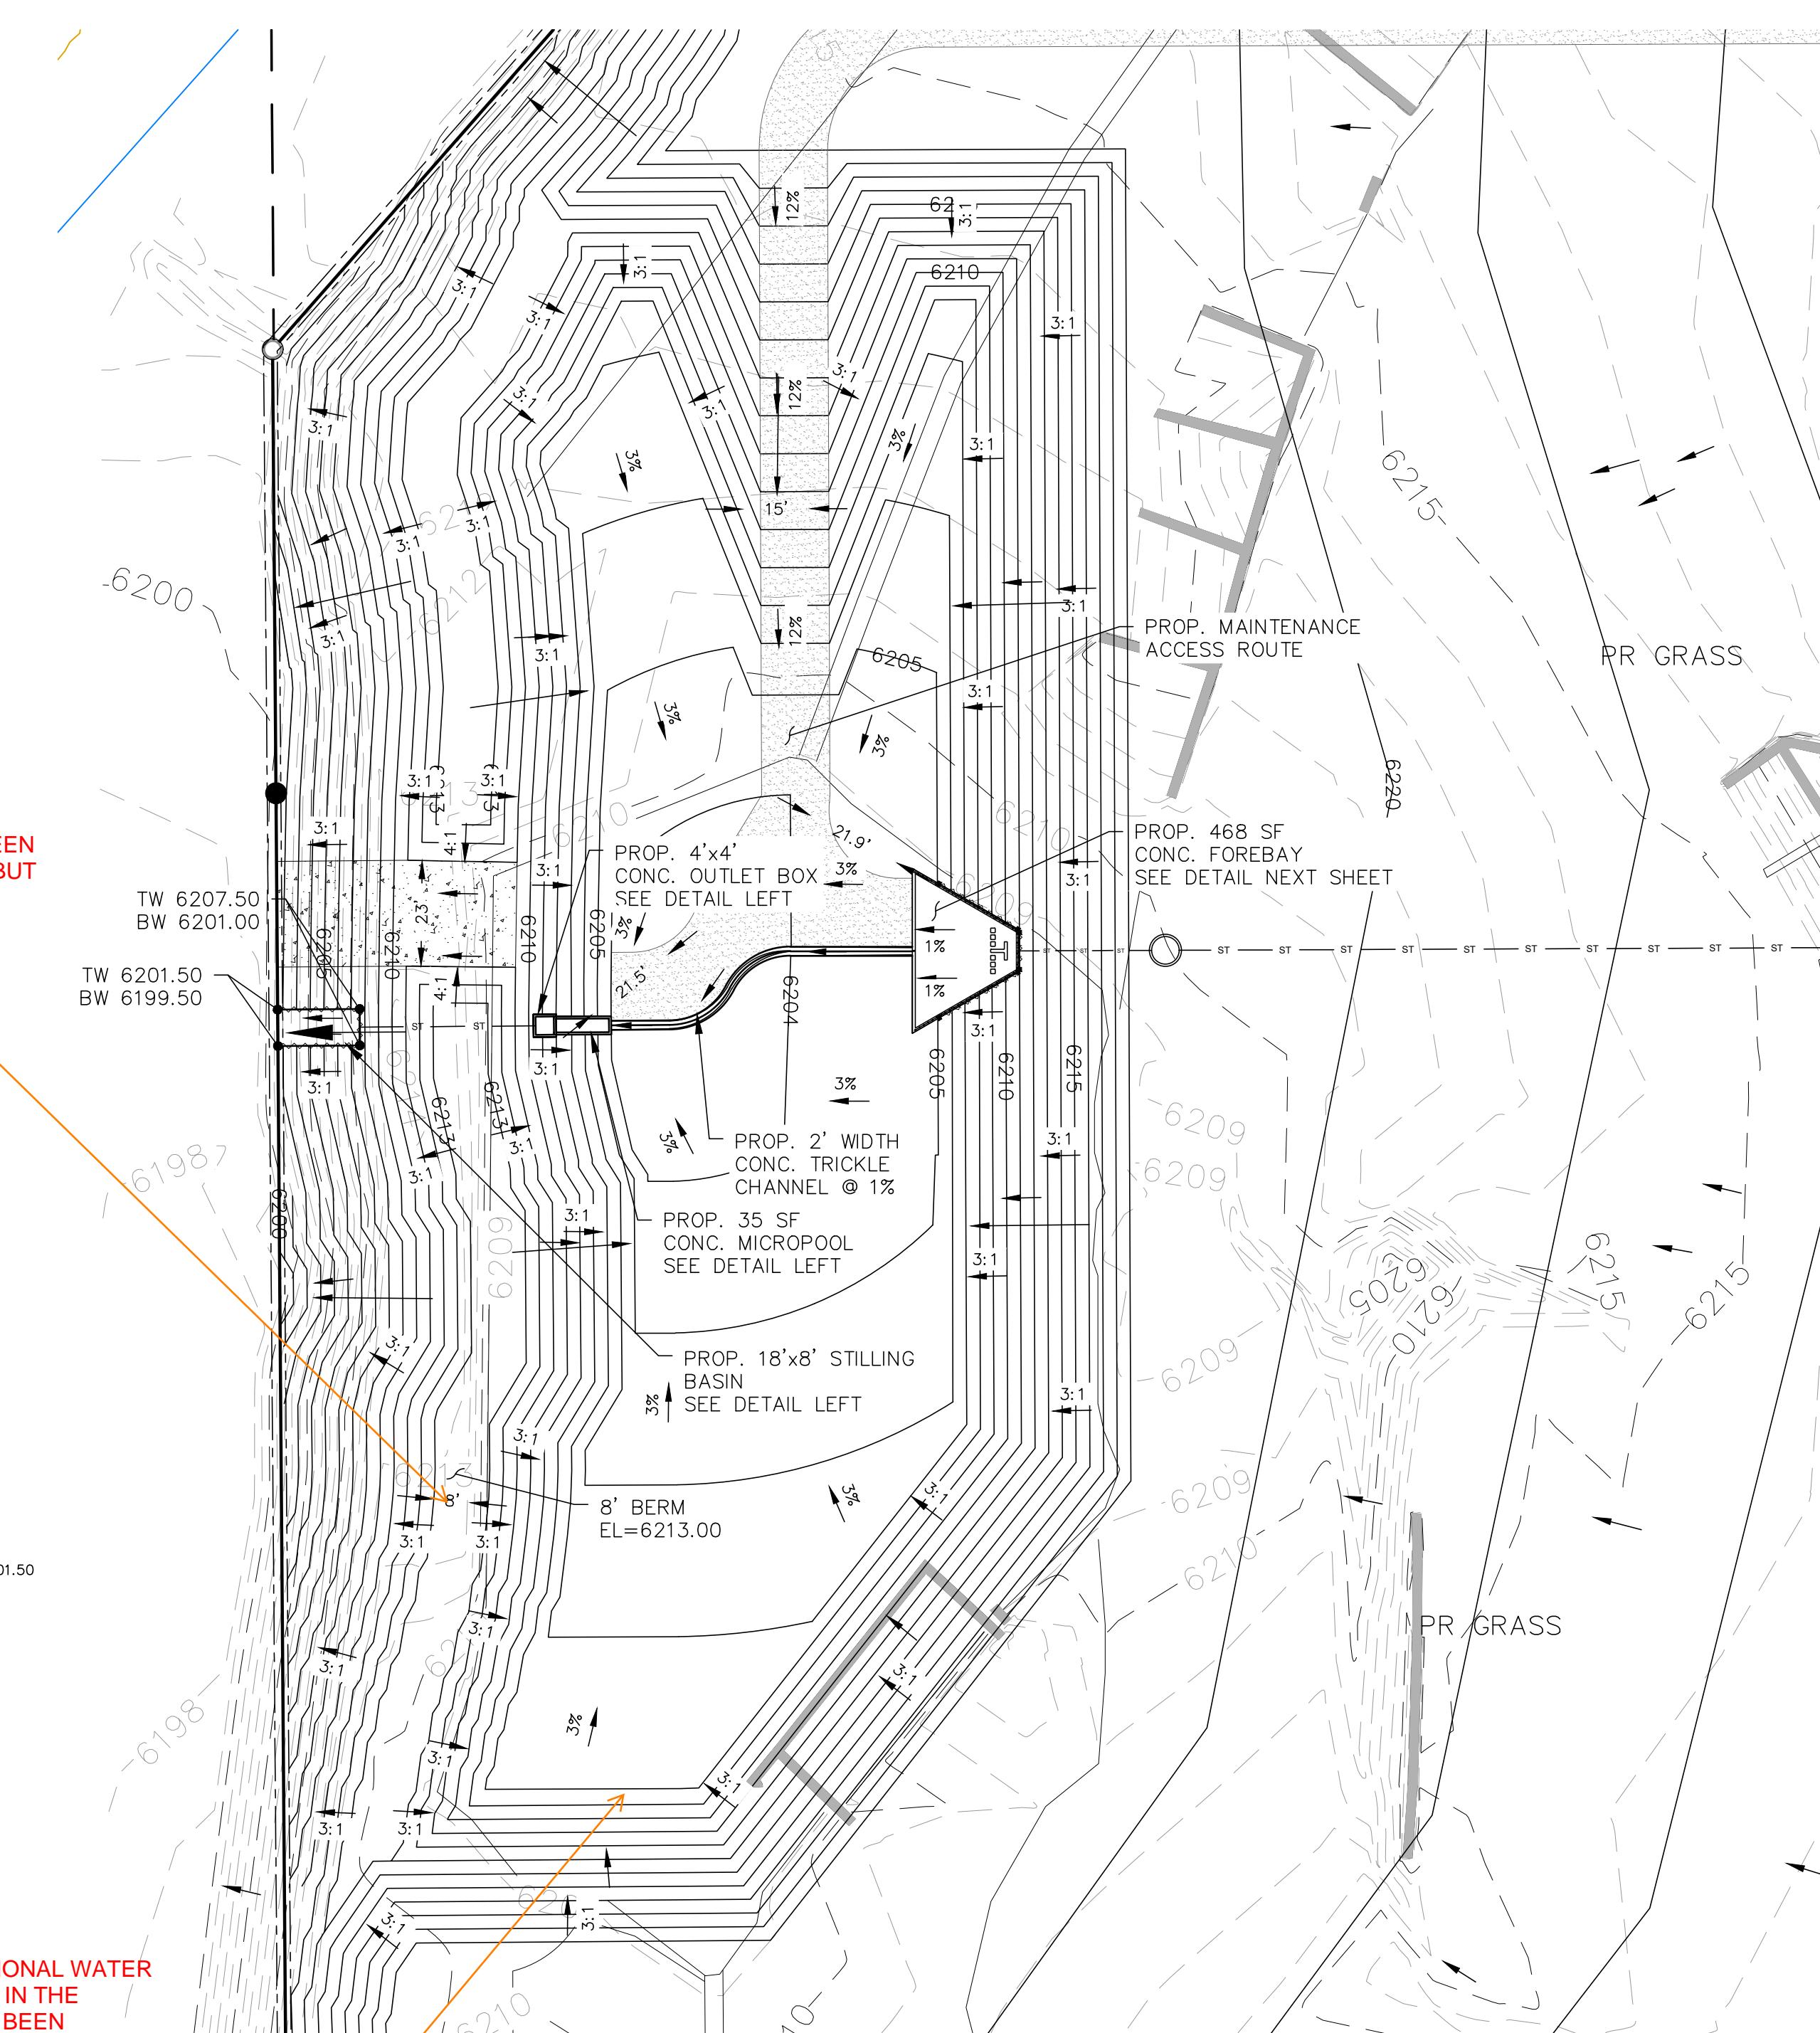

#### NOTES

- ALL HDPE STORM PIPE IS TO BE SMOOTH INTERIOR PIPE.
- LARGE BLOCKS OF TEXT QUOTING STANDARD DRAWINGS OR DETAILS ARE INCLUDED AS A REQUIREMENT OF COUNTY REVIEWERS.


#### BENCHMARKS

- #5 REBAR WITH ORANGE PLASTIC CAP MARKED "CSAM, LLC PLS 32439", FLUSH WITH GROUND - ELEV.=6513.85 (NAVD-1988) [NORTHWEST PROPERTY CORNER]

REVISIONS	DESCRIPTION
NO.	DATE
UNTIL SUCH TIME AS THESE DRAWINGS ARE APPROVED BY THE APPROPRIATE REVIEWING AGENCIES, INC. APPROVES THEIR USE ONLY FOR THE PURPOSES DESIGNATED BY WRITTEN AUTHORIZATION.	
PREPARED FOR: RMG-ROCKY MOUNTAIN GROUP ATTN: 5085 LIST DR, #200 COLORADO SPRINGS, CO 80919 719.548.0600	
Terra Nova Engineering, Inc. Civil/Structural Engineering Services	
221 S. 23RD STREET COLORADO SPRINGS, CO 80904 OFFICE: 719-535-6422 FAX: 719-535-6426 www.tresinc.com	
PLATE SELF STORAGE GRADING AND EROSION CONTROL PLAN EXTENDED DETENTION BASIN PLAN	
DESIGNED BY DLF	DRAWN BY DLF
CHECKED BY LD	H-SCALE AS SHOWN
V-SCALE N/A	JOB NO. 2419.00
DATE ISSUED 08/14/24	
SHEET NO. 19 OF 25	

THIS DESIGN WAS PREPARED UNDER MY DIRECT SUPERVISION FOR AND ON BEHALF OF TERRA NOVA ENGINEERING, INC.

DANE FRANK  
COLORADO P.E. # 50207

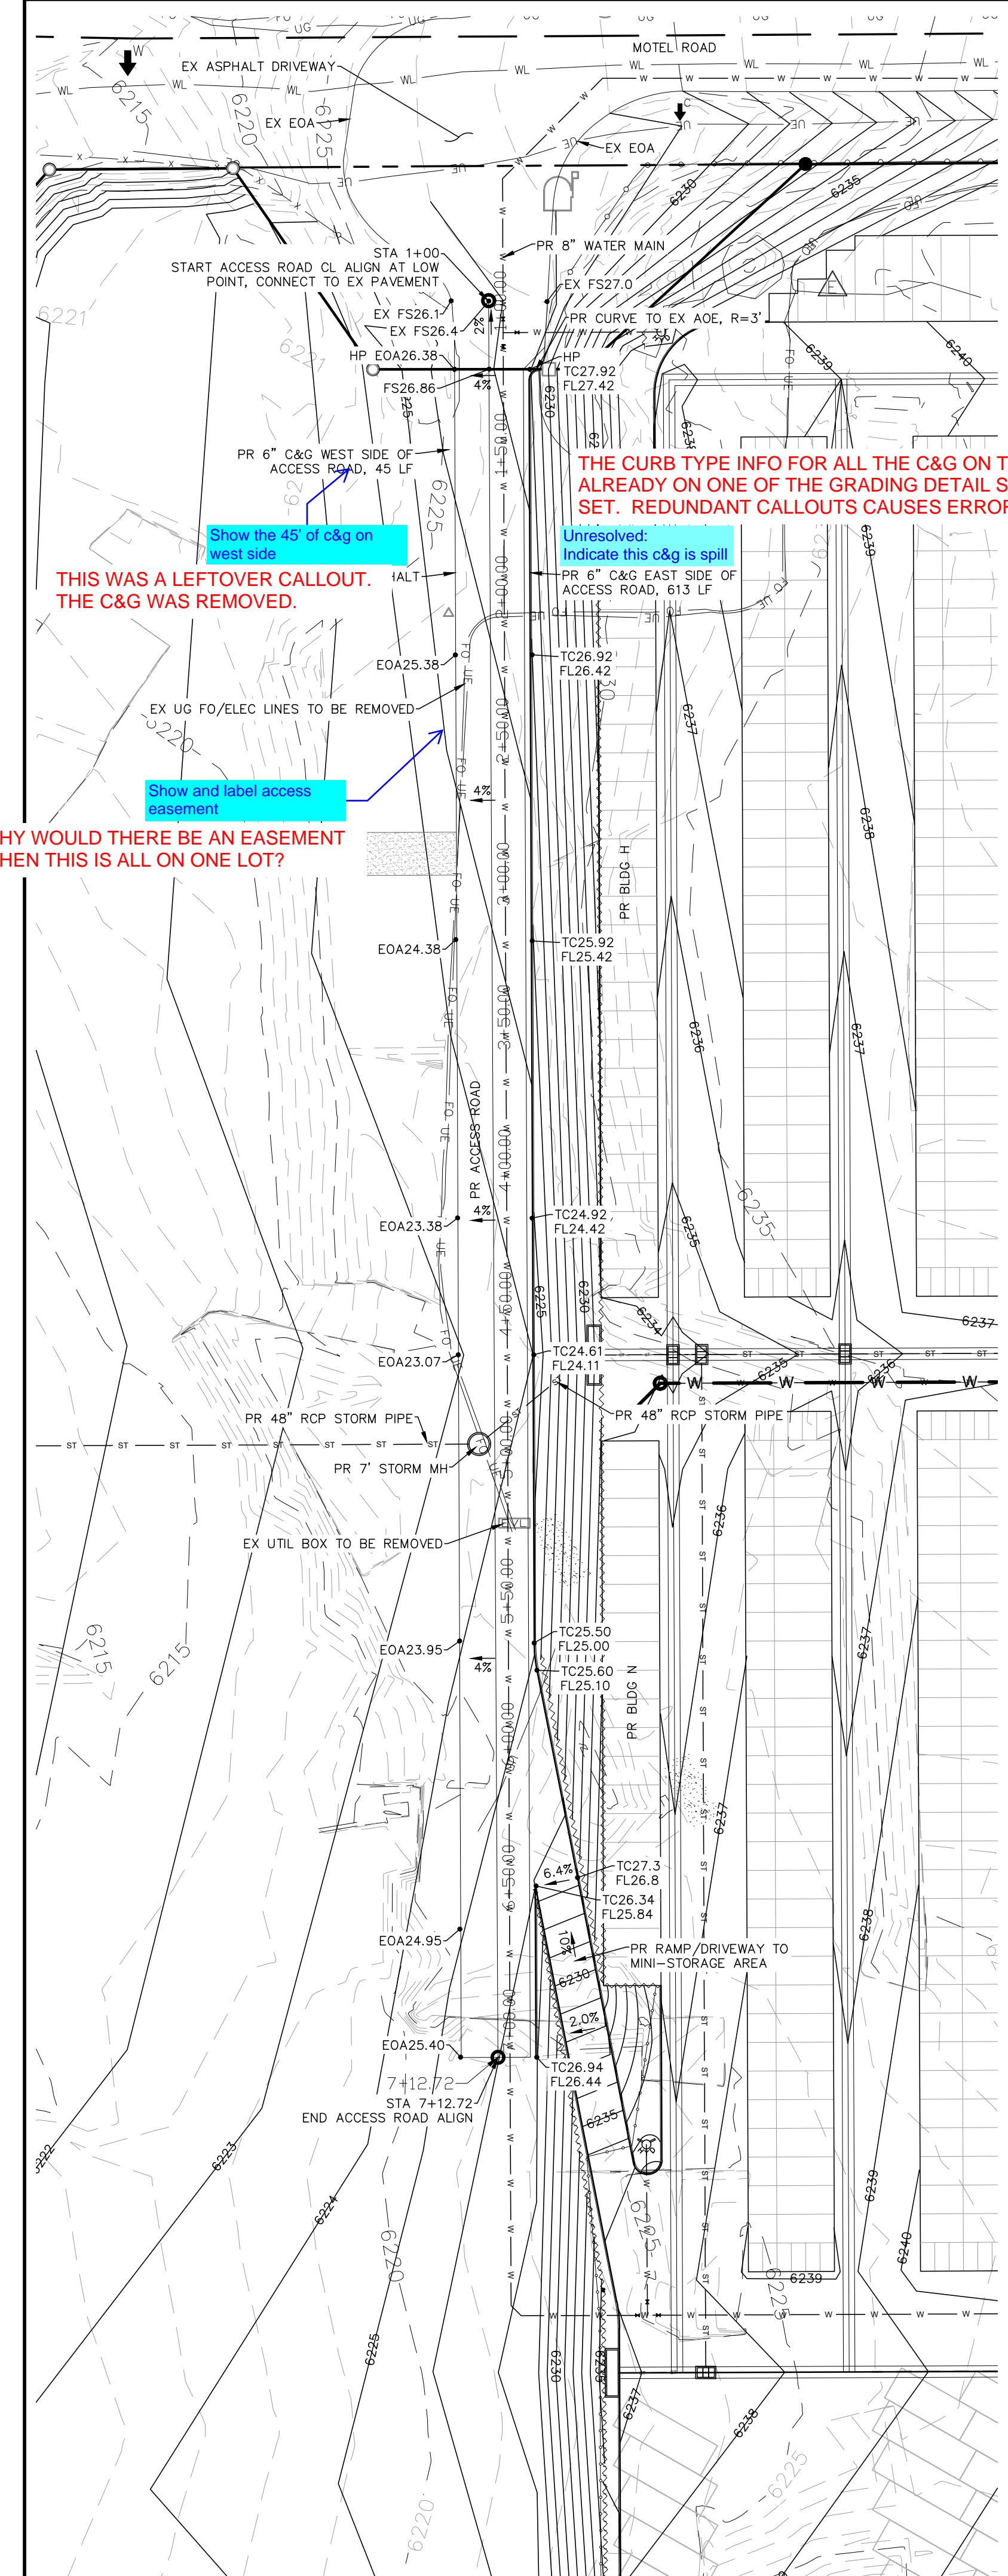

SIDWALK: WIDTH	<input type="checkbox"/> ATTACHED	<input type="checkbox"/> DETACHED			
LOCATION:					
DESIGN SPEED: 25 MPH (POSTED)					
CURB TYPE:	<input checked="" type="checkbox"/> 1	<input type="checkbox"/> 2	<input type="checkbox"/> 3	<input type="checkbox"/> 4	<input type="checkbox"/> 5
ROW WIDTH:	FL-FL: 28'				
STREET TYPE:	CUSTOM				
PAVEMENT TYPE:	<input type="checkbox"/> HMA	<input type="checkbox"/> PCC			
THICKNESS:					
COMPOSITE SECTION:	<input type="checkbox"/> HMA	<input type="checkbox"/> BASE			
SUBGRADE STABILIZATION:	<input type="checkbox"/> CHEMICAL	<input type="checkbox"/> MECHANICAL			
TYPE	<input type="checkbox"/> THICKNESS				


### LEGEND

EXISTING CONTOURS - MINOR	— 6231 —
EXISTING CONTOURS - MAJOR	— 6230 —
PROPOSED CONTOURS - 1'	— 6231 —
EXISTING PROPERTY LINE	~~~~~
PROPOSED RET WALL	██████
PROPOSED RIPRAP	██████████
WATER LINE	— w —
SANITARY SEWER LINE	— ss —
GAS LINE	— ug —
UNDERGROUND ELECTRICAL LINE	— ue —
TELEPHONE LINE	— ut —
FIBER OPTIC LINE	— fd —
STORM SEWER LINE	— st —
LIMIT OF CONSTRUCTION	— — —
LIMIT OF SOIL DISTURBANCE	— — —
PROPOSED FENCE	— — —
EXISTING CONTOURS (LIDAR)	BT3Q
FIRE HYDRANT	hydrant

REVISIONS  
NO. \_\_\_\_\_ DATE \_\_\_\_\_


UNTIL SUCH TIME AS THESE DRAWINGS ARE APPROVED BY THE APPROPRIATE REVIEWING AGENCIES, TERRA NOVA ENGINEERING, INC. APPROVES THEIR USE ONLY FOR THE PURPOSES DESIGNATED BY WRITTEN AUTHORIZATION.

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ATTN: 5085 LIST DR, #200  
COLORADO SPRINGS, CO 80919  
719.548.0600

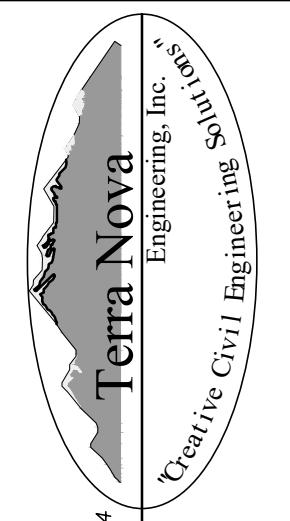


Engineering, Inc.  
Civil Engineering Services  
Terra Nova

www.trensic.com

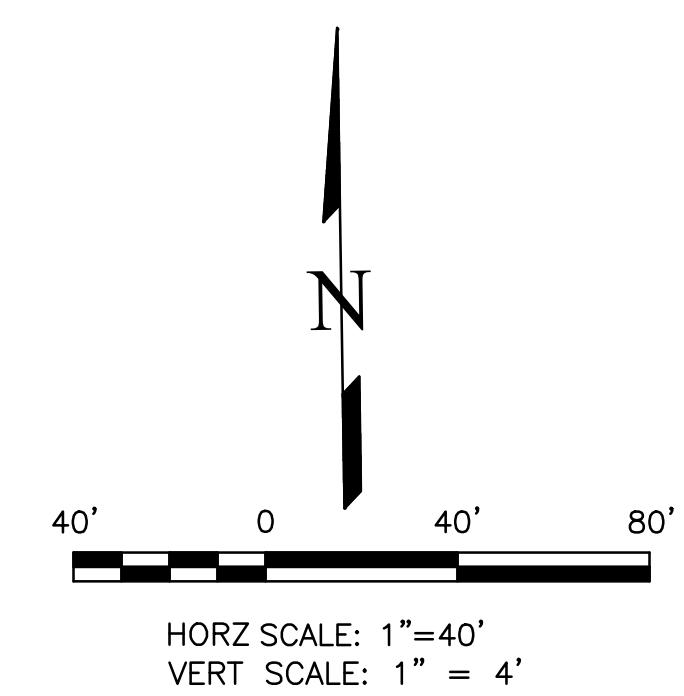

ACCESS ROAD - PLAN & PROFILE  
HORZ SCALE: 1"=40' - VERT SCALE: 1"=4'

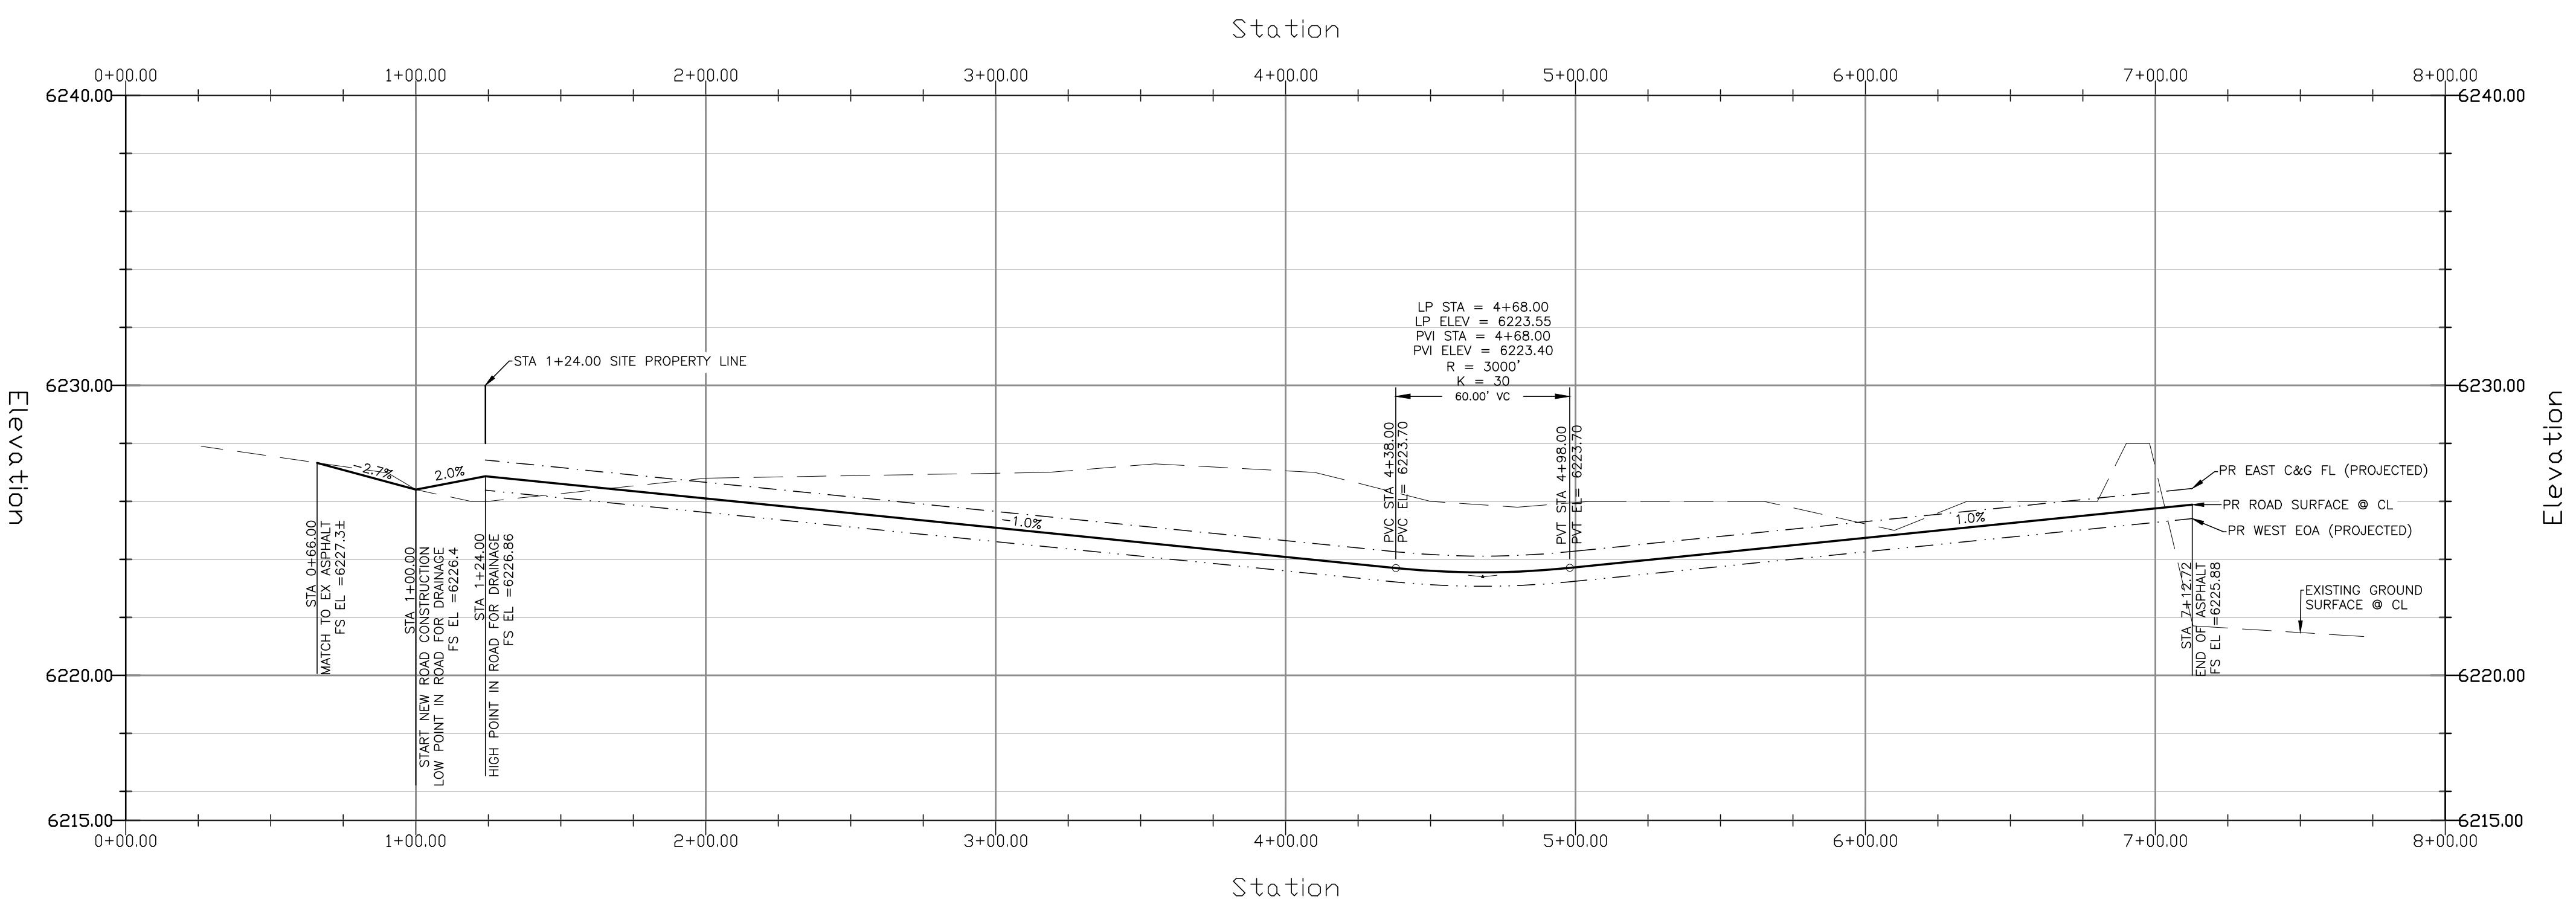

THIS DESIGN WAS PREPARED UNDER MY DIRECT SUPERVISION FOR AND ON BEHALF OF TERRA NOVA ENGINEERING, INC.

DANE FRANK  
COLORADO P.E. # 50207

PLATE SELF STORAGE  
STREET IMPROVEMENT PLAN  
ACCESS ROAD PLAN & PROFILE  
DESIGNED BY DLF  
DRAWN BY DLF  
CHECKED BY LD  
H-SCALE AS SHOWN  
V-SCALE N/A  
JOB NO. 2419.00  
DATE ISSUED 08/14/24  
SHEET NO. 23 OF 25