

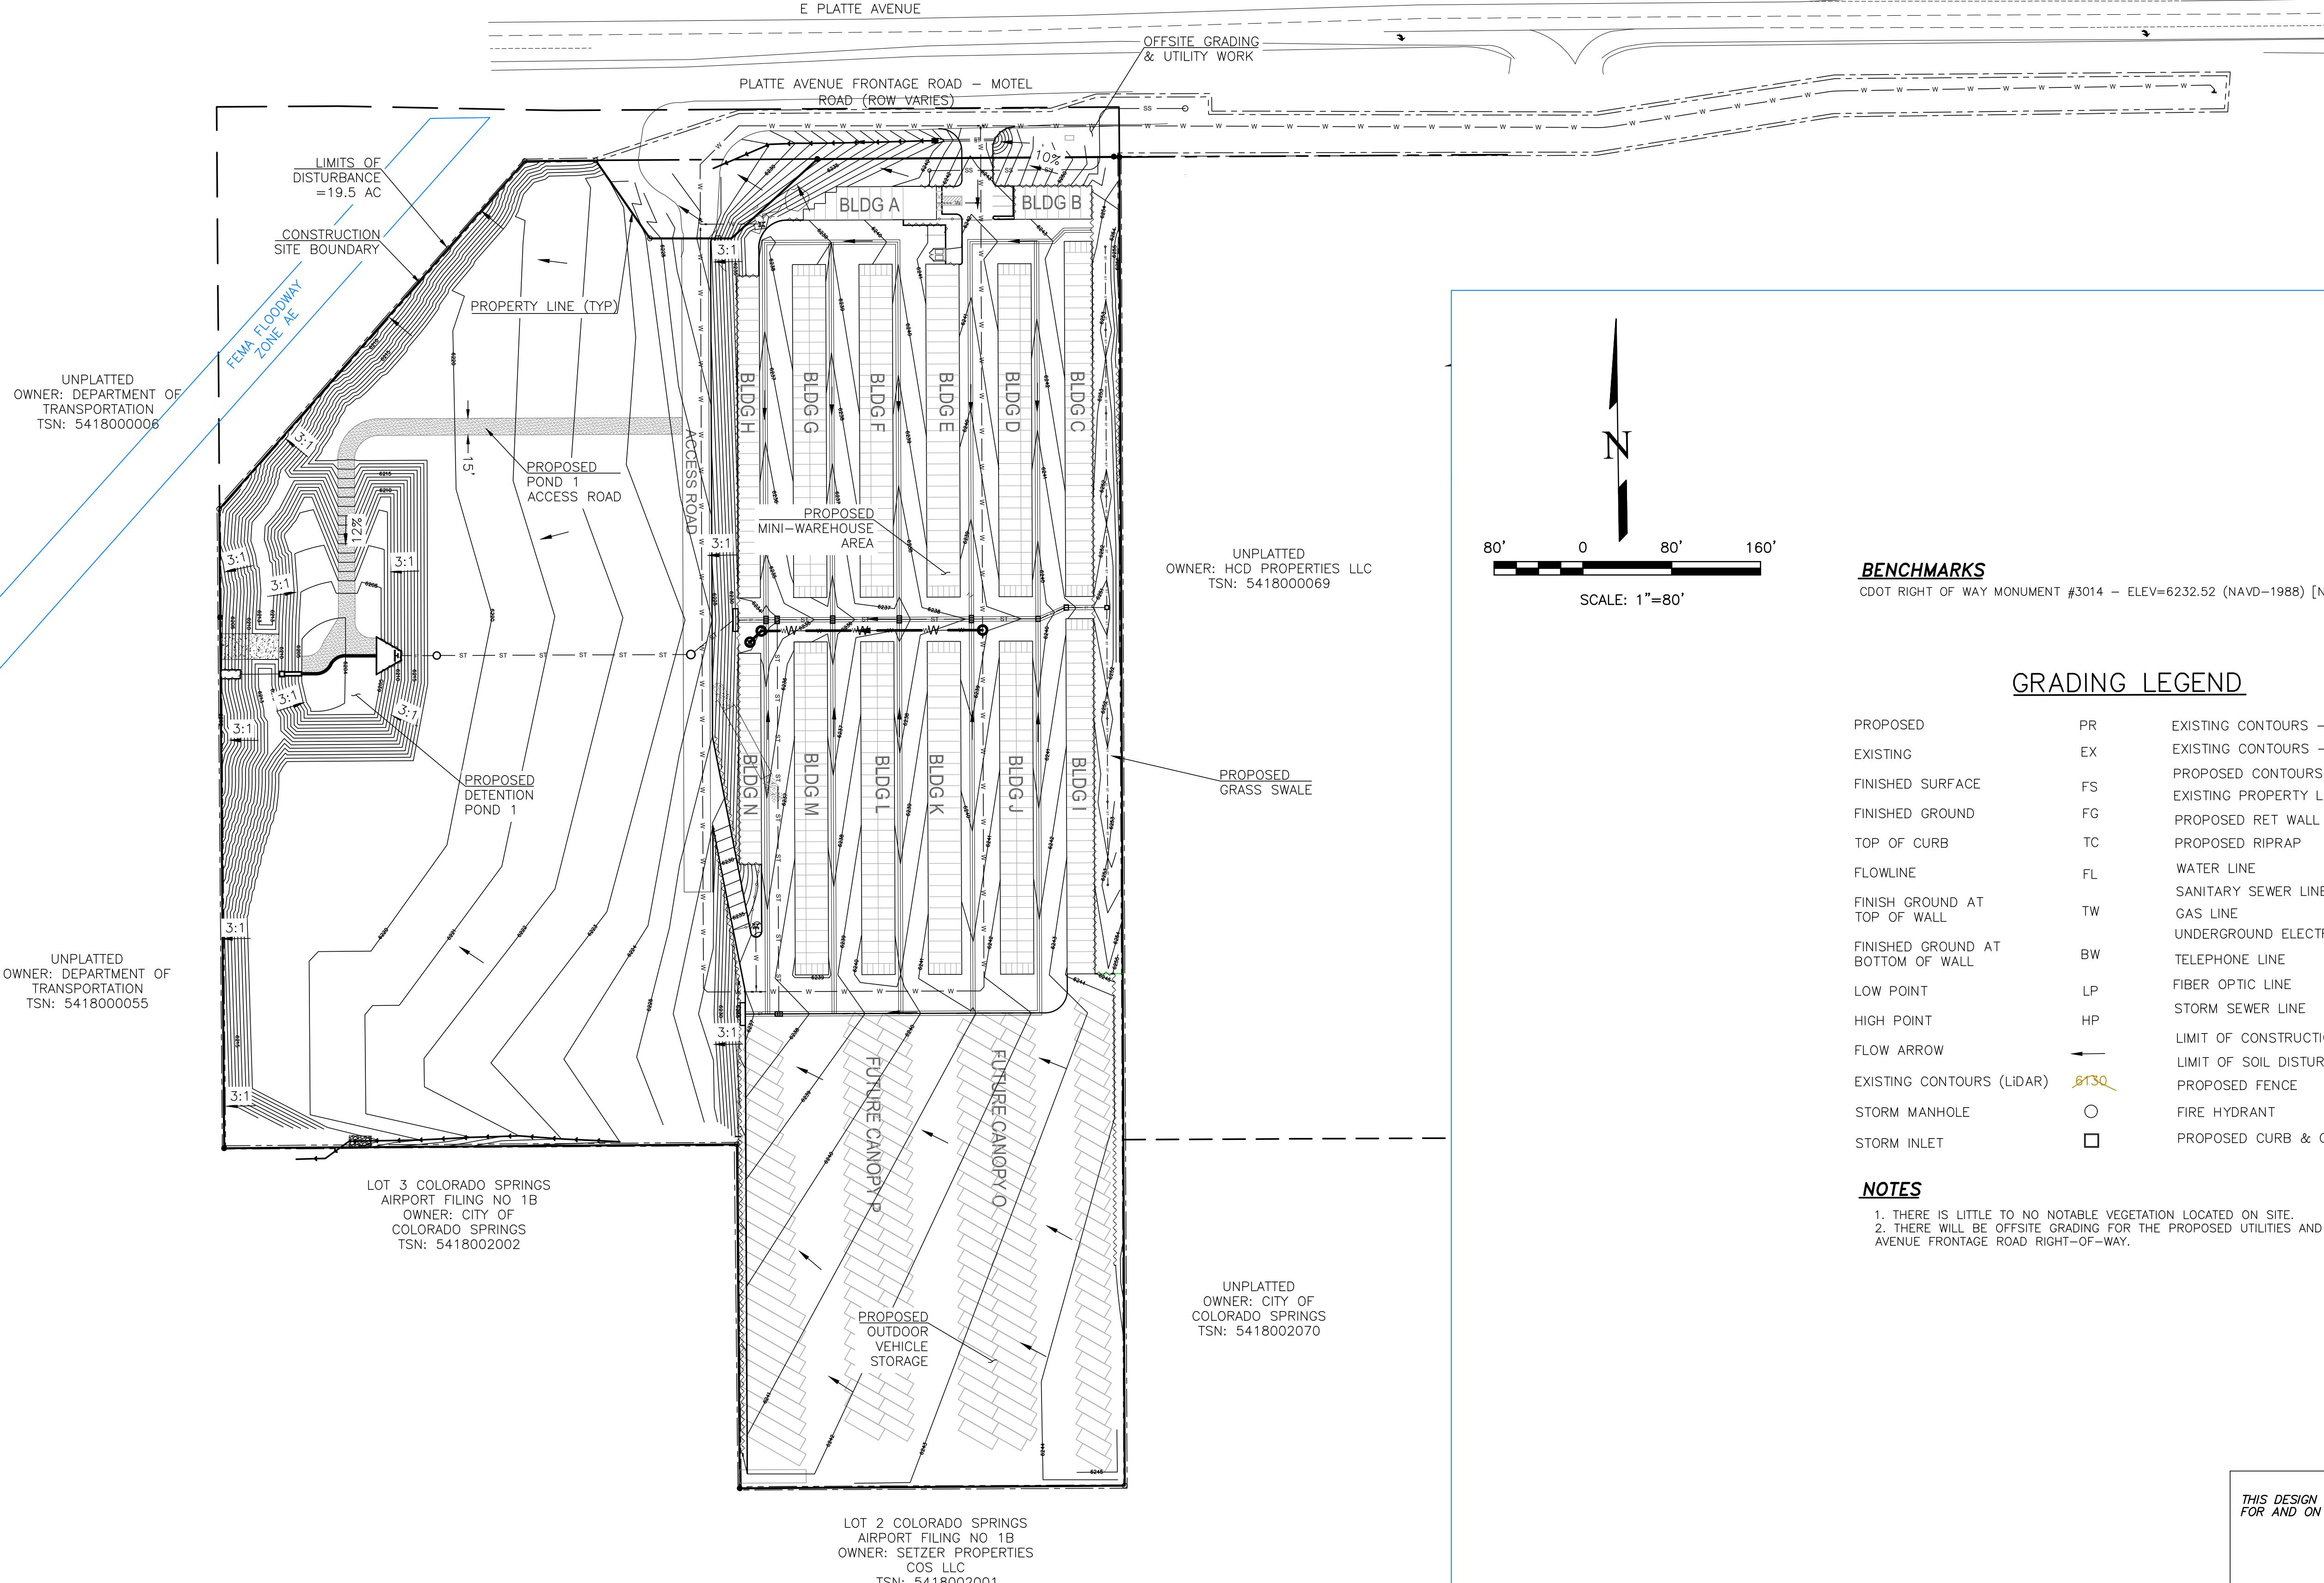


PLATTE SELF STORAGE
GRADING AND EROSION CONTROL PLAN
OVERVIEW SHEET
NOVEMBER 2024

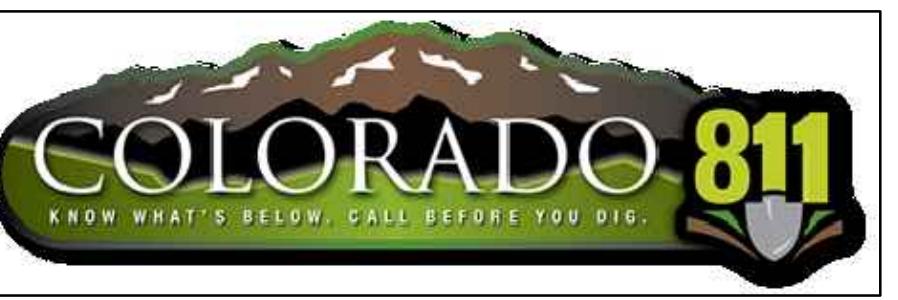

REVISIONS
NO. _____ DATE _____
UNTIL SUCH TIME AS THESE DRAWINGS ARE APPROVED BY THE APPROPRIATE REVIEWING AGENCIES, TERRA NOVA ENGINEERING, INC. APPROVES THEIR USE ONLY FOR THE PURPOSES DESIGNATED BY WRITTEN AUTHORIZATION.

PREPARED FOR:
RMG-ROCKY MOUNTAIN GROUP
ATTN: 5085 LIST DR, #200
COLORADO SPRINGS, CO 80919
719.548.0600

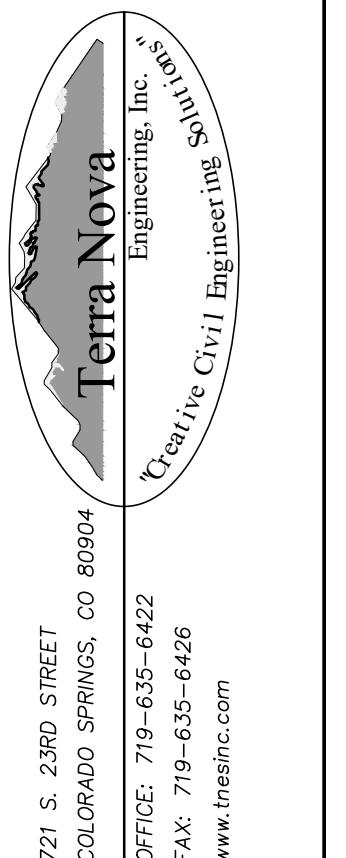

PLATTE SELF STORAGE	721 S. 23RD STREET COLORADO SPRINGS, CO 80904 PHONE: 719-535-6422 FAX: 719-535-6426 www.tresinc.com
GRADING AND EROSION CONTROL PLAN	GRADING AND EROSION CONTROL PLAN OVERVIEW SHEET
DESIGNED BY JF	
DRAWN BY JF	
CHECKED BY DF	
H-SCALE AS SHOWN	
V-SCALE N/A	
JOB NO. 2419.00	
DATE ISSUED 11/13/24	
SHEET NO. 2 OF 27	

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DANE FRANK
COLORADO P.E. # 50207



PLATTE SELF STORAGE GRADING AND EROSION CONTROL PLAN INTERIM GRADING PLAN - NORTH SIDE

NOVEMBER 2024

BENCHMARKS


CDOT RIGHT OF WAY MONUMENT #3014 - ELEV=6232.52 (NAVD-1988) [NORTHEAST OF SITE ENTRANCE]

GRADING LEGEND

REVISIONS NO.	DESCRIPTION	DATE
—	EXISTING CONTOURS - MINOR	— 6231 —
—	EXISTING CONTOURS - MAJOR	— 6230 —
—	PROPOSED CONTOURS - 1'	— 6231 —
—	EXISTING PROPERTY LINE	—
—	PROPOSED RET WALL	—
—	PROPOSED RIPRAP	—
—	WATER LINE	—
—	SANITARY SEWER LINE	—
—	GAS LINE	—
—	UNDERGROUND ELECTRICAL LINE	—
—	TELEPHONE LINE	—
—	LOW POINT	—
—	HIGH POINT	—
—	FLOW ARROW	—
—	EXISTING CONTOURS (LiDAR)	—
—	STORM MANHOLE	—
—	PROPOSED FENCE	—
—	FIRE HYDRANT	—
—	PROPOSED CURB & GUTTER	—

UNTIL SUCH TIME AS THESE DRAWINGS ARE APPROVED BY THE APPROPRIATE REVIEWING AGENCIES, INC. APPROVES THEIR USE ONLY FOR THE PURPOSES DESIGNATED BY WRITTEN AUTHORIZATION.

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RMG-ROCKY MOUNTAIN GROUP
ATTN: LIST DR, #200
5085 LIST DR, #200
COLORADO SPRINGS, CO 80919
719.548.0600

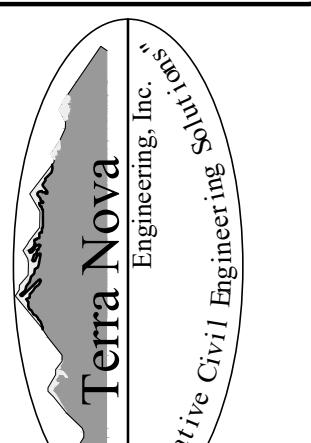

Engineering, Inc.
Civil / Structural / Geotechnical / Environmental / Construction / Project Management



PLATTE SELF STORAGE

GRADING AND EROSION CONTROL PLAN
INTERIM GRADING PLAN - NORTH SIDE

DESIGNED BY JF
DRAWN BY JF
CHECKED BY DF
H-SCALE AS SHOWN
V-SCALE N/A
JOB NO. 2419.00
DATE ISSUED 11/13/24
SHEET NO. 3 OF 27

THIS DESIGN WAS PREPARED UNDER MY DIRECT SUPERVISION FOR AND ON BEHALF OF TERRA NOVA ENGINEERING, INC.

DANE FRANK
COLORADO P.E. # 50207

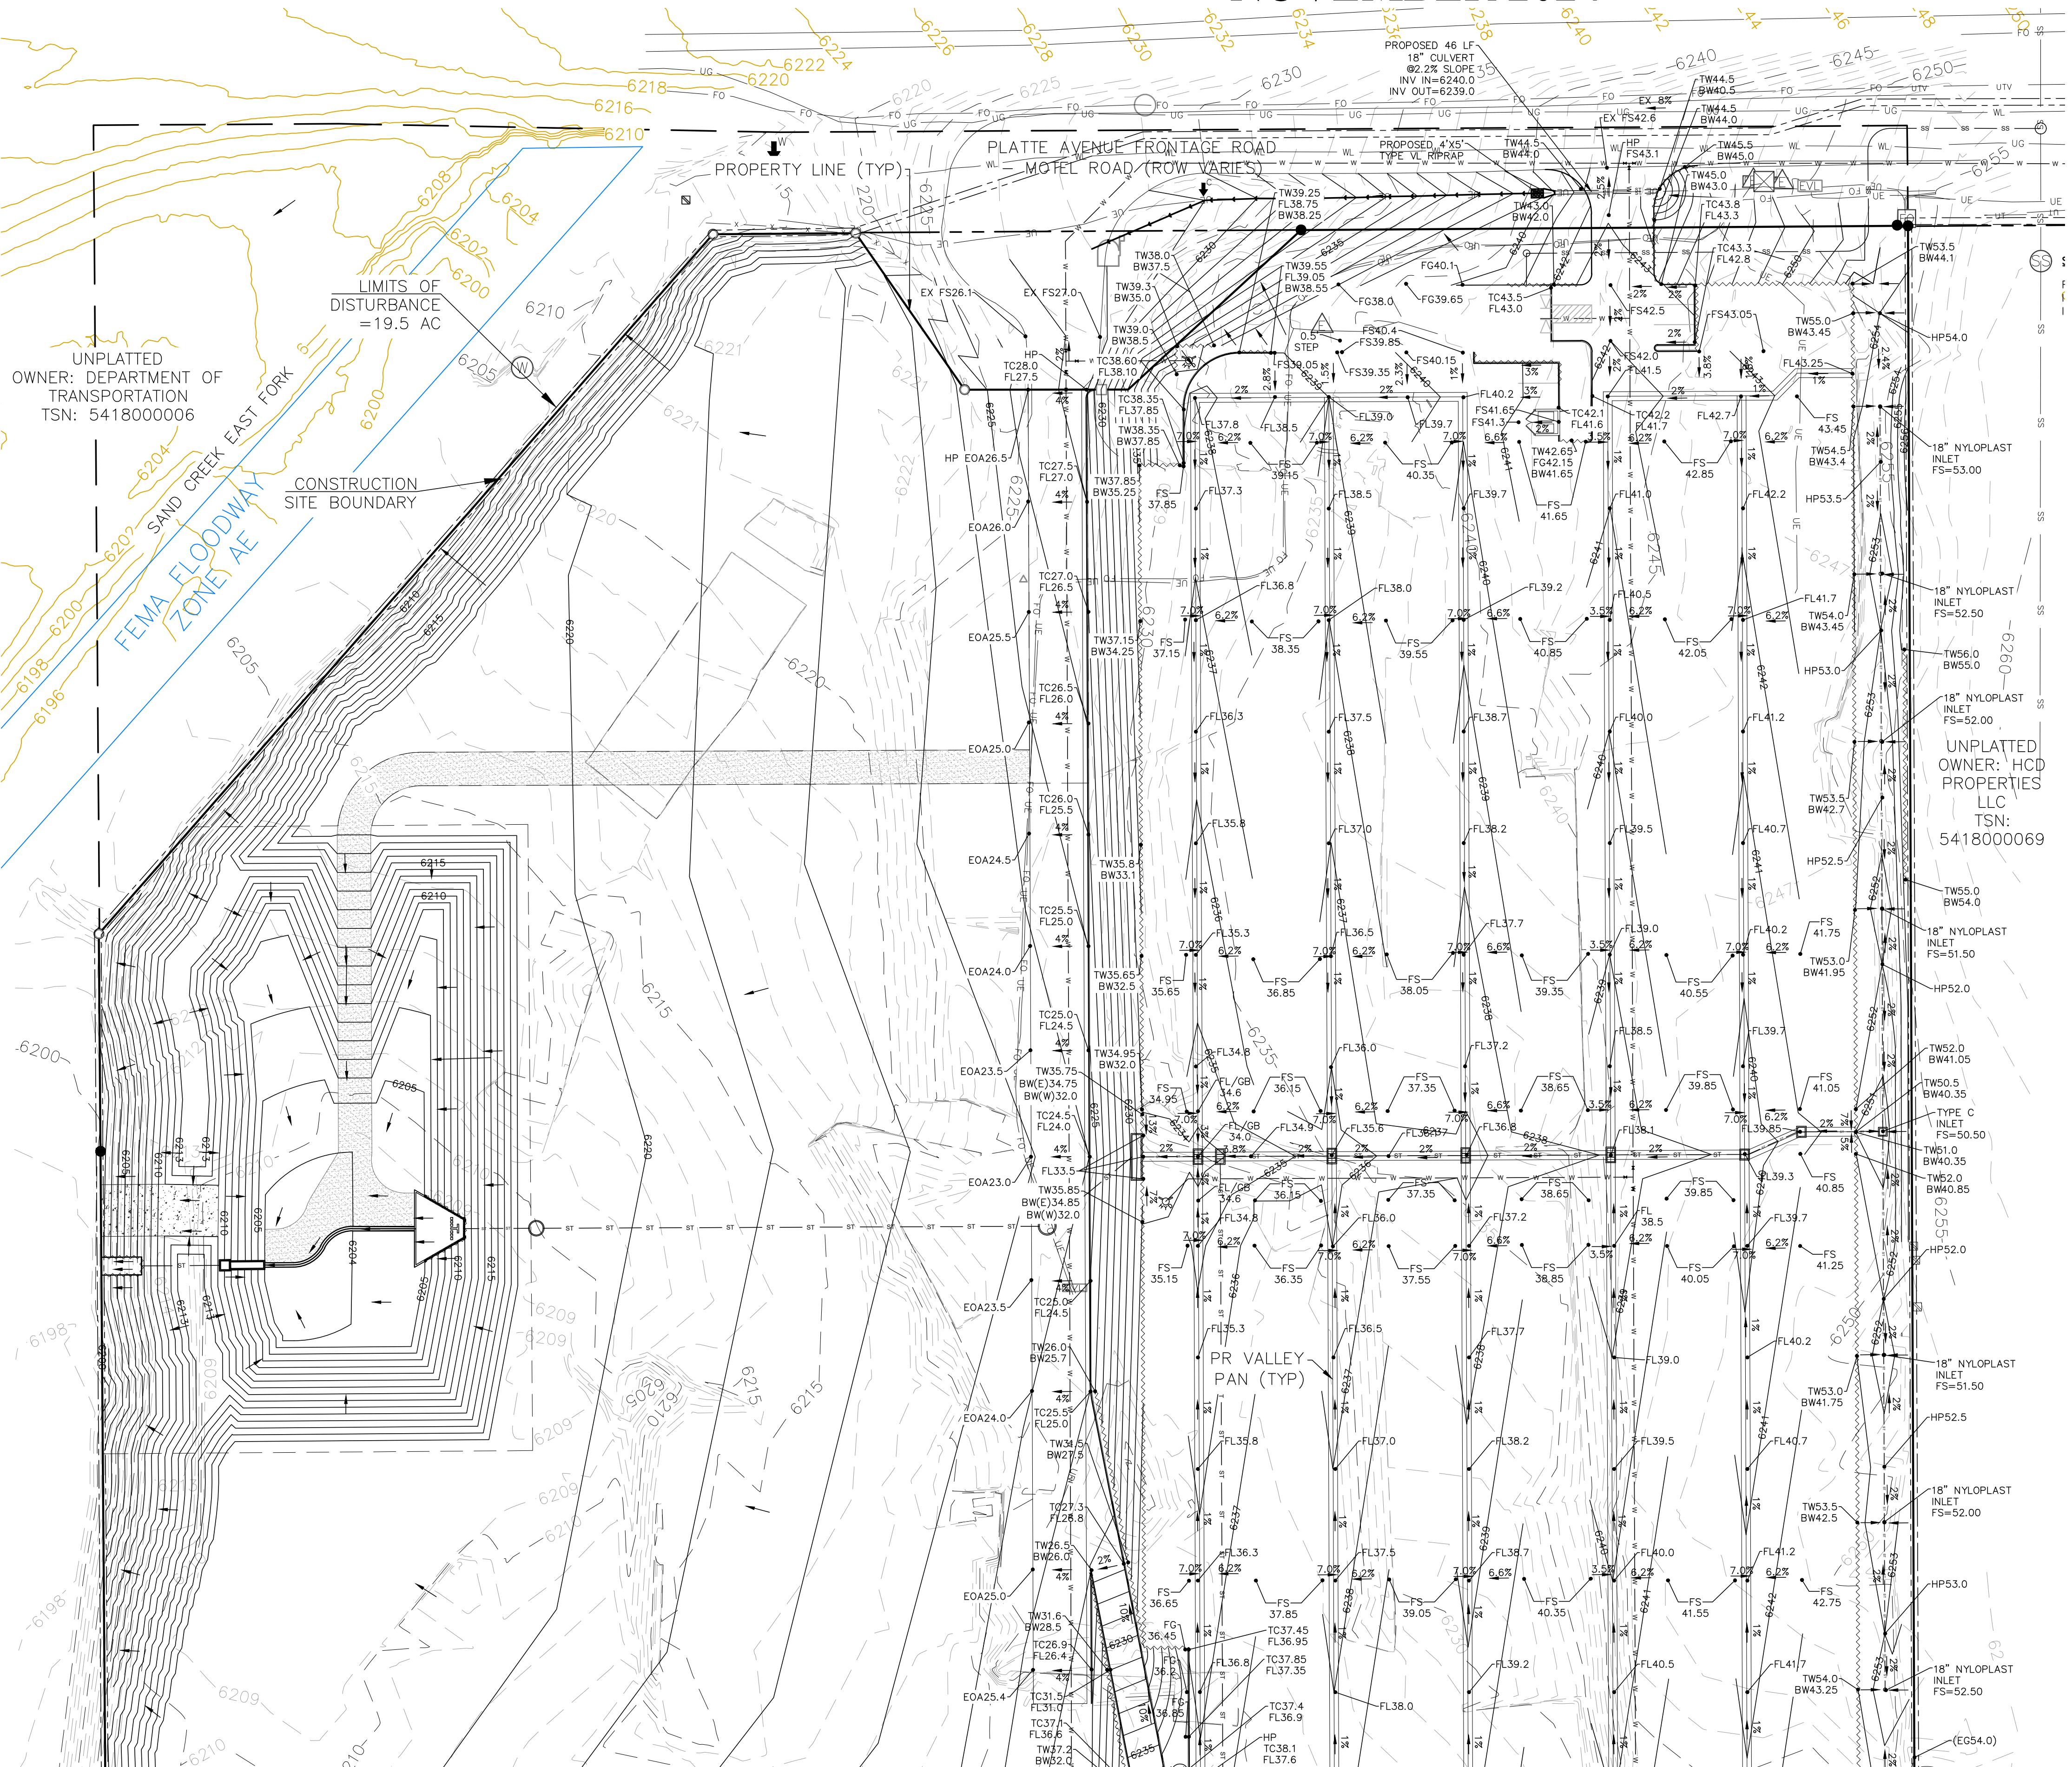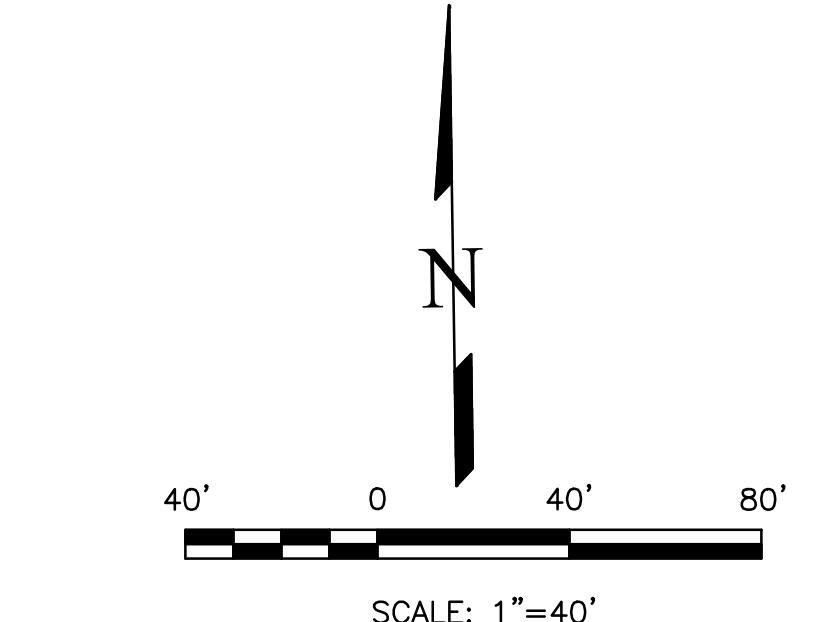

PLATTE SELF STORAGE
GRADING AND EROSION CONTROL PLAN
INTERIM GRADING PLAN - SOUTH SIDE
NOVEMBER 2024


BENCHMARKS
 CDOT RIGHT OF WAY MONUMENT #3014 - ELEV=6232.52 (NAVD-1988) [NORTHEAST OF SITE ENTRANCE]

GRADING LEGEND

PROPOSED	PR	EXISTING CONTOURS - MINOR
EXISTING	EX	EXISTING CONTOURS - MAJOR
FINISHED SURFACE	FS	PROPOSED CONTOURS - 1'
FINISHED GROUND	FG	EXISTING PROPERTY LINE
TOP OF CURB	TC	PROPOSED RIPRAP
FLOWLINE	FL	WATER LINE
FINISH GROUND AT TOP OF WALL	TW	SANITARY SEWER LINE
FINISHED GROUND AT BOTTOM OF WALL	BW	GAS LINE
LOW POINT	LP	UNDERGROUND ELECTRICAL LINE
HIGH POINT	HP	TELEPHONE LINE
FLOW ARROW		FIBER OPTIC LINE
EXISTING CONTOURS (LIDAR)	8130	STORM SEWER LINE
STORM MANHOLE	○	LIMIT OF CONSTRUCTION
STORM INLET	□	LIMIT OF SOIL DISTURBANCE
		PROPOSED FENCE
		FIRE HYDRANT
		PROPOSED CURB & GUTTER

REVISIONS
 UNTIL SUCH TIME AS THESE DRAWINGS ARE APPROVED BY THE APPROPRIATE REVIEWING AGENCIES, TERRA NOVA ENGINEERING, INC. APPROVES THEIR USE ONLY FOR THE PURPOSES DESIGNATED BY WRITTEN AUTHORIZATION.

PREPARED FOR:
RMG-ROCKY MOUNTAIN GROUP
 ATTN: 5085 LIST DR, #200
 COLORADO SPRINGS, CO 80919
 719.548.0600

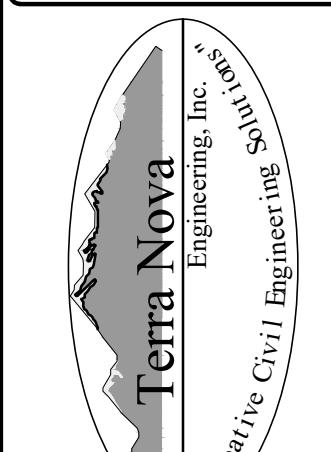


271 S. 28TH STREET
 COLORADO SPRINGS, CO 80904
 OFFICE: 719-535-6422
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 www.tresinc.com

PLATTE SELF STORAGE
 GRADING AND EROSION CONTROL PLAN
 INTERIM GRADING PLAN - SOUTH SIDE

DESIGNED BY JF
 DRAWN BY JF
 CHECKED BY DF
 H-SCALE AS SHOWN
 V-SCALE N/A
 JOB NO. 2419.00
 DATE ISSUED 11/13/24
 SHEET NO. 4 OF 27


NOTES

1. THERE IS LITTLE TO NO NOTABLE EXISTING VEGETATION LOCATED ON SITE.
2. THERE WILL BE OFFSITE GRADING FOR THE PROPOSED UTILITIES AND GRADING WITHIN THE PLATTE AVENUE FRONTAGE ROAD RIGHT-OF-WAY.

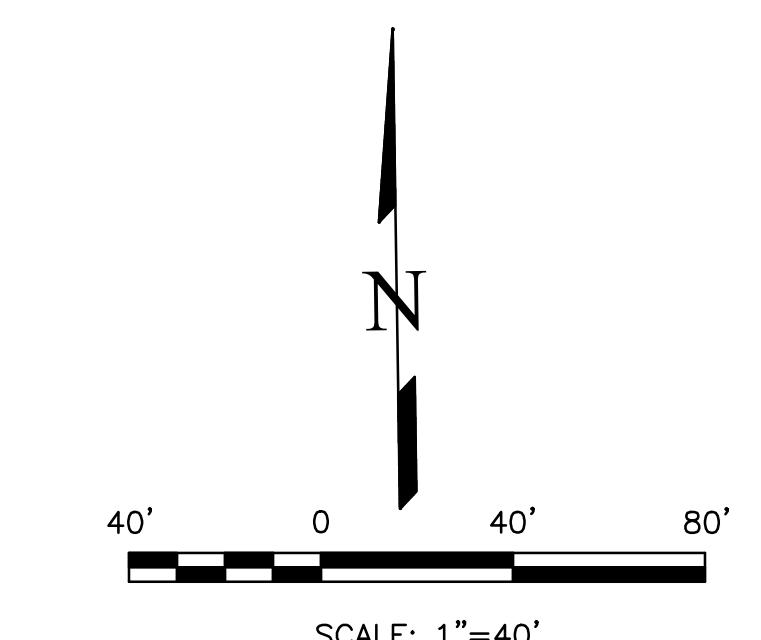


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DANE FRANK
 COLORADO P.E. # 50207

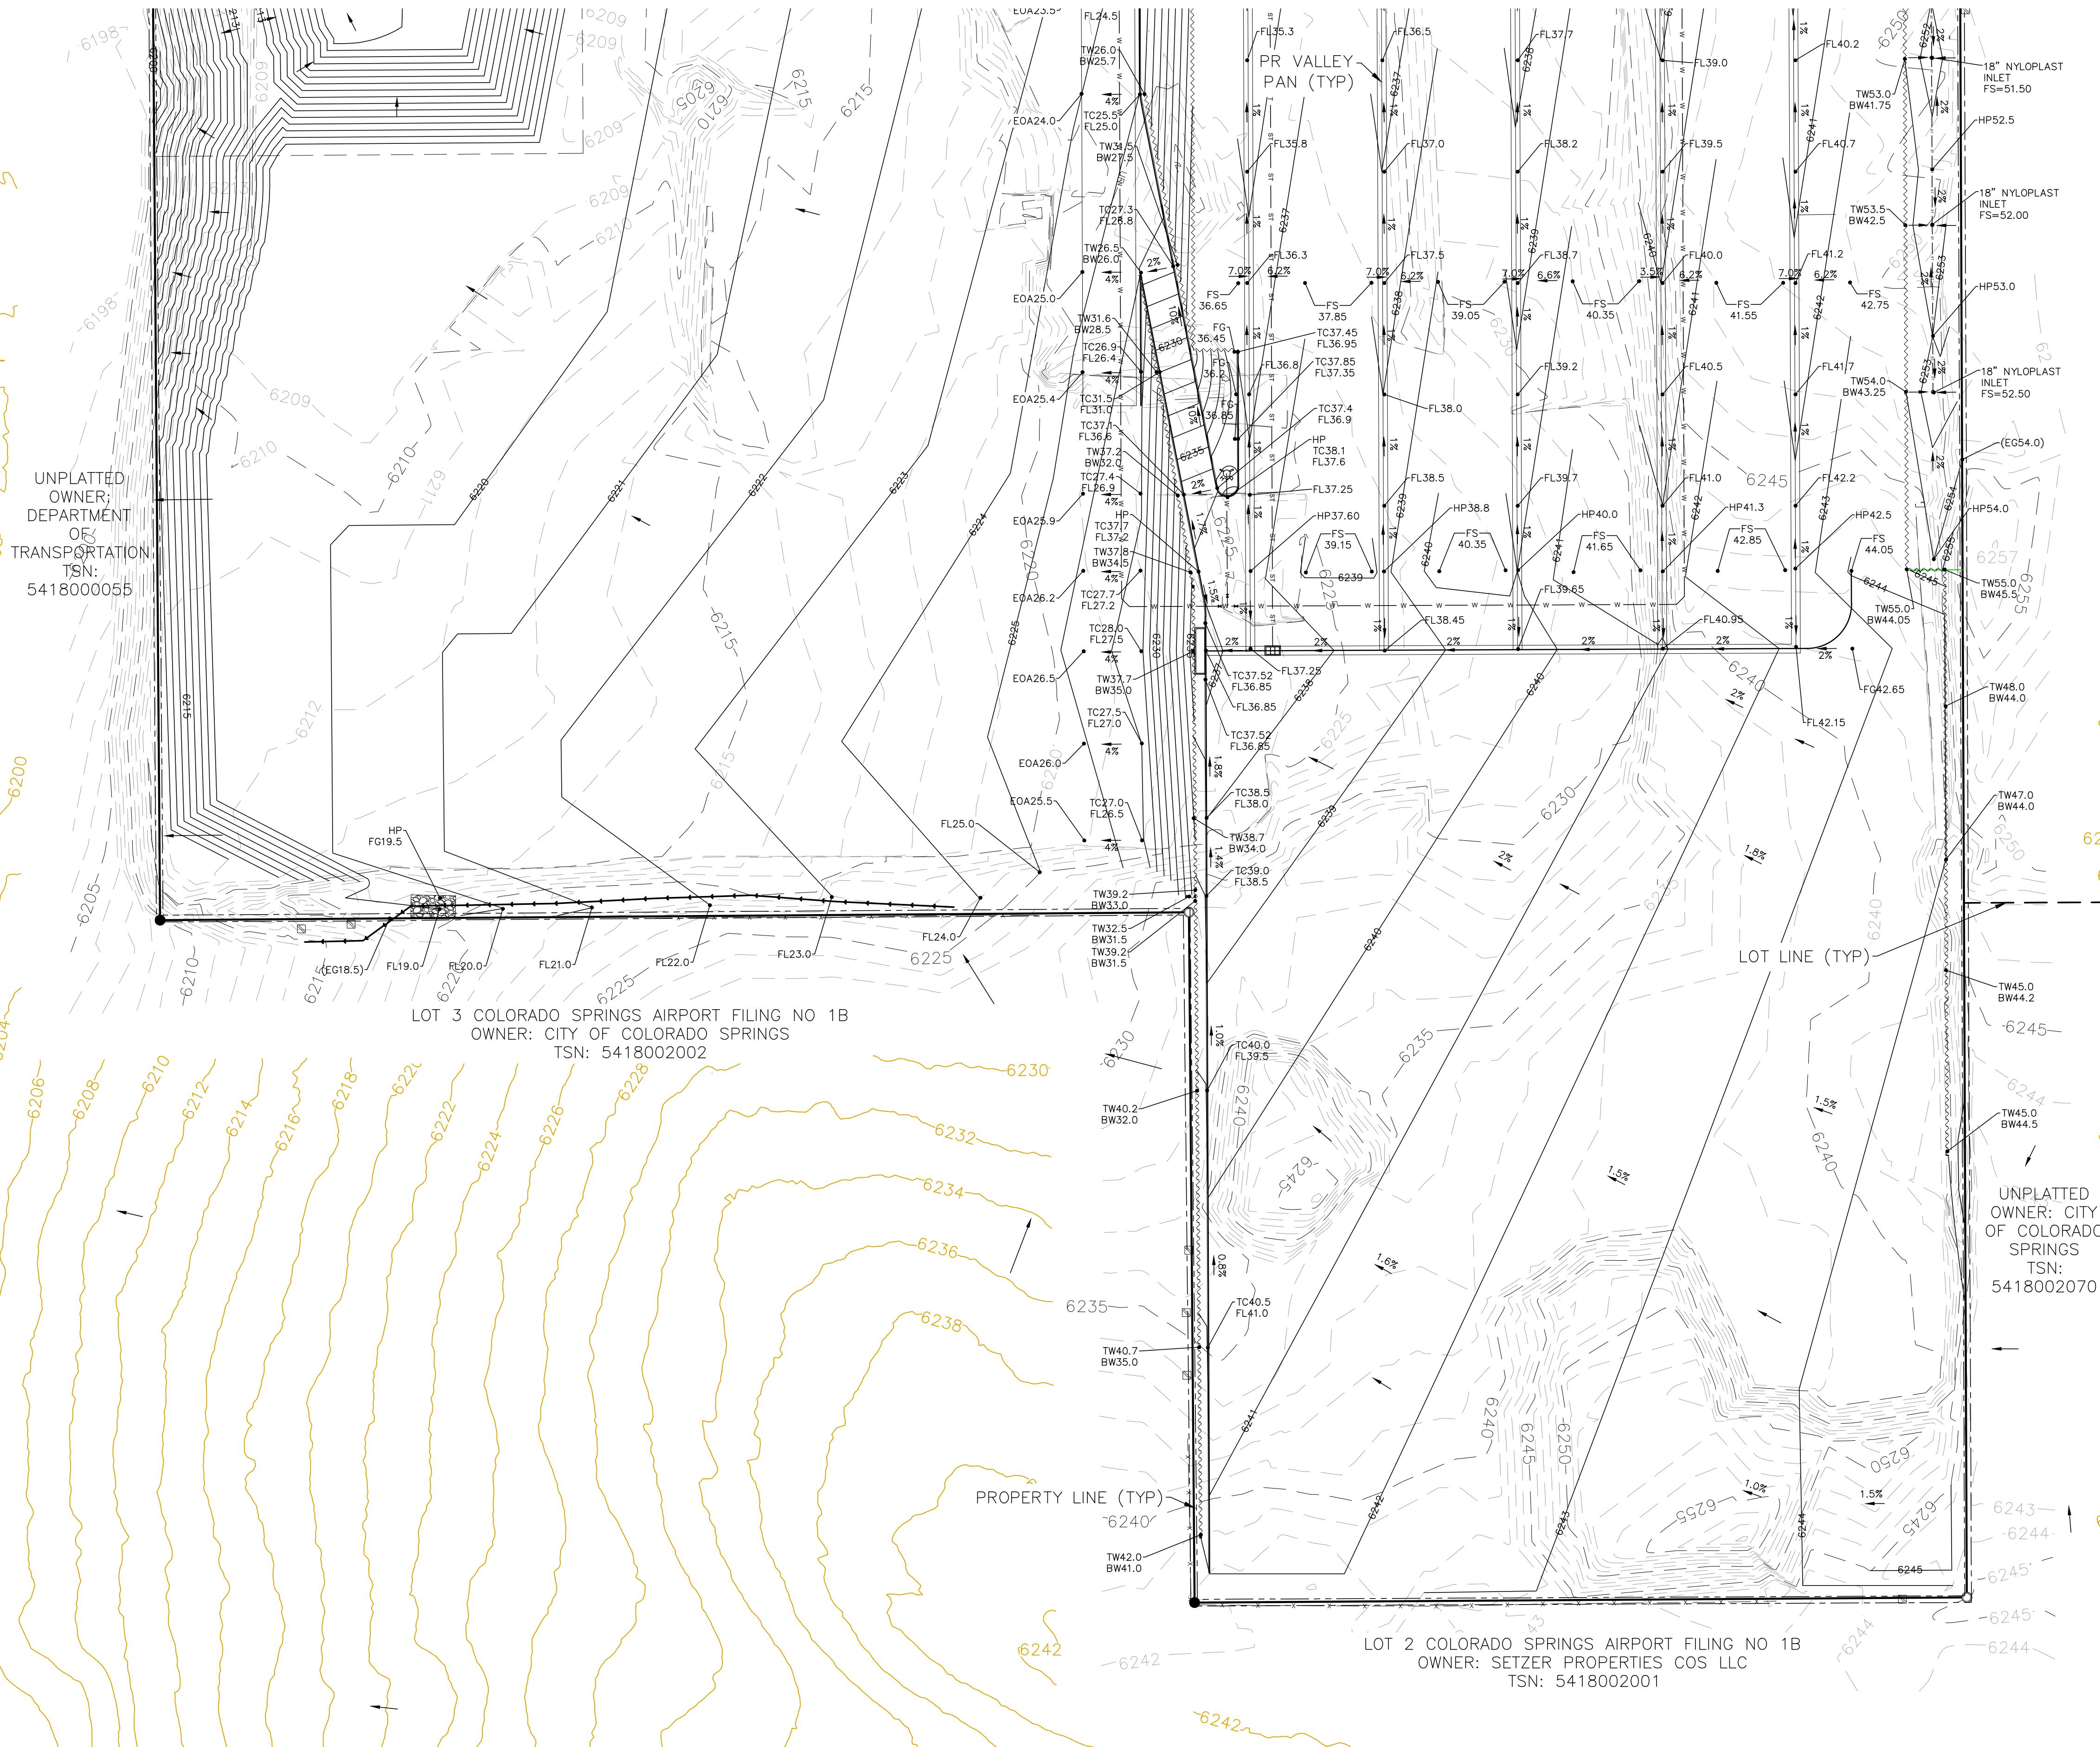

PLATTE SELF STORAGE
GRADING AND EROSION CONTROL PLAN
FINAL GRADING PLAN - NORTH SIDE
NOVEMBER 2024

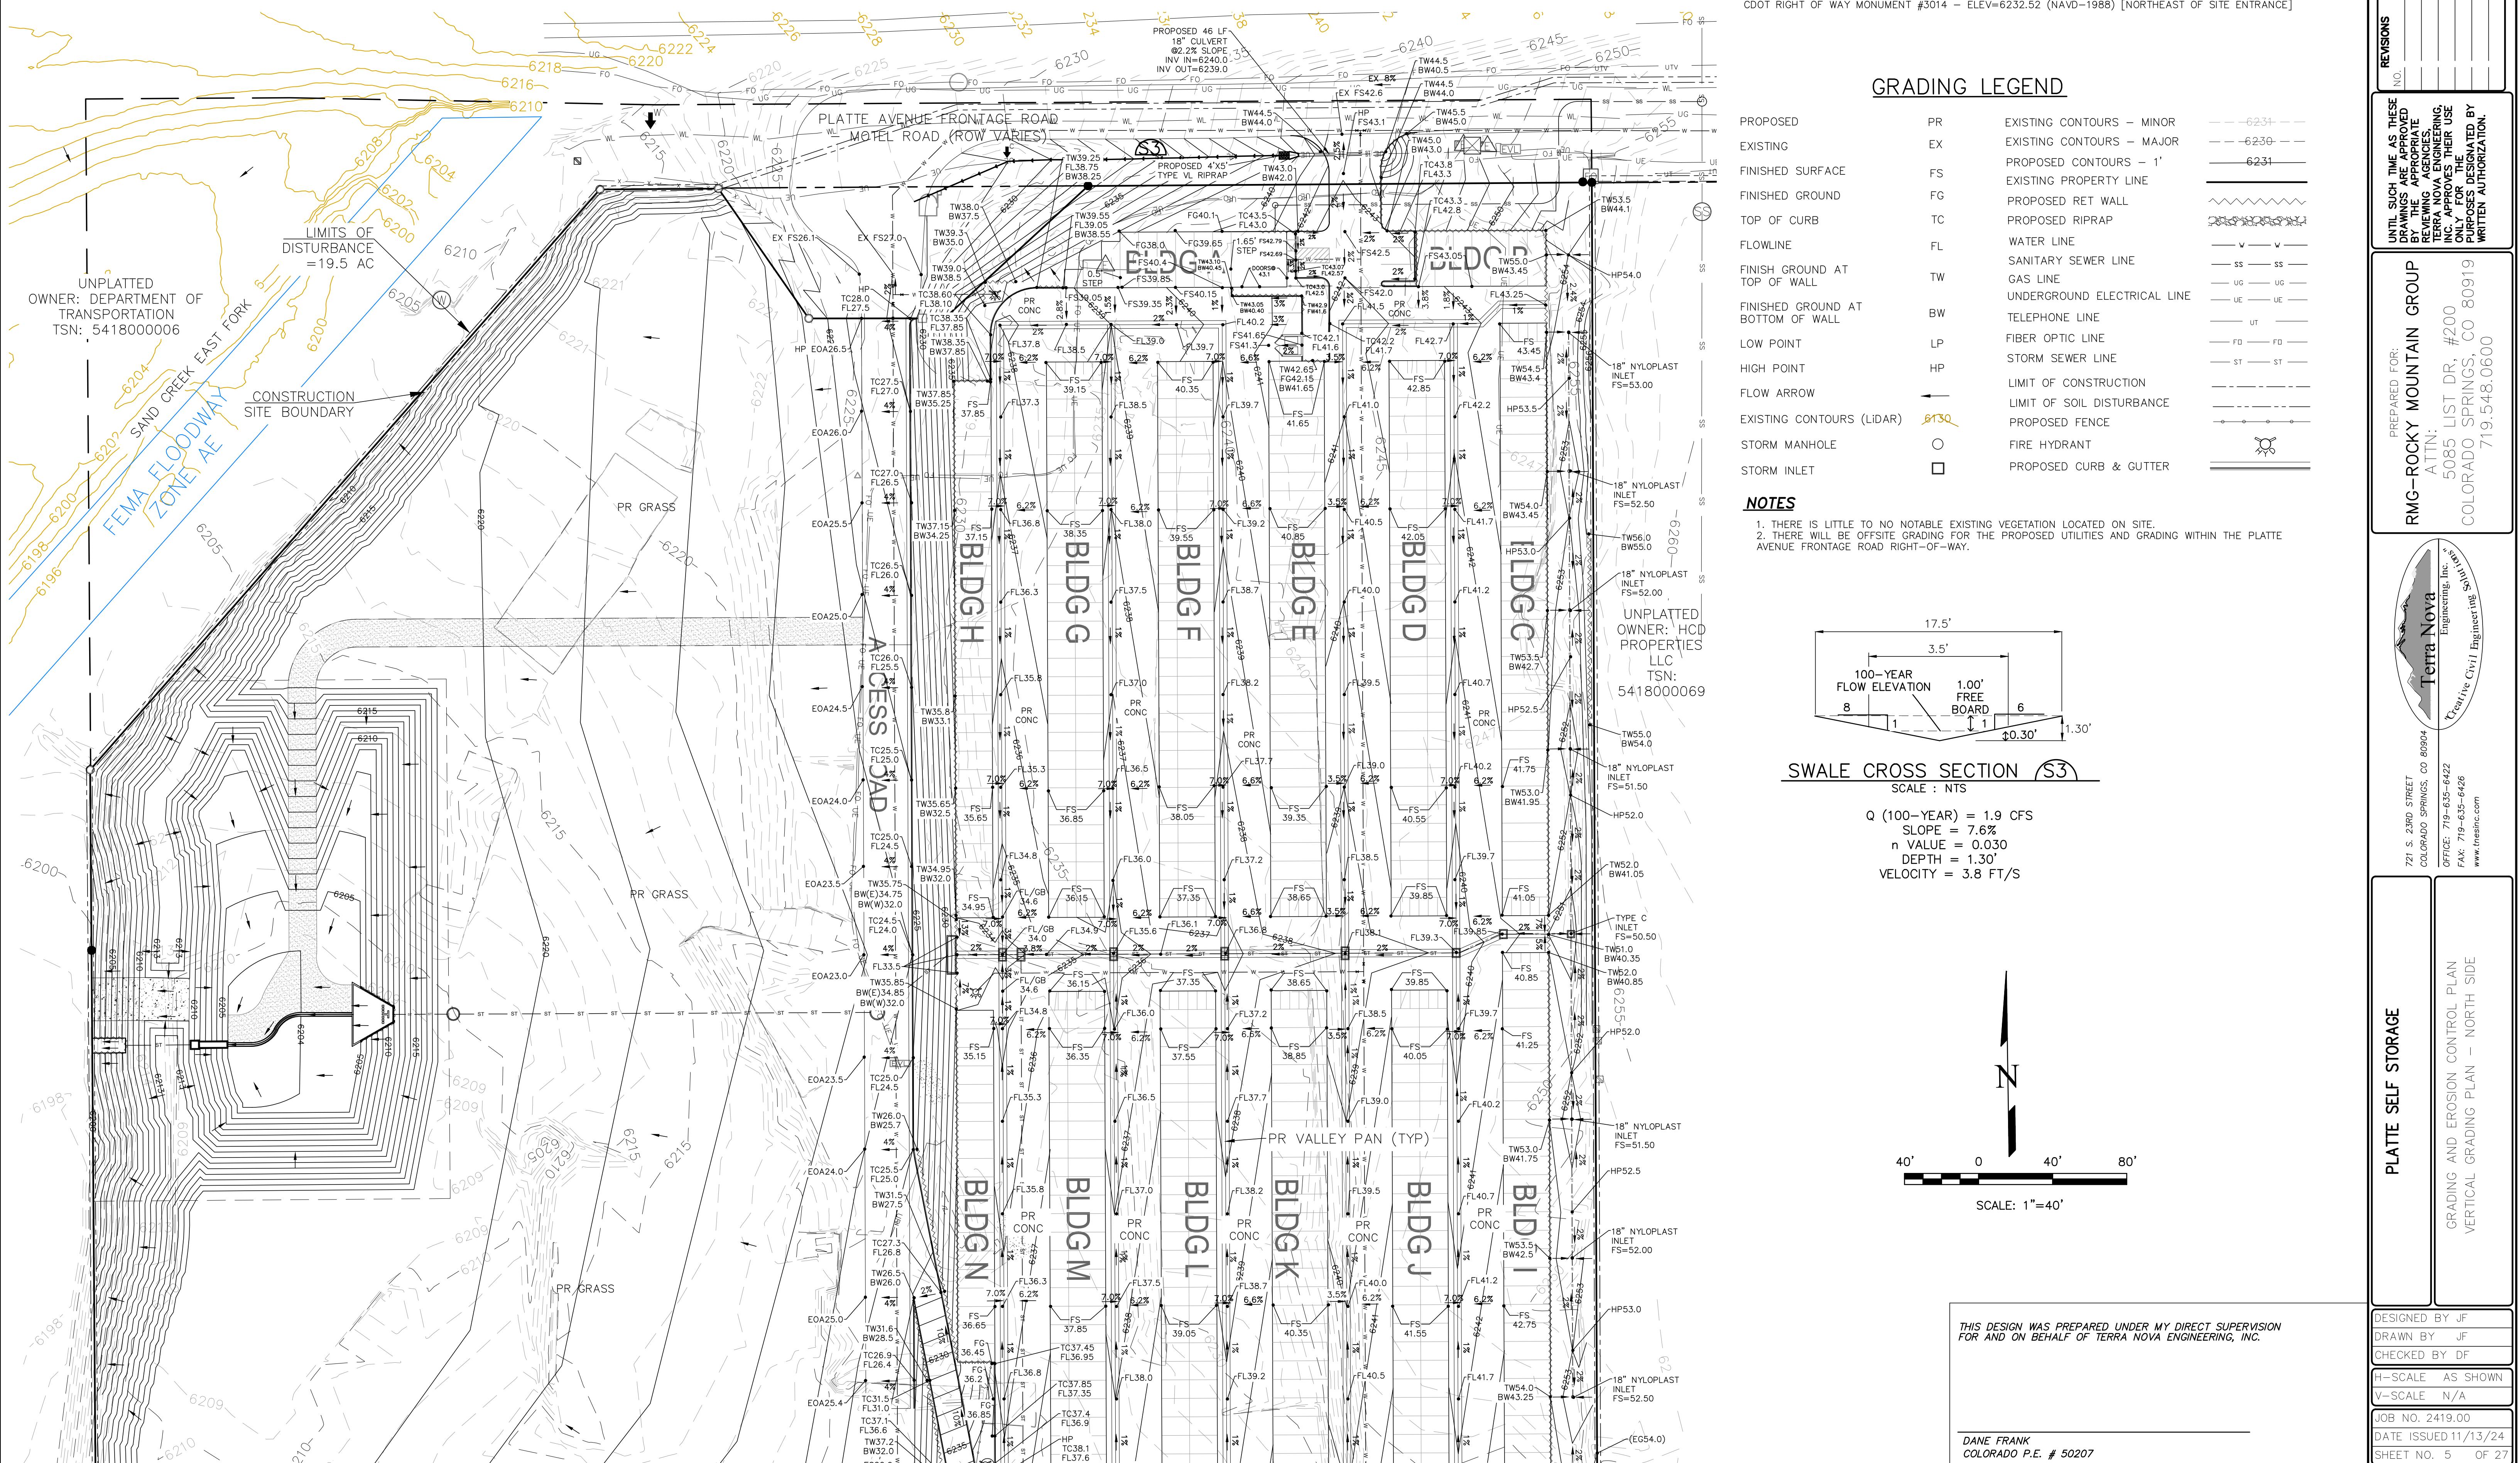

PLATTE SELF STORAGE

GRADING AND EROSION CONTROL PLAN

FINAL GRADING PLAN - SOUTH SIDE


NOVEMBER 2024

BENCHMARKS
CDOT RIGHT OF WAY MONUMENT #3014 - ELEV=6232.52 (NAVD-1988) [NORTHEAST OF SITE ENTRANCE]

GRADING LEGEND

REVISIONS	DESCRIPTION	DATE
NO.		
Wavy line	EXISTING CONTOURS - MINOR	6231
Dash-dot line	EXISTING CONTOURS - MAJOR	6230
Long dashed line	PROPOSED CONTOURS - 1'	6231
Wavy line with dots	EXISTING PROPERTY LINE	
Wavy line with dots	PROPOSED RET WALL	
Wavy line with dots	PROPOSED RIPRAP	
Wavy line with dots	WATER LINE	
Wavy line with dots	SANITARY SEWER LINE	
Wavy line with dots	GAS LINE	
Wavy line with dots	UNDERGROUND ELECTRICAL LINE	
Wavy line with dots	TELEPHONE LINE	
Wavy line with dots	FIBER OPTIC LINE	
Wavy line with dots	STORM SEWER LINE	
Wavy line with dots	LIMIT OF CONSTRUCTION	
Wavy line with dots	LIMIT OF SOIL DISTURBANCE	
Wavy line with dots	PROPOSED FENCE	
Wavy line with dots	EXISTING CONTOURS (LIDAR)	8130
Circle with dot	FIRE HYDRANT	
Open square	PROPOSED CURB & GUTTER	


PREPARED FOR:
RMG-ROCKY MOUNTAIN GROUP
ATTN: 5085 LIST DR, #200
COLORADO SPRINGS, CO 80919
719.548.0600

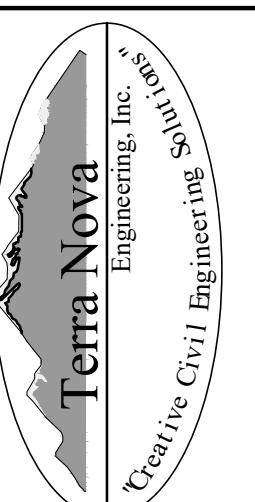





PLATTE SELF STORAGE

GRADING AND EROSION CONTROL PLAN
VERTICAL GRADING PLAN - SOUTH SIDE

DESIGNED BY JF
DRAWN BY JF
CHECKED BY DF
H-SCALE AS SHOWN
V-SCALE N/A
JOB NO. 2419.00
DATE ISSUED 11/13/24
SHEET NO. 6 OF 27

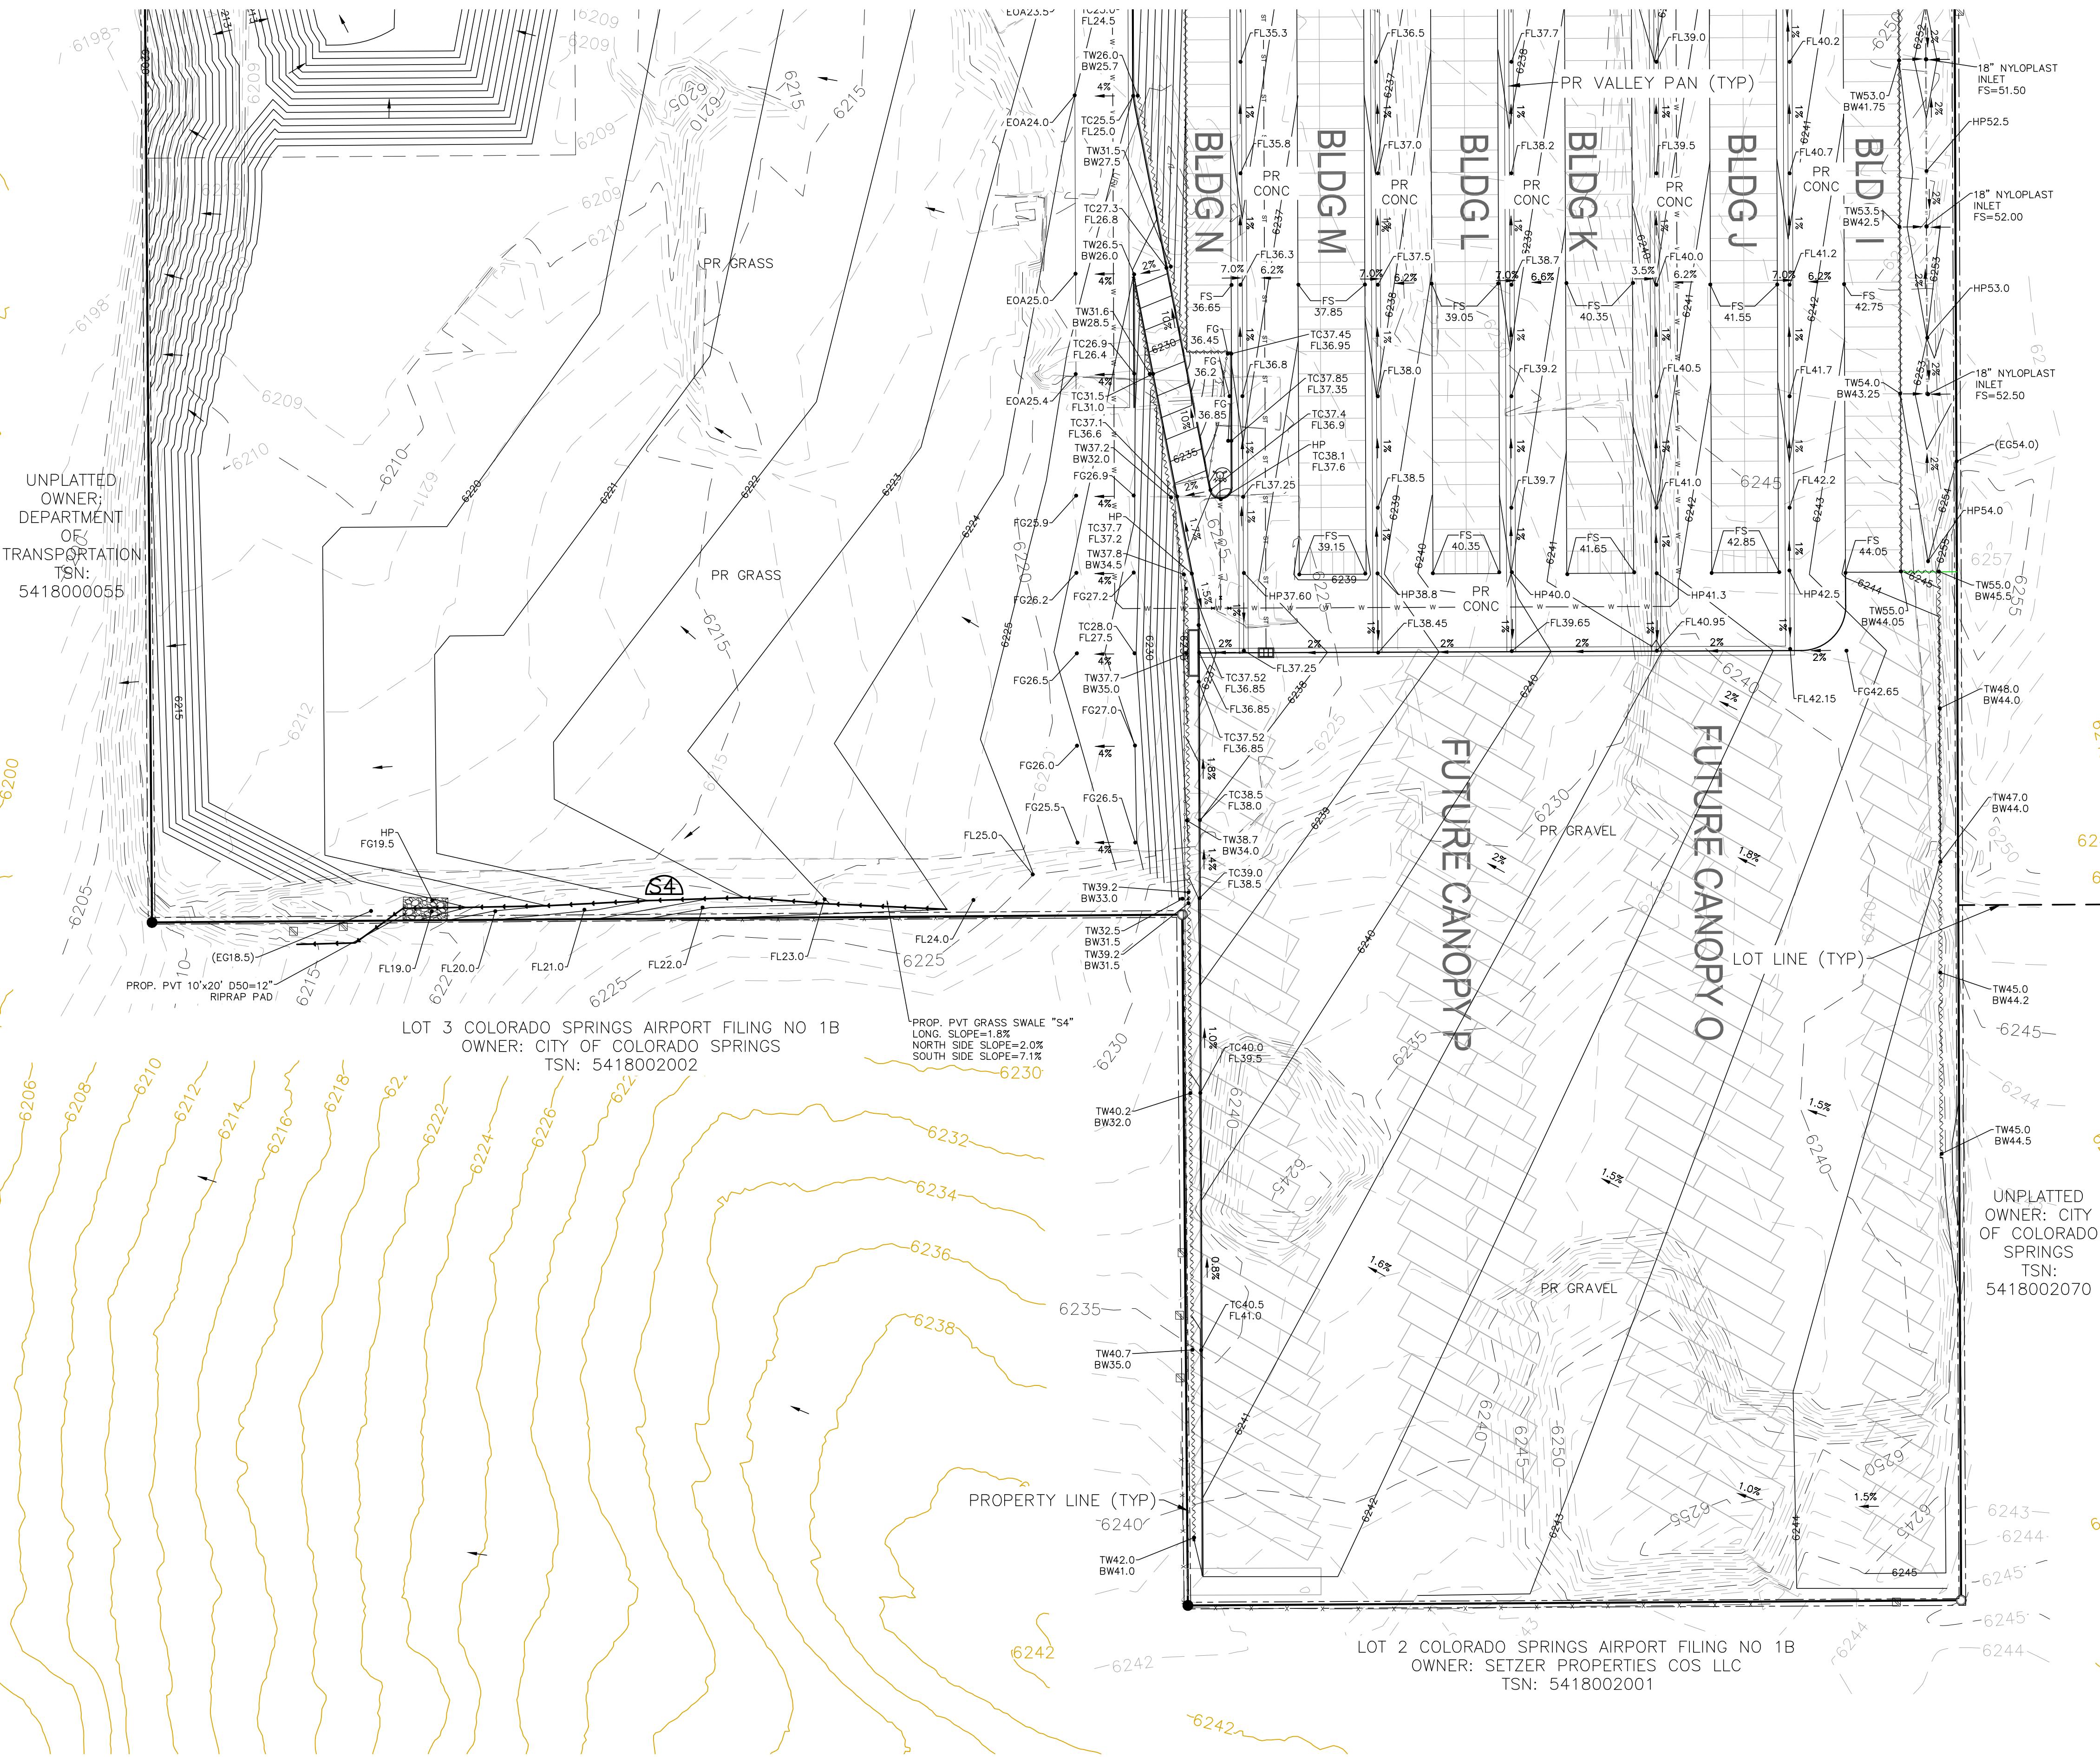

PLATTE SELF STORAGE
GRADING AND EROSION CONTROL PLAN
GRADING DETAILS SHEET
NOVEMBER 2024

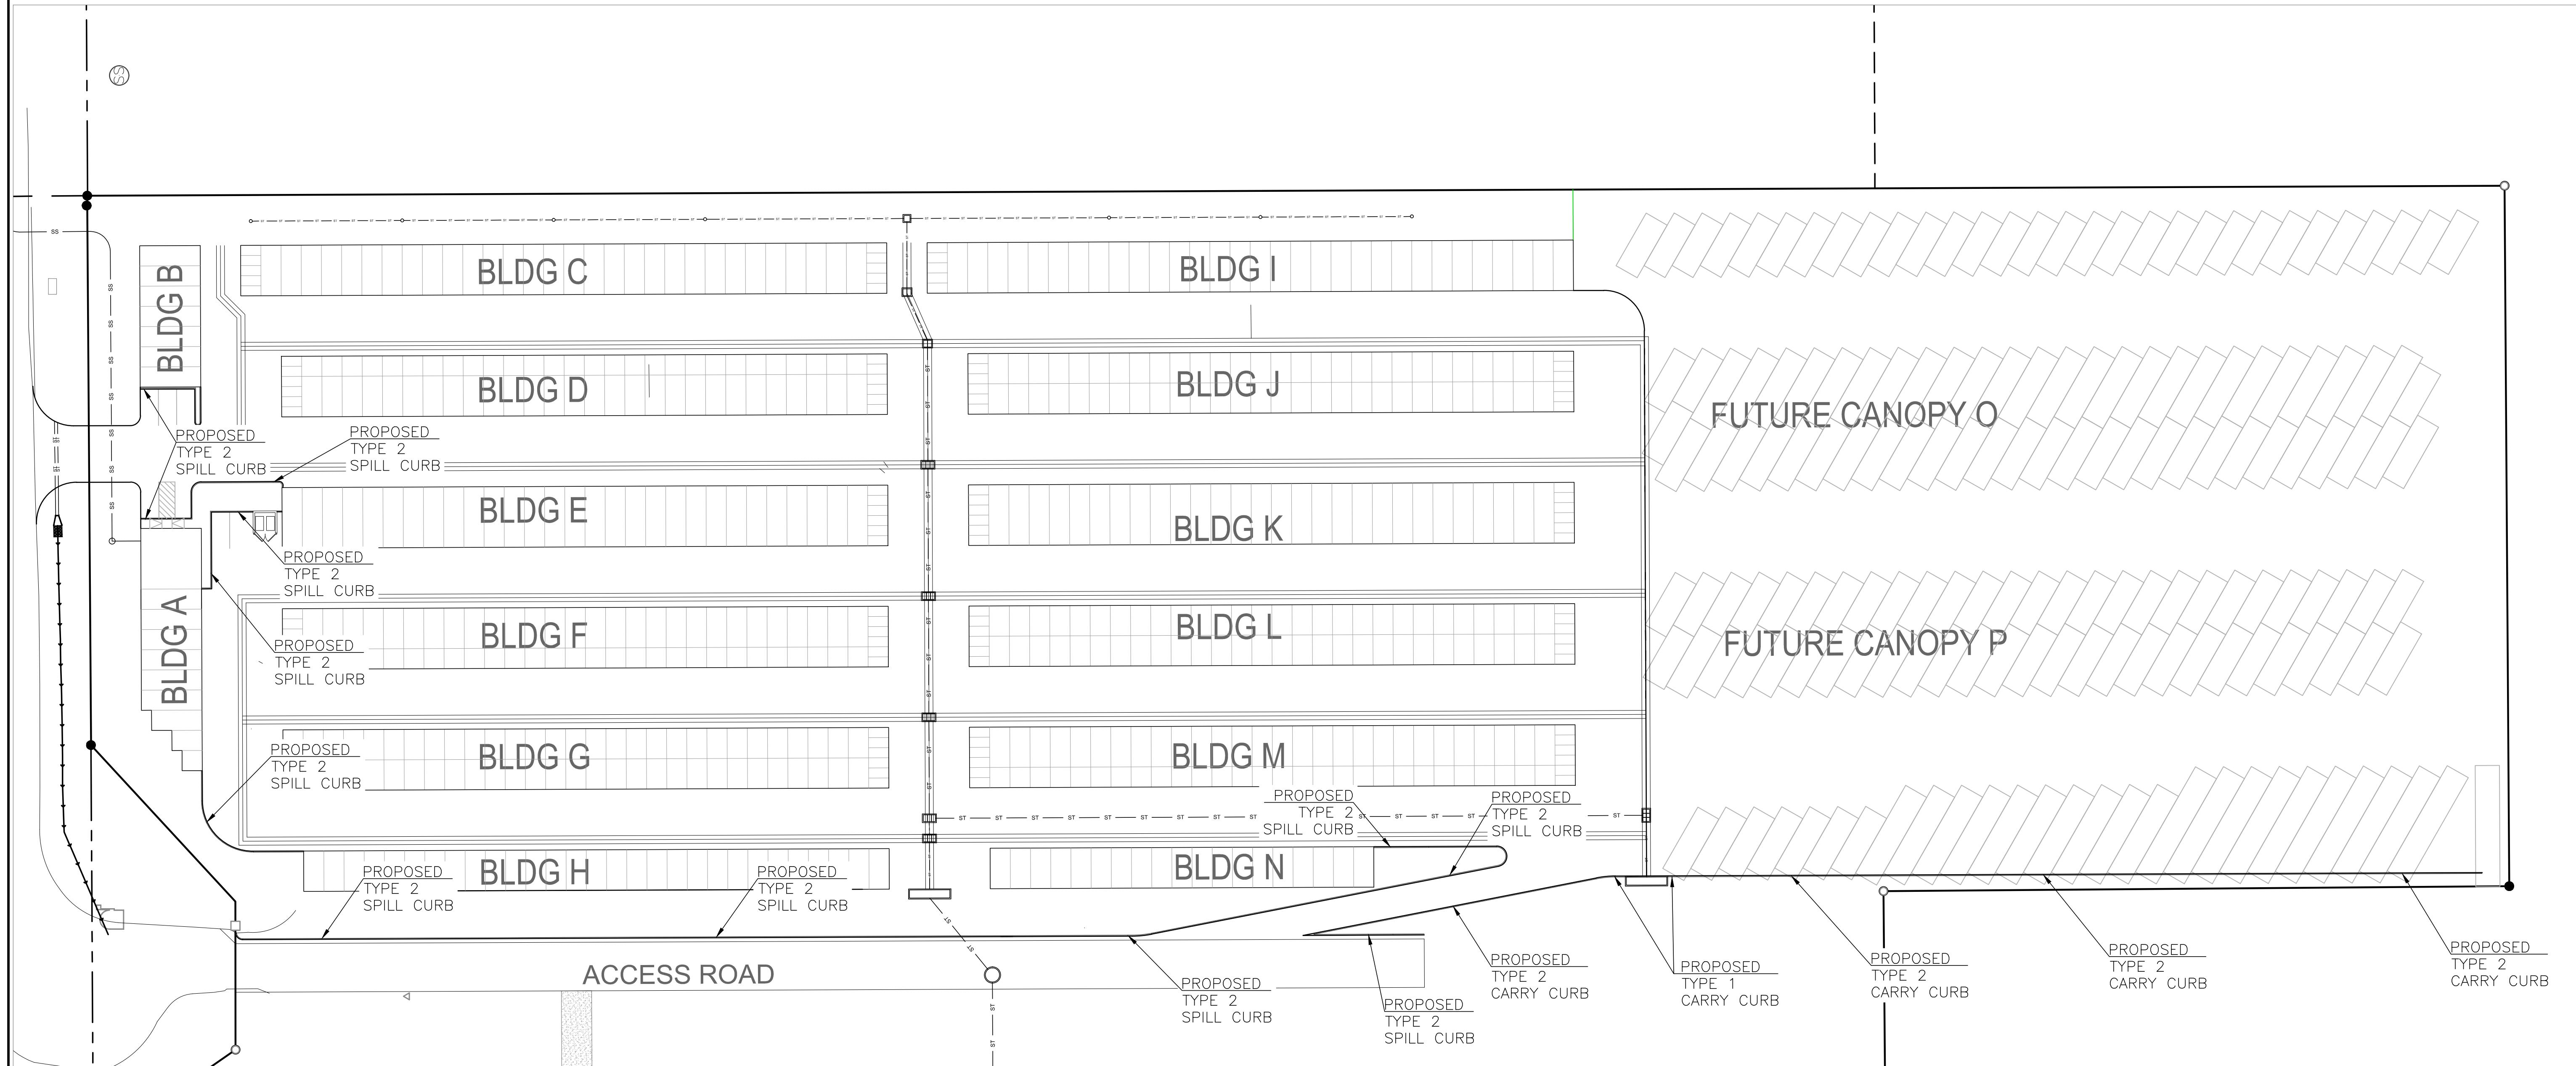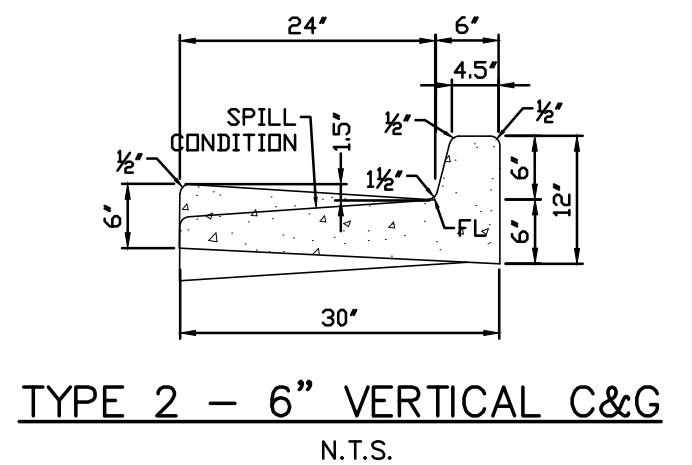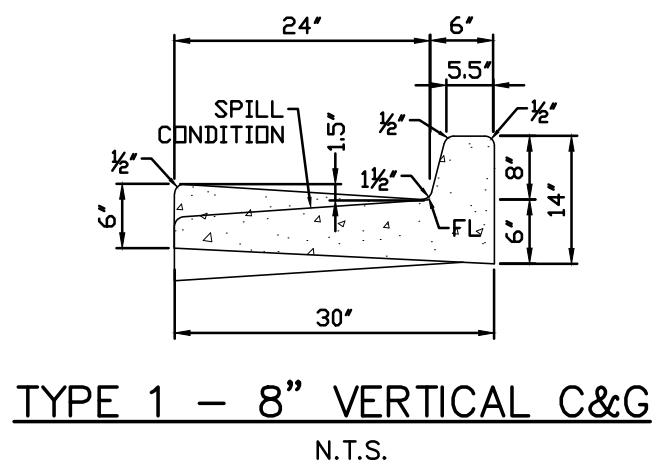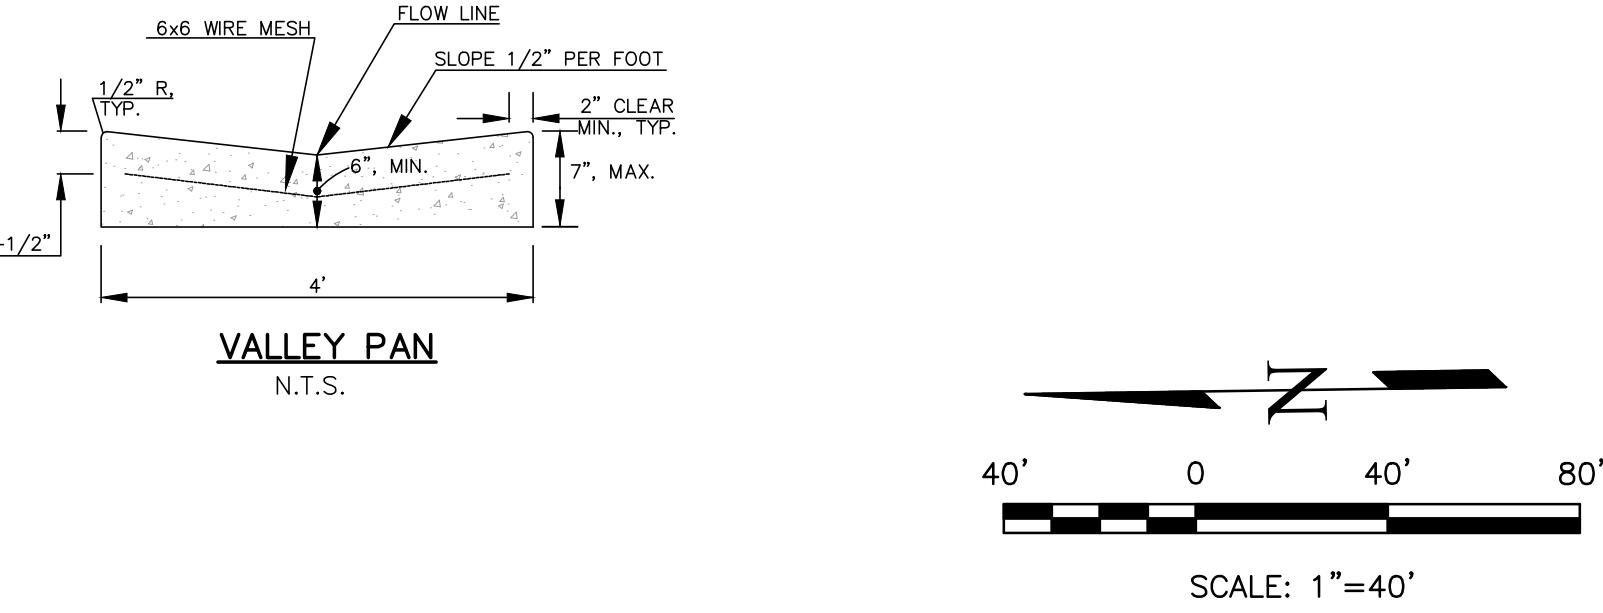


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DANE FRANK
COLORADO P.E. # 50207


REVISIONS	DESCRIPTION	DATE
NO. _____	_____	_____
UNTIL SUCH TIME AS THESE DRAWINGS ARE APPROVED BY THE APPROVING AGENCIES, TERRA NOVA ENGINEERING, INC. APPROVES THEIR USE ONLY FOR THE PURPOSES DESIGNATED BY WRITTEN AUTHORIZATION.		

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ATTN: 5085 LIST DR, #200
COLORADO SPRINGS, CO 80919
719.548.0600

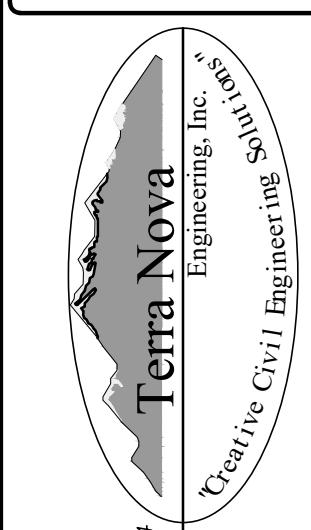

PLATTE SELF STORAGE
GRADING AND EROSION CONTROL PLAN
GRADING DETAILS

DESIGNED BY JF
DRAWN BY JF
CHECKED BY DF
H-SCALE AS SHOWN
V-SCALE N/A
JOB NO. 2419.00
DATE ISSUED 11/13/24
SHEET NO. 7 OF 27

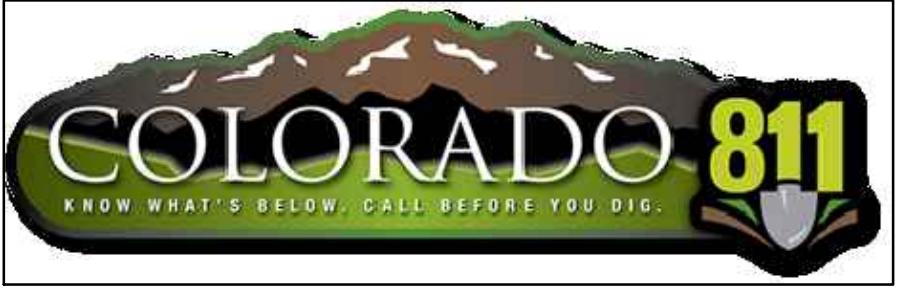

PLATTE SELF STORAGE GRADING AND EROSION CONTROL PLAN INITIAL GRADING & EROSION CONTROL - NORTH SIDE NOVEMBER 2024

BENCHMARKS

CDOT RIGHT OF WAY MONUMENT #3014 – ELEV=6232.52 (NAVD-1988) [NORTHEAST OF SITE ENTRANCE]



GRADING LEGEND

PR	EXISTING CONTOURS – MINOR	— 6231 —
EX	EXISTING CONTOURS – MAJOR	— 6230 —
FS	PROPOSED CONTOURS – 1'	6231
FG	EXISTING PROPERTY LINE	~~~~~
TC	PROPOSED RET WALL	██████
FL	PROPOSED RIPRAP	████████
WL	WATER LINE	— v —
FO	SANITARY SEWER LINE	— ss —
UG	GAS LINE	— ug —
WL	UNDERGROUND ELECTRICAL LINE	— ue —
WL	TELEPHONE LINE	— ue —
WL	LOW POINT	— ut —
LP	HIGH POINT	— fd —
HP	FLOW ARROW	— st —
—	LIMIT OF CONSTRUCTION	— st —
—	LIMIT OF SOIL DISTURBANCE	— st —
—	EXISTING CONTOURS (LIDAR)	— st —
—	PROPOSED FENCE	— st —
—	STORM MANHOLE	○
—	FIRE HYDRANT	□
—	STORM INLET	— st —

NOTES

1. THERE IS LITTLE TO NO NOTABLE EXISTING VEGETATION LOCATED ON SITE.
2. THERE WILL BE OFFSITE GRADING FOR THE PROPOSED UTILITIES AND GRADING WITHIN THE PLATTE AVENUE FRONTAGE ROAD, RIGHT-OF-WAY.
3. THE COUNTY HAS REQUIRED AN INITIAL GRADING PLAN. THIS INITIAL GRADING IS A POOR FIT FOR THE PROPOSED SITE DUE TO THE LARGE NUMBER OF TALL RETAINING WALLS PROPOSED. THE DESIGN ENGINEER DOES NOT CONSIDER MATCHING THE INITIAL GRADING PLAN TO BE CRITICAL AND RECOMMENDS THE CONTRACTOR PRIORITIZE CONSTRUCTION OF THE RETAINING WALLS AND THE VERTICAL GRADING PLAN OVER THE INITIAL GRADING PLAN.
4. SEED AND MULCH DISTURBED AREAS ONLY.
5. SEDIMENT CONTROL LOGS MAY BE SUBSTITUTED FOR SILT FENCE AND VICE VERSA.


EROSION CONTROL LEGEND

KEY	TITLE	SYMBOL	IMPLEMENTATION PHASE
SF	SILT FENCE	— SF —	INITIAL
SSA	STABILIZED STAGING AREA	[Stabilized Area Symbol]	INITIAL
VTC	VEHICLE TRACKING CONTROL	[Vehicle Tracking Control Symbol]	INITIAL
SP	STOCKPILE MANAGEMENT WITH PROTECTION	[Stockpile Management Symbol]	INITIAL
CWA	CONCRETE WASHOUT AREA	[Concrete Washout Area Symbol]	INITIAL
SR	SURFACE ROUGHENING	[Surface Roughening Symbol]	INITIAL
TSB	TEMPORARY SEDIMENT BASIN	NONE	INITIAL
PT	PORTABLE TOILET	NONE	INITIAL

Unresolved from Submittal 2:
Please include full limits of construction within the view, it appears to extend further to the east.

Utility work should be shown on the GEC Plans and BMPs should be implemented for those areas as well. The full limits of construction need BMPs and to be shown.

See new sheet #10

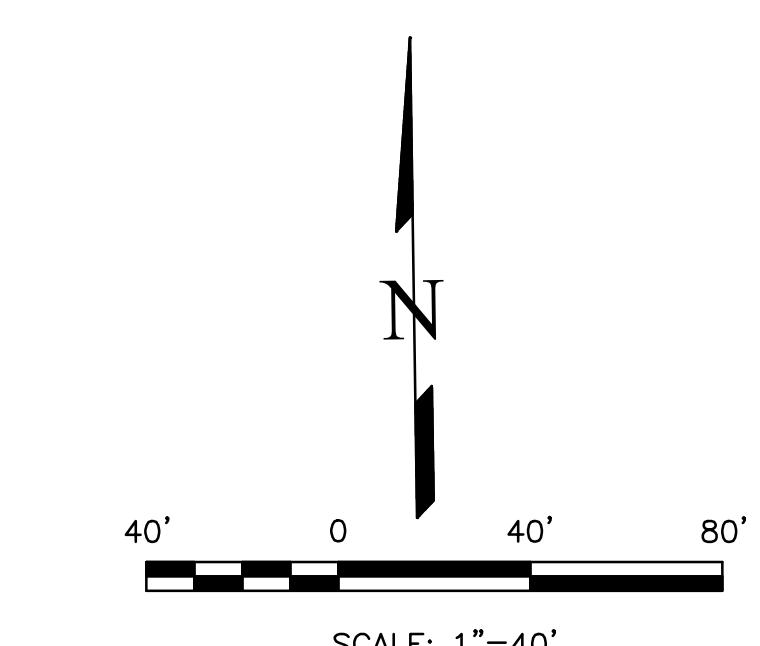


UNPLATTED
OWNER: HCD
PROPERTIES
LLC
TSN:
5418000069

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DANE FRANK
COLORADO P.E. # 50207

PREPARED FOR:	RMG-ROCKY MOUNTAIN GROUP
ATTN:	5085 LIST DR, #200
	COLORADO SPRINGS, CO 80919
	719.548.0600
REVISIONS	UNTIL SUCH TIME AS THESE DRAWINGS ARE APPROVED BY THE APPROPRIATE REVIEWING AGENCIES, INC. APPROVES THEIR USE ONLY FOR THE PURPOSES DESIGNATED BY WRITTEN AUTHORIZATION.
DESIGNER:	Terra Nova Engineering, Inc. Civil/Pre-Construction Services
OFFICE:	719.535-6422
FAX:	719-535-6426
www.tresinc.com	
PLATTE SELF STORAGE	
GRADING AND EROSION CONTROL PLAN	
INITIAL – NORTH SIDE	
DESIGNED BY JF	DRAWN BY JF
CHECKED BY DF	H-SCALE AS SHOWN
V-SCALE N/A	JOB NO. 2419.00
DATE ISSUED 11/13/24	SHEET NO. 8 OF 27

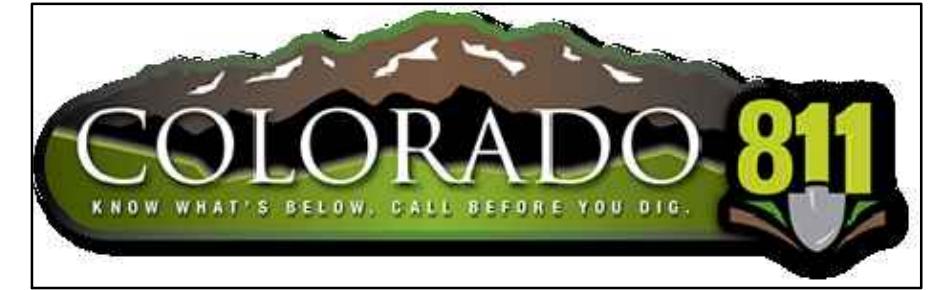


PLATTE SELF STORAGE GRADING AND EROSION CONTROL PLAN INITIAL GRADING & EROSION CONTROL PLAN - SOUTH SIDE

NOVEMBER 2024

BENCHMARKS

CDOT RIGHT OF WAY MONUMENT #3014 - ELEV=6232.52 (NAVD-1988) [NORTHEAST OF SITE ENTRANCE]

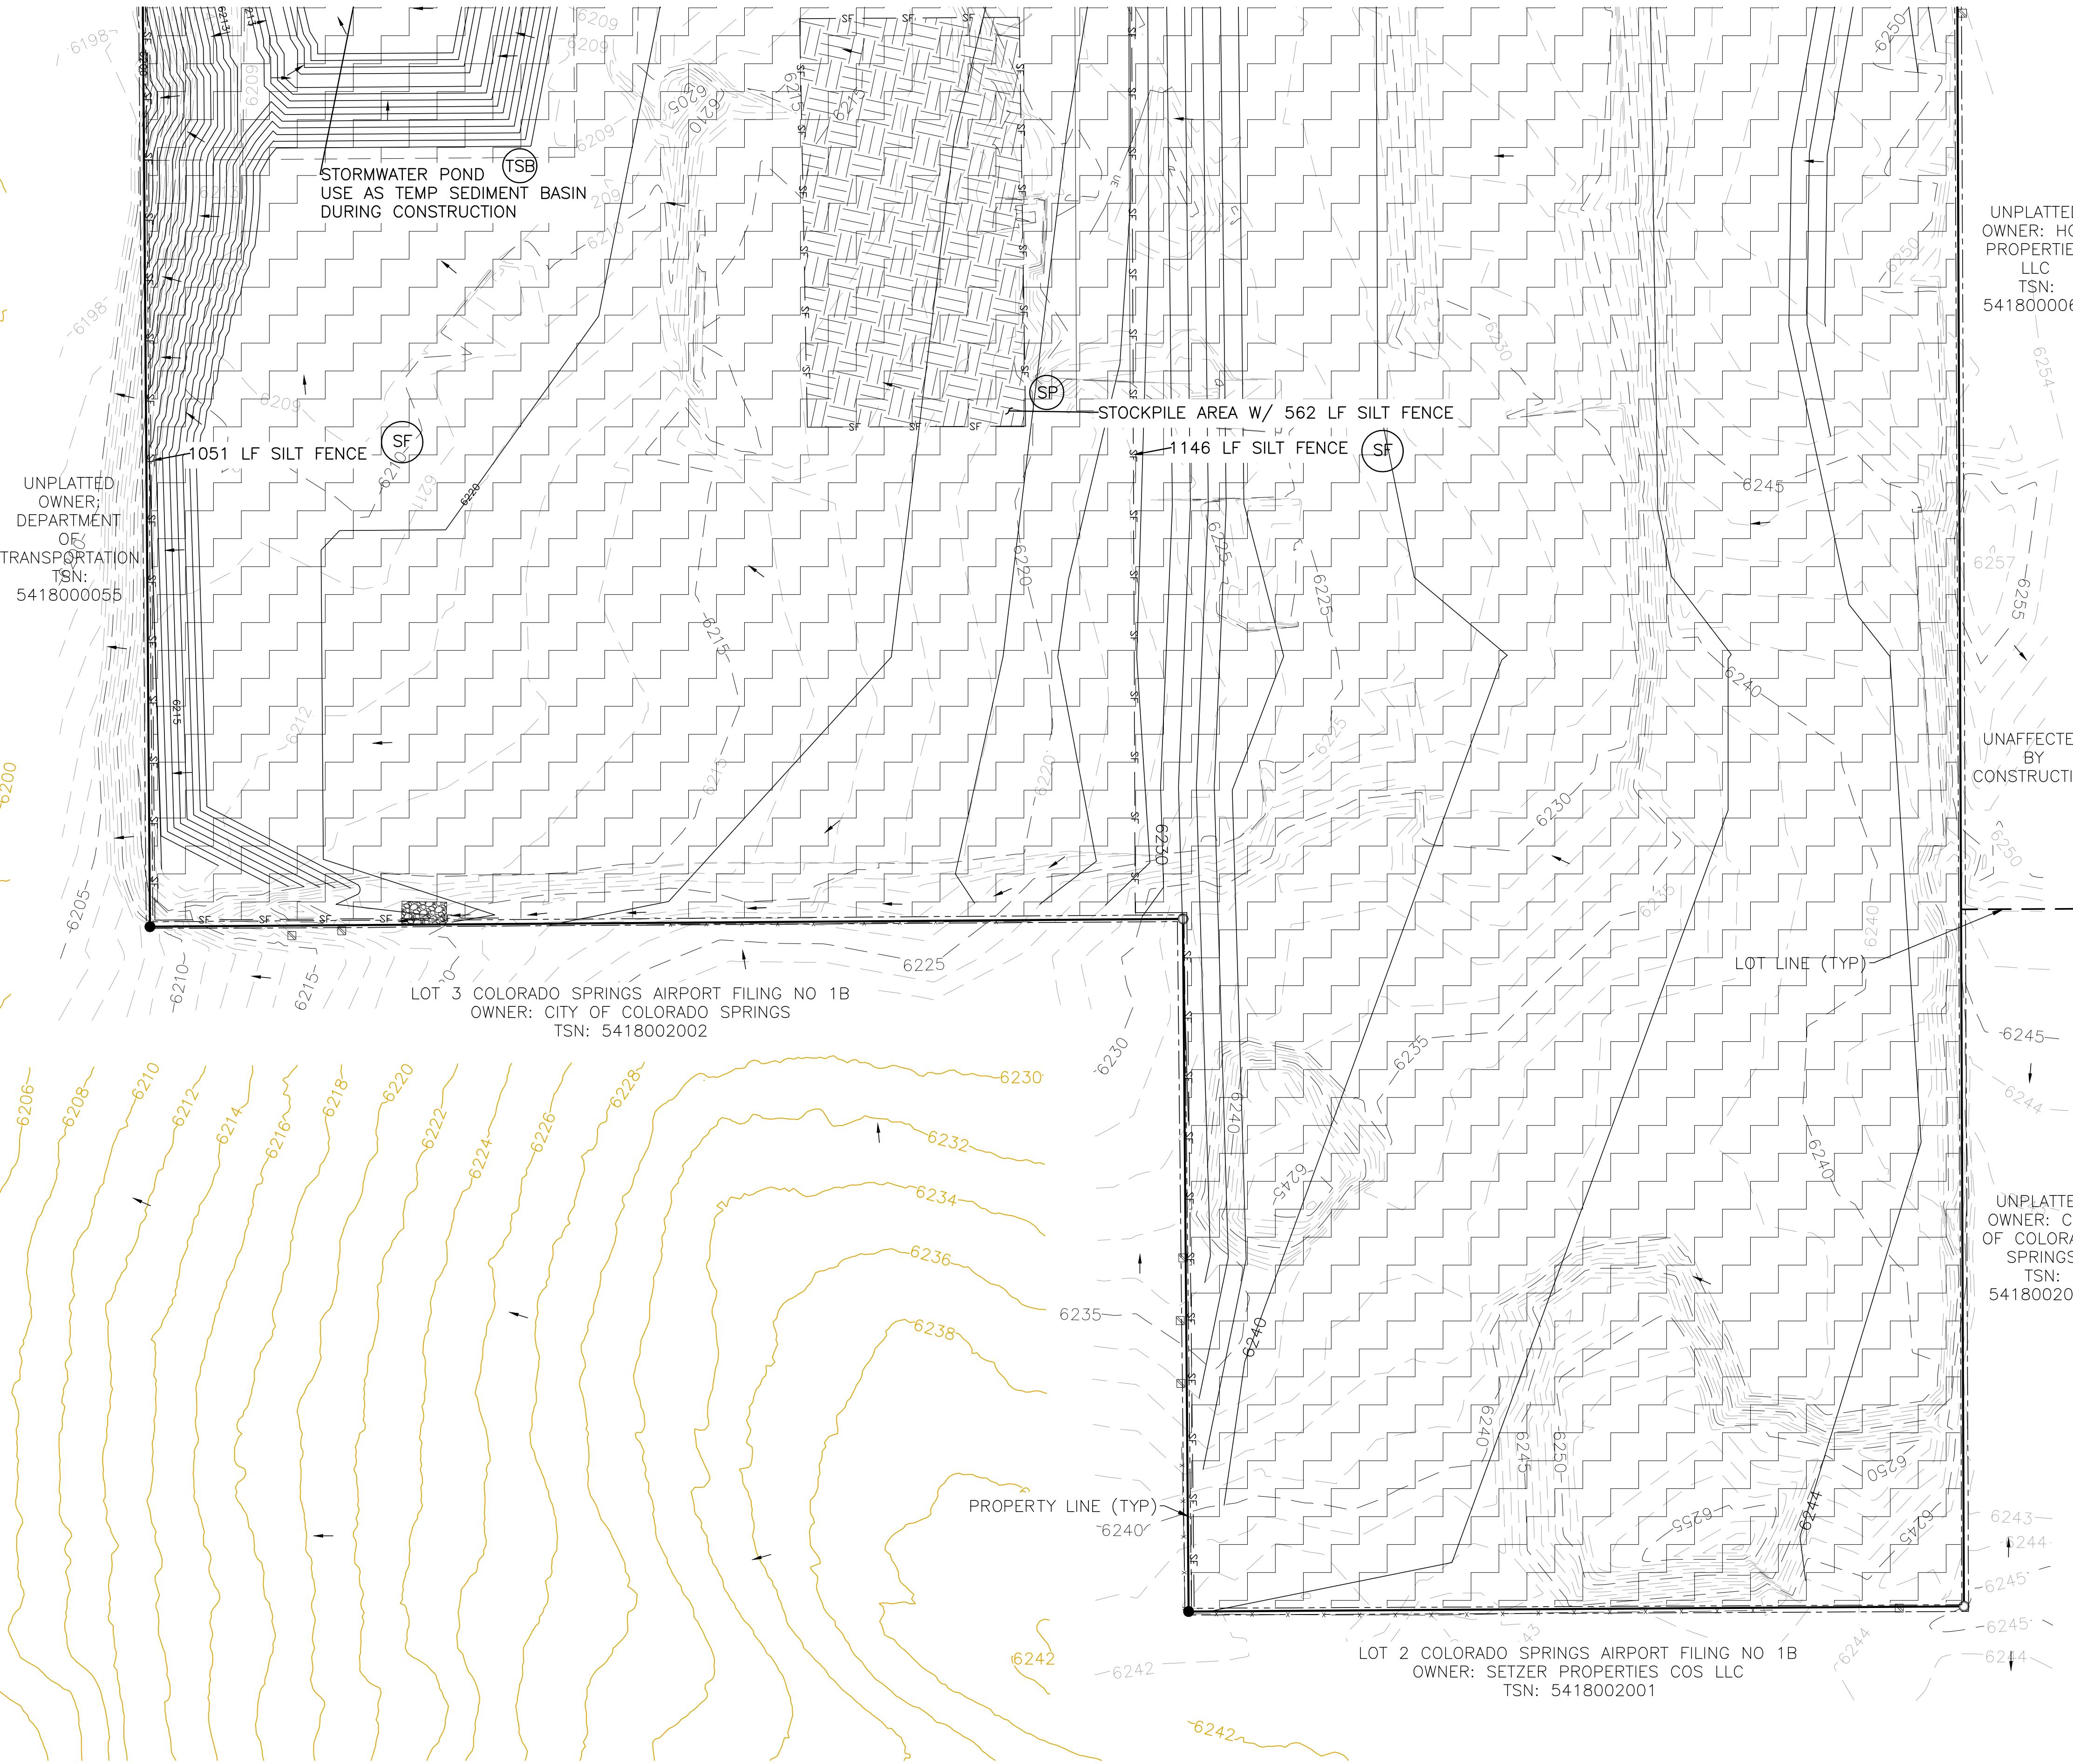

GRADING LEGEND


PROPOSED	PR	EXISTING CONTOURS - MINOR
EXISTING	EX	EXISTING CONTOURS - MAJOR
FINISHED SURFACE	FS	PROPOSED CONTOURS - 1'
FINISHED GROUND	FG	EXISTING PROPERTY LINE
TOP OF CURB	TC	PROPOSED RET WALL
FLOWLINE	FL	PROPOSED RIPRAP
		WATER LINE
		SANITARY SEWER LINE
		GAS LINE
		UNDERGROUND ELECTRICAL LINE
		TELEPHONE LINE
		FIBER OPTIC LINE
		STORM SEWER LINE
		LIMIT OF CONSTRUCTION
		LIMIT OF SOIL DISTURBANCE
		PROPOSED FENCE
		STORM MANHOLE
		FIRE HYDRANT
		PROPOSED CURB & GUTTER

NOTES

1. THERE IS LITTLE TO NO NOTABLE EXISTING VEGETATION LOCATED ON SITE.
2. THERE WILL BE OFFSITE GRADING FOR THE PROPOSED UTILITIES AND GRADING WITHIN THE PLATTE AVENUE FRONTAGE ROAD RIGHT-OF-WAY.
3. THE COUNTY HAS REQUIRED AN INITIAL GRADING PLAN. THIS INITIAL GRADING IS A POOR FIT FOR THE PROPOSED SITE DUE TO THE LARGE NUMBER OF TALL RETAINING WALLS PROPOSED. THE DESIGN ENGINEER DOES NOT CONSIDER MATCHING THE INITIAL GRADING PLAN TO BE CRITICAL AND RECOMMENDS THE CONTRACTOR PRIORITIZE CONSTRUCTION OF THE RETAINING WALLS AND THE VERTICAL GRADING PLAN OVER THE INITIAL GRADING PLAN.
4. SEDIMENT CONTROL LOGS MAY BE SUBSTITUTED FOR SILT FENCE AND VICE VERSA.

EROSION CONTROL LEGEND

KEY	TITLE	SYMBOL	IMPLEMENTATION PHASE
SF	SILT FENCE	— SF —	INITIAL
SSA	STABILIZED STAGING AREA	[Hatched Box]	INITIAL
VTC	VEHICLE TRACKING CONTROL	[Hatched Pattern]	INITIAL
SP	STOCKPILE MANAGEMENT W/ PROTECTION	[Hatched Box with Protection]	INITIAL
CWA	CONCRETE WASHOUT AREA	[Oval]	INITIAL
SR	SURFACE ROUGHENING	[Hatched Pattern]	INITIAL
TBB	TEMPORARY SEDIMENT BASIN	NONE	INITIAL
PT	PORTABLE TOILET	NONE	INITIAL

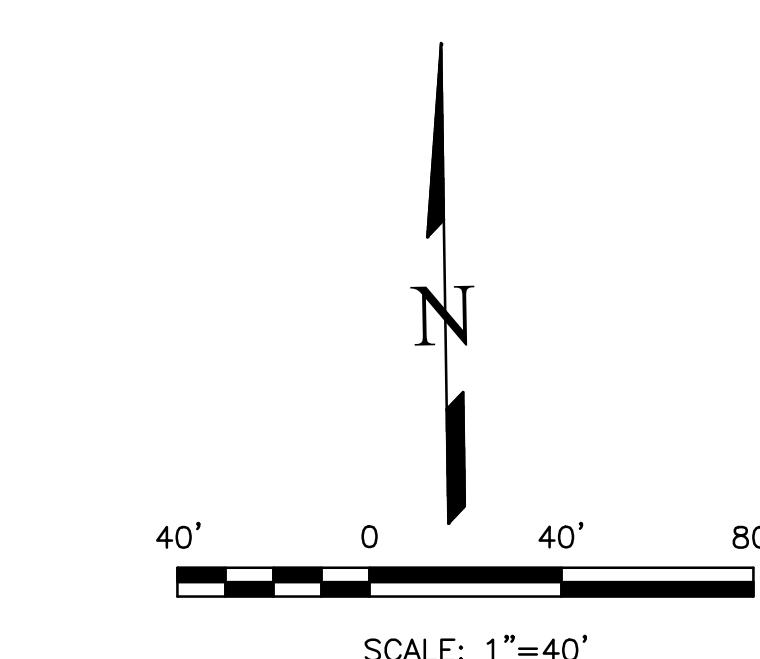

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FOR AND ON BEHALF OF TERRA NOVA ENGINEERING, INC.

DANE FRANK
COLORADO P.E. # 50207

PREPARED FOR:	RMG-ROCKY MOUNTAIN GROUP
ATTN:	5085 LIST DR, #200
	COLORADO SPRINGS, CO 80919
	719-548-0600
DESIGNED BY:	JF
DRAWN BY:	JF
CHECKED BY:	DF
H-SCALE AS SHOWN	
V-SCALE:	N/A
JOB NO.:	2419.00
DATE ISSUED:	11/13/24
SHEET NO.:	9 OF 27

**PLATTE SELF STORAGE
GRADING AND EROSION CONTROL PLAN
INTERIM EC PLAN - NORTH SIDE
NOVEMBER 2024**

BENCHMARKS


CDOT RIGHT OF WAY MONUMENT #3014 – ELEV=6232.52 (NAVD-1988) [NORTHEAST OF SITE ENTRANCE]

GRADING LEGEND

REVISIONS NO.	DESCRIPTION	DATE
PR	EXISTING CONTOURS – MINOR	— 6231 —
EX	EXISTING CONTOURS – MAJOR	— 6230 —
FS	PROPOSED CONTOURS – 1'	— 6231 —
FG	EXISTING PROPERTY LINE	~~~~~
TC	PROPOSED RET WALL	—○—
FO	PROPOSED RIPRAP	—×—
FL	WATER LINE	—v—
WL	SANITARY SEWER LINE	—ss—
UG	GAS LINE	—ug—
UE	UNDERGROUND ELECTRICAL LINE	—ue—
TW	TELEPHONE LINE	—t—
BW	FIBER OPTIC LINE	—fo—
LP	STORM SEWER LINE	—st—
HP	LIMIT OF CONSTRUCTION	—l—
VTC	LIMIT OF SOIL DISTURBANCE	—o—
SCL	PROPOSED FENCE	—□—
SMH	STORM MANHOLE	—x—
VTC	STORM INLET	—x—

UNTIL SUCH TIME AS THESE DRAWINGS ARE APPROVED BY THE APPROPRIATE REVIEWING AGENCIES, INC. APPROVES THEIR USE ONLY FOR THE PURPOSES DESIGNATED BY WRITTEN AUTHORIZATION.

PREPARED FOR:
RMG–ROCKY MOUNTAIN GROUP
ATTN: DR. #200
5085 LIST DR.
COLORADO SPRINGS, CO 80919
719.548.0600

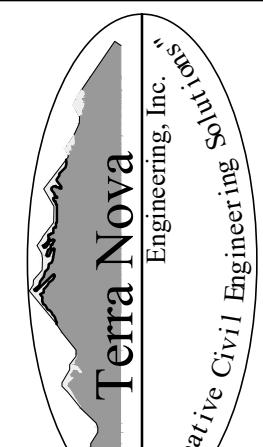

271 S. 2ND STREET
COLORADO SPRINGS, CO 80904
OFFICE: 719-535-6422
FAX: 719-535-6426
www.tresinc.com

PLATTE SELF STORAGE

GRADING AND EROSION CONTROL PLAN – NORTH SIDE
INTERIM EROSION CONTROL PLAN – NORTH SIDE

EROSION CONTROL LEGEND

KEY	TITLE	SYMBOL	IMPLEMENTATION PHASE
SF	SILT FENCE	— SF —	INITIAL
SSA	STABILIZED STAGING AREA	[Stippled Box]	INITIAL
VTC	VEHICLE TRACKING CONTROL	[Hatched Box]	INITIAL
SP	STOCKPILE MANAGEMENT WITH PROTECTION	[Hatched Box]	INITIAL
CWA	CONCRETE WASHOUT AREA	[Oval]	INITIAL
TBB	TEMPORARY SEDIMENT BASIN	NONE	INITIAL
PT	PORTABLE TOILET	NONE	INITIAL
SCL	SEDIMENT CONTROL LOG	— SCL —	INTERIM
IP	INLET PROTECTION	□	INTERIM


NOTES

1. SEDIMENT CONTROL LOGS MAY BE SUBSTITUTED FOR SILT FENCE AND VICE VERSA.
2. SEED AND MULCH DISTURBED AREAS ONLY.
3. THERE IS LITTLE TO NO NOTABLE EXISTING VEGETATION LOCATED ON SITE.
4. THERE WILL BE OFFSITE GRADING FOR THE PROPOSED UTILITIES AND GRADING WITHIN THE PLATTE AVENUE FRONTAGE ROAD RIGHT-OF-WAY.


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COLORADO P.E. # 50207

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SHEET NO. 10 OF 27

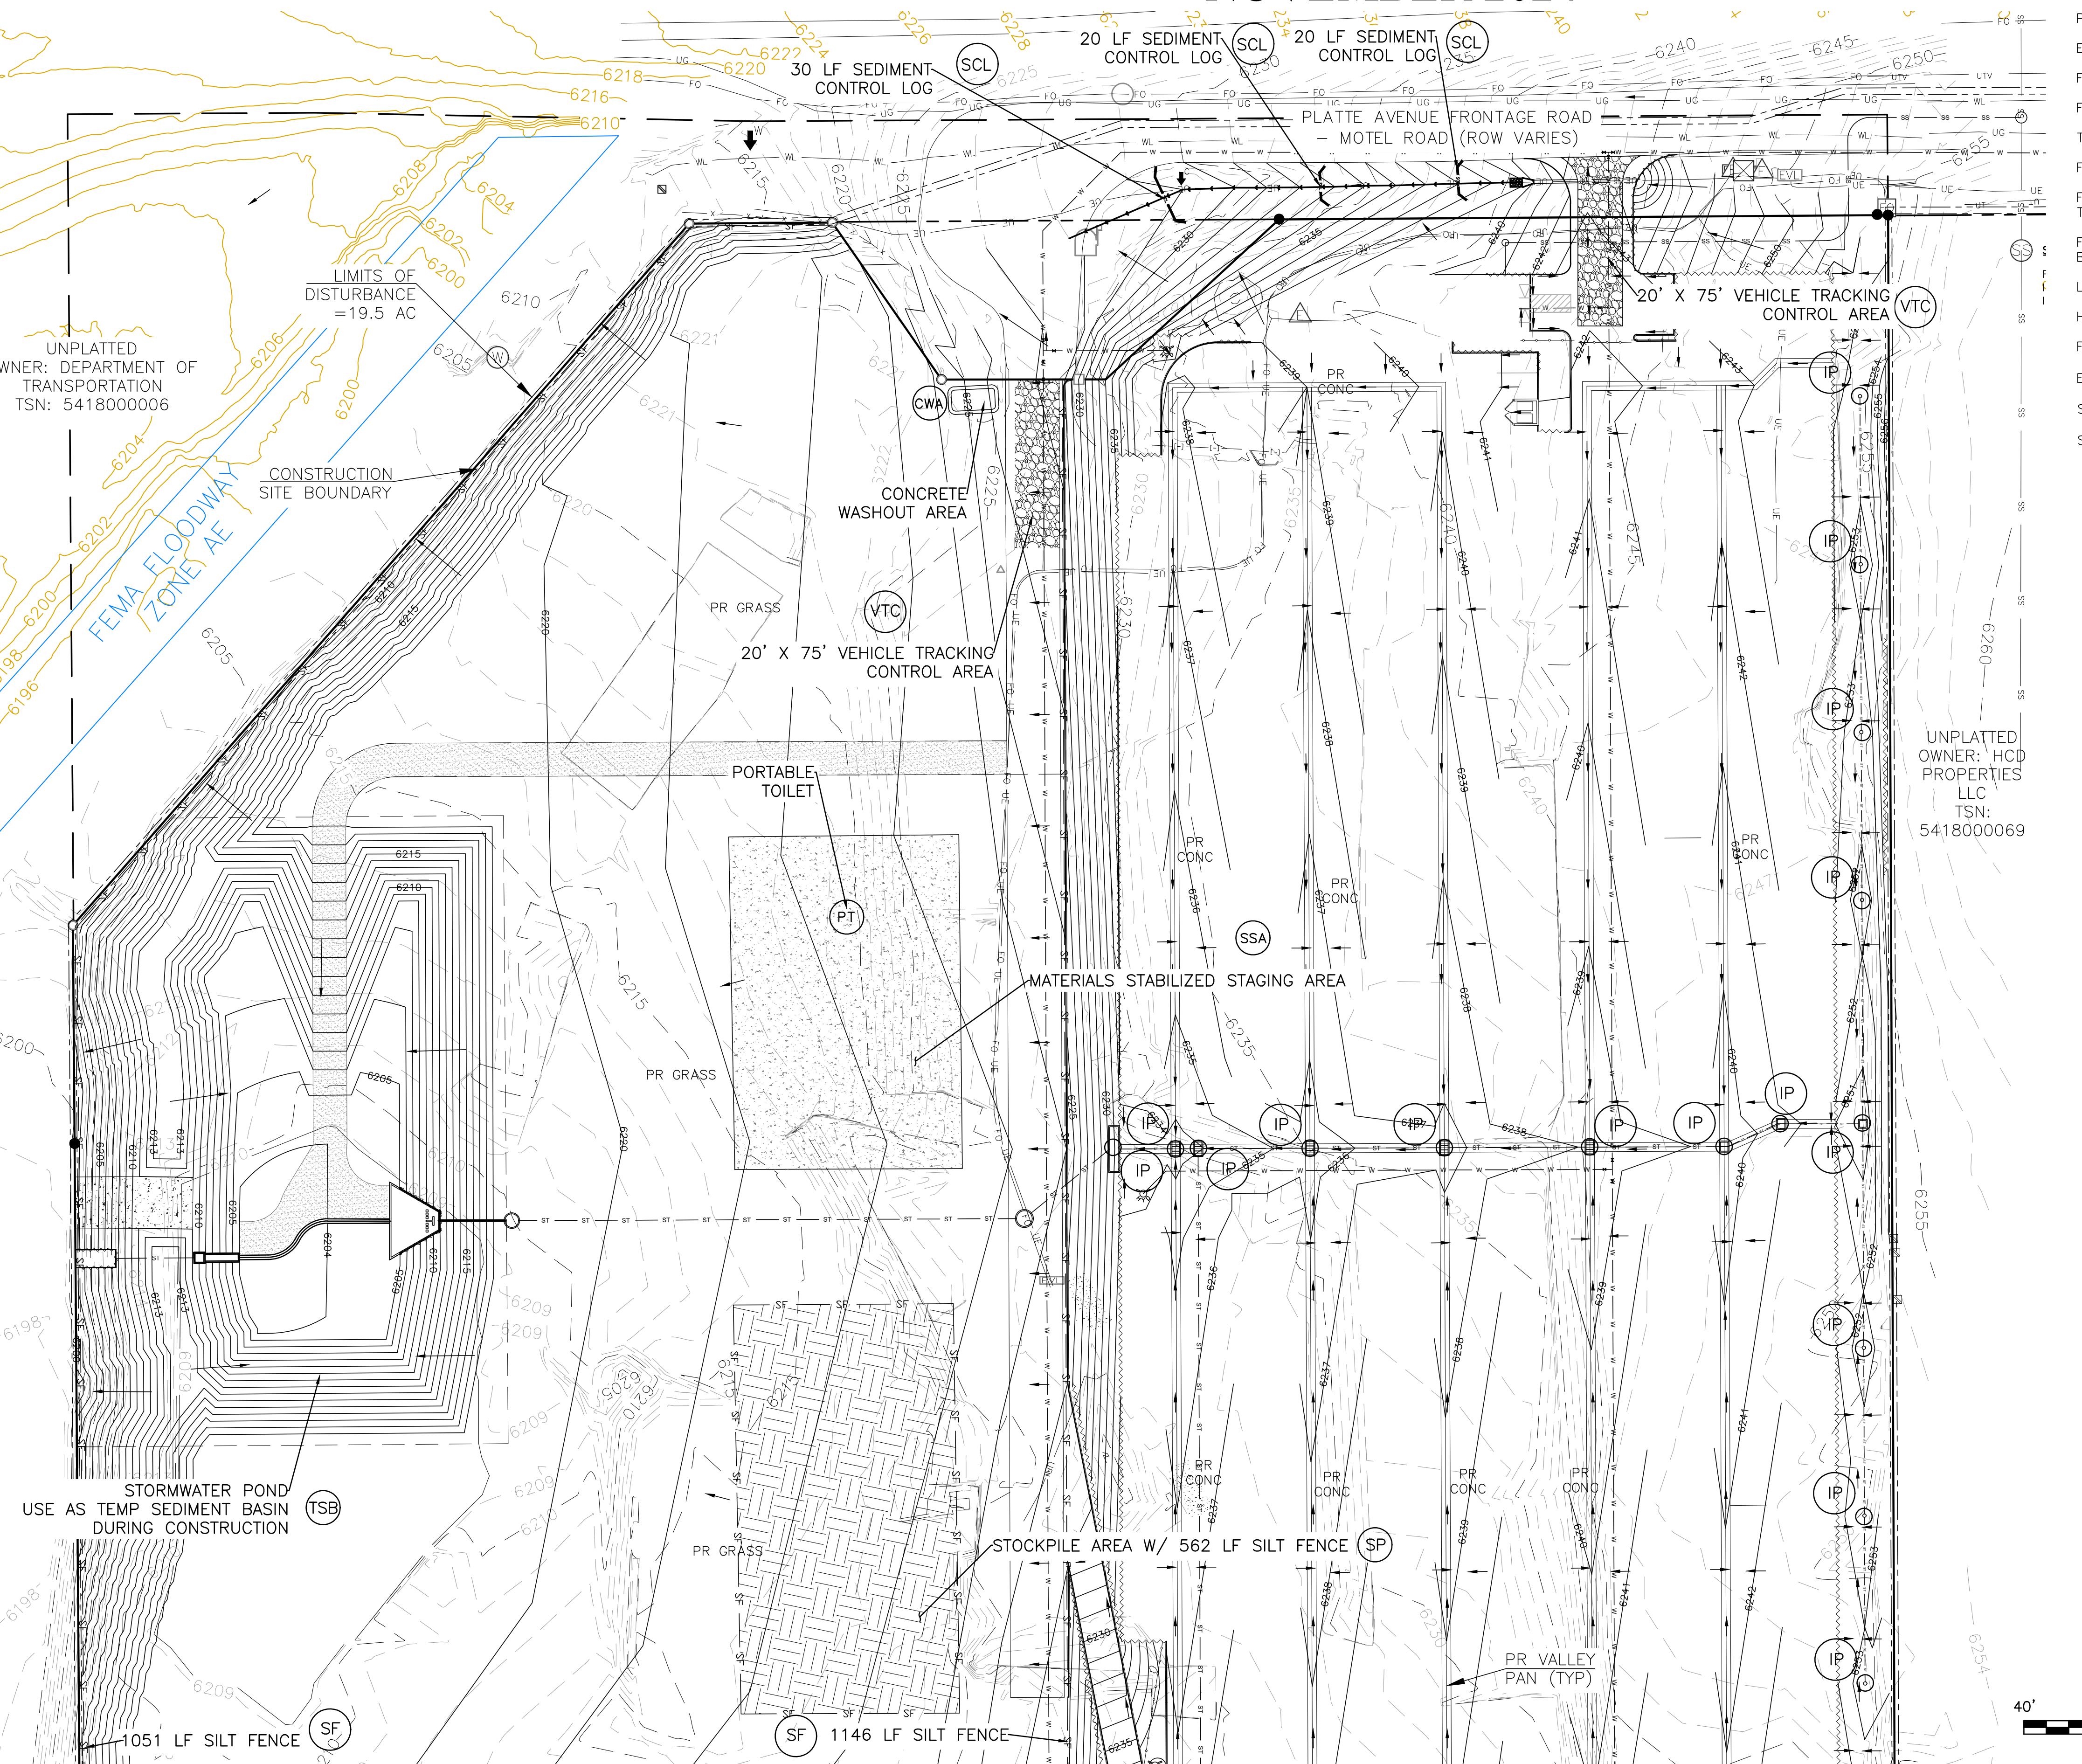

**PLATTE SELF STORAGE
GRADING AND EROSION CONTROL PLAN
INTERIM EC PLAN - SOUTH SIDE
NOVEMBER 2024**

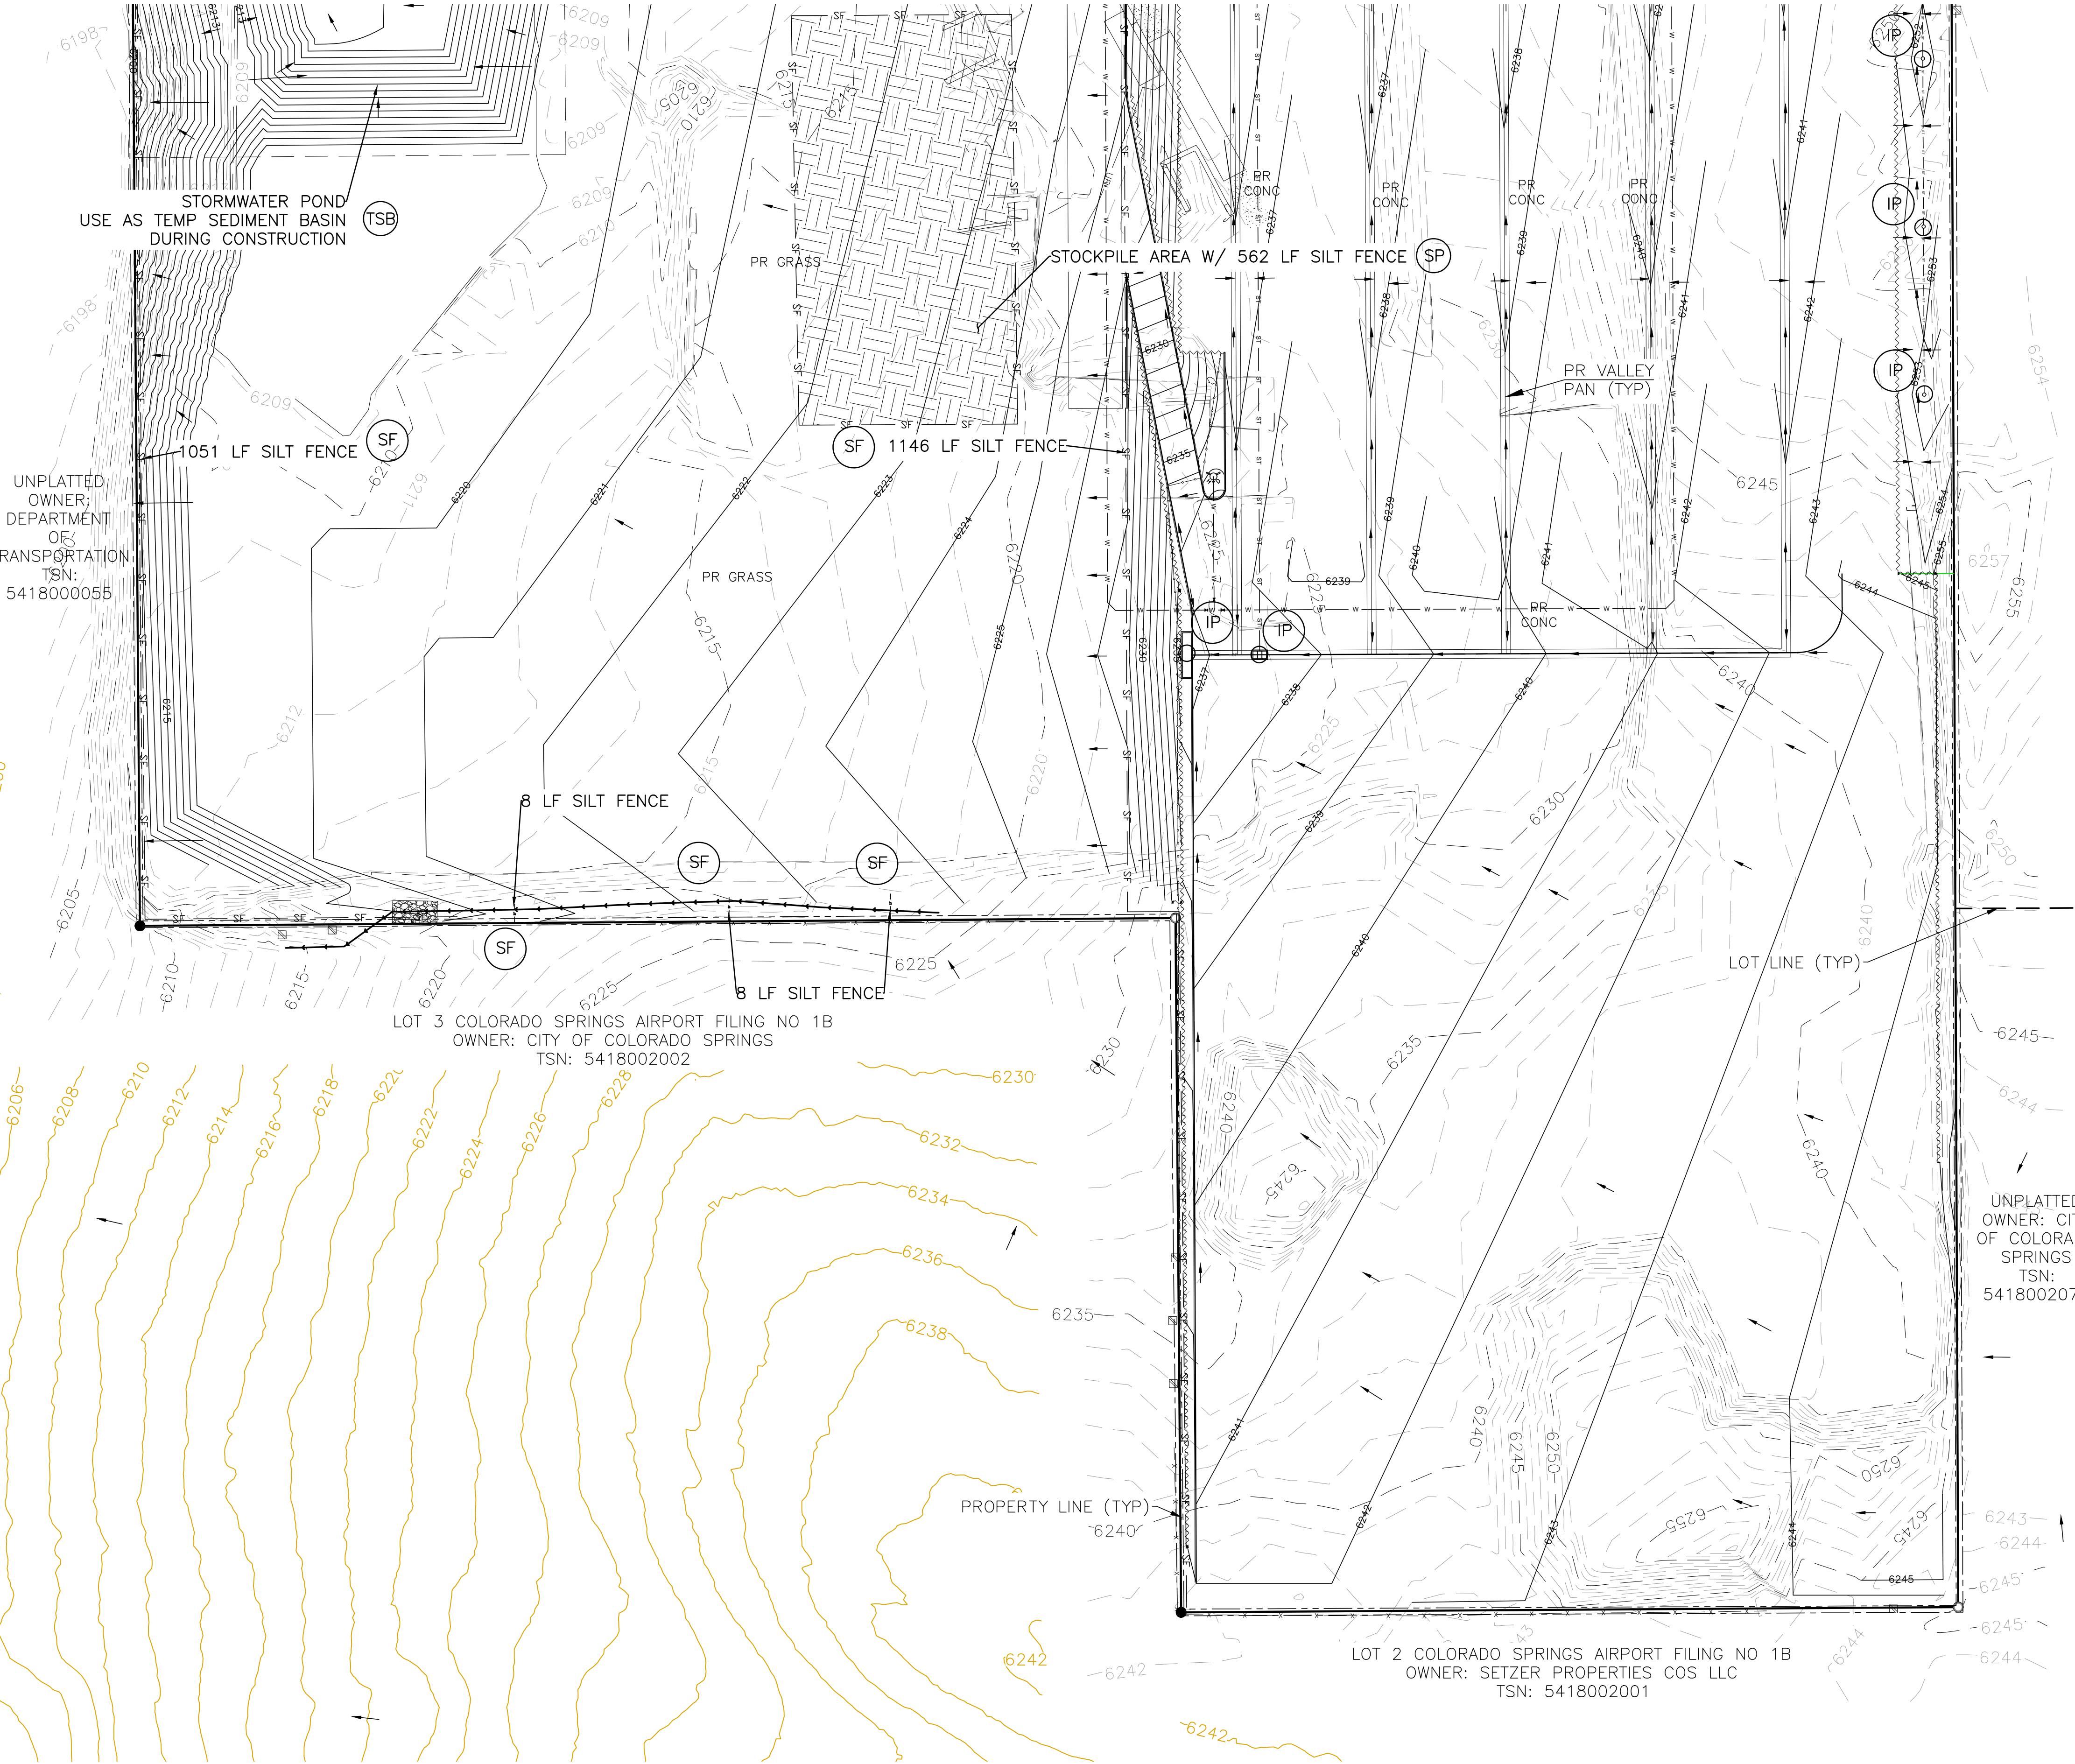

BENCHMARKS


CDOT RIGHT OF WAY MONUMENT #3014 - ELEV=6232.52 (NAVD-1988) [NORTHEAST OF SITE ENTRANCE]

GRADING LEGEND

PROPOSED	PR	EXISTING CONTOURS - MINOR	6231
EXISTING	EX	EXISTING CONTOURS - MAJOR	6230
FINISHED SURFACE	FS	PROPOSED CONTOURS - 1'	6231
FINISHED GROUND	FG	EXISTING PROPERTY LINE	~~~~~
TOP OF CURB	TC	PROPOSED RET WALL	---
FLOWLINE	FL	PROPOSED RIPRAP	~~~~~
FINISH GROUND AT TOP OF WALL	TW	WATER LINE	W W
FINISHED GROUND AT BOTTOM OF WALL	BW	SANITARY SEWER LINE	SS SS
LOW POINT	LP	GAS LINE	UG UG
HIGH POINT	HP	UNDERGROUND ELECTRICAL LINE	UE UE
FLOW ARROW		TELEPHONE LINE	UT UT
EXISTING CONTOURS (LIDAR)	6130	FIBER OPTIC LINE	FD FD
STORM MANHOLE	○	STORM SEWER LINE	ST ST
STORM INLET	□	LIMIT OF CONSTRUCTION	- - -
		LIMIT OF SOIL DISTURBANCE	- - -
		PROPOSED FENCE	- - -
		FIRE HYDRANT	●
		PROPOSED CURB & GUTTER	□

REVISIONS
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ATTN: 5085 LIST DR, #200
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719.548.0600

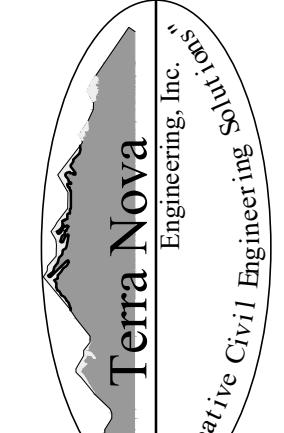


Terra Nova
Engineering, Inc.
Civil/Pre-Construction Services
721 S. 23rd STREET
COLORADO SPRINGS, CO 80904
OFFICE: 719-535-6422
FAX: 719-535-6426
www.tresinc.com

EROSION CONTROL LEGEND

KEY	TITLE	SYMBOL	IMPLEMENTATION PHASE
SF	SILT FENCE	— SF —	INITIAL
SSA	STABILIZED STAGING AREA	[Hatched Box]	INITIAL
VTC	VEHICLE TRACKING CONTROL	[Dotted Box]	INITIAL
SP	STOCKPILE MANAGEMENT WITH PROTECTION	[Hatched Box with Protection]	INITIAL
CWA	CONCRETE WASHOUT AREA	[Oval]	INITIAL
TSB	TEMPORARY SEDIMENT BASIN	NONE	INITIAL
PT	PORTABLE TOILET	NONE	INITIAL
SCL	SEDIMENT CONTROL LOG	— SCL —	INTERIM
IP	INLET PROTECTION	□	INTERIM

NOTES

1. SEDIMENT CONTROL LOGS MAY BE SUBSTITUTED FOR SILT FENCE AND VICE VERSA.
2. SEED AND MULCH DISTURBED AREAS ONLY.
3. THERE IS LITTLE TO NO NOTABLE EXISTING VEGETATION LOCATED ON SITE.
4. THERE WILL BE OFFSITE GRADING FOR THE PROPOSED UTILITIES AND GRADING WITHIN THE PLATTE AVENUE FRONTAGE ROAD RIGHT-OF-WAY.

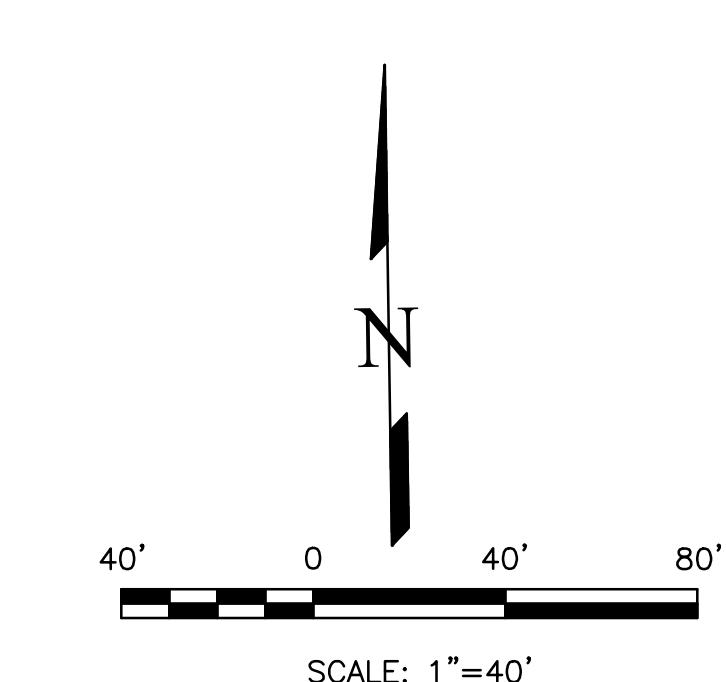

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DANE FRANK
COLORADO P.E. # 50207

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**PLATTE SELF STORAGE
GRADING AND EROSION CONTROL PLAN
FINAL EC PLAN - NORTH SIDE
NOVEMBER 2024**

BENCHMARKS

CDOT RIGHT OF WAY MONUMENT #3014 - ELEV=6232.52 (NAVD-1988) [NORTHEAST OF SITE ENTRANCE]


GRADING LEGEND

PROPOSED	PR	EXISTING CONTOURS - MINOR
EXISTING	EX	EXISTING CONTOURS - MAJOR
FINISHED SURFACE	FS	PROPOSED CONTOURS - 1'
FINISHED GROUND	FG	EXISTING PROPERTY LINE
TOP OF CURB	TC	PROPOSED RET WALL
FLOWLINE	FL	WATER LINE
FINISH GROUND AT TOP OF WALL	TW	SANITARY SEWER LINE
FINISHED GROUND AT BOTTOM OF WALL	BW	GAS LINE
LOW POINT	LP	UNDERGROUND ELECTRICAL LINE
HIGH POINT	HP	TELEPHONE LINE
FLOW ARROW	→	FIBER OPTIC LINE
EXISTING CONTOURS (LIDAR)	8130	STORM SEWER LINE
STORM MANHOLE	SM	LIMIT OF CONSTRUCTION
STORM INLET	SI	LIMIT OF SOIL DISTURBANCE
		PROPOSED FENCE
		FIRE HYDRANT
		PROPOSED CURB & GUTTER
		CUT/FILL BOUNDARY

REVISIONS
NO.
DESCRIPTION
DATE

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PLATTE SELF STORAGE

GRADING AND EROSION CONTROL PLAN - NORTH SIDE
VERTICAL EROSION CONTROL PLAN - NORTH SIDE

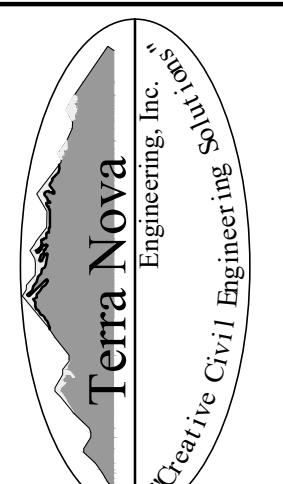EROSION CONTROL LEGEND

KEY	TITLE	IMPLEMENTATION PHASE
SF	SILT FENCE	INITIAL
SSA	STABILIZED STAGING AREA	INITIAL
VTC	VEHICLE TRACKING CONTROL	INITIAL
SP	STOCKPILE MANAGEMENT WITH PROTECTION	INITIAL
CWA	CONCRETE WASHOUT AREA	INITIAL
TBB	TEMPORARY SEDIMENT BASIN	NONE
PT	PORTABLE TOILET	INITIAL
SCL	SEDIMENT CONTROL LOG	INTERIM
IP	INLET PROTECTION	INTERIM
PERMANENT SEEDING AND MULCHING		FINAL
SM	PS - DRILL SEED, HAND SEED, OR HYDROSEED; SEED MIX PER COLORADO SPRINGS STORMWATER CONSTRUCTION MANUAL (DECEMBER 2020), TABLE 5-2 MU - MECHANICALLY CRIMP MULCH OR HYDROMULCH	


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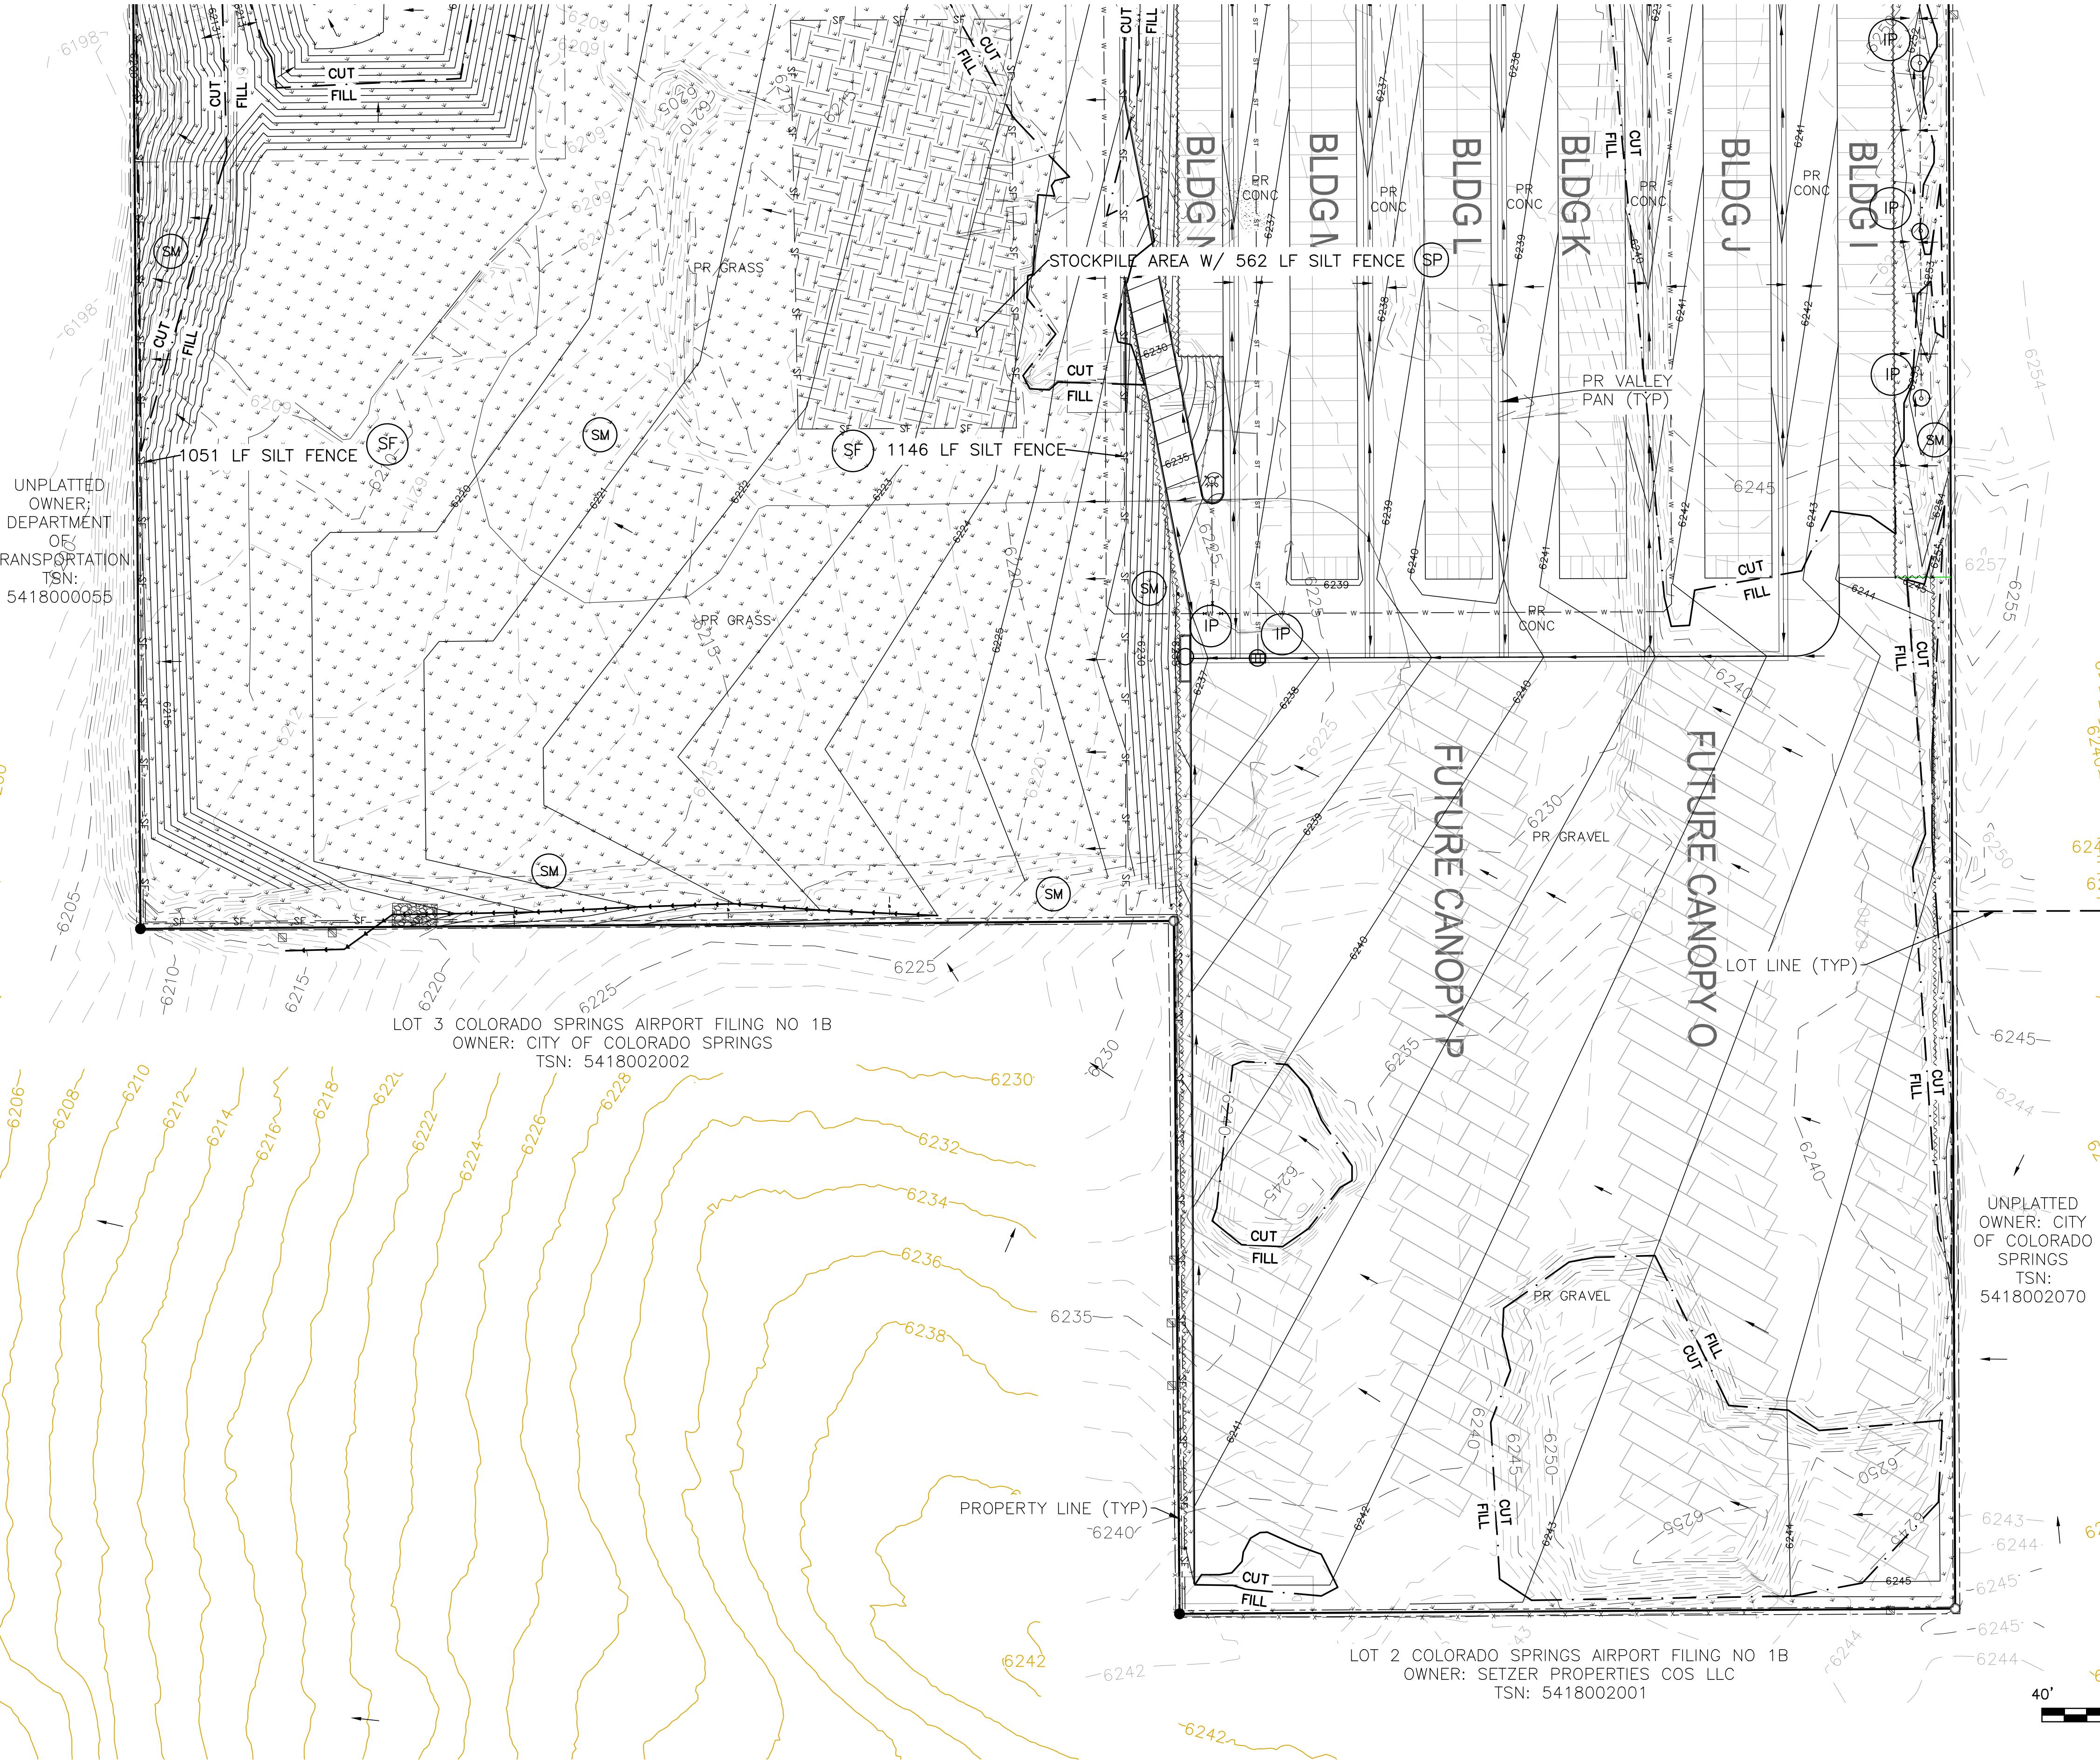
DANE FRANK
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SHEET NO. 12 OF 27



40' 0' 40' 80'
SCALE: 1"=40'

**PLATTE SELF STORAGE
GRADING AND EROSION CONTROL PLAN
FINAL EC PLAN - SOUTH SIDE
NOVEMBER 2024**

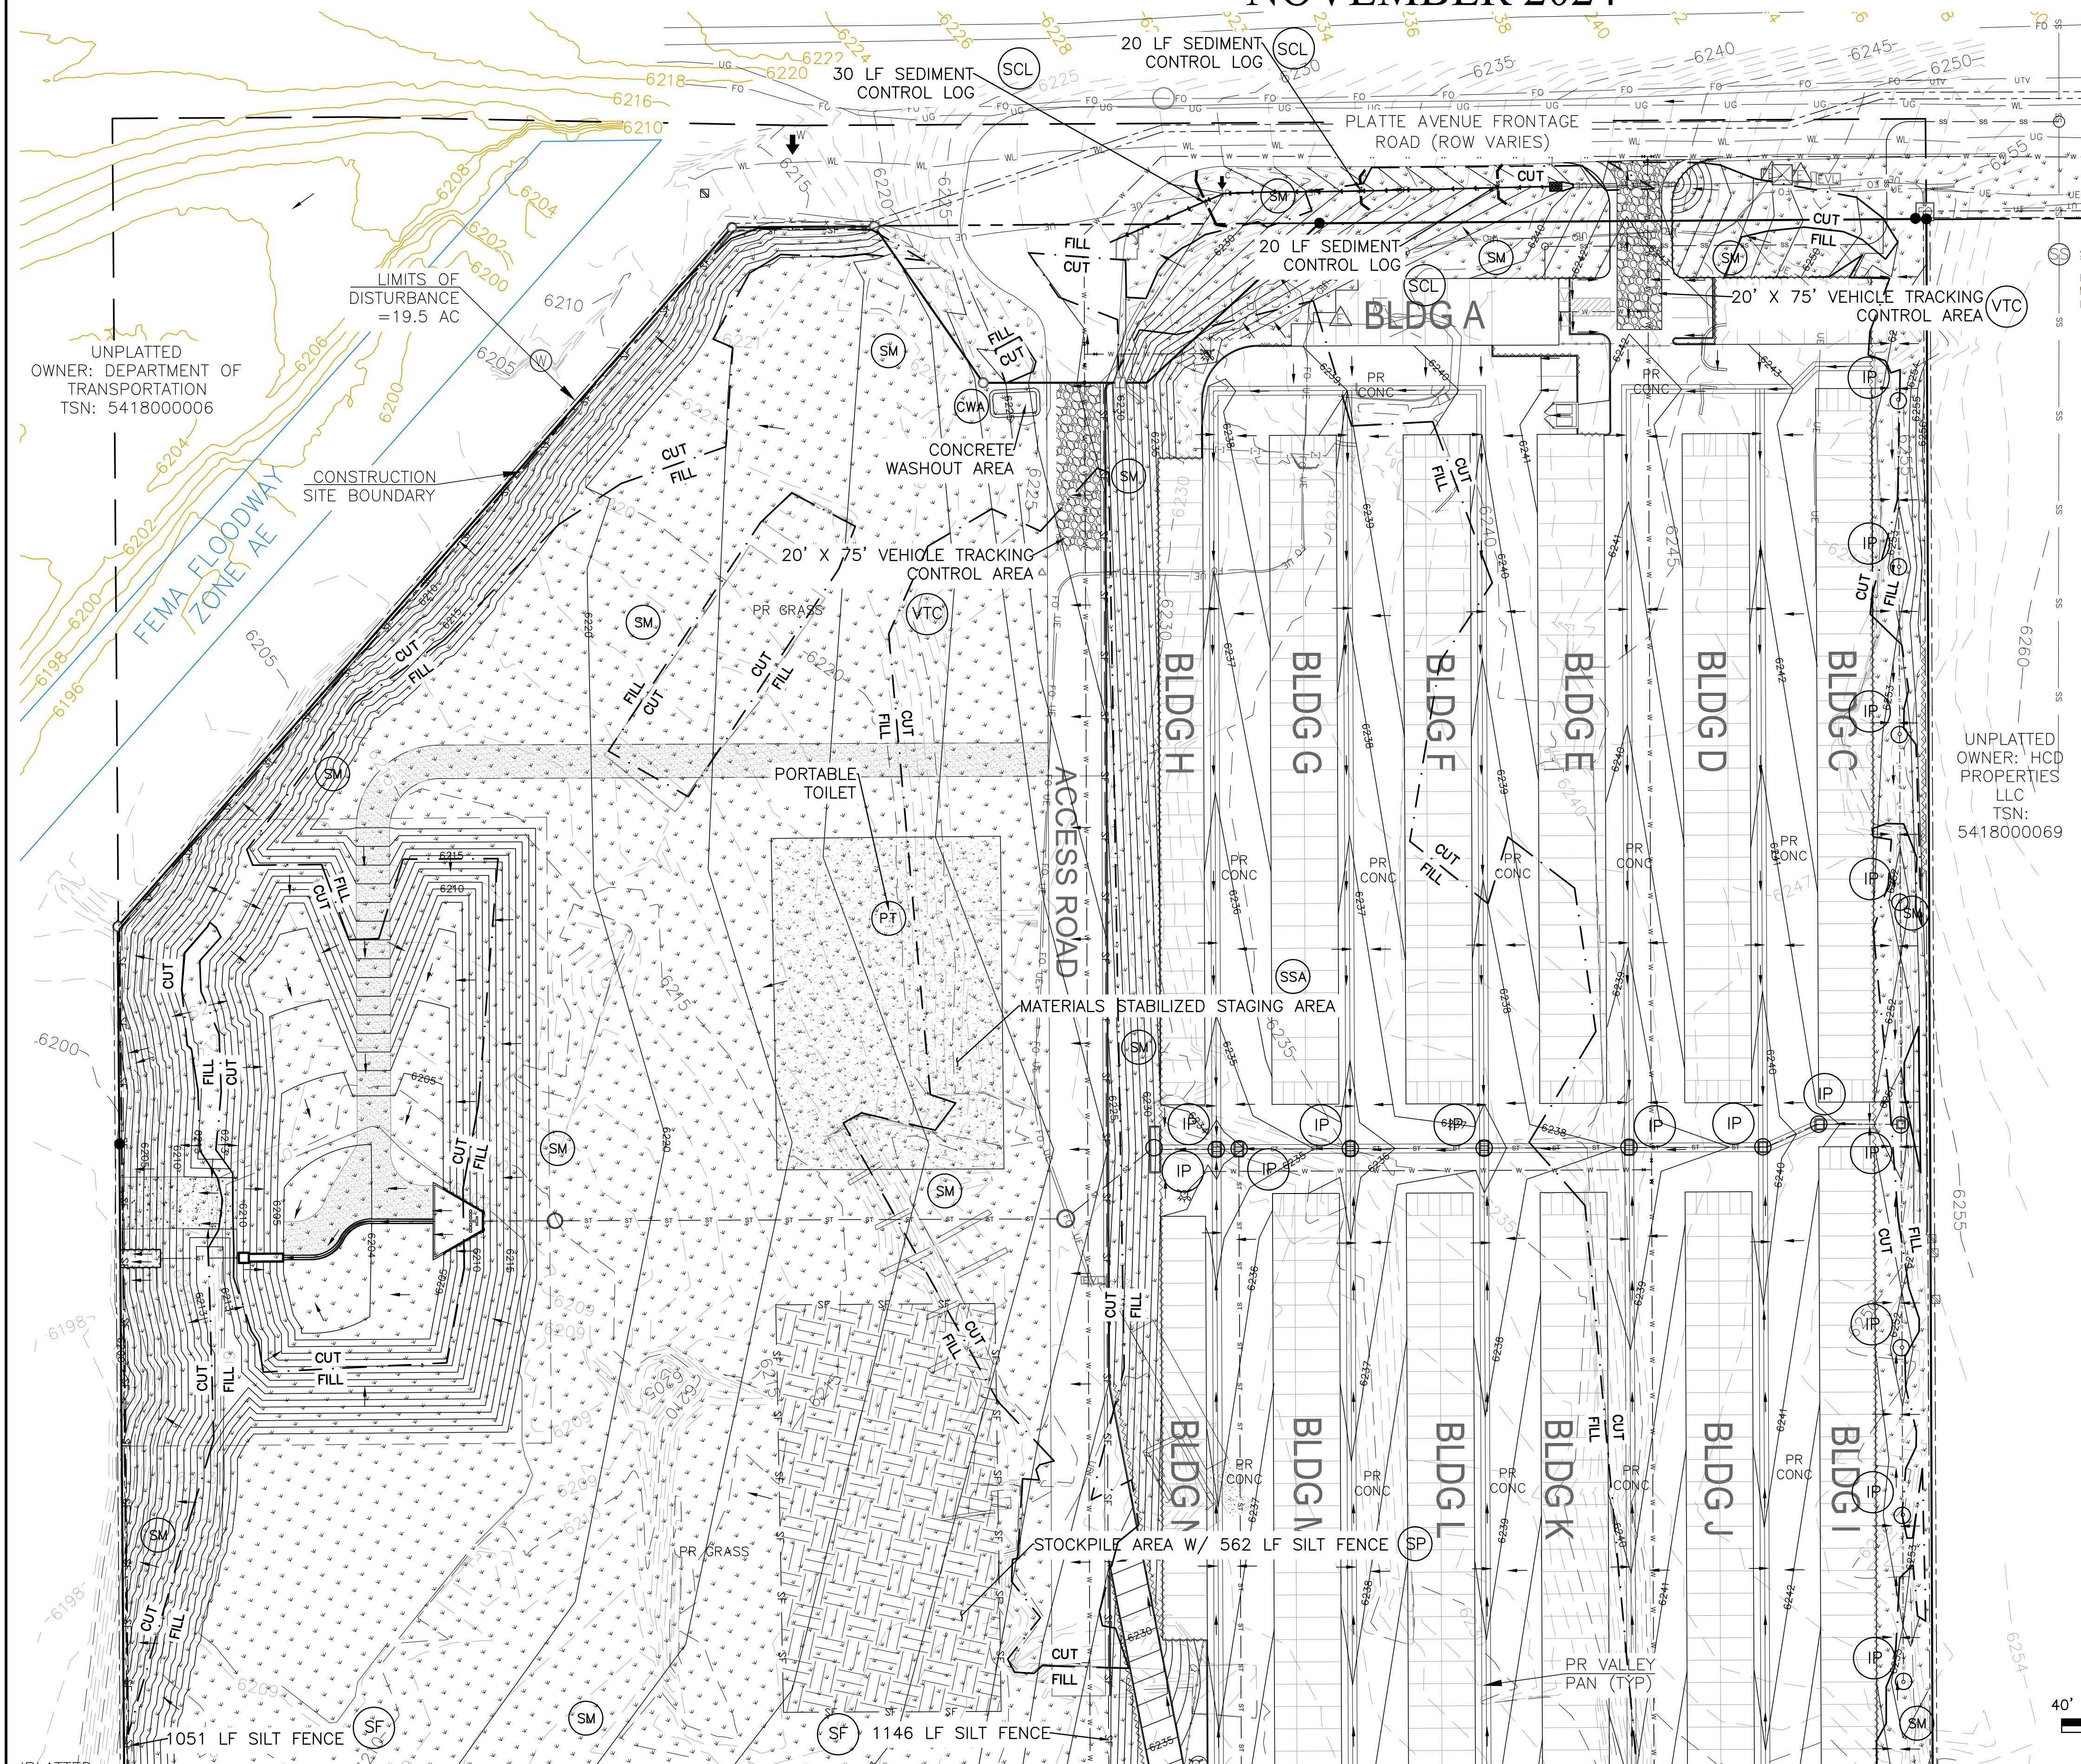

BENCHMARKS

CDOT RIGHT OF WAY MONUMENT #3014 – ELEV=6232.52 (NAVD-1988) [NORTHEAST OF SITE ENTRANCE]


GRADING LEGEND

PROPOSED	PR	EXISTING CONTOURS - MINOR
EXISTING	EX	EXISTING CONTOURS - MAJOR
FINISHED SURFACE	FS	PROPOSED CONTOURS - 1'
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FINISH GROUND AT TOP OF WALL	TW	WATER LINE
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FLOW ARROW	FA	TELEPHONE LINE
EXISTING CONTOURS (LIDAR)	EL	FIBER OPTIC LINE
STORM MANHOLE	SM	STORM SEWER LINE
STORM INLET	SI	LIMIT OF CONSTRUCTION
		LIMIT OF SOIL DISTURBANCE
		PROPOSED FENCE
		FIRE HYDRANT
		PROPOSED CURB & GUTTER
		CUT/FILL BOUNDARY

REVISIONS
NO. _____
DESCRIPTION _____
DATE _____

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ATTN: 5085 LIST DR, #200
COLORADO SPRINGS, CO 80919
719.548.0600

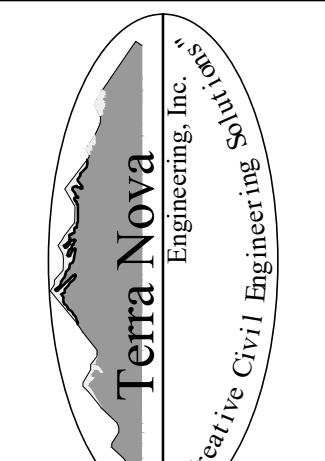

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COLORADO SPRINGS, CO 80904
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PLATTE SELF STORAGE
GRADING AND EROSION CONTROL PLAN – SOUTH SIDE
VERTICAL EROSION CONTROL PLAN – SOUTH SIDE

NOTES





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H-SCALE AS SHOWN
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JOB NO. 2419.00
DATE ISSUED 11/13/24
SHEET NO. 13 OF 27

DANE FRANK
COLORADO P.E. # 50207

SCALE: 1"=40'
40' 0' 40' 80'



PREPARED FOR:	RMG—ROCKY MOUNTAIN GROUP
ATTN:	5085 LIST DR, #200
	COLORADO SPRINGS, CO 80919
DATE:	7/19/2019
REVISIONS:	NO.
DESCRIPTION:	REVIEWS
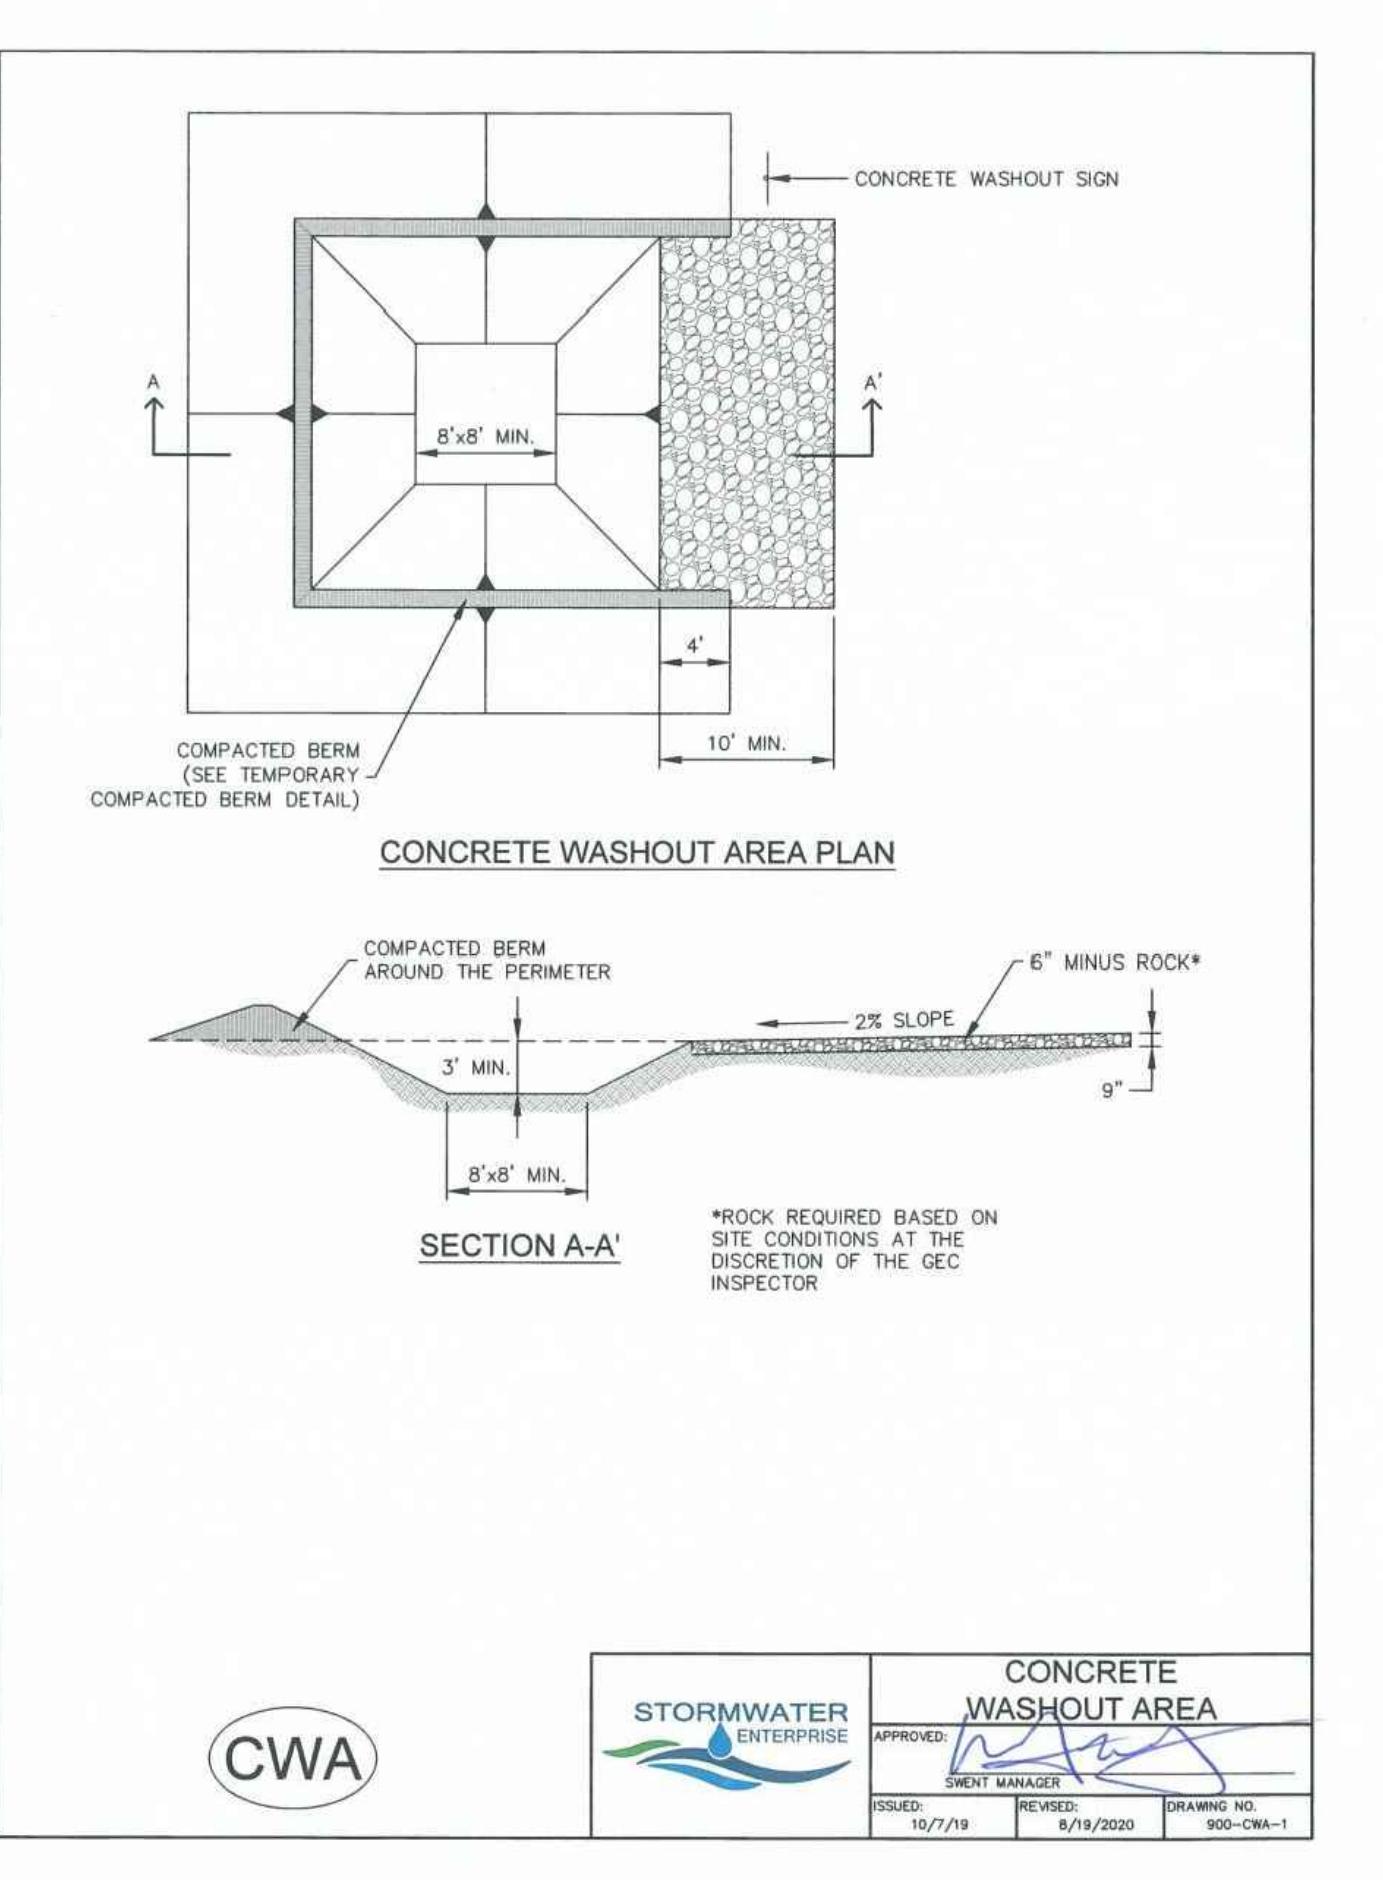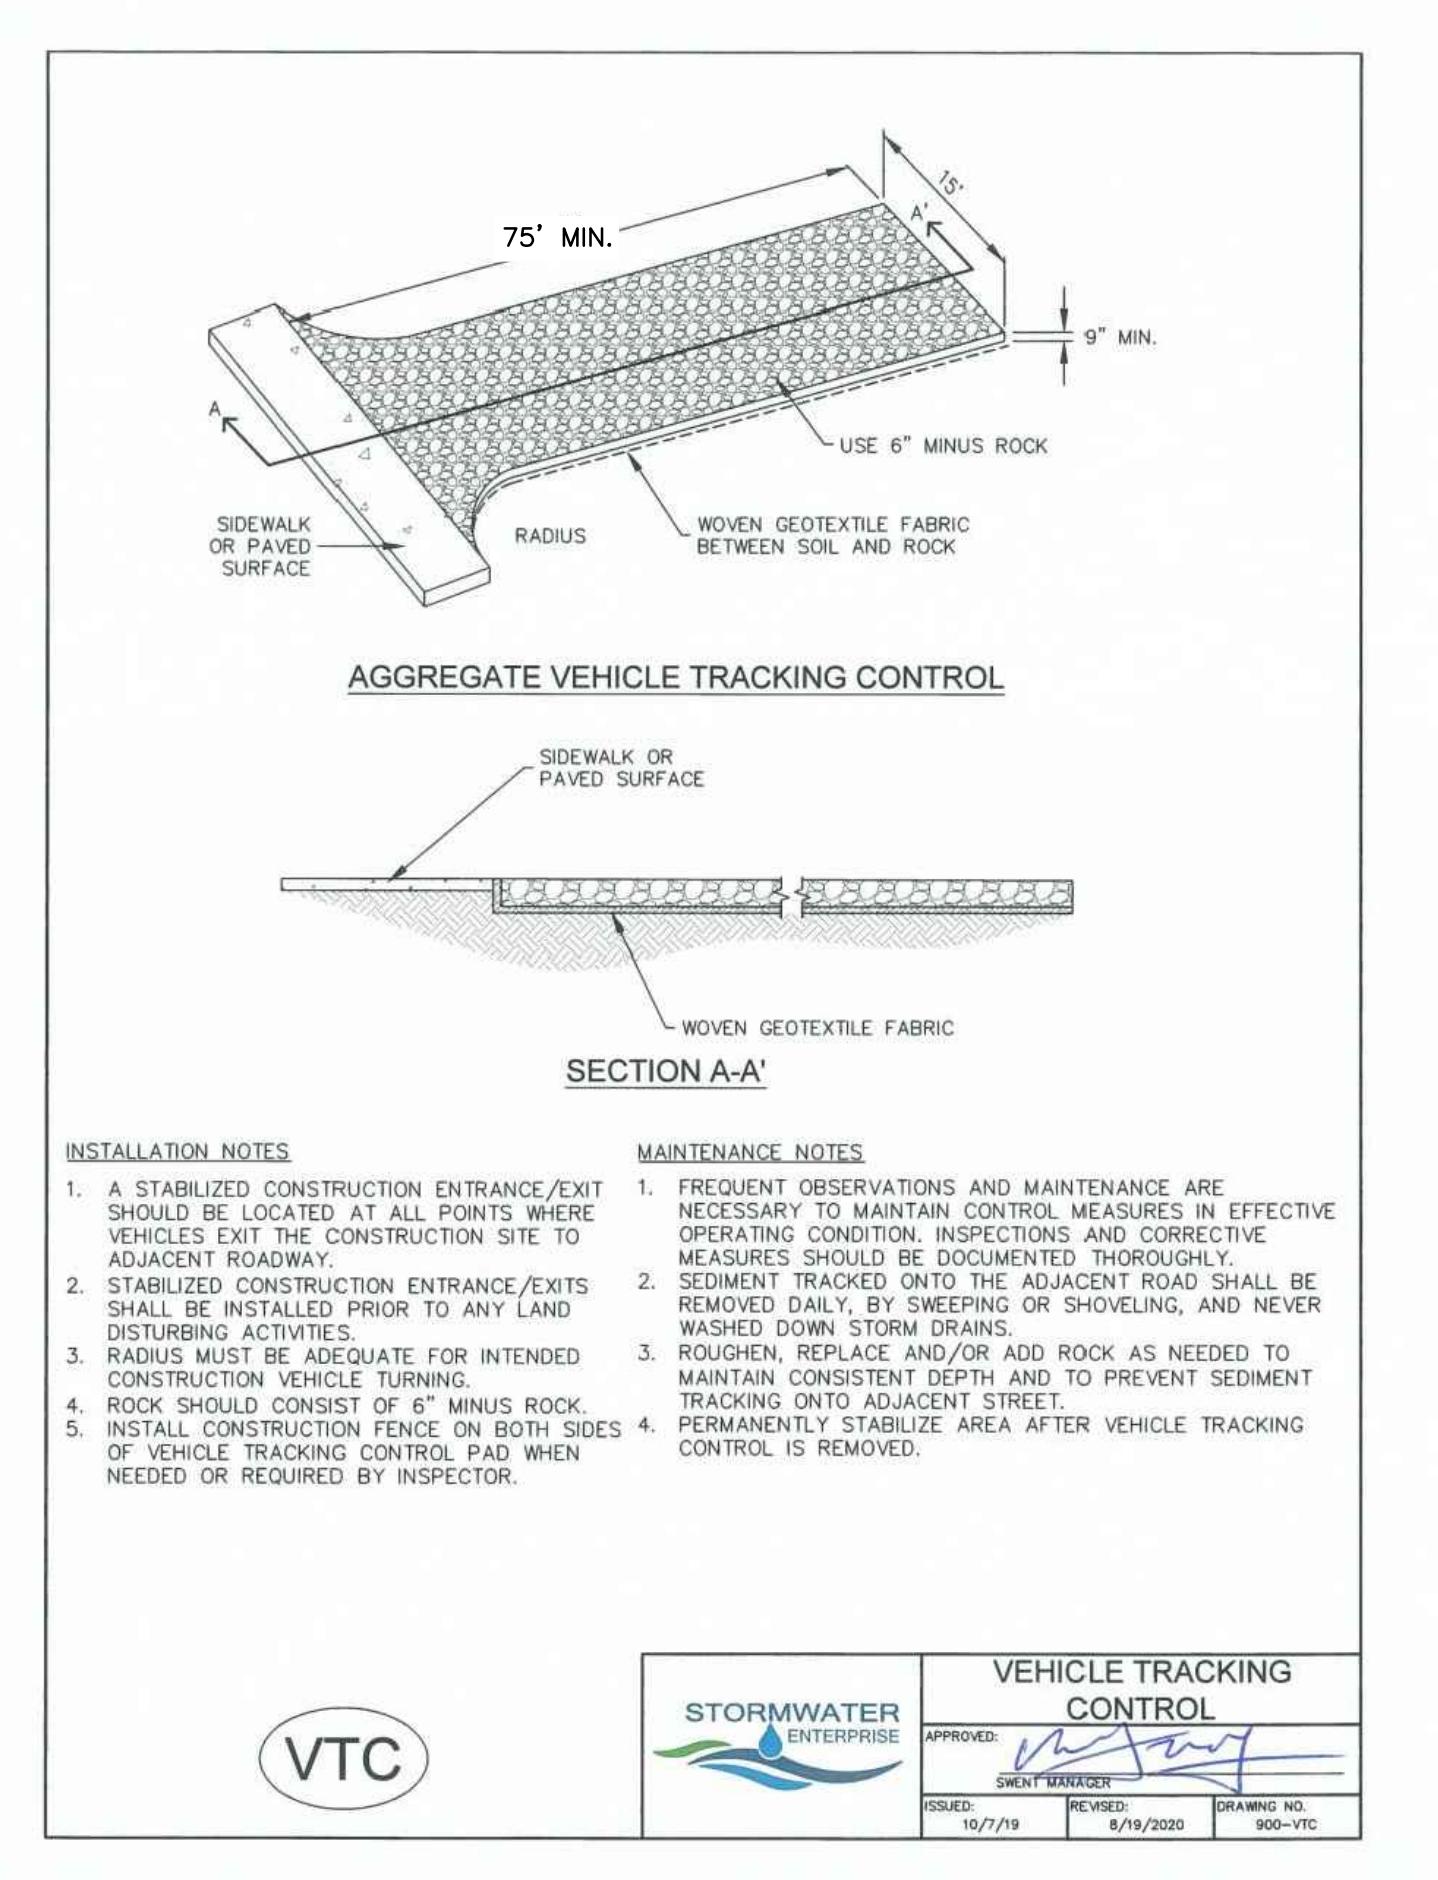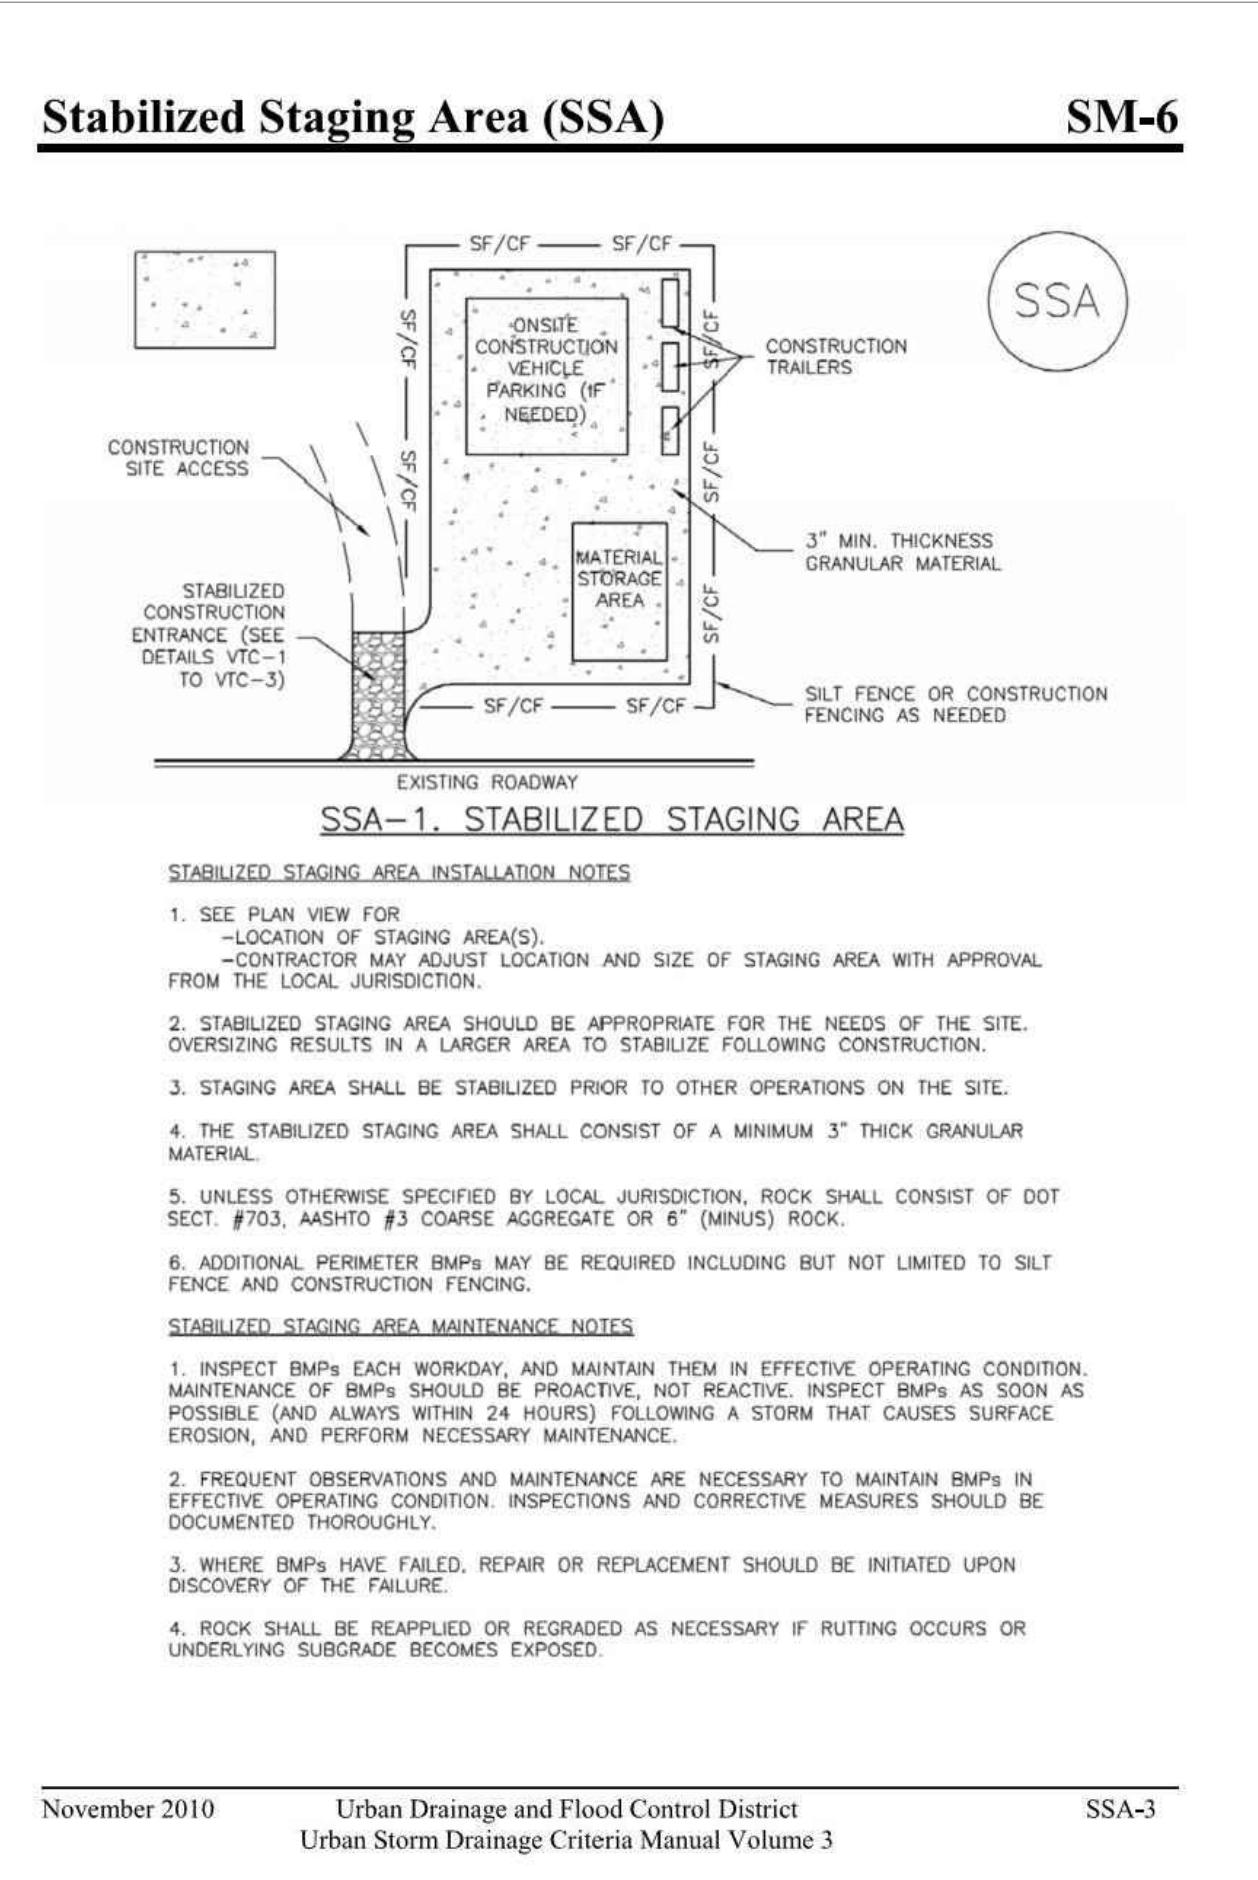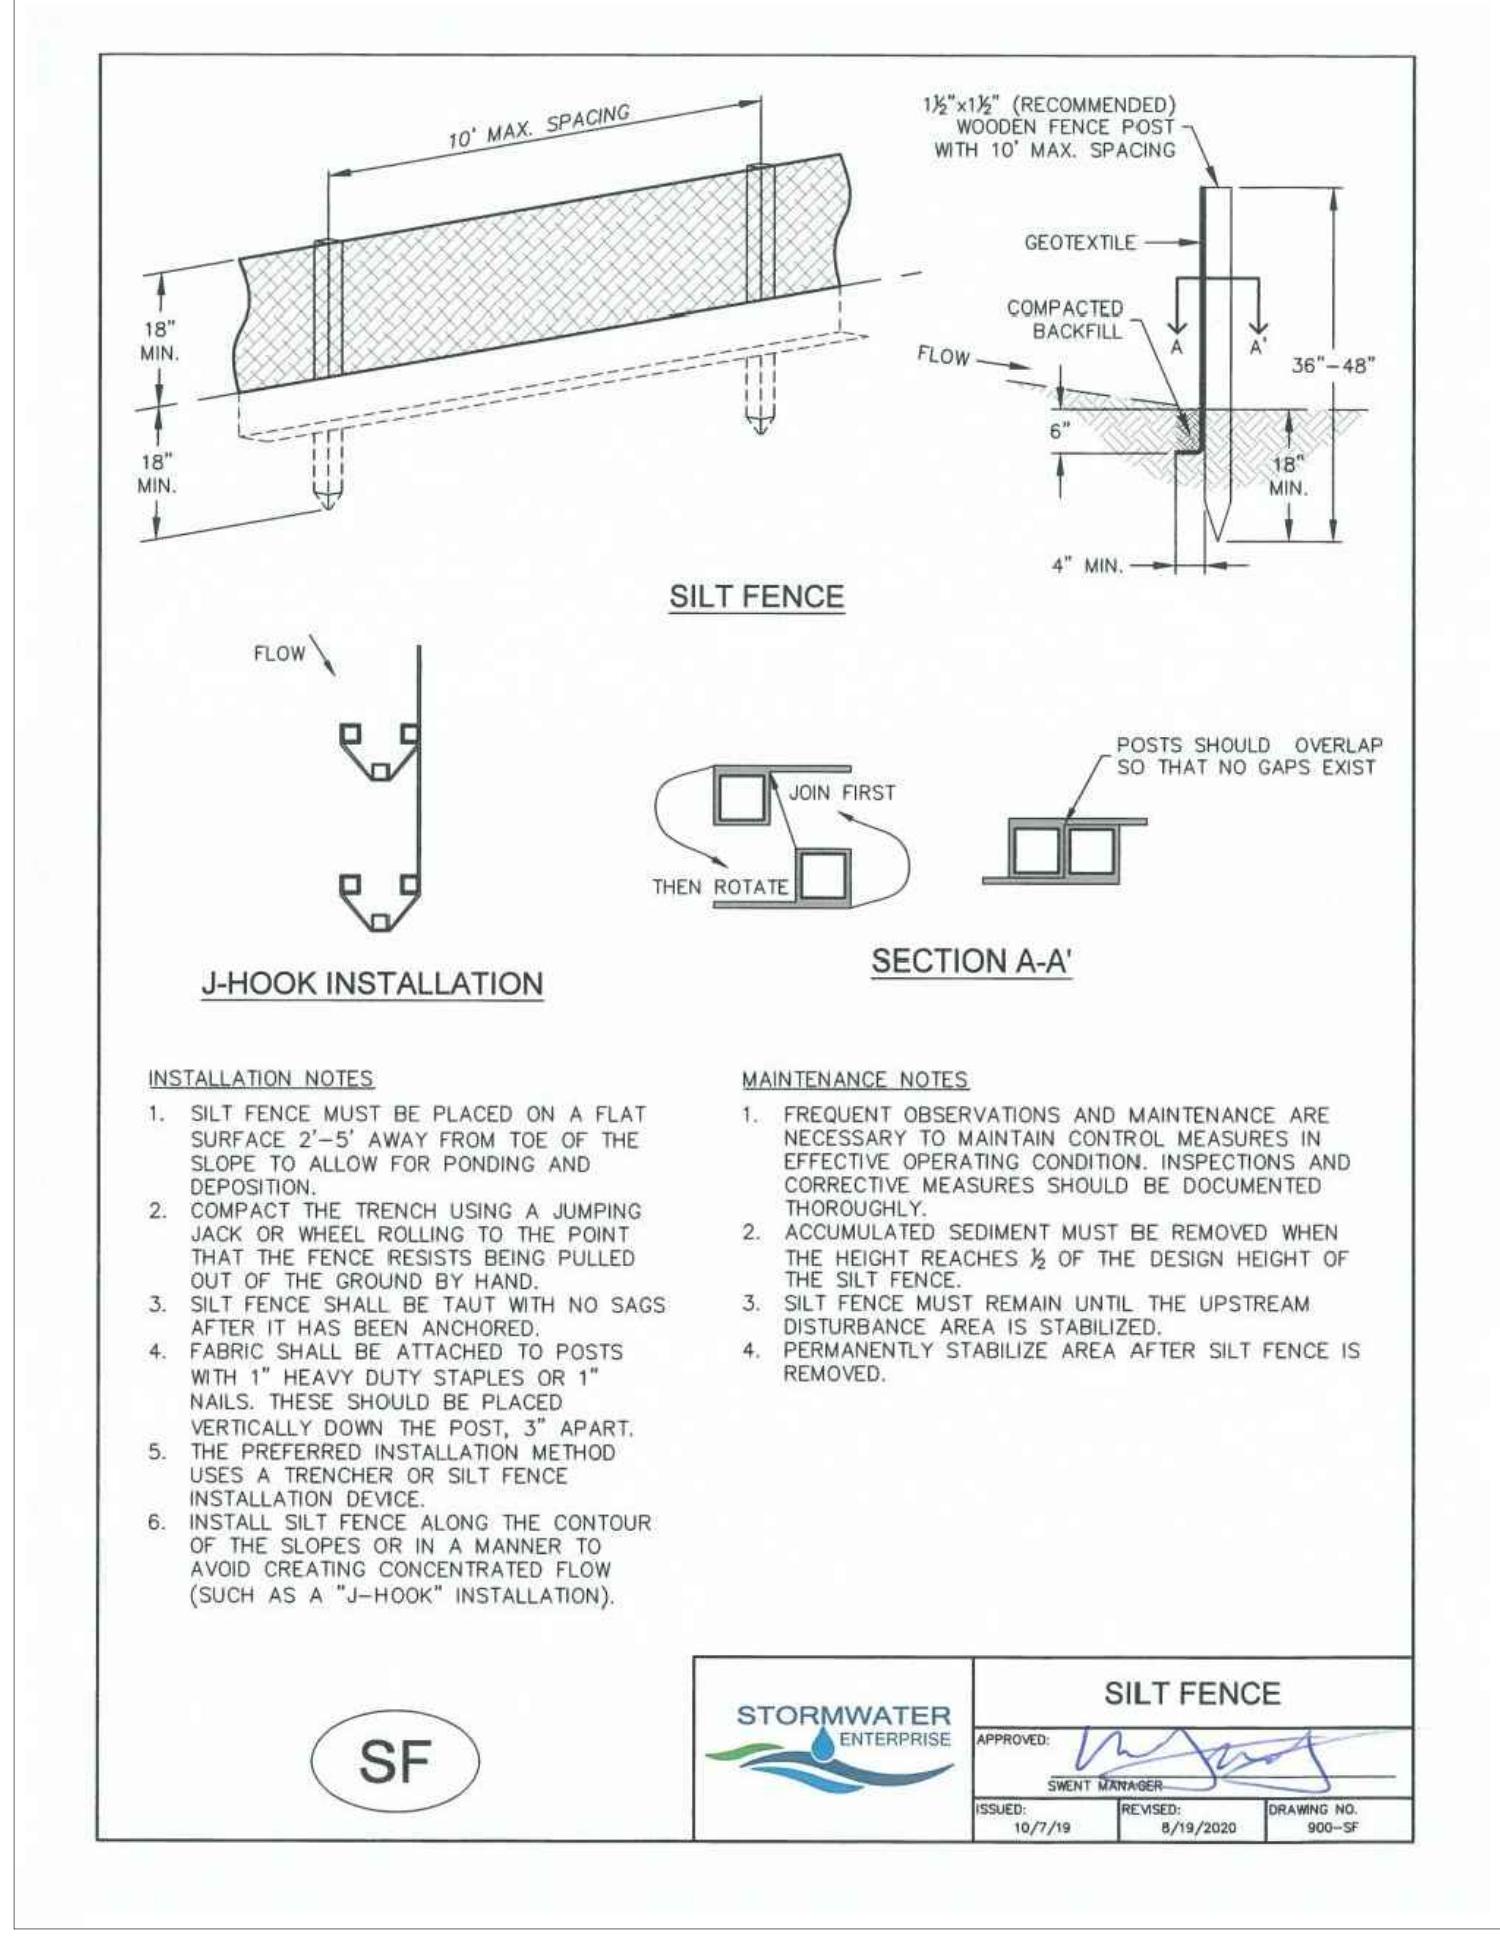
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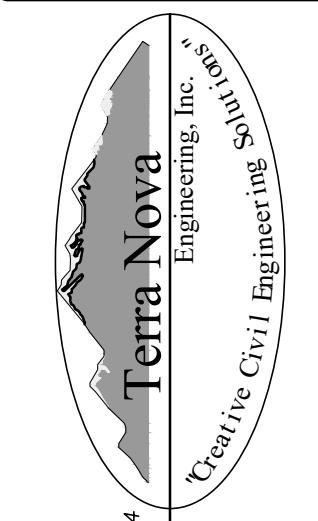
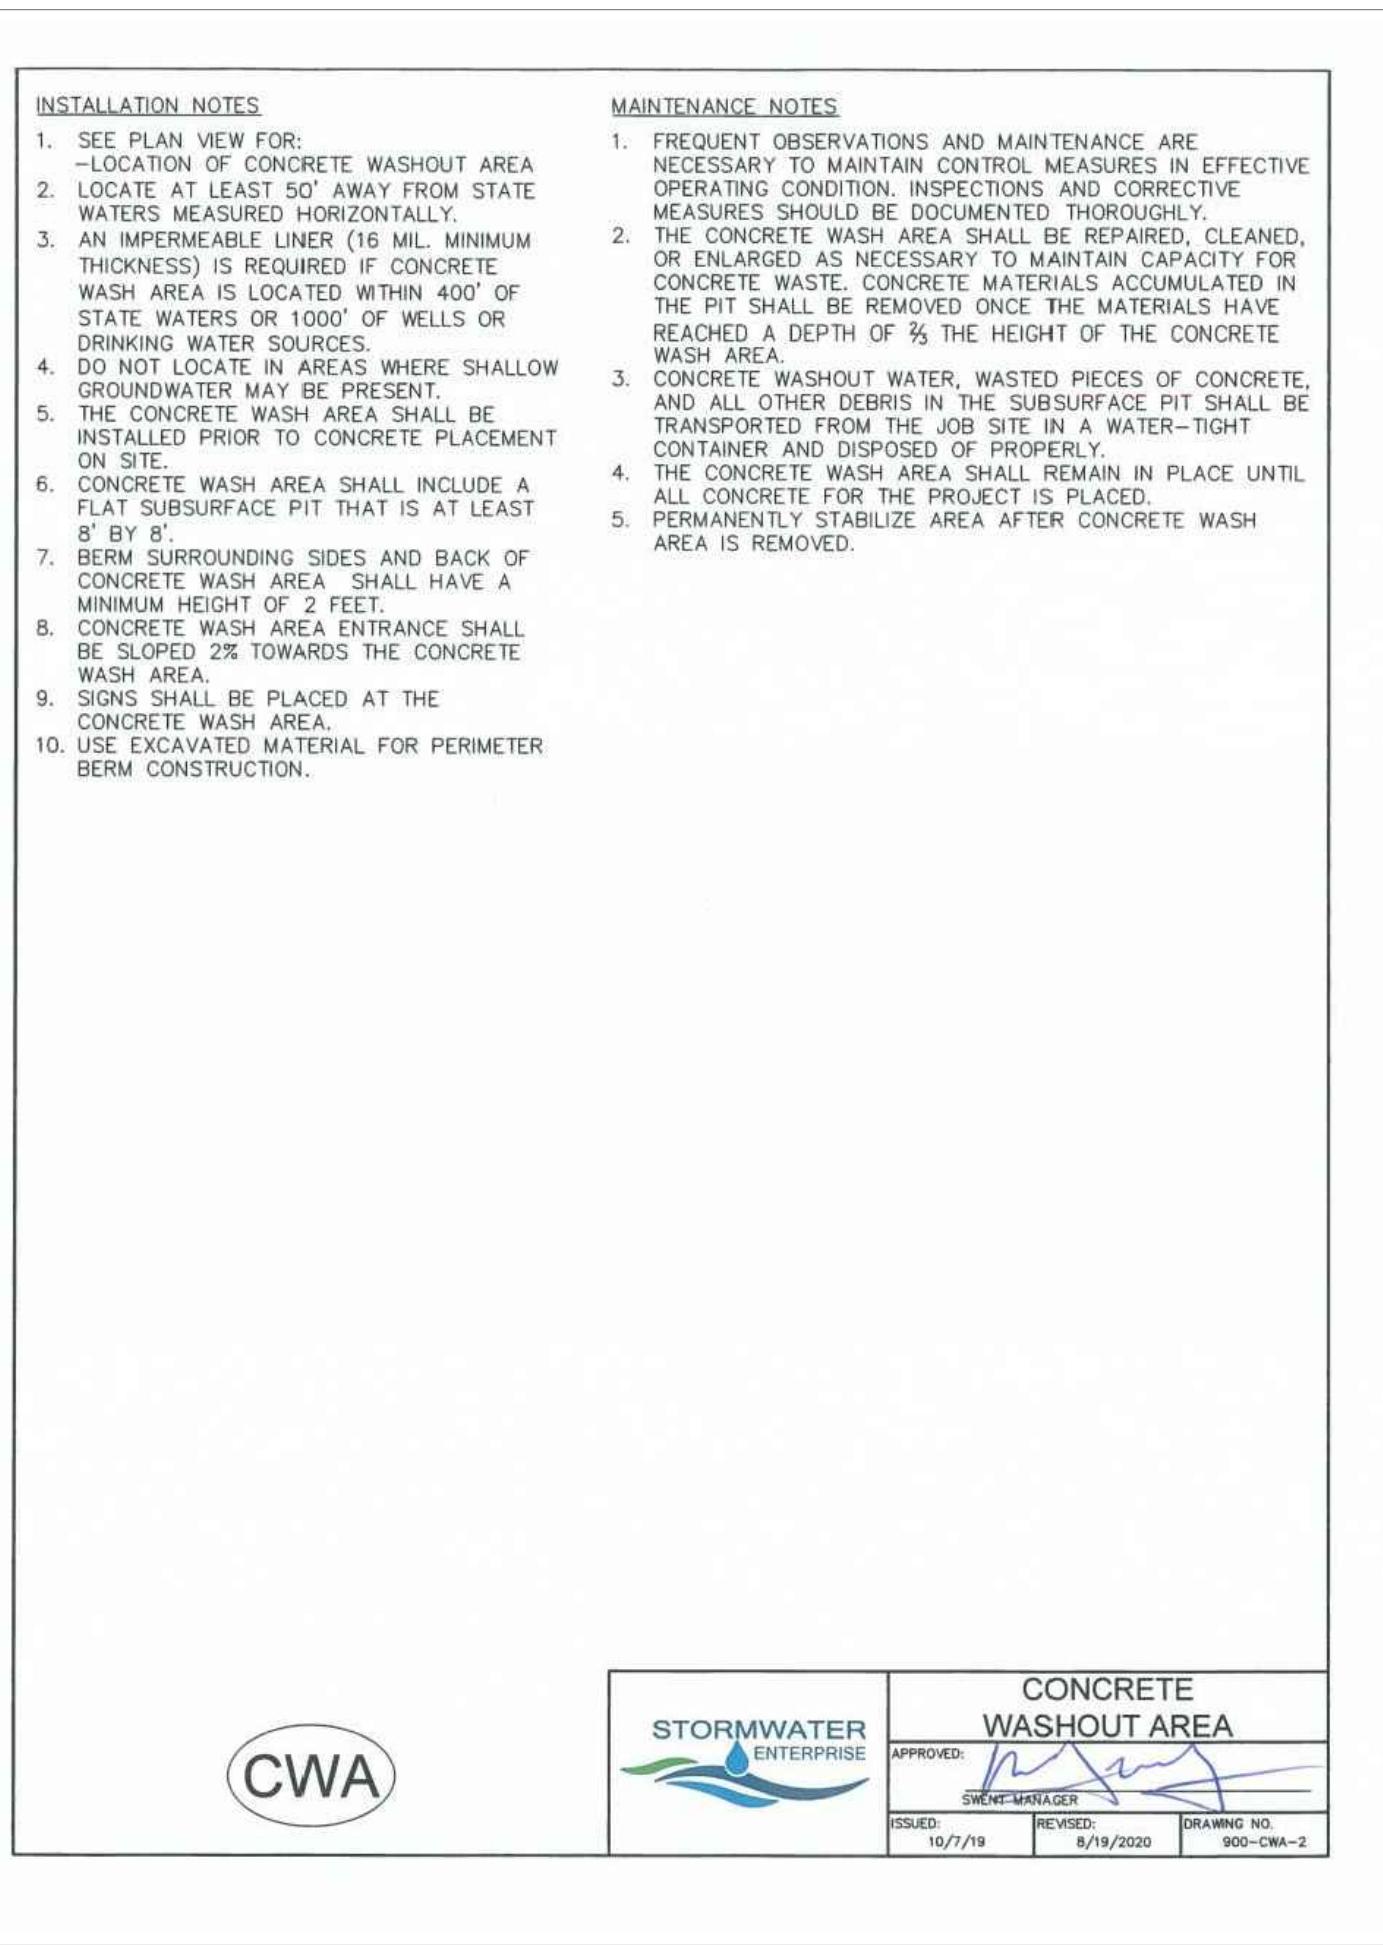
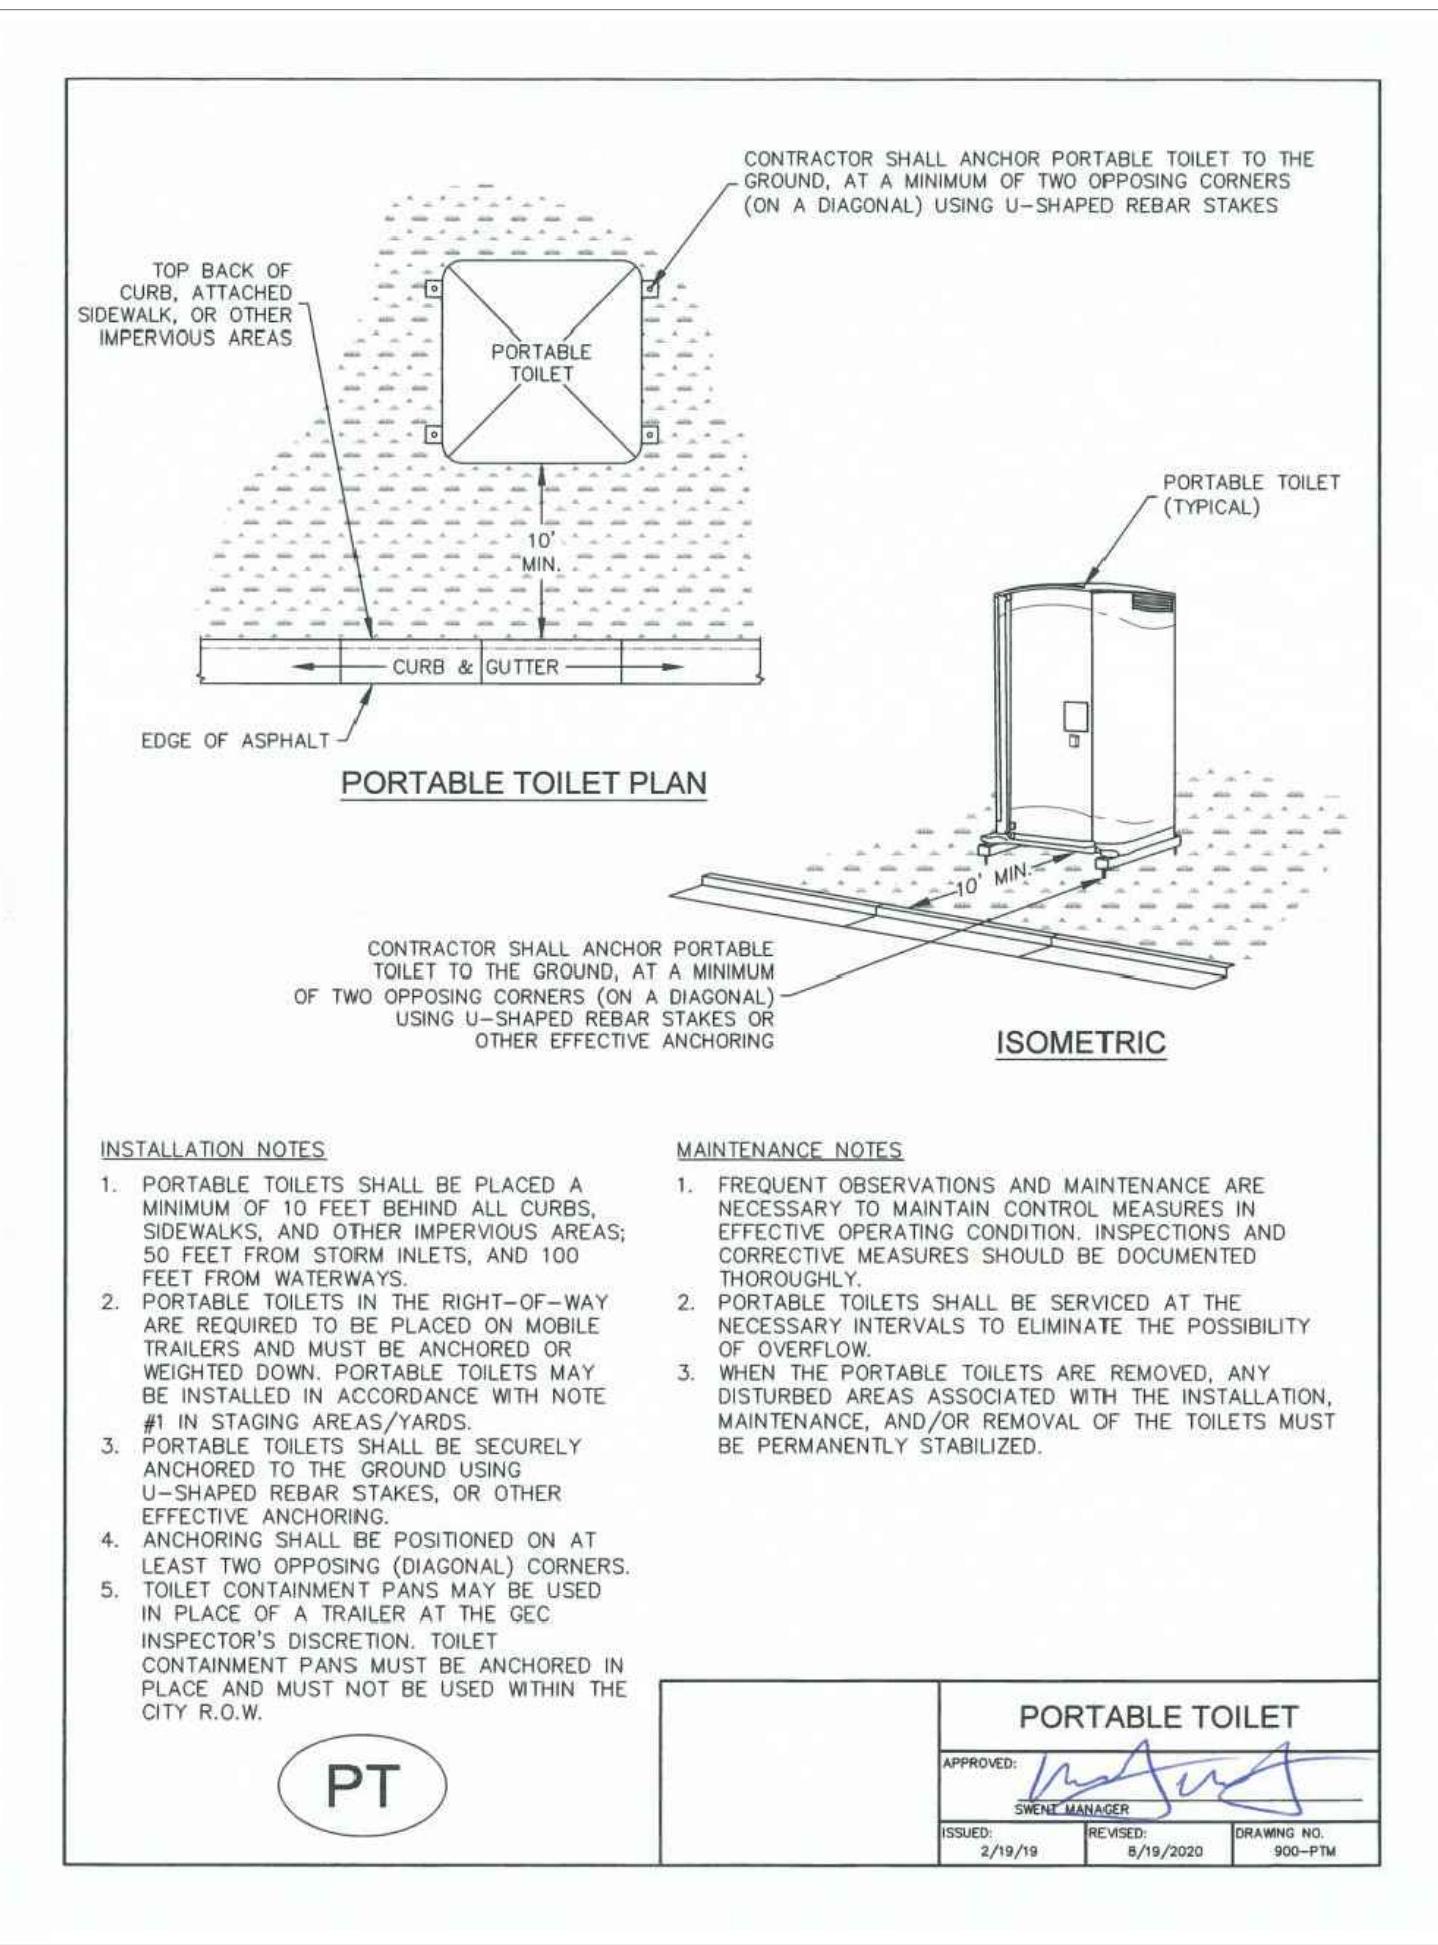
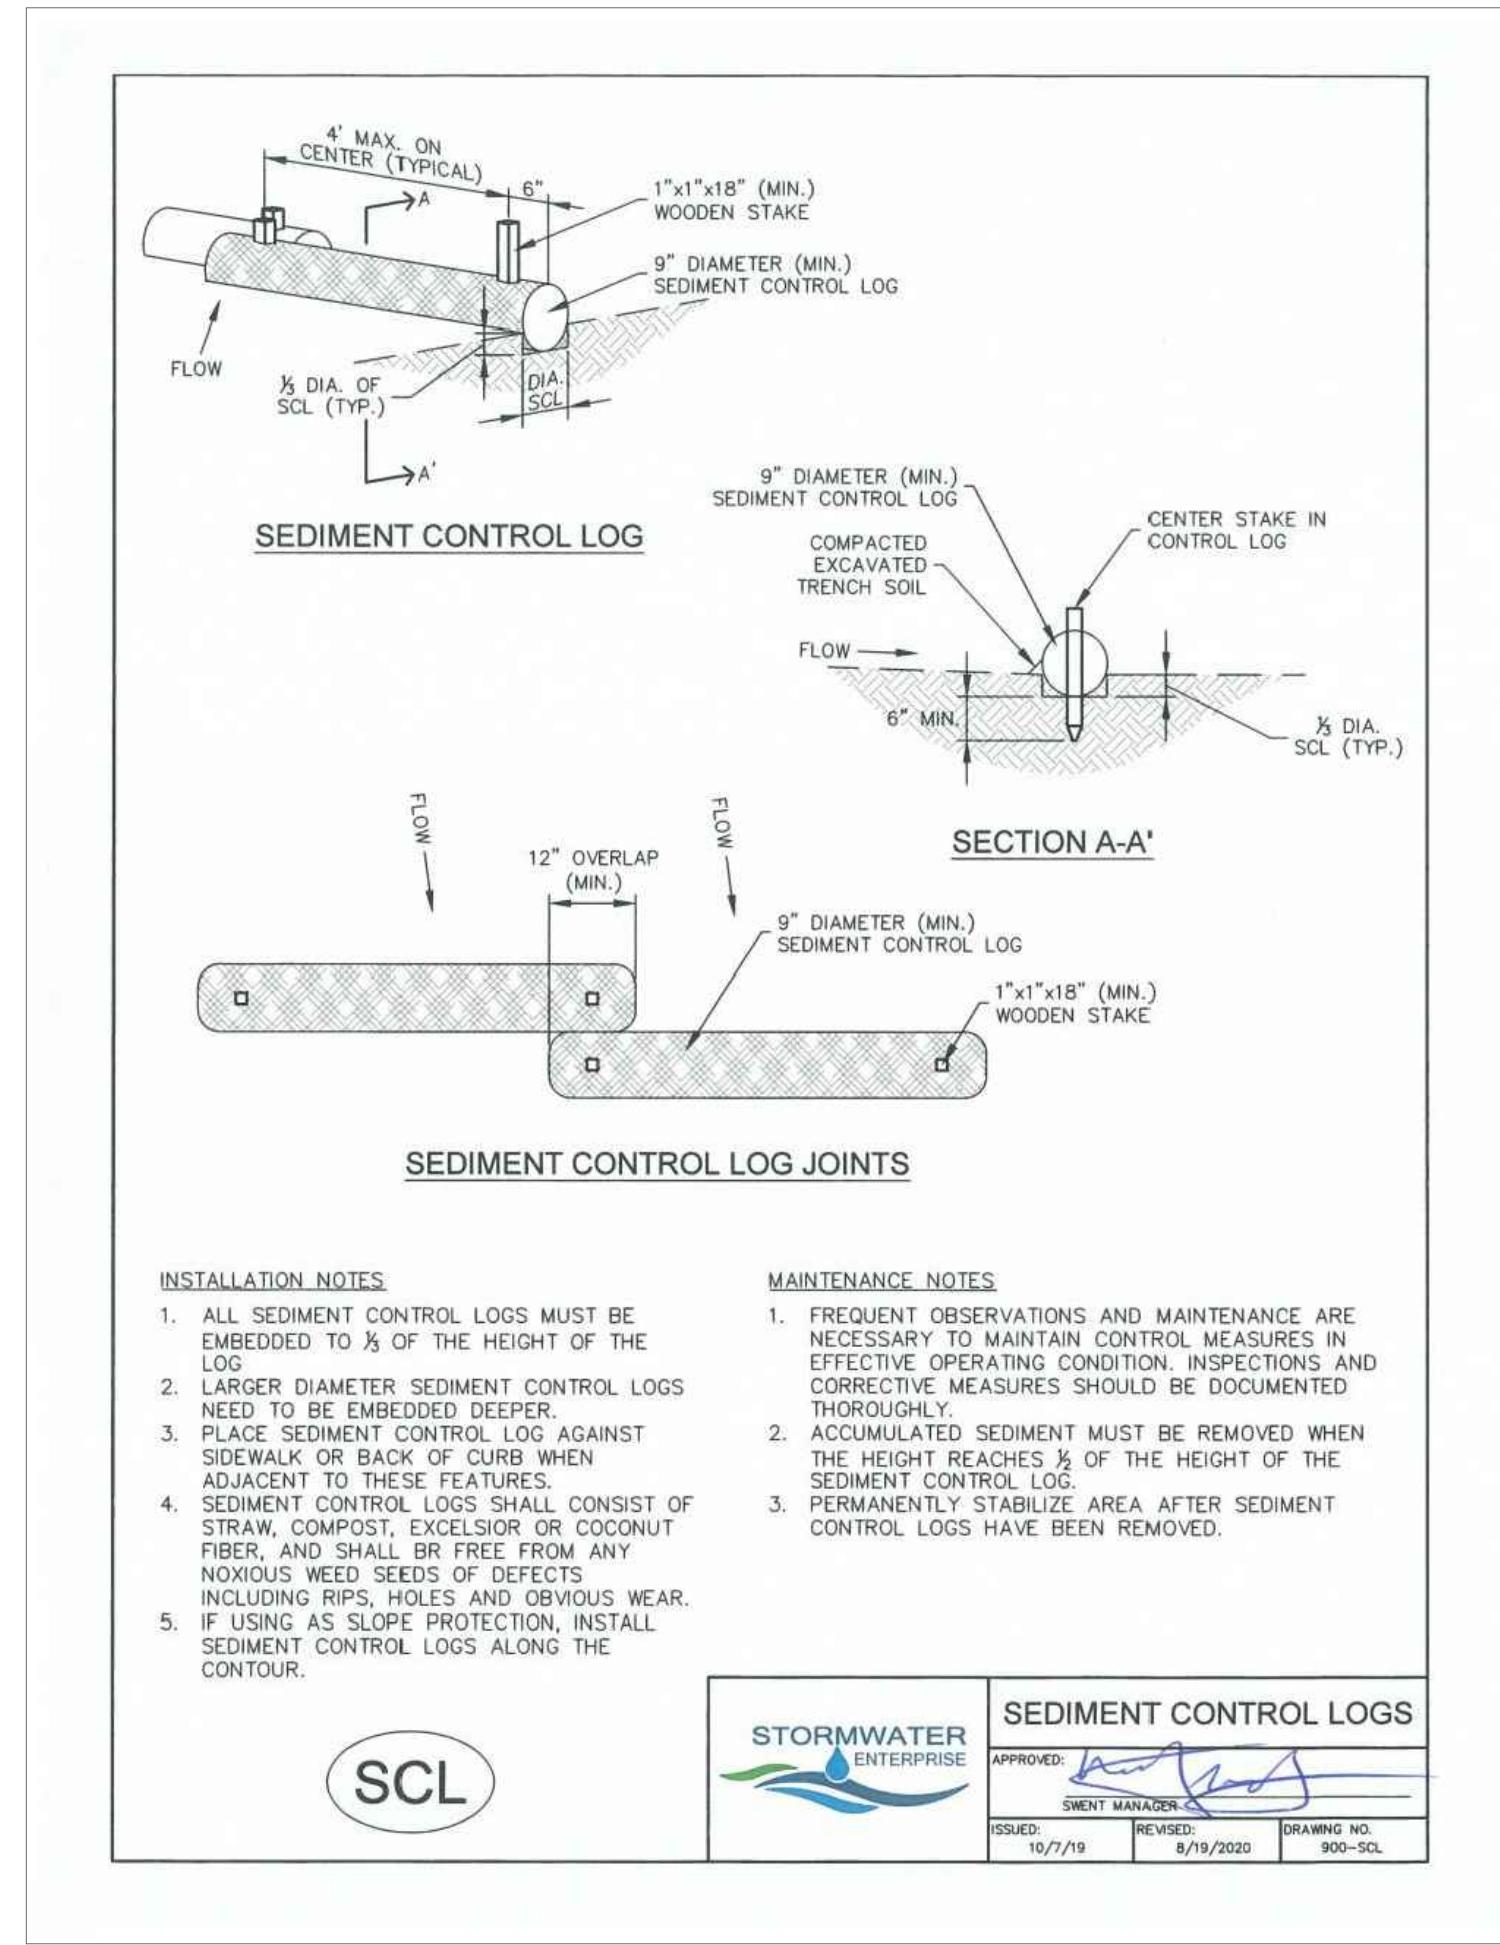
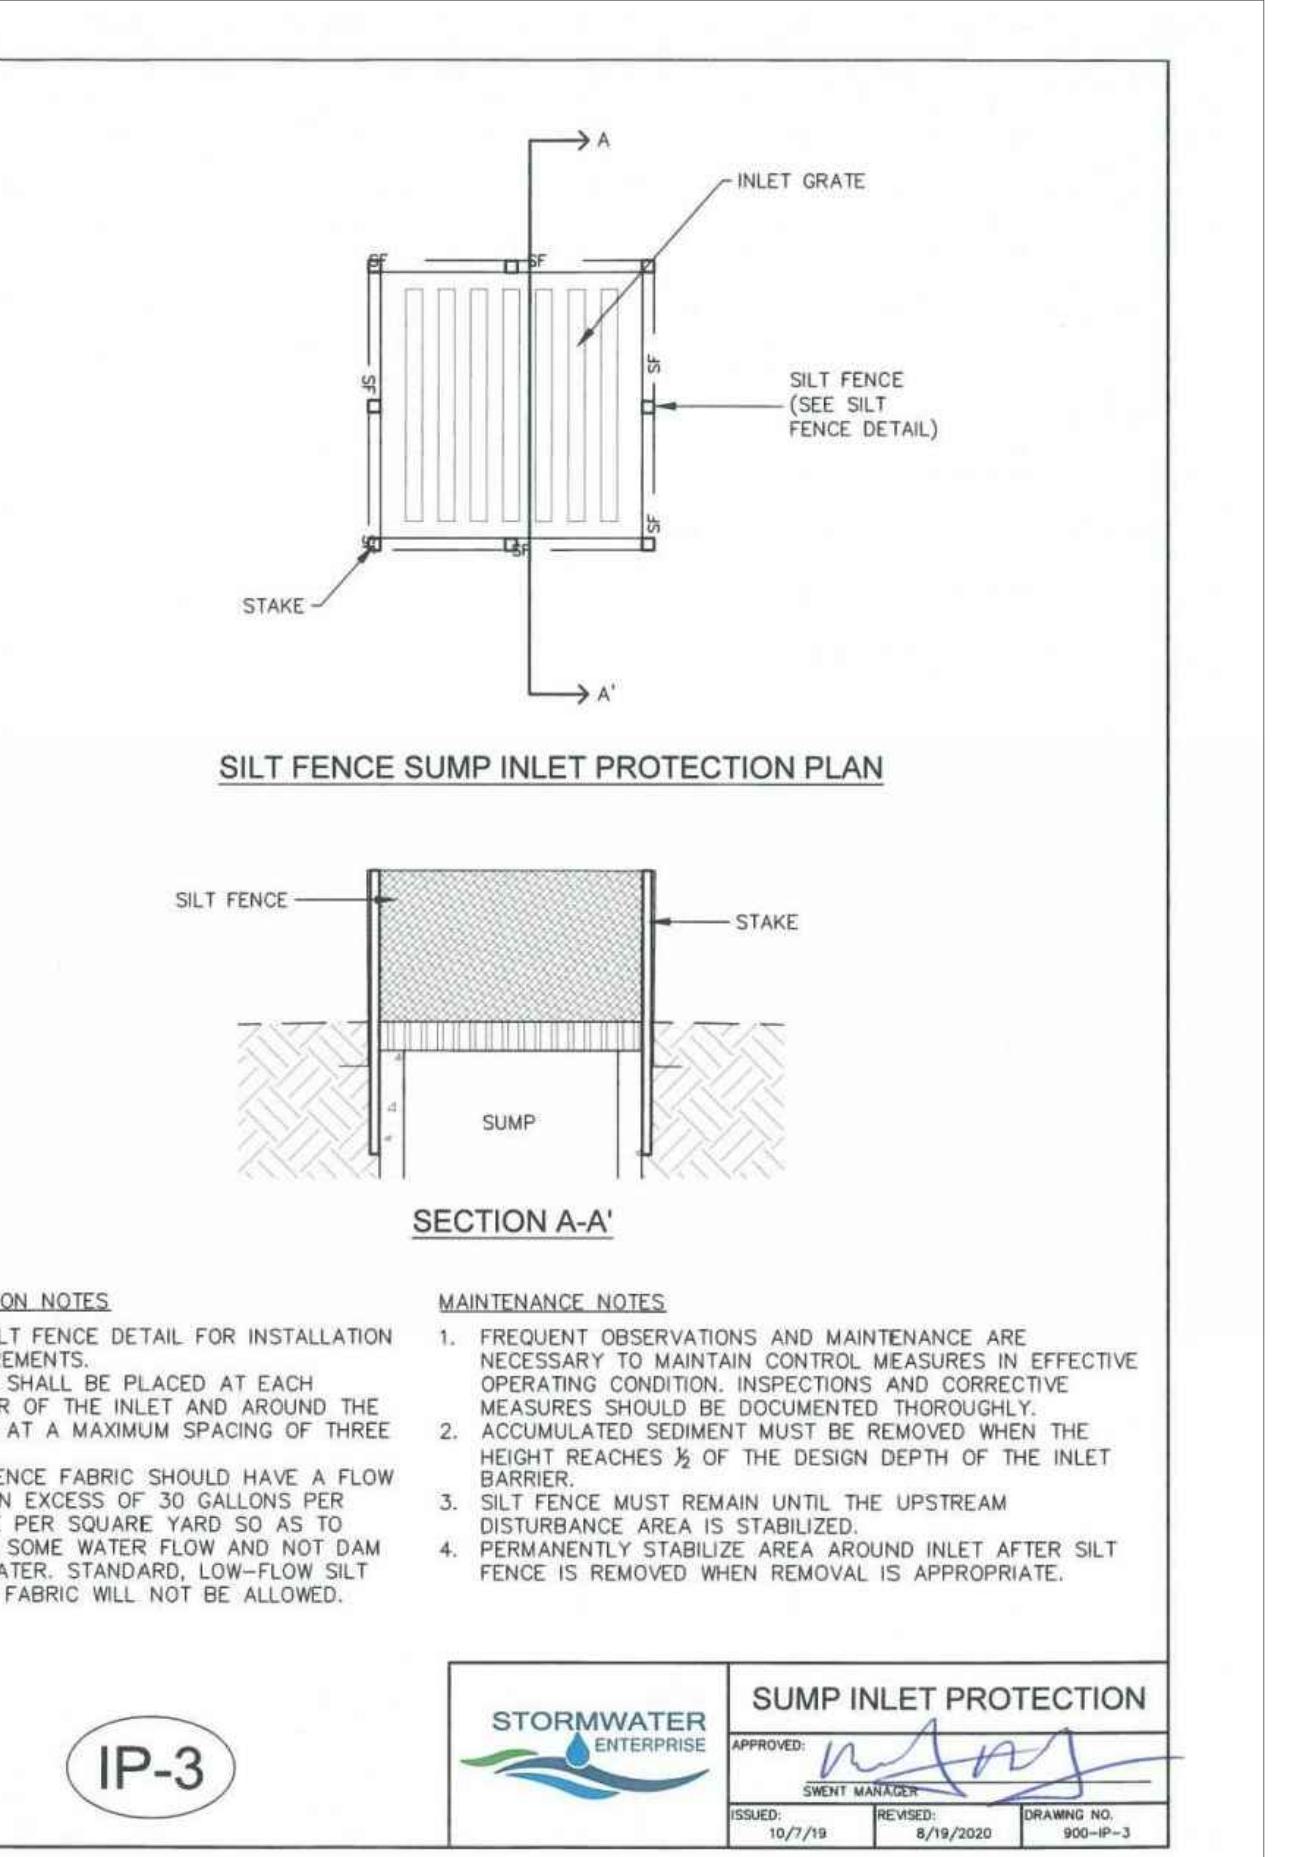
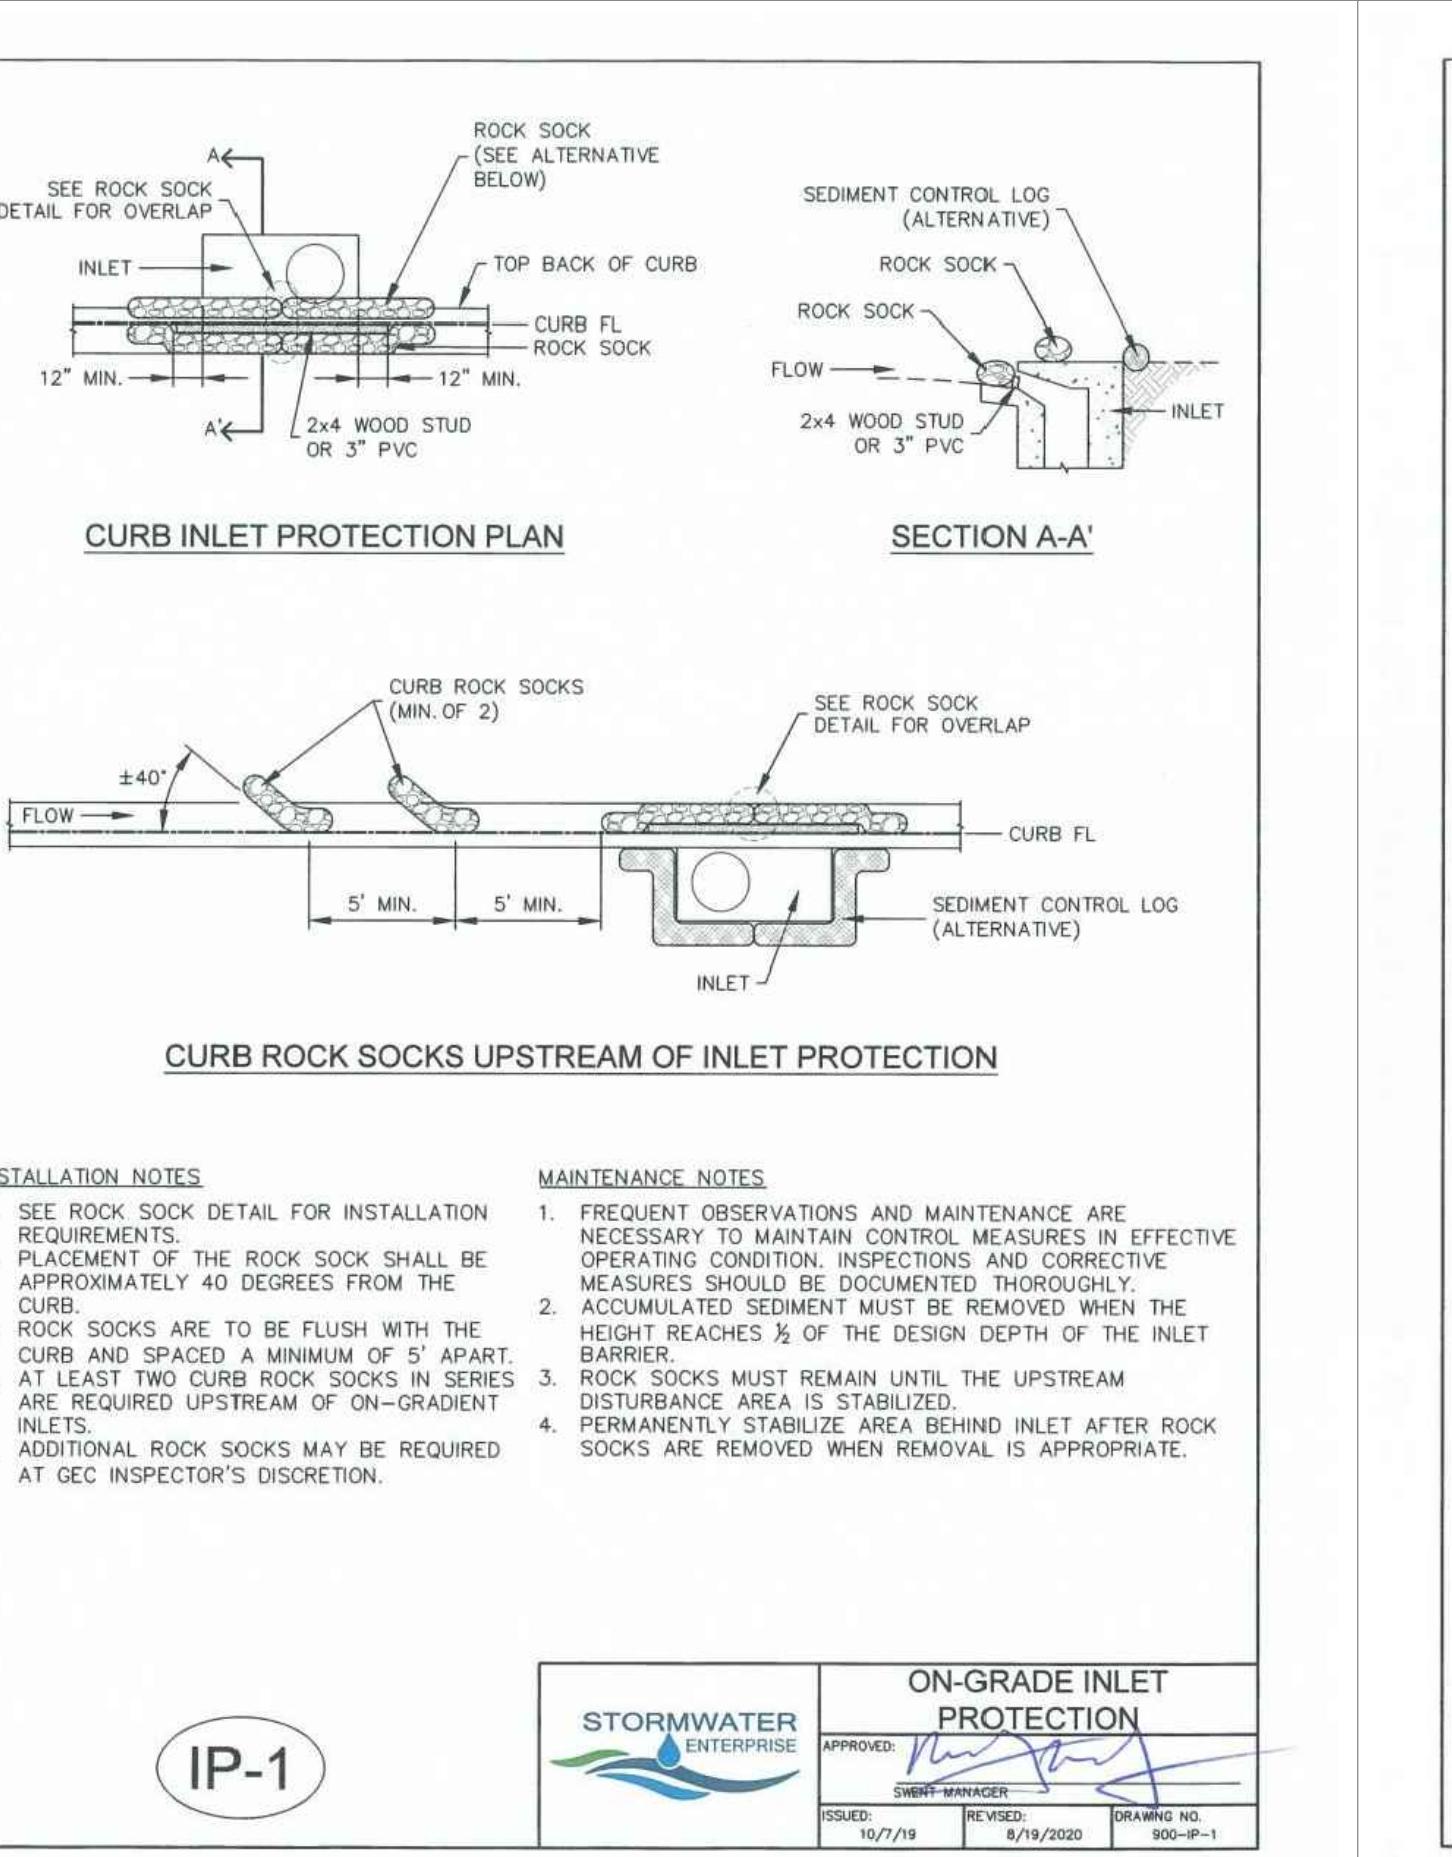
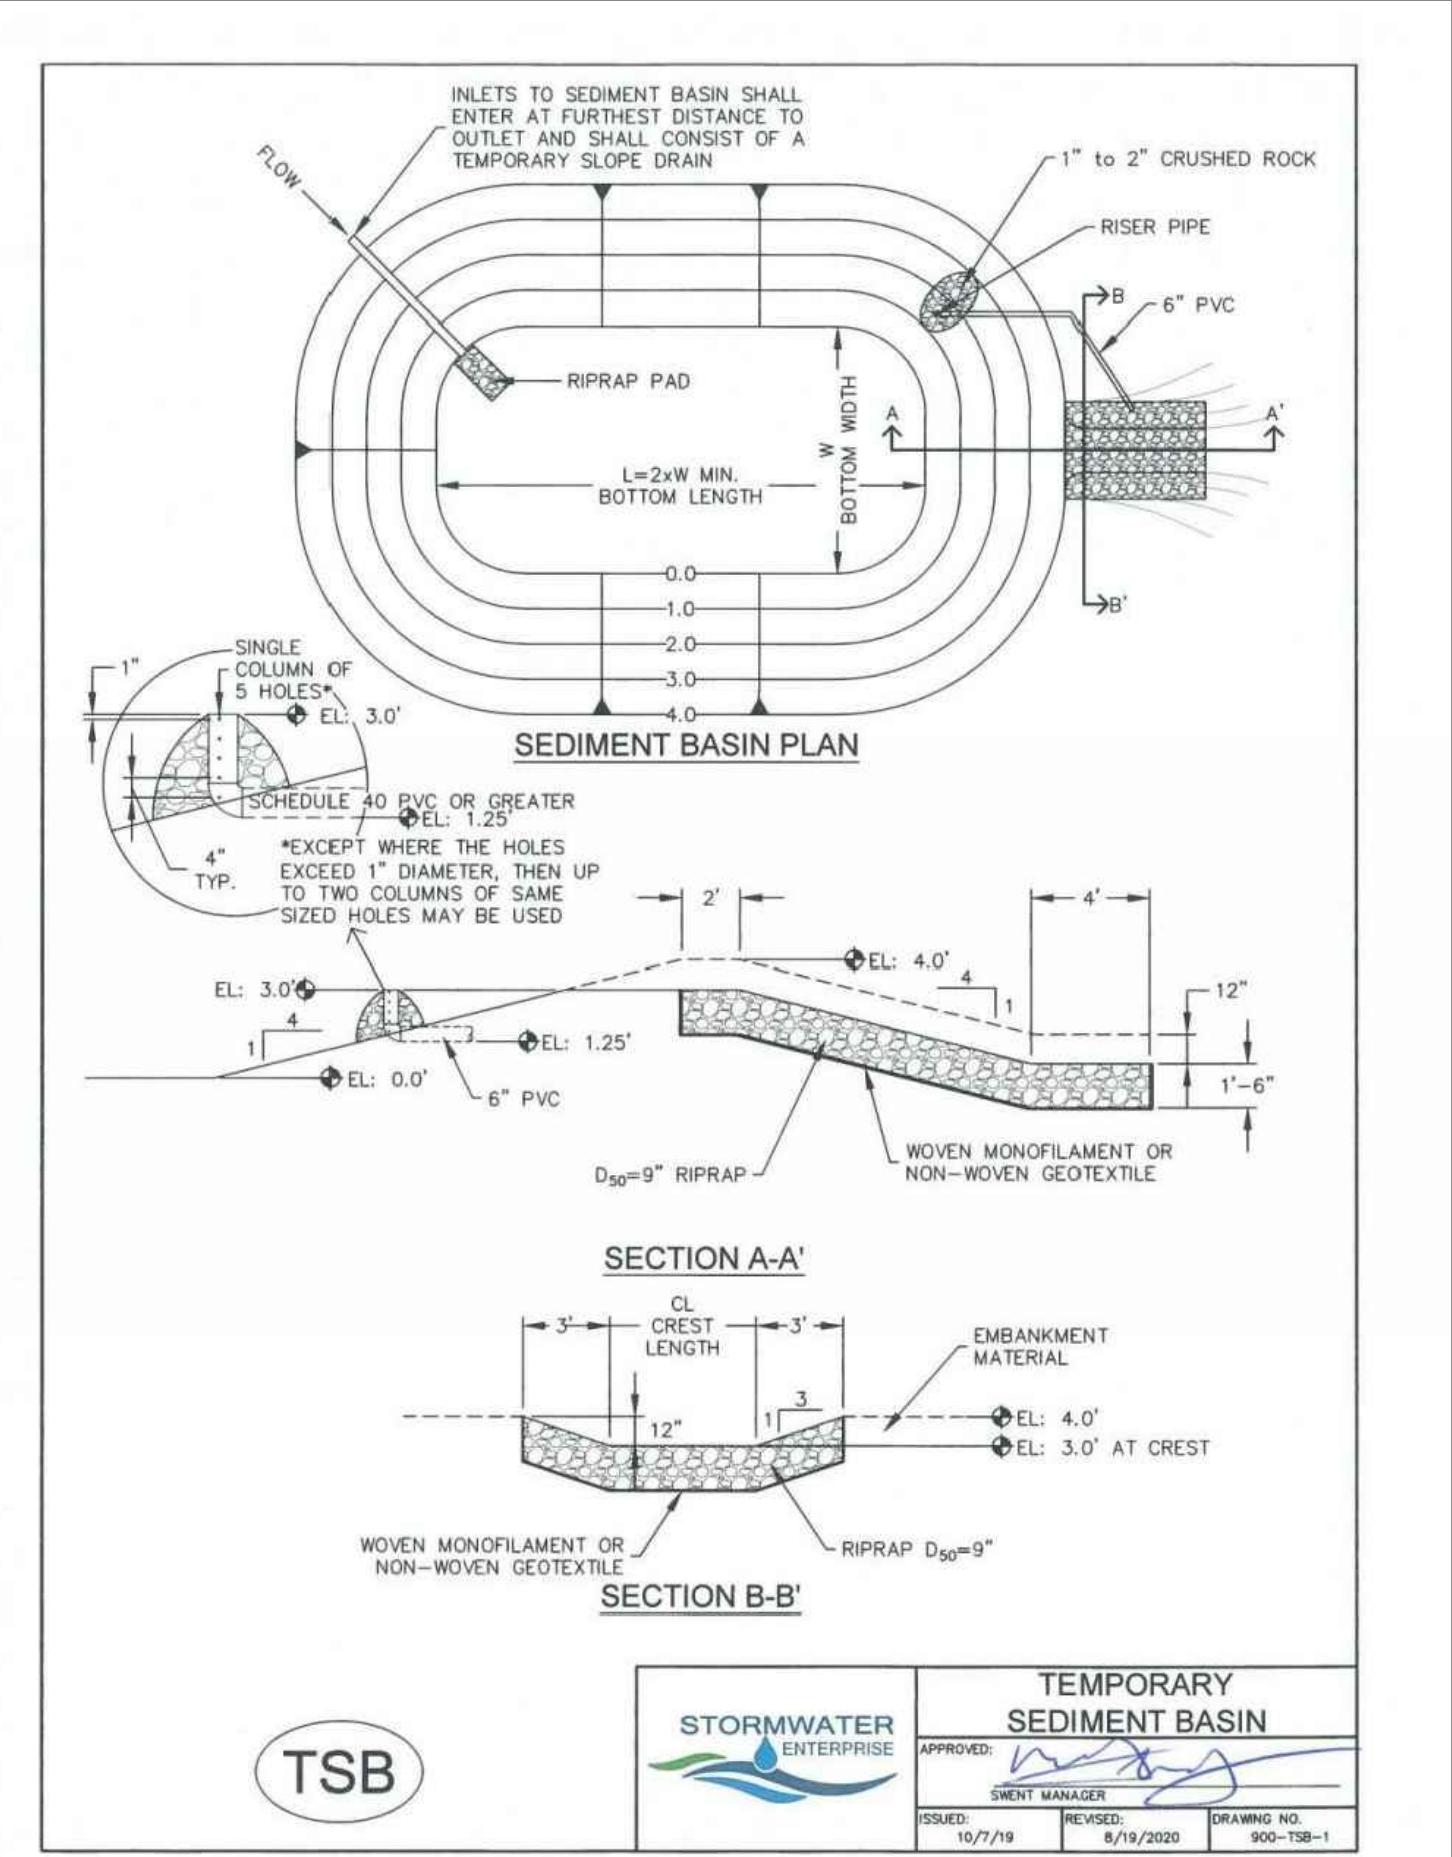
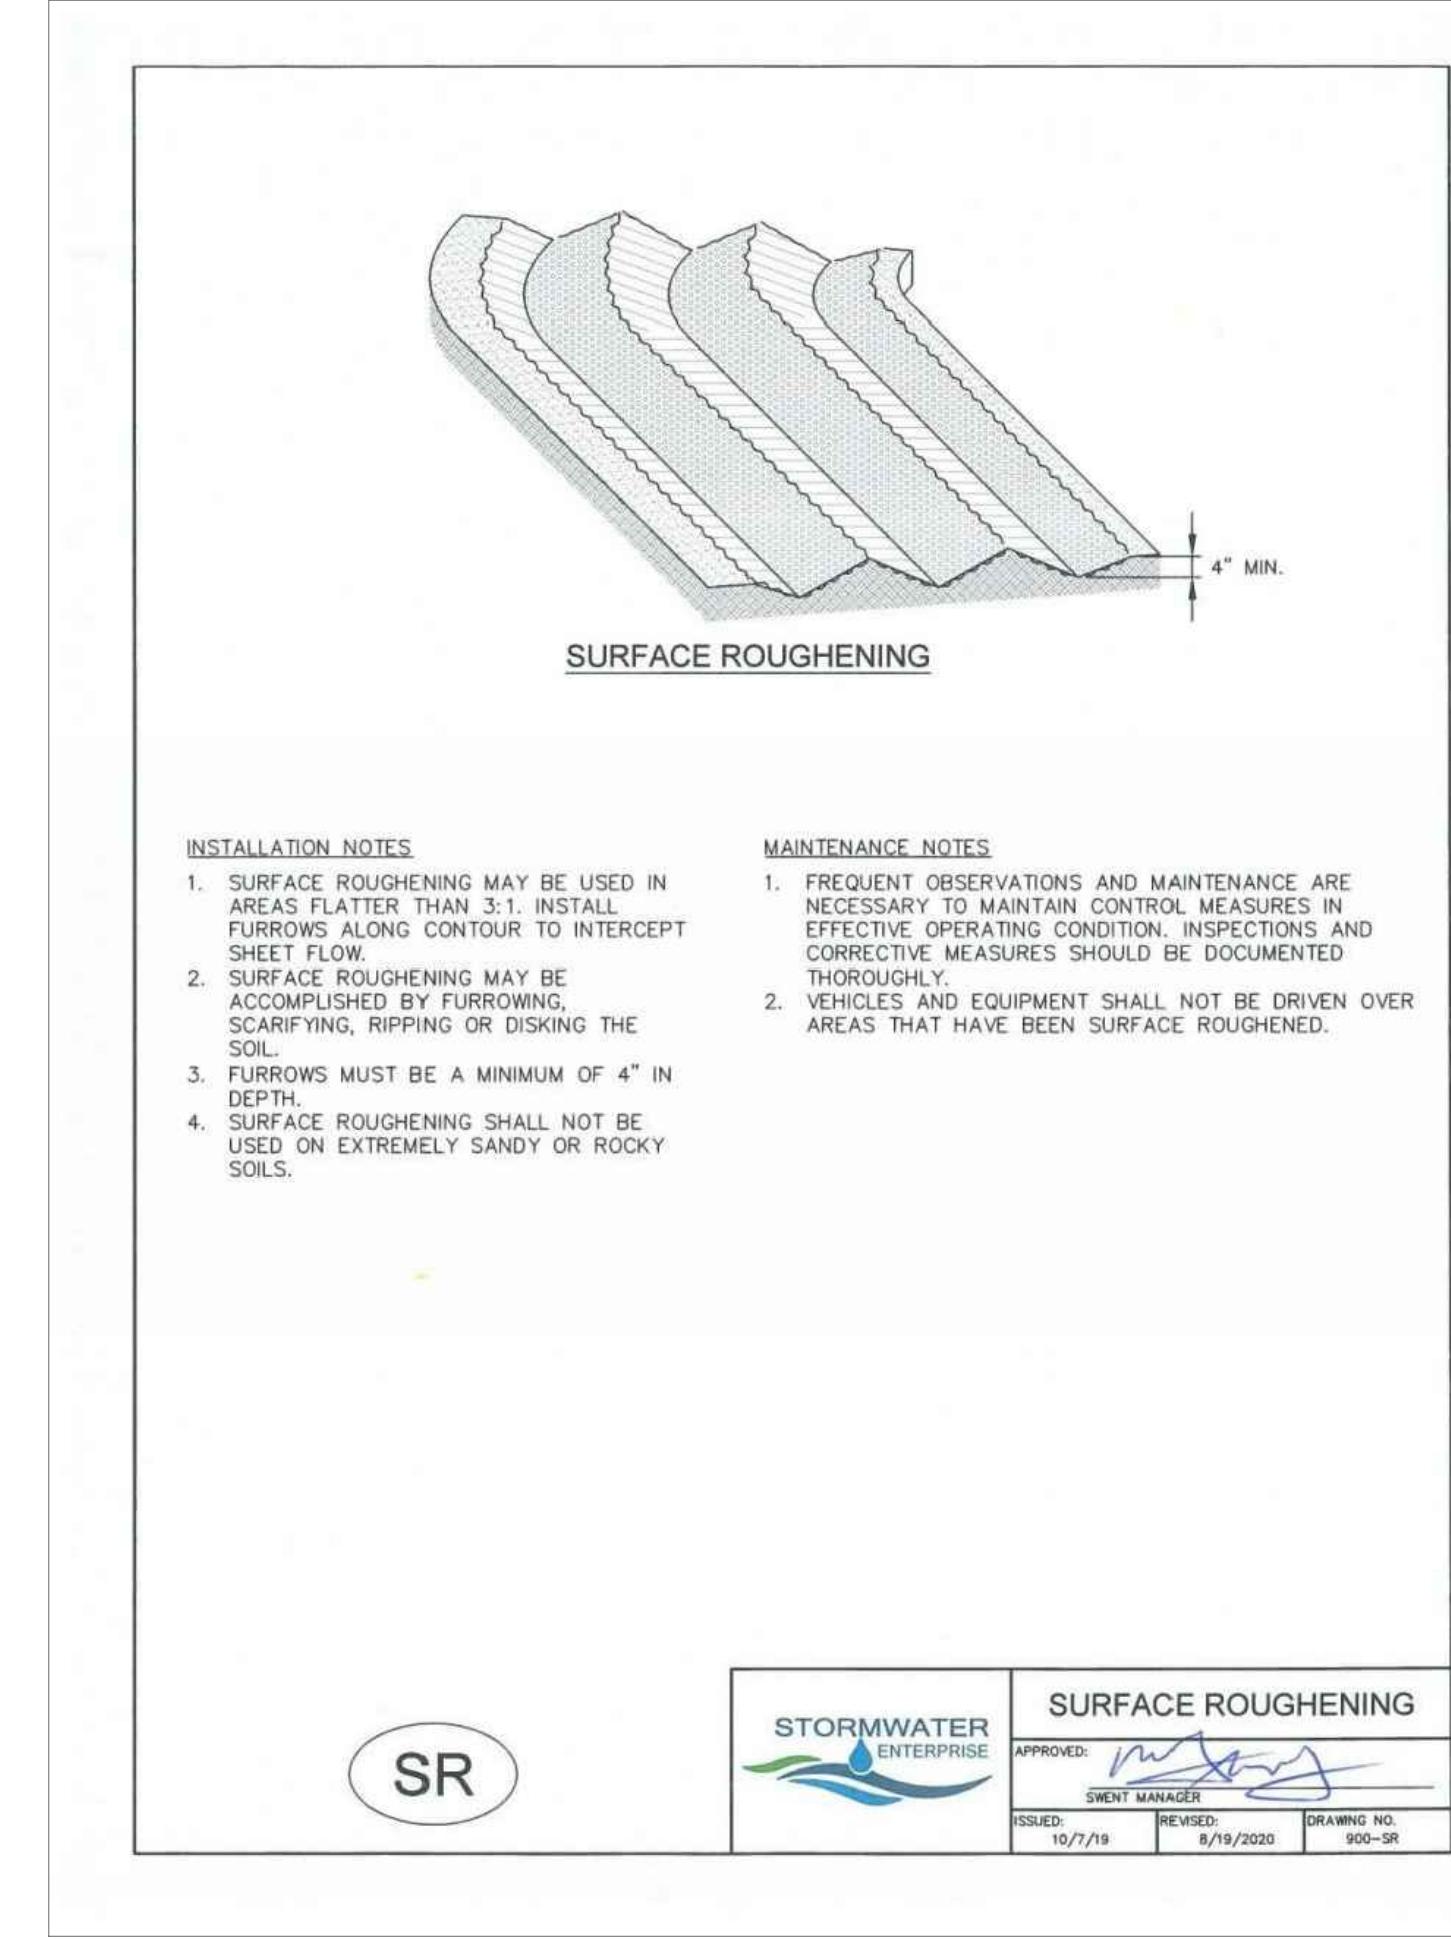


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V-SCALE N/A	
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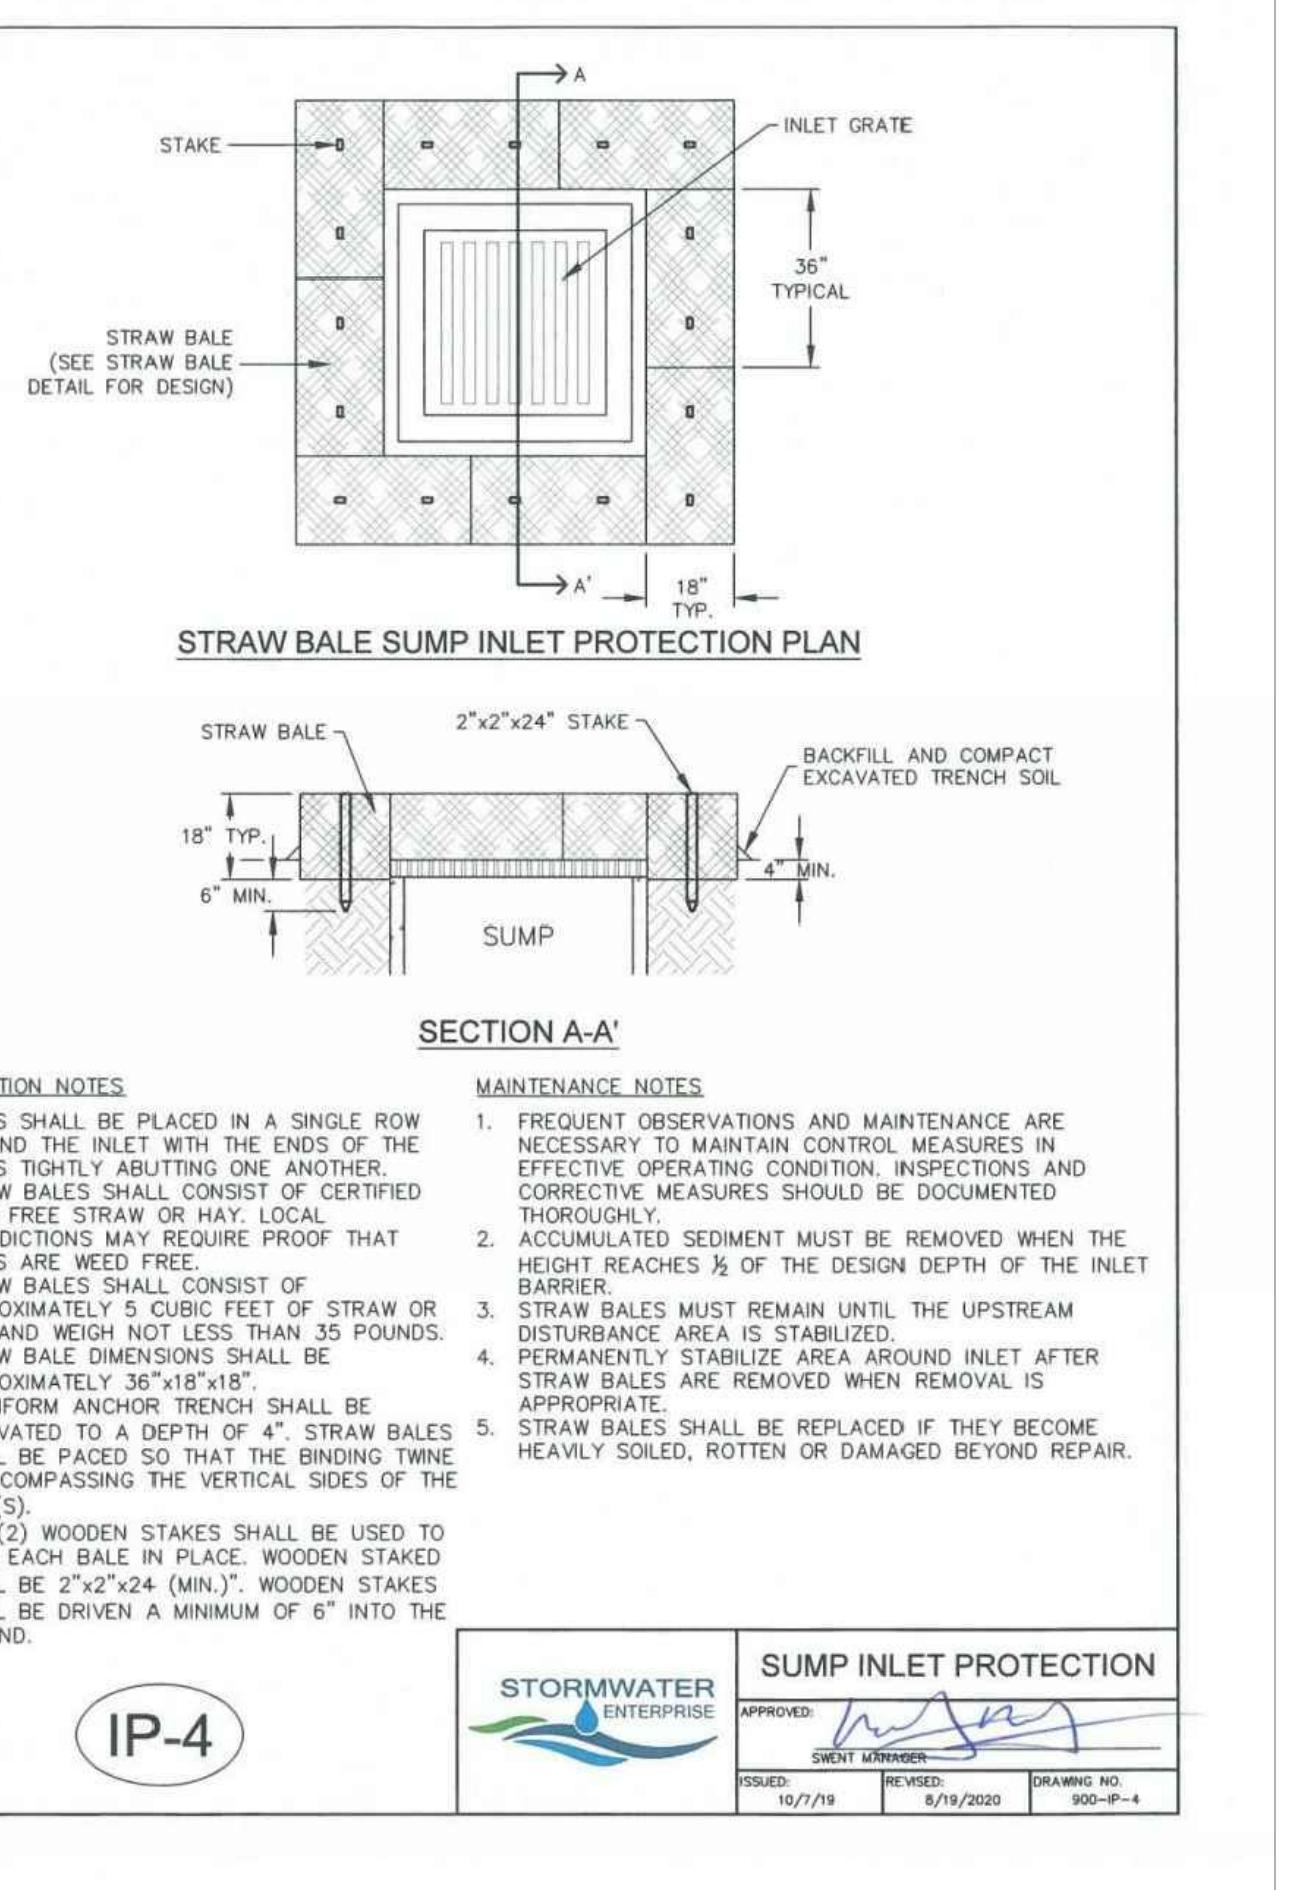
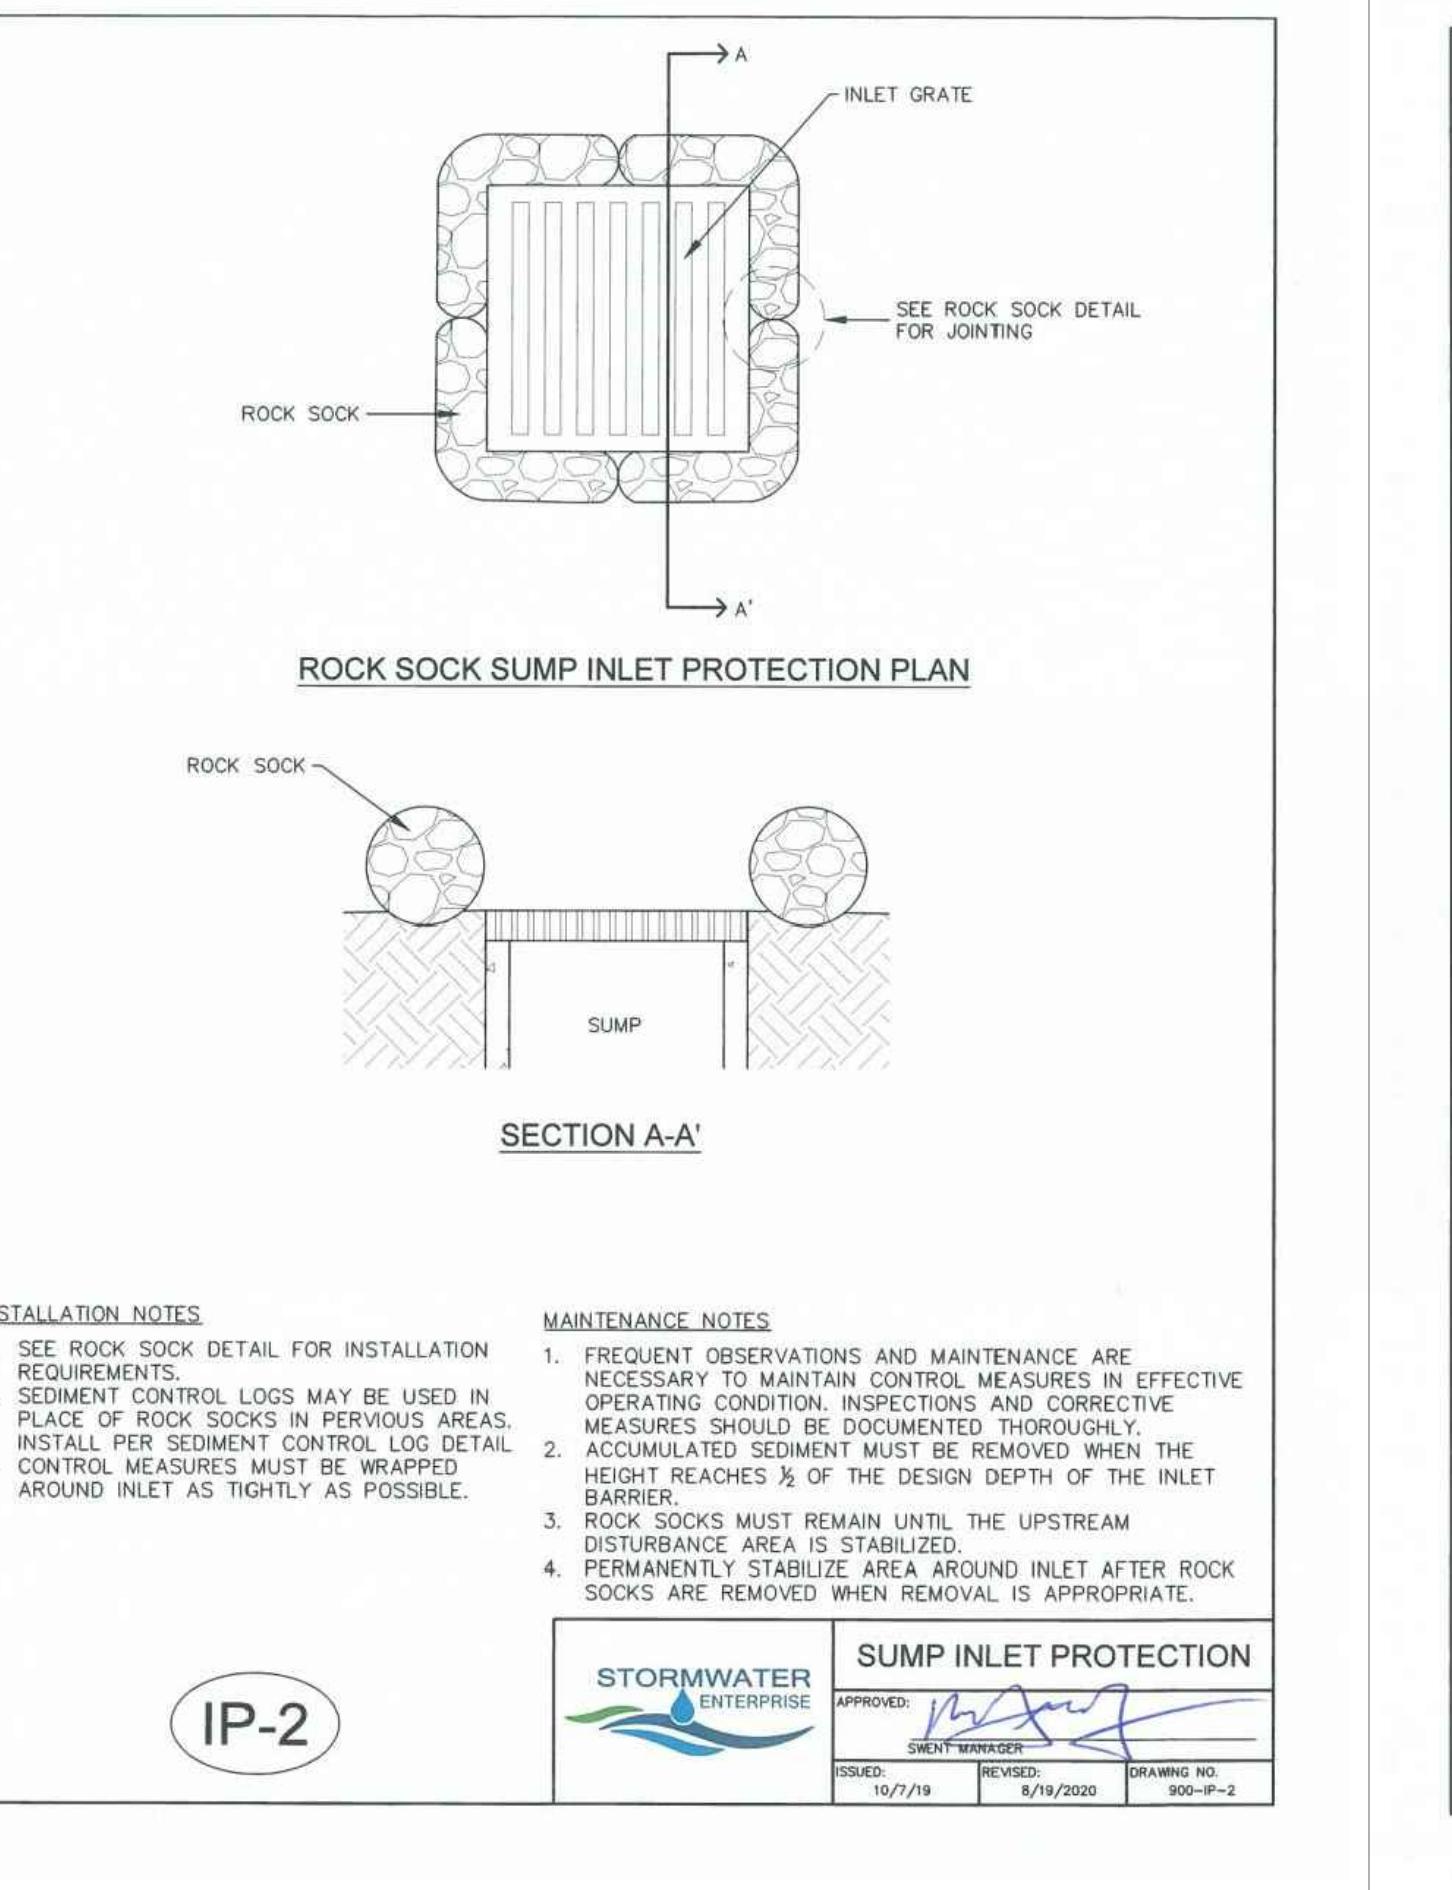
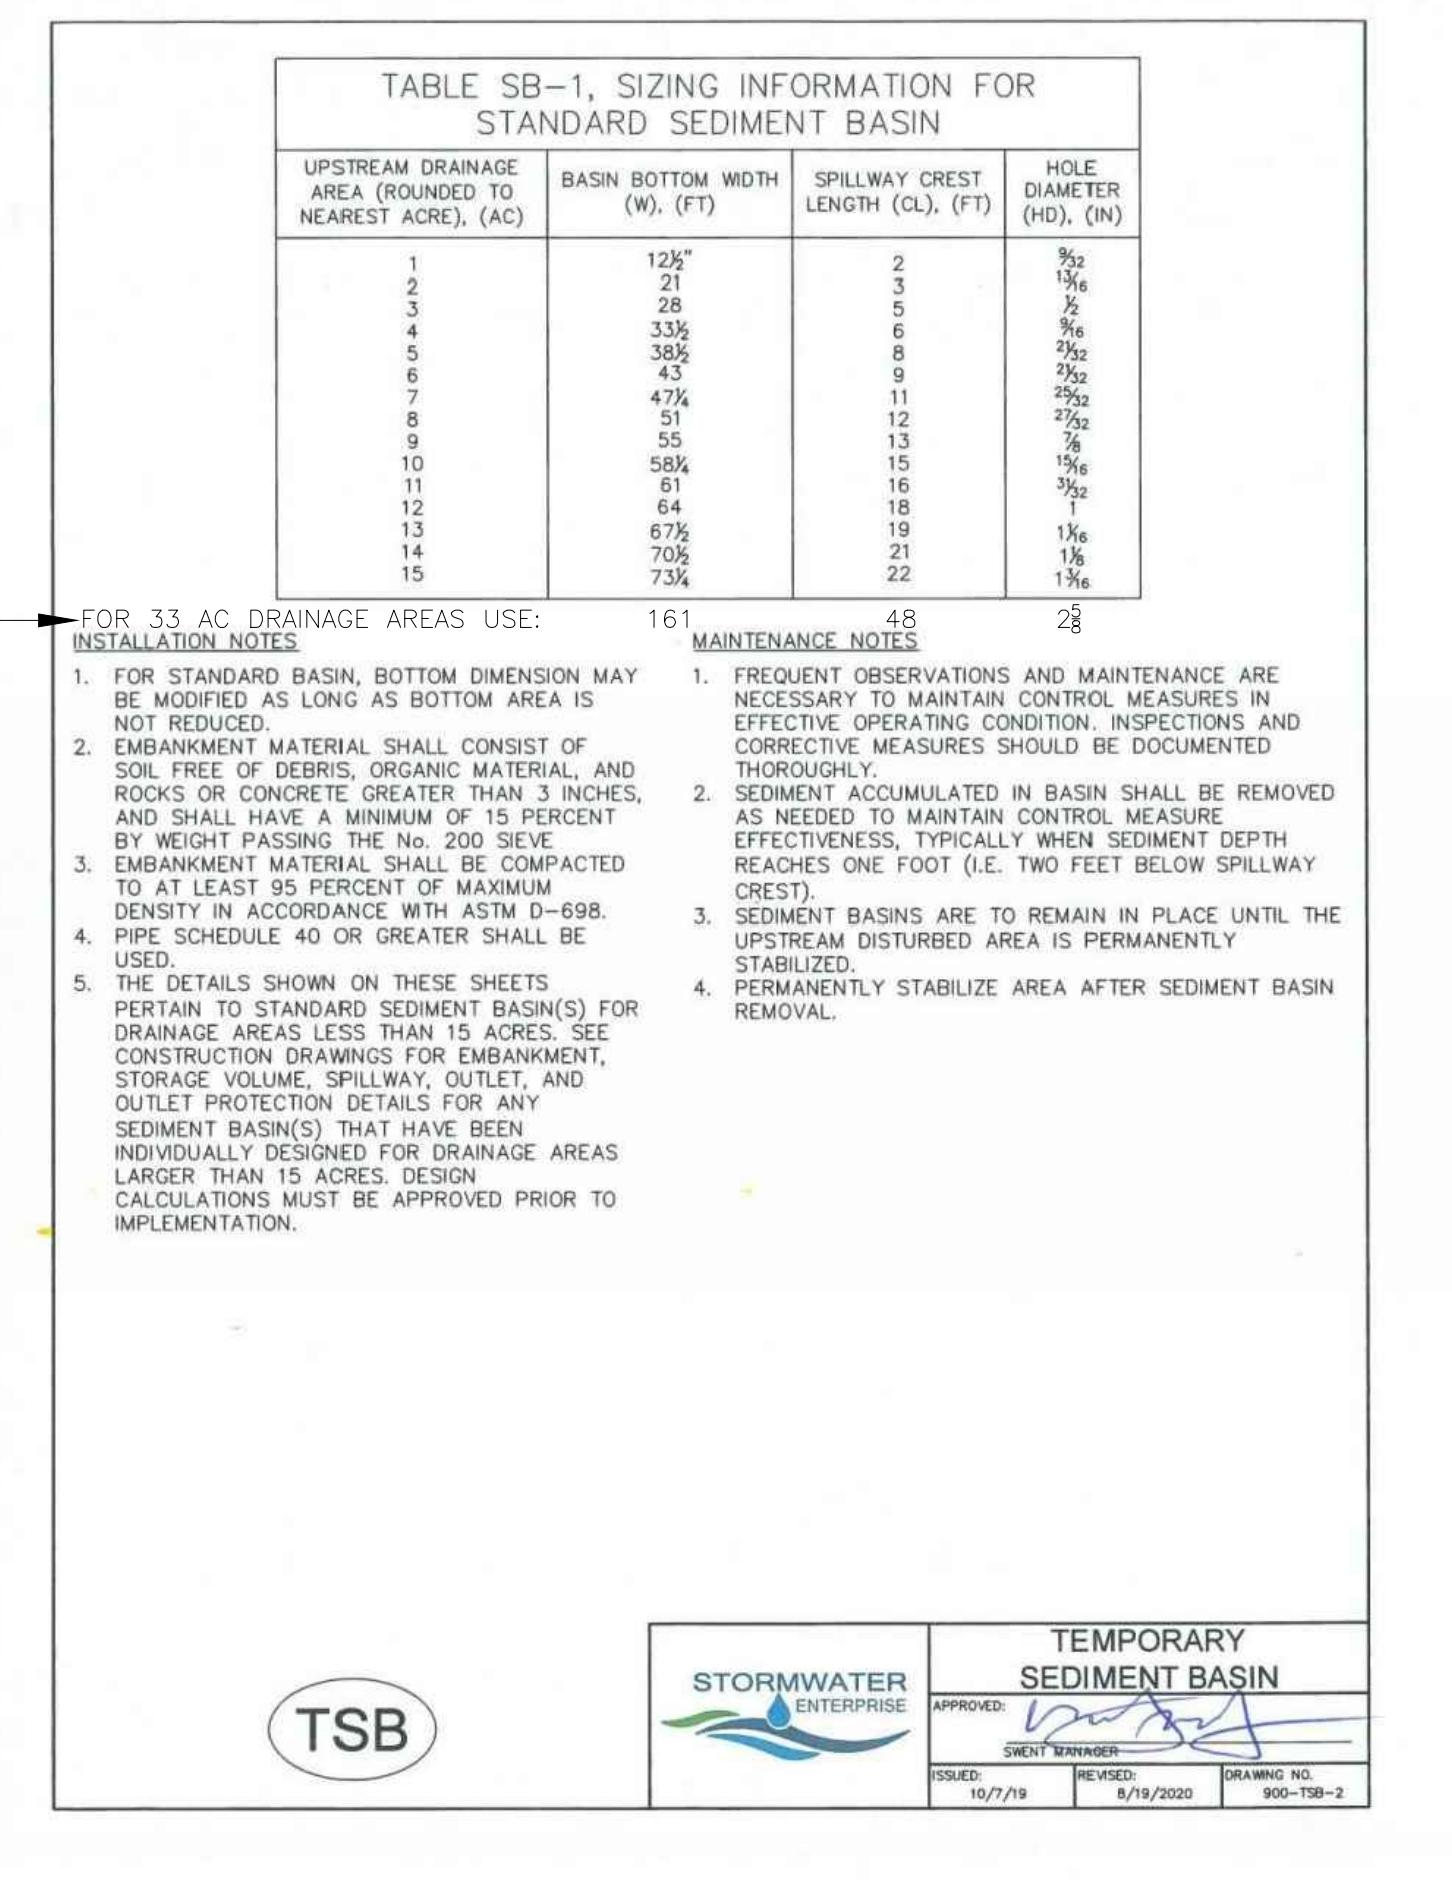
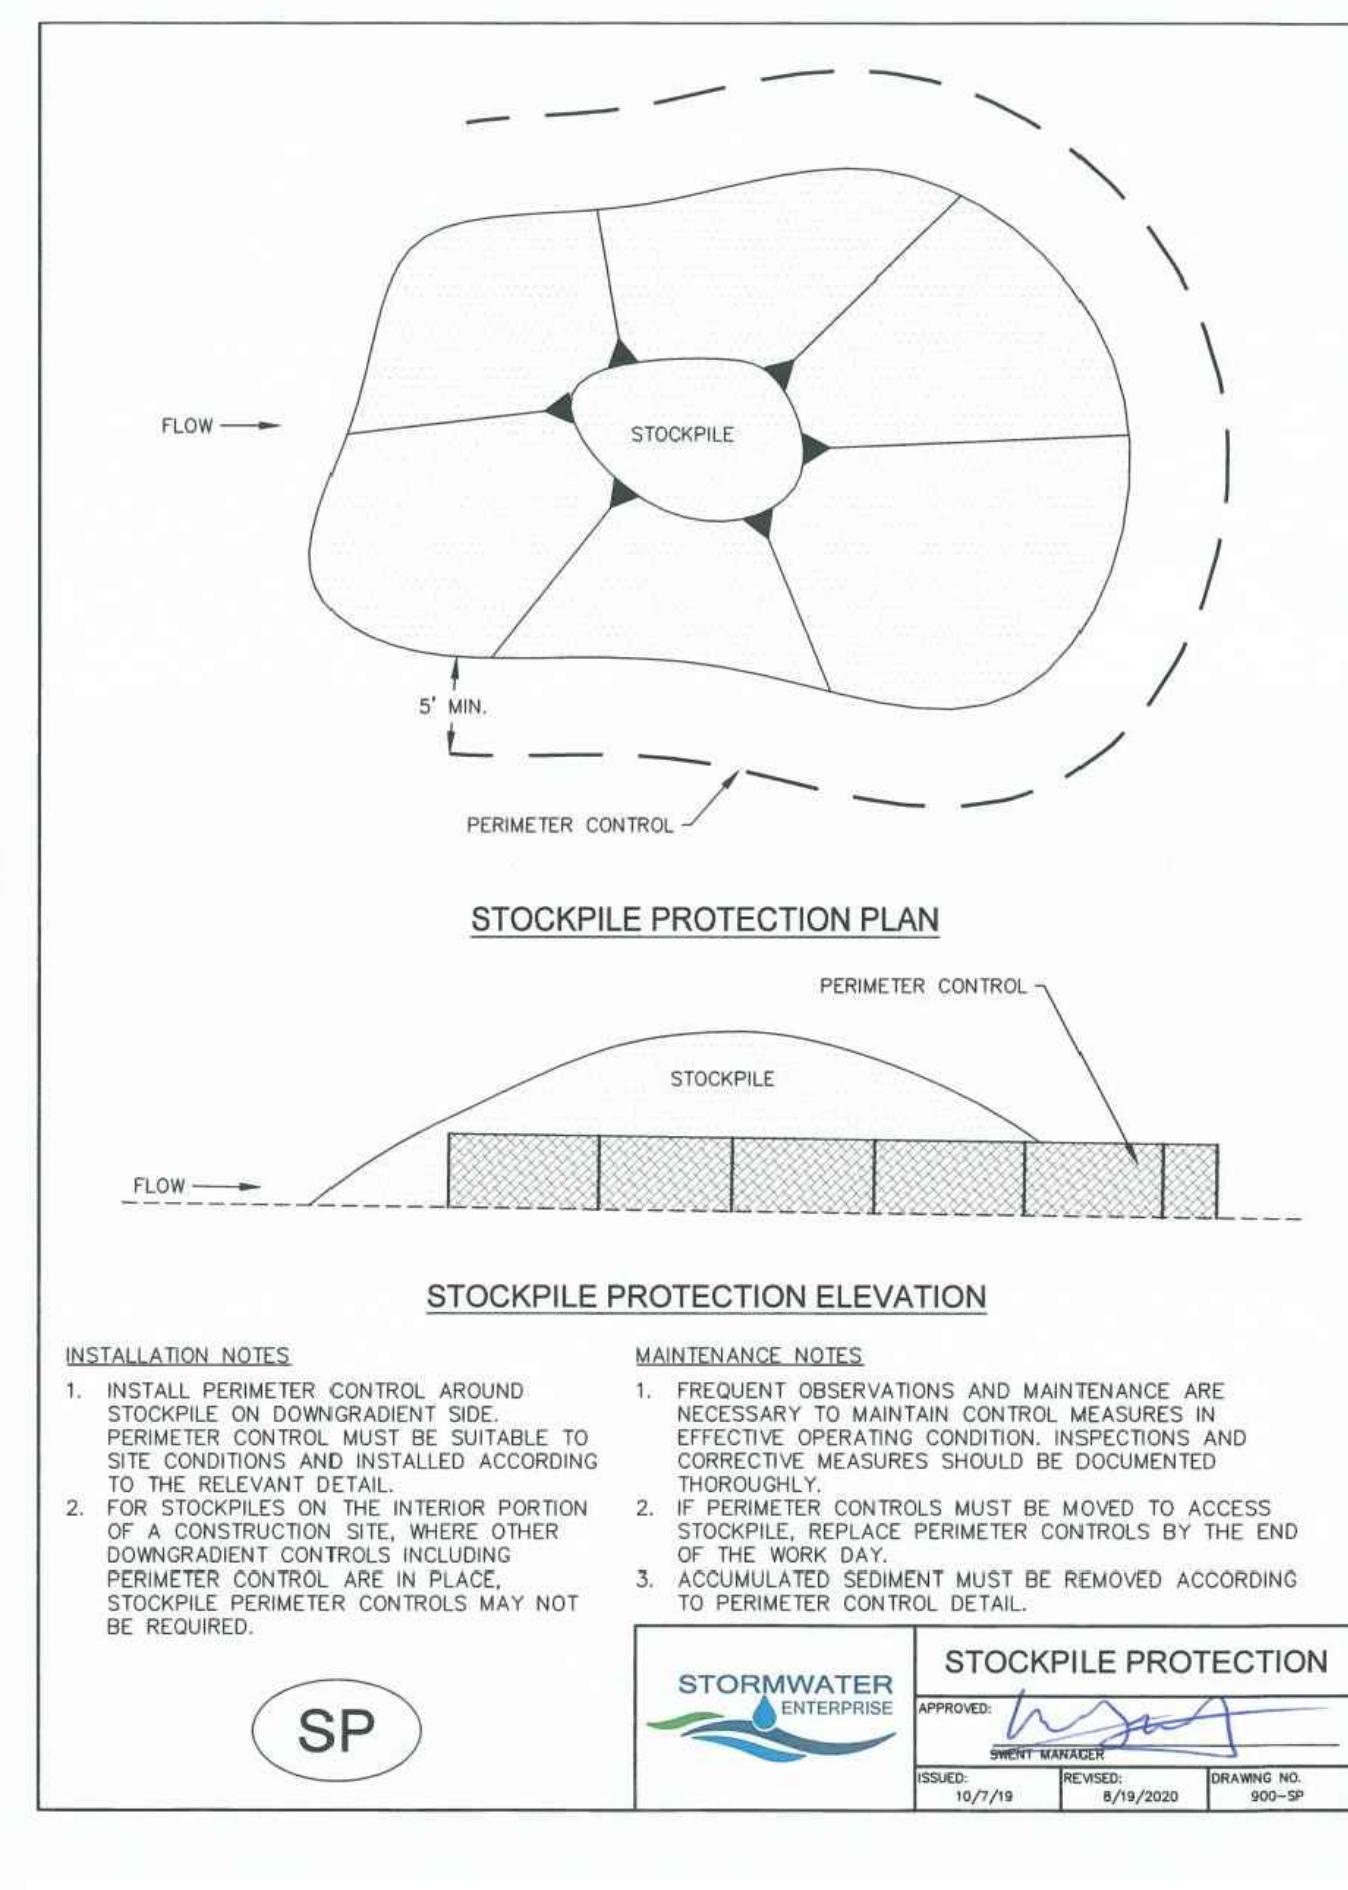


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	COLORADO SPRINGS, CO 80919
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REVISIONS:	NO.
DESCRIPTION:	REVIEWS

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PREPARED FOR: RMG—ROCKY MOUNTAIN GROUP ATTN: [Signature] 5085 LIST DR, #200 COLORADO SPRINGS, CO 80919 719.548.0600		



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SHEET NO. 15 OF 27	

Chapter 5
Native Vegetation Requirements and Guidelines

<p>SEEDING & MULCHING</p> <p>ALL SOIL TESTING, SOILS AMENDMENT AND FERTILIZER DOCUMENTATION, AND SEED LOAD AND BAG TICKETS MUST BE ADDED TO THE CSWMP.</p> <p>SOIL PREPARATION</p> <ol style="list-style-type: none"> 1. IN AREAS TO BE SEEDED, THE UPPER 6 INCHES OF THE SOIL MUST NOT BE HEAVILY COMPACTED, AND SOIL THAT IS FRIBLY COHESIVE, LESS THAN 85% DRY DENSITY, IS ACCEPTABLE. AREAS OF COMPACTION OR GENERAL CONSTRUCTION ACTIVITY MUST BE SCARIFIED TO A DEPTH OF 6 TO 12 INCHES PRIOR TO SPREADING TOPSOIL TO BREAK UP COMPACTED LAYERS AND PROVIDE A BLENDING ZONE BETWEEN DIFFERENT SOIL LAYERS. 2. AREAS TO BE PLANTED SHALL HAVE AT LEAST 4 INCHES OF TOPSOIL SUITABLE TO SUPPORT PLANT GROWTH. 3. THE CITY RECOMMENDS THAT EXISTING AND/OR IMPORTED TOPSOIL BE TESTED TO IDENTIFY SOIL DEFICIENCIES AND ANY SOIL AMENDMENTS NECESSARY TO ADDRESS THESE DEFICIENCIES. SOIL AMENDMENTS AND/OR FERTILIZERS SHOULD BE ADDED TO CORRECT TOPSOIL DEFICIENCIES BASED ON SOIL TESTING RESULTS. 4. TOPSOIL SHALL BE PROTECTED DURING THE CONSTRUCTION PERIOD TO RETAIN ITS STRUCTURE, AVOID COMPACTION, AND TO PREVENT EROSION AND CONTAMINATION. STRIPPED TOPSOIL MUST BE STORED IN AN AREA AWAY FROM MACHINERY AND CONSTRUCTION OPERATIONS, AND CARE MUST BE TAKEN TO PROTECT THE TOPSOIL FROM EXPOSURE AND WATER. TOPSOIL MUST NOT BE STRIPPED DURING UNDESIRABLE WORKING CONDITIONS (E.G. DURING WET WEATHER OR WHEN SOILS ARE SATURATED). TOPSOIL SHALL NOT BE STORED IN SWALES OR IN AREAS WITH POOR DRAINAGE. <p>SEEDING</p> <ol style="list-style-type: none"> 1. ALLOWABLE SEED MIXES ARE INCLUDED IN THE CITY OF COLORADO SPRINGS STORMWATER CONSTRUCTION MANUAL. ALTERNATIVE SEED MIXES ARE ACCEPTABLE IF INCLUDED IN AN APPROVED LANDSCAPING PLAN. 2. SEED SHOULD BE DRILL-SEEDED WHENEVER POSSIBLE. 3. BROADCAST SEEDED OR HYDRO-SEEDED WITH TACKIFIER MAY BE SUBSTITUTED ON SLOPES STEEPER THAN 3:1 OR ON OTHER AREAS AS PRACTICAL TO DRILL SEEDED. 4. SEEDED RATES MUST BE DOUBLED FOR BROADCAST SEEDED OR INCREASED BY 50% IF USING A BRILLION DRILL OR HYDRO-SEEDED. 5. BROADCAST SEEDED MUST BE LIGHTLY HAND-RAKED INTO THE SOIL. <p>MULCHING</p> <ol style="list-style-type: none"> 1. MULCHING SHOULD BE COMPLETED AS SOON AS PRACTICABLE AFTER SEEDED, HOWEVER PLANTED AREAS MUST BE MULCHED NO LATER THAN 14 DAYS AFTER PLANTING. 2. MULCHING REQUIREMENTS INCLUDE: <ul style="list-style-type: none"> ▪ THAT WHICH IS MULCHED - ONLY CERTIFIED WEED-FREE AND CERTIFIED SEEDED-FREE MULCH MAY BE USED. MULCH MUST BE APPLIED AT 2 TONS/ACRE AND ADEQUATELY SECURED BY CRIMPING AND/OR TACKIFIER. - CRIMPING MUST NOT BE USED ON SLOPES GREATER THAN 3:1 AND MULCH FIBERS MUST BE TUCKED INTO THE SOIL TO A DEPTH OF 3 TO 4 INCHES. - TACKIFIER MUST BE USED IN PLACE OF CRIMPING ON SLOPES STEEPER THAN 3:1. ▪ HYDRAULIC MULCHING - HYDRAULIC MULCHING IS AN OPTION ON STEEP SLOPES OR WHERE ACCESS IS LIMITED. - HYDRAULIC MULCHING IS NOT PRACTICAL AS A SEEDING METHOD FOR CONSTRUCTION OPERATION. - WOOD CELLULOSE FIBERS MIXED WITH WATER MUST BE APPLIED AT A RATE OF 2,000 TO 2,500 POUNDS/ACRE, AND TACKIFIER MUST BE APPLIED AT A RATE OF 100 POUNDS/ACRE. ▪ EROSION CONTROL BLANKET - EROSION CONTROL BLANKET MAY BE USED IN PLACE OF TRADITIONAL MULCHING METHODS. 	<p>Table 5-1. El Paso County Conservation District All-Purpose Mix for Upland, Transition and Permanent Control Measure Areas</p> <table border="1" style="width: 100%; border-collapse: collapse;"> <thead> <tr> <th rowspan="2">Common Name</th> <th rowspan="2">Scientific Name</th> <th rowspan="2">Growth Season / Form</th> <th rowspan="2">% of Mix</th> <th colspan="3">Pounds PLS</th> </tr> <tr> <th>• Irrigated broadcast</th> <th>• Non-irrigated broadcast</th> <th>• Non-irrigated drilled</th> </tr> </thead> <tbody> <tr> <td>Bluestem, big</td> <td><i>Andropogon gerardii</i></td> <td>Warm, sod</td> <td>20</td> <td>4.4</td> <td>2.2</td> <td>1.1</td> </tr> <tr> <td>Grama, blue</td> <td><i>Bouteloua gracilis</i></td> <td>Warm, bunch</td> <td>10</td> <td>0.5</td> <td>0.25</td> <td>0.13</td> </tr> <tr> <td>Green needlegrass²</td> <td><i>Nassella viridula</i></td> <td>Cool, bunch</td> <td>10</td> <td>2</td> <td>1</td> <td>0.5</td> </tr> <tr> <td>Wheatgrass, western²</td> <td><i>Pascopyrum smithii</i></td> <td>Cool, sod</td> <td>20</td> <td>6.4</td> <td>3.2</td> <td>1.6</td> </tr> <tr> <td>Grama, sideoats</td> <td><i>Bouteloua curtipendula</i></td> <td>Warm, bunch</td> <td>10</td> <td>2</td> <td>1</td> <td>0.5</td> </tr> <tr> <td>Switchgrass²</td> <td><i>Panicum virgatum</i></td> <td>Warm, bunch/sod</td> <td>10</td> <td>0.8</td> <td>0.4</td> <td>0.2</td> </tr> <tr> <td>Prairie sandreed</td> <td><i>Calimovilfa longifolia</i></td> <td>Warm, sod</td> <td>10</td> <td>1.2</td> <td>0.6</td> <td>0.3</td> </tr> <tr> <td>Yellow indiangrass²</td> <td><i>Sorghastrum nutans</i></td> <td>Warm, sod</td> <td>10</td> <td>2</td> <td>1</td> <td>0.5</td> </tr> <tr> <td colspan="4"></td> <td>Seed rate (lbs PLS/acre)</td> <td>19.3</td> <td>9.7</td> </tr> <tr> <td colspan="4"></td> <td></td> <td></td> <td>4.8</td> </tr> </tbody> </table> <p><small>¹For portions of facilities located near or on the bottom or where wet soil conditions occur. Planting of potted nursery stock wetland plants 2-foot on-center is recommended for sites with wetland hydrology.</small></p> <p><small>²Species that will do well in the bottom of pond areas.</small></p>	Common Name	Scientific Name	Growth Season / Form	% of Mix	Pounds PLS			• Irrigated broadcast	• Non-irrigated broadcast	• Non-irrigated drilled	Bluestem, big	<i>Andropogon gerardii</i>	Warm, sod	20	4.4	2.2	1.1	Grama, blue	<i>Bouteloua gracilis</i>	Warm, bunch	10	0.5	0.25	0.13	Green needlegrass ²	<i>Nassella viridula</i>	Cool, bunch	10	2	1	0.5	Wheatgrass, western ²	<i>Pascopyrum smithii</i>	Cool, sod	20	6.4	3.2	1.6	Grama, sideoats	<i>Bouteloua curtipendula</i>	Warm, bunch	10	2	1	0.5	Switchgrass ²	<i>Panicum virgatum</i>	Warm, bunch/sod	10	0.8	0.4	0.2	Prairie sandreed	<i>Calimovilfa longifolia</i>	Warm, sod	10	1.2	0.6	0.3	Yellow indiangrass ²	<i>Sorghastrum nutans</i>	Warm, sod	10	2	1	0.5					Seed rate (lbs PLS/acre)	19.3	9.7							4.8
Common Name	Scientific Name					Growth Season / Form	% of Mix	Pounds PLS																																																																									
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Chapter 5
Native Vegetation Requirements and Guidelines

<p>RMG—ROCKY MOUNTAIN GROUP</p> <p>ATTN: 5085 LIST DR, #200 COLORADO SPRINGS, CO 80919 719.548.0600</p>	<p>PREPARED FOR: UNTIL SUCH TIME AS THESE DRAWINGS ARE APPROVED BY THE APPROPRIATE REVIEWING AGENCIES. TERRA NOVA ENGINEERING, INC. APPROVES THEIR USE ONLY FOR THE PURPOSES DESIGNATED BY WRITTEN AUTHORIZATION.</p>
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City of Colorado Springs
Stormwater Enterprise



5-11
Stormwater Construction Manual
December 2020

Chapter 5
Native Vegetation Requirements and Guidelines


<p>PLATE SELF STORAGE</p> <p>271 S. 280 STREET COLORADO SPRINGS, CO 80904 PHONE: 719-535-6422 FAX: 719-535-6426 www.tresinc.com</p>	<p>Table 5-2. El Paso County All-Purpose Low Grow Mix for Upland and Transition Areas</p> <table border="1" style="width: 100%; border-collapse: collapse;"> <thead> <tr> <th rowspan="2">Common Name</th> <th rowspan="2">Scientific Name</th> <th rowspan="2">Growth Season / Form</th> <th rowspan="2">% of Mix</th> <th colspan="3">Pounds PLS</th> </tr> <tr> <th>• Irrigated broadcast</th> <th>• Non-irrigated broadcast</th> <th>• Non-irrigated drilled</th> </tr> </thead> <tbody> <tr> <td>Buffalograss</td> <td><i>Buchloe dactyloides</i></td> <td>Warm, sod</td> <td>25</td> <td>9.6</td> <td>4.8</td> <td>2.4</td> </tr> <tr> <td>Grama, blue</td> <td><i>Bouteloua gracilis</i></td> <td>Warm, bunch</td> <td>20</td> <td>10.8</td> <td>5.4</td> <td>2.7</td> </tr> <tr> <td>Grama, sideoats</td> <td><i>Bouteloua curtipendula</i></td> <td>Warm, bunch</td> <td>29</td> <td>5.6</td> <td>2.8</td> <td>1.4</td> </tr> <tr> <td>Green needlegrass</td> <td><i>Nassella viridula</i></td> <td>Cool, bunch</td> <td>5</td> <td>3.2</td> <td>1.6</td> <td>0.8</td> </tr> <tr> <td>Wheatgrass, western</td> <td><i>Pascopyrum smithii</i></td> <td>Cool, sod</td> <td>20</td> <td>12</td> <td>6</td> <td>3</td> </tr> <tr> <td>Dropseed, sand</td> <td><i>Sporobolus cryptandrus</i></td> <td>Warm, bunch</td> <td>1</td> <td>0.8</td> <td>0.4</td> <td>0.2</td> </tr> <tr> <td colspan="4"></td> <td>Seed rate (lbs PLS/acre)</td> <td>42</td> <td>21</td> </tr> <tr> <td colspan="4"></td> <td></td> <td></td> <td>10.3</td> </tr> </tbody> </table>	Common Name	Scientific Name	Growth Season / Form	% of Mix	Pounds PLS			• Irrigated broadcast	• Non-irrigated broadcast	• Non-irrigated drilled	Buffalograss	<i>Buchloe dactyloides</i>	Warm, sod	25	9.6	4.8	2.4	Grama, blue	<i>Bouteloua gracilis</i>	Warm, bunch	20	10.8	5.4	2.7	Grama, sideoats	<i>Bouteloua curtipendula</i>	Warm, bunch	29	5.6	2.8	1.4	Green needlegrass	<i>Nassella viridula</i>	Cool, bunch	5	3.2	1.6	0.8	Wheatgrass, western	<i>Pascopyrum smithii</i>	Cool, sod	20	12	6	3	Dropseed, sand	<i>Sporobolus cryptandrus</i>	Warm, bunch	1	0.8	0.4	0.2					Seed rate (lbs PLS/acre)	42	21							10.3
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City of Colorado Springs
Stormwater Enterprise




5-12
Stormwater Construction Manual
December 2020

<p>PLATE SELF STORAGE</p> <p>271 S. 280 STREET COLORADO SPRINGS, CO 80904 PHONE: 719-535-6422 FAX: 719-535-6426 www.tresinc.com</p>	<p>DESIGNED BY JF DRAWN BY JF CHECKED BY DF H-SCALE AS SHOWN V-SCALE N/A JOB NO. 2419.00 DATE ISSUED 11/13/24 SHEET NO. 16 OF 27</p>
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STORM SEWER EAST RUN – PLAN & PROFILE
HORZ SCALE: 1"=40' – VERT SCALE: 1"=4'

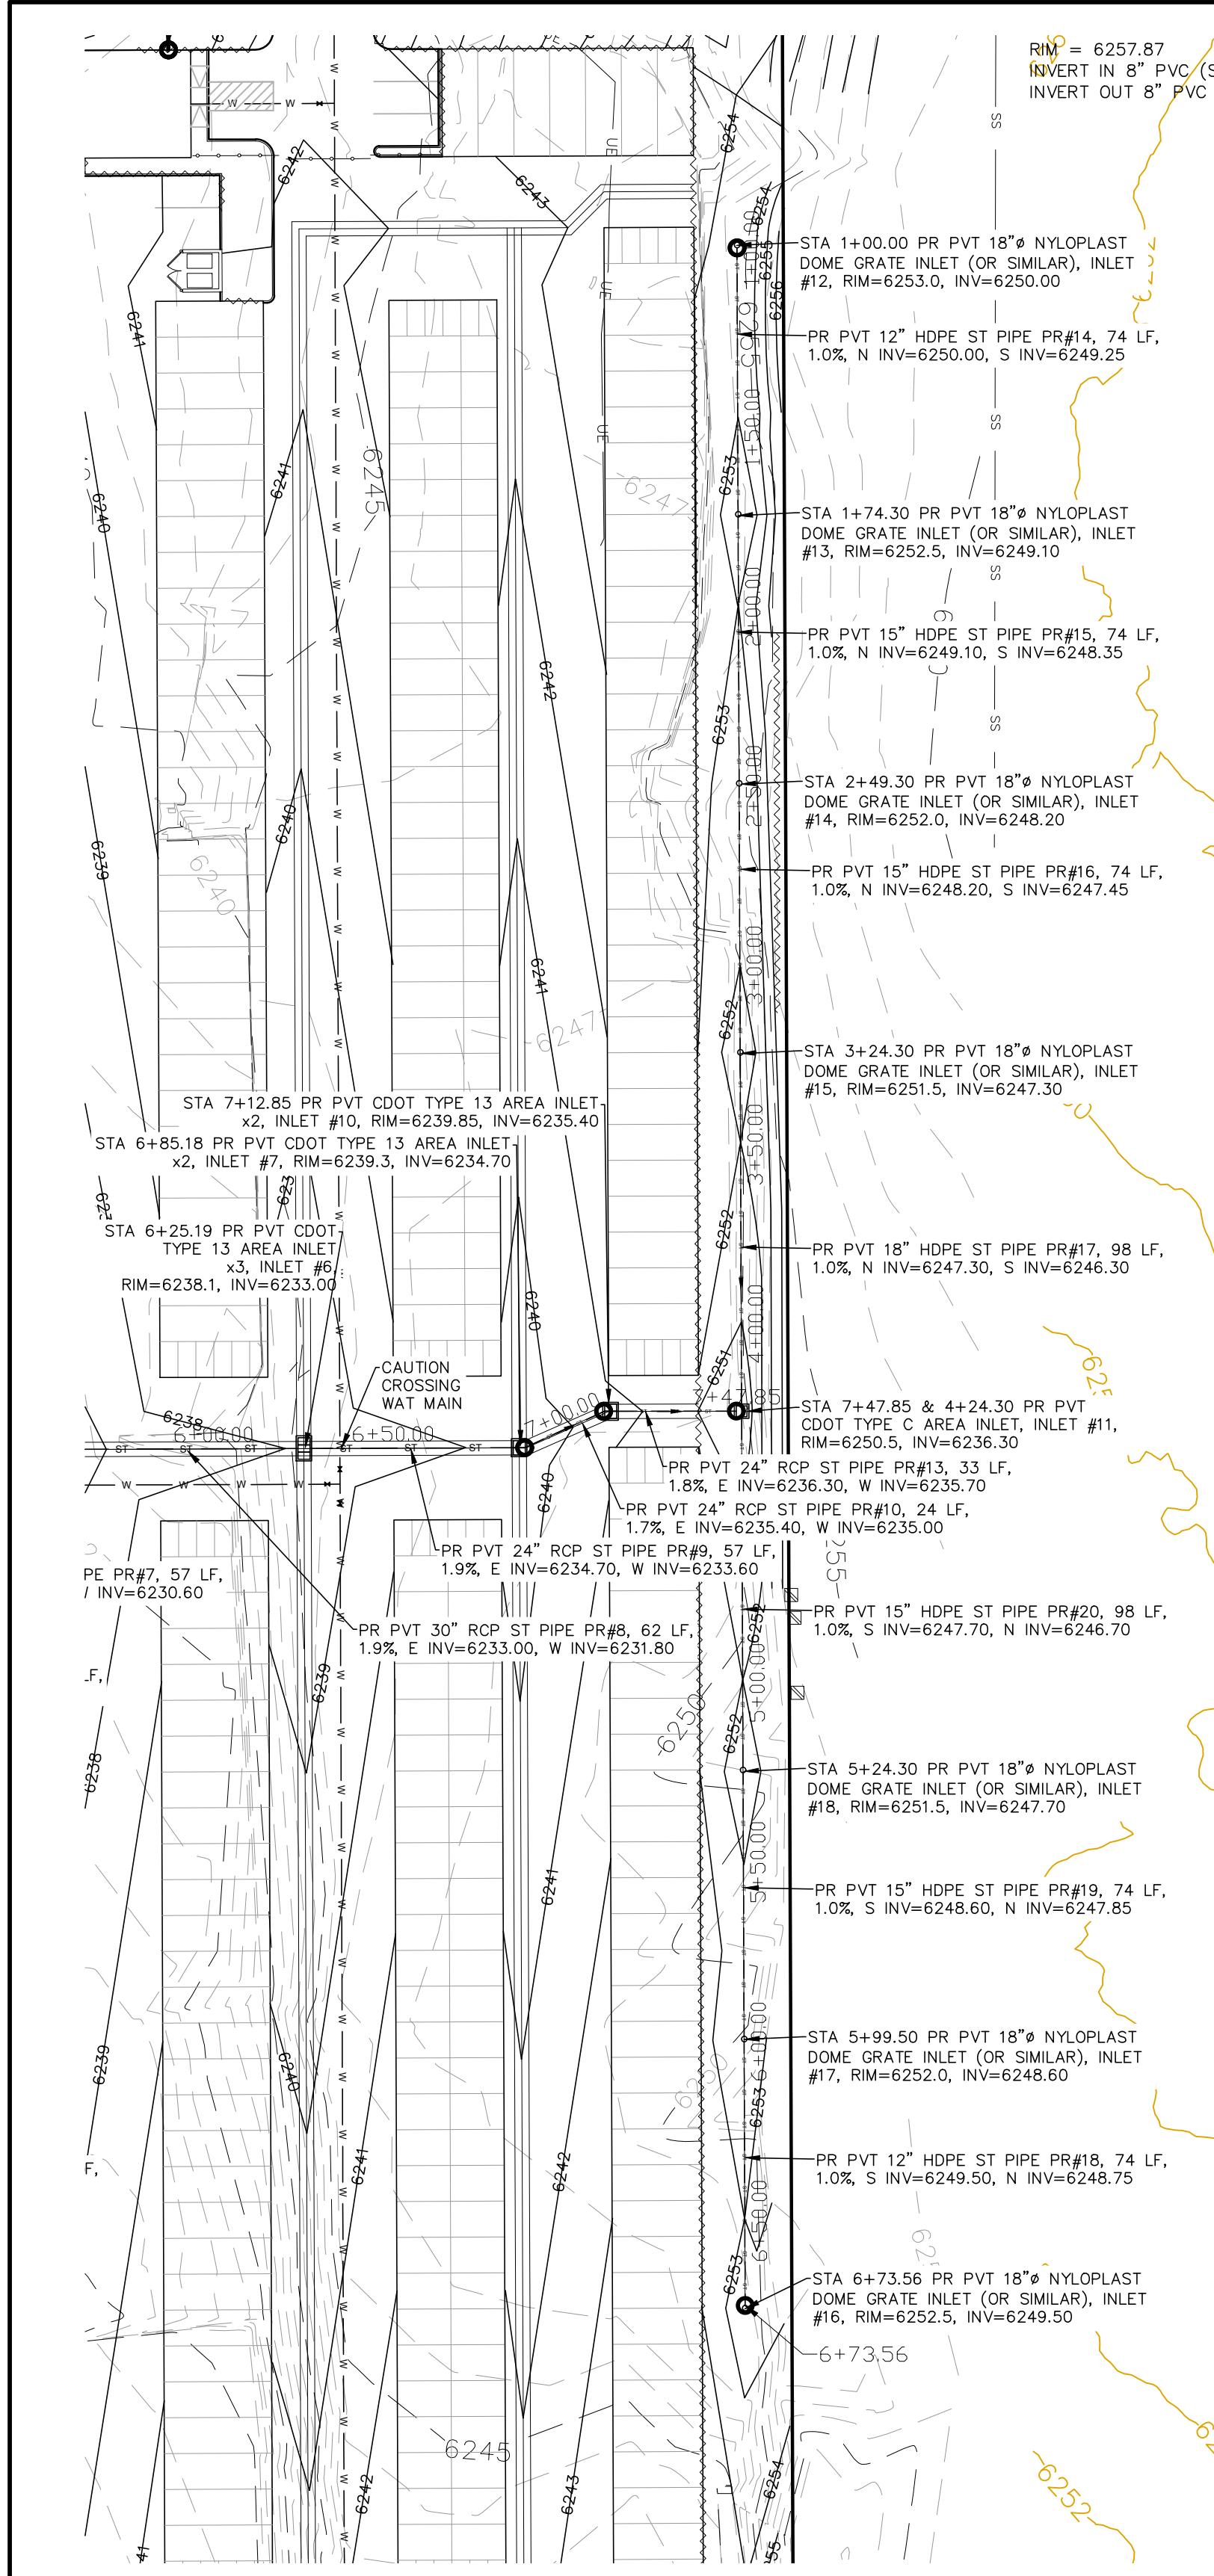

GRADING LEGEND

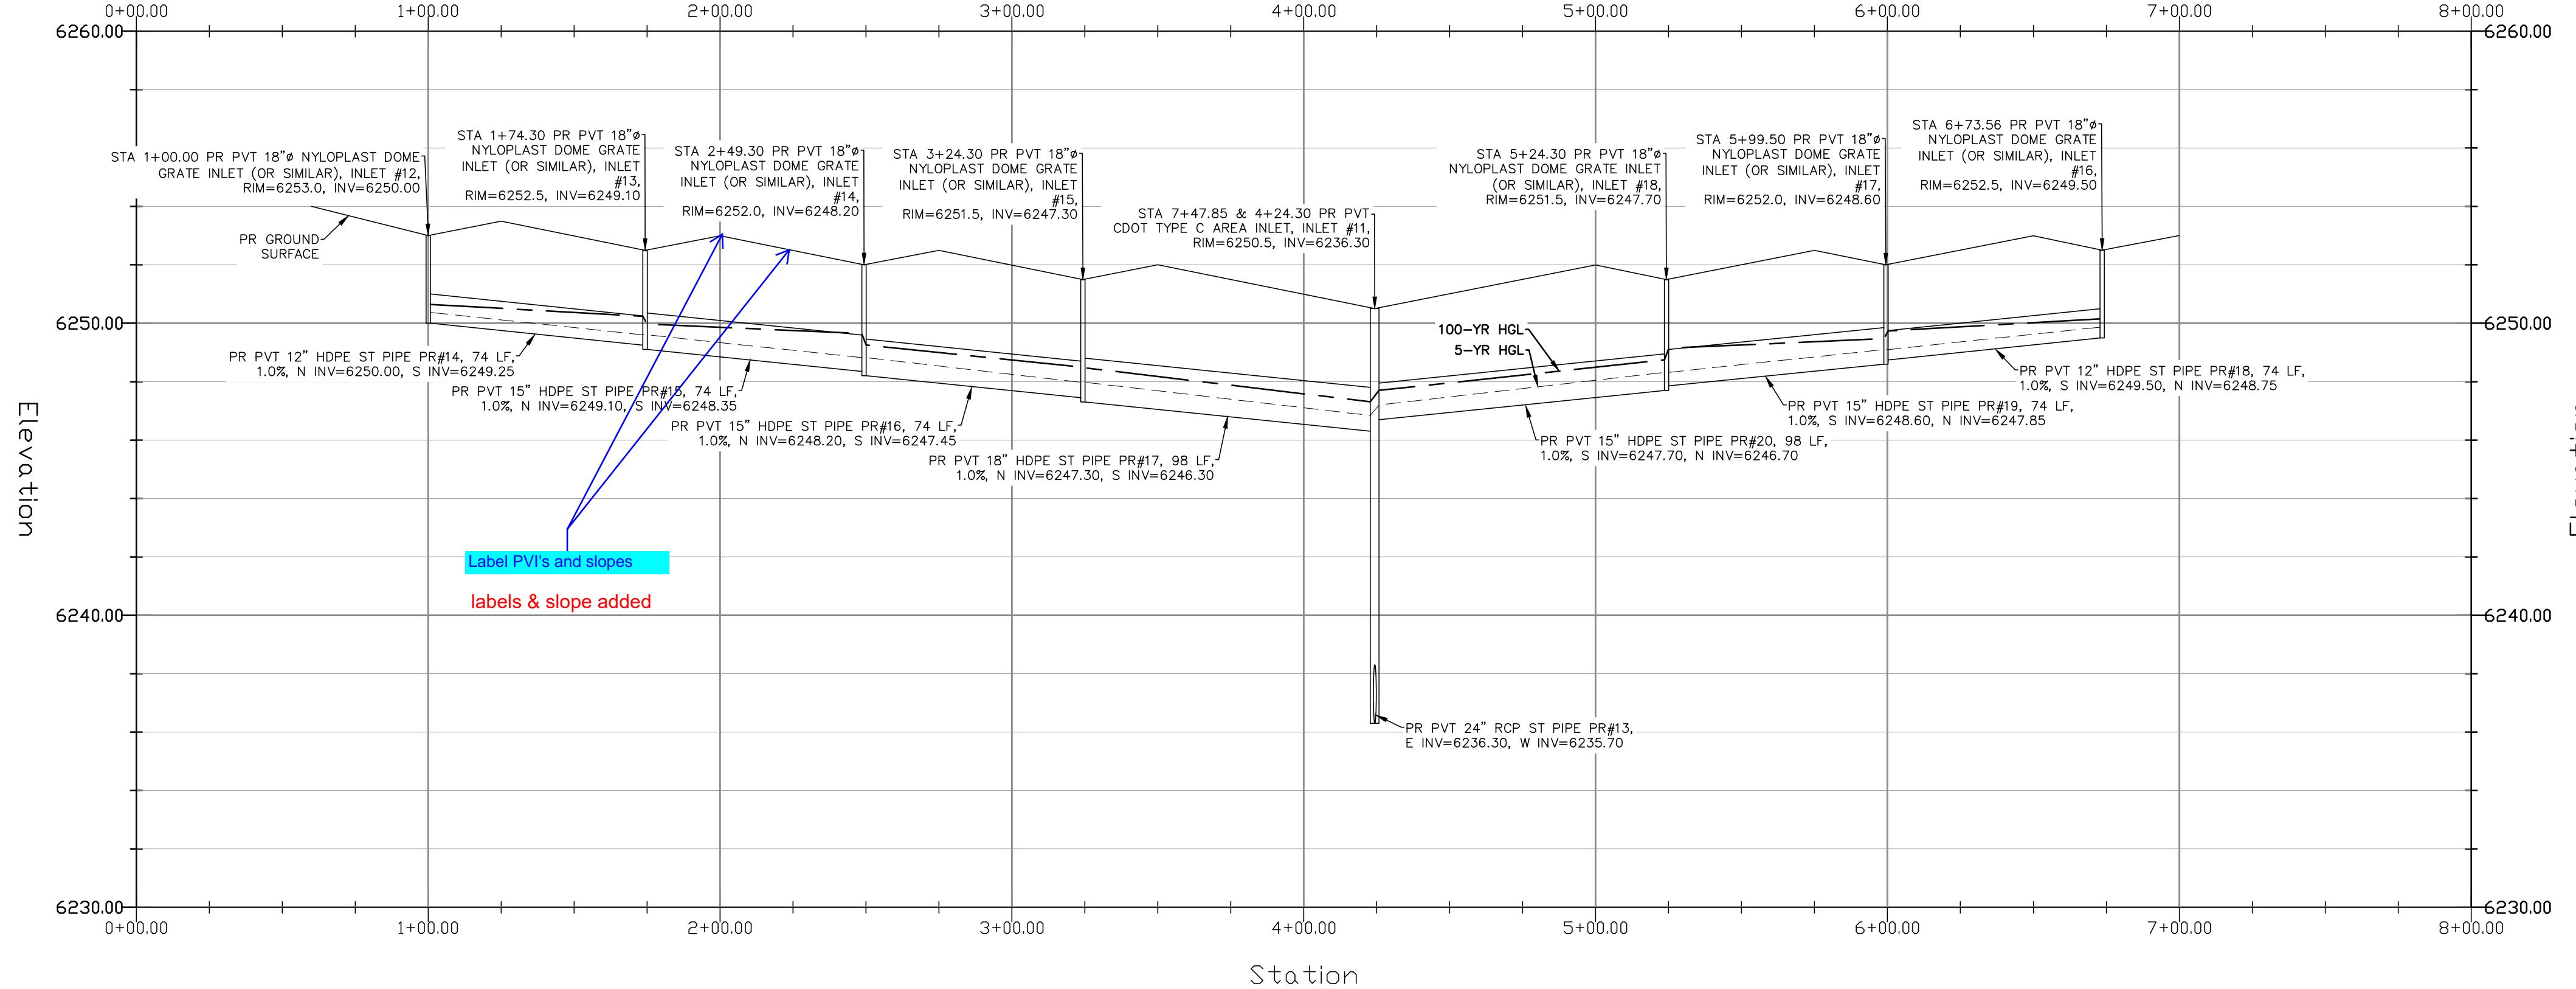PROPOSED	PR	EXISTING CONTOURS – MINOR
EXISTING	EX	EXISTING CONTOURS – MAJOR
FINISHED SURFACE	FS	PROPOSED CONTOURS – 1'
FINISHED GROUND	FG	EXISTING PROPERTY LINE
TOP OF CURB	TC	PROPOSED RET WALL
FLOWLINE	FL	PROPOSED RIPRAP
FINISH GROUND AT TOP OF WALL	TW	WATER LINE
FINISHED GROUND AT BOTTOM OF WALL	BW	SANITARY SEWER LINE
LOW POINT	LP	GAS LINE
HIGH POINT	HP	UNDERGROUND ELECTRICAL LINE
FLOW ARROW	FA	TELEPHONE LINE
EXISTING CONTOURS (LIDAR)	SL	FIBER OPTIC LINE
STORM MANHOLE	SM	STORM SEWER LINE
STORM INLET	SI	LIMIT OF CONSTRUCTION
		LIMIT OF SOIL DISTURBANCE
		PROPOSED FENCE
		STORM MANHOLE
		FIRE HYDRANT

STORM SEWER NOTES

1. ALL HDPE STORM SEWER MUST BE SMOOTH INTERIOR PIPE. ALL RCP MUST BE MINIMUM CLASS 3.
2. ALL PIPE CONNECTIONS TO PREFABRICATED INLETS OR BOXES MUST USE A REINFORCED CONCRETE COLLAR.
3. ALL TYPE C INLETS SHALL HAVE CLOSE MESH GRATES.

REVISIONS
NO. _____ DATE _____

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PREPARED FOR:
RMG—ROCKY MOUNTAIN GROUP
ATTN: #200
5085 LIST DR,
COLORADO SPRINGS, CO 80919
719.548.0600





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COLORADO SPRINGS, CO 80904
OFFICE: 719-535-6422
FAX: 719-535-6426
www.tresinc.com





STORM SEWER PLAN
EAST RUN – PLAN & PROFILE

THIS DESIGN WAS PREPARED UNDER MY DIRECT SUPERVISION
FOR AND ON BEHALF OF TERRA NOVA ENGINEERING, INC.

DANE FRANK
COLORADO P.E. # 50207

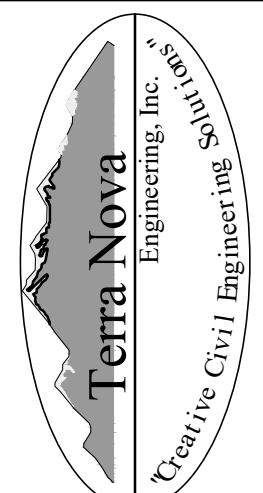DESIGNED BY DLF
DRAWN BY DLF
CHECKED BY LD
H-SCALE AS SHOWN
V-SCALE N/A
JOB NO. 2419.00
DATE ISSUED 11/13/24
SHEET NO. 17 OF 27

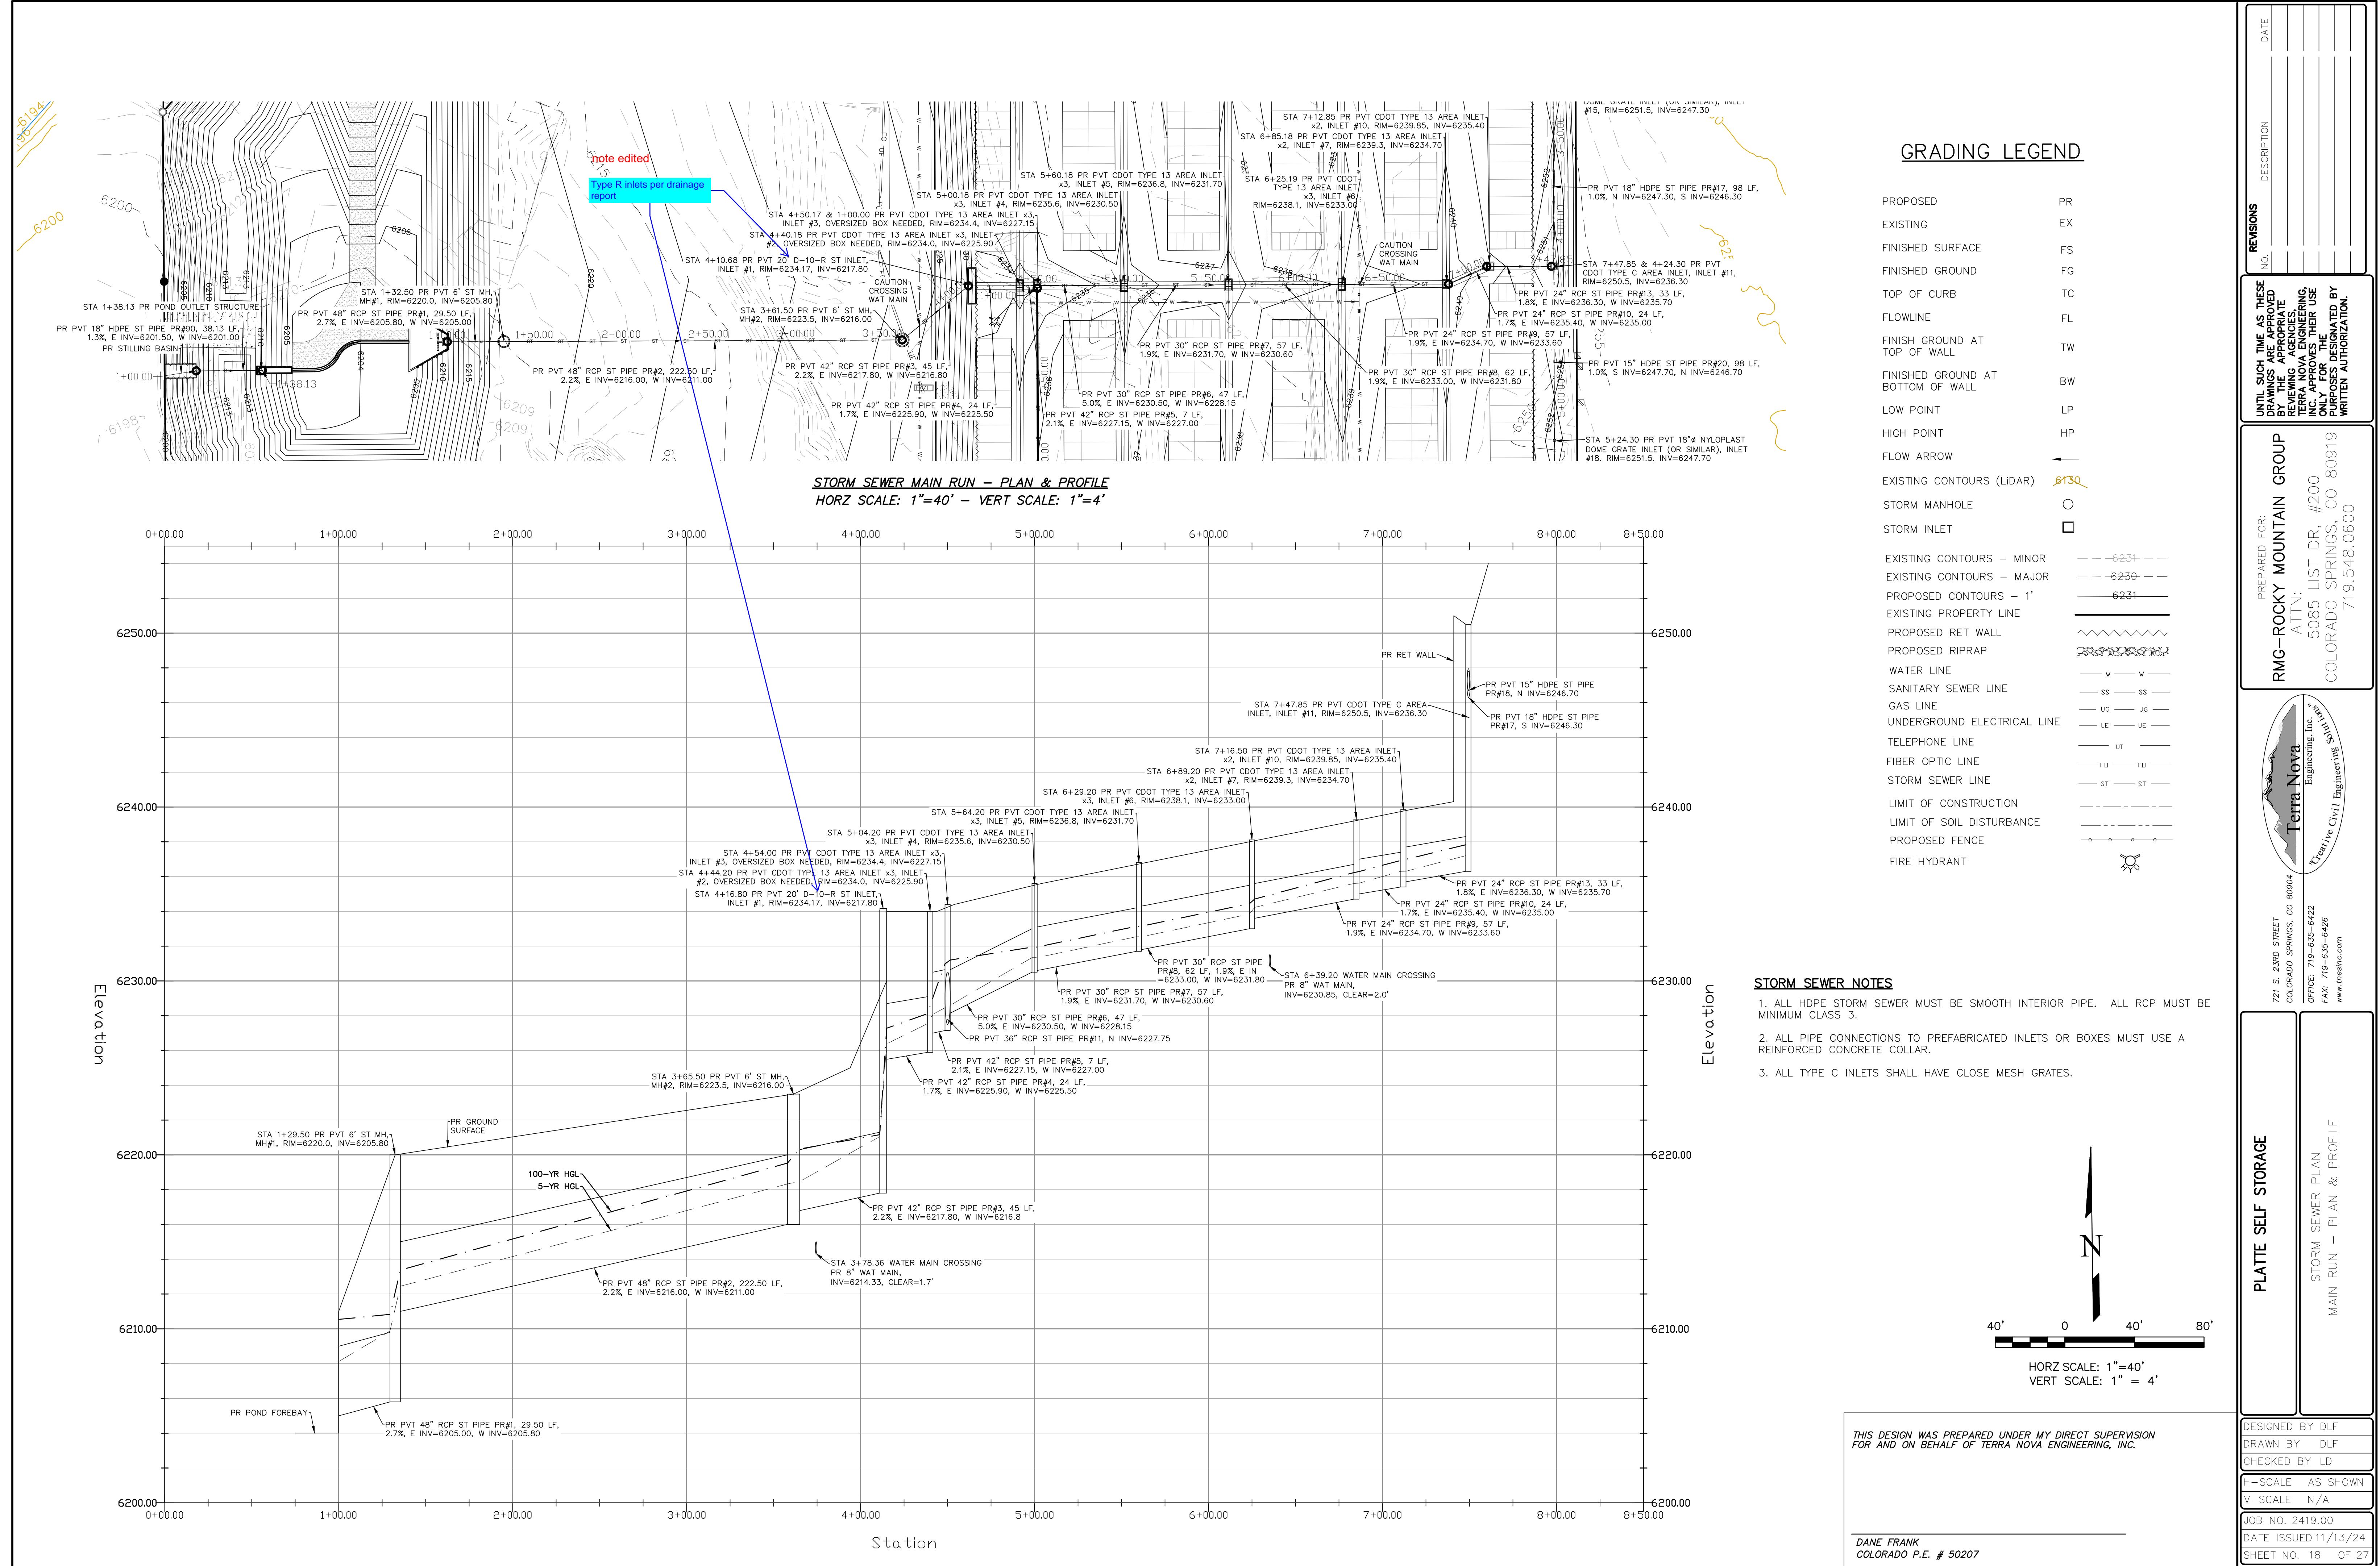

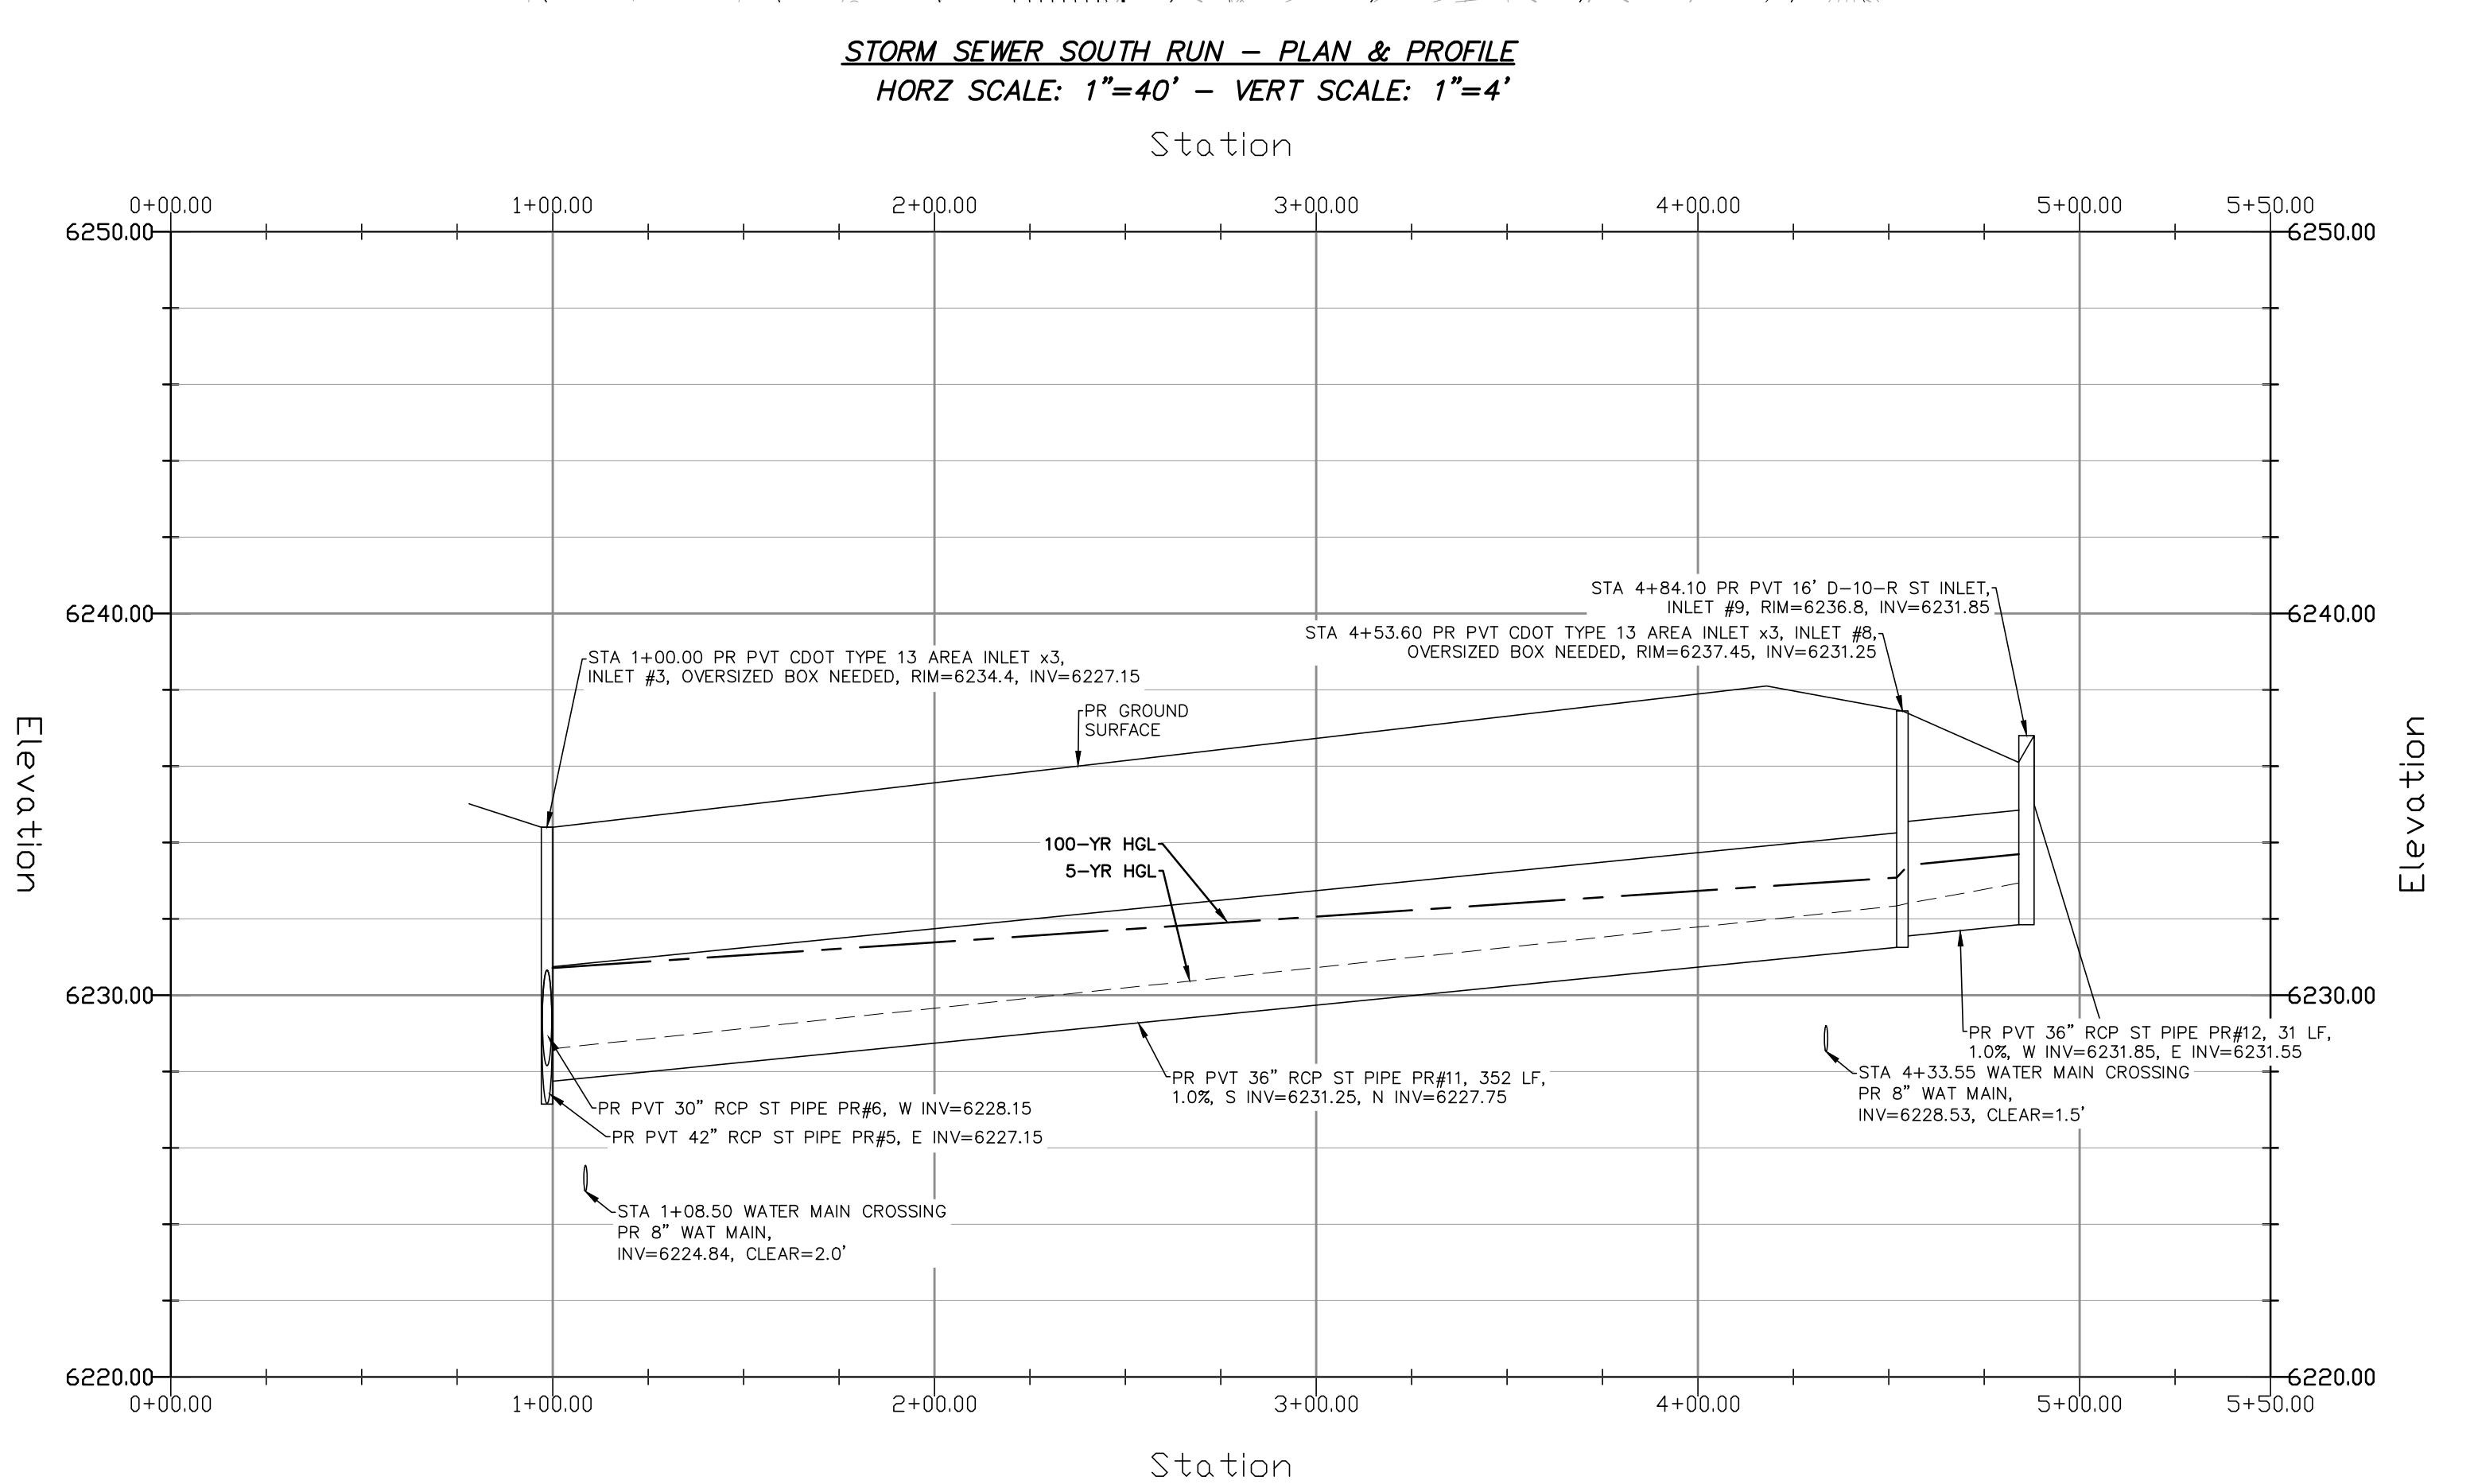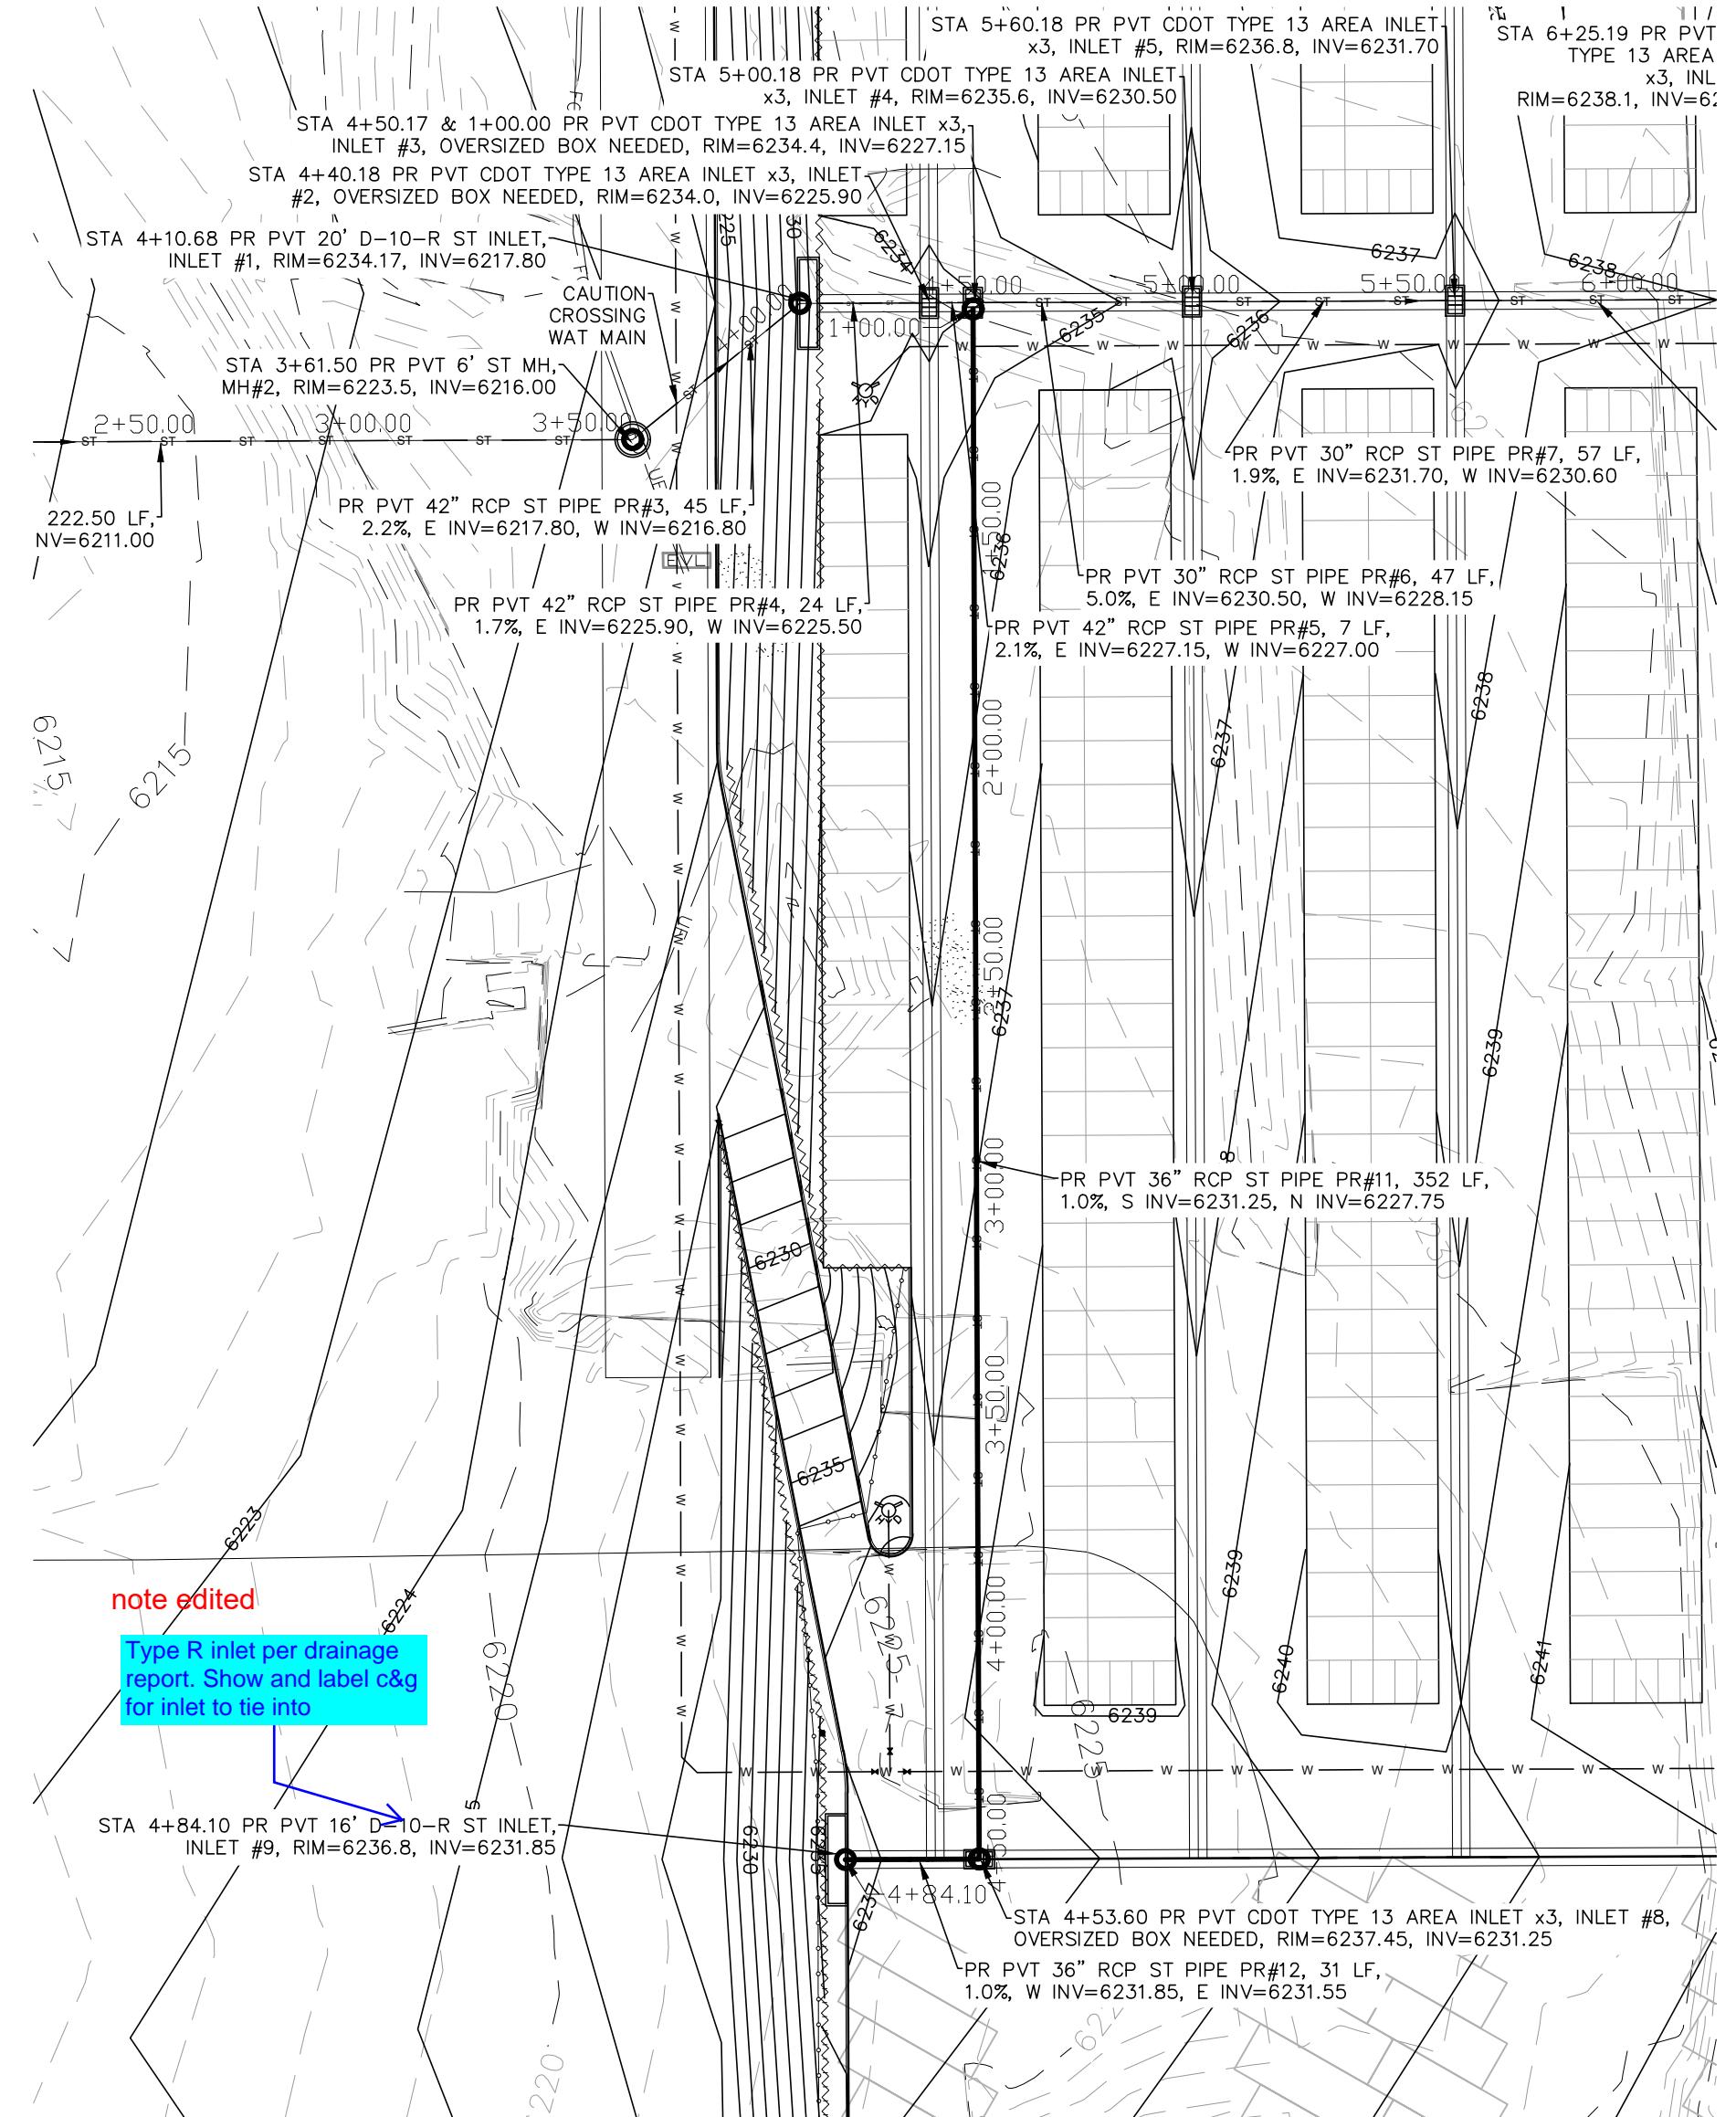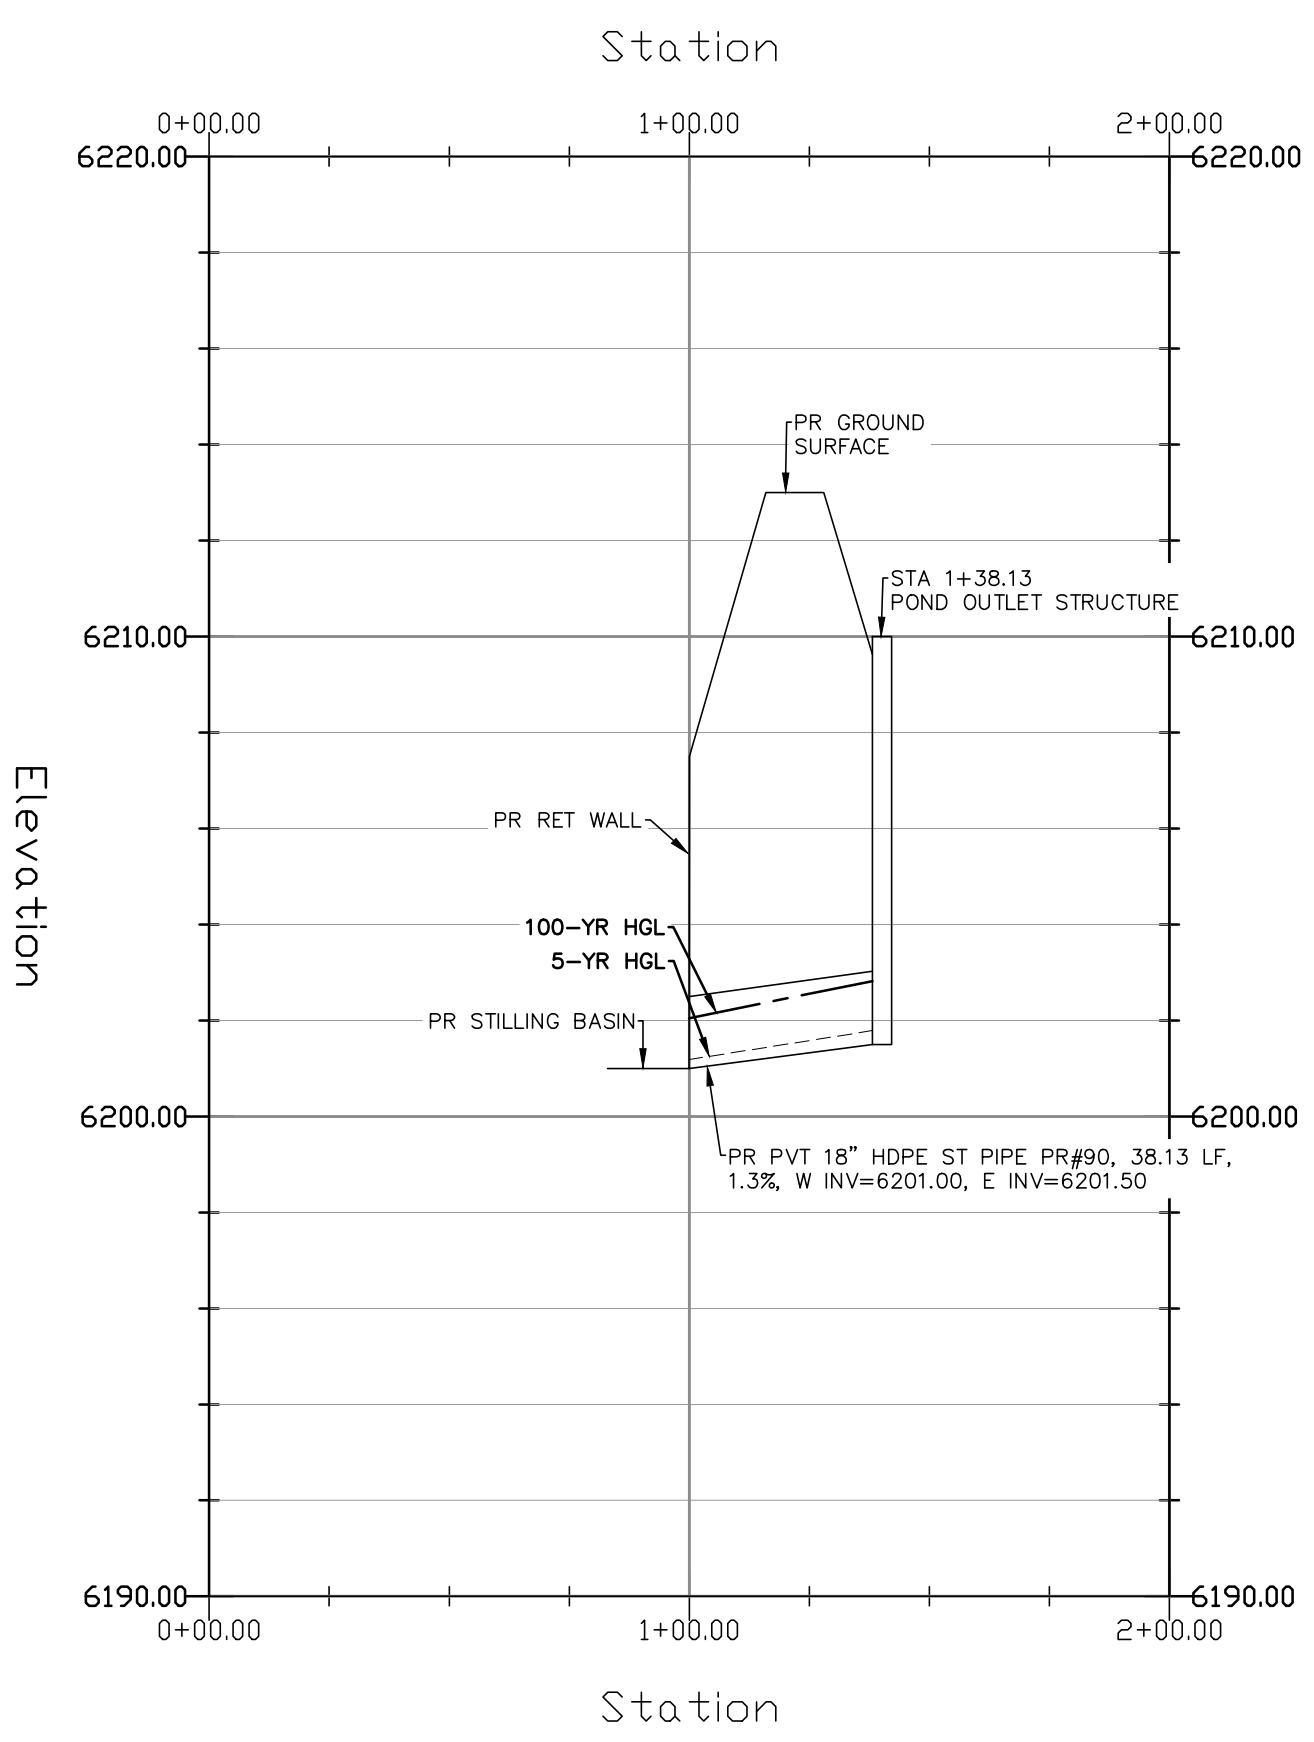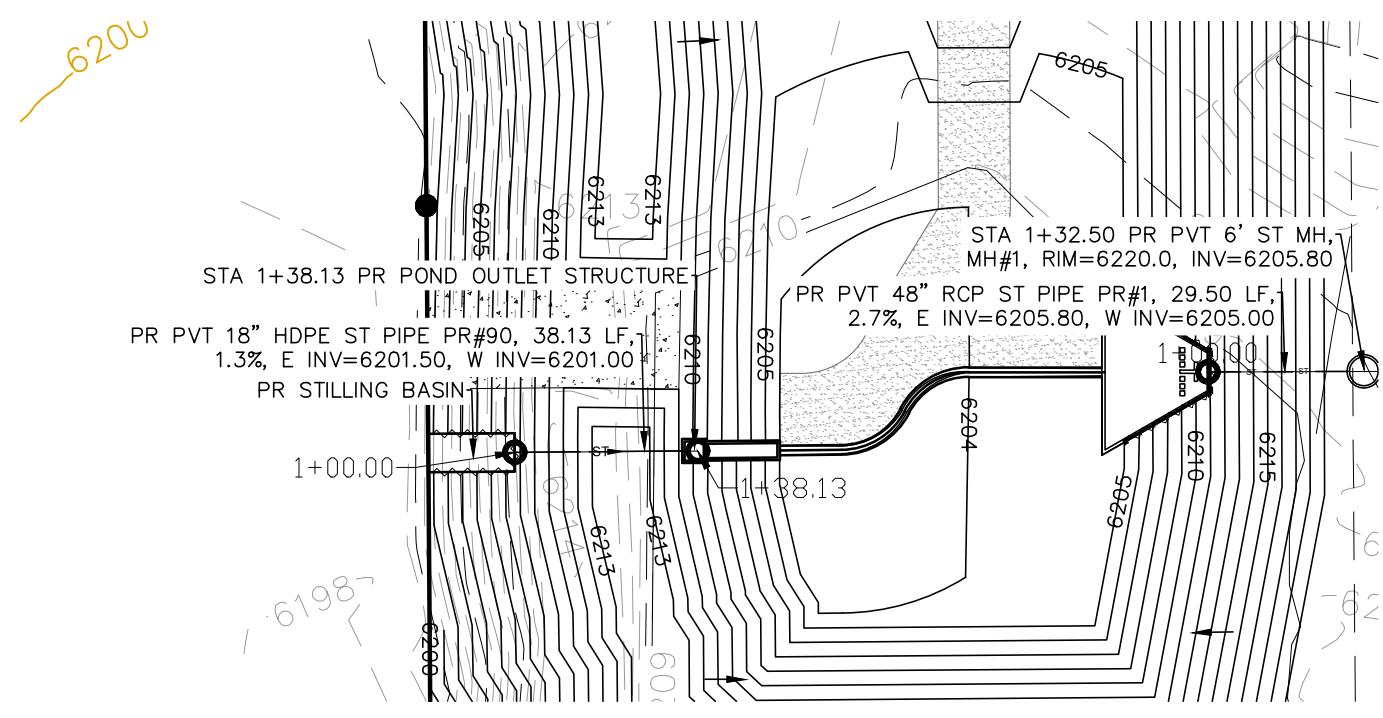

GRADING LEGEND

PROPOSED	PR	EXISTING CONTOURS - MINOR	— — 6231 — —
EXISTING	EX	EXISTING CONTOURS - MAJOR	— — 6230 — —
FINISHED SURFACE	FS	PROPOSED CONTOURS - 1'	6231
FINISHED GROUND	FG	EXISTING PROPERTY LINE	~~~~~
TOP OF CURB	TC	PROPOSED RET WALL	██████████
FLOWLINE	FL	PROPOSED RIPRAP	~~~~~
FINISH GROUND AT TOP OF WALL	TW	WATER LINE	▀ ▀
FINISHED GROUND AT BOTTOM OF WALL	BW	SANITARY SEWER LINE	— SS —
TELEPHONE LINE	UE	GAS LINE	— UG —
LOW POINT	LP	UNDERGROUND ELECTRICAL LINE	— UE —
HIGH POINT	HP	TELEPHONE LINE	— UT —
FLOW ARROW	←	FIBER OPTIC LINE	— FD —
EXISTING CONTOURS (LIDAR)	6130	STORM SEWER LINE	— ST —
STORM MANHOLE	□	LIMIT OF CONSTRUCTION	— - - - -
STORM INLET	○	LIMIT OF SOIL DISTURBANCE	— - - - -
		PROPOSED FENCE	— - - - -
		FIRE HYDRANT	●

STORM SEWER NOTES

- ALL HDPE STORM SEWER MUST BE SMOOTH INTERIOR PIPE. ALL RCP MUST BE MINIMUM CLASS 3.
- ALL PIPE CONNECTIONS TO PREFABRICATED INLETS OR BOXES MUST USE A REINFORCED CONCRETE COLLAR.
- ALL TYPE C INLETS SHALL HAVE CLOSE MESH GRATES.

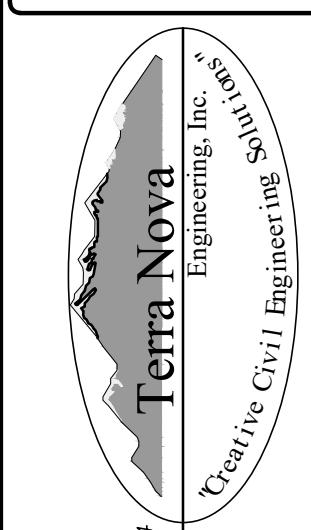


PLATE SELF STORAGE
STORM SEWER PLAN
SOUTH RUN & POND OUTLET - PLAN & PROFILE

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PLATTE SELF STORAGE


GRADING AND EROSION CONTROL PLAN

EXTENDED DETENTION BASIN PLAN


NOVEMBER 2024

GRADING LEGEND


PROPOSED	PR	EXISTING CONTOURS - MINOR	— 6231 —
EXISTING	EX	EXISTING CONTOURS - MAJOR	— 6230 —
FINISHED SURFACE	FS	PROPOSED CONTOURS - 1'	6231
FINISHED GROUND	FG	EXISTING PROPERTY LINE	————
TOP OF CURB	TC	PROPOSED RET WALL	~~~~~
FLOWLINE	FL	WATER LINE	— v —
FISH GROUND AT TOP OF WALL	TW	SANITARY SEWER LINE	— SS —
FISH GROUND AT BOTTOM OF WALL	BW	UNDERGROUND ELECTRICAL LINE	— UG —
LOW POINT	LP	TELEPHONE LINE	— UT —
HIGH POINT	HP	FIBER OPTIC LINE	— FD —
LIMIT OF CONSTRUCTION		STORM SEWER LINE	— ST —
LIMIT OF SOIL DISTURBANCE			— - - - -
PROPOSED FENCE			— o o o —
FIRE HYDRANT			— x —

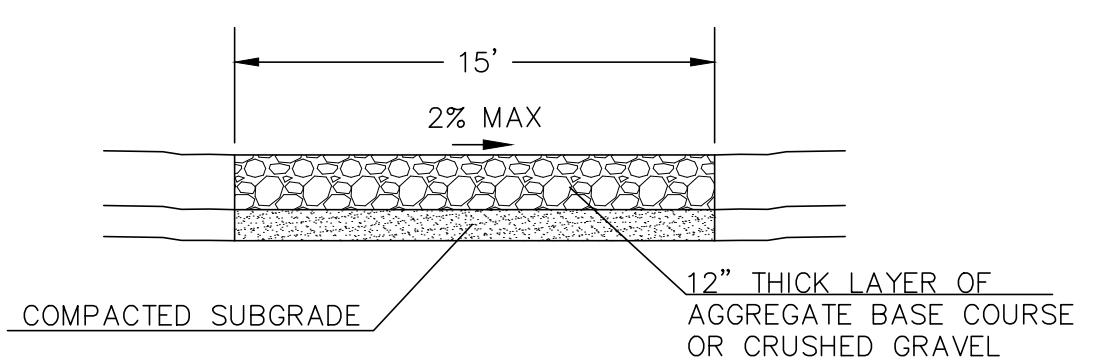


15' MAINTENANCE ACCESS ROAD SECTION
NOT TO SCALE

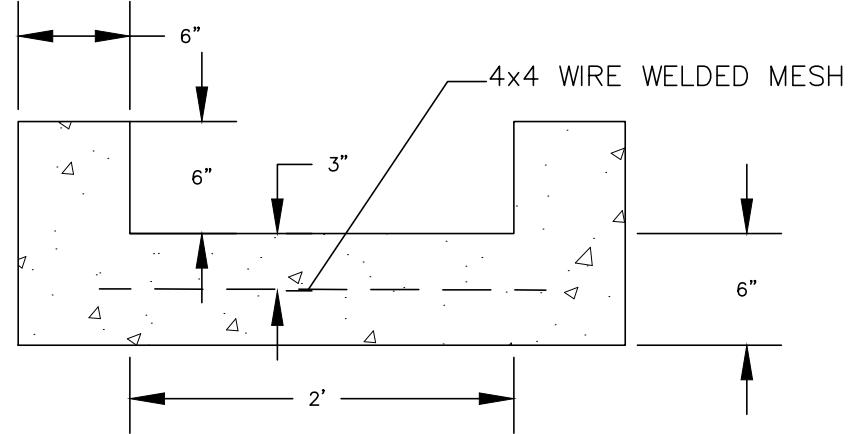


2' CONCRETE TRICKLE CHANNEL
NOT TO SCALE

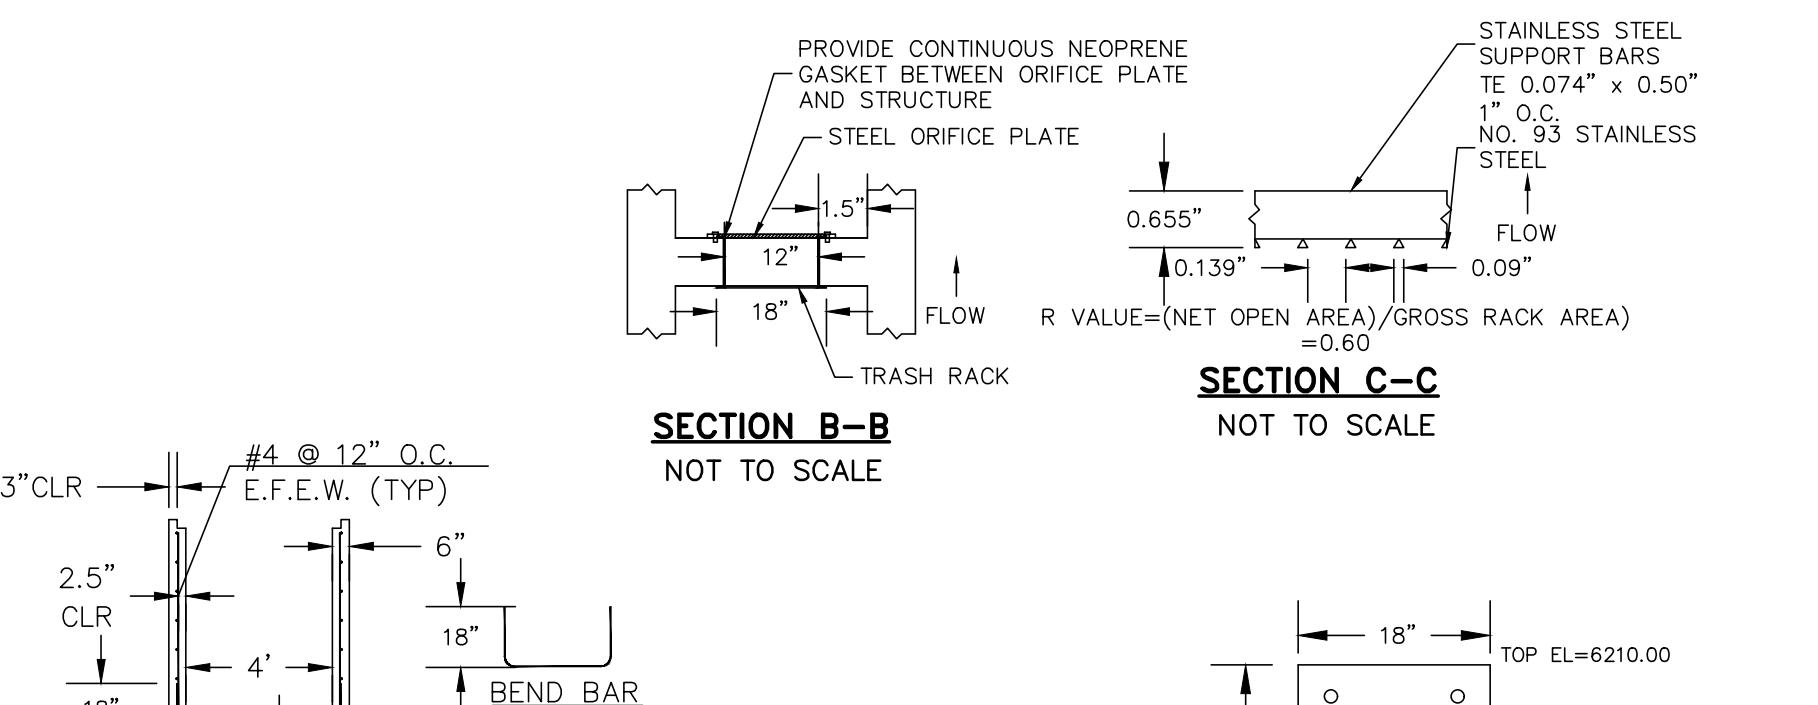


SECTION B-B
NOT TO SCALE

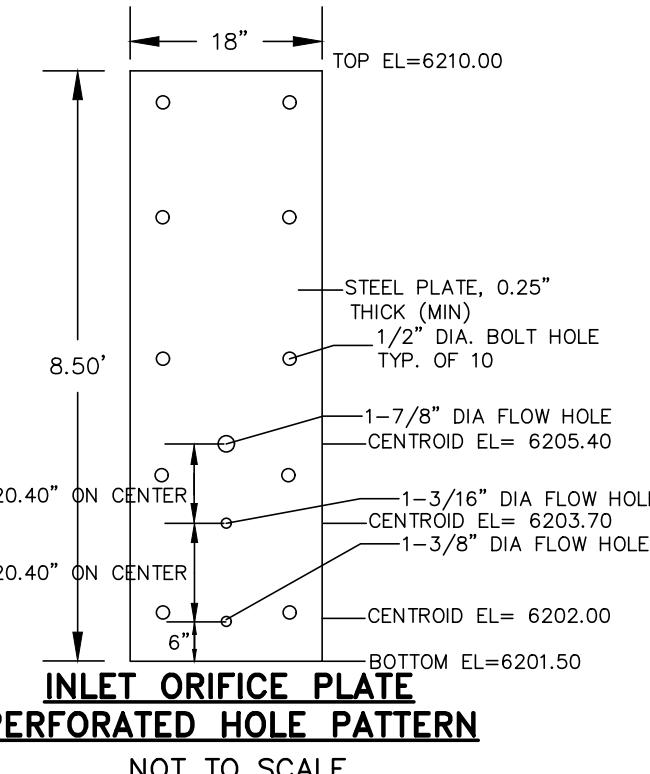


INLET ORIFICE PLATE
PERFORATED HOLE PATTERN
NOT TO SCALE

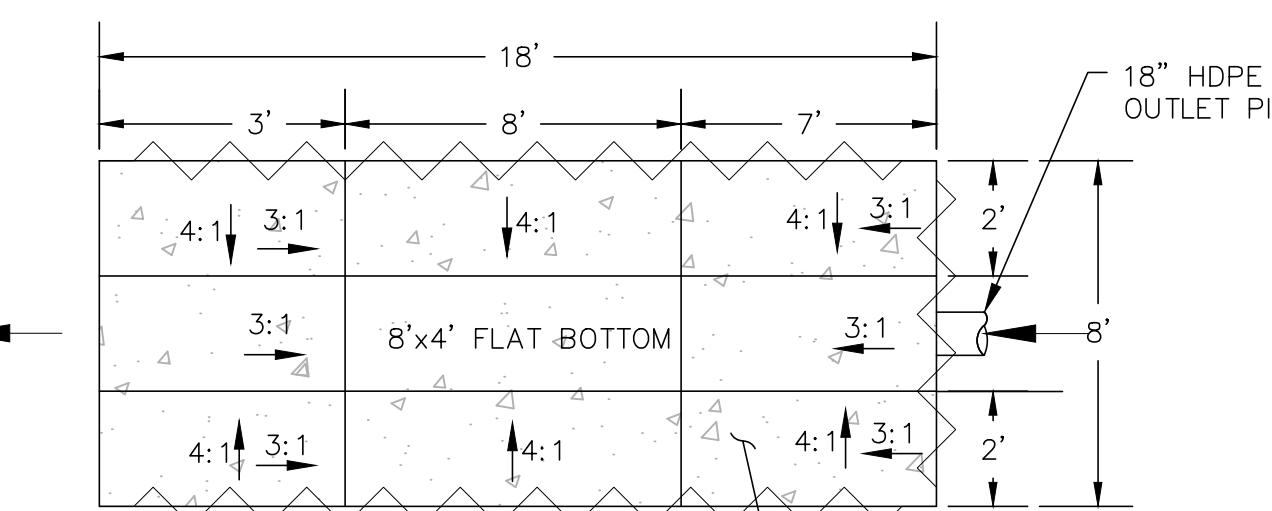


PROFILE VIEW

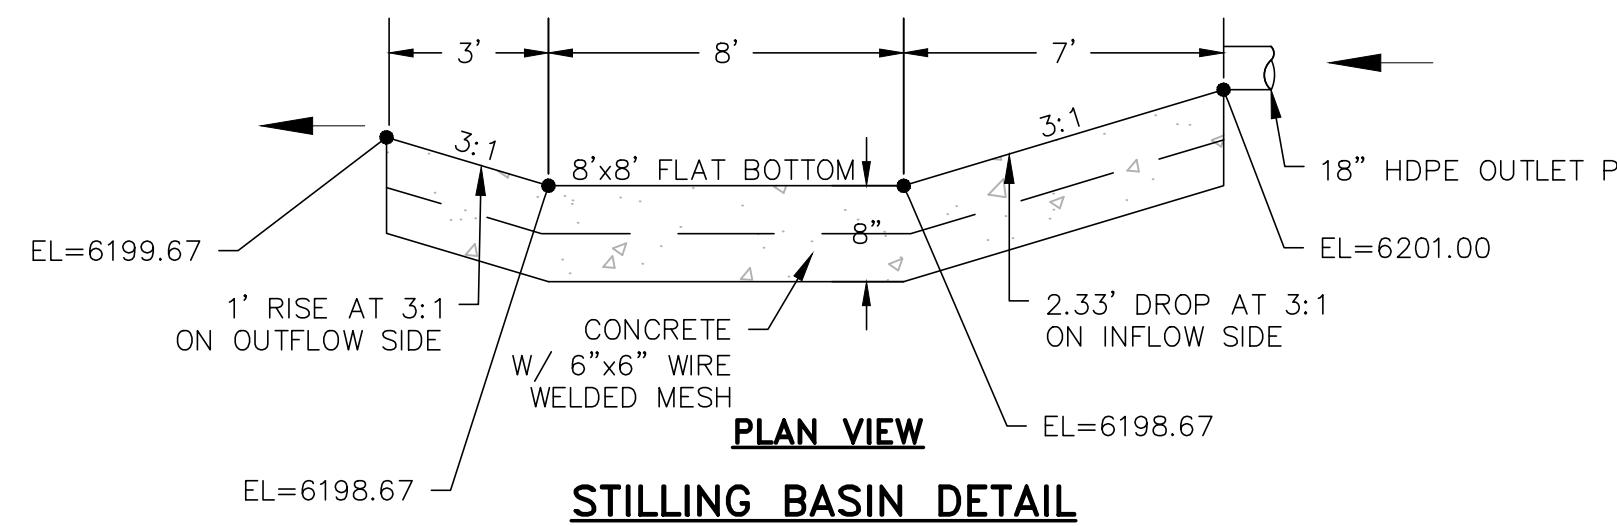

STILLING BASIN DETAIL
NOT TO SCALE

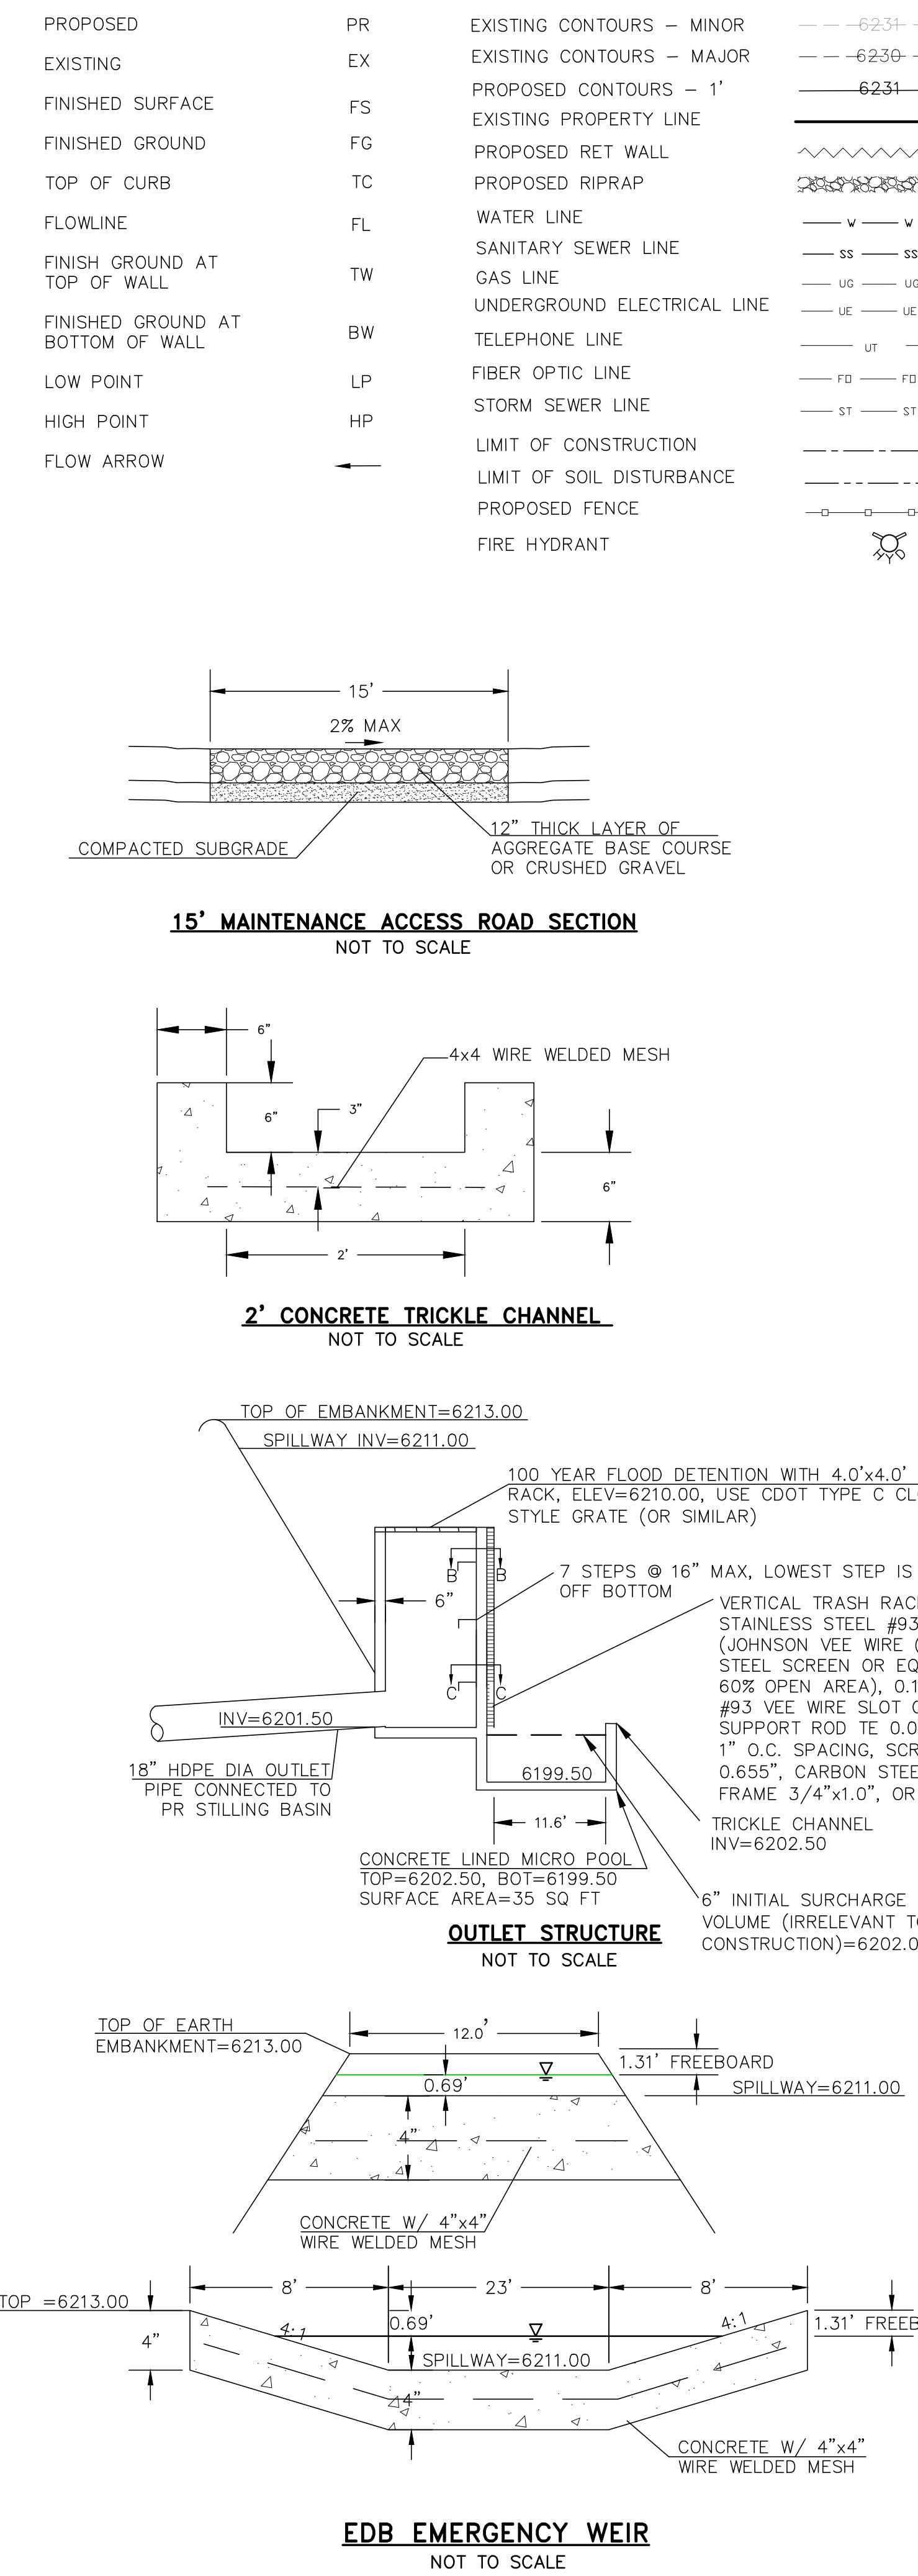


EDB EMERGENCY WEIR
NOT TO SCALE

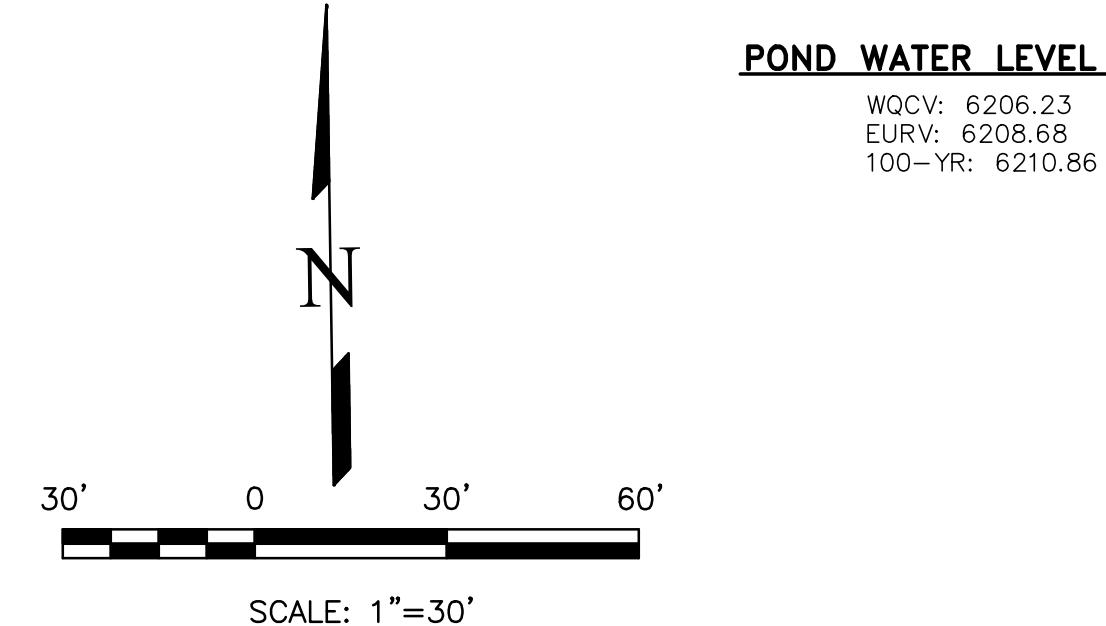

POND WATER LEVEL ELEV

WQCV: 6206.23
EURV: 6208.68
100-YR: 6210.86

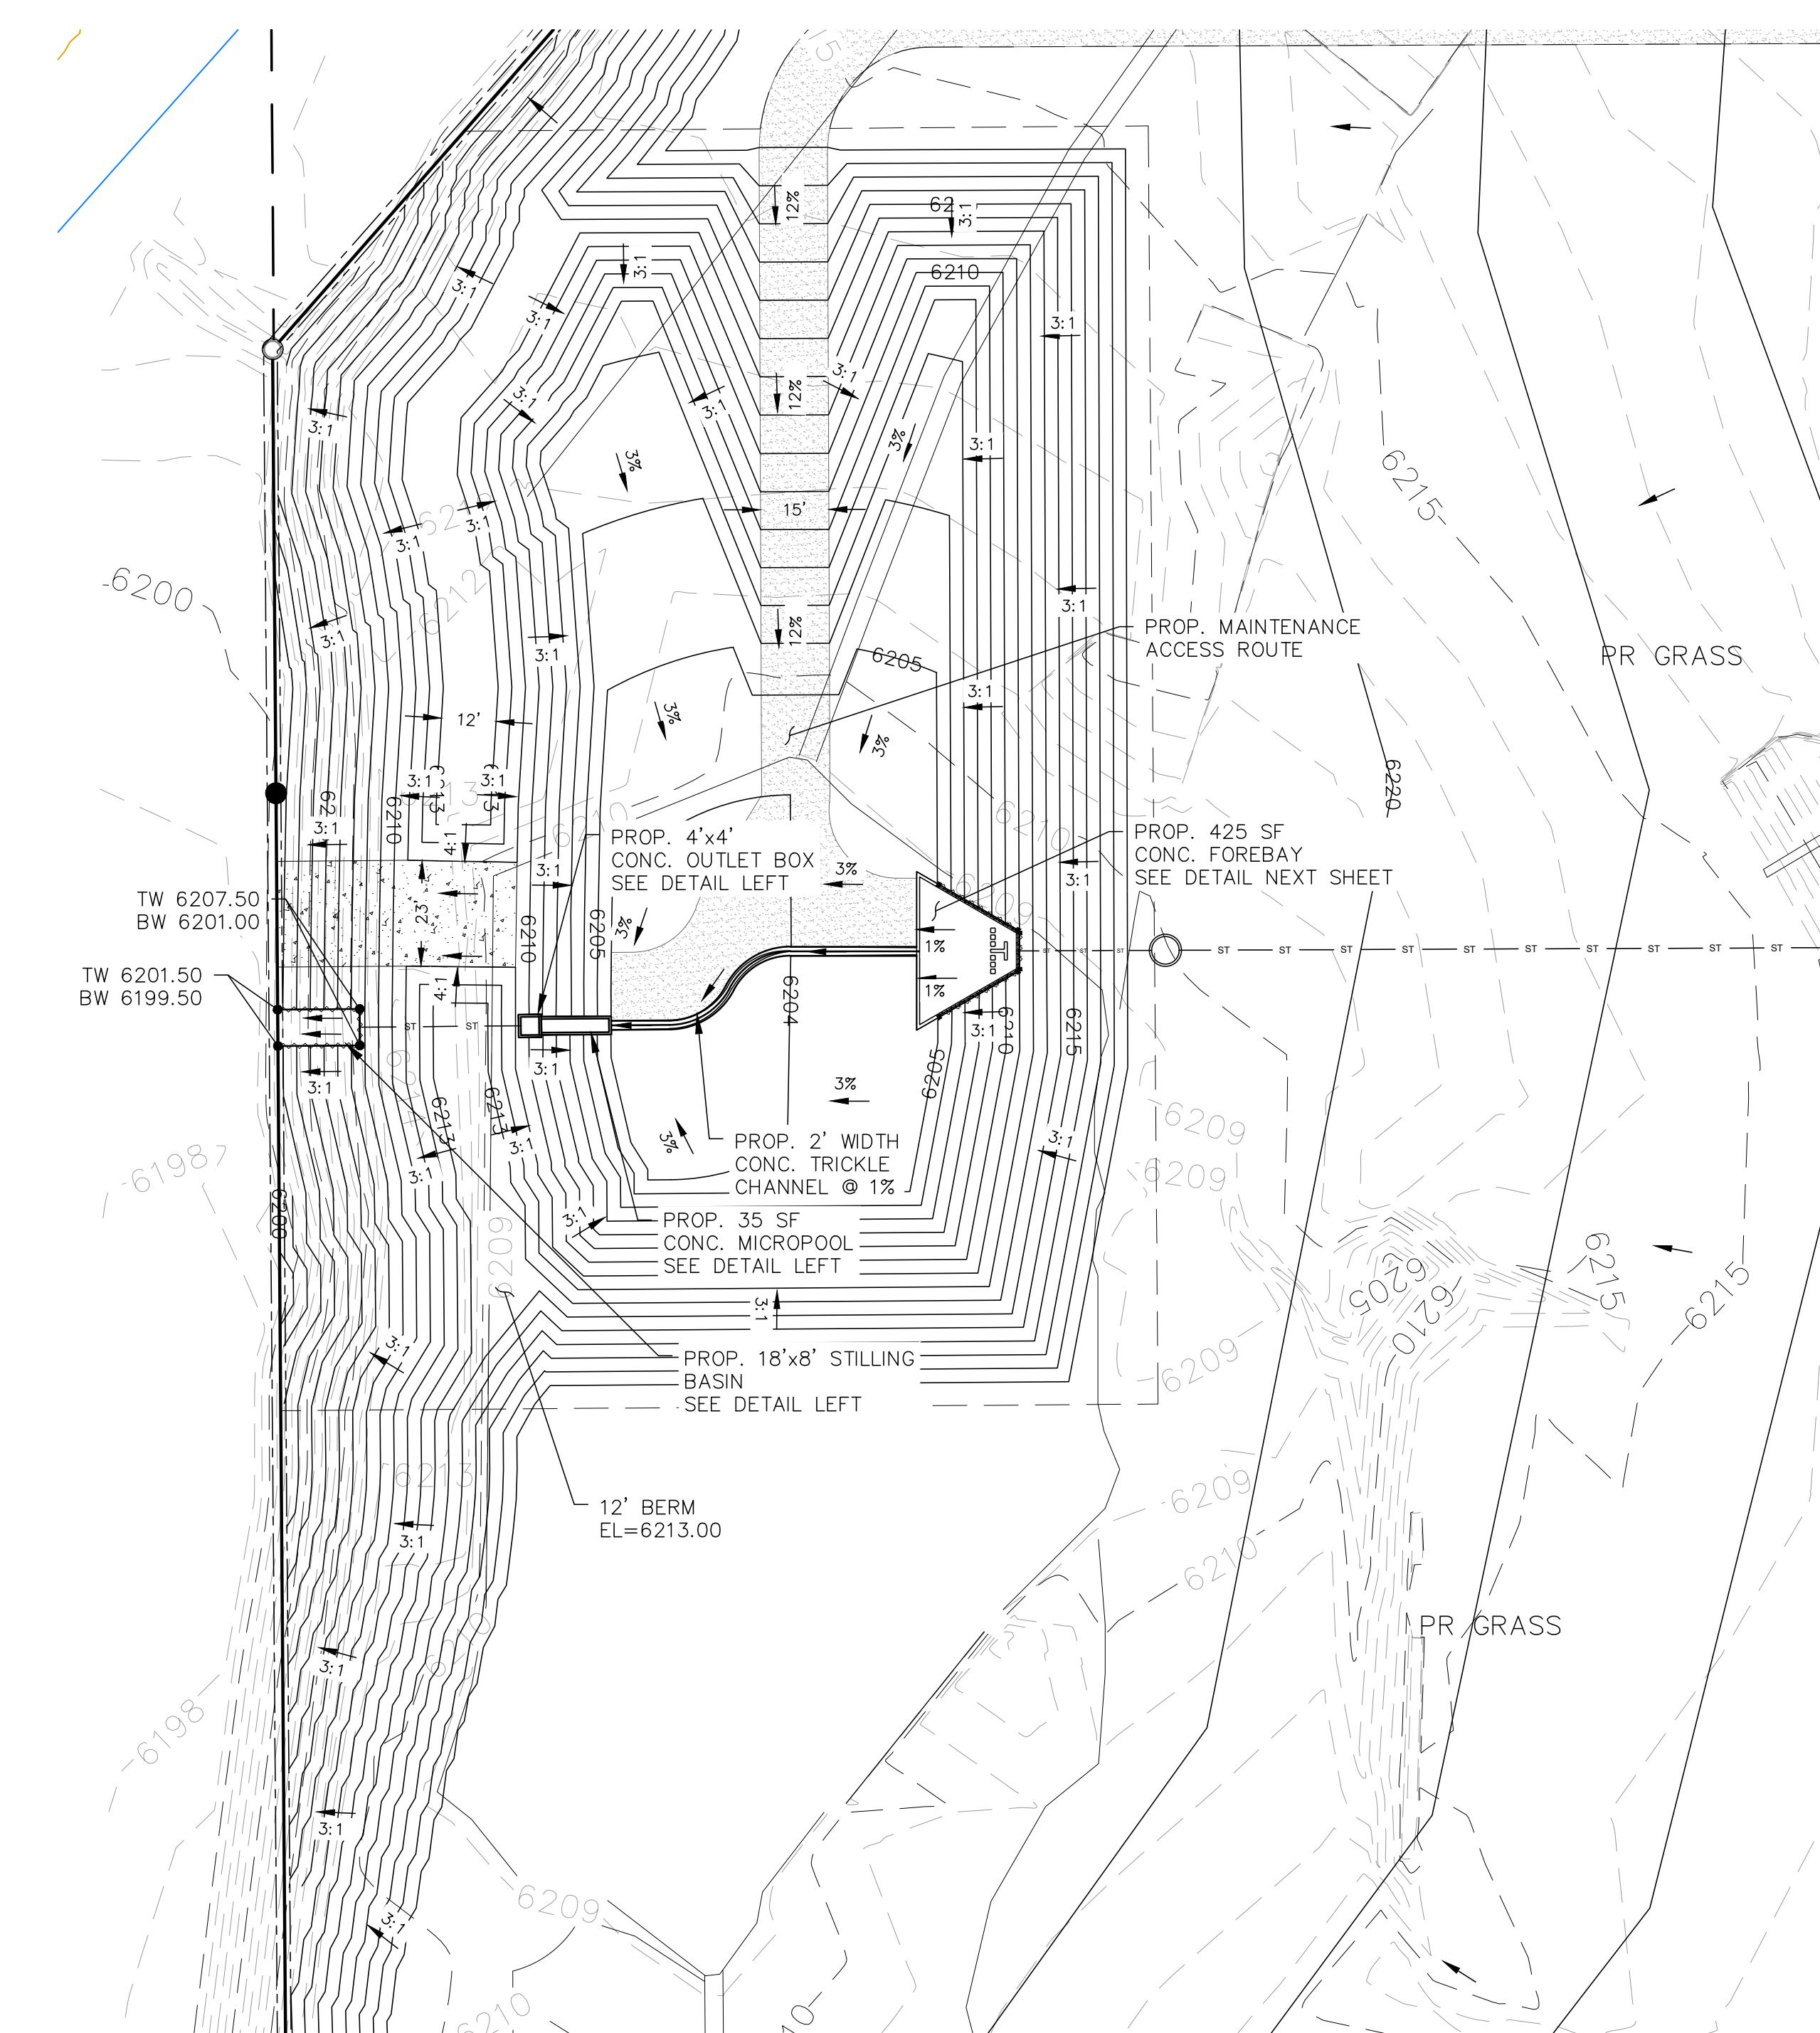

NOTES

- ALL HDPE STORM PIPE IS TO BE SMOOTH INTERIOR PIPE.
- LARGE BLOCKS OF TEXT QUOTING STANDARD DRAWINGS OR DETAILS ARE INCLUDED AS A REQUIREMENT OF COUNTY REVIEWERS.

BENCHMARKS

- #5 REBAR WITH ORANGE PLASTIC CAP MARKED "CSAM, LLC PLS 32439", FLUSH WITH GROUND - ELEV.=6513.85 (NAVD-1988) [NORTHWEST PROPERTY CORNER]

REVISIONS	DESCRIPTION
DATE	
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Terra Nova Terra Nova Engineering, Inc. Civil/Pre-Construction Services	
721 S. 23RD STREET COLORADO SPRINGS, CO 80904 / OFFICE: 719-535-6422 FAX: 719-535-6426 www.tresinc.com	
PLATE SELF STORAGE GRADING AND EROSION CONTROL PLAN EXTENDED DETENTION BASIN PLAN	
DESIGNED BY DLF DRAWN BY DLF CHECKED BY LD H-SCALE AS SHOWN V-SCALE N/A JOB NO. 2419.00 DATE ISSUED 11/13/24 SHEET NO. 20 OF 27	

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DANE FRANK
COLORADO P.E. # 50207

PLATTE SELF STORAGE

GRADING AND EROSION CONTROL PLAN

EXTENDED DETENTION BASIN PLAN

NOVEMBER 2024

GRADING LEGEND




PROPOSED	PR	EXISTING CONTOURS - MINOR	— — 6231 — —
EXISTING	EX	EXISTING CONTOURS - MAJOR	— — 6230 — —
FINISHED SURFACE	FS	PROPOSED CONTOURS - 1'	6231
FINISHED GROUND	FG	EXISTING PROPERTY LINE	~~~~~
TOP OF CURB	TC	PROPOSED RET WALL	~~~~~
FLOWLINE	FL	WATER LINE	— v — v —
FINISH GROUND AT TOP OF WALL	TW	SANITARY SEWER LINE	— ss — ss —
FINISHED GROUND AT BOTTOM OF WALL	BW	GAS LINE	— ug — ug —
LOW POINT	LP	UNDERGROUND ELECTRICAL LINE	— ue — ue —
HIGH POINT	HP	TELEPHONE LINE	— ut —
FLOW ARROW		FIBER OPTIC LINE	— fd — fd —
		STORM SEWER LINE	— st — st —
		LIMIT OF CONSTRUCTION	— - - - -
		LIMIT OF SOIL DISTURBANCE	— - - - -
		PROPOSED FENCE	— - - - -
		FIRE HYDRANT	○ ○ ○ ○ ○

NOTES

- ALL HDPE STORM PIPE IS TO BE SMOOTH INTERIOR PIPE.
- LARGE BLOCKS OF TEXT QUOTING STANDARD DRAWINGS OR DETAILS ARE INCLUDED AS A REQUIREMENT OF COUNTY REVIEWERS.

BENCHMARKS

- #5 REBAR WITH ORANGE PLASTIC CAP MARKED "CSAM, LLC PLS 32439", FLUSH WITH GROUND - ELEV.=6513.85 (NAVD-1988) [NORTHWEST PROPERTY CORNER]

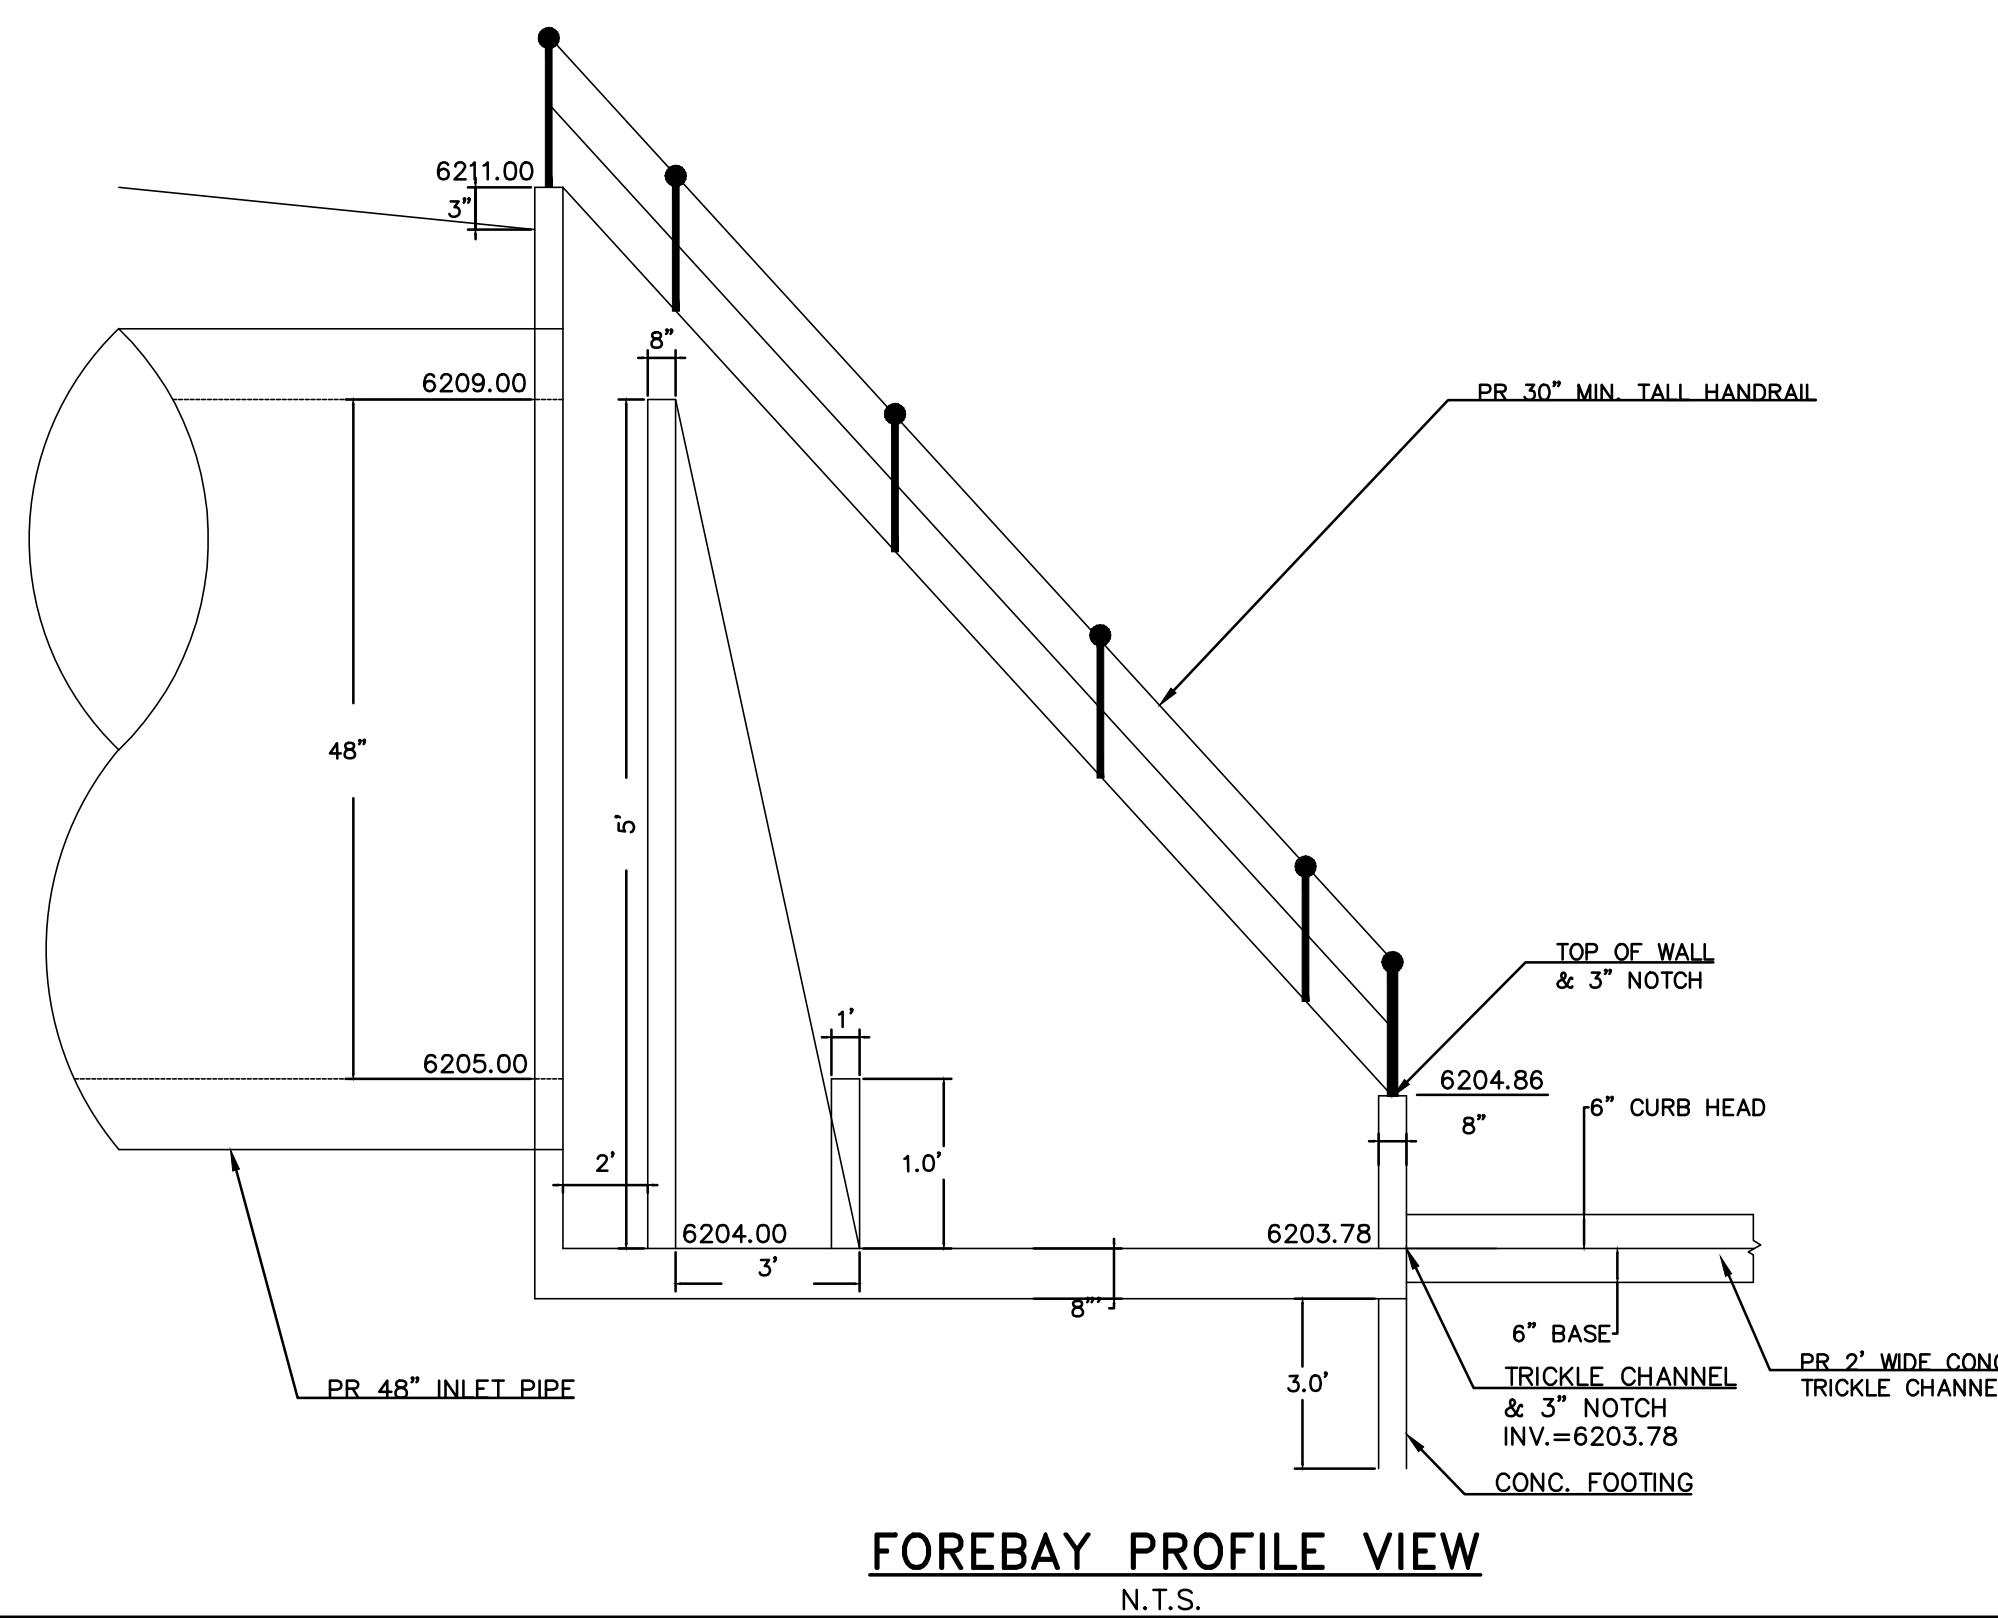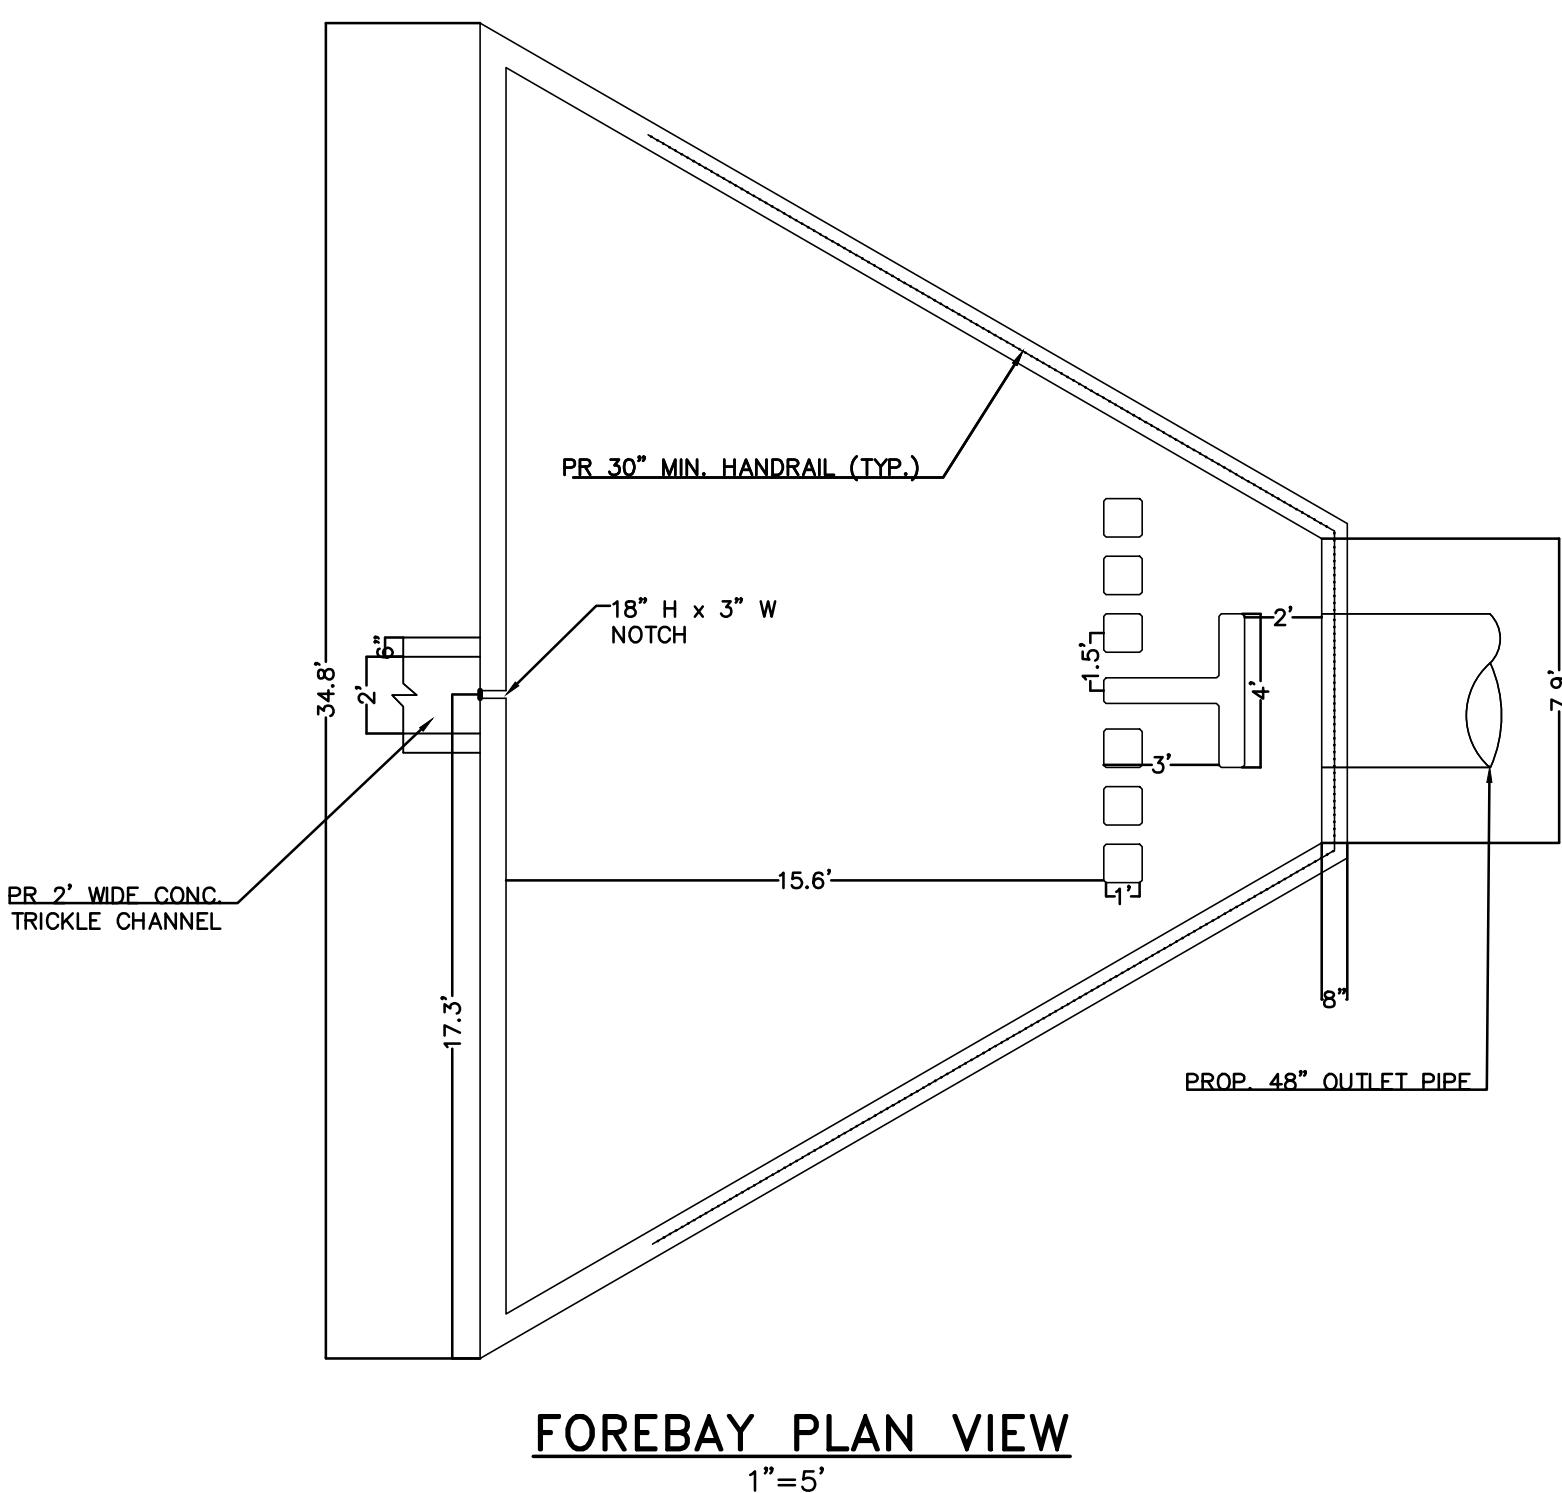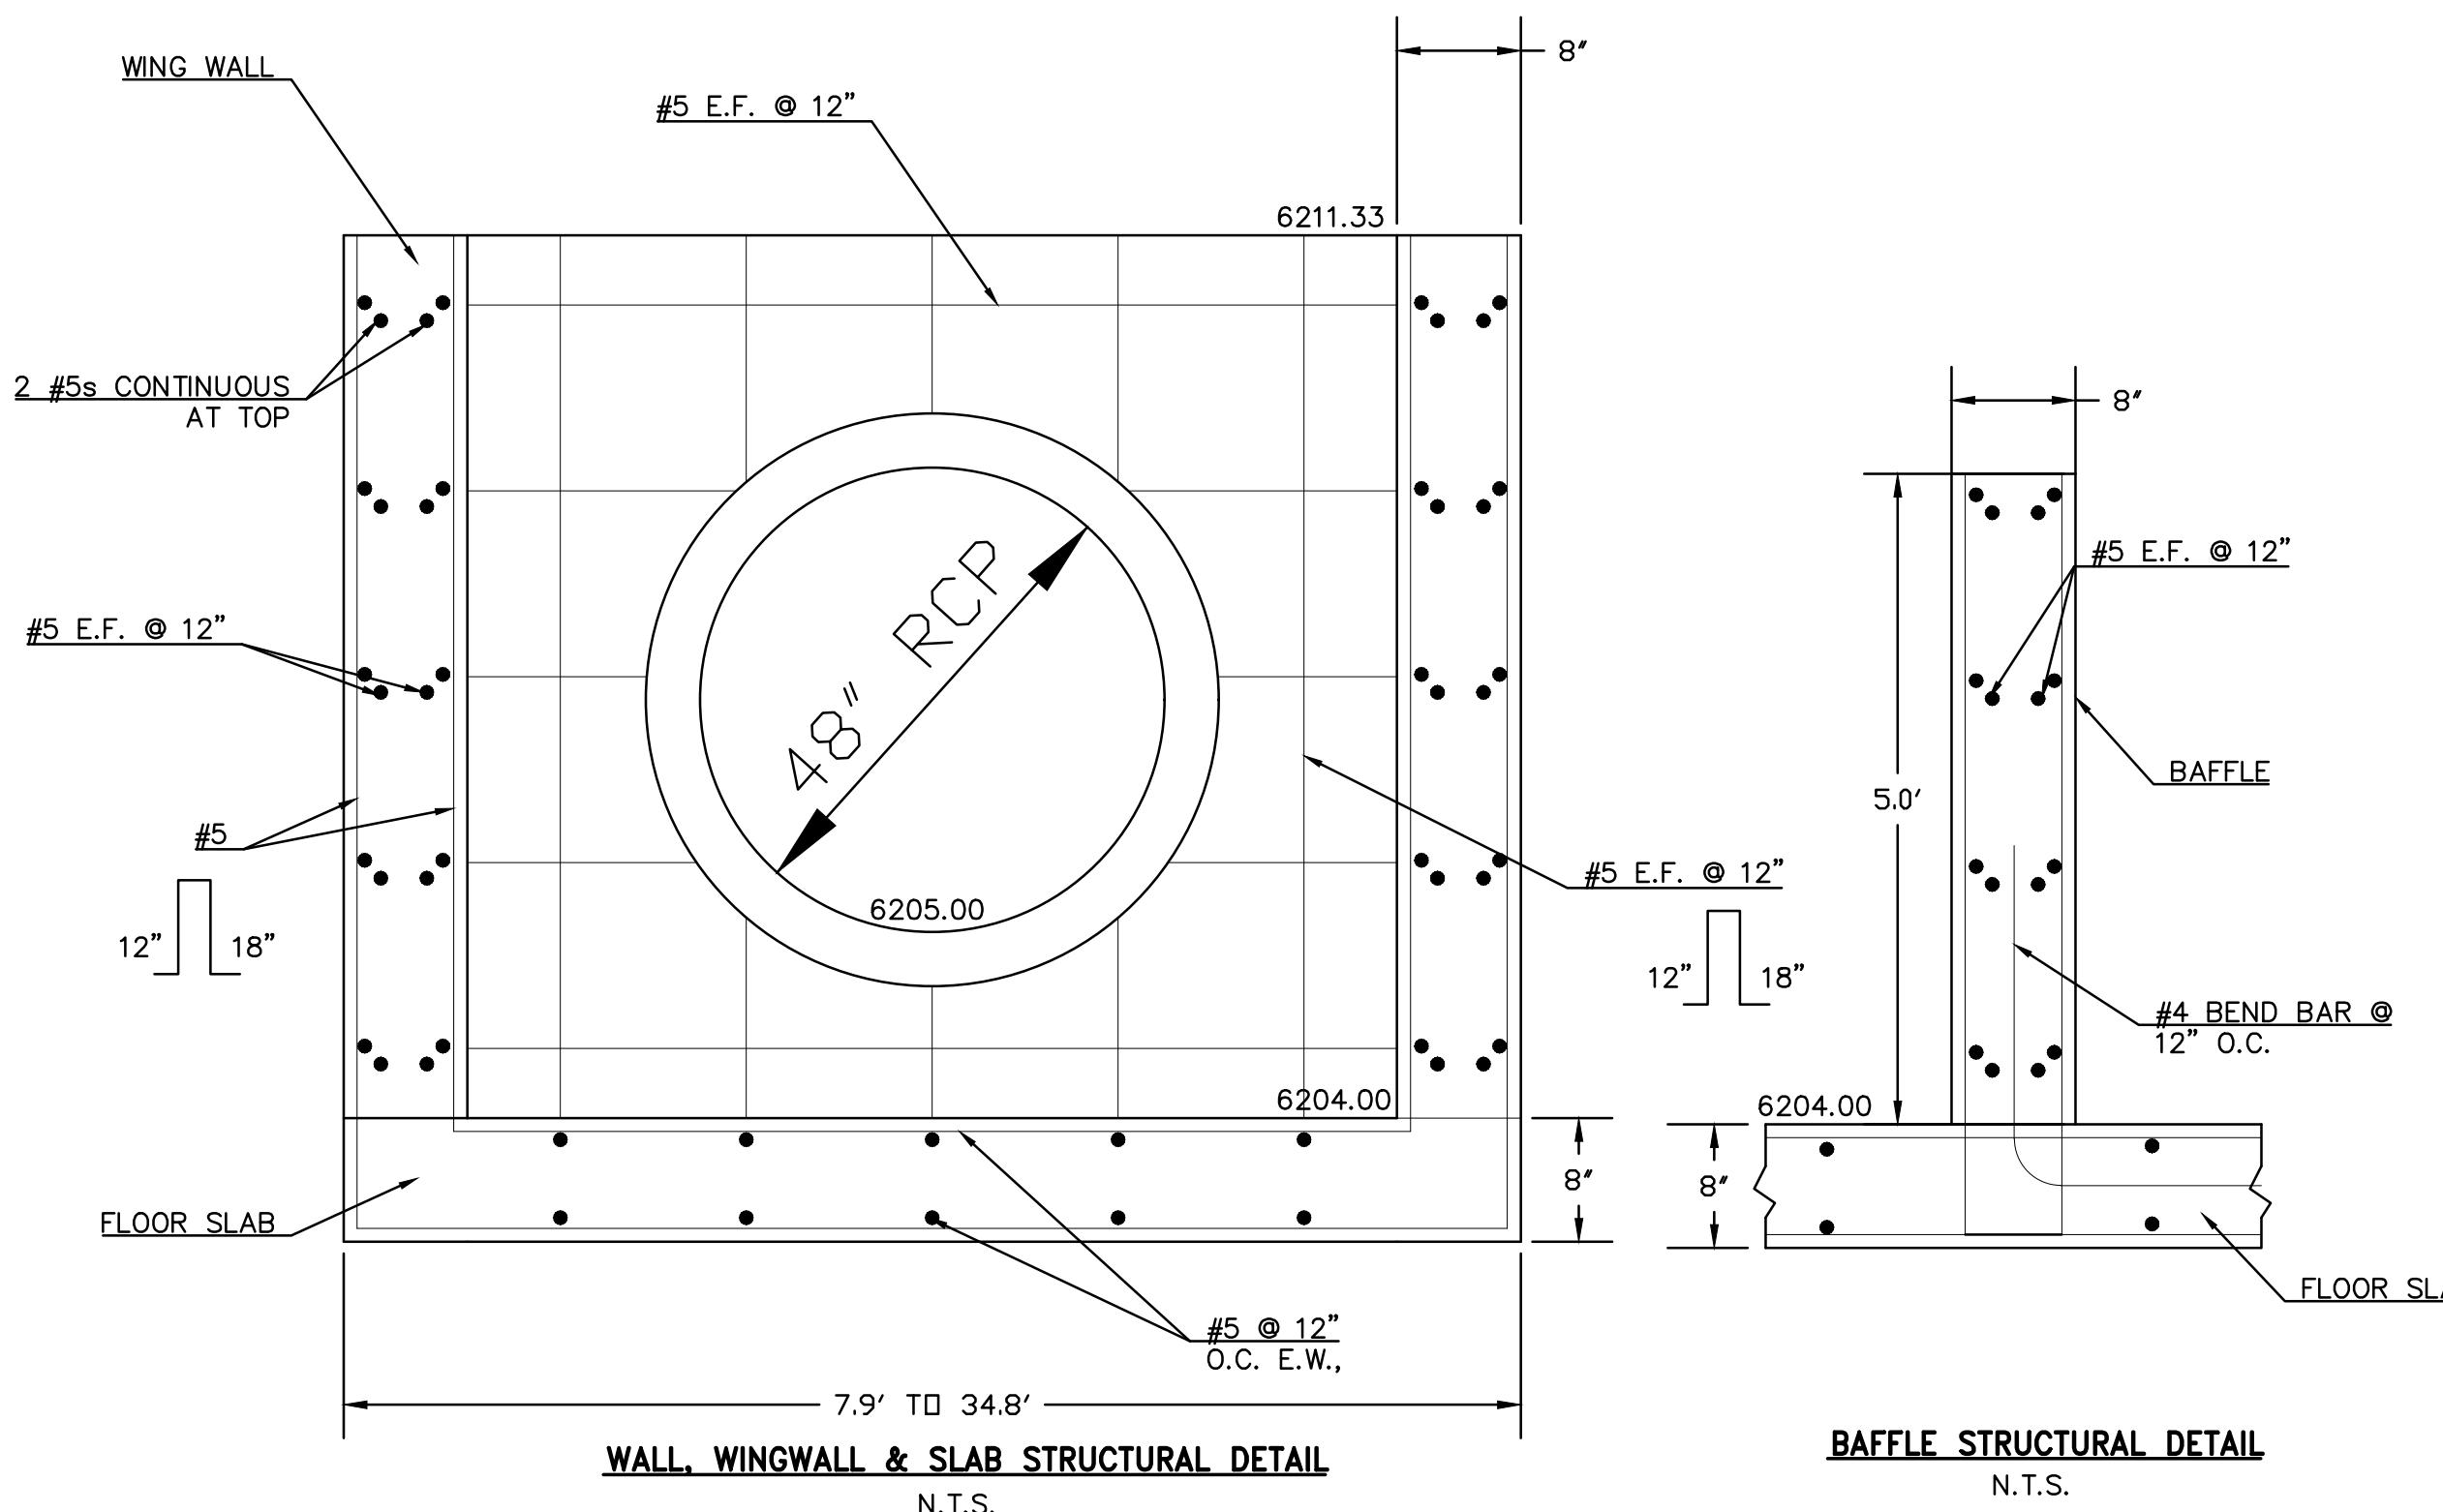


THIS DESIGN WAS PREPARED UNDER MY DIRECT SUPERVISION FOR AND ON BEHALF OF TERRA NOVA ENGINEERING, INC.

DANE FRANK
COLORADO P.E. # 50207

PLATTE SELF STORAGE

GRADING AND EROSION CONTROL PLAN
EXTENDED DETENTION BASIN PLAN

PREPARED FOR:
RMG-ROCKY MOUNTAIN GROUP
ATTN: #200
5085 LIST DR, #200
COLORADO SPRINGS, CO 80919
719.548.0600

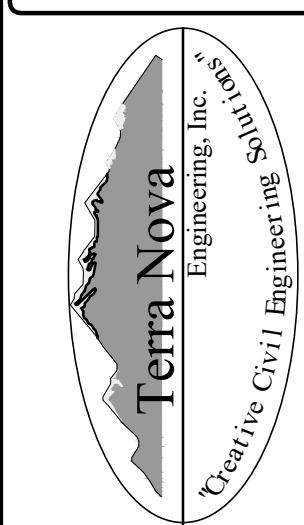

721 S. 23RD STREET
COLORADO SPRINGS, CO 80904
OFFICE: 719-535-6422
FAX: 719-535-6426
www.tnseinc.com

DESIGNED BY DLF
DRAWN BY DLF
CHECKED BY LD
H-SCALE AS SHOWN
V-SCALE N/A
JOB NO. 2419.00
DATE ISSUED 11/13/24
SHEET NO. 21 OF 27

NOTE: ALL EXISTING UNDERGROUND AND ABOVE GROUND UTILITY LOCATIONS, INVERTS AND SIZES ARE APPROXIMATE ONLY AND MUST BE FIELD VERIFIED PRIOR TO CONSTRUCTION. TIE IN POINTS SHALL BE POTHOLED AND LOCATIONS, INVERTS AND SIZES SHALL BE FIELD VERIFIED BY THE CONTRACTOR PRIOR TO CONSTRUCTION.


EL PASO COUNTY STANDARD CONSTRUCTION NOTES:

- ALL DRAINAGE AND ROADWAY CONSTRUCTION SHALL MEET THE STANDARDS AND SPECIFICATIONS OF THE CITY OF COLORADO SPRINGS/EL PASO COUNTY DRAINAGE CRITERIA MANUAL, VOLUMES 1 & 2 AND THE EL PASO COUNTY ENGINEERING CRITERIA MANUAL.
- CONTRACTOR SHALL BE RESPONSIBLE FOR THE NOTIFICATION AND FIELD NOTIFICATION OF ALL EXISTING UTILITIES, WHETHER SHOWN ON THE PLANS OR NOT, BEFORE BEGINNING CONSTRUCTION. LOCATION OF EXISTING UTILITIES SHALL BE VERIFIED BY THE CONTRACTOR PRIOR TO CONSTRUCTION. CALL 811 TO CONTACT THE UTILITY NOTIFICATION CENTER OF COLORADO (UNCC).
- CONTRACTOR SHALL KEEP A COPY OF THESE APPROVED PLANS, THE GRADING AND EROSION CONTROL PLAN, THE STORMWATER MANAGEMENT PLAN (SMP), THE SOILS AND GEOTECHNICAL REPORT, AND THE APPROPRIATE DESIGN AND CONSTRUCTION STANDARDS AND SPECIFICATIONS AT THE JOB SITE AT ALL TIMES, INCLUDING THE FOLLOWING:
 - EL PASO COUNTY ENGINEERING CRITERIA MANUAL (ECM)
 - CITY OF COLORADO SPRINGS/EL PASO COUNTY DRAINAGE CRITERIA MANUAL, VOLUMES 1 & 2
 - COLORADO DEPARTMENT OF TRANSPORTATION (CDOT) STANDARD SPECIFICATIONS FOR ROAD AND BRIDGE CONSTRUCTION
 - CDOT M & S STANDARDS
- NOTWITHSTANDING ANYTHING DEPICTED IN THESE PLANS IN WORDS OR GRAPHIC REPRESENTATION, ALL DESIGN AND CONSTRUCTION RELATED TO ROADS, STORM DRAINAGE AND EROSION CONTROL SHALL CONFORM TO THE STANDARDS AND REQUIREMENTS OF THE MOST RECENT VERSION OF THE RELEVANT ADOPTED EL PASO COUNTY STANDARDS, INCLUDING THE LAND DEVELOPMENT CODE, THE ENGINEERING CRITERIA MANUAL, THE DRAINAGE CRITERIA MANUAL, AND THE DRAINAGE CRITERIA MANUAL VOLUME 2. ANY DEVIATIONS FROM REGULATIONS AND STANDARDS MUST BE REQUESTED, AND APPROVED, IN WRITING. ANY MODIFICATIONS NECESSARY TO MEET CRITERIA AFTER-THE-FACE WILL BE ENTIRELY THE DEVELOPER'S RESPONSIBILITY TO RECTIFY.
- IT IS THE DESIGN ENGINEER'S RESPONSIBILITY TO ACCURATELY SHOW EXISTING CONDITIONS, BOTH ON SITE AND OFF-SITE, ON THE CONSTRUCTION PLANS. ANY MODIFICATIONS NECESSARY DUE TO CONFLICTS, OMISSIONS, OR CHANGED CONDITIONS WILL BE ENTIRELY THE DEVELOPER'S RESPONSIBILITY TO RECTIFY.
- CONTRACTOR SHALL SCHEDULE A PRE-CONSTRUCTION MEETING WITH EL PASO COUNTY PLANNING AND COMMUNITY DEVELOPMENT (PCD) INSPECTIONS, PRIOR TO STARTING CONSTRUCTION.
- IT IS THE CONTRACTORS RESPONSIBILITY TO UNDERSTAND THE REQUIREMENTS OF ALL JURISDICTIONAL AGENCIES AND TO OBTAIN ALL REQUIRED PERMITS, INCLUDING BUT NOT LIMITED TO EL PASO COUNTY EROSION AND STORMWATER QUALITY CONTROL PERMIT (ESQCP), REGIONAL BUILDING FLOODPLAIN DEVELOPMENT PERMIT, U.S. ARMY CORPS OF ENGINEERS-ISSUED 401 AND/OR 404 PERMITS, AND COUNTY AND STATE FUGITIVE DUST PERMITS.
- CONTRACTOR SHALL NOT DEVIATE FROM THE PLANS WITHOUT FIRST OBTAINING WRITTEN APPROVAL FROM THE DESIGN ENGINEER AND PCD. CONTRACTOR SHALL NOTIFY THE DESIGN ENGINEER IMMEDIATELY UPON DISCOVERY OF ANY ERRORS OR INCONSISTENCIES.
- ALL STORM DRAIN PIPE SHALL BE CLASS III RCP UNLESS OTHERWISE NOTED AND APPROVED BY PCD.
- CONTRACTOR SHALL COORDINATE GEOTECHNICAL TESTING PER ECM STANDARDS. PAVEMENT DESIGN SHALL BE APPROVED BY EL PASO COUNTY PCD PRIOR TO PLACEMENT OF CURB AND GUTTER AND PAVEMENT.
- ALL CONSTRUCTION TRAFFIC MUST ENTER/EXIT THE SITE AT APPROVED CONSTRUCTION ACCESS POINTS.
- SIGHT VISIBILITY TRIANGLES AS IDENTIFIED IN THE PLANS SHALL BE PROVIDED AT ALL INTERSECTIONS. OBSTRUCTIONS GREATER THAN 18 INCHES ABOVE FLOWLINE ARE NOT ALLOWED WITHIN SIGHT TRIANGLES.
- SIGNING AND STRIPING SHALL COMPLY WITH EL PASO COUNTY PUBLIC WORK DEPARTMENT AND MUTCD CRITERIA.
- CONTRACTOR SHALL OBTAIN ANY PERMITS REQUIRED BY EL PASO COUNTY PWD, INCLUDING WORK WITHIN THE RIGHT-OF-WAY AND SPECIAL TRANSPORT PERMITS.
- THE LIMITS OF CONSTRUCTION SHALL REMAIN WITHIN THE PROPERTY LINE UNLESS OTHERWISE NOTED. THE OWNER/DEVELOPER SHALL OBTAIN WRITTEN PERMISSION AND EASEMENTS, WHERE REQUIRED, FROM ADJOINING PROPERTY OWNER(S) PRIOR TO ANY OFF-SITE DISTURBANCE, GRADING OR CONSTRUCTION.

GENERAL NOTES

- IT SHALL BE THE RESPONSIBILITY OF THE CONTRACTOR TO VERIFY THE EXISTENCE AND LOCATION OF ALL UNDERGROUND UTILITIES ALONG THE SITE. THE OMISSION FROM OR THE INCLUSION OF UTILITY LOCATIONS ON THE PLANS IS NOT TO BE CONSIDERED AS THE NON-EXISTENCE OR OF A DEFINITE LOCATION OF EXISTING UNDERGROUND UTILITIES.
- THE CONTRACTOR WILL TAKE THE NECESSARY PRECAUTIONS TO PROTECT EXISTING UTILITIES, BUILDINGS, FENCES, AND ROADWAYS FROM DAMAGE DUE TO THIS OPERATION. ANY DAMAGE TO THE ABOVE WILL BE REPAIRED AT THE CONTRACTOR'S EXPENSE, AND ANY SERVICE DISRUPTION WILL BE SETTLED BY THE CONTRACTOR.
- BULK GRADING SHALL BE COMPLETED TO A SUBGRADE TOLERANCE OF PLUS OR MINUS 0.2".
- CONTRACTOR TO OBTAIN COPIES OF THE SOILS REPORT FROM THE GEOTECHNICAL ENGINEER AND TO BE KEPT ON SITE DURING ALL EARTHWORK OPERATIONS. CONTRACTOR SHALL REVIEW GEOTECHNICAL REPORT BY GEOTECHNICAL ENGINEER PRIOR TO CONSTRUCTION.
- MAXIMUM CUT/FILL SLOPES SHALL NOT EXCEED 3:1, UNLESS OTHERWISE NOTED.
- EROSION CONTROL MEASURES SHALL BE IMPLEMENTED IN A MANNER THAT WILL PROTECT PROPERTIES AND PUBLIC FACILITIES FROM THE ADVERSE EFFECTS OF EROSION AND SEDIMENTATION AS A RESULT OF CONSTRUCTION AND EARTHWORK ACTIVITIES WITHIN THE PROJECT SITE.
- EROSION CONTROL DEVICES SHOULD BE CHECKED AFTER EVERY STORM. REPAIRS OR REPLACEMENT SHOULD BE MADE AS NECESSARY TO MAINTAIN PROPER PROTECTION.
- CONTRACTOR SHALL REVIEW GEOTECHNICAL REPORT BY GEOTECHNICAL ENGINEER PRIOR TO CONSTRUCTION.
- BROWN GROUND SURFACE CONTOURS ARE LIDAR DATA DOWNLOADED FROM THE COLORADO HAZARD MAPPING & RISK MAP PORTAL, DATA SET: 2018_3DEP_EAST_CO_EL_PASO. THIS DATA IS APPROXIMATE. LIDAR DATA IS FROM 2018 AND AT 2' INTERVALS.

PLATTE SELF STORAGE STREET IMPROVEMENT PLAN COVER SHEET NOVEMBER 2024

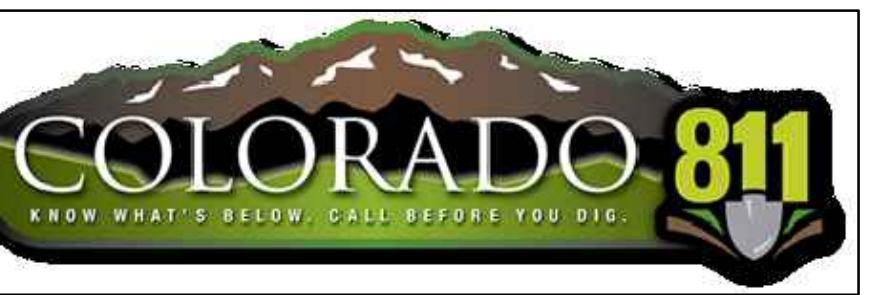

SITE ADDRESS
6001 E PLATTE AVE, COLORADO SPRINGS

TAX ID
5418000075

LEGAL DESCRIPTION


TRACT IN NW4 OF SEC 18-14-65 AS FOLS, BEG AT A PT ON S/R/W LN OF US HWY 24 940 FT E OF W LN OF SD SEC, TH E ON SD LN 310 FT, ANG R 90< S 25 FT, ANG L 90< E 155.2 FT M/L, S 931.8 FT, W PARA WITH S LN OF N2 426.1 FT M/L TO A PT, TH ANG R 89<59' N 958.2 FT TO POB, W 349.88 FT OF NE4NW4 OF SEC 18 EX HWY BY BK 6509-223 & REC #201040780

SOIL TYPES


ONSITE SOILS ARE HYDROLOGIC GROUP "A", BLAKELAND LOAMY SAND (8), 1 TO 9 PERCENT SLOPES (PER NRCS WEB SOIL SURVEY MAP)

BENCHMARKS

CDOT RIGHT OF WAY MONUMENT #3014 – ELEV=6232.52 (NAVD-1988)
[NORTHEAST OF SITE ENTRANCE]

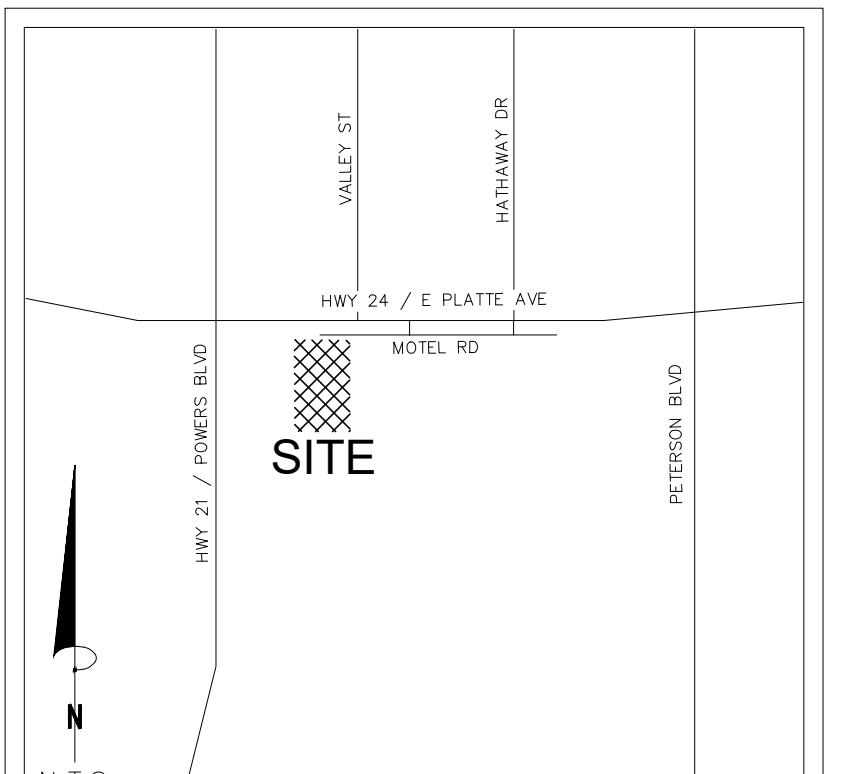

VICINITY MAP
N.T.S.

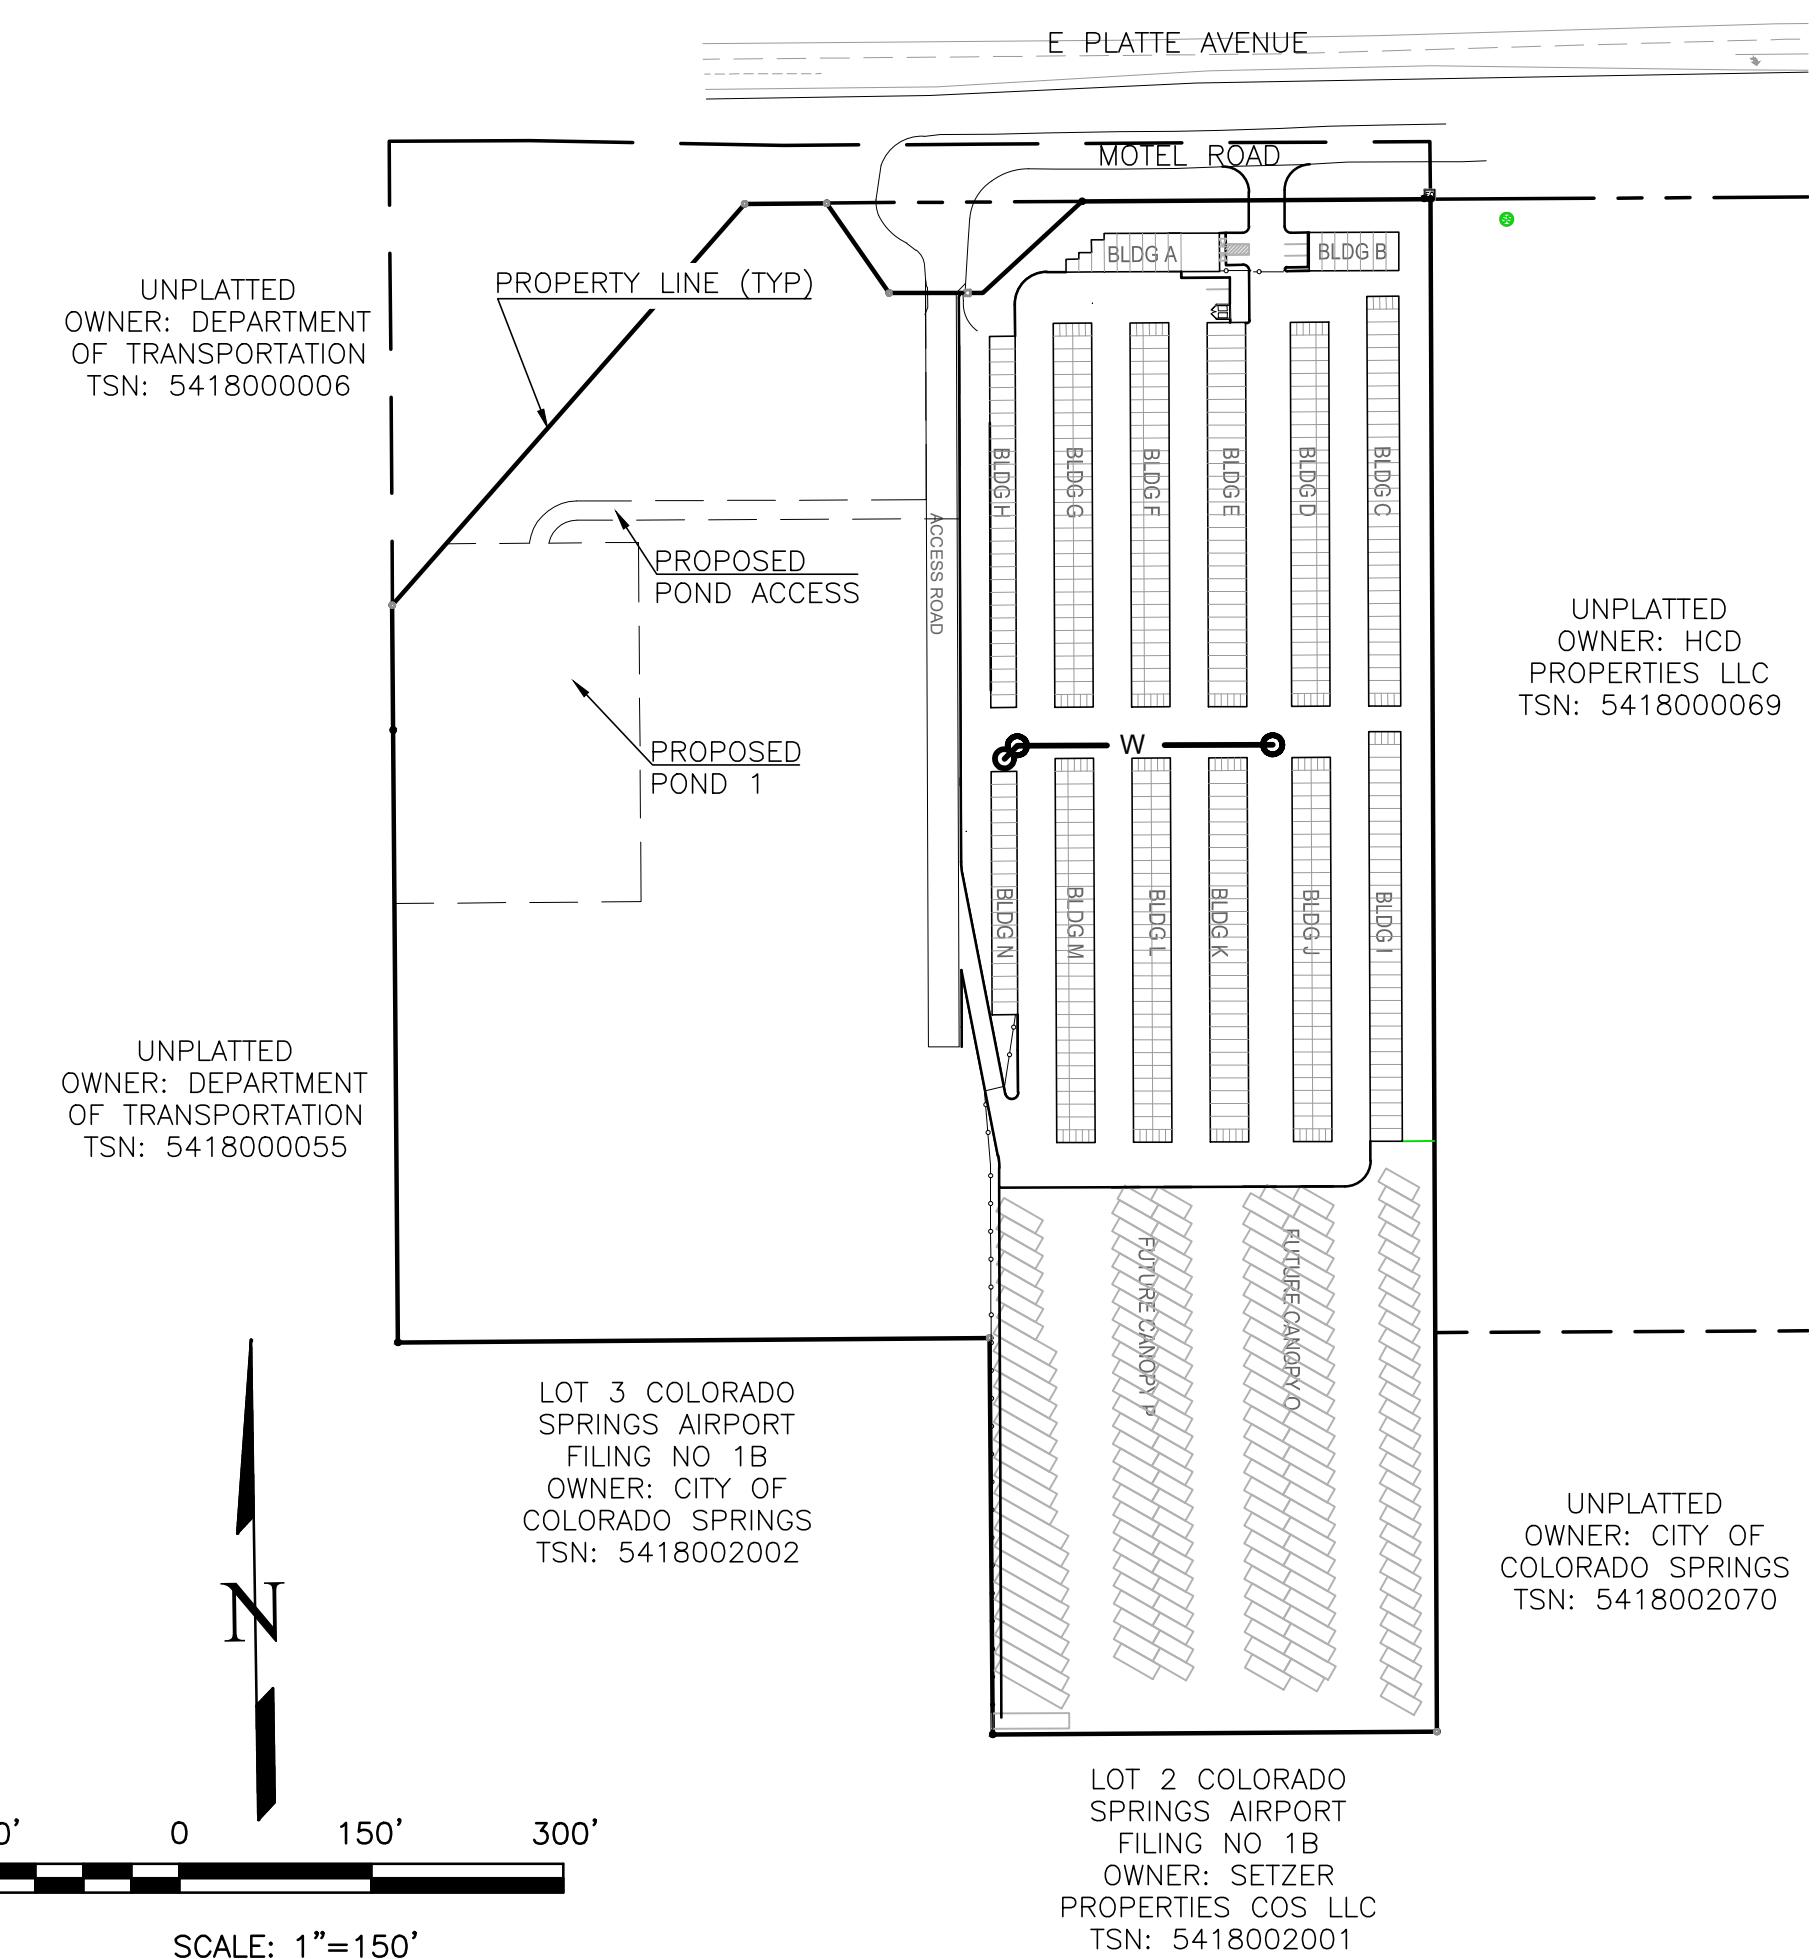

SCALE: 1"=150'

CONTACT INFORMATION:

OWNER: DONALD HUMPHREY
5780 SAYRES ROAD
COLORADO SPRINGS, CO 80927
(719) 492-8649

CIVIL ENGINEER: TERRA NOVA ENGINEERING, INC.
721 S. 23RD STREET
COLORADO SPRINGS, COLORADO 80904
DALE FRANK, P.E., (719) 635-6422

EL PASO COUNTY PLANNING AND COMMUNITY DEVELOPMENT
2880 INTERNATIONAL CIRCLE
COLORADO SPRINGS, COLORADO 80910
(719) 520-6300

CIMARRON HILLS FIRE DEPT HEADQUARTERS
1835 TUSKEGEE PL
COLORADO SPRINGS, COLORADO 80915
(719) 591-0960

CHEROKEE METRO DISTRICT 6250 PALMER PARK BOULEVARD
COLORADO SPRINGS, COLORADO 80915
(719) 597-5080

ENGINEER'S STATEMENT

THESE DETAILED PLANS AND SPECIFICATIONS WERE PREPARED UNDER MY DIRECTION AND SUPERVISION. SAID PLANS AND SPECIFICATIONS HAVE BEEN PREPARED ACCORDING TO THE CRITERIA ESTABLISHED BY THE COUNTY FOR DETAILED ROADWAY, DRAINAGE, GRADING AND EROSION CONTROL PLANS AND SPECIFICATIONS, AND SAID PLANS AND SPECIFICATIONS ARE IN CONFORMITY WITH APPLICABLE MASTER DRAINAGE PLANS AND MASTER TRANSPORTATION PLANS. SAID PLANS AND SPECIFICATIONS MEET THE PURPOSES FOR WHICH THE PARTICULAR ROADWAY AND DRAINAGE FACILITIES ARE DESIGNED AND ARE CORRECT TO THE BEST OF MY KNOWLEDGE AND BELIEF. I ACCEPT RESPONSIBILITY FOR ANY LIABILITY CAUSED BY ANY NEGIGENT ACTS, ERRORS OR OMISSIONS ON MY PART IN PREPARATION OF THESE DETAILED PLANS AND SPECIFICATIONS.

ENGINEER OF RECORD SIGNATURE DATE
DANE FRANK, P.E. #50207
FOR AND ON BEHALF OF TERRA NOVA ENGINEERING, INC.

OWNER/DEVELOPER'S STATEMENT

I, THE OWNER/DEVELOPER HAVE READ AND WILL COMPLY WITH ALL OF THE REQUIREMENTS SPECIFIED IN THESE DETAILED PLANS AND SPECIFICATIONS.

OWNER NAME, TITLE DATE

BUSINESS NAME, ADDRESS


EL PASO COUNTY APPROVAL

COUNTY PLAN REVIEW IS PROVIDED ONLY FOR GENERAL CONFORMANCE WITH COUNTY DESIGN CRITERIA. THE COUNTY IS NOT RESPONSIBLE FOR THE ACCURACY AND ADEQUACY OF THE DESIGN, DIMENSIONS, AND/OR ELEVATIONS WHICH SHALL BE CONFIRMED AT THE JOB SITE. THE COUNTY THROUGH THE APPROVAL OF THIS DOCUMENT ASSUMES NO RESPONSIBILITY FOR COMPLETENESS AND/OR ACCURACY OF THIS DOCUMENT.

FILED IN ACCORDANCE WITH THE REQUIREMENTS OF THE EL PASO COUNTY LAND DEVELOPMENT CODE, DRAINAGE CRITERIA MANUAL, VOLUMES 1 AND 2, AND ENGINEERING CRITERIA MANUAL AS AMENDED.


IN ACCORDANCE WITH ECM SECTION 1.12, THESE CONSTRUCTION DOCUMENTS WILL BE VALID FOR CONSTRUCTION FOR A PERIOD OF 2 YEARS FROM THE DATE SIGNED BY THE EL PASO COUNTY ENGINEER. IF CONSTRUCTION HAS NOT STARTED WITHIN THOSE 2 YEARS, THE PLANS WILL NEED TO BE RESUBMITTED FOR APPROVAL, INCLUDING PAYMENT OF REVIEW FEES AT THE PLANNING AND COMMUNITY DEVELOPMENT DIRECTOR'S DISCRETION.


JENNIFER IRVINE, P.E. DATE
COUNTY ENGINEER / ECM ADMINISTRATOR

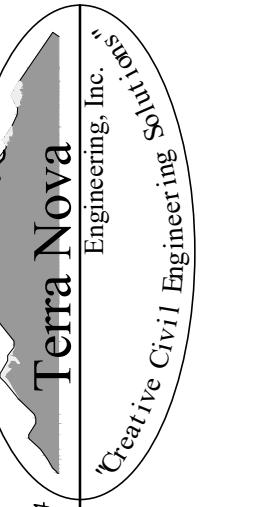REVISIONS	DATE
NO. _____	DESCRIPTION _____
UNTIL SUCH TIME AS THESE DRAWINGS ARE APPROVED BY THE APPROPRIATE REVIEWING AGENCIES, INC. APPROVES THEIR USE ONLY FOR THE PURPOSES DESIGNATED BY WRITTEN AUTHORIZATION.	
PREPARED FOR: RMG-ROCKY MOUNTAIN GROUP ATTN: 5085 LIST DR, #200 COLORADO SPRINGS, CO 80919 719.548.0600	
	
DESIGNED BY DLF DRAWN BY DLF CHECKED BY LD	
H-SCALE AS SHOWN V-SCALE N/A	
JOB NO. 2419.00 DATE ISSUED 11/13/24 SHEET NO. 22 OF 27	

PLATTE SELF STORAGE STREET IMPROVEMENT PLAN OVERVIEW SHEET

NOVEMBER 2024

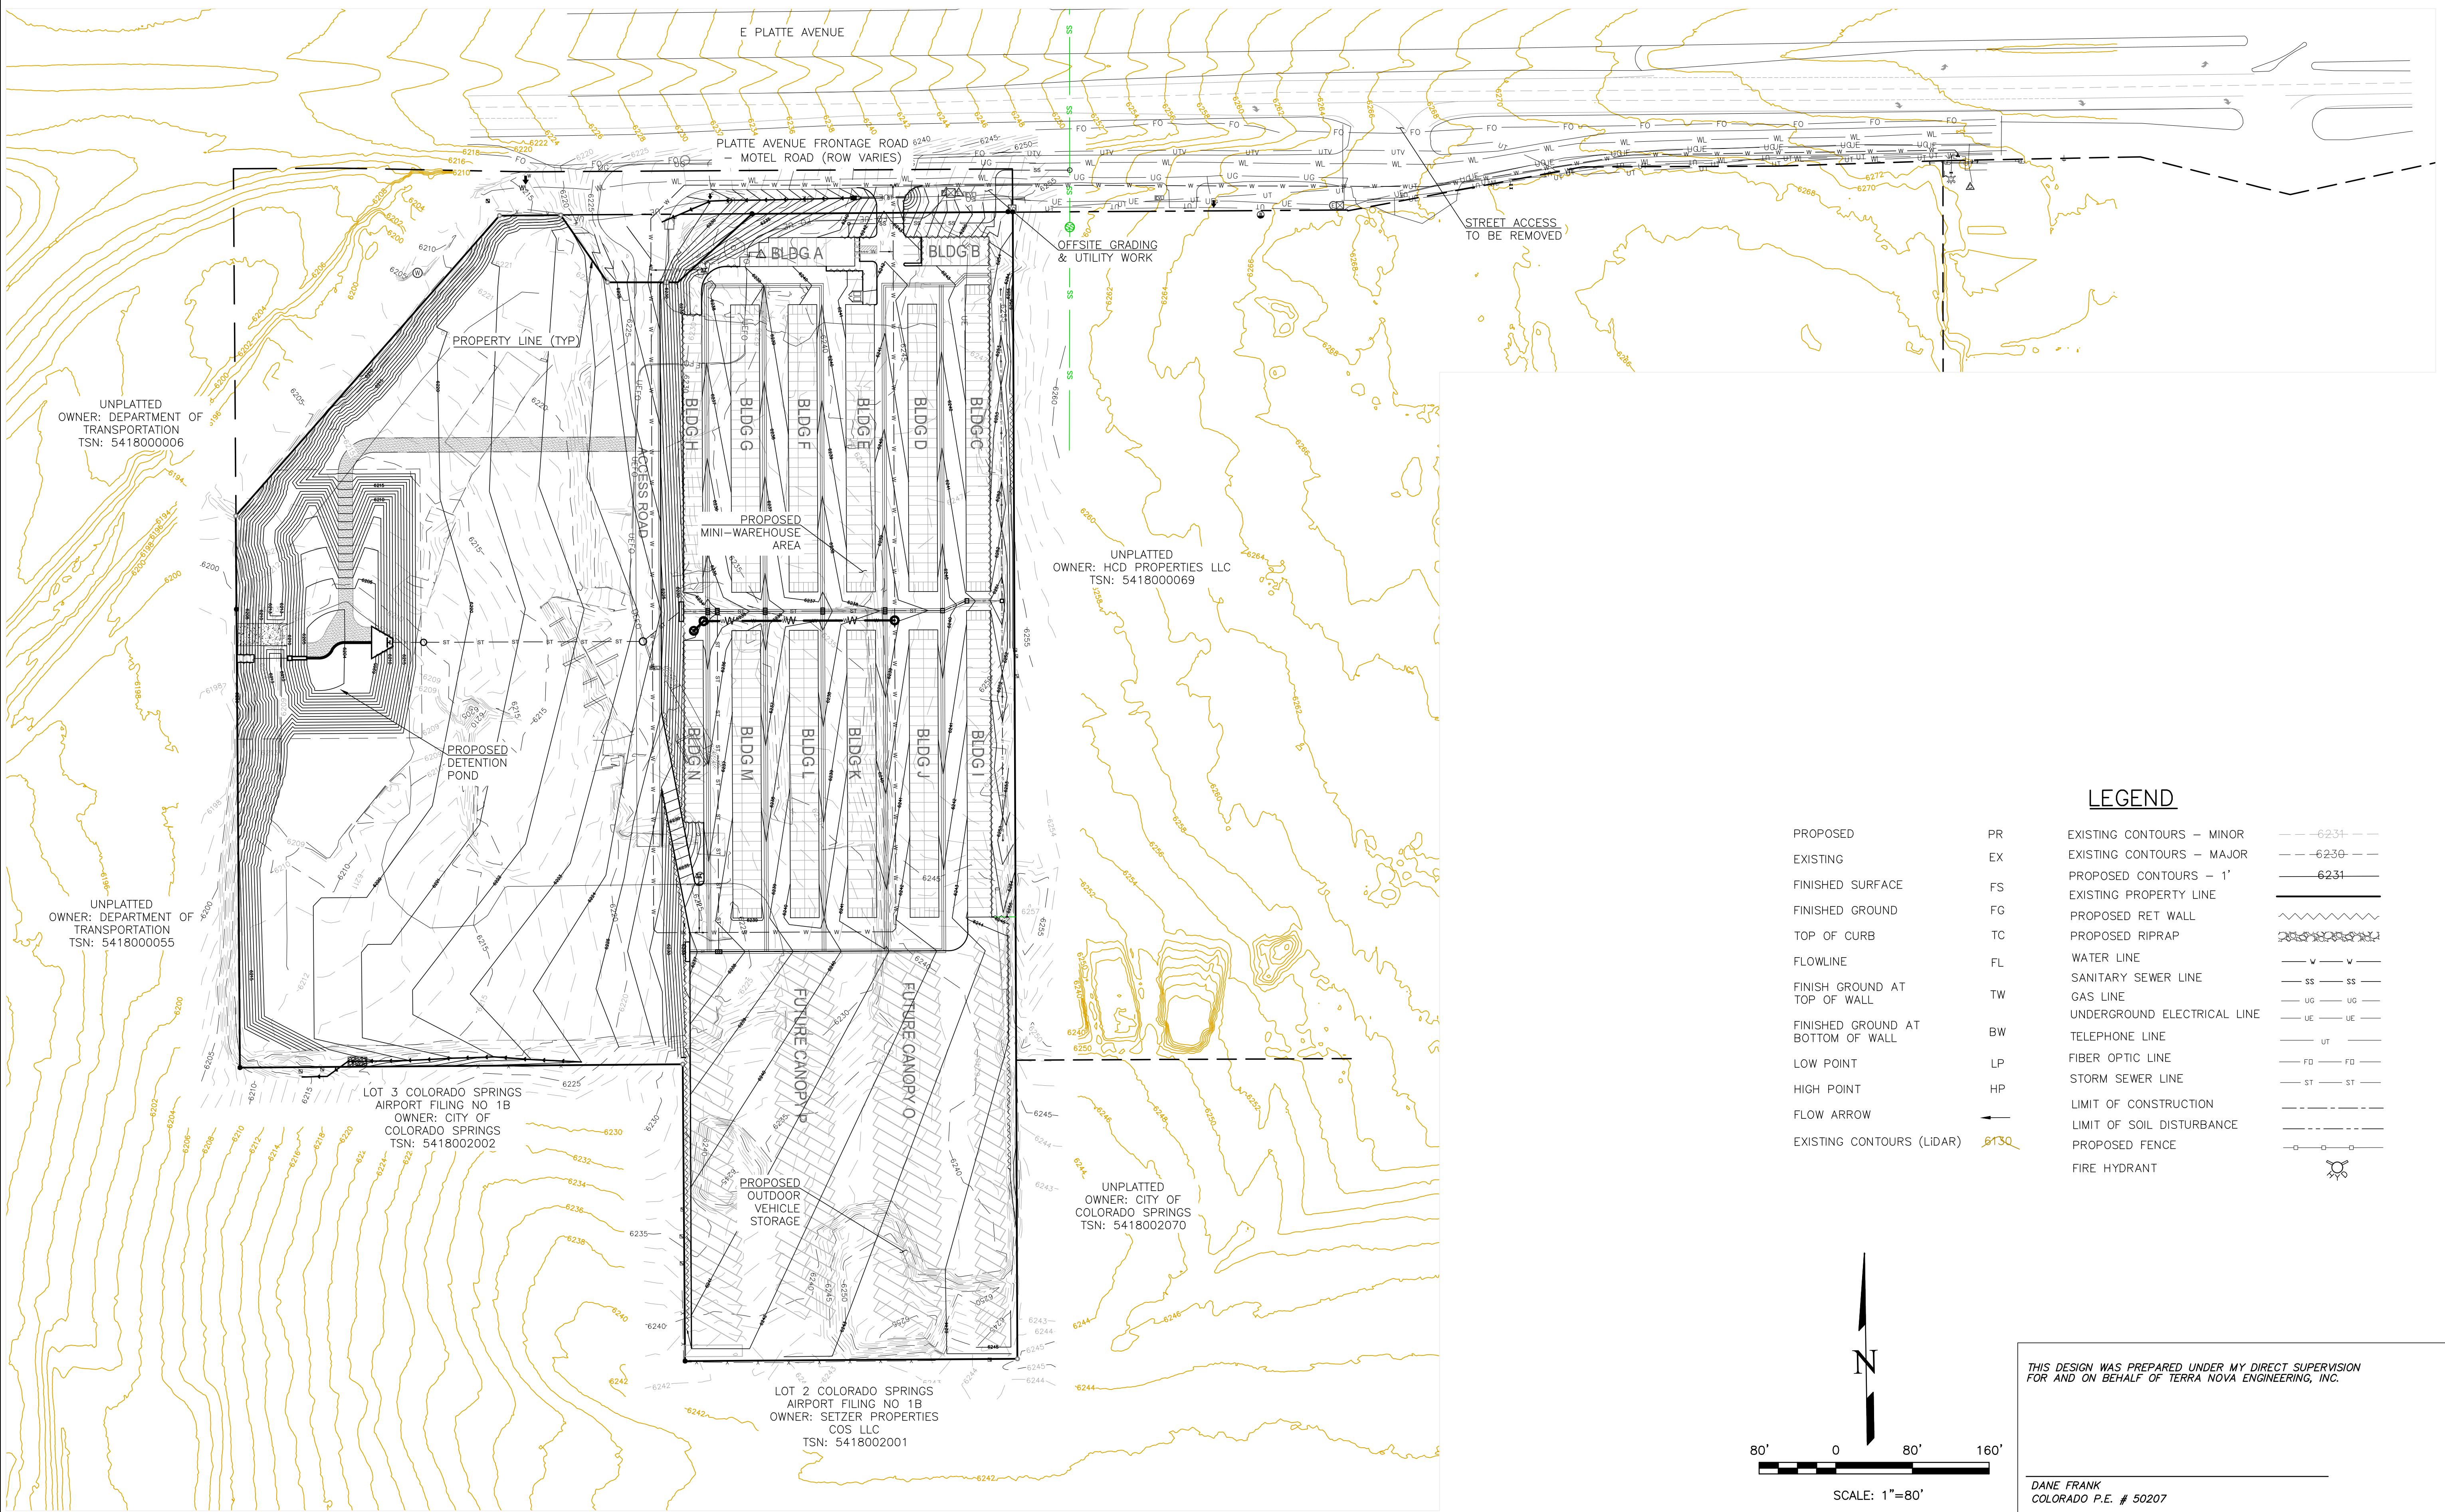

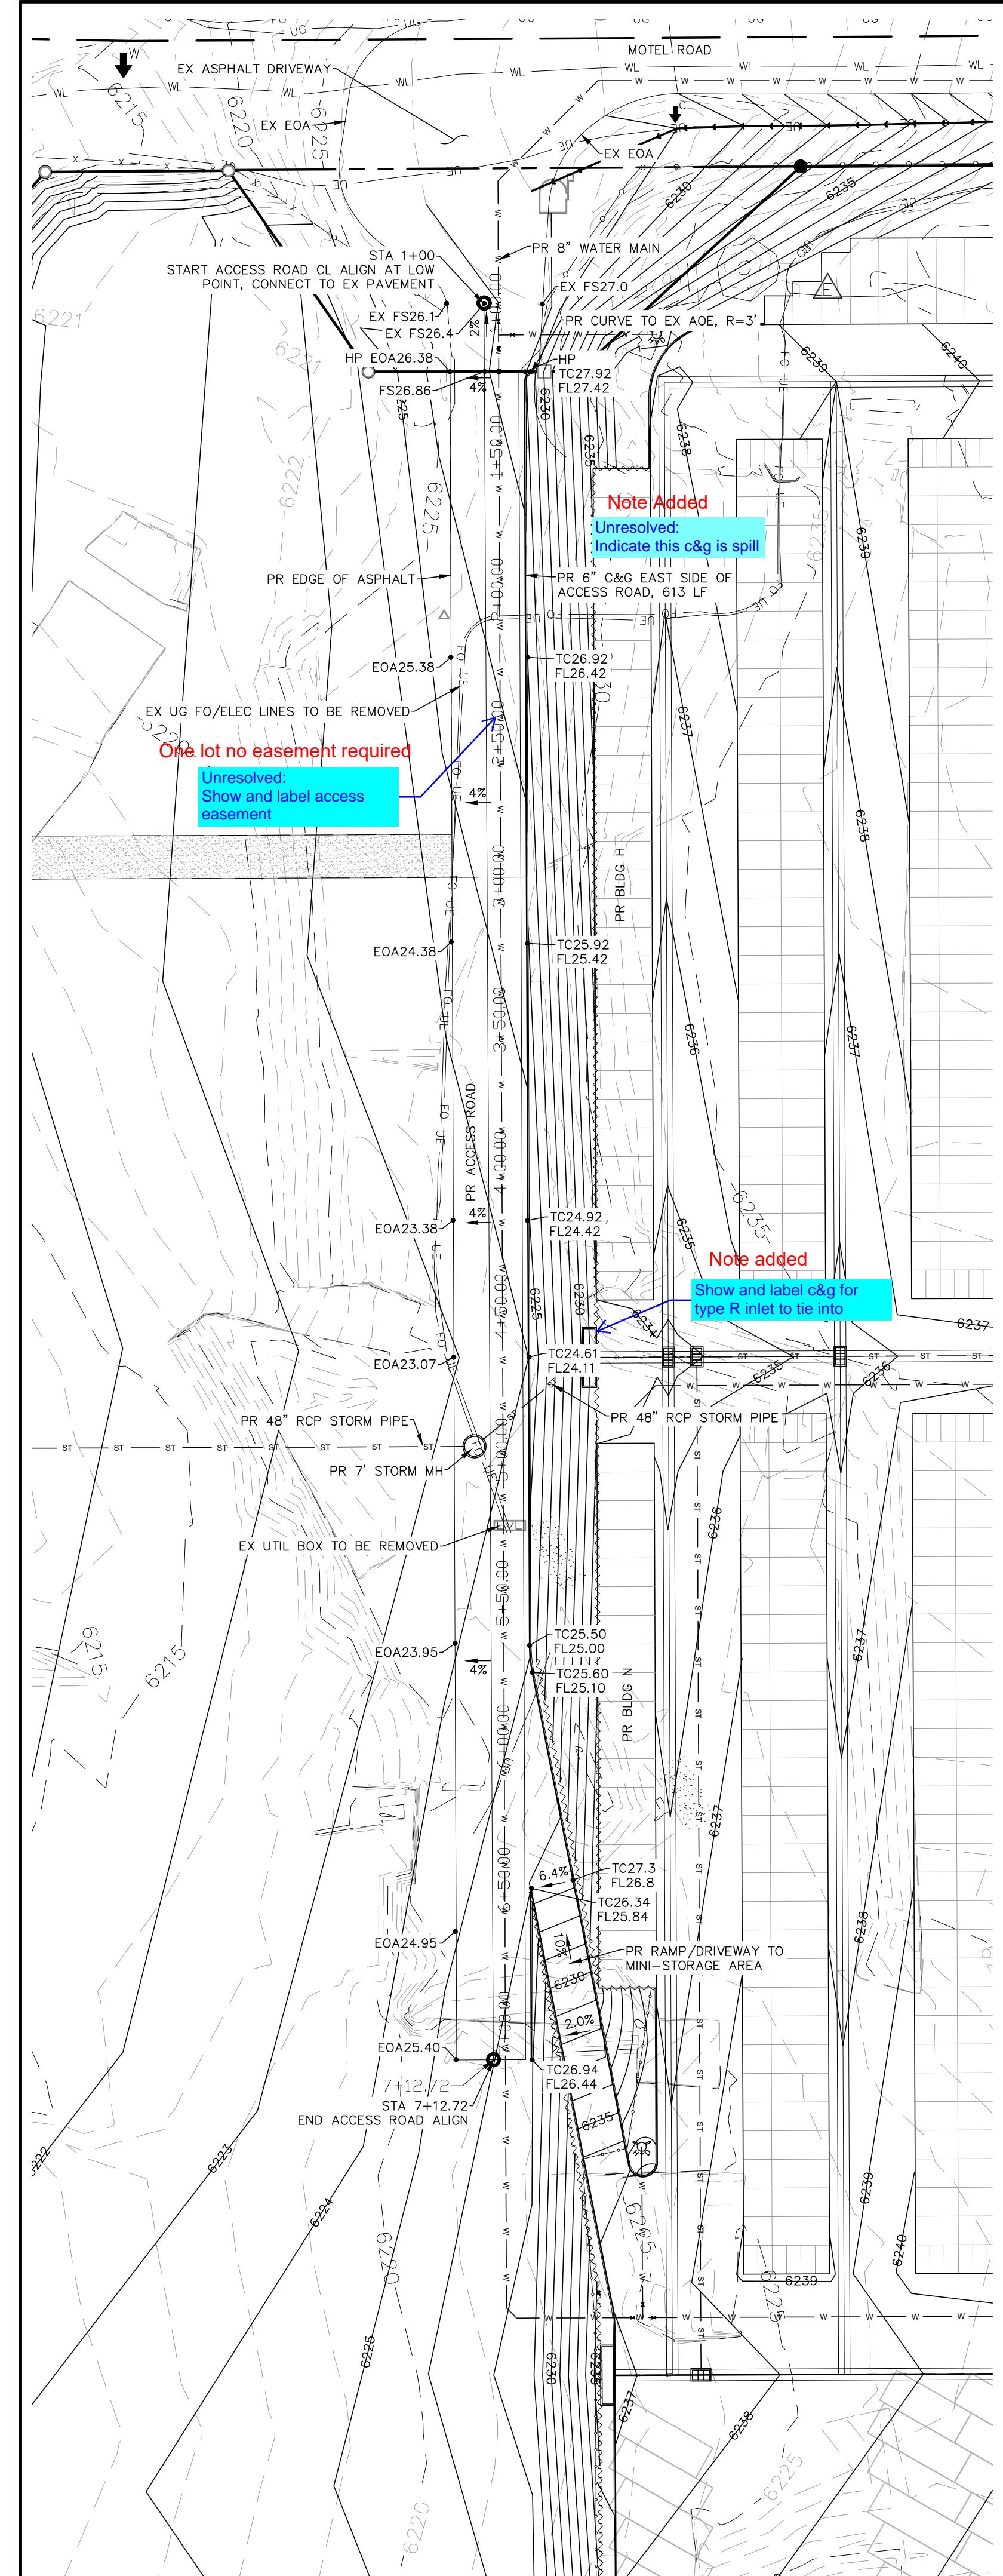

SIDWALK: WIDTH

LOCATION: ATTACHED DETACHED

DESIGN SPEED: 25 MPH (POSTED)

CURB TYPE: 1 2 3 4 5

ROW WIDTH: FL-FL: 28'

STREET TYPE: CUSTOM

PAVEMENT TYPE: HMA PCC

THICKNESS:

COMPOSITE SECTION:

HMA BASE

SUBGRADE STABILIZATION:

CHEMICAL MECHANICAL

TYPE: THICKNESS


LEGEND

PROPOSED	PR	EXISTING CONTOURS - MINOR
EXISTING	EX	EXISTING CONTOURS - MAJOR
FINISHED SURFACE	FS	PROPOSED CONTOURS - 1'
FINISHED GROUND	FG	EXISTING PROPERTY LINE
TOP OF CURB	TC	PROPOSED RET WALL
FLOWLINE	FL	PROPOSED RIPRAP
FINISH GROUND AT TOP OF WALL	TW	WATER LINE
FINISHED GROUND AT BOTTOM OF WALL	BW	SANITARY SEWER LINE
LOW POINT	LP	GAS LINE
HIGH POINT	HP	UNDERGROUND ELECTRICAL LINE
TELEPHONE LINE		TELEPHONE LINE
FIBER OPTIC LINE		STORM SEWER LINE
STORM SEWER LINE		LIMIT OF CONSTRUCTION
LIMIT OF SOIL DISTURBANCE		LIMIT OF SOIL DISTURBANCE
PROPOSED FENCE		PROPOSED FENCE
EXISTING CONTOURS (LIDAR)	BT3Q	FIRE HYDRANT

REVISIONS
NO. _____ DATE _____

UNTIL SUCH TIME AS THESE DRAWINGS ARE APPROVED BY THE APPROPRIATE REVIEWING AGENCIES, TERRA NOVA ENGINEERING, INC. APPROVES THEIR USE ONLY FOR THE PURPOSES DESIGNATED BY WRITTEN AUTHORIZATION.

PREPARED FOR:
ATTN: #200
RMG-ROCKY MOUNTAIN GROUP
5085 LIST DR,
COLORADO SPRINGS, CO 80919
719.548.0600

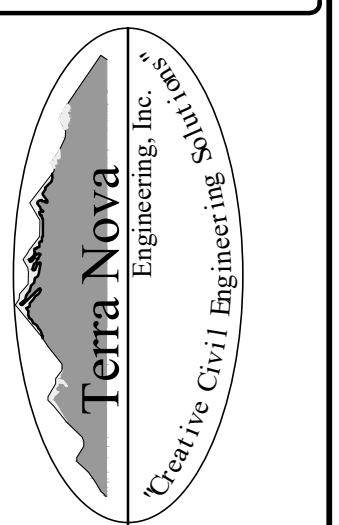

Engineering, Inc.
Civil/Structural/Geotechnical
Terra Nova
Engineering, Inc.
Civil/Structural/Geotechnical Services

www.tresinc.com


OFFICE: 719-535-4422
FAX: 719-535-4426

21 S. 23rd STREET
COLORADO SPRINGS, CO 80904


www.tresinc.com

PLATE SELF STORAGE

STREET IMPROVEMENT PLAN
ACCESS ROAD PLAN & PROFILE

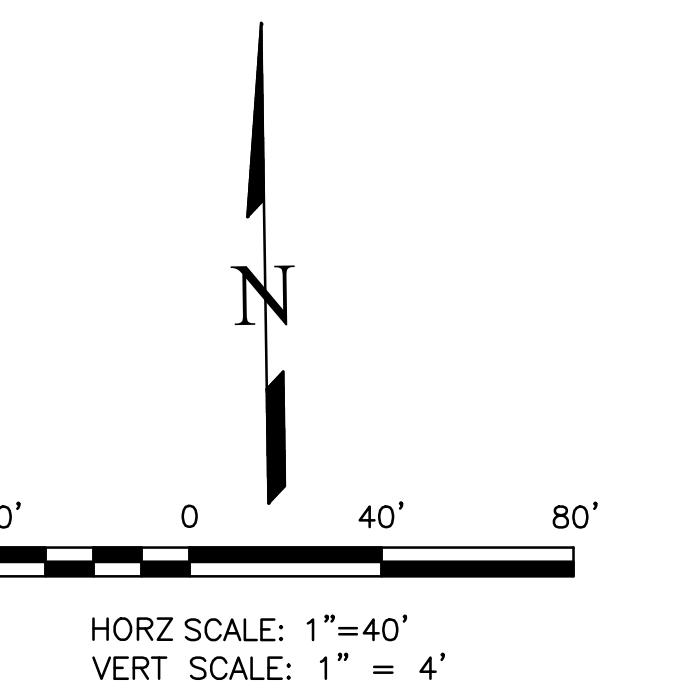

ACCESS ROAD - PLAN & PROFILE
HORZ SCALE: 1"=40' - VERT SCALE: 1"=4'

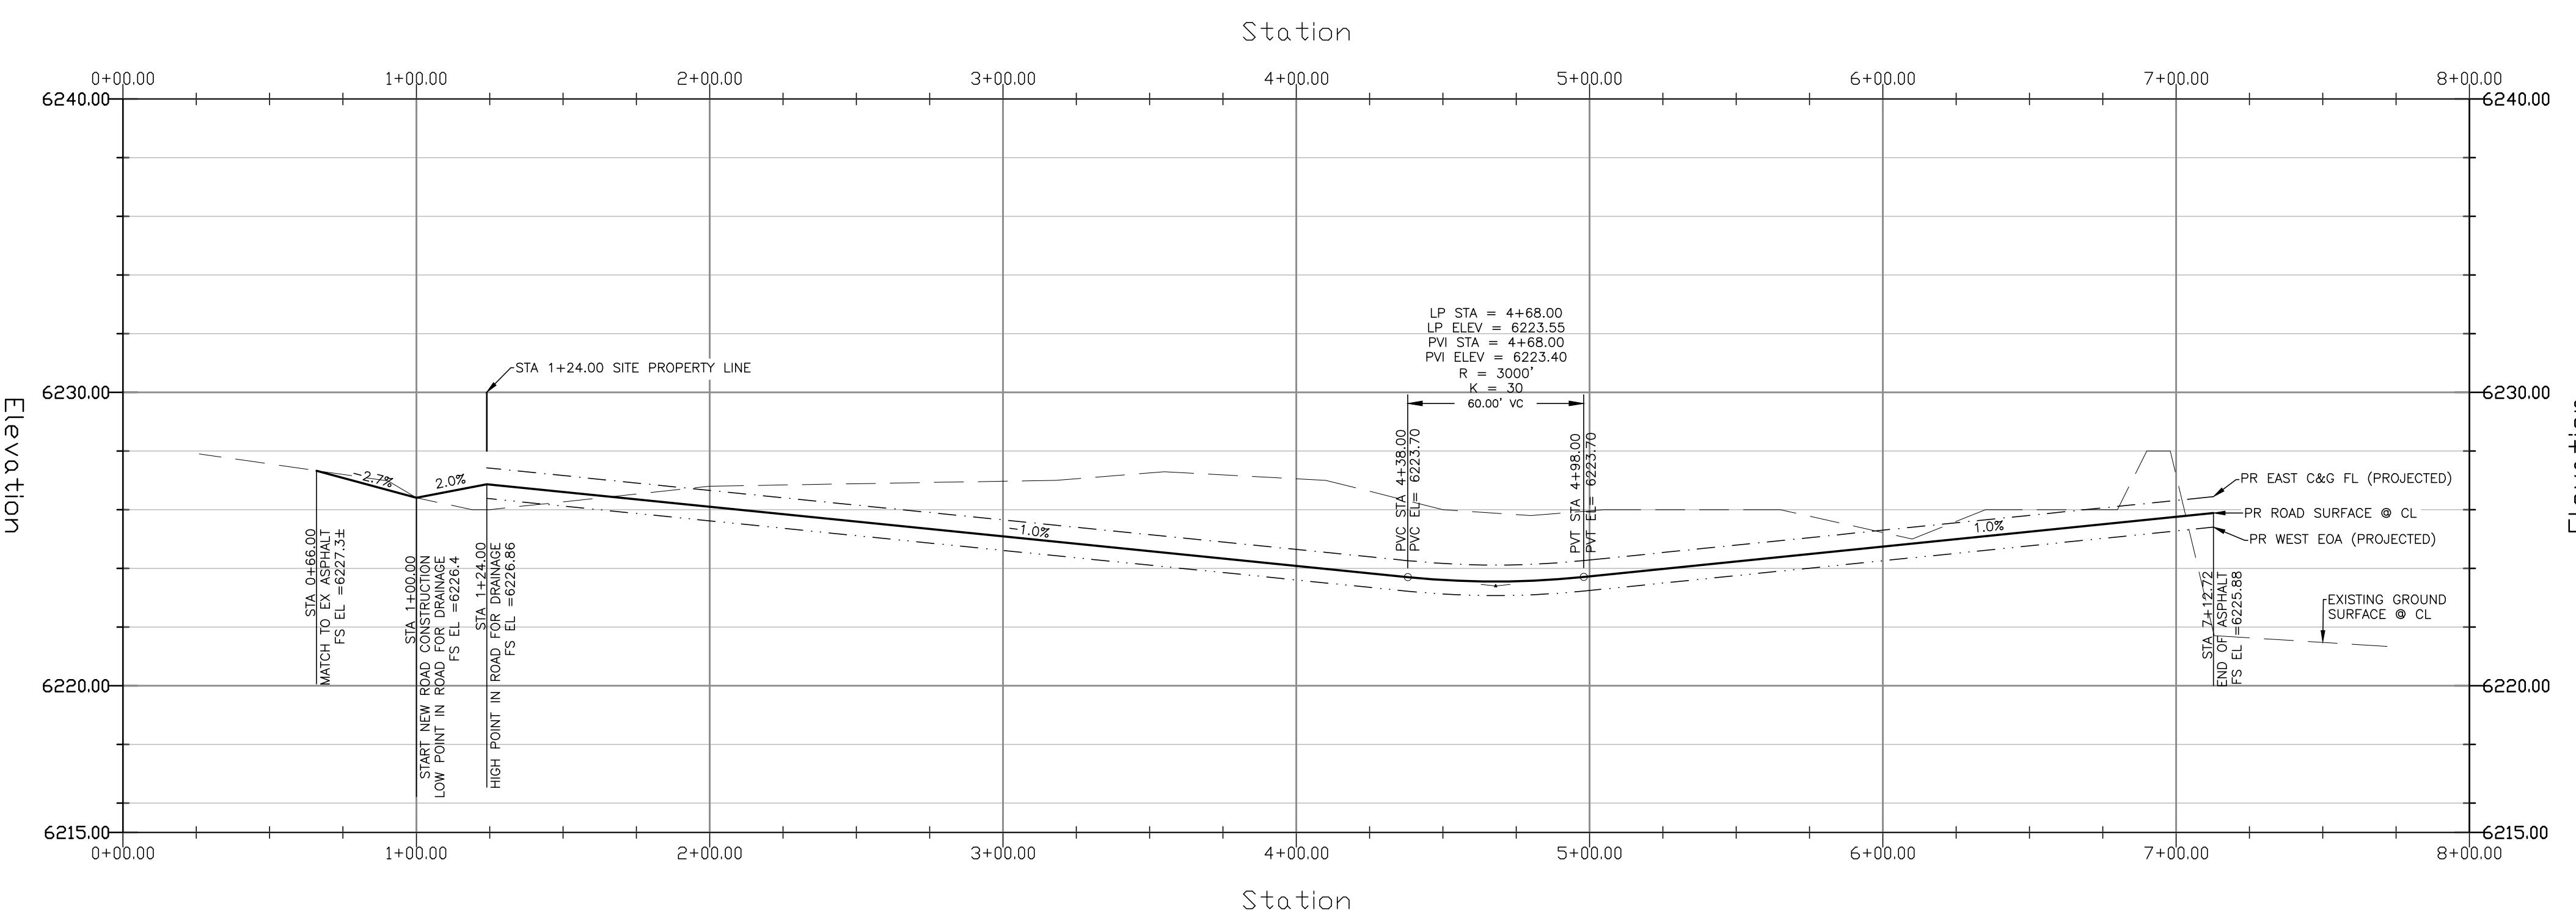

THIS DESIGN WAS PREPARED UNDER MY DIRECT SUPERVISION
FOR AND ON BEHALF OF TERRA NOVA ENGINEERING, INC.

DANE FRANK
COLORADO P.E. # 50207

DESIGNED BY DLF
DRAWN BY DLF
CHECKED BY LD
H-SCALE AS SHOWN
V-SCALE N/A
JOB NO. 2419.00
DATE ISSUED 11/13/24
SHEET NO. 24 OF 27

PLATTE SELF STORAGE



STREET IMPROVEMENT PLAN

DETAILS SHEET

NOVEMBER 2024


LEGEND

PROPOSED	PR	EXISTING CONTOURS - MINOR
EXISTING	EX	EXISTING CONTOURS - MAJOR
FINISHED SURFACE	FS	PROPOSED CONTOURS - 1'
FINISHED GROUND	FG	EXISTING PROPERTY LINE
TOP OF CURB	TC	PROPOSED RET WALL
FLOWLINE	FL	PROPOSED RIPRAP
FINISH GROUND AT TOP OF WALL	TW	WATER LINE
FINISHED GROUND AT BOTTOM OF WALL	BW	SANITARY SEWER LINE
LOW POINT	LP	GAS LINE
HIGH POINT	HP	UNDERGROUND ELECTRICAL LINE
FLOW ARROW		TELEPHONE LINE
EXISTING CONTOURS (LIDAR)	813Q	FIBER OPTIC LINE
		STORM SEWER LINE
		LIMIT OF CONSTRUCTION
		LIMIT OF SOIL DISTURBANCE
		PROPOSED FENCE
		FIRE HYDRANT

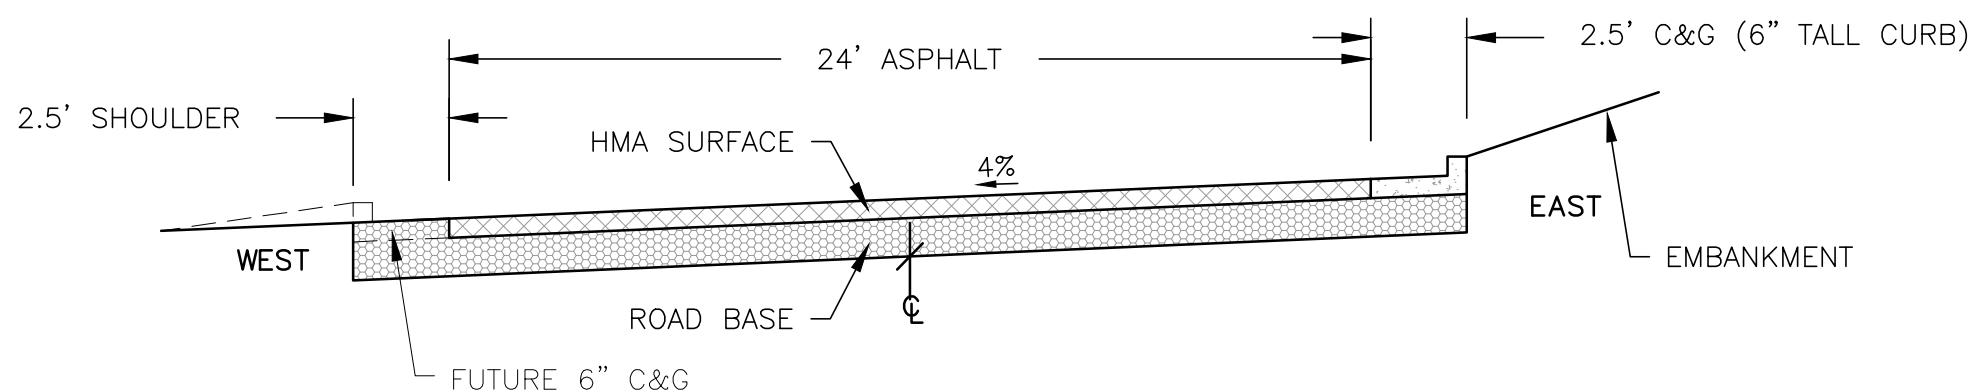
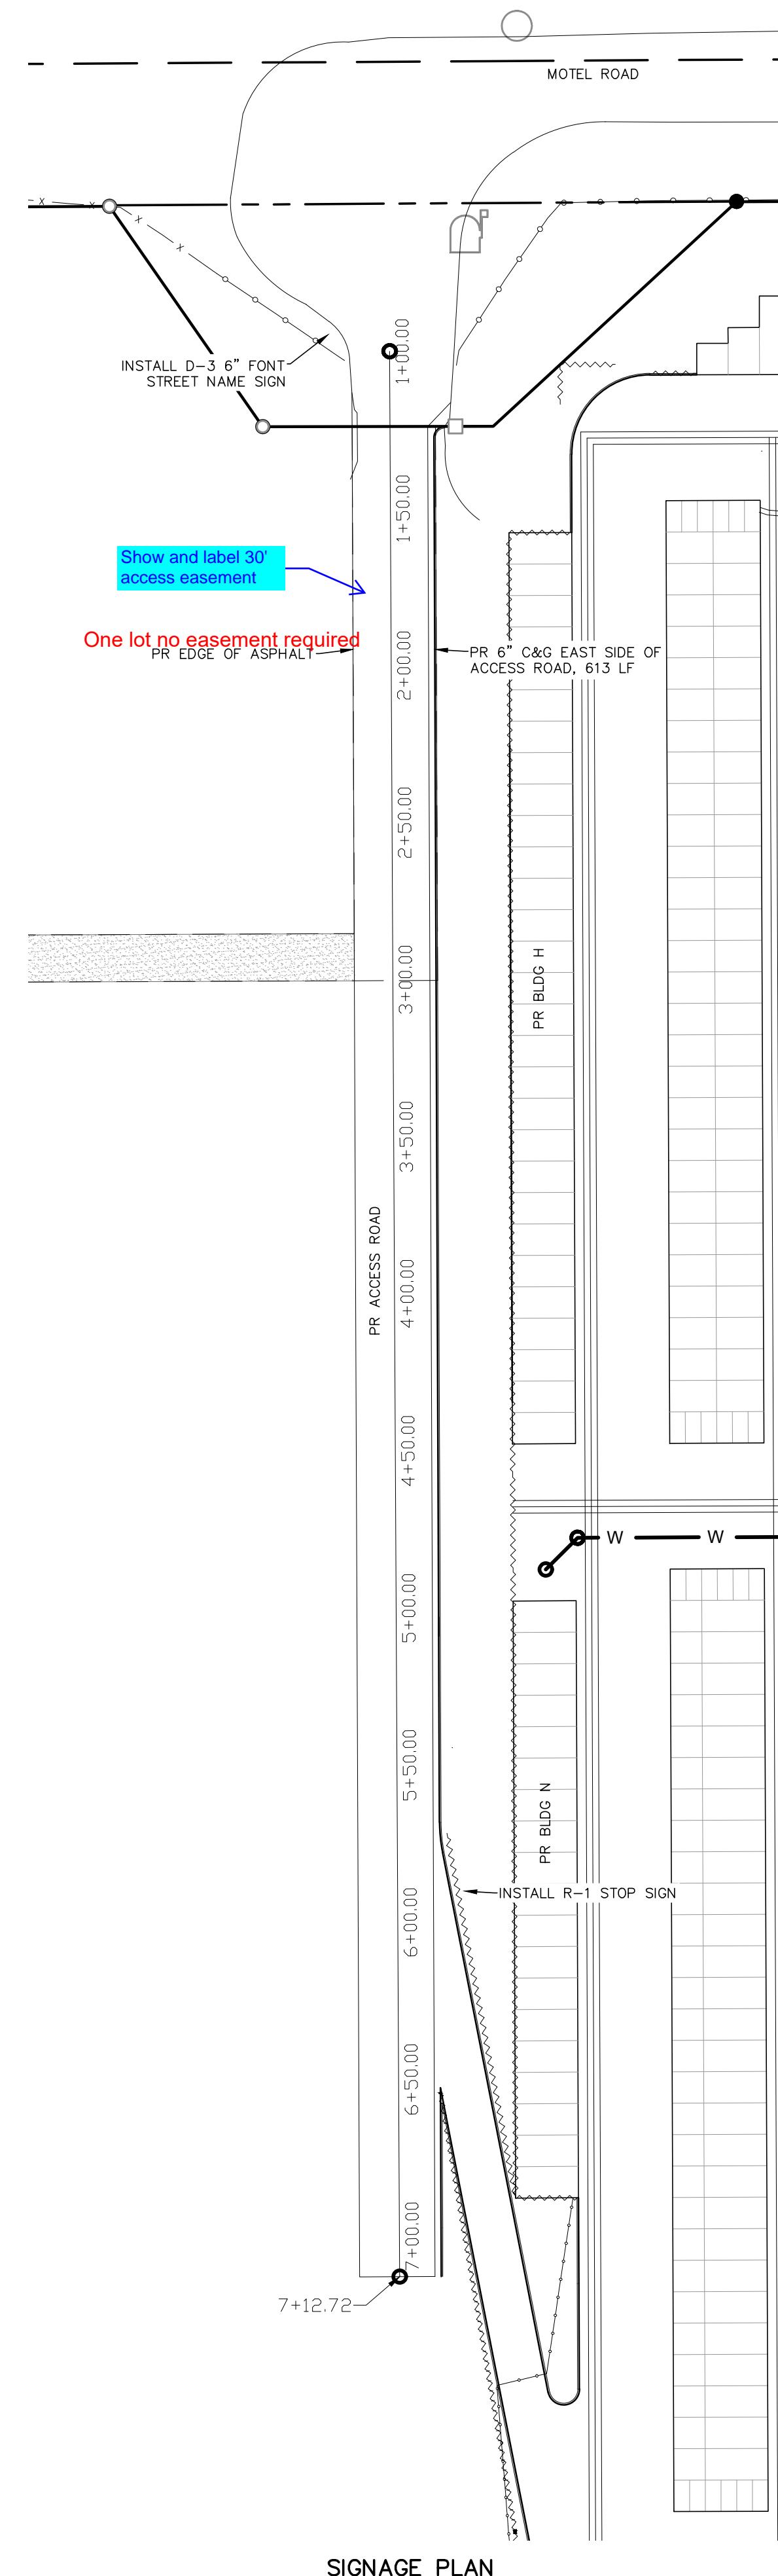


TYPICAL STREET SECTION (CUSTOM) - ACCESS ROAD (PRIVATE)

NOT TO SCALE

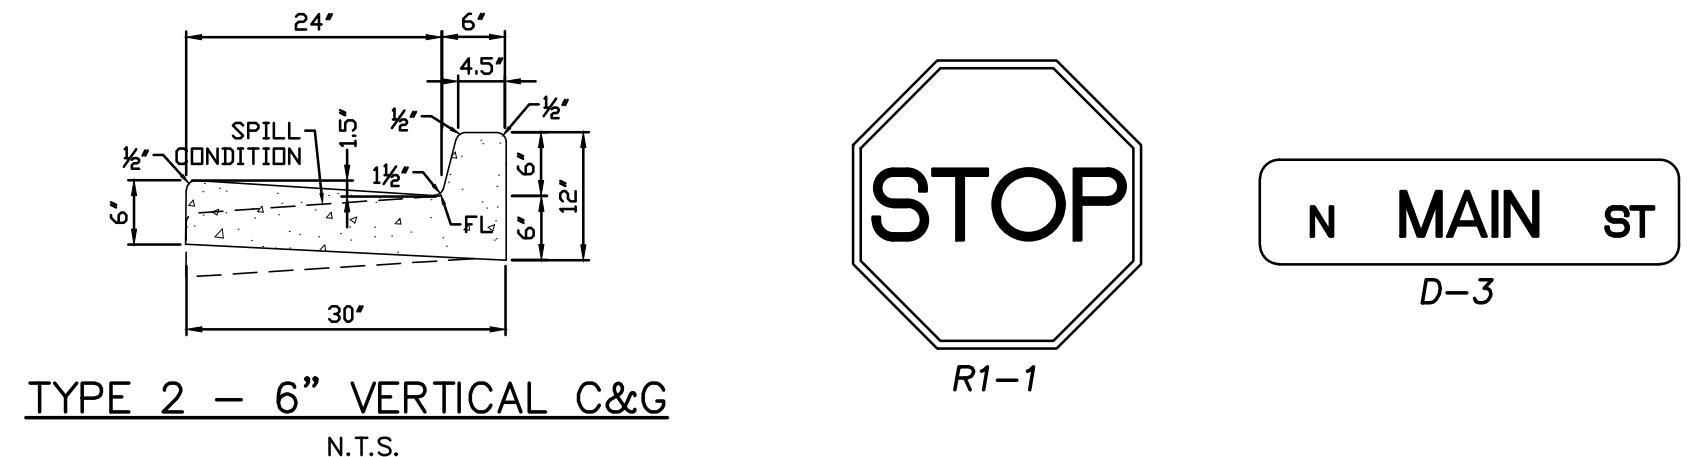

STREET NAME SIGNS
1 - ACCESS ROAD NAME TBD, 6"/4.5" TALL FONT, 12" TALL SIGN

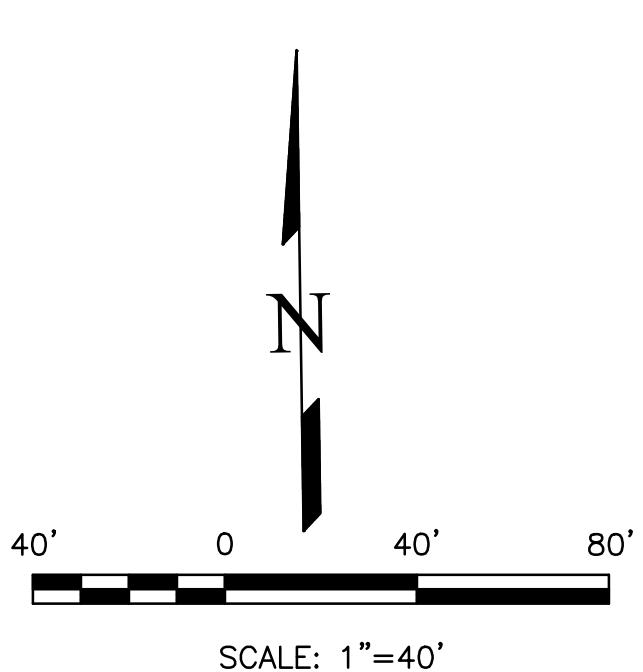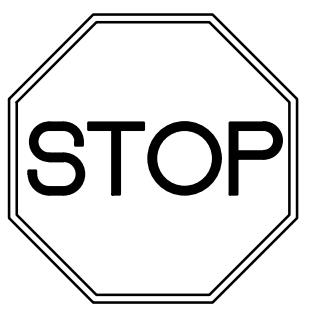


THIS DESIGN WAS PREPARED UNDER MY DIRECT SUPERVISION
FOR AND ON BEHALF OF TERRA NOVA ENGINEERING, INC.

DANE FRANK
COLORADO P.E. # 50207

REVISIONS	DESCRIPTION	DATE
NO.		
UNTIL SUCH TIME AS THESE DRAWINGS ARE APPROVED BY THE APPROPRIATE REVIEWING AGENCIES, TERRA NOVA ENGINEERING, INC. APPROVES THEIR USE ONLY FOR THE PURPOSES DESIGNATED BY WRITTEN AUTHORIZATION.		

PREPARED FOR:	RMG-ROCKY MOUNTAIN GROUP
ATTN:	5085 LIST DR, #200
	COLORADO SPRINGS, CO 80919
	719.548.0600

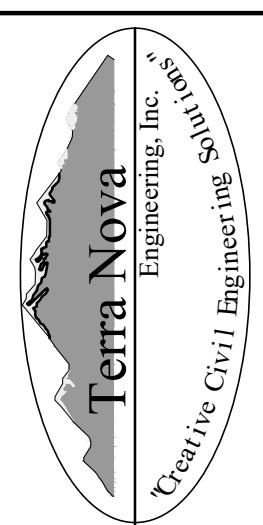


721 S. 23RD STREET
COLORADO SPRINGS, CO 80904
OFFICE: 719-535-6422
FAX: 719-535-6426
www.tnengineering.com

PLATTE SELF STORAGE
STREET IMPROVEMENT PLAN
DETAILS SHEET

DESIGNED BY DLF
DRAWN BY DLF
CHECKED BY LD
H-SCALE AS SHOWN
V-SCALE N/A
JOB NO. 2419.00
DATE ISSUED 11/13/24
SHEET NO. 25 OF 27

**PLATTE SELF STORAGE
STREET IMPROVEMENT PLAN
HWY 24 MID BLOCK ACCESS REMOVAL
NOVEMBER 2024**

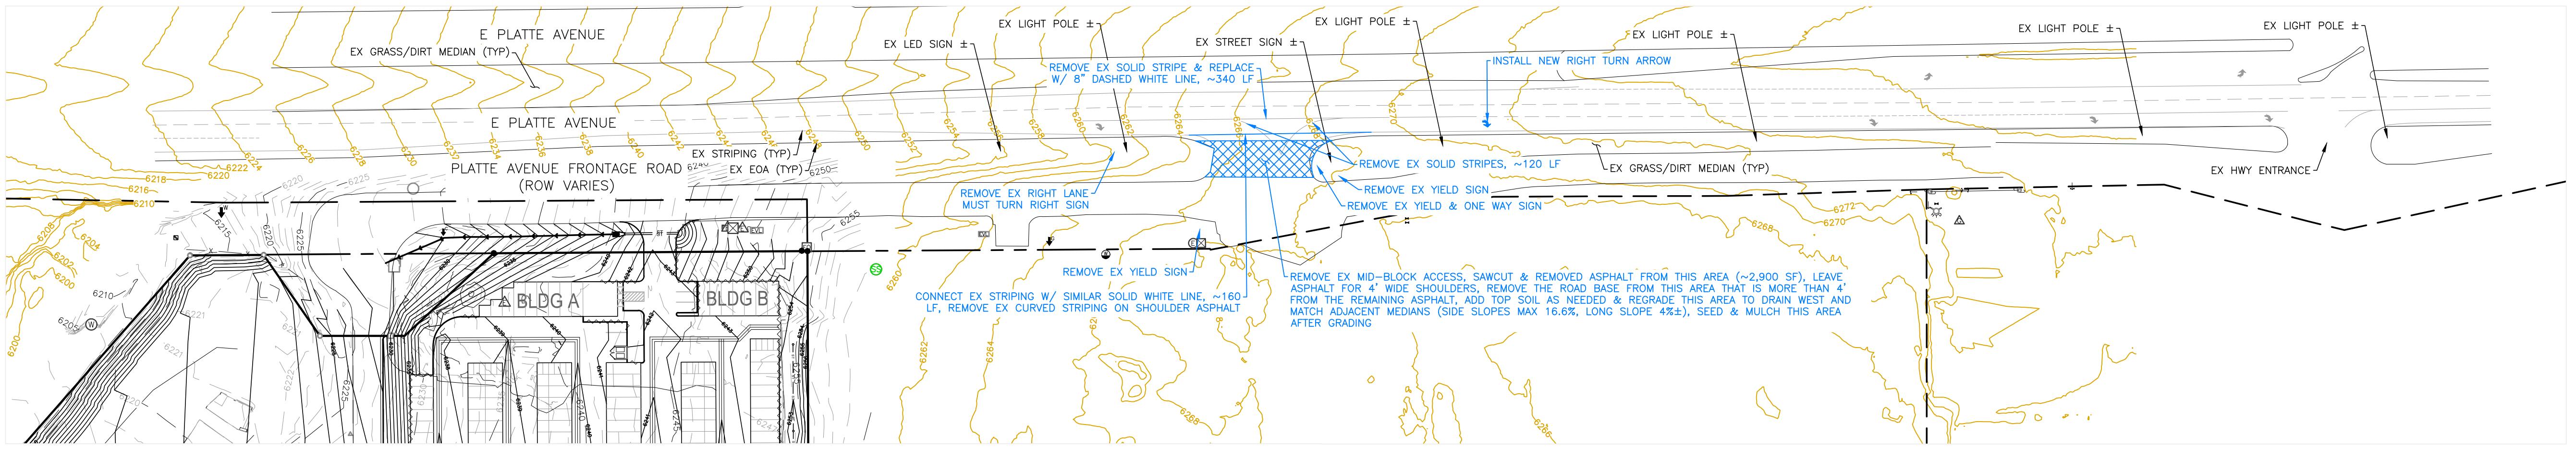

NOTES

1. THE MID-BLOCK ACCESS REMOVAL WORK SHALL BE PER CDOT STANDARDS.
2. INFO SHOWN IN BLUE IS THE PROPOSED WORK.

LEGEND


PROPOSED	PR	EXISTING CONTOURS - MINOR
EXISTING	EX	EXISTING CONTOURS - MAJOR
FINISHED SURFACE	FS	PROPOSED CONTOURS - 1'
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HIGH POINT	HP	UNDERGROUND ELECTRICAL LINE
FLOW ARROW	→	TELEPHONE LINE
EXISTING CONTOURS (LIDAR)	6230	FIBER OPTIC LINE
		STORM SEWER LINE
		LIMIT OF CONSTRUCTION
		LIMIT OF SOIL DISTURBANCE
		PROPOSED FENCE
		FIRE HYDRANT

PLATTE SELF STORAGE

STREET IMPROVEMENT PLAN
HWY 24 MID BLOCK ACCESS REMOVAL


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V-SCALE N/A
JOB NO. 2419.00
DATE ISSUED 11/13/24
SHEET NO. 26 OF 27

THIS DESIGN WAS PREPARED UNDER MY DIRECT SUPERVISION
FOR AND ON BEHALF OF TERRA NOVA ENGINEERING, INC.

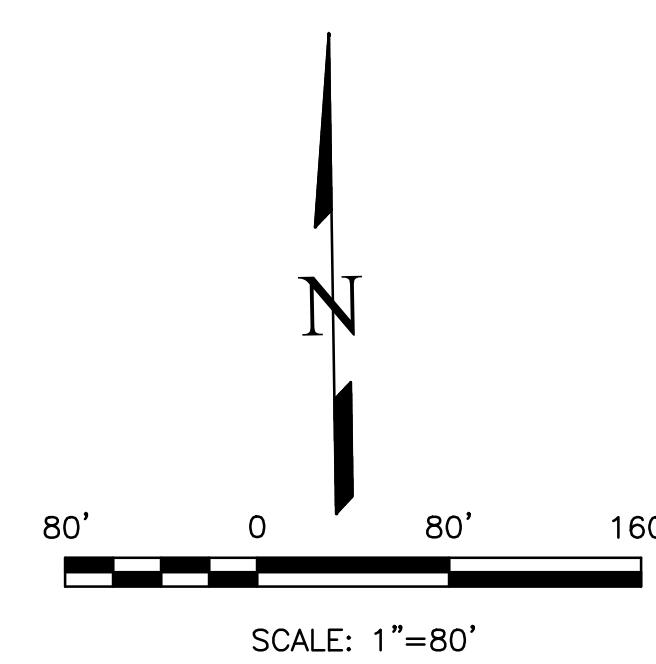


DANE FRANK
COLORADO P.E. # 50207

REVISIONS NO.	DESCRIPTION	DATE
UNTIL SUCH TIME AS THESE DRAWINGS ARE APPROVED BY THE APPROPRIATE REVIEWING AGENCIES, TERRA NOVA ENGINEERING, INC. APPROVES THEIR USE ONLY FOR THE PURPOSES DESIGNATED BY WRITTEN AUTHORIZATION.		
PREPARED FOR: RMG—ROCKY MOUNTAIN GROUP ATTN: #200 5085 LIST DR, #200 COLORADO SPRINGS, CO 80919 719.548.0600		

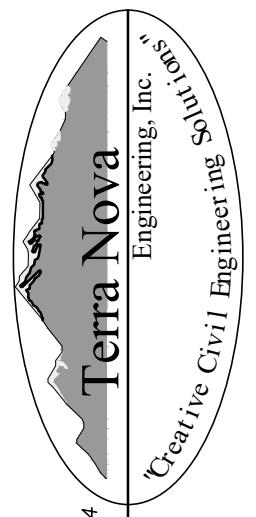

721 S. 28TH STREET
COLORADO SPRINGS, CO 80904
OFFICE: 719-535-6422
FAX: 719-535-6426
www.tresinc.com

PLATTE SELF STORAGE
STREET IMPROVEMENT PLAN
RIGHT OF WAY IMPROVEMENTS SHEET
NOVEMBER 2024

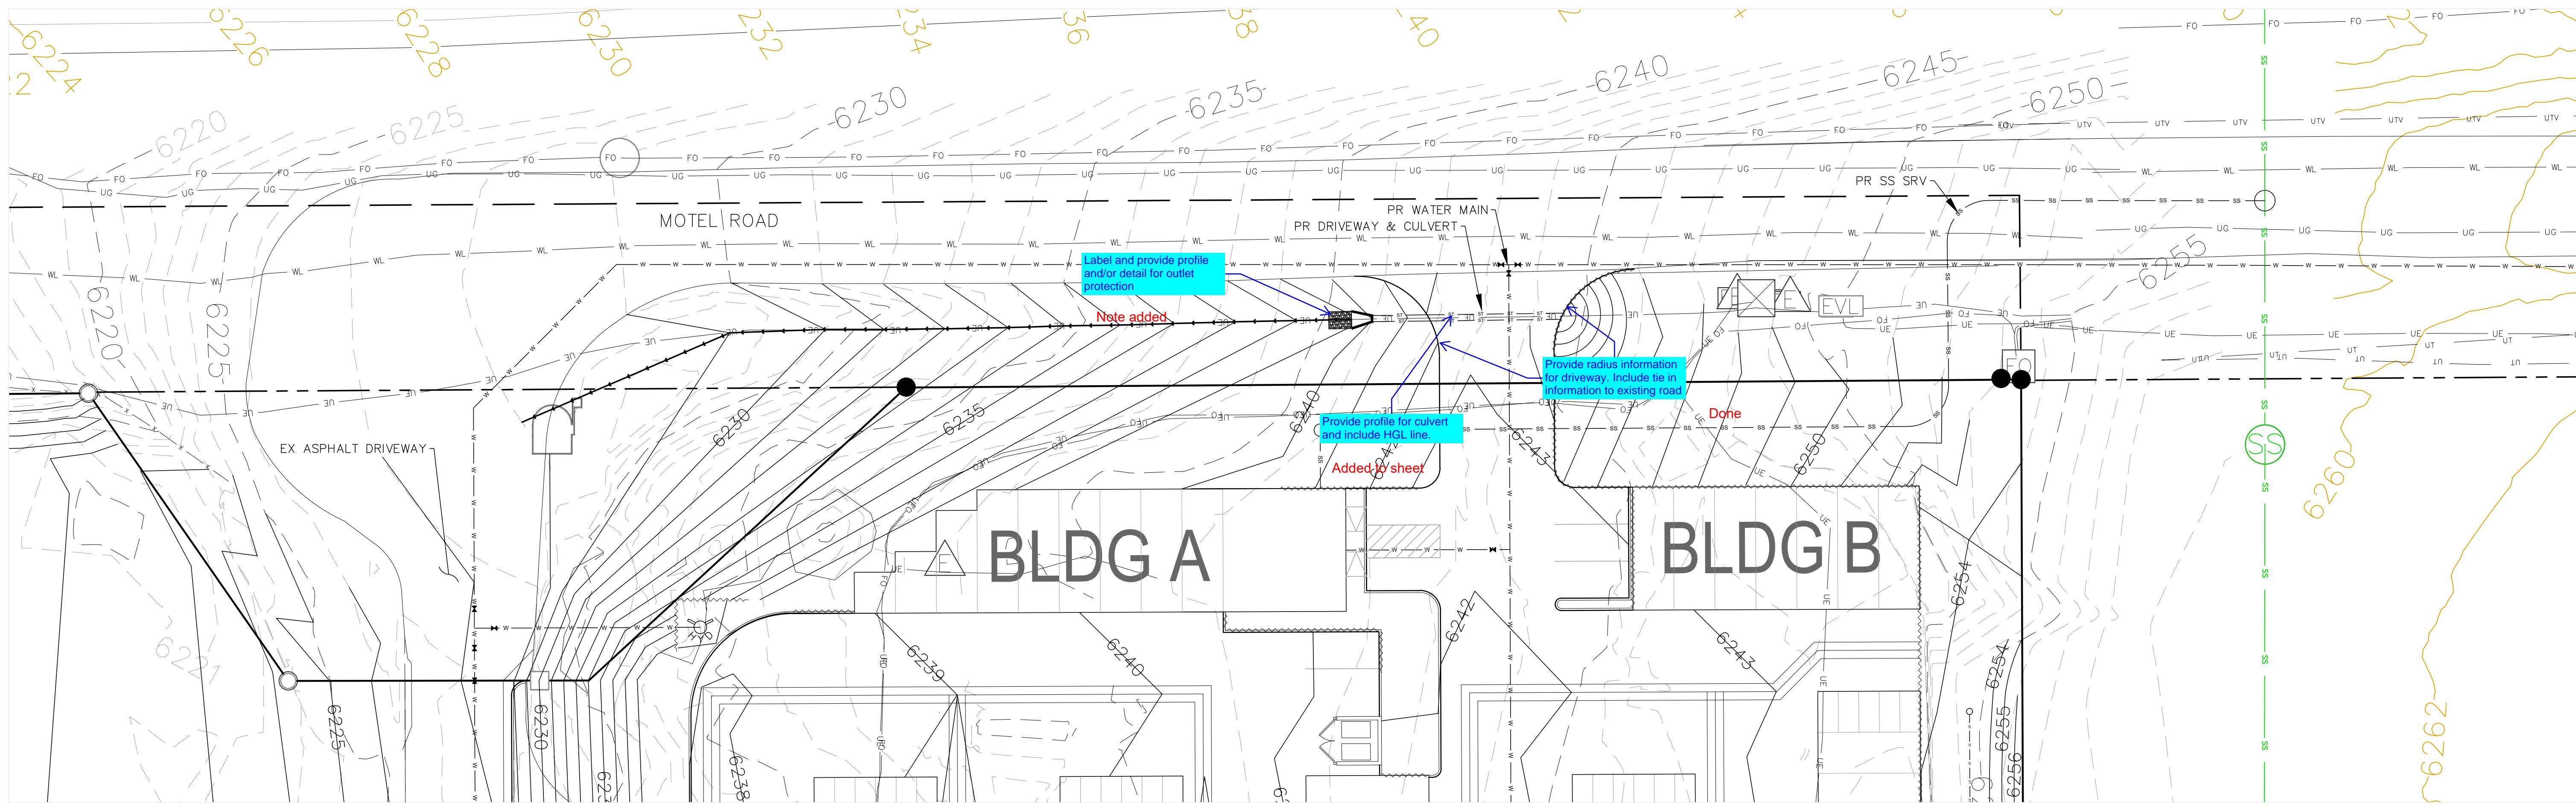

NOTES


1. THE COUNTY REQUIRED THIS SHEET BE ADDED TO THE PLAN SET. NO NEW INFO IS INCLUDED HERE.

LEGEND

PROPOSED	PR	EXISTING CONTOURS - MINOR
EXISTING	EX	EXISTING CONTOURS - MAJOR
FINISHED SURFACE	FS	PROPOSED CONTOURS - 1'
FINISHED GROUND	FG	EXISTING PROPERTY LINE
TOP OF CURB	TC	PROPOSED RIPRAP
FLOWLINE	FL	WATER LINE
FINISH GROUND AT TOP OF WALL	TW	SANITARY SEWER LINE
FINISHED GROUND AT BOTTOM OF WALL	BW	GAS LINE
LOW POINT	LP	UNDERGROUND ELECTRICAL LINE
HIGH POINT	HP	TELEPHONE LINE
FLOW ARROW	→	FIBER OPTIC LINE
EXISTING CONTOURS (LIDAR)	6230	STORM SEWER LINE

PLATTE SELF STORAGE


STREET IMPROVEMENT PLAN
 RIGHT OF WAY IMPROVEMENTS SHEET

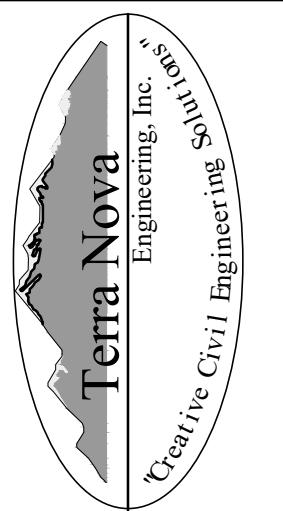

REVISIONS
 NO. _____ DATE _____
 UNTIL SUCH TIME AS THESE DRAWINGS ARE APPROVED BY THE APPROPRIATE REVIEWING AGENCIES, TERRA NOVA ENGINEERING, INC. APPROVES THEIR USE ONLY FOR THE PURPOSES DESIGNATED BY WRITTEN AUTHORIZATION.

PREPARED FOR:
RMG-ROCKY MOUNTAIN GROUP
 ATTN: 5085 LIST DR, #200
 COLORADO SPRINGS, CO 80919
 719.548.0600

DESIGNED BY DLF
 DRAWN BY DLF
 CHECKED BY LD
 H-SCALE AS SHOWN
 V-SCALE N/A
 JOB NO. 2419.00
 DATE ISSUED 11/13/24
 SHEET NO. 27 OF 27

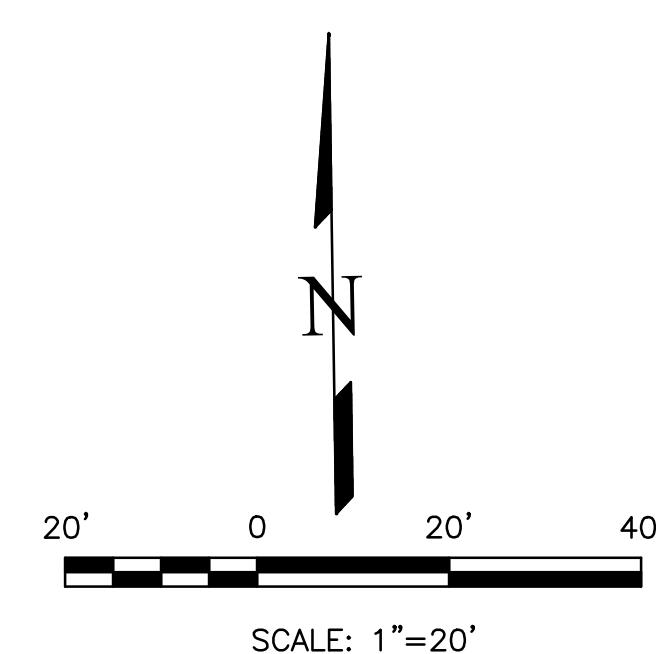


THIS DESIGN WAS PREPARED UNDER MY DIRECT SUPERVISION FOR AND ON BEHALF OF TERRA NOVA ENGINEERING, INC.

DANE FRANK
 COLORADO P.E. # 50207


V3_Grading & Erosion Control Plan.pdf Markup Summary

Callout (9)

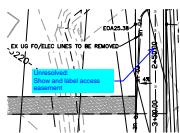


Subject: Callout
Page Label: [1] 241900 SIP-STREET P&P
Author: CDurham
Date: 12/23/2024 12:39:33 PM
Status:
Color:
Layer:
Space:

Unresolved:
Show and label access easement

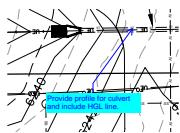


Subject: Callout
Page Label: [1] 241900 SIP-ROW SHEET
Author: CDurham
Date: 12/23/2024 12:47:33 PM
Status:
Color:
Layer:
Space:

Provide profile for culvert and include HGL line.

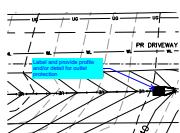


Subject: Callout
Page Label: [1] 241900 SIP-ROW SHEET
Author: CDurham
Date: 12/23/2024 12:44:56 PM
Status:
Color:
Layer:
Space:

Label and provide profile and/or detail for outlet protection

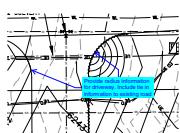

Subject: Callout
Page Label: [1] 241900 SIP-ROW SHEET
Author: CDurham
Date: 12/23/2024 12:48:56 PM
Status:
Color:
Layer:
Space:

Provide radius information for driveway. Include tie in information to existing road

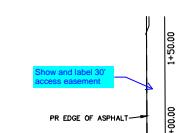


Subject: Callout
Page Label: [1] 241900 SIP-DETAILS #1
Author: CDurham
Date: 12/23/2024 12:50:00 PM
Status:
Color:
Layer:
Space:

Show and label 30' access easement



Subject: Callout
Page Label: [1] 241900 SIP-STREET P&P
Author: CDurham
Date: 12/23/2024 3:22:11 PM
Status:
Color:
Layer:
Space:

Show and label c&g for type R inlet to tie into

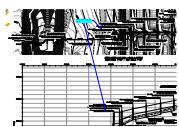

Subject: Callout
Page Label: [1] 241900 GEC-STORM #2
Author: CDurham
Date: 12/23/2024 3:23:30 PM
Status:
Color:
Layer:
Space:

Type R inlets per drainage report



Subject: Callout
Page Label: [1] 241900 GEC-STORM #1
Author: CDurham
Date: 12/23/2024 3:26:18 PM
Status:
Color:
Layer:
Space:

Label PVI's and slopes



Subject: Callout
Page Label: [1] 241900 GEC-STORM #3
Author: CDurham
Date: 12/23/2024 3:28:53 PM
Status:
Color:
Layer:
Space:

Type R inlet per drainage report. Show and label c&g for inlet to tie into

SW - Textbox with Arrow (1)




Subject: SW - Textbox with Arrow
Page Label: [1] 241900 GEC-GEC-INIT-N
Author: Mikayla Hartford
Date: 12/23/2024 9:02:14 AM
Status:
Color:
Layer:
Space:

Unresolved from Submittal 2: Please include full limits of construction within the view, it appears to extend further to the east.

Utility work should be shown on the GEC Plans and BMPs should be implemented for those areas as well. The full limits of construction need BMPs and to be shown.

Text Box (1)

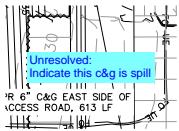

Subject: Text Box
Page Label: [1] 241900 SIP-STREET P&P
Author: CDurham
Date: 12/23/2024 12:40:59 PM
Status:
Color:
Layer:
Space:

Unresolved:
Indicate this c&g is spill