

NOTE: ALL EXISTING UNDERGROUND AND ABOVE GROUND UTILITY LOCATIONS, INVERTS AND SIZES ARE APPROXIMATE ONLY AND MUST BE FIELD VERIFIED PRIOR TO CONSTRUCTION. TIE IN POINTS SHALL BE POTHOLED AND LOCATIONS, INVERTS AND SIZES SHALL BE FIELD VERIFIED BY THE CONTRACTOR PRIOR TO CONSTRUCTION.

STANDARD NOTES FOR EL PASO COUNTY GRADING AND EROSION CONTROL PLANS

1. STORMWATER DISCHARGES FROM CONSTRUCTION SITES SHALL NOT CAUSE OR THREATEN TO CAUSE POLLUTION, CONTAMINATION, OR DEGRADATION OF STATE WATERS. ALL WORK AND EARTH DISTURBANCE SHALL BE DONE IN A MANNER THAT MINIMIZES POLLUTION OF ANY ON-SITE OR OFF SITE WATERS, INCLUDING WETLANDS.

2. NOTWITHSTANDING ANYTHING DEPICTED IN THESE PLANS IN WORDS OR GRAPHIC REPRESENTATION, ALL DESIGN AND CONSTRUCTION RELATED TO ROADS, STORM DRAINAGE AND EROSION CONTROL SHALL CONFORM TO THE STANDARDS AND REQUIREMENTS OF THE MOST RECENT VERSION OF THE RELEVANT ADOPTED EL PASO COUNTY STANDARDS, INCLUDING THE LAND DEVELOPMENT CODE, THE ENGINEERING CRITERIA MANUAL, THE DRAINAGE CRITERIA MANUAL, AND THE DRAINAGE CRITERIA MANUAL VOLUME 2. ANY DEVIATIONS TO REGULATIONS AND STANDARDS MUST BE REQUESTED, AND APPROVED, IN WRITING.

3. A SEPARATE STORMWATER MANAGEMENT PLAN (SMWP) FOR THIS PROJECT SHALL BE COMPLETED AND AN EROSION AND STORMWATER QUALITY CONTROL PERMIT (ESQCP) ISSUED PRIOR TO COMMENCING CONSTRUCTION. MANAGEMENT OF THE SMWP DURING CONSTRUCTION IS THE RESPONSIBILITY OF THE DESIGNATED QUALIFIED STORMWATER MANAGER OR CERTIFIED EROSION CONTROL INSPECTOR. THE SMWP SHALL BE LOCATED ON SITE AT ALL TIMES DURING CONSTRUCTION AND SHALL BE KEPT UP TO DATE WITH WORK PROGRESS AND CHANGES IN THE FIELD.

4. ONCE THE ESQCP IS APPROVED AND A "NOTICE TO PROCEED" HAS BEEN ISSUED, THE CONTRACTOR MAY INSTALL THE INITIAL STAGE EROSION AND SEDIMENT CONTROL MEASURES, AS INDICATED IN THE APPROVED GEC. A PRECONSTRUCTION MEETING BETWEEN THE CONTRACTOR, ENGINEER, AND EL PASO COUNTY WILL BE HELD PRIOR TO ANY CONSTRUCTION. IT IS THE RESPONSIBILITY OF THE APPLICANT TO COORDINATE THE MEETING TIME AND PLACE WITH COUNTY STAFF.

5. CONTROL MEASURES MUST BE INSTALLED PRIOR TO COMMENCEMENT OF ACTIVITIES THAT COULD CONTRIBUTE POLLUTANTS TO STORMWATER. CONTROL MEASURES FOR ALL SLOPES, CHANNELS, DITCHES, AND DISTURBED LAND AREAS SHALL BE INSTALLED IMMEDIATELY UPON COMPLETION OF THE DISTURBANCE.

6. ALL TEMPORARY SEDIMENT AND EROSION CONTROL MEASURES SHALL BE MAINTAINED AND REMAIN IN EFFECTIVE OPERATING CONDITION UNTIL PERMANENT SOIL EROSION CONTROL MEASURES ARE IMPLEMENTED AND FINAL STABILIZATION IS ESTABLISHED. ALL PERSONS ENGAGED IN LAND DISTURBANCE ACTIVITIES SHALL ASSESS THE ADEQUACY OF CONTROL MEASURES AT THE SITE AND IDENTIFY IF CHANGES TO THOSE CONTROL MEASURES ARE NEEDED TO ENSURE THE CONTINUED EFFECTIVE PERFORMANCE OF THE CONTROL MEASURES. ALL CHANGES TO TEMPORARY SEDIMENT AND EROSION CONTROL MEASURES MUST BE INCORPORATED INTO THE STORMWATER MANAGEMENT PLAN.

7. TEMPORARY STABILIZATION SHALL BE IMPLEMENTED ON DISTURBED AREAS AND STOCKPILES WHERE GROUND DISTURBING CONSTRUCTION ACTIVITY HAS PERMANENTLY CEASED OR TEMPORARILY CEASED FOR LONGER THAN 14 DAYS.

8. FINAL STABILIZATION MUST BE IMPLEMENTED AT ALL APPLICABLE CONSTRUCTION SITES. FINAL STABILIZATION IS ACHIEVED WHEN ALL GROUND DISTURBING ACTIVITIES ARE COMPLETE AND ALL DISTURBED AREAS EITHER HAVE A UNIFORM VEGETATIVE COVER WITH INDIVIDUAL PLANT DENSITY OF 70 PERCENT OF PRE-DISTURBANCE LEVELS ESTABLISHED OR EQUIVALENT PERMANENT ALTERNATIVE STABILIZATION METHOD IS IMPLEMENTED. ALL TEMPORARY SEDIMENT AND EROSION CONTROL MEASURES SHALL BE REMOVED UPON FINAL STABILIZATION AND BEFORE PERMIT CLOSURE.

9. ALL PERMANENT STORMWATER MANAGEMENT FACILITIES SHALL BE INSTALLED AS DESIGNED IN THE APPROVED PLANS. ANY PROPOSED CHANGES THAT AFFECT THE DESIGN OR FUNCTION OF PERMANENT STORMWATER MANAGEMENT STRUCTURES MUST BE APPROVED BY THE ECM ADMINISTRATOR PRIOR TO IMPLEMENTATION.

10. EARTH DISTURBANCES SHALL BE CONDUCTED IN SUCH A MANNER SO AS TO EFFECTIVELY MINIMIZE ACCELERATED EROSION AND RESULTING SEDIMENTATION. ALL DISTURBANCES SHALL BE DESIGNED, CONSTRUCTED, AND COMPLETED SO THAT THE EXPOSED AREA OF ANY DISTURBED LAND SHALL BE LIMITED TO THE SHORTEST PRACTICAL PERIOD OF TIME. PRE-EXISTING VEGETATION SHALL BE PROTECTED AND MAINTAINED WITHIN 50 HORIZONTAL FEET OF A WATERS OF THE STATE UNLESS SHOWN TO BE INEFFECTIVE AND SPECIFICALLY REQUESTED AND APPROVED.

11. COMPACTION OF SOIL MUST BE PREVENTED IN AREAS DESIGNATED FOR INFILTRATION CONTROL MEASURES OR WHERE FINAL STABILIZATION WILL BE ACHIEVED BY VEGETATIVE COVER. AREAS DESIGNATED FOR INFILTRATION CONTROL MEASURES SHALL ALSO BE PROTECTED FROM SEDIMENTATION DURING CONSTRUCTION UNTIL FINAL STABILIZATION IS ACHIEVED. IF COMPACTION PREVENTION IS NOT FEASIBLE DUE TO SITE CONSTRAINTS, ALL AREAS DESIGNATED FOR INFILTRATION AND VEGETATION CONTROL MEASURES MUST BE LOOSEND PRIOR TO INSTALLATION OF THE CONTROL MEASURE(S).

12. ANY TEMPORARY OR PERMANENT FACILITY DESIGNED AND CONSTRUCTED FOR THE CONVEYANCE OF STORMWATER AROUND, THROUGH, OR FROM THE EARTH DISTURBANCE AREA SHALL BE A STABILIZED CONVEYANCE DESIGNED TO MINIMIZE EROSION AND THE DISCHARGE OF SEDIMENT OFF SITE.

13. CONCRETE WASH WATER SHALL BE CONTAINED AND DISPOSED OF IN ACCORDANCE WITH THE SMWP. NO WASH WATER SHALL BE DISCHARGED TO OR ALLOWED TO ENTER STATE WATERS, INCLUDING ANY SURFACE OR SUBSURFACE STORM DRAINAGE SYSTEM OR FACILITIES. CONCRETE WASHOUTS SHALL NOT BE LOCATED IN AN AREA WHERE SHALLOW GROUNDWATER MAY BE PRESENT, OR WITHIN 50 FEET OF A SURFACE WATER BODY, CREEK OR STREAM.

14. DURING DEWATERING OPERATIONS OF UNCONTAMINATED GROUND WATER MAY BE DISCHARGED ON SITE, BUT SHALL NOT LEAVE THE SITE IN THE FORM OF SURFACE RUNOFF UNLESS AN APPROVED STATE DEWATERING PERMIT IS IN PLACE.

15. EROSION CONTROL BLANKETING OR OTHER PROTECTIVE COVERING SHALL BE USED ON SLOPES STEEPER THAN 3:1.

16. CONTRACTOR SHALL BE RESPONSIBLE FOR THE REMOVAL OF ALL WASTES FROM THE CONSTRUCTION SITE FOR DISPOSAL IN ACCORDANCE WITH LOCAL AND STATE REGULATORY REQUIREMENTS. NO CONSTRUCTION DEBRIS, TREE SLASH, BUILDING MATERIAL WASTES OR UNUSED BUILDING MATERIALS SHALL BE BURIED, DUMPED, OR DISCHARGED AT THE SITE.

17. WASTE MATERIALS SHALL NOT BE TEMPORARILY PLACED OR STORED IN THE STREET, ALLEY, OR OTHER PUBLIC WAY, UNLESS IN ACCORDANCE WITH AN APPROVED TRAFFIC CONTROL PLAN. CONTROL MEASURES MAY BE REQUIRED BY EL PASO COUNTY ENGINEERING IF DEEMED NECESSARY, BASED ON SPECIFIC CONDITIONS AND CIRCUMSTANCES.

18. TRACKING OF SOILS AND CONSTRUCTION DEBRIS OFF-SITE SHALL BE MINIMIZED. MATERIALS TRACKED OFF-SITE SHALL BE CLEANED UP AND PROPERLY DISPOSED OF IMMEDIATELY.

19. THE OWNER/DEVELOPER SHALL BE RESPONSIBLE FOR THE REMOVAL OF ALL CONSTRUCTION DEBRIS, DIRT, TRASH, ROCK, SEDIMENT, SOIL, AND SAND THAT MAY ACCUMULATE IN ROADS, STORM DRAINS AND OTHER DRAINAGE CONVEYANCE SYSTEMS AND STORMWATER APPURTENANCES AS A RESULT OF SITE DEVELOPMENT.

20. THE QUANTITY OF MATERIALS STORED ON THE PROJECT SITE SHALL BE LIMITED, AS MUCH AS PRACTICAL, TO THAT QUANTITY REQUIRED TO PERFORM THE WORK IN AN ORDERLY SEQUENCE. ALL MATERIALS STORED ON-SITE SHALL BE STORED IN A NEAT, ORDERLY MANNER, IN THEIR ORIGINAL CONTAINERS, WITH ORIGINAL MANUFACTURER'S LABELS.

21. NO CHEMICAL(S) HAVING THE POTENTIAL TO BE RELEASED IN STORMWATER ARE TO BE STORED OR USED ON SITE UNLESS PERMISSION FOR THE USE OF SUCH CHEMICAL(S) IS GRANTED IN WRITING BY THE ECM ADMINISTRATOR. IN GRANTING APPROVAL FOR THE USE OF SUCH CHEMICAL(S), SPECIAL CONDITIONS AND MONITORING MAY BE REQUIRED.

22. BULK STORAGE OF ALLOWED PETROLEUM PRODUCTS OR OTHER ALLOWED LIQUID CHEMICALS IN EXCESS OF 55 GALLONS SHALL REQUIRE ADEQUATE SECONDARY CONTAINMENT PROTECTION TO CONTAIN ALL SPILLS ON SITE AND TO PREVENT ANY SPILLED MATERIALS FROM ENTERING STATE WATERS, ANY SURFACE OR SUBSURFACE STORM DRAINAGE SYSTEM OR OTHER FACILITIES.

23. NO PERSON SHALL CAUSE THE IMPEDIMENT OF STORMWATER FLOW IN THE CURB AND GUTTER OR DITCH EXCEPT WITH APPROVED SEDIMENT CONTROL MEASURES.

24. OWNER/DEVELOPER AND THEIR AGENTS SHALL COMPLY WITH THE "COLORADO WATER QUALITY CONTROL ACT" (TITLE 25, ARTICLE 8, CRS), AND THE "CLEAN WATER ACT" (33 USC 1334), IN ADDITION TO THE REQUIREMENTS OF THE LAND DEVELOPMENT CODE, DCM VOLUME II AND THE ECM APPENDIX I. ALL APPROPRIATE PERMITS MUST BE OBTAINED BY THE CONTRACTOR PRIOR TO CONSTRUCTION (1041, NPDES, FLOODPLAIN, 404, FUGITIVE DUST, ETC.). IN THE EVENT OF CONFLICTS BETWEEN THESE REQUIREMENTS AND OTHER LAWS, RULES, OR REGULATIONS OF OTHER FEDERAL, STATE, LOCAL, OR COUNTY AGENCIES, THE MOST RESTRICTIVE LAWS, RULES, OR REGULATIONS SHALL APPLY.

25. ALL CONSTRUCTION TRAFFIC MUST ENTER/EXIT THE SITE ONLY AT APPROVED CONSTRUCTION ACCESS POINTS.

26. PRIOR TO CONSTRUCTION THE PERMITTEE SHALL VERIFY THE LOCATION OF EXISTING UTILITIES.

27. A WATER SOURCE SHALL BE AVAILABLE ON SITE DURING EARTHWORK OPERATIONS AND SHALL BE UTILIZED AS REQUIRED TO MINIMIZE DUST FROM EARTHWORK EQUIPMENT AND WIND.

28. THE SOILS REPORT FOR THIS SITE HAS BEEN PREPARED BY RMG ENGINEERS/ARCHITECTS DATED MAY 9, 2024 AND SHALL BE CONSIDERED A PART OF THESE PLANS.

29. AT LEAST TEN (10) DAYS PRIOR TO THE ANTICIPATED START OF CONSTRUCTION, FOR PROJECTS THAT WILL DISTURB ONE (1) ACRE OR MORE, THE OWNER OR OPERATOR OF CONSTRUCTION ACTIVITY SHALL SUBMIT A PERMIT APPLICATION FOR STORMWATER DISCHARGE TO THE COLORADO DEPARTMENT OF PUBLIC HEALTH AND ENVIRONMENT, WATER QUALITY DIVISION. THE APPLICATION CONTAINS CERTIFICATION OF COMPLETION OF A STORMWATER MANAGEMENT PLAN (SMWP), OF WHICH THIS GRADING AND EROSION CONTROL PLAN MAY BE A PART. FOR INFORMATION OR APPLICATION MATERIALS CONTACT:

COLORADO DEPARTMENT OF PUBLIC HEALTH AND ENVIRONMENT
WATER QUALITY CONTROL DIVISION
WQCD -PERMITS
4300 CHERRY CREEK DRIVE SOUTH
DENVER, CO 80246-1530
ATTN: PERMITS UNIT

PLATTE SELF STORAGE GRADING AND EROSION CONTROL PLAN COVER SHEET JANUARY 2025

GENERAL NOTES

- IT SHALL BE THE RESPONSIBILITY OF THE CONTRACTOR TO VERIFY THE EXISTENCE AND LOCATION OF ALL UNDERGROUND UTILITIES ALONG THE SITE. THE OMISSION FROM OR THE INCLUSION OF UTILITY LOCATIONS ON THE PLANS IS NOT TO BE CONSIDERED AS THE NON-EXISTENCE OF OR A DEFINITE LOCATION OF EXISTING UNDERGROUND UTILITIES.
- THE CONTRACTOR WILL TAKE THE NECESSARY PRECAUTIONS TO PROTECT EXISTING UTILITIES, BUILDINGS, FENCES, AND ROADWAYS FROM DAMAGE DUE TO THIS OPERATION. ANY DAMAGE TO THE ABOVE WILL BE REPAIRED AT THE CONTRACTOR'S EXPENSE, AND ANY SERVICE DISRUPTION WILL BE SETTLED BY THE CONTRACTOR.
- BULK GRADING SHALL BE COMPLETED TO A SUBGRADE TOLERANCE OF PLUS OR MINUS 0.2".
- CONTRACTOR TO OBTAIN COPIES OF THE SOILS REPORT FROM THE GEOTECHNICAL ENGINEER AND TO BE KEPT ON SITE DURING ALL EARTHWORK OPERATIONS.
- MAXIMUM CUT/FILL SLOPES SHALL NOT EXCEED 3:1, UNLESS OTHERWISE NOTED.
- ALL BOTTOM OF WALL (BW) CALLOUTS ARE FOR THE BOTTOM OF WALL AT GRADE. THEY DO NOT REPRESENT THE BOTTOM OF THE CONSTRUCTED WALL OR FOOTING, WHICH IS NOT SPECIFIED ON THESE PLANS.
- BROWN GROUND SURFACE CONTOURS ARE LIDAR DATA DOWNLOADED FROM THE COLORADO HAZARD MAPPING & RISK MAP PORTAL, DATA SET: 2018 3DEP EAST CO EL PASO. THIS DATA IS APPROXIMATE. LIDAR DATA IS FROM 2018 AND AT 2' INTERVALS.

SOIL TYPES

ON-SITE SOILS ARE HYDROLOGIC GROUP "A", BLAKELAND LOAMY SAND (8), 1 TO 9 PERCENT SLOPES (PER NRCS WEB SOIL SURVEY MAP)

BENCHMARKS

CDOT RIGHT OF WAY MONUMENT #3014 - ELEV=6232.52 (NAVD-1988)
[NORTHEAST OF SITE ENTRANCE]

EARTHWORK VOLUMES

ESTIMATED CUT = 32,200 CY, ESTIMATED FILL = 101,550 CY, NET = 69,350 CY <CUT>

EROSION CONTROL COST OPINION:

1. 2,759 LF-SILT FENCE @ \$3.00/LF	\$ 8,277
2. 2 EA-VEHICLE TRACKING CONTROL @ \$3,085/EA	\$ 6,170
3. 1 EA-CONCRETE WASHOUT @ \$1,172/EA	\$ 1,172
4. 18 EA-INLET PROTECTION @ \$217/EA	\$ 3,906
5. 8.70 AC-PERF SEED AND MULCH @ \$2,018/AC	\$ 17,557
6. 1 EA-TEMP SEDIMENT BASIN @ \$2,294/EA	\$ 2,294
7. 17.7 AC-SURFACE ROUGHENING @ \$269/AC	\$ 4,761
8. 70 LF-STRAW WATTLE @ \$8.00/LF	\$ 560
7. 35% MAINTENANCE AND REPLACEMENT	\$ 15,644
TOTAL	\$ 60,341



SHEET INDEX

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GEO EC DETAILS	17		

SITE ADDRESS

6001 E PLATTE AVE, COLORADO SPRINGS

TAX ID

5418000075

LEGAL DESCRIPTION

TRACT IN NW4 OF SEC 18-14-65 AS FOLDS, BEG AT A PT ON S/R/W LN OF US HWY 24 940 FT E OF W LN OF SD SEC, TH E ON SD LN 310 FT, ANG R 90< S 25 FT, ANG L 90< E 155.4 FT M/L, S 931.8 FT, W 349.88 FT OF NE4NW4 OF SEC 18 EX HWY BY BK 6509-223 & REC #201040780

CONSTRUCTION SCHEDULE

BEGIN GRADING: SUMMER 2025, END GRADING: FALL 2025

CONTACT INFORMATION:

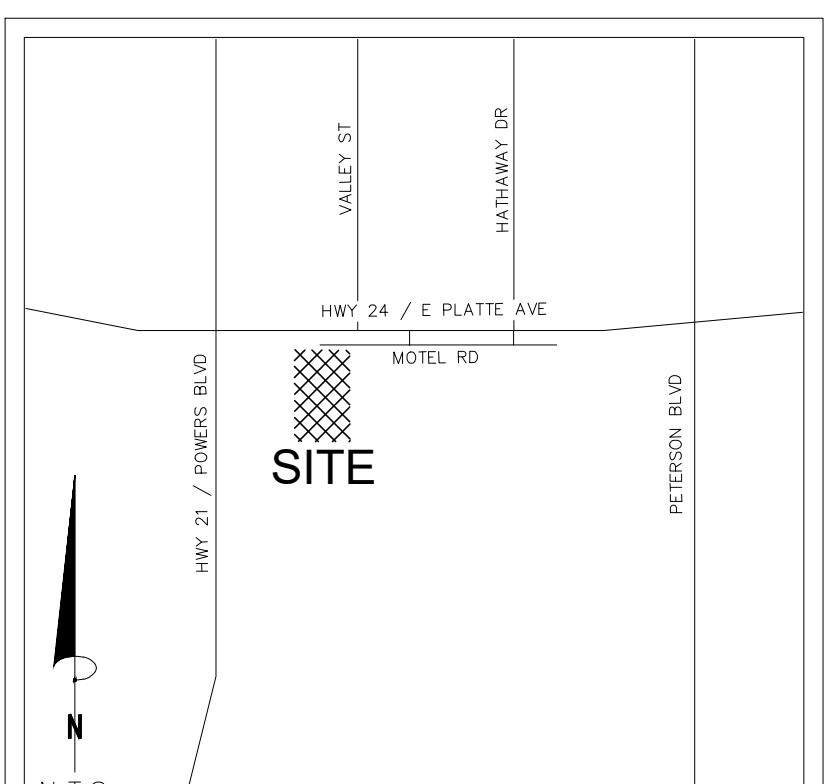
OWNER: DONALD HUMPHREY
5780 SAYRES ROAD
COLORADO SPRINGS, CO 80927
(719) 492-8649

CIVIL ENGINEER: TERRA NOVA ENGINEERING, INC.
721 S. 23RD STREET
COLORADO SPRINGS, COLORADO 80904
DALE FRANK, P.E., (719) 635-6422

EL PASO COUNTY: PLANNING AND COMMUNITY DEVELOPMENT
2880 INTERNATIONAL CIRCLE
COLORADO SPRINGS, COLORADO 80910
(719) 520-6300


CIMARRON HILLS FIRE DEPT: HEADQUARTERS
1835 TUSKEGE PL
COLORADO SPRINGS, COLORADO 80915
(719) 591-0960

CHEROKEE METRO DISTRICT: 6250 PALMER PARK BOULEVARD
COLORADO SPRINGS, COLORADO 80915
(719) 597-5080



VICINITY MAP

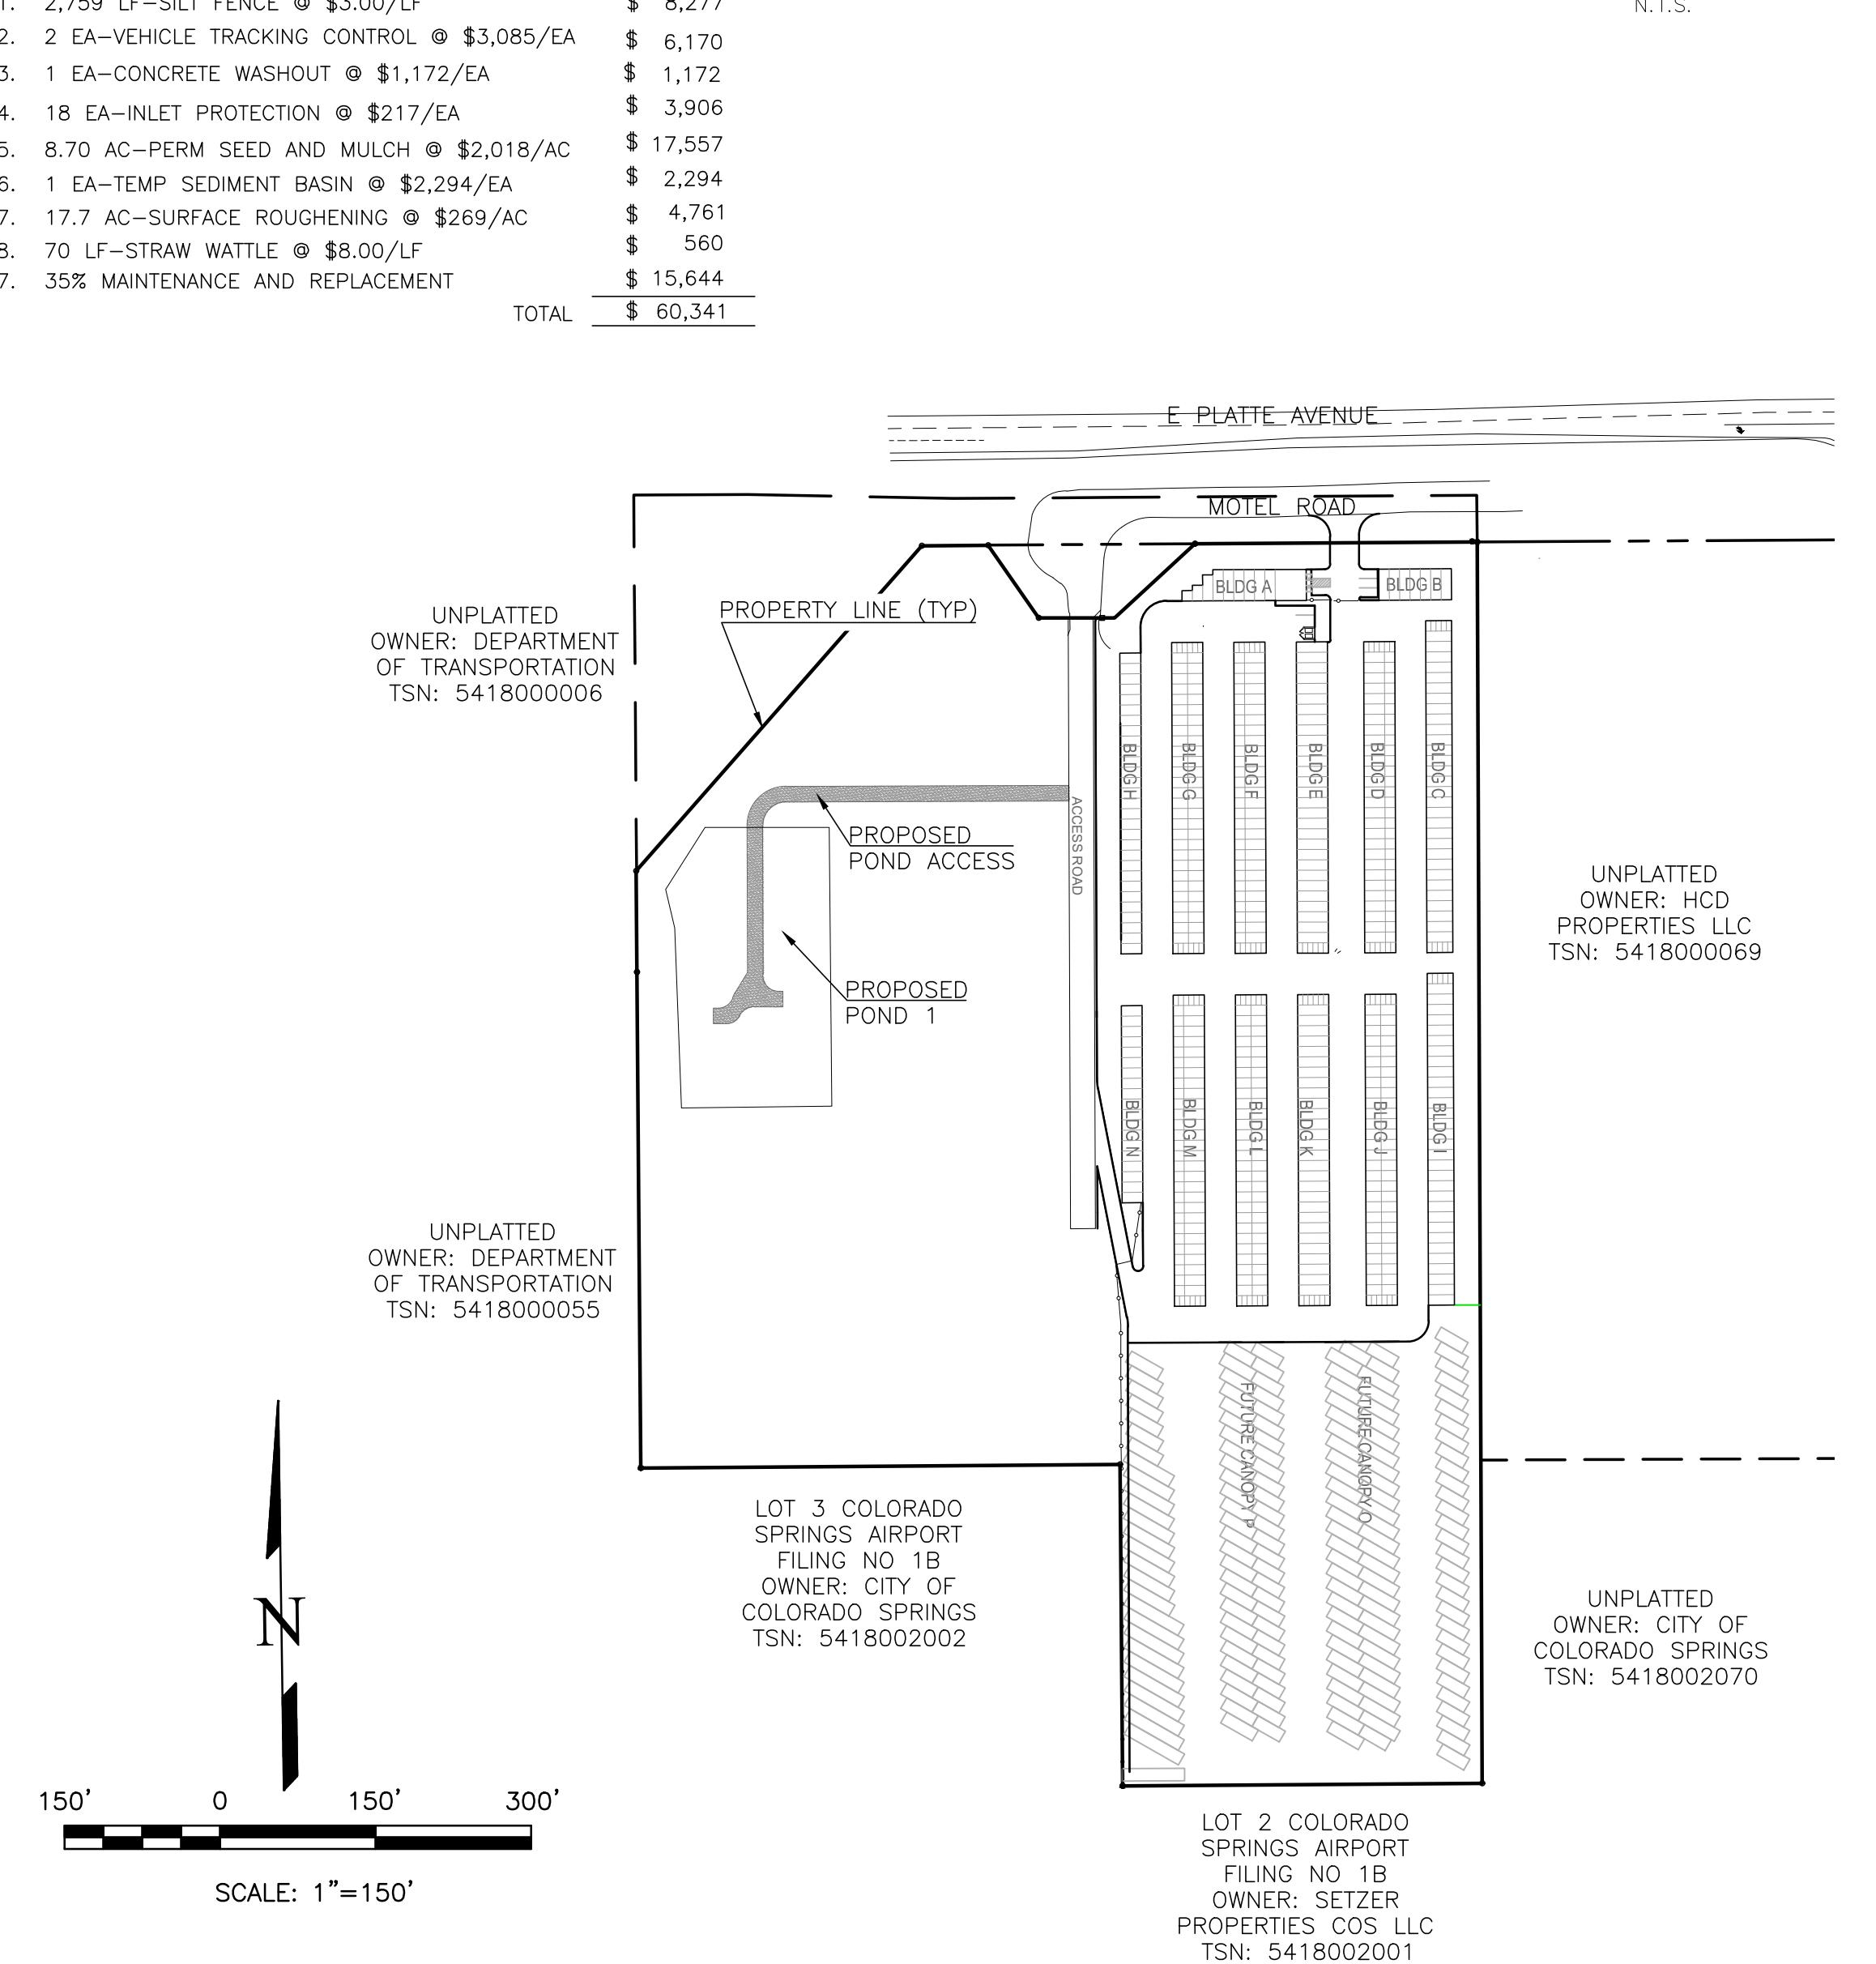N.T.S.




ENGINEER OF RECORD SIGNATURE DATE
DANE FRANK, P.E. #50207
FOR AND ON BEHALF OF TERRA NOVA ENGINEERING, INC.

PLATTE SELF STORAGE

GRADING AND EROSION CONTROL PLAN

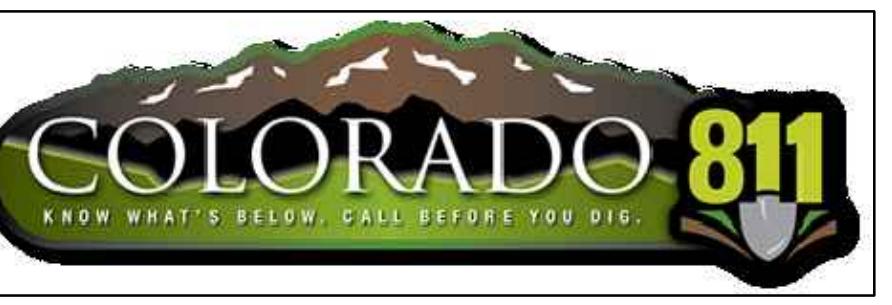OVERVIEW SHEET



E PLATTE AVENUE

PLATTE AVENUE FRONTAGE ROAD - MOTEL ROAD (ROW VARIES)

LIMITS OF DISTURBANCE = 19.5 AC

CONSTRUCTION SITE BOUNDARY

FEMA FLOODWAY ZONE AE

PROPERTY LINE (TYP)

UNPLATTED OWNER: DEPARTMENT OF TRANSPORTATION TSN: 5418000006

UNPLATTED OWNER: DEPARTMENT OF TRANSPORTATION TSN: 5418000055

UNPLATTED OWNER: HCD PROPERTIES LLC TSN: 5418000069

BLDG A

BLDG B

BLDG H

BLDG G

BLDG F

BLDG E

BLDG D

BLDG C

BLDG J

BLDG I

BLDG M

BLDG L

BLDG K

BLDG N

PROPOSED POND 1 ACCESS ROAD

PROPOSED DETENTION POND 1

PROPOSED MINI-WAREHOUSE AREA

PROPOSED GRASS SWALE

FUTURE CANOPY

PROPOSED OUTDOOR VEHICLE STORAGE

OFFSITE GRADING & UTILITY WORK

OFFSITE UTILITY WORK

UNPLATTED OWNER: CITY OF COLORADO SPRINGS TSN: 5418002002

UNPLATTED OWNER: CITY OF COLORADO SPRINGS TSN: 5418002070

UNPLATTED OWNER: SETZER PROPERTIES COS LLC TSN: 5418002001

BENCHMARKS
CDOT RIGHT OF WAY MONUMENT #3014 – ELEV=6232.52 (NAVD-1988) [NORTHEAST]

SCALE: 1"=80'

N

GRADING LEGEND

PROPOSED	PR	EXISTING CONTOURS – MINOR
EXISTING	EX	EXISTING CONTOURS – MAJOR
FINISHED SURFACE	FS	PROPOSED CONTOURS – 1'
FINISHED GROUND	FG	EXISTING PROPERTY LINE
TOP OF CURB	TC	PROPOSED RET WALL
FLOWLINE	FL	PROPOSED RIPRAP
FINISH GROUND AT TOP OF WALL	TW	WATER LINE
FINISHED GROUND AT BOTTOM OF WALL	BW	SANITARY SEWER LINE
LOW POINT	LP	GAS LINE
HIGH POINT	HP	UNDERGROUND ELECTRICAL LINE
FLOW ARROW	←	TELEPHONE LINE
EXISTING CONTOURS (LIDAR)	8130	FIBER OPTIC LINE
STORM MANHOLE	○	STORM SEWER LINE
STORM INLET	□	LIMIT OF CONSTRUCTION
		LIMIT OF SOIL DISTURBANCE
		PROPOSED FENCE
		● FIRE HYDRANT
		□ PROPOSED CURB & GUTTER

NOTES


1. THERE IS LITTLE TO NO NOTABLE VEGETATION LOCATED ON SITE.
2. THERE WILL BE OFFSITE GRADING FOR THE PROPOSED UTILITIES AND GRADING AVENUE FRONTAGE ROAD RIGHT-OF-WAY.

THIS DESIGN WAS PREPARED FOR AND ON BEHALF OF

DANE FRANK
COLORADO P.E. # 502

REVISIONS	NO.	DESCRIPTION	DATE
UNTIL SUCH TIME AS THESE DRAWINGS ARE APPROVED BY THE APPROPRIATE REVIEWING AGENCIES, TERRA NOVA ENGINEERING, INC. APPROVES THEIR USE ONLY FOR THE PURPOSES DESIGNATED BY WRITTEN AUTHORIZATION.			

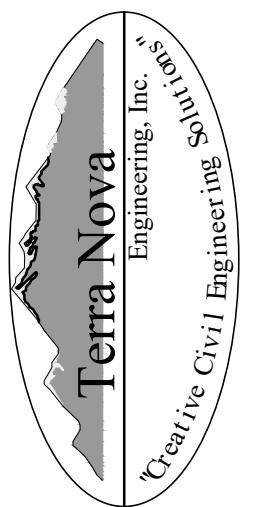PREPARED FOR:
RMG-ROCKY MOUNTAIN GROUP
ATTN:
5085 LIST DR, #200
COLORADO SPRINGS, CO 80919
719.548.0600



PLATTE SELF STORAGE

GRADING AND EROSION CONTROL PLAN OVERVIEW SHEET

DESIGNED BY	JF
DRAWN BY	JF
CHECKED BY	DF
H-SCALE	AS SHOWN
V-SCALE	N/A
JOB NO. 2419.00	
DATE ISSUED 01/15/25	
SHEET NO.	2 OF 28



PLATTE SELF STORAGE GRADING AND EROSION CONTROL PLAN INTERIM GRADING PLAN - NORTH SIDE

JANUARY 2025


BENCHMARKS

CDOT RIGHT OF WAY MONUMENT #3014 - ELEV=6232.52 (NAVD-1988) [NORTHEAST OF SITE ENTRANCE]

GRADING LEGEND

REVISIONS	DESCRIPTION	DATE
NO.		
6231	EXISTING CONTOURS - MINOR	6231
6230	EXISTING CONTOURS - MAJOR	6230
6231	PROPOSED CONTOURS - 1'	6231
	EXISTING PROPERTY LINE	
	PROPOSED RET WALL	
	PROPOSED RIPRAP	
	WATER LINE	
	SANITARY SEWER LINE	
	GAS LINE	
	UNDERGROUND ELECTRICAL LINE	
	TELEPHONE LINE	
	FIBER OPTIC LINE	
	STORM SEWER LINE	
	LIMIT OF CONSTRUCTION	
	LIMIT OF SOIL DISTURBANCE	
	PROPOSED FENCE	
	STORM MANHOLE	
	STORM HYDRANT	
	PROPOSED CURB & GUTTER	

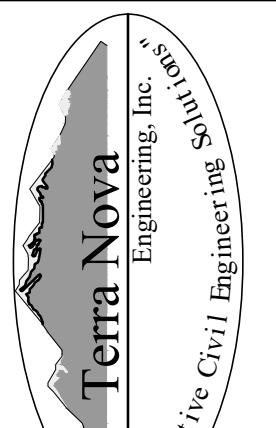PREPARED FOR:
RMG-ROCKY MOUNTAIN GROUP
ATTN: LIST DR, #200
5085 COLORADO SPRINGS, CO 80919
719.548.0600




PLATTE SELF STORAGE

GRADING AND EROSION CONTROL PLAN
INTERIM GRADING PLAN - NORTH SIDE

DESIGNED BY JF
DRAWN BY JF
CHECKED BY DF
H-SCALE AS SHOWN
V-SCALE N/A
JOB NO. 2419.00
DATE ISSUED 01/15/25
SHEET NO. 3 OF 28

THIS DESIGN WAS PREPARED UNDER MY DIRECT SUPERVISION
FOR AND ON BEHALF OF TERRA NOVA ENGINEERING, INC.

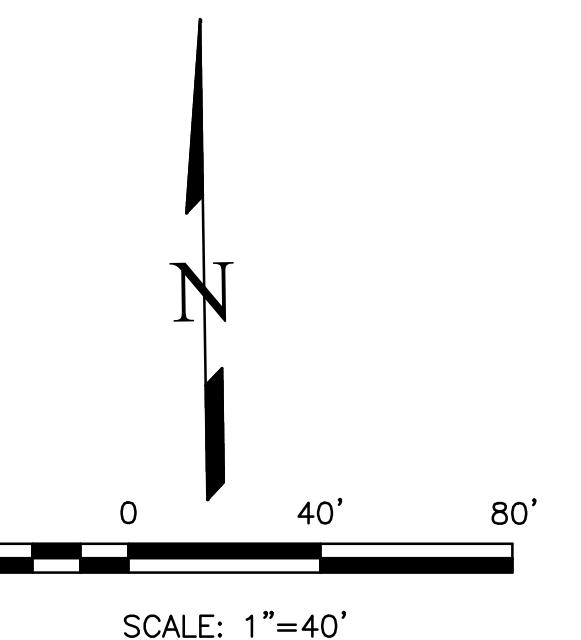DANE FRANK
COLORADO P.E. # 50207



NOTES

1. THERE IS LITTLE TO NO NOTABLE EXISTING VEGETATION LOCATED ON SITE.
2. THERE WILL BE OFFSITE EARTHWORK FOR THE PROPOSED UTILITIES AND GRADING WITHIN THE PLATTE AVENUE FRONTAGE ROAD RIGHT-OF-WAY.

PLATTE SELF STORAGE
GRADING AND EROSION CONTROL PLAN
INTERIM GRADING PLAN - SOUTH SIDE
JANUARY 2025


BENCHMARKS
 CDOT RIGHT OF WAY MONUMENT #3014 - ELEV=6232.52 (NAVD-1988) [NORTHEAST OF SITE ENTRANCE]

GRADING LEGEND

PROPOSED	PR	EXISTING CONTOURS - MINOR
EXISTING	EX	EXISTING CONTOURS - MAJOR
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STORM INLET	□	LIMIT OF SOIL DISTURBANCE
		PROPOSED FENCE
		FIRE HYDRANT
		PROPOSED CURB & GUTTER

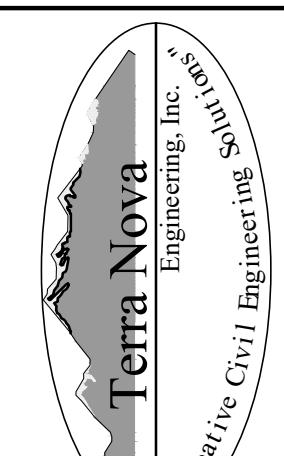REVISIONS
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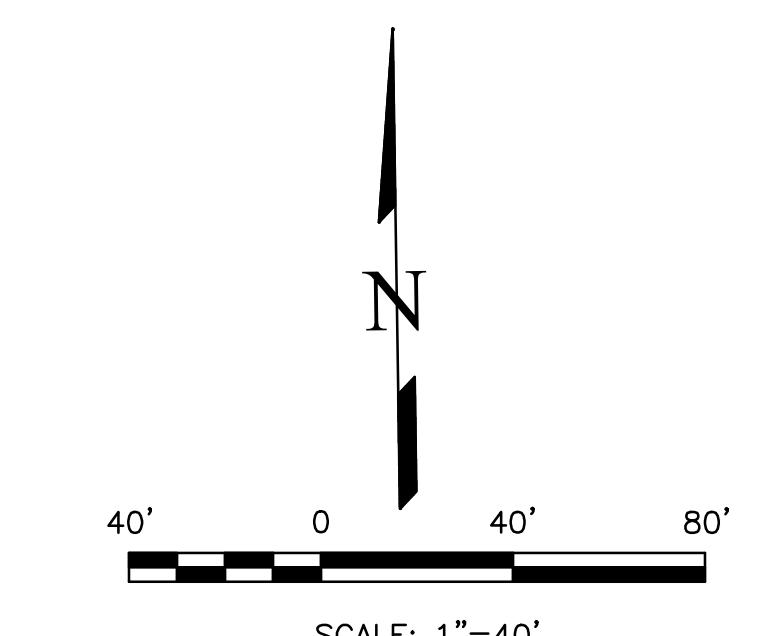
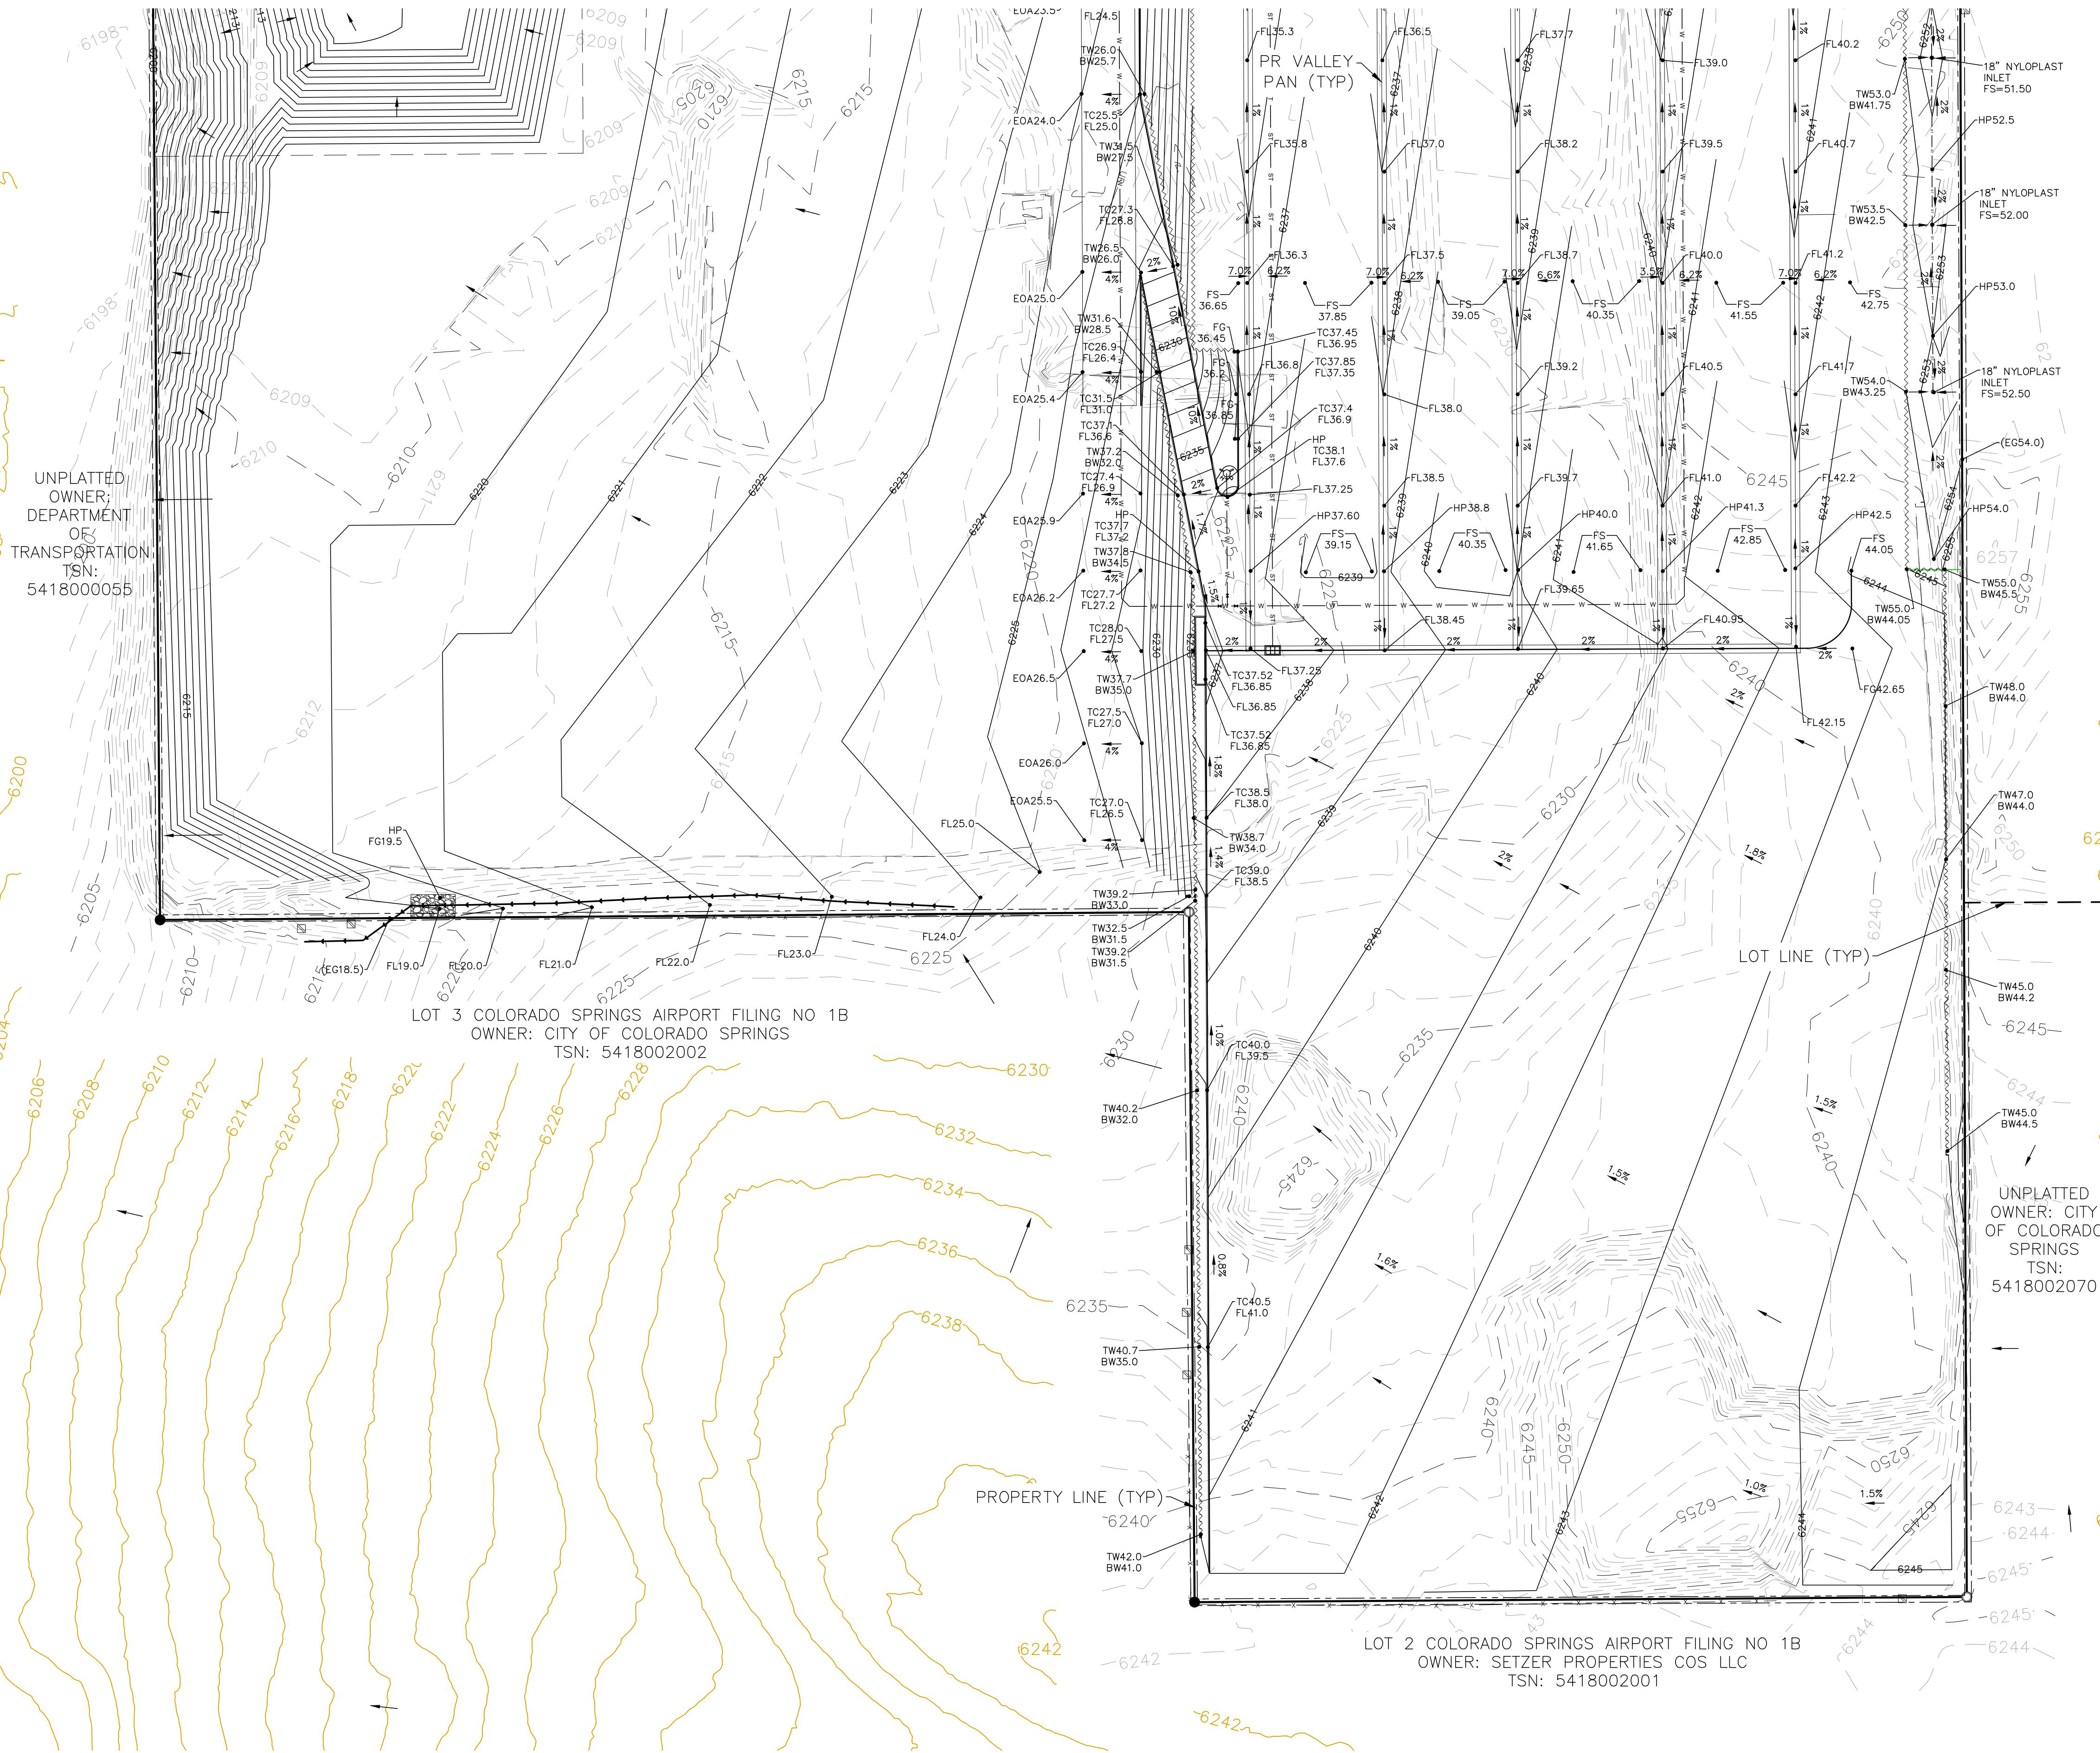


721 S. 23RD STREET
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 FAX: 719-535-6426
 www.tresinc.com

PLATTE SELF STORAGE

GRADING AND EROSION CONTROL PLAN
 INTERIM GRADING PLAN - SOUTH SIDE

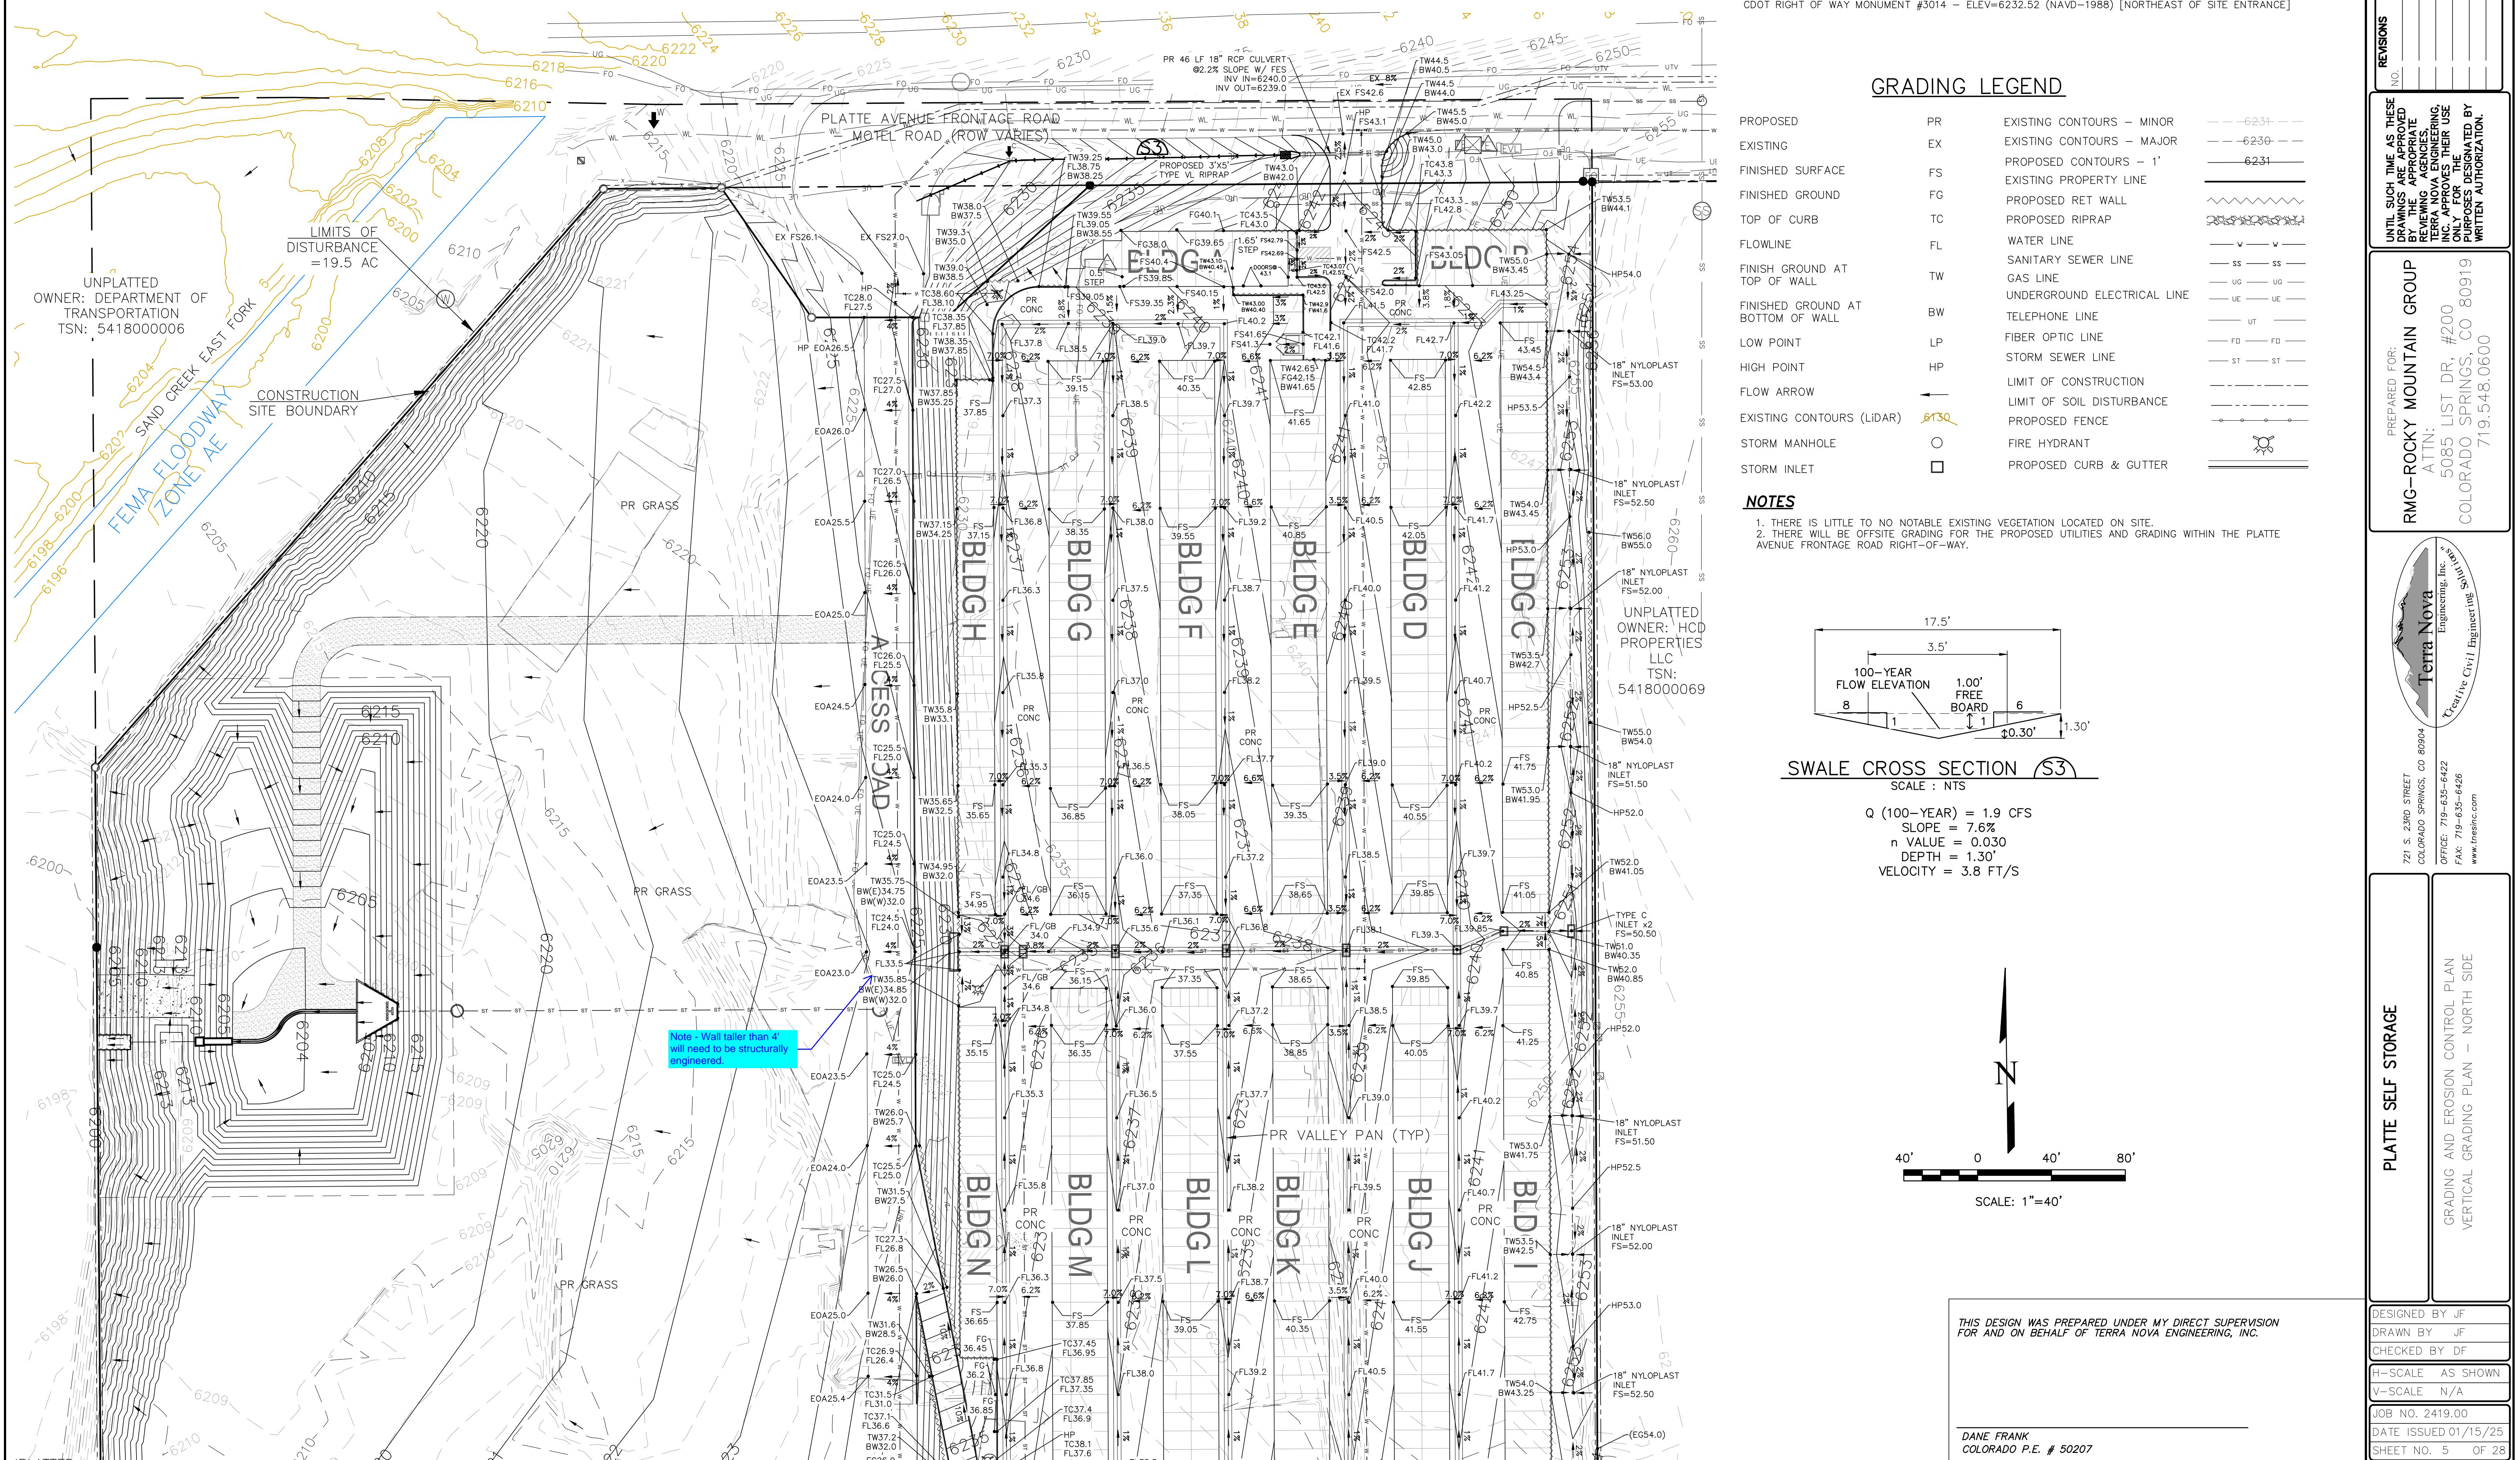
DESIGNED BY JF
DRAWN BY JF
CHECKED BY DF
H-SCALE AS SHOWN
V-SCALE N/A
JOB NO. 2419.00
DATE ISSUED 01/15/25
SHEET NO. 4 OF 28



NOTES

1. THERE IS LITTLE TO NO NOTABLE EXISTING VEGETATION LOCATED ON SITE.
2. THERE WILL BE OFFSITE EARTHWORK FOR THE PROPOSED UTILITIES AND GRADING WITHIN THE PLATTE AVENUE FRONTAGE ROAD RIGHT-OF-WAY.

PLATTE SELF STORAGE
GRADING AND EROSION CONTROL PLAN
FINAL GRADING PLAN - NORTH SIDE
JANUARY 2025



**PLATTE SELF STORAGE
GRADING AND EROSION CONTROL PLAN
FINAL GRADING PLAN - SOUTH SIDE
JANUARY 2025**

BENCHMARKS


CDOT RIGHT OF WAY MONUMENT #3014 - ELEV=6232.52 (NAVD-1988) [NORTHEAST OF SITE ENTRANCE]

GRADING LEGEND

		REVISIONS	DESCRIPTION
		NO.	
PROPOSED	PR		EXISTING CONTOURS - MINOR
EXISTING	EX		EXISTING CONTOURS - MAJOR
FINISHED SURFACE	FS		PROPOSED CONTOURS - 1'
FINISHED GROUND	FG		EXISTING PROPERTY LINE
TOP OF CURB	TC		PROPOSED RET WALL
FLOWLINE	FL		PROPOSED RIPRAP
FINISH GROUND AT TOP OF WALL	TW		WATER LINE
FINISHED GROUND AT BOTTOM OF WALL	BW		SANITARY SEWER LINE
LOW POINT	LP		GAS LINE
HIGH POINT	HP		UNDERGROUND ELECTRICAL LINE
FLOW ARROW	◀		TELEPHONE LINE
EXISTING CONTOURS (LiDAR)	6130		FIBER OPTIC LINE
STORM MANHOLE	○		STORM SEWER LINE
STORM INLET	□		LIMIT OF CONSTRUCTION
			LIMIT OF SOIL DISTURBANCE
			PROPOSED FENCE
			FIRE HYDRANT
			PROPOSED CURB & GUTTER


NOTES

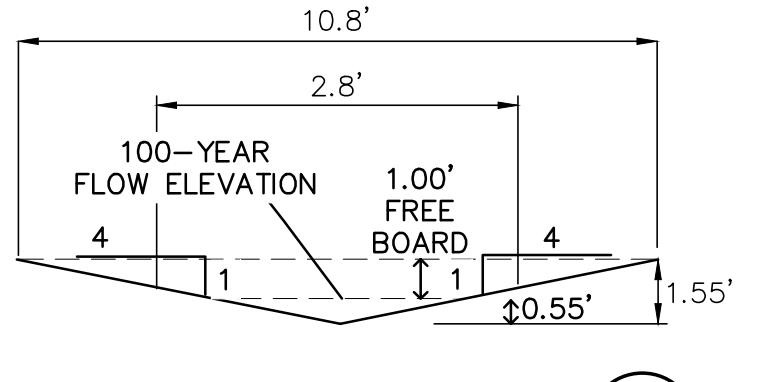- 1. THERE IS LITTLE TO NO NOTABLE EXISTING VEGETATION LOCATED ON SITE.
 2. THERE WILL BE OFFSITE GRADING FOR THE PROPOSED UTILITIES AND GRADING WITHIN THE PLATTE AVENUE FRONTAGE ROAD RIGHT-OF-WAY.



SWALE CROSS SECTION S4

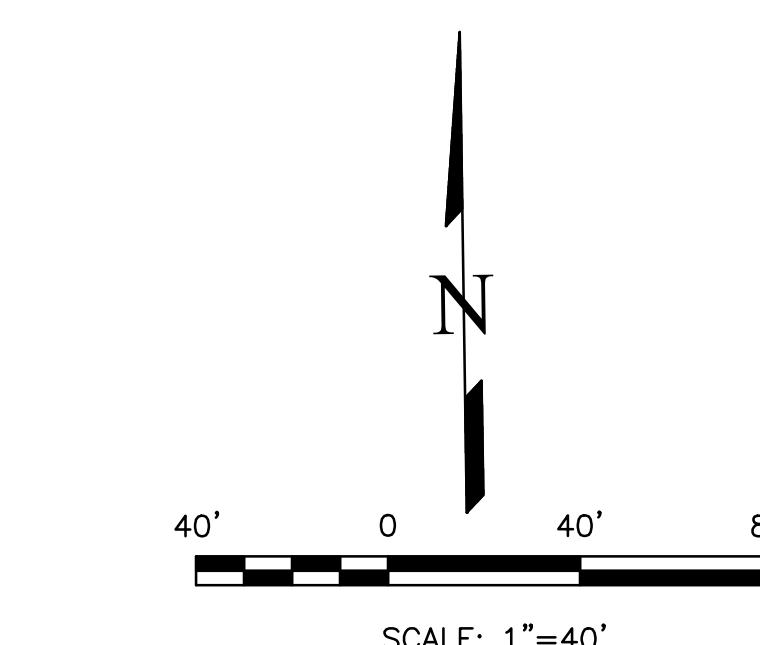Q (100-YEAR) = 3.3 CFS
SLOPE = 2.0%
n VALUE = 0.030
DEPTH = 1.55'
VELOCITY = 2.9 FT/S



LOT 3 COLORADO SPRINGS AIRPORT FILING NO
OWNER: CITY OF COLORADO SPRINGS
TSN: 5418002002

Note - Wall tags will need to be engineered.

An architectural rendering of a modern building's exterior. The building features a complex roof system with multiple levels and overhangs. One prominent overhang is labeled "FUTURE CANOPY" and "P". Another section of the roof has a label "2%" with an arrow indicating a slope. The building is surrounded by trees and other architectural elements.

A topographic map showing property boundaries. A specific point is marked with a small circle and labeled with coordinates: TW45.0 and BW44.5. The map includes contour lines and property lines. A label 'UNPLATTED' is written across the bottom right. Other labels visible include '6240', '6244', '6245', '1.5%', and 'C4'. A yellow dot is located near the bottom right corner.

UNPLATTED
OWNER: CITY
OF COLORADO
SPRINGS
TSN:
5418002070

LOT 2 COLORADO SPRINGS AIRPORT FILING NO 1B
OWNER: SETZER PROPERTIES COS LLC
TSN: 5418002001

*THIS DESIGN WAS PREPARED UNDER MY DIRECT SUPERVISION
FOR AND ON BEHALF OF TERRA NOVA ENGINEERING, INC.*

DANE FRANK
COLORADO P.E. # 50207

PLATTE SELF STORAGE

GRADING AND EROSION CONTROL PLAN VERTICAL GRADING PLAN – SOUTH SIDE

The logo for Terra Nova Engineering, Inc. is set against a background of a stylized, jagged mountain range silhouette. The company name "Terra Nova" is written vertically in large, bold, sans-serif capital letters across the center of the graphic. To the right of the main name, the words "Engineering, Inc." are stacked vertically in a smaller font. A curved banner or ribbon graphic sweeps from the bottom right towards the center, containing the slogan "Creative Civil Engineering Solutions" in a cursive, italicized font.

PREPARED FOR:	NO.	DESCRIPTION	DATE
RMG-ROCKY MOUNTAIN GROUP			
ATTN:			
50085 LIST DR, #200 COLORADO SPRINGS, CO 80919 719.548.0600			
UNTIL SUCH TIME AS THESE DRAWINGS ARE APPROVED BY THE APPROPRIATE REVIEWING AGENCIES, TERRA NOVA ENGINEERING, INC. APPROVES THEIR USE ONLY FOR THE PURPOSES DESIGNATED BY WRITTEN AUTHORIZATION.			



PLATTE SELF STORAGE	
721 S. 23RD COLORADO SPRINGS, CO 80904	
OFFICE: 719-558-1111 FAX: 719-632-1111 www.tnesinc.com	
GRADING AND EROSION CONTROL PLAN VERTICAL GRADING PLAN - SOUTH SIDE	
DESIGNED BY JF	
DRAWN BY JF	
CHECKED BY DF	
-SCALE AS SHOWN	
-SCALE N/A	
JOB NO. 2419.00	
DATE ISSUED 01/15/25	
HEET NO. 6 OF 28	

PLATTE SELF STORAGE


GRADING AND EROSION CONTROL PLAN

GRADING DETAILS SHEET

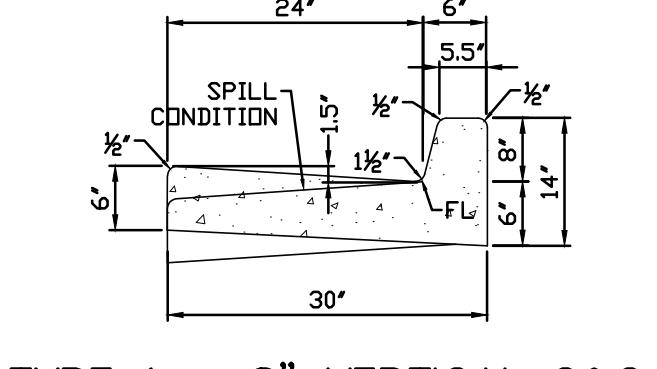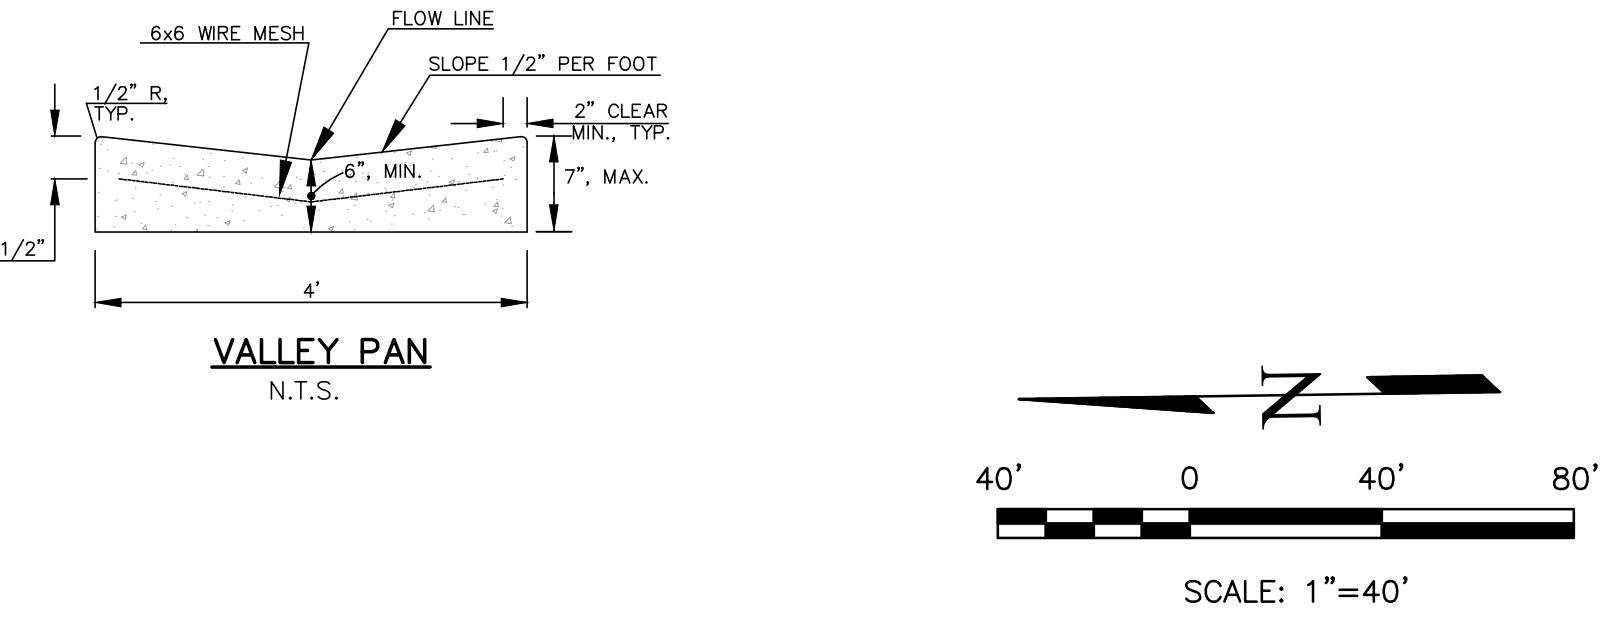
JANUARY 2025



TYPE 1 - 8" VERTICAL C&G

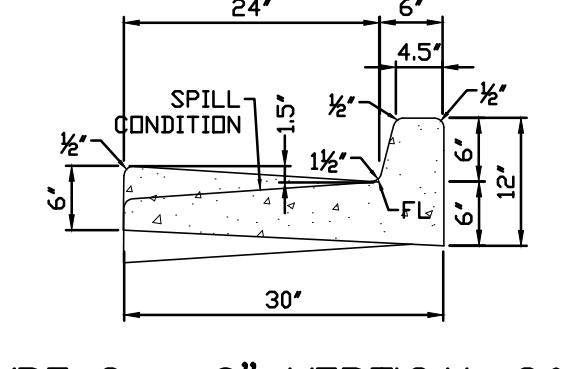

TYPE 2 - 6" VERTICAL C&G
N.T.S.

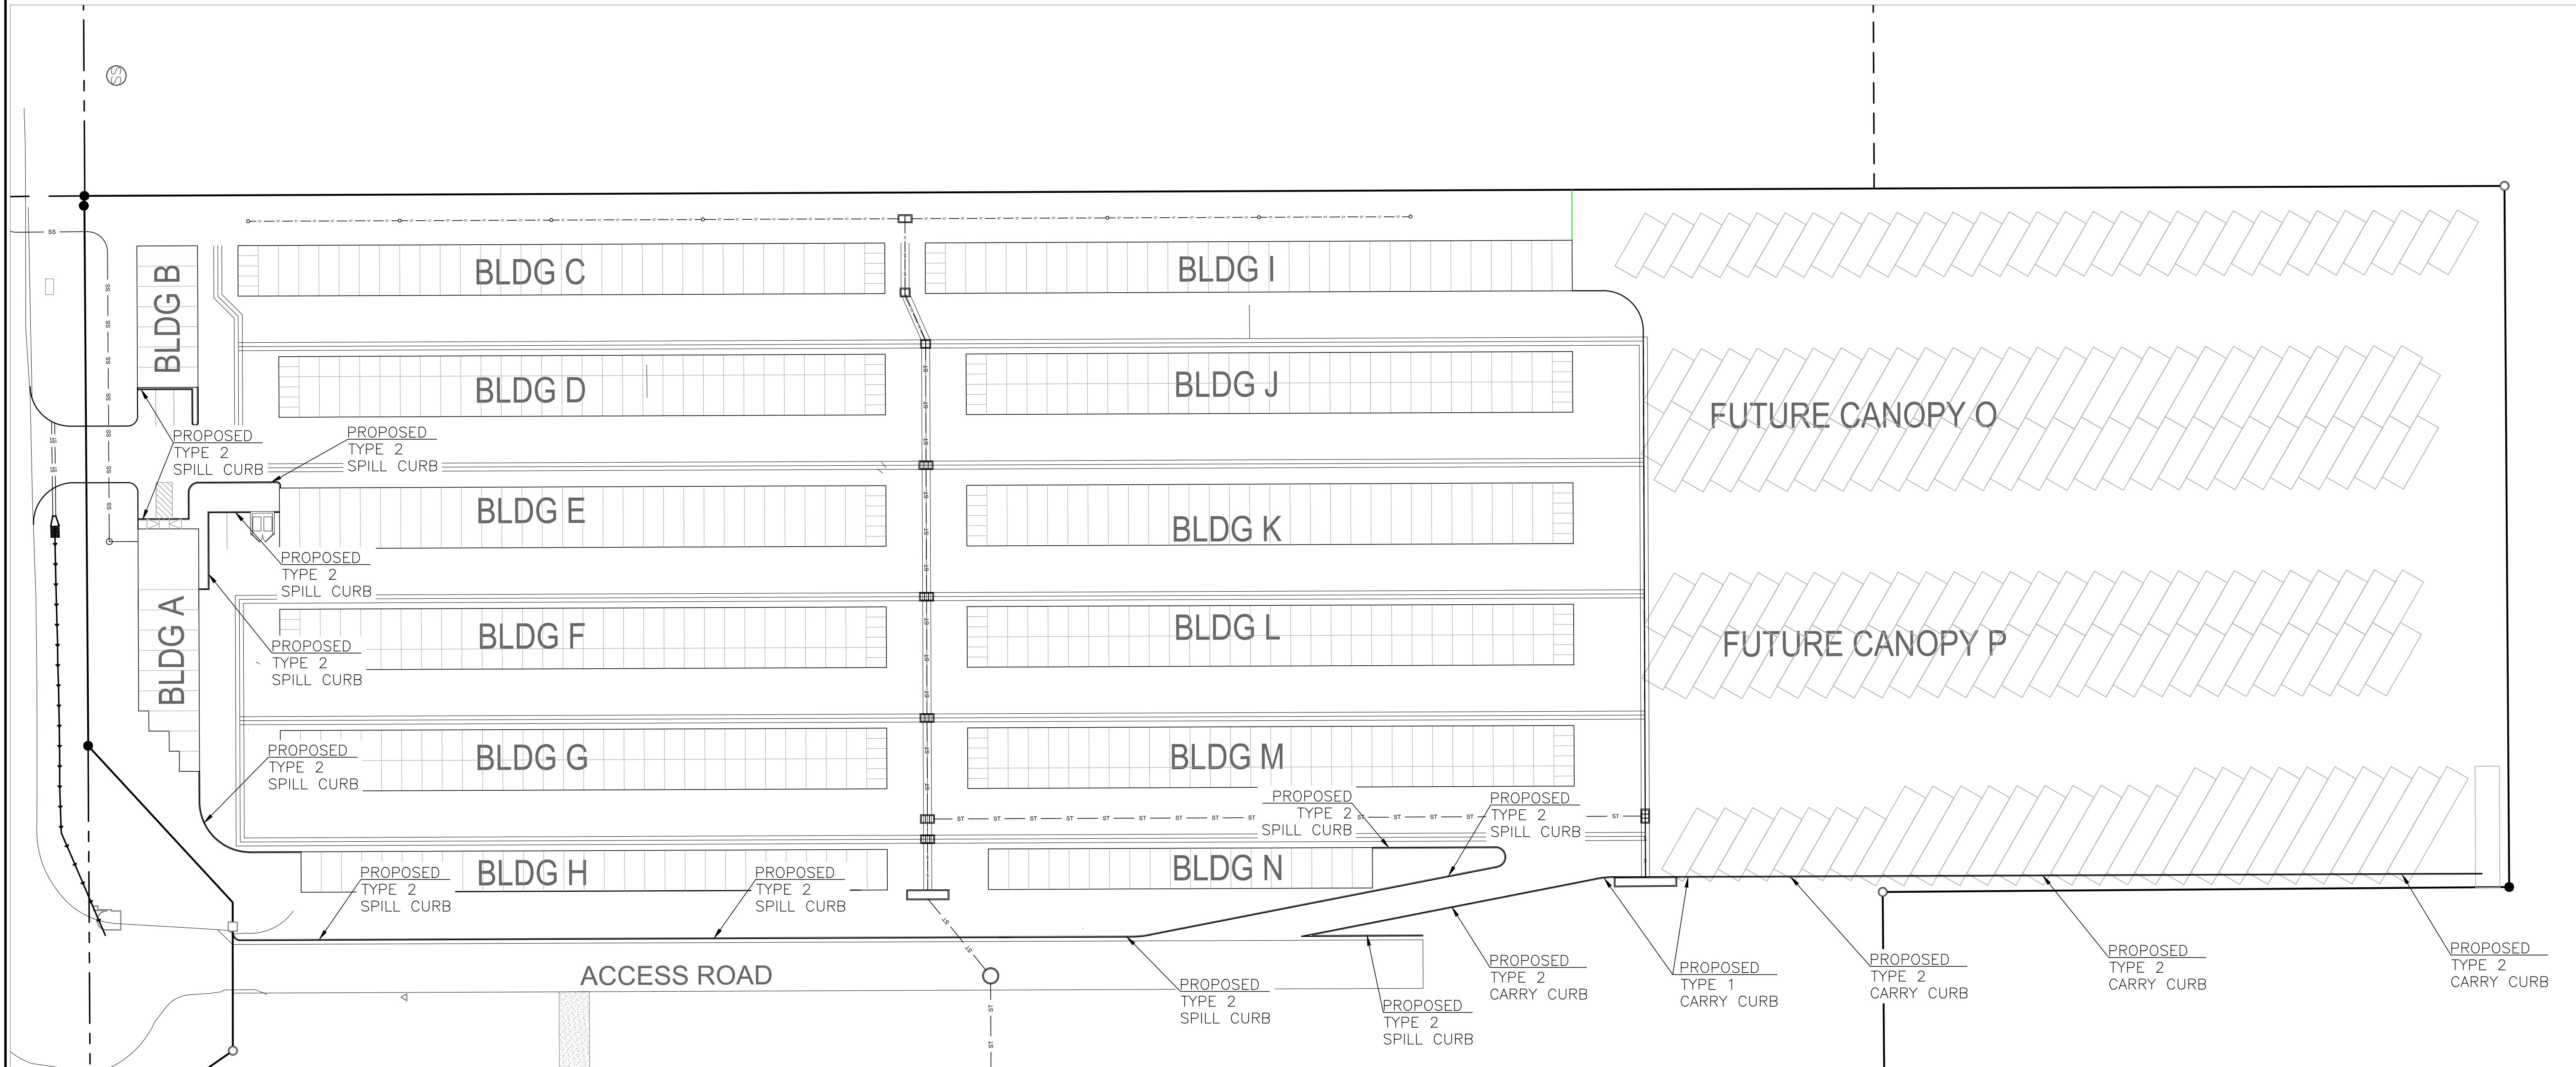


THIS DESIGN WAS PREPARED UNDER MY DIRECT SUPERVISION
FOR AND ON BEHALF OF TERRA NOVA ENGINEERING, INC.

*DANE FRANK
COLORADO P.E. # 50207*

RMG-ROCKY MOUNTAIN GROUP

PREPARED FOR:
ATTN:

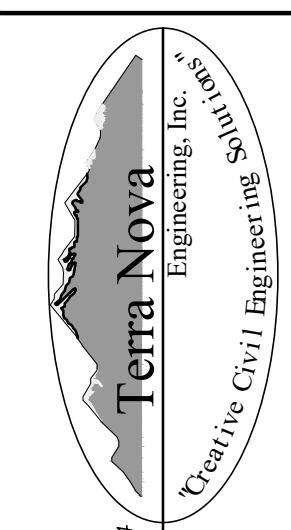
5085 LIST DR, #200
COLORADO SPRINGS, CO 80919
719.548.0600



PLATTE SELF STORAGE

GRADING AND EROSION CONTROL PLAN GRADING DETAILS

DESIGNED BY	JF
DRAWN BY	JF
CHECKED BY	DF
H-SCALE	AS SHOWN
V-SCALE	N/A
JOB NO. 2419.00	
DATE ISSUED 01/15/25	
SHEET NO.	7 OF 28

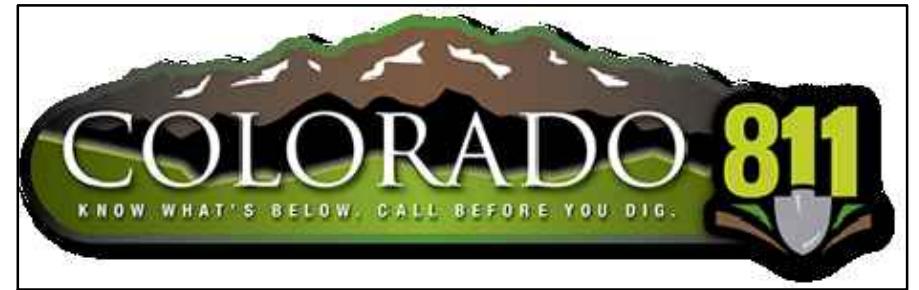

PLATTE SELF STORAGE
GRADING AND EROSION CONTROL PLAN

INITIAL GRADING & EROSION CONTROL - NORTH SIDE

JANUARY 2025

BENCHMARKS

CDOT RIGHT OF WAY MONUMENT #3014 – ELEV=6232.52 (NAVD-1988) [NORTHEAST OF SITE ENTRANCE]



GRADING LEGEND


PROPOSED	PR	EXISTING CONTOURS – MINOR	— — 6231 — —
EXISTING	EX	EXISTING CONTOURS – MAJOR	— — 6230 — —
FINISHED SURFACE	FS	PROPOSED CONTOURS – 1'	6231
FINISHED GROUND	FG	EXISTING PROPERTY LINE	
TOP OF CURB	TC	PROPOSED RET WALL	
FLOWLINE	FL	PROPOSED RIPRAP	
FINISH GROUND AT TOP OF WALL	TW	WATER LINE	— w — w —
FINISHED GROUND AT BOTTOM OF WALL	BW	SANITARY SEWER LINE	— ss — ss —
LOW POINT	LP	GAS LINE	— ug — ug —
HIGH POINT	HP	UNDERGROUND ELECTRICAL LINE	— ue — ue —
FLOW ARROW	←	TELEPHONE LINE	— ut — —
EXISTING CONTOURS (LiDAR)		FIBER OPTIC LINE	— fo — fo —
STORM MANHOLE	○	STORM SEWER LINE	— st — st —
STORM INLET	□	LIMIT OF CONSTRUCTION	— - — - — -
		LIMIT OF SOIL DISTURBANCE	— - - - — -
		PROPOSED FENCE	○ ○ ○ ○ ○
		FIRE HYDRANT	
		PROPOSED CURB & GUTTER	

NOTES

1. THERE IS LITTLE TO NO NOTABLE EXISTING VEGETATION LOCATED ON SITE.
 2. THERE WILL BE OFFSITE EARTHWORK FOR THE PROPOSED UTILITIES AND GRADING WITHIN THE PLATTE AVENUE FRONTAGE ROAD RIGHT-OF-WAY.
 3. THE COUNTY HAS REQUIRED AN INITIAL GRADING PLAN. THIS INITIAL GRADING IS A POOR FIT FOR THE PROPOSED SITE DUE TO THE LARGE NUMBER OF TALL RETAINING WALLS PROPOSED. THE DESIGN ENGINEER DOES NOT CONSIDER MATCHING THE INITIAL GRADING PLAN TO BE CRITICAL AND RECOMMENDS THE CONTRACTOR PRIORITIZE CONSTRUCTION OF THE RETAINING WALLS AND THE VERTICAL GRADING PLAN OVER THE INITIAL GRADING PLAN.
 4. SEED AND MULCH DISTURBED AREAS ONLY.
 5. SEDIMENT CONTROL LOGS MAY BE SUBSTITUTED FOR SILT FENCE AND VICE VERSA.

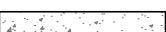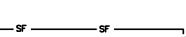EROSION CONTROL LEGEND

<u>KEY</u>	<u>TITLE</u>	<u>SYMBOL</u>	<u>IMPLEMENTATION PHASE</u>
	SILT FENCE	— SF —	INITIAL
	STABILIZED STAGING AREA		INITIAL
	VEHICLE TRACKING CONTROL		INITIAL
	STOCKPILE MANAGEMENT WITH PROTECTION		INITIAL
	CONCRETE WASHOUT AREA		INITIAL
	SURFACE ROUGHENING		INITIAL
	TEMPORARY SEDIMENT BASIN	NONE	INITIAL
	PORTABLE TOILET	NONE	INITIAL

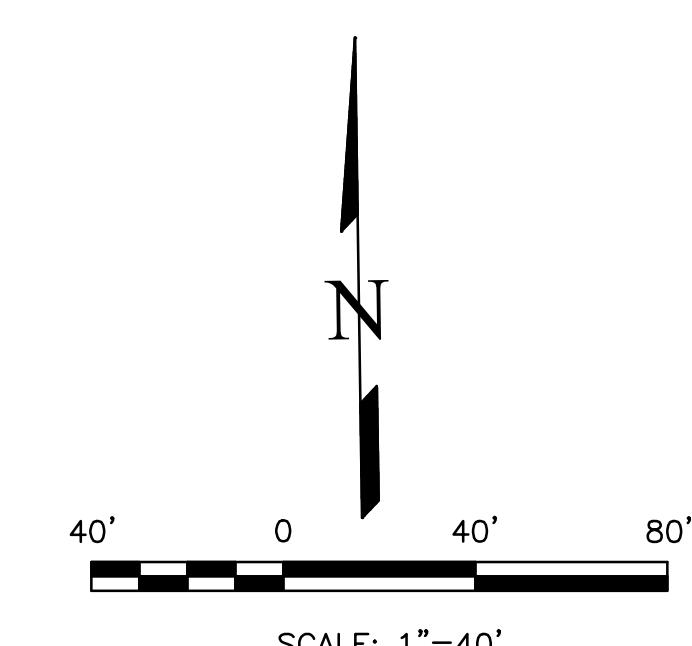

THIS DESIGN WAS PREPARED UNDER MY DIRECT SUPERVISION
FOR AND ON BEHALF OF TERRA NOVA ENGINEERING, INC.

DANE FRANK
COLORADO P.E. # 50207

PREPARED FOR: RMG-ROCKY MOUNTAIN GROUP	REVISIONS NO.	DESCRIPTION	DATE
<p>UNTIL SUCH TIME AS THESE DRAWINGS ARE APPROVED BY THE APPROPRIATE REVIEWING AGENCIES, TERRA NOVA ENGINEERING, INC. APPROVES THEIR USE ONLY FOR THE PURPOSES DESIGNATED BY WRITTEN AUTHORIZATION.</p>			

The logo features a large, dark grey mountain peak shape with jagged edges and a rocky base. Overlaid on the left side of the peak is the word "Terra" in a bold, serif font. To the right of the peak, the word "Nova" is written vertically in a bold, sans-serif font. Below the peak, the words "Engineering, Inc. " are stacked vertically in a smaller, serif font. Along the bottom right edge of the peak, the words "Creative Civil Engineering Solutions" are written in a cursive, italicized font.

PLATTE SELF STORAGE

RADING AND EROSION CONTROL PLAN INITIAL – NORTH SIDE

DESIGNED BY	JF
DRAWN BY	JF
CHECKED BY	DF
H-SCALE	AS SHOWN
V-SCALE	N/A
JOB NO. 2419.00	
DATE ISSUED 01/15/25	
SHEET NO.	8 OF 28




PLATTE SELF STORAGE GRADING AND EROSION CONTROL PLAN INITIAL GRADING & EROSION CONTROL PLAN - SOUTH SIDE

JANUARY 2025

BENCHMARKS

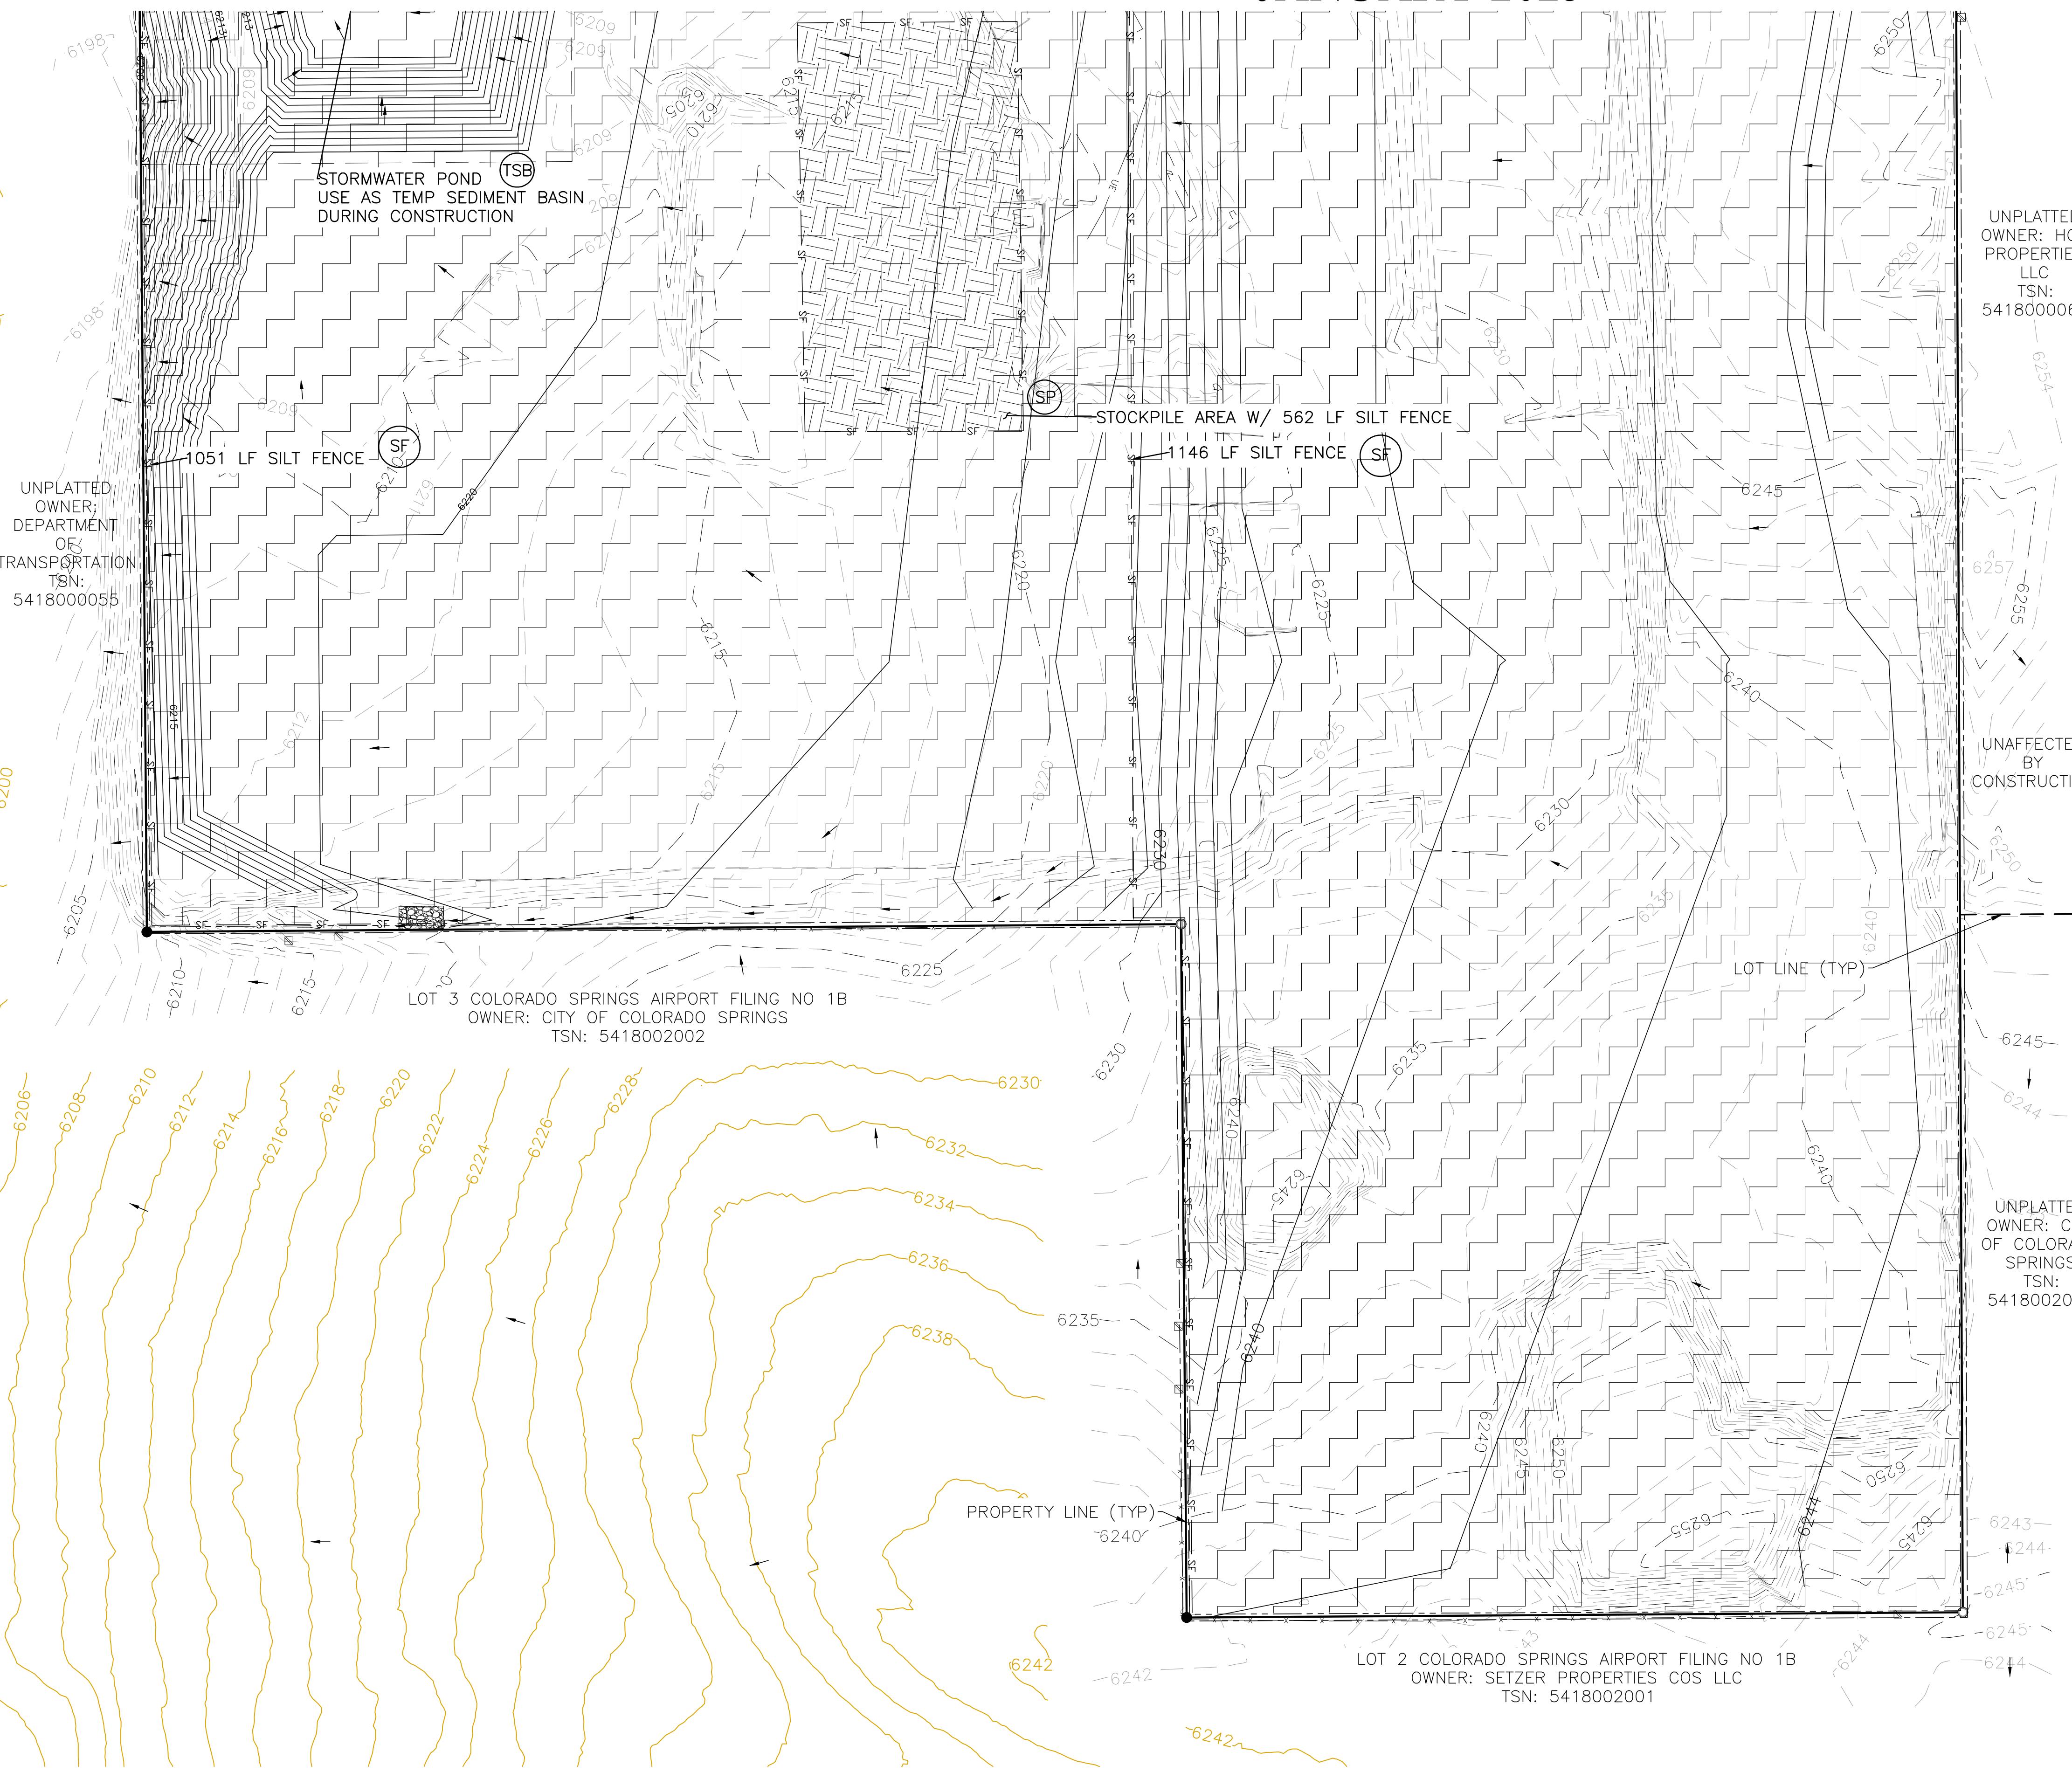CDOT RIGHT OF WAY MONUMENT #3014 - ELEV=6232.52 (NAVD-1988) [NORTHEAST OF SITE ENTRANCE]




GRADING LEGEND

PROPOSED	PR	EXISTING CONTOURS - MINOR
EXISTING	EX	EXISTING CONTOURS - MAJOR
FINISHED SURFACE	FS	PROPOSED CONTOURS - 1'
FINISHED GROUND	FG	EXISTING PROPERTY LINE
TOP OF CURB	TC	PROPOSED RET WALL
FLOWLINE	FL	PROPOSED RIPRAP
		WATER LINE
		SANITARY SEWER LINE
		GAS LINE
		UNDERGROUND ELECTRICAL LINE
		TELEPHONE LINE
		FIBER OPTIC LINE
		STORM SEWER LINE
		LIMIT OF CONSTRUCTION
		LIMIT OF SOIL DISTURBANCE
		PROPOSED FENCE
		STORM MANHOLE
		FIRE HYDRANT
		PROPOSED CURB & GUTTER

REVISIONS
NO.
DATE
UNTIL SUCH TIME AS THESE DRAWINGS ARE APPROVED BY THE APPROPRIATE REVIEWING AGENCIES, INC. APPROVES THEIR USE ONLY FOR THE PURPOSES DESIGNATED BY WRITTEN AUTHORIZATION.

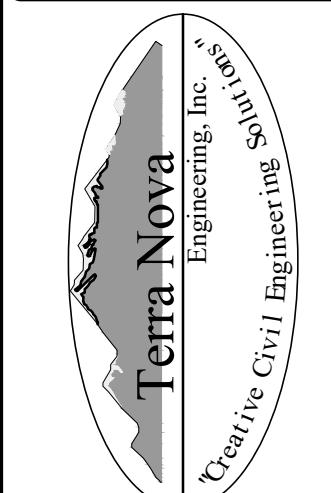PREPARED FOR:
RMG-ROCKY MOUNTAIN GROUP
ATTN: 5085 LIST DR, #200
COLORADO SPRINGS, CO 80919
719.548.0600



271 S. 28TH STREET
COLORADO SPRINGS, CO 80904
OFFICE: 719-535-6422
FAX: 719-535-6426
www.tresinc.com


PLATTE SELF STORAGE
GRADING AND EROSION CONTROL PLAN
INITIAL - SOUTH SIDE

NOTES

1. THERE IS LITTLE TO NO NOTABLE EXISTING VEGETATION LOCATED ON SITE.
2. THERE WILL BE OFFSITE EARTHWORK FOR THE PROPOSED UTILITIES AND GRADING WITHIN THE PLATTE AVENUE FRONTAGE ROAD RIGHT-OF-WAY.
3. THE COUNTY HAS REQUIRED AN INITIAL GRADING PLAN. THIS INITIAL GRADING IS A POOR FIT FOR THE PROPOSED SITE DUE TO THE LARGE NUMBER OF TALL RETAINING WALLS PROPOSED. THE DESIGN ENGINEER DOES NOT CONSIDER MATCHING THE INITIAL GRADING PLAN TO BE CRITICAL AND RECOMMENDS THE CONTRACTOR PRIORITIZE CONSTRUCTION OF THE RETAINING WALLS AND THE VERTICAL GRADING PLAN OVER THE INITIAL GRADING PLAN.
4. SEDIMENT CONTROL LOGS MAY BE SUBSTITUTED FOR SILT FENCE AND VICE VERSA.

EROSION CONTROL LEGEND

KEY	TITLE	SYMBOL	IMPLEMENTATION PHASE
SF	SILT FENCE	— SF —	INITIAL
SSA	STABILIZED STAGING AREA	[Hatched Box]	INITIAL
VTC	VEHICLE TRACKING CONTROL	[Hatched Pattern]	INITIAL
SP	STOCKPILE MANAGEMENT WITH PROTECTION	[Hatched Box with Protection]	INITIAL
CWA	CONCRETE WASHOUT AREA	[Oval]	INITIAL
SR	SURFACE ROUGHENING	[Hatched Surface]	INITIAL
TSB	TEMPORARY SEDIMENT BASIN	NONE	INITIAL
PT	PORTABLE TOILET	NONE	INITIAL

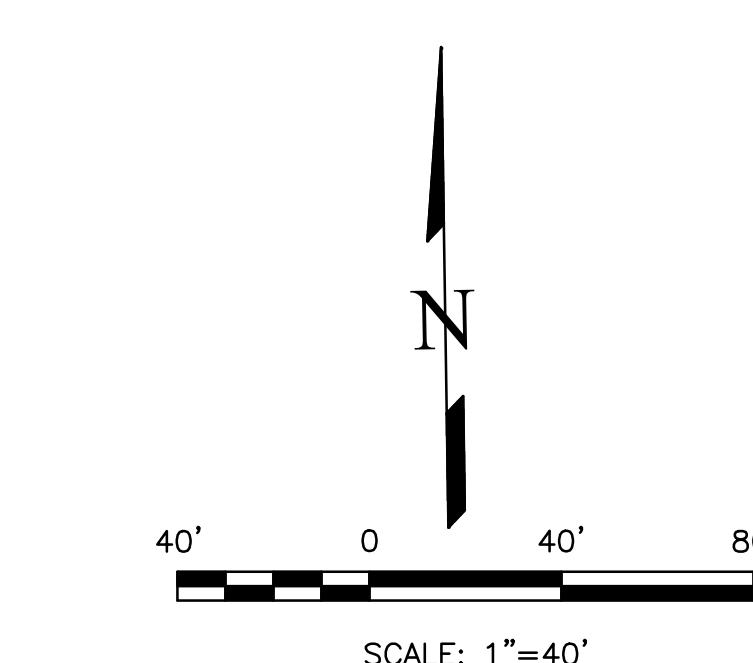

THIS DESIGN WAS PREPARED UNDER MY DIRECT SUPERVISION FOR AND ON BEHALF OF TERRA NOVA ENGINEERING, INC.

DANE FRANK
COLORADO P.E. # 50207

DESIGNED BY JF
DRAWN BY JF
CHECKED BY DF
H-SCALE AS SHOWN
V-SCALE N/A
JOB NO. 2419.00
DATE ISSUED 01/15/25
SHEET NO. 9 OF 28



PLATTE SELF STORAGE


GRADING AND EROSION CONTROL PLAN

INITIAL GRADING & EROSION CONTROL - EAST SIDE

JANUARY 2025

BENCHMARKS

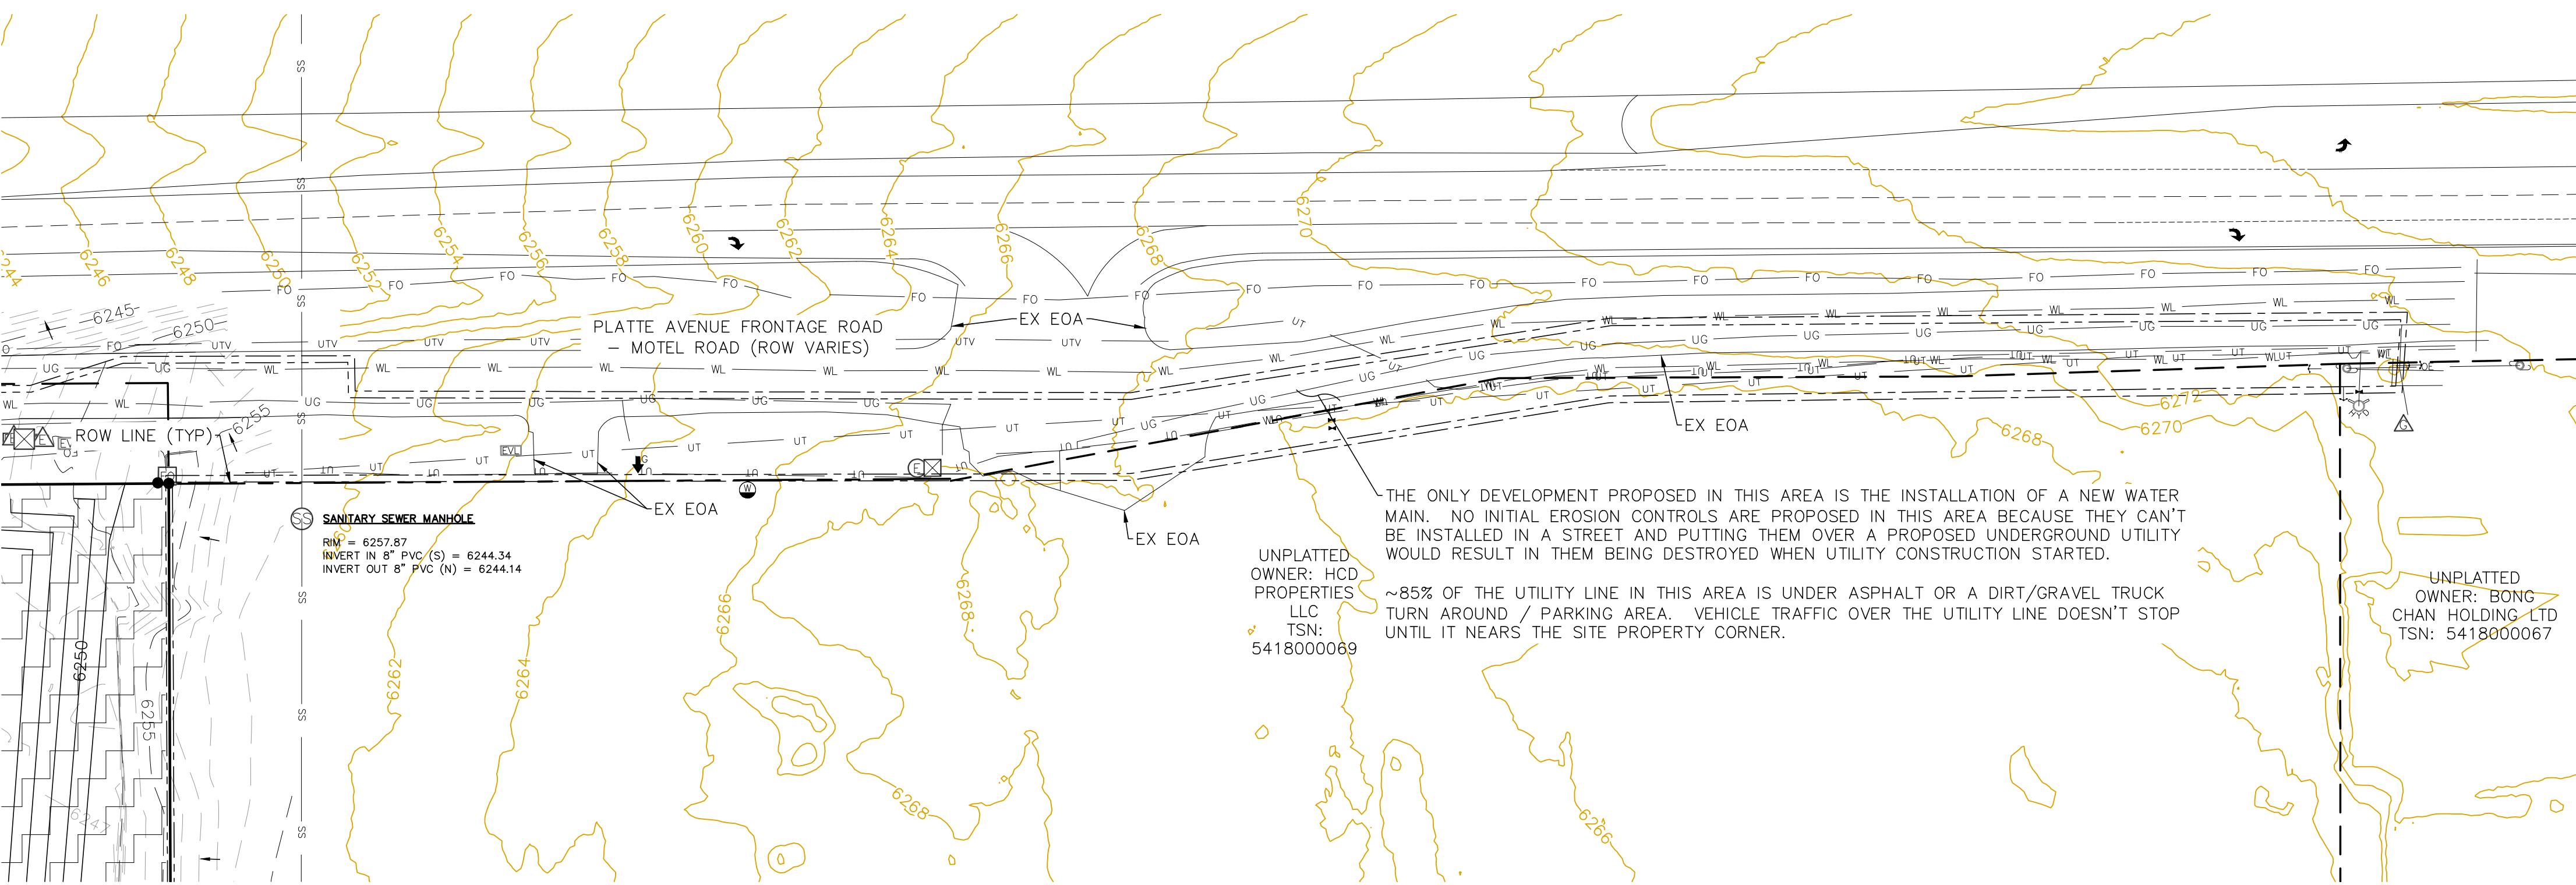CDOT RIGHT OF WAY MONUMENT #3014 – ELEV=6232.52 (NAVD-1988) [NORTHEAST OF SITE ENTRANCE]



PLATTE SELF STORAGE

GRADING AND EROSION CONTROL PLAN

INTERIM EC PLAN - NORTH SIDE

BENCHMARKS

CDOT RIGHT OF WAY MONUMENT #3014 – ELEV=6232.52 (NAVD-1988) [NORTHEAST OF SITE ENTRANCE]

JANUARY 2025

This detailed construction site plan illustrates a complex project area with the following key features and labels:




- UNPLATTED OWNER: DEPARTMENT OF TRANSPORTATION TSN: 5418000006**
- CONSTRUCTION SITE BOUNDARY**: Indicated by a blue line.
- FEMA FLOODWAY ZONE AF**: Shaded blue area representing the floodway zone.
- LIMITS OF DISTURBANCE = 19.5 AC**: The area within the construction site boundary.
- STORMWATER POND USE AS TEMP SEDIMENT BASIN DURING CONSTRUCTION (TSB)**: Located in the lower left corner.
- 1051 LF SILT FENCE (SF)**: Located along the bottom left boundary.
- 30 LF SEDIMENT CONTROL LOG (SCL)**: Located near the top center.
- 20 LF SEDIMENT CONTROL LOG (SCL)**: Located near the top center.
- PLATTE AVENUE FRONTAGE ROAD - MOTEL ROAD (ROW VARIES)**: Labeled as a road feature.
- 20' X 75' VEHICLE TRACKING CONTROL AREA (VTC)**: Shaded areas labeled VTC.
- CONCRETE WASHOUT AREA (CWA)**: Shaded area labeled CWA.
- PORTABLE TOILET (PT)**: Located in the center-left area.
- PR GRASS**: Shaded areas labeled PR GRASS.
- MATERIALS STABILIZED STAGING AREA (SSA)**: Shaded area labeled SSA.
- STOCKPILE AREA W/ 562 LF SILT FENCE (SP)**: Shaded area labeled SP.
- PR VALLEY PAN (TYP)**: Shaded area labeled PR VALLEY PAN (TYP).
- 1146 LF SILT FENCE (SF)**: Located at the bottom center.
- UNPLATTED OWNER: HCD PROPERTIES LLC TSN: 5418000069**: Located on the right side.

The plan also includes contour lines, elevation markers (e.g., 6198, 6200, 6202, 6204, 6205, 6206, 6208, 6210, 6215, 6218, 6220, 6222, 6225, 6228, 6230, 6235, 6238, 6240, 6244, 6245, 6250, 6254, 6255), and various symbols for utility lines and structures.

GRADING LEGEND

PROPOSED	PR	EXISTING CONTOURS – MINOR	— — — 6231 — — —
EXISTING	EX	EXISTING CONTOURS – MAJOR	— — — 6230 — — —
FINISHED SURFACE	FS	PROPOSED CONTOURS – 1'	— — — 6231 — — —
FINISHED GROUND	FG	EXISTING PROPERTY LINE	—————
TOP OF CURB	TC	PROPOSED RET WALL	~~~~~
FLOWLINE	FL	PROPOSED RIPRAP	████████████████
FINISH GROUND AT TOP OF WALL	TW	WATER LINE	— w — w —
FINISHED GROUND AT BOTTOM OF WALL	BW	SANITARY SEWER LINE	— ss — ss —
LOW POINT	LP	GAS LINE	— ug — ug —
HIGH POINT	HP	UNDERGROUND ELECTRICAL LINE	— ue — ue —
FLOW ARROW	←	TELEPHONE LINE	— ut — — —
EXISTING CONTOURS (LiDAR)	6130	FIBER OPTIC LINE	— fo — fo —
STORM MANHOLE	○	STORM SEWER LINE	— st — st —
STORM INLET	□	LIMIT OF CONSTRUCTION	— — — — — —
		LIMIT OF SOIL DISTURBANCE	— — — — — —
		PROPOSED FENCE	— o — o — o — o
		FIRE HYDRANT	████████
		PROPOSED CURB & GUTTER	—————

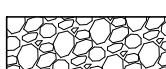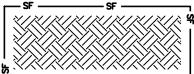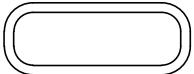EROSION CONTROL LEGEND

<u>KEY</u>	<u>TITLE</u>	<u>SYMBOL</u>	<u>IMPLEMENTATION PHASE</u>
	SILT FENCE	— SF —	INITIAL
	STABILIZED STAGING AREA		INITIAL
	VEHICLE TRACKING CONTROL		INITIAL
	STOCKPILE MANAGEMENT WITH PROTECTION		INITIAL
	CONCRETE WASHOUT AREA		INITIAL
	TEMPORARY SEDIMENT BASIN	NONE	INITIAL
	PORTABLE TOILET	NONE	INITIAL
	SEDIMENT CONTROL LOG	— SCL —	INTERIM
	INLET PROTECTION		INTERIM

NOTES

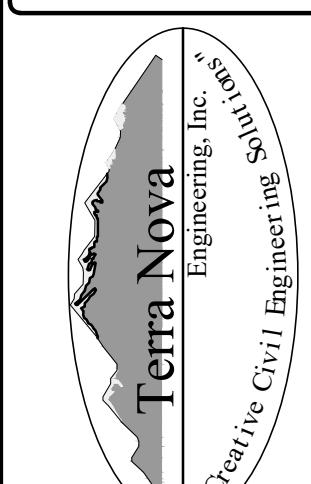
- NOTES**

 1. SEDIMENT CONTROL LOGS MAY BE SUBSTITUTED FOR SILT FENCE AND VICE VERSA.
 2. SEED AND MULCH DISTURBED AREAS ONLY.
 3. THERE IS LITTLE TO NO NOTABLE EXISTING VEGETATION LOCATED ON SITE.
 4. THERE WILL BE OFFSITE EARTHWORK FOR THE PROPOSED UTILITIES AND GRADING WITHIN THE PLATTE AVENUE FRONTAGE ROAD RIGHT OF WAY.

THIS DESIGN WAS PREPARED UNDER MY DIRECT SUPERVISION
FOR AND ON BEHALF OF TERRA NOVA ENGINEERING, INC.

DANE FRANK
COLORADO P.E. # 50207

PREPARED FOR:
ATTN:
5085 LIST DR,
#²
COLORADO SPRINGS, CO
719.548.0600



PLATTE SELF STORAGE

GRADING AND EROSION CONTROL PLAN INTERIM EROSION CONTROL PLAN – NORTH SIDE


DESIGNED BY JF	
DRAWN BY	JF
CHECKED BY DF	
H-SCALE	AS SHOWN
V-SCALE	N/A
JOB NO. 2419.00	
DATE ISSUED 01/15/25	
SHEET NO.	11 OF 28

PLATTE SELF STORAGE

GRADING AND EROSION CONTROL PLAN

INTERIM EC PLAN - SOUTH SIDE

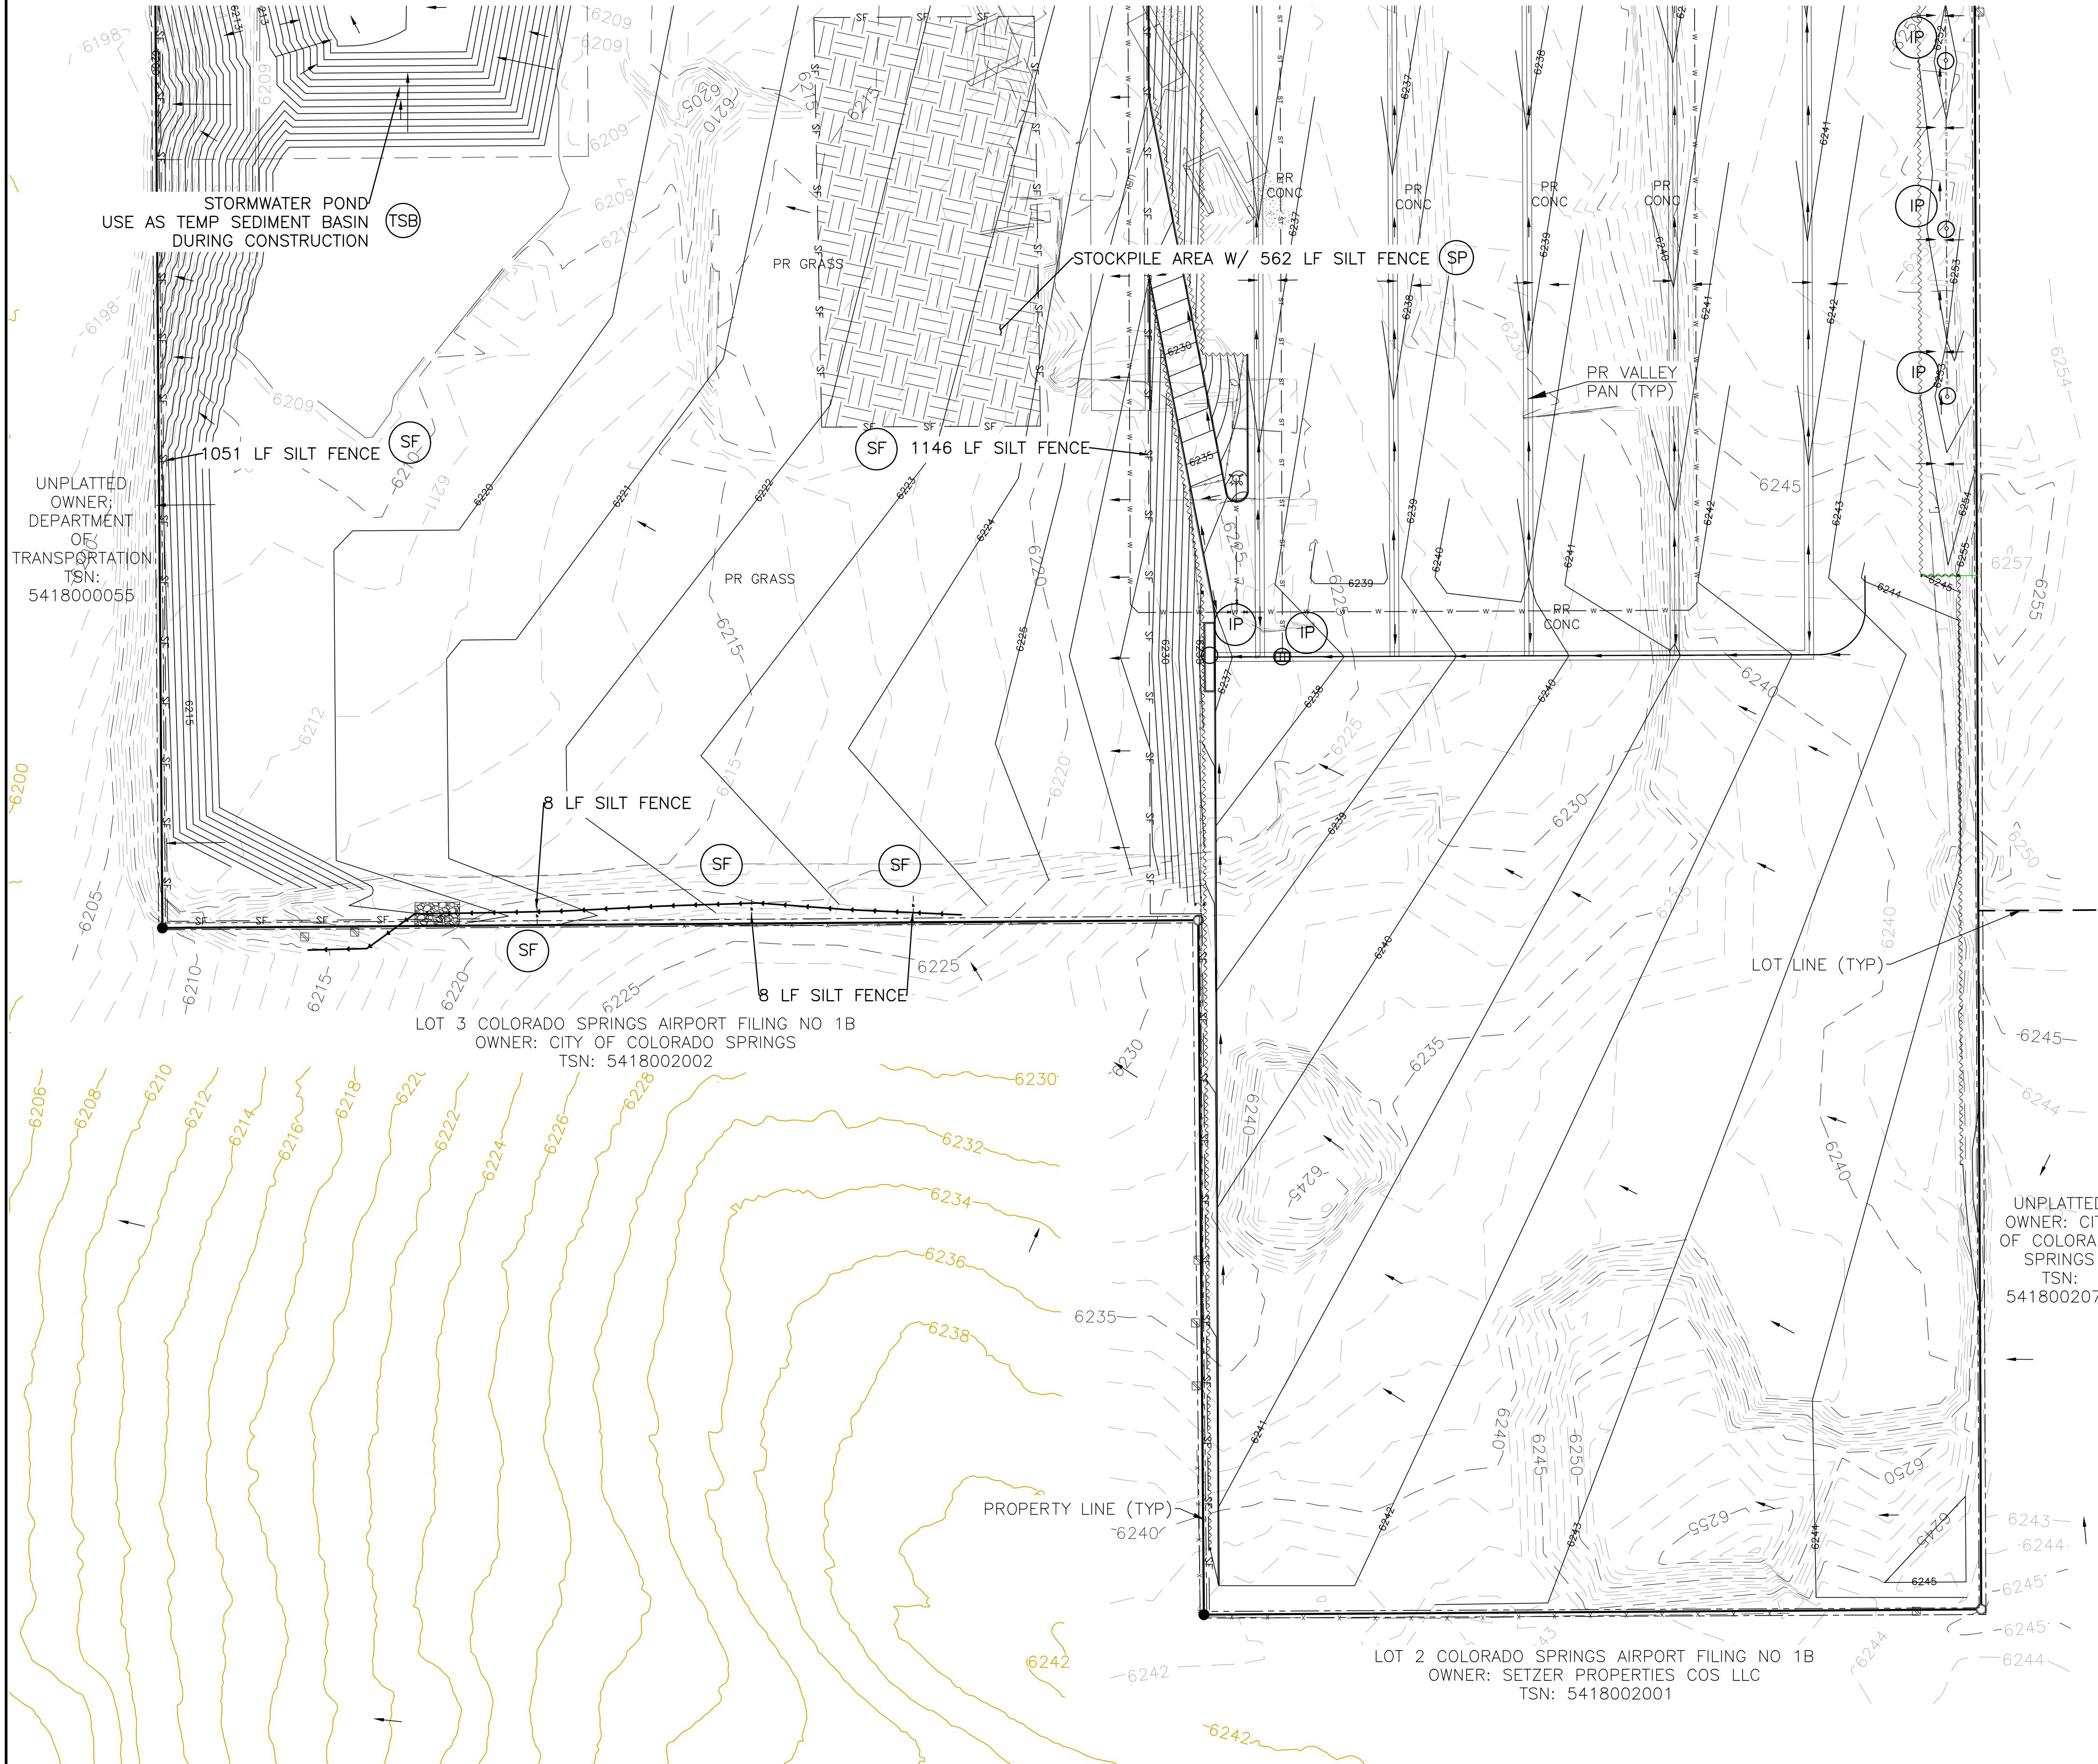JANUARY 2025



PLATTE SELF STORAGE

GRADING AND EROSION CONTROL PLAN

FINAL EC PLAN - NORTH SIDE

JANUARY 2025

BENCHMARKS

CDOT RIGHT OF WAY MONUMENT #3014 – ELEV=6232.52 (NAVD-1988) [NORTHEAST OF SITE ENTRANCE]

GRADING LEGEND

PROPOSED	PR	EXISTING CONTOURS – MINOR
EXISTING	EX	EXISTING CONTOURS – MAJOR
FINISHED SURFACE	FS	PROPOSED CONTOURS – 1'
FINISHED GROUND	FG	EXISTING PROPERTY LINE
TOP OF CURB	TC	PROPOSED RET WALL
FLOWLINE	FL	PROPOSED RIPRAP
WATER LINE		
FINISH GROUND AT TOP OF WALL	TW	SANITARY SEWER LINE
GAS LINE		
UNDERGROUND ELECTRICAL LINE		
FINISHED GROUND AT BOTTOM OF WALL	BW	TELEPHONE LINE
FIBER OPTIC LINE		
LOW POINT	LP	STORM SEWER LINE
HIGH POINT	HP	LIMIT OF CONSTRUCTION
FLOW ARROW	←	LIMIT OF SOIL DISTURBANCE
EXISTING CONTOURS (LiDAR)	6130	PROPOSED FENCE
STORM MANHOLE	○	FIRE HYDRANT
STORM INLET	□	PROPOSED CURB & GUTTER
		CUT/FILL BOUNDARY

NO. _____
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REVIEWING AGENCIES,
TERRA NOVA ENGINEERING,
INC. APPROVES THEIR USE
ONLY FOR THE
PURPOSES DESIGNATED BY
WRITTEN AUTHORIZATION.

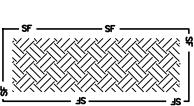
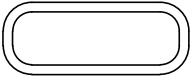
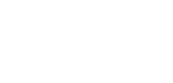
FOR: MOUNTAIN GROUP
R, #200
GS, CO 80919
D600

PREPARED FOR:
RMG-ROCKY MOUNTAIN
ATTN:
5085 LIST DR,
COLORADO SPRINGS,
719.548.060

The logo for Terra Nova Engineering, Inc. features a large, stylized graphic of a mountain range or coastline on the left side. The mountains are depicted with dark grey peaks and lighter grey slopes. A thick horizontal line runs across the center of the graphic, separating it from the company name. To the right of this line, the word "Terra" is written vertically in a bold, sans-serif font. Below it, "Nova" is also written vertically in a slightly smaller font. To the right of the "Nova" text, there is a vertical stack of three overlapping semi-transparent circles. The top circle is light blue, the middle is light green, and the bottom is light orange. To the right of these circles, the words "Engineering, Inc." are stacked vertically in a small, thin font. To the right of "Engineering, Inc.", the word "Solutions" is written vertically in a large, bold, italicized font. Finally, at the very bottom of the logo, the word "Innovative" is written in a small, thin font.

S. 23RD STREET
ORRADO SPRINGS, CO 80904
CE: 719-635-6422
719-635-6426
tnesinc.com

EROSION CONTROL LEGEND

<u>KEY</u>	<u>TITLE</u>	<u>SYMBOL</u>	<u>IMPLEMENTATION PHASE</u>
 SF	SILT FENCE	— SF —	INITIAL
 SSA	STABILIZED STAGING AREA		INITIAL
 VTC	VEHICLE TRACKING CONTROL		INITIAL
 SP	STOCKPILE MANAGEMENT WITH PROTECTION		INITIAL
 CWA	CONCRETE WASHOUT AREA		INITIAL
 TSB	TEMPORARY SEDIMENT BASIN	NONE	INITIAL
 PT	PORTABLE TOILET	NONE	INITIAL
 SCL	SEDIMENT CONTROL LOG	— SCL —	INTERIM
 IP	INLET PROTECTION		INTERIM
 SM	PERMANENT SEEDING AND MULCHING PS – DRILL SEED, HAND SEED, OR HYDROSEED; SEED MIX PER COLORADO SPRINGS STORMWATER CONSTRUCTION MANUAL (DECEMBER 2020), TABLE 5-2 MU – MECHANICALLY CRIMP MULCH OR HYDROMULCH		FINAL

NOTES

- NOTES**

 1. SEDIMENT CONTROL LOGS MAY BE SUBSTITUTED FOR SILT FENCE AND VICE VERSA.
 2. SEED AND MULCH DISTURBED AREAS ONLY.
 3. THERE IS LITTLE TO NO NOTABLE EXISTING VEGETATION LOCATED ON SITE.
 4. THERE WILL BE OFFSITE EARTHWORK FOR THE PROPOSED UTILITIES AND GRADING WITHIN THE PLATTE AVENUE FRONTAGE ROAD RIGHT-OF-WAY.

THIS DESIGN WAS PREPARED UNDER MY DIRECT SUPERVISION
FOR AND ON BEHALF OF TERRA NOVA ENGINEERING, INC.


DANE FRANK
COLORADO P.E. # 50207

PLATE SELF STORAGE

GRADING AND EROSION CONTROL PLAN VERTICAL EROSION CONTROL PLAN – NORTH SIDE

SIGNED BY JF
AWN BY JF
ECKED BY DF
SCALE AS SHOWN
SCALE N/A
B NO. 2419.00
TE ISSUED 01/15/25
EET NO. 13 OF 28

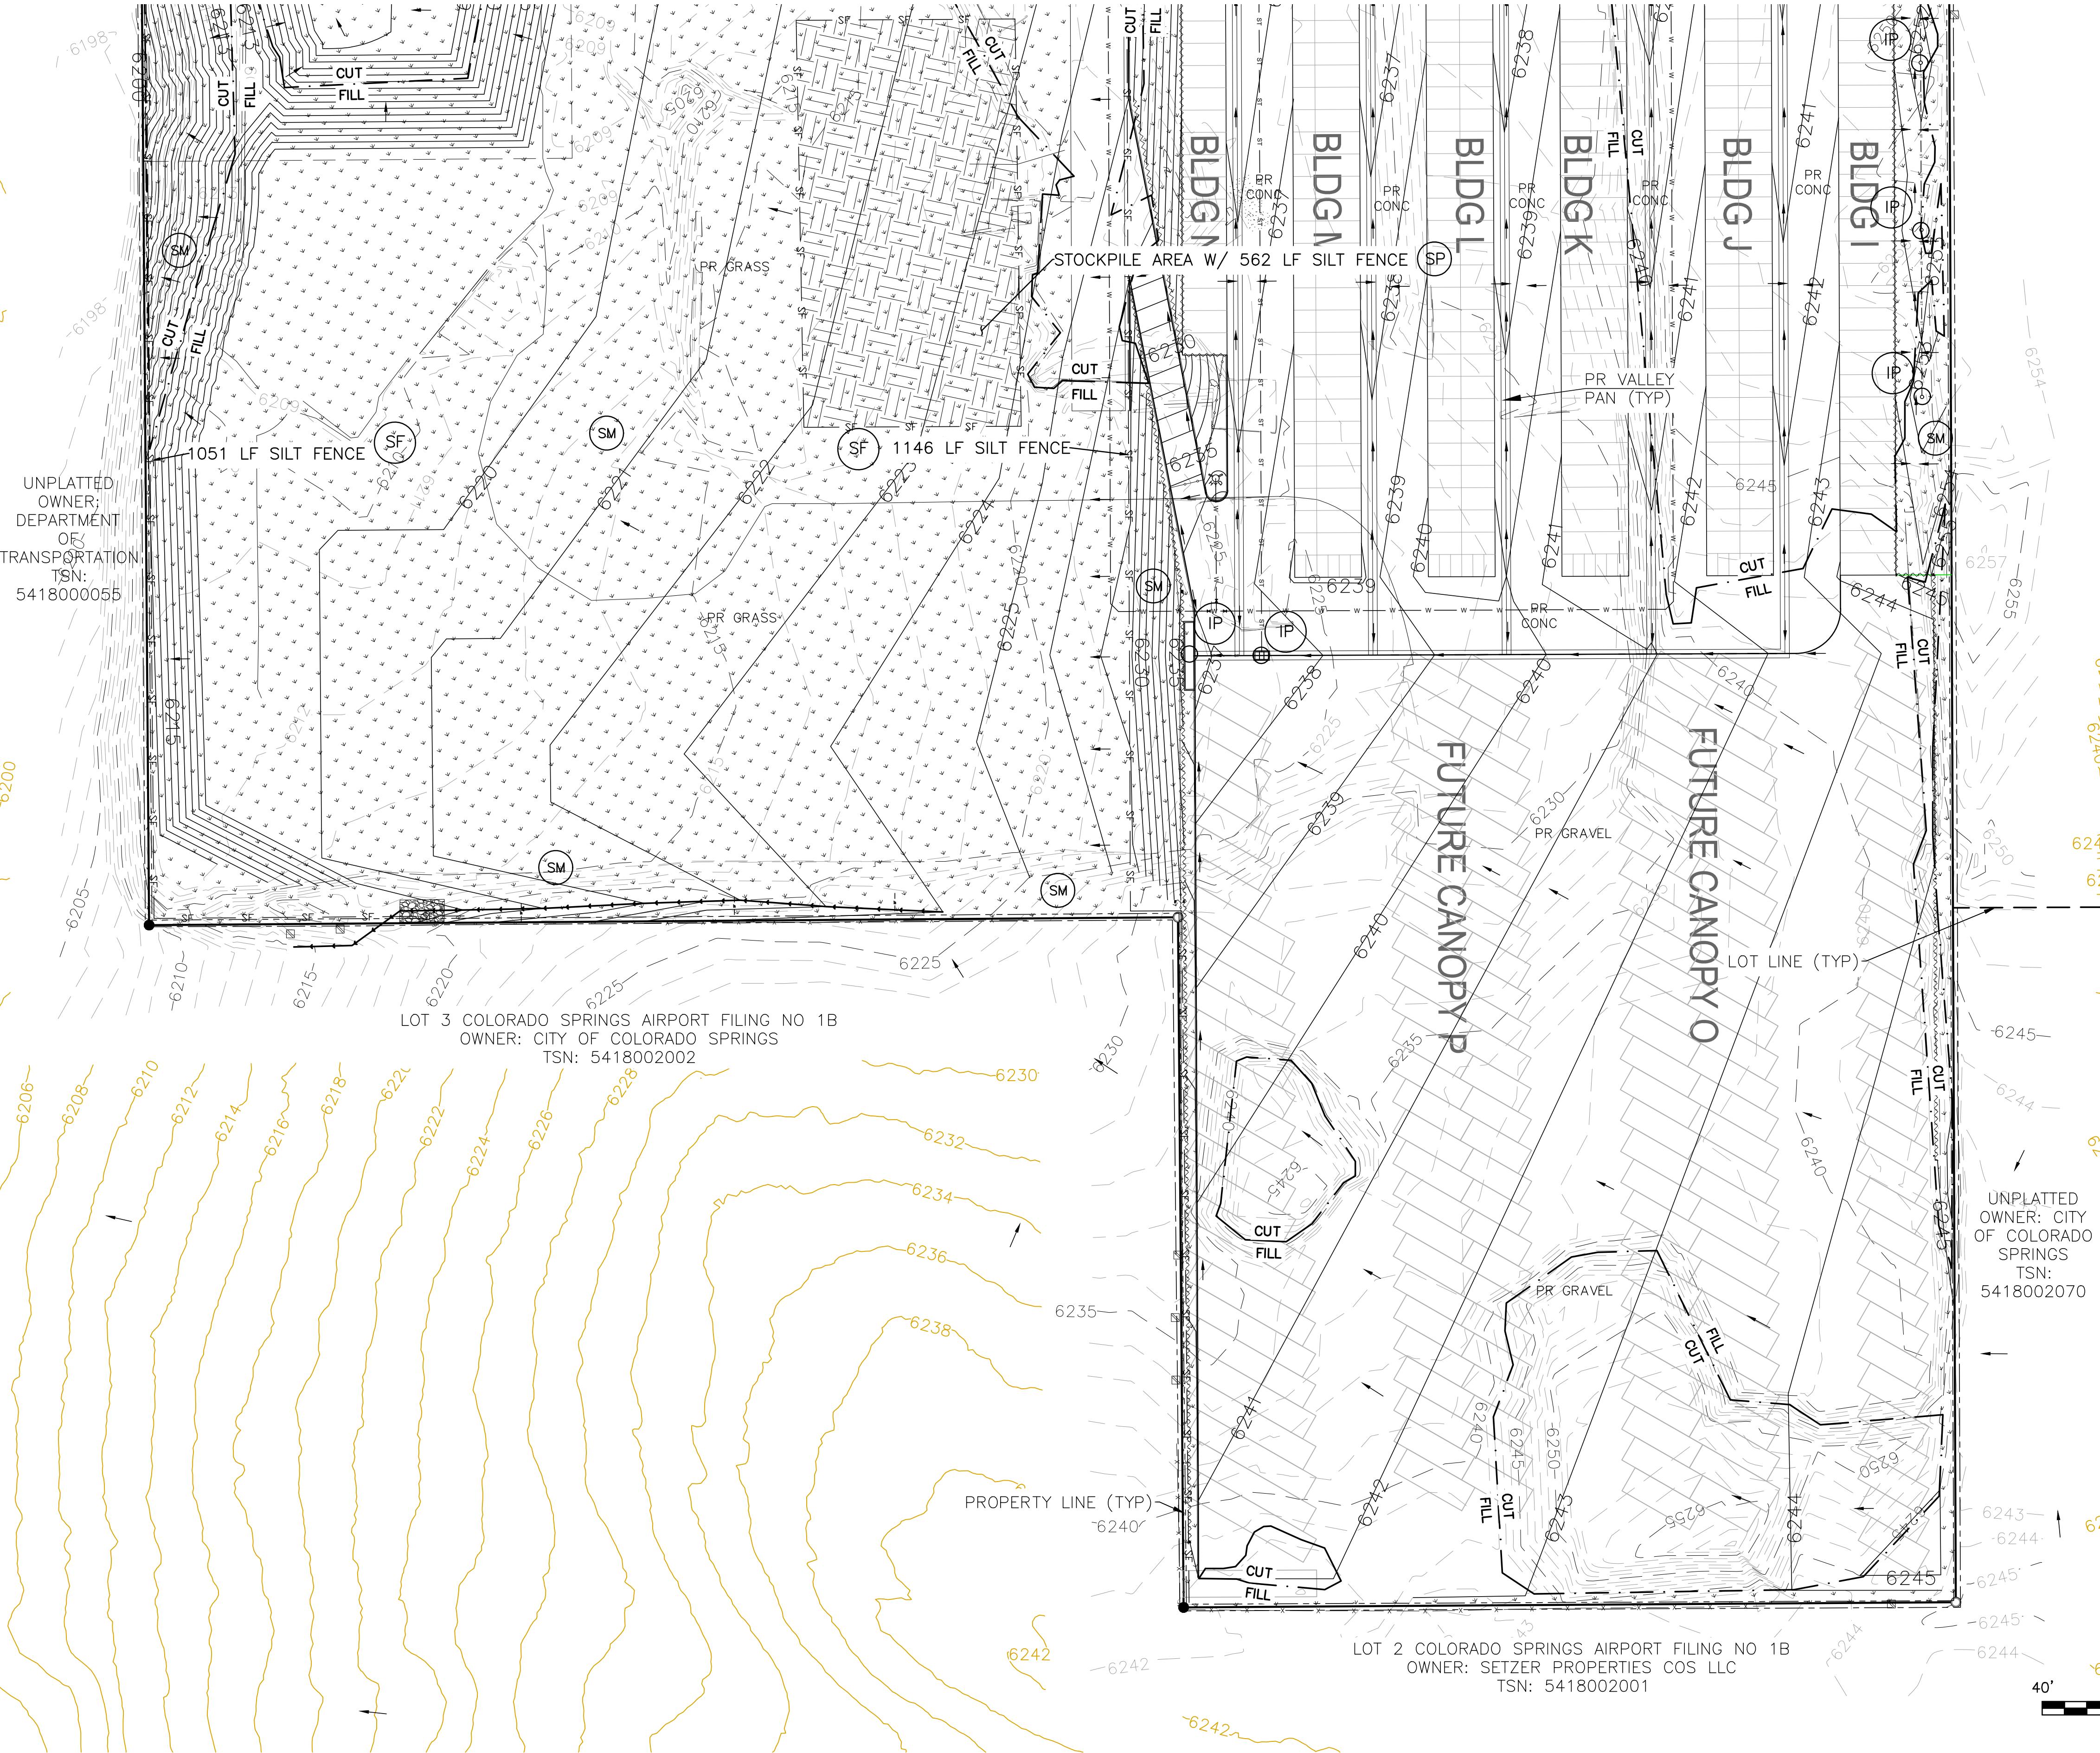**PLATTE SELF STORAGE
GRADING AND EROSION CONTROL PLAN
FINAL EC PLAN - SOUTH SIDE
JANUARY 2025**



BENCHMARKS
CDOT RIGHT OF WAY MONUMENT #3014 – ELEV=6232.52 (NAVD-1988) [NORTHEAST OF SITE ENTRANCE]

GRADING LEGEND

PROPOSED	PR	EXISTING CONTOURS - MINOR
EXISTING	EX	EXISTING CONTOURS - MAJOR
FINISHED SURFACE	FS	PROPOSED CONTOURS - 1'
FINISHED GROUND	FG	EXISTING PROPERTY LINE
TOP OF CURB	TC	PROPOSED RET WALL
FLOWLINE	FL	PROPOSED RIPRAP
FINISH GROUND AT TOP OF WALL	TW	WATER LINE
PR CONC	PR CONC	SANITARY SEWER LINE
PR CONC	PR CONC	GAS LINE
PR CONC	PR CONC	UNDERGROUND ELECTRICAL LINE
PR CONC	PR CONC	TELEPHONE LINE
PR CONC	PR CONC	FIBER OPTIC LINE
PR CONC	PR CONC	STORM SEWER LINE
LOW POINT	LP	LIMIT OF CONSTRUCTION
HIGH POINT	HP	LIMIT OF SOIL DISTURBANCE
FLOW ARROW	→	PROPOSED FENCE
EXISTING CONTOURS (LIDAR)	6230	STORM MANHOLE
STORM MANHOLE	○	FIRE HYDRANT
STORM INLET	□	PROPOSED CURB & GUTTER
		CUT/FILL BOUNDARY

REVISIONS	DESCRIPTION	DATE
UNTIL SUCH TIME AS THESE DRAWINGS ARE APPROVED BY THE APPROPRIATE REVIEWING AGENCIES, INC. APPROVES THEIR USE ONLY FOR THE PURPOSES DESIGNATED BY WRITTEN AUTHORIZATION.		
PREPARED FOR: RMG-ROCKY MOUNTAIN GROUP ATTN: 5085 LIST DR, #200 COLORADO SPRINGS, CO 80919 719.548.0600		

EROSION CONTROL LEGEND





KEY	TITLE	SYMBOL	IMPLEMENTATION PHASE
SF	SILT FENCE	— SF —	INITIAL
SSA	STABILIZED STAGING AREA	[]	INITIAL
VTC	VEHICLE TRACKING CONTROL	[]	INITIAL
SP	STOCKPILE MANAGEMENT WITH PROTECTION	[]	INITIAL
CWA	CONCRETE WASHOUT AREA	[]	INITIAL
TSB	TEMPORARY SEDIMENT BASIN	NONE	INITIAL
PT	PORTABLE TOILET	NONE	INITIAL
SCL	SEDIMENT CONTROL LOG	— SCL —	INTERIM
IP	INLET PROTECTION	□	INTERIM
PERMANENT SEEDING AND MULCHING			
PS	PS - DRILL SEED, HAND SEED, OR HYDROSEED;		
SM	SEED MIX PER COLORADO SPRINGS STORMWATER CONSTRUCTION MANUAL (DECEMBER 2020), TABLE 5-2		
MU	MU - MECHANICALLY CRIMP MULCH OR HYDROMULCH		

NOTES

1. SEDIMENT CONTROL LOGS MAY BE SUBSTITUTED FOR SILT FENCE AND VICE VERSA.
2. SEED AND MULCH DISTURBED AREAS ONLY.
3. THERE IS LITTLE TO NO NOTABLE EXISTING VEGETATION LOCATED ON SITE.
4. THERE WILL BE OFFSITE EARTHWORK FOR THE PROPOSED UTILITIES AND GRADING WITHIN THE PLATTE AVENUE FRONTAGE ROAD RIGHT-OF-WAY.

THIS DESIGN WAS PREPARED UNDER MY DIRECT SUPERVISION FOR AND ON BEHALF OF TERRA NOVA ENGINEERING, INC.

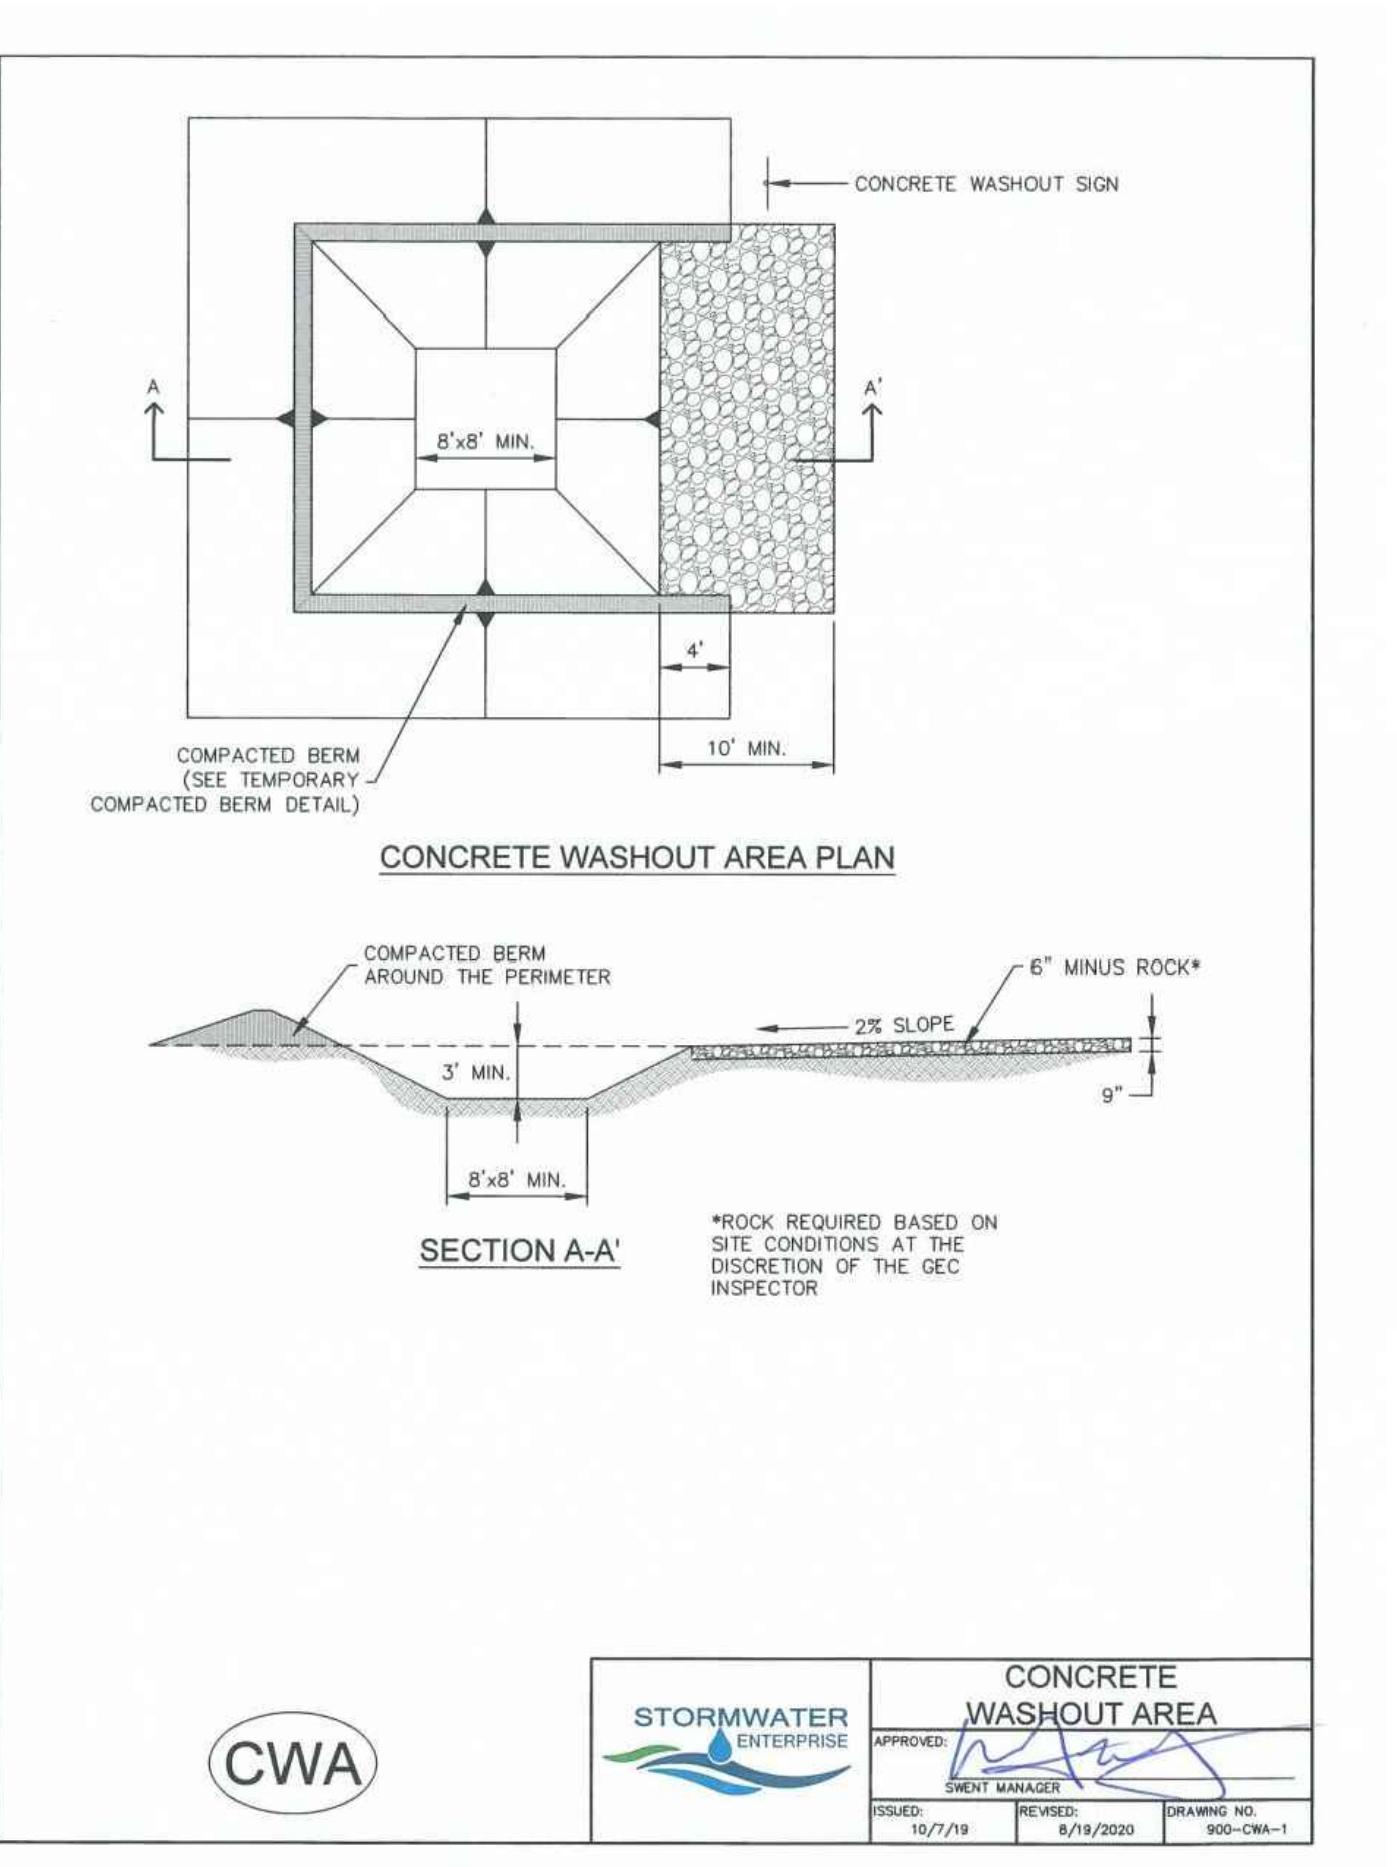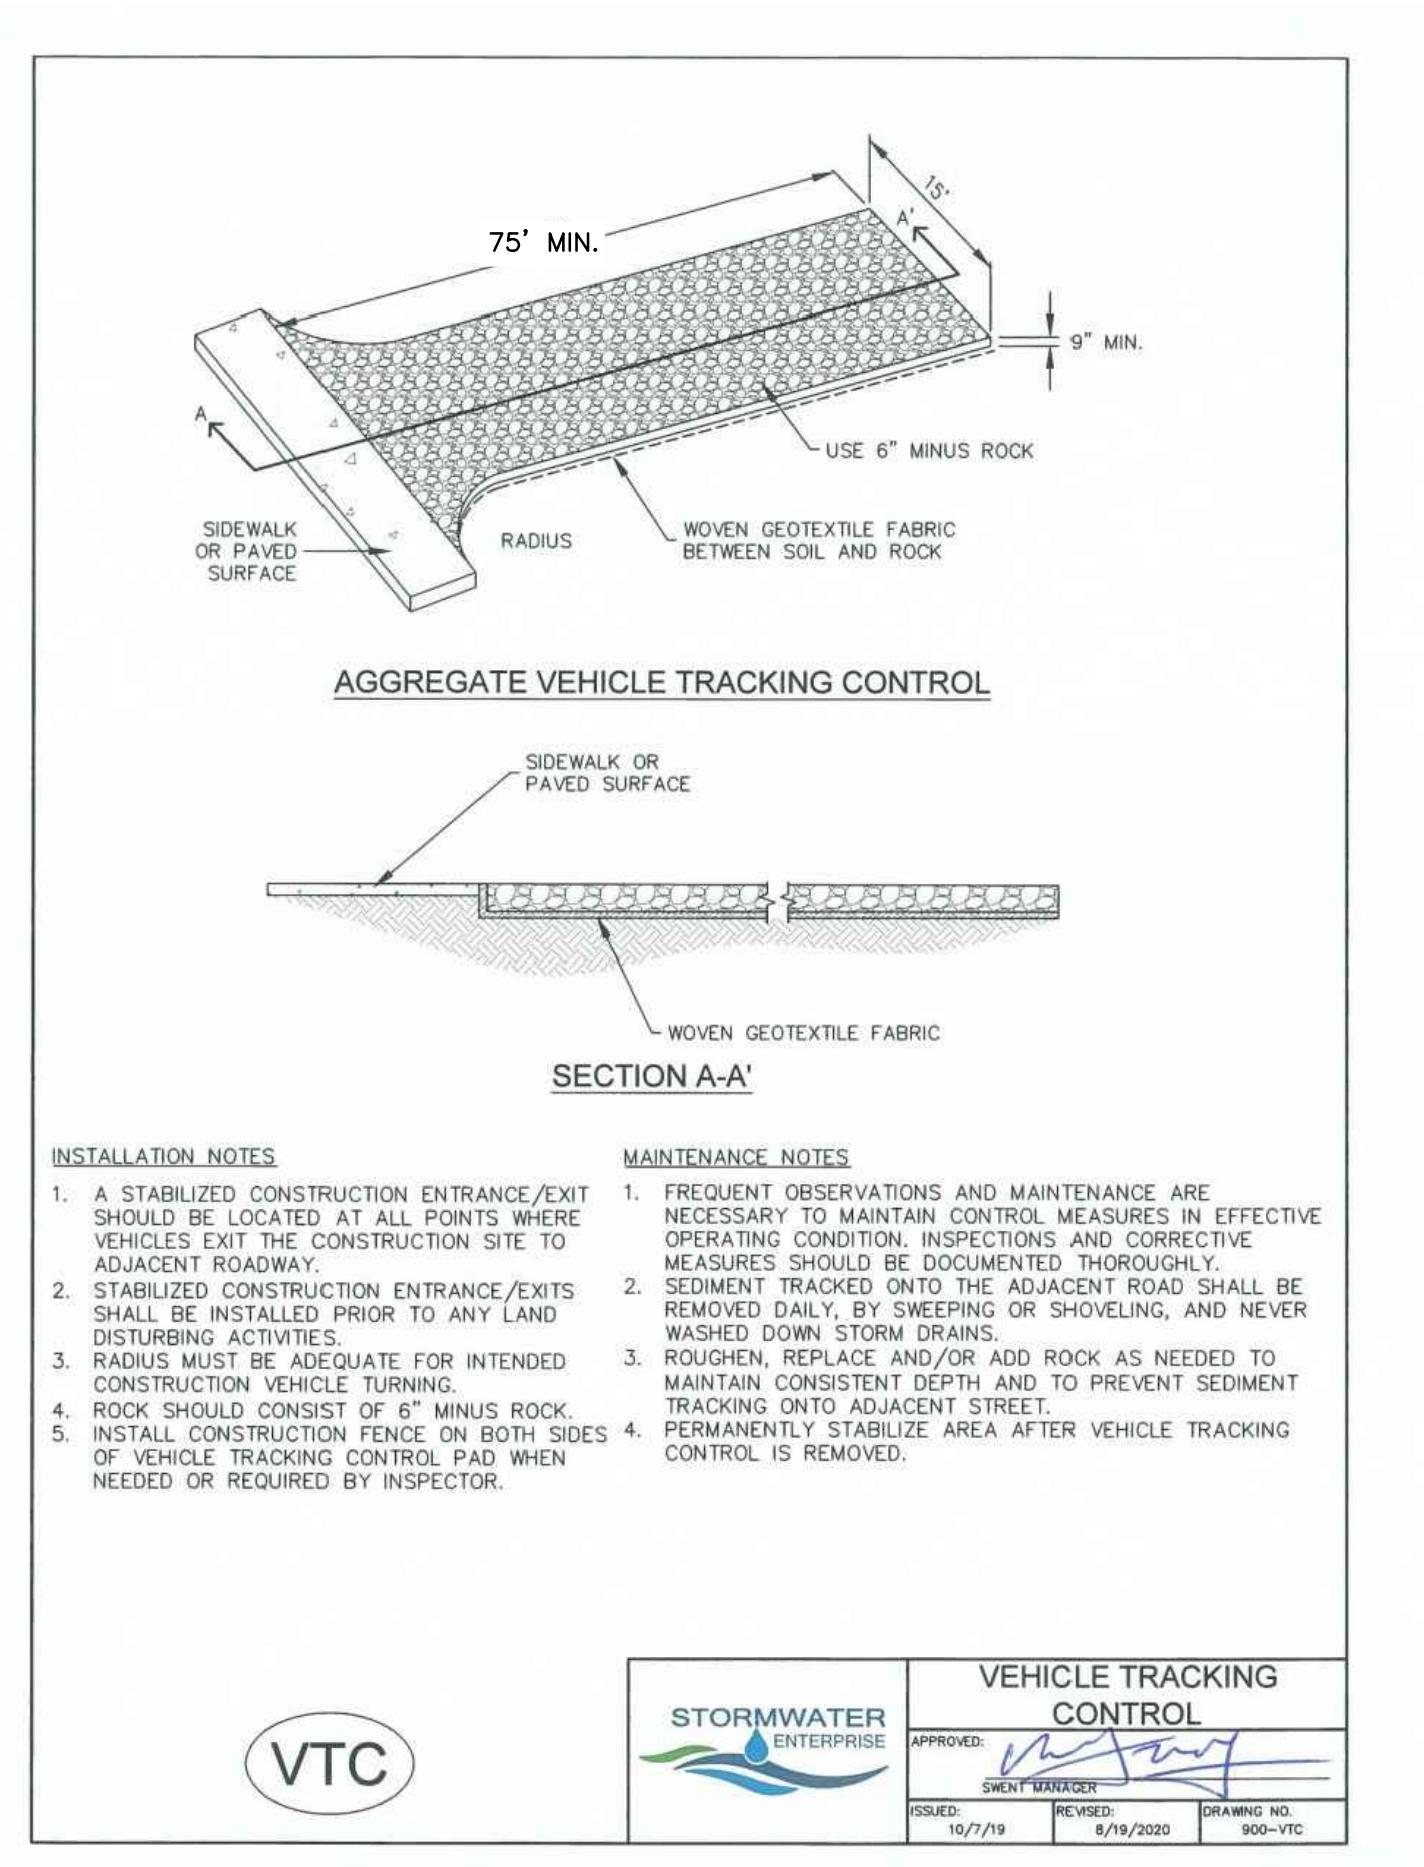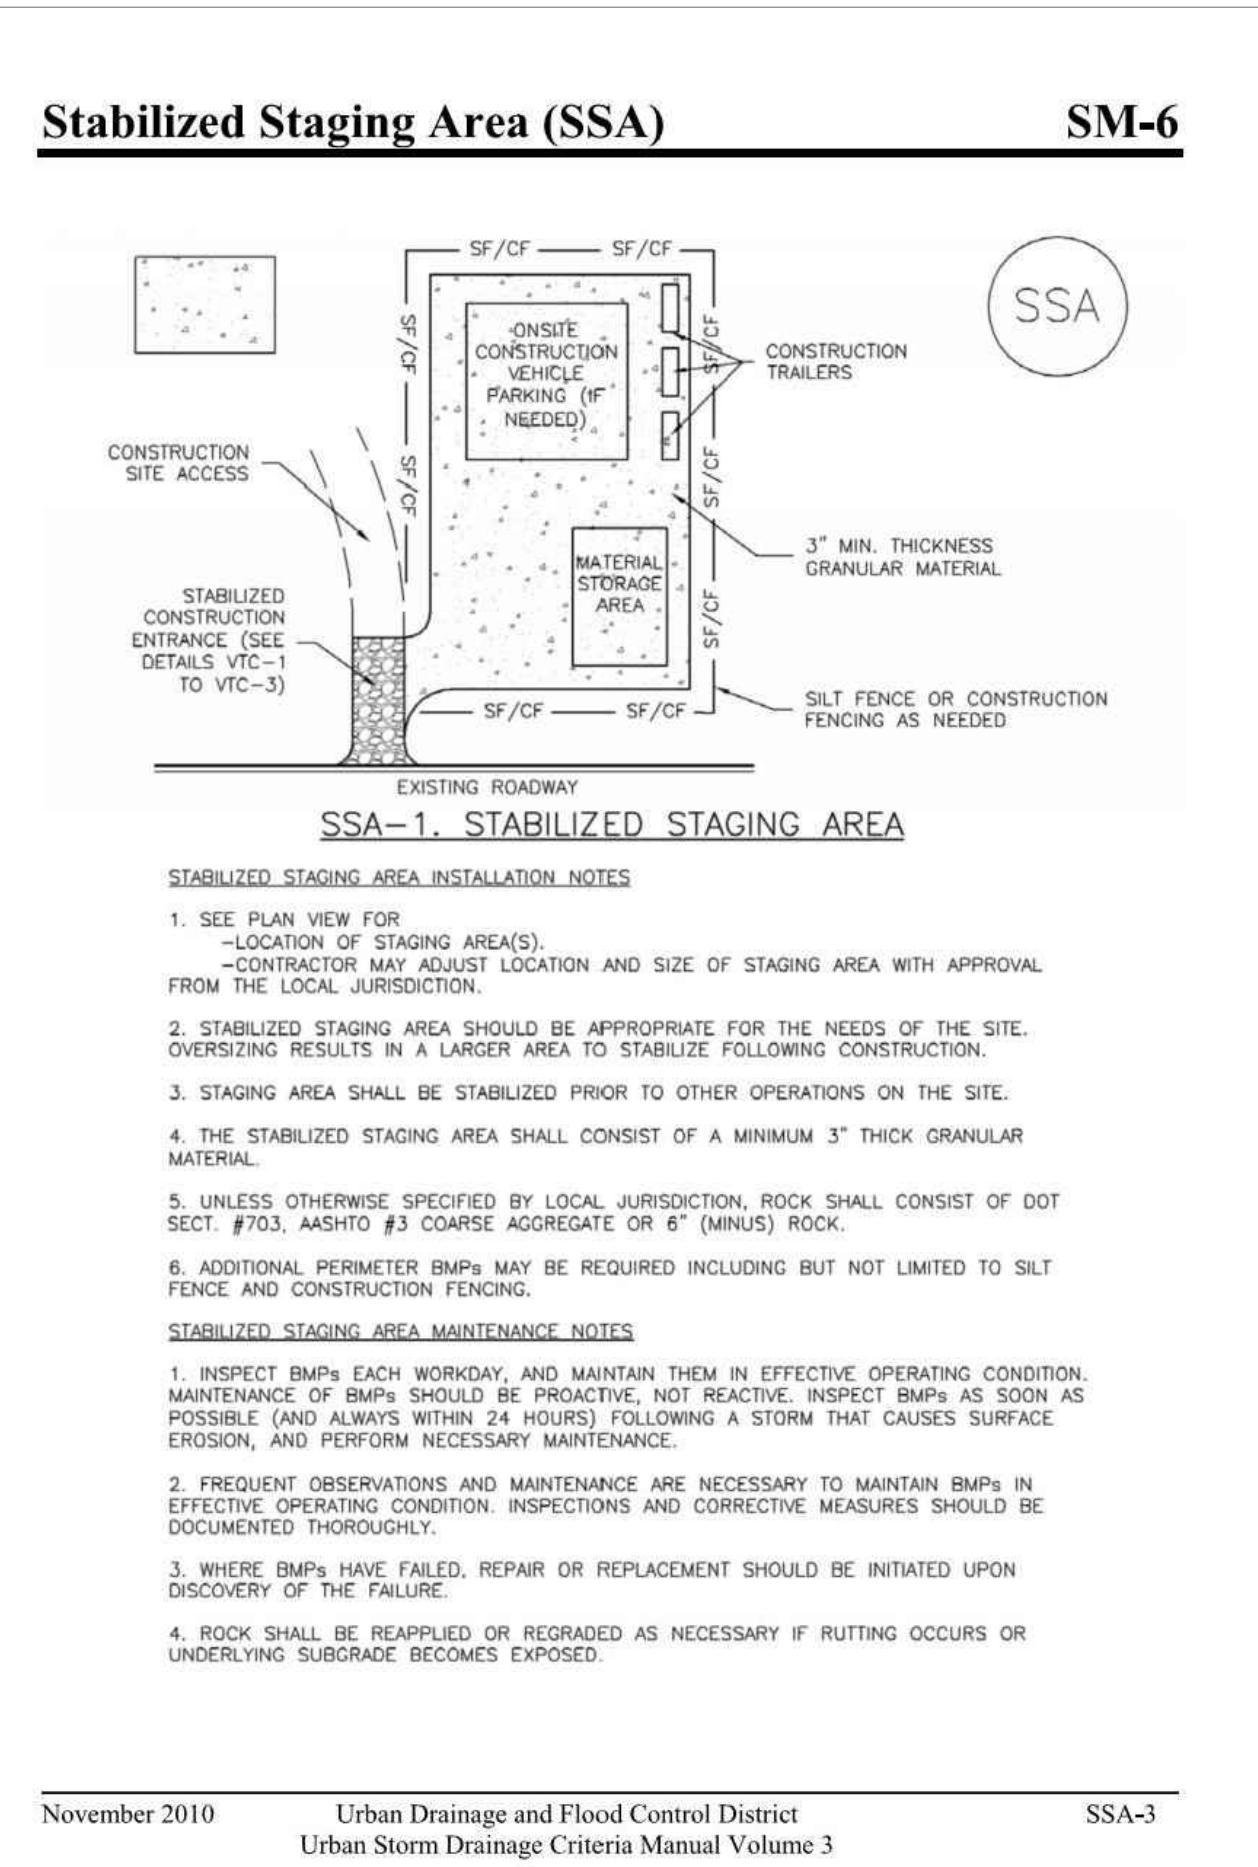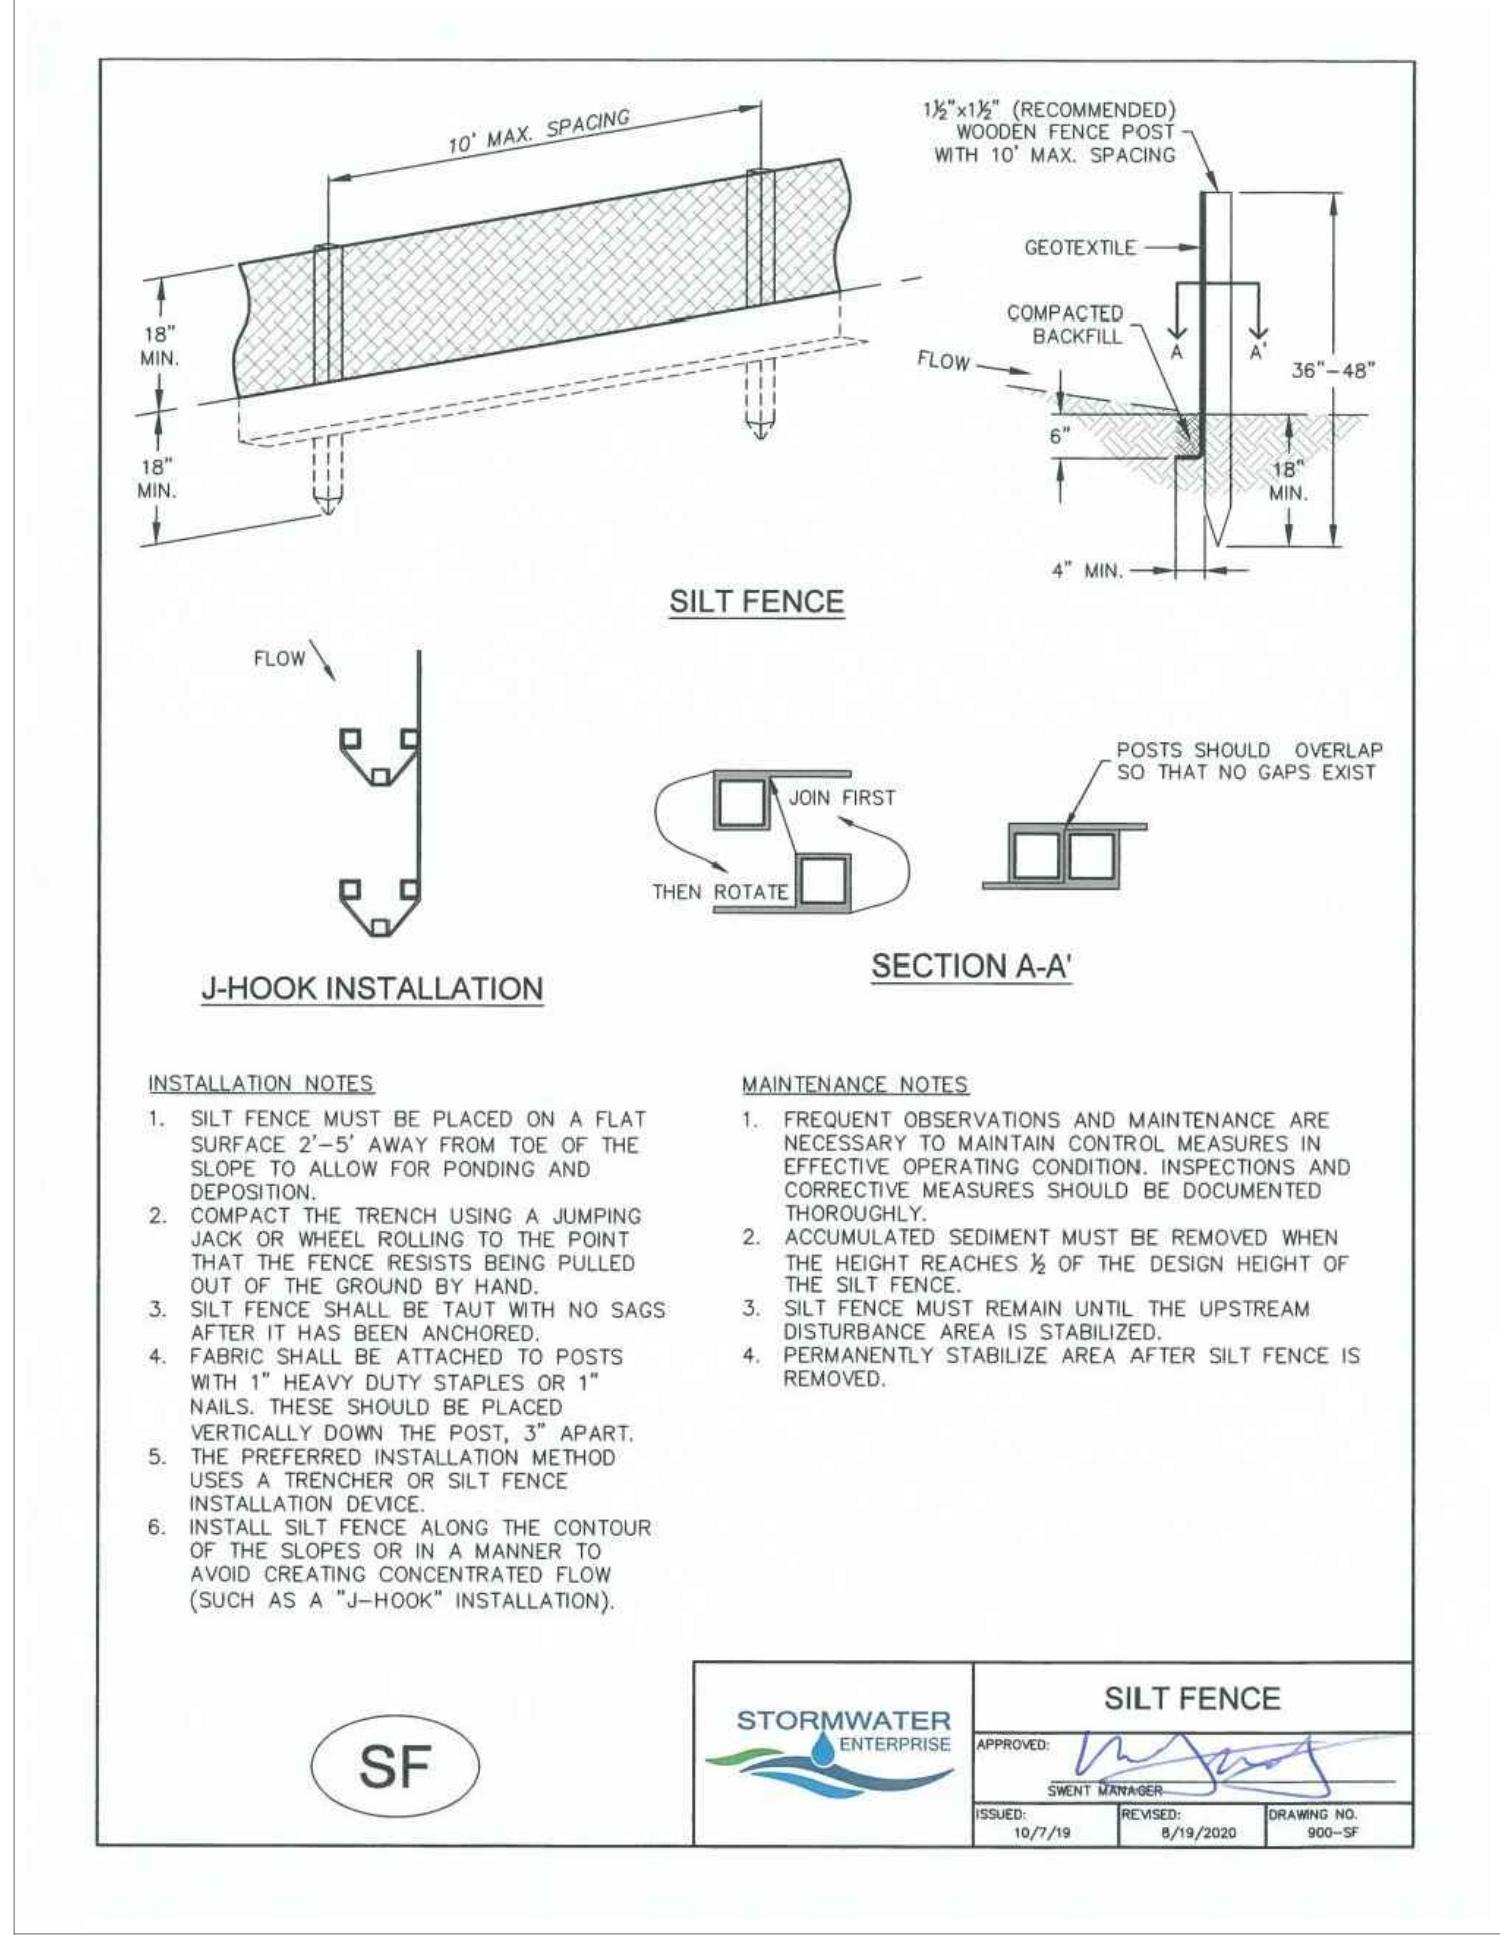DESIGNED BY JF DRAWN BY JF CHECKED BY DF H-SCALE AS SHOWN V-SCALE N/A JOB NO. 2419.00 DATE ISSUED 01/15/25 SHEET NO. 14 OF 28
DANE FRANK COLORADO P.E. # 50207



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RMG-ROCKY MOUNTAIN GROUP
ATTN: 5085 LIST DR, #200
COLORADO SPRINGS, CO 80919
719.548.0600



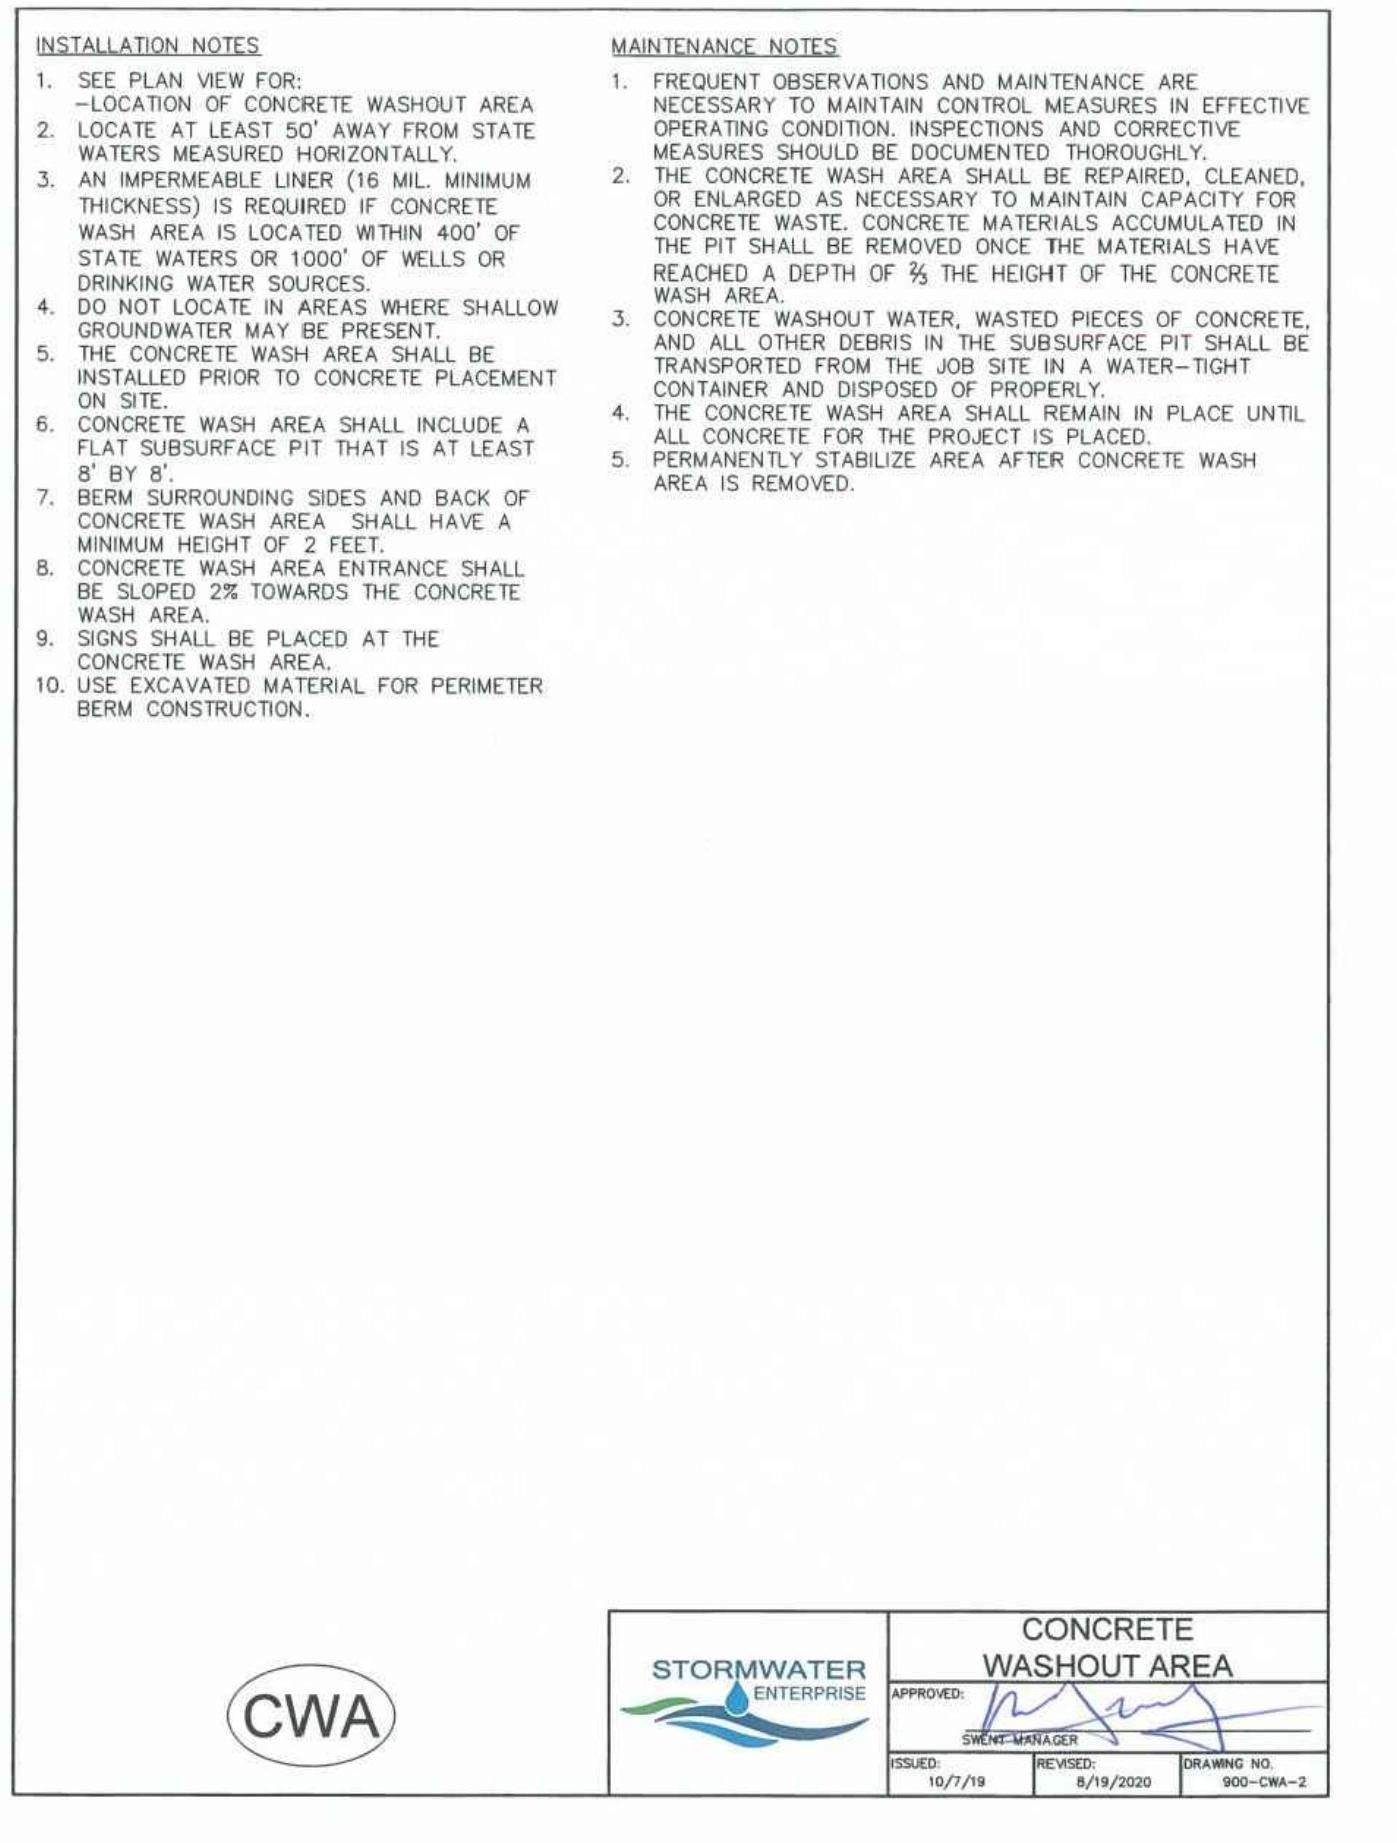
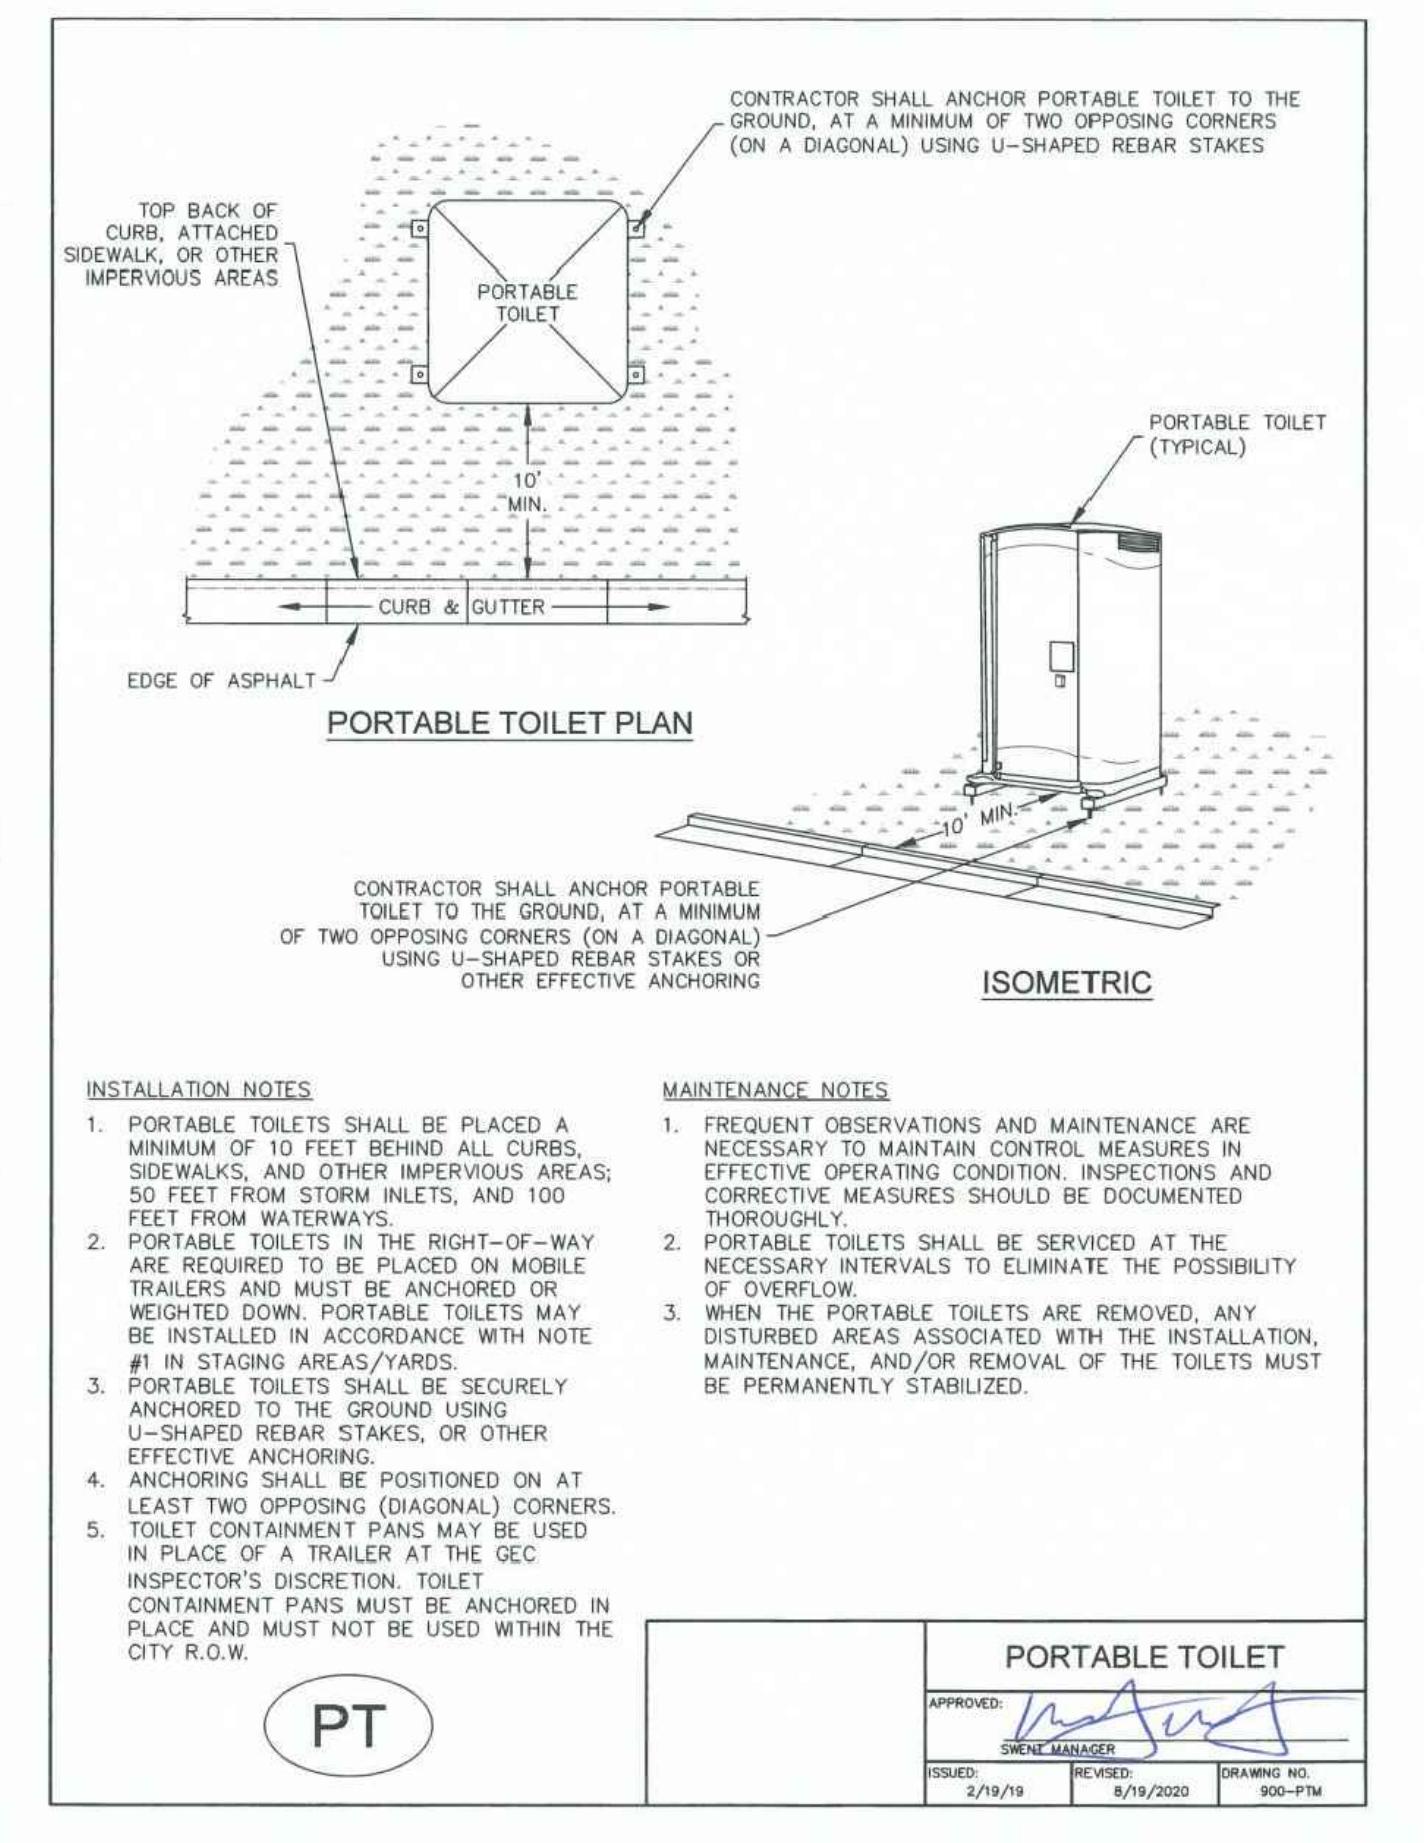
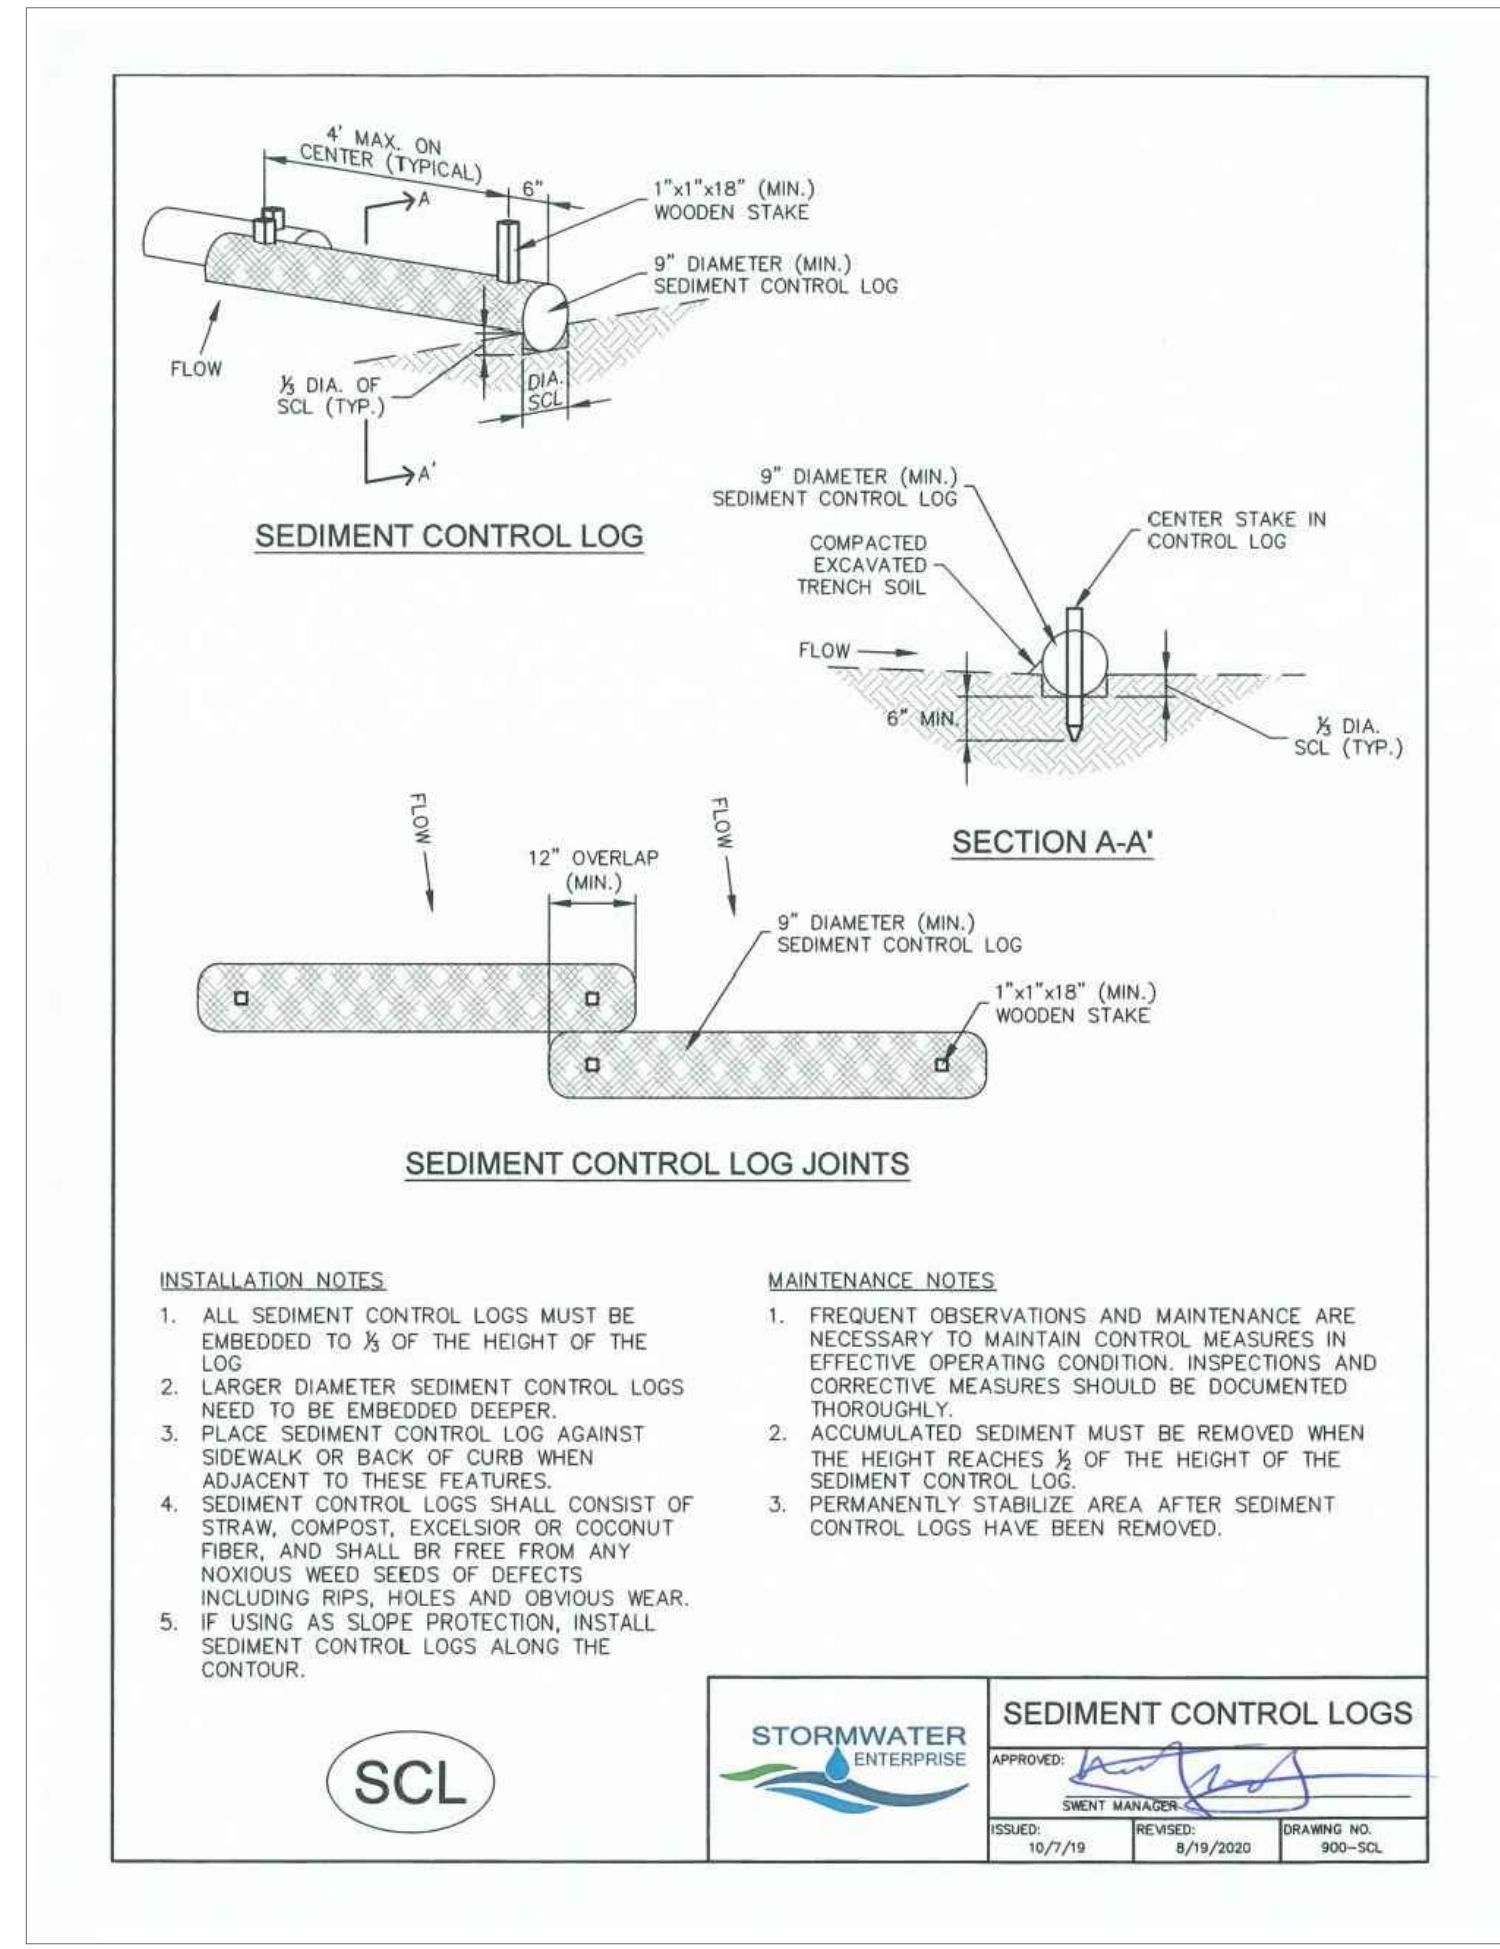
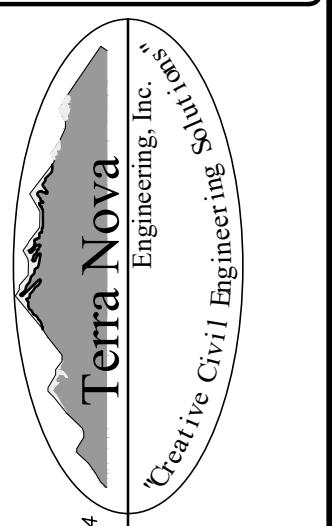
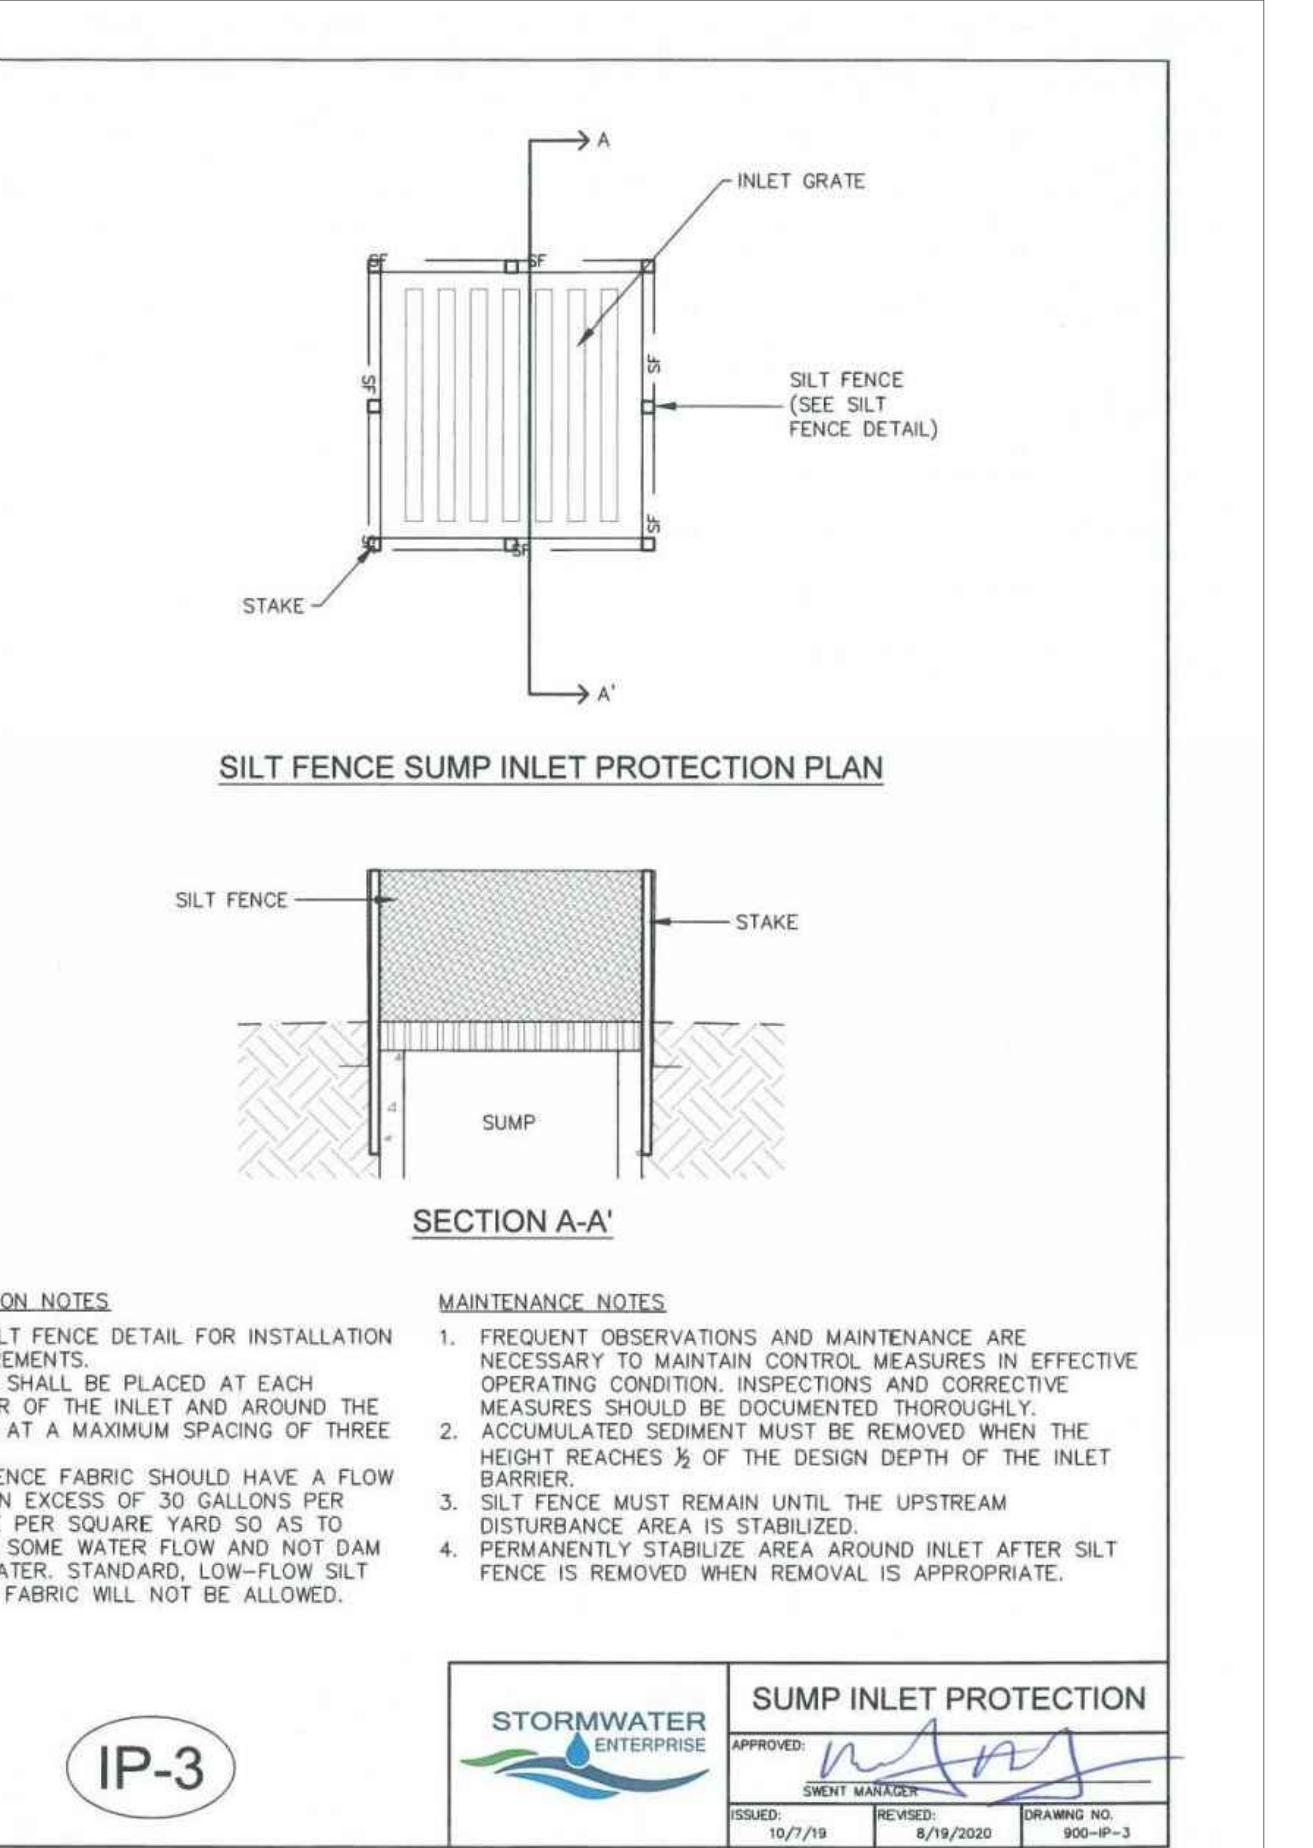
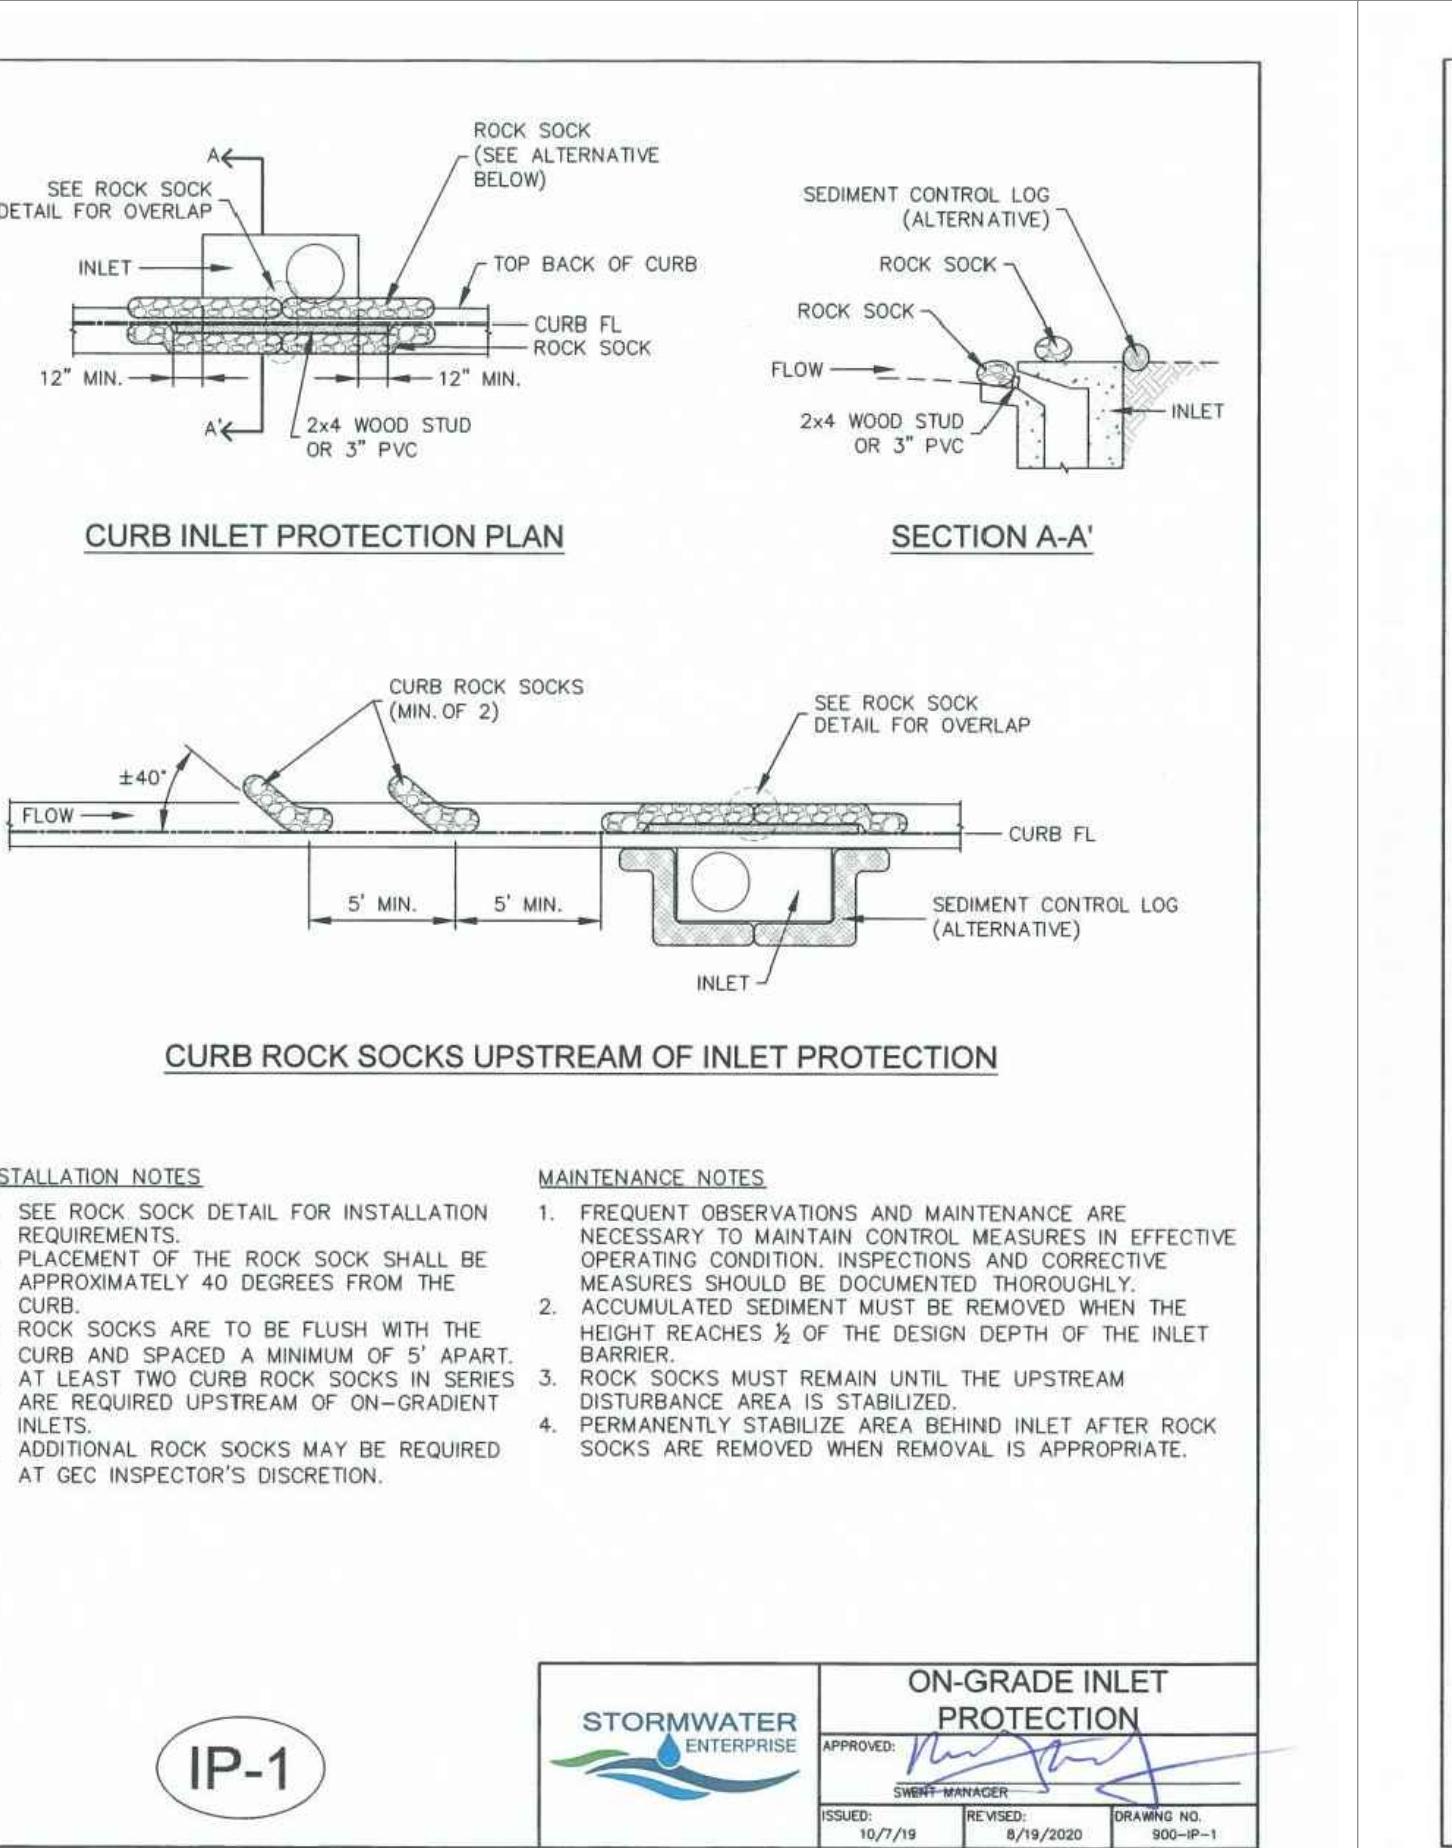







PLATE SELF STORAGE
GRADING AND EROSION CONTROL PLAN
EROSION CONTROL DETAILS

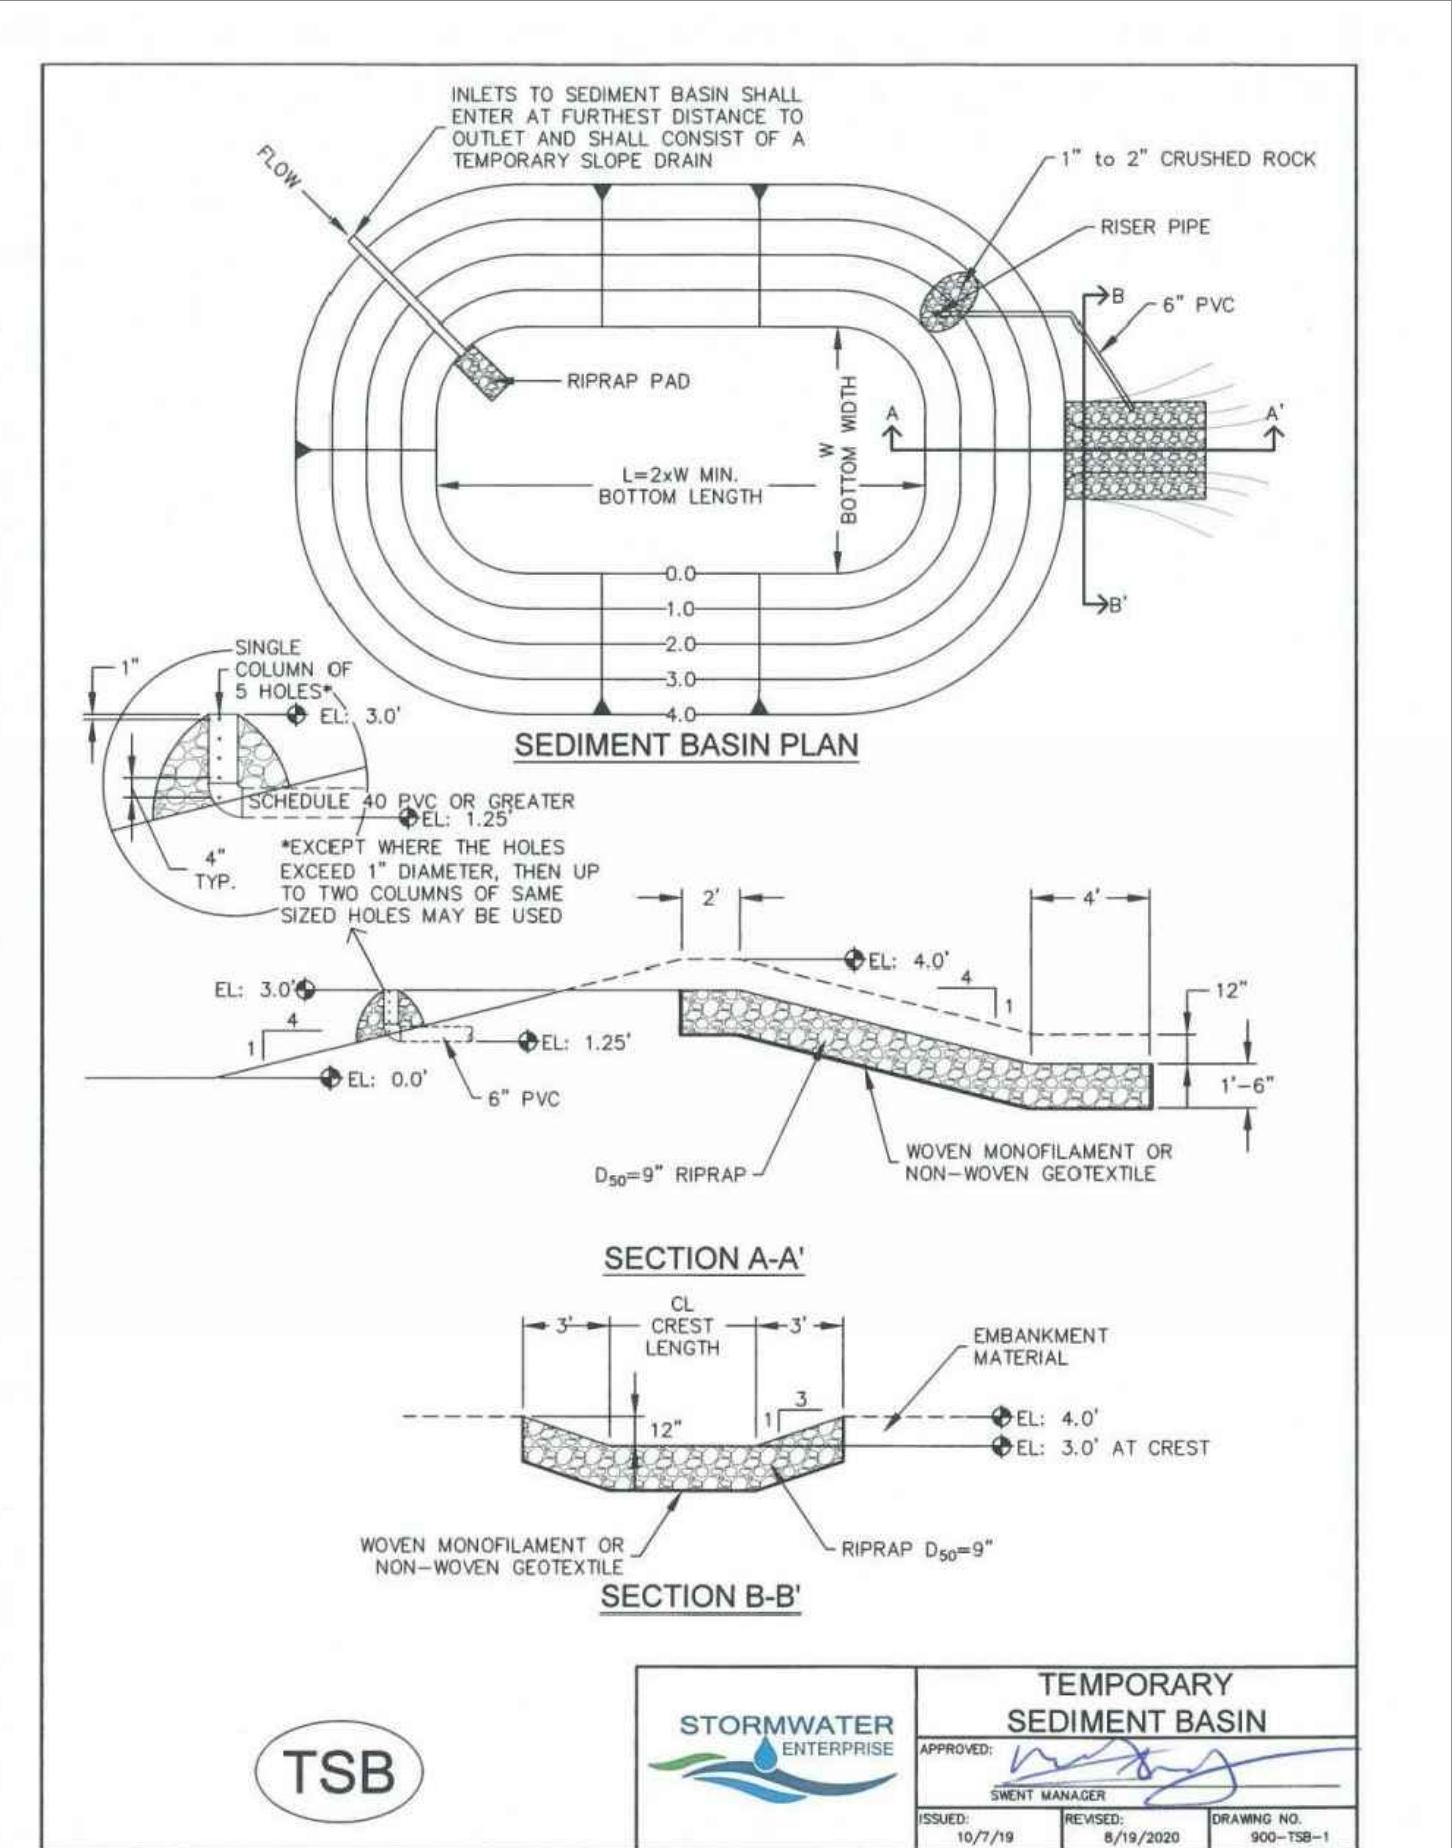DESIGNED BY JF
DRAWN BY JF
CHECKED BY DF
H-SCALE AS SHOWN
V-SCALE N/A
JOB NO. 2419.00
DATE ISSUED 01/15/25
SHEET NO. 15 OF 28



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PREPARED FOR:
RMG—ROCKY MOUNTAIN GROUP
ATTN: [Signature]
5085 LIST DR, #200
COLORADO SPRINGS, CO 80919
719.548.0600

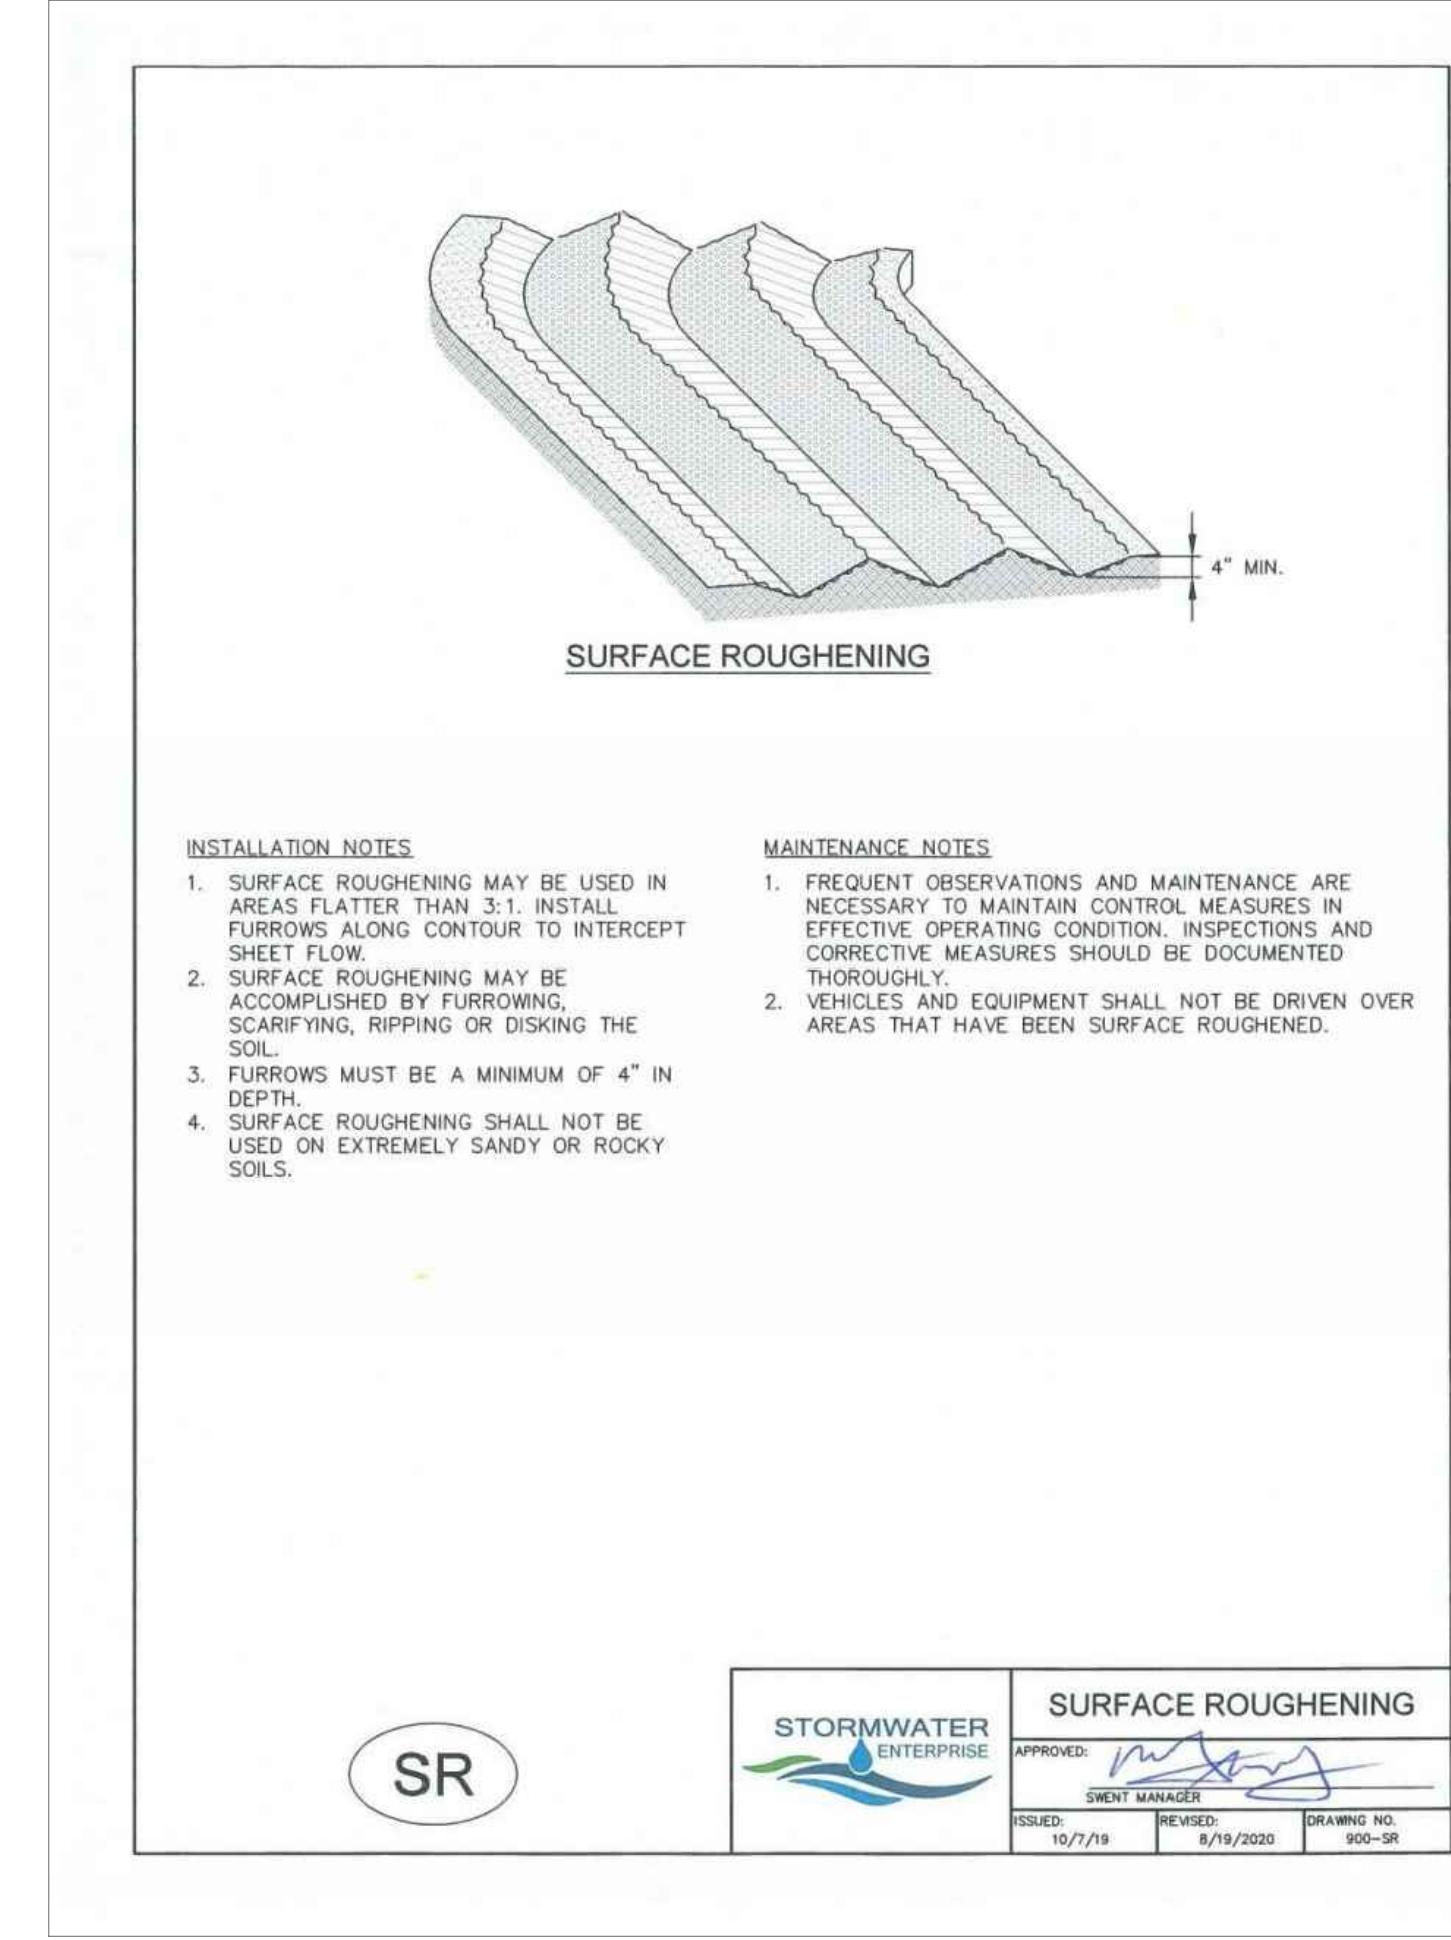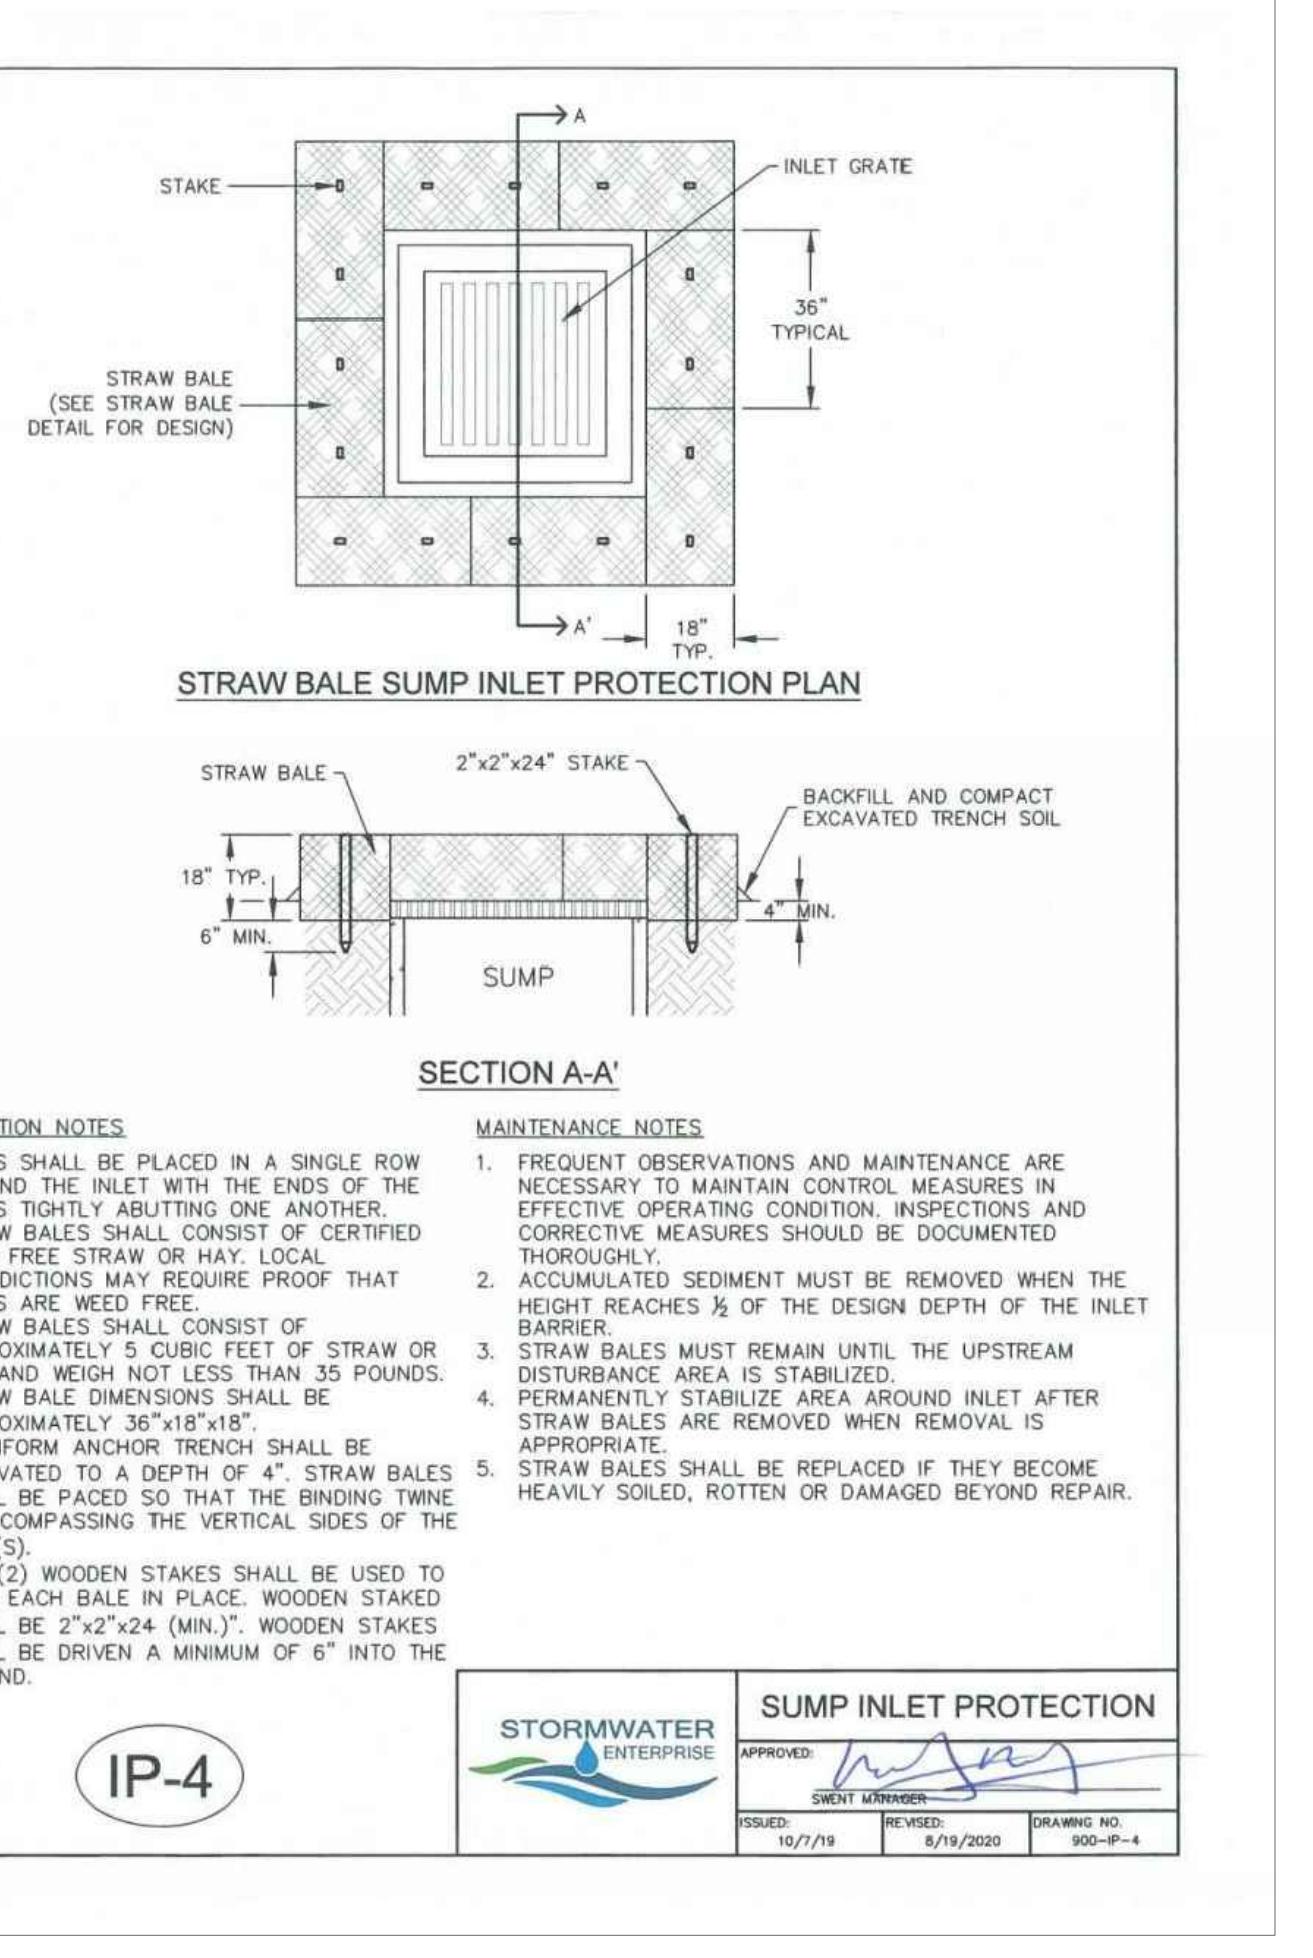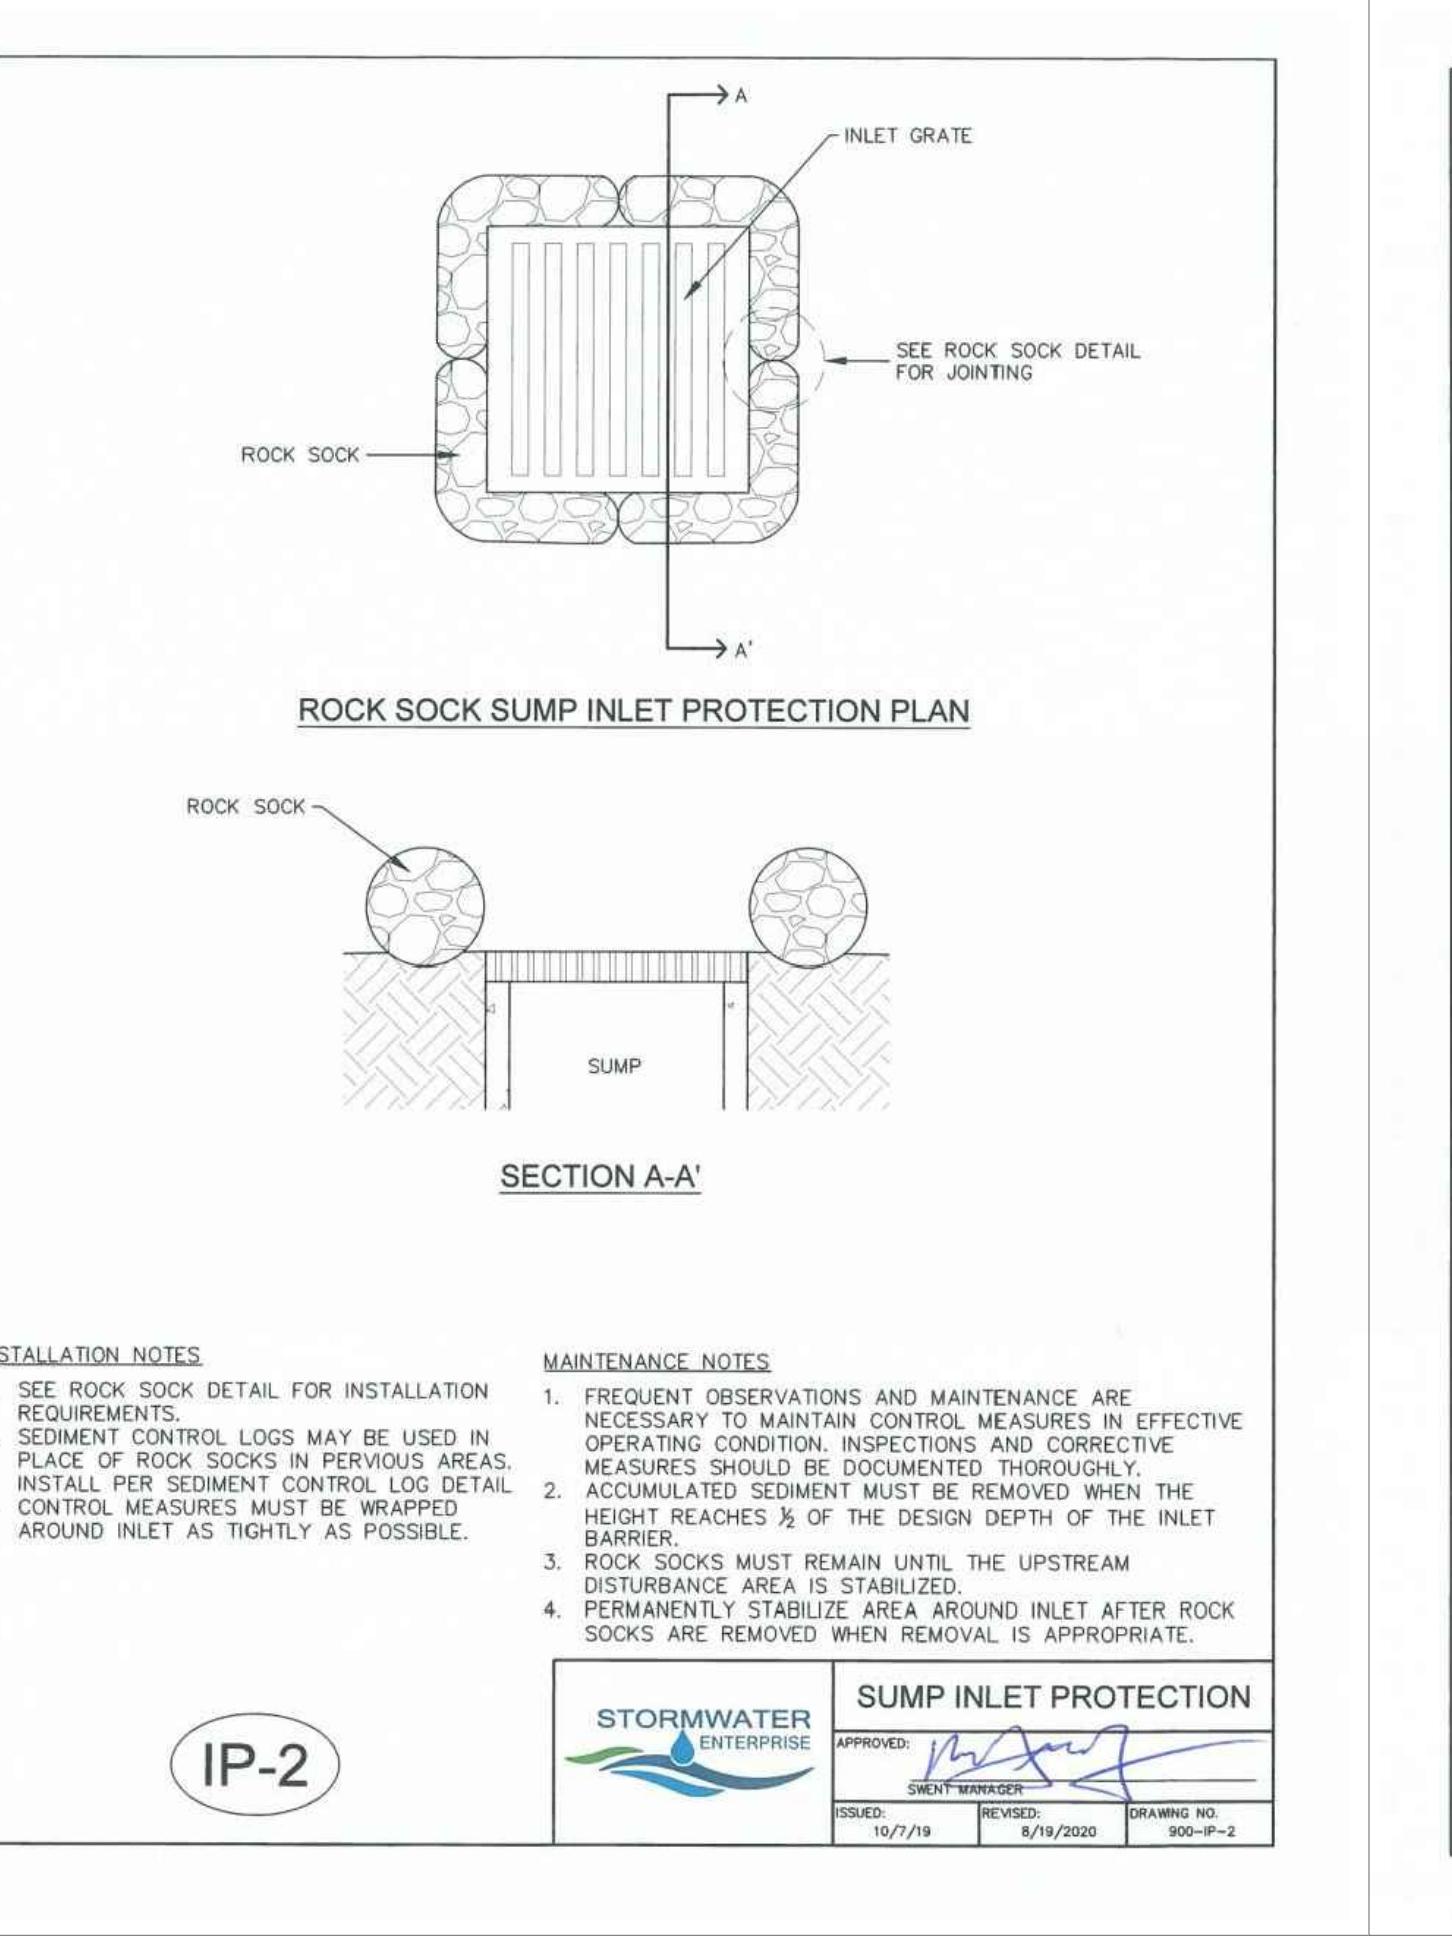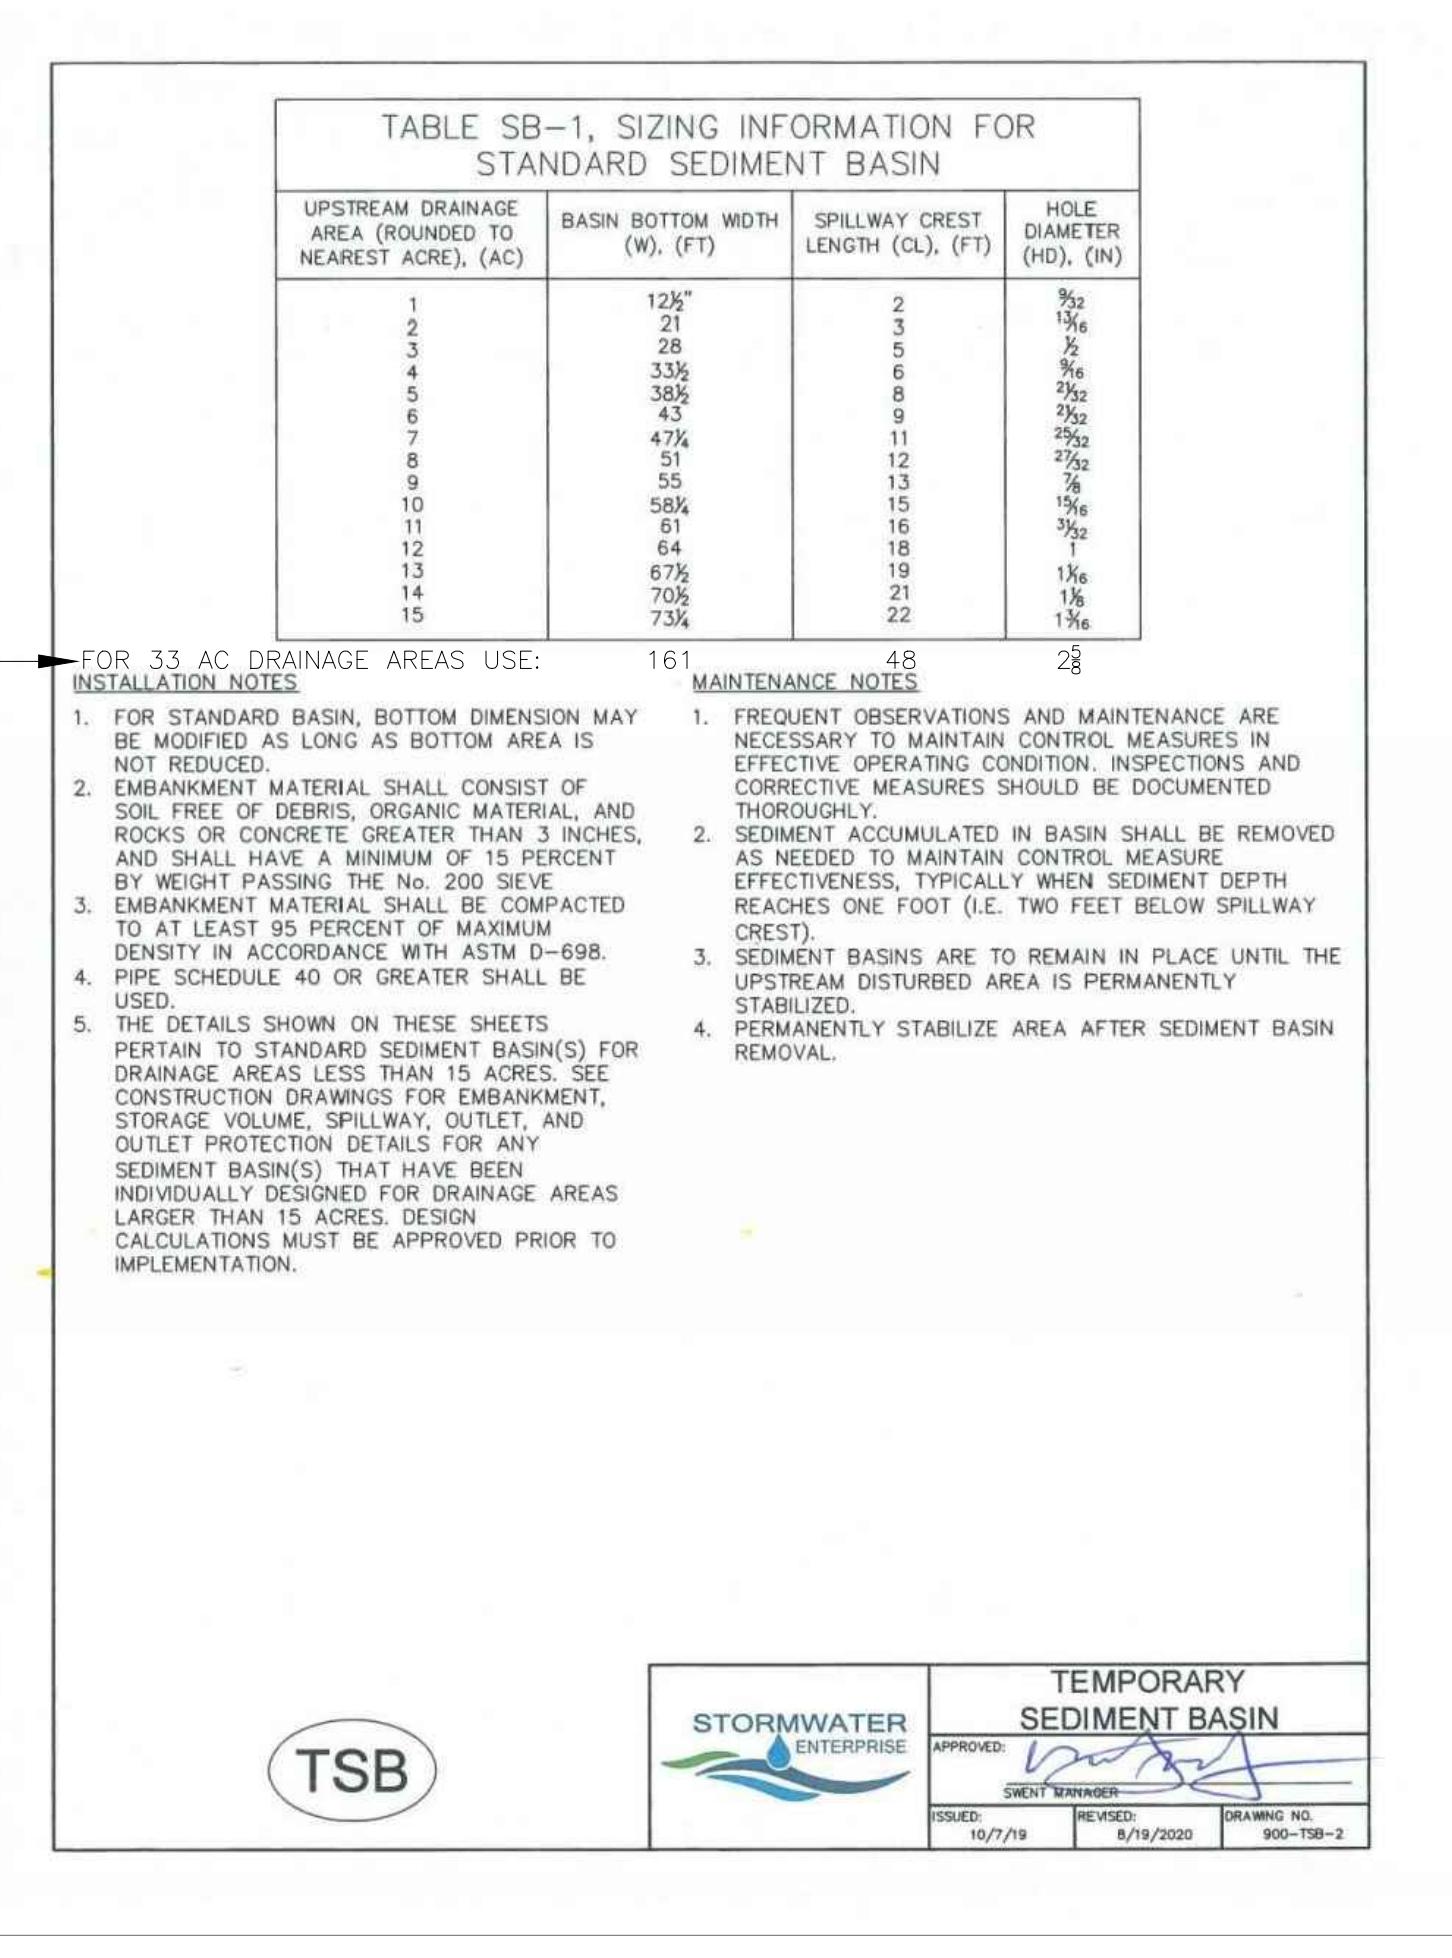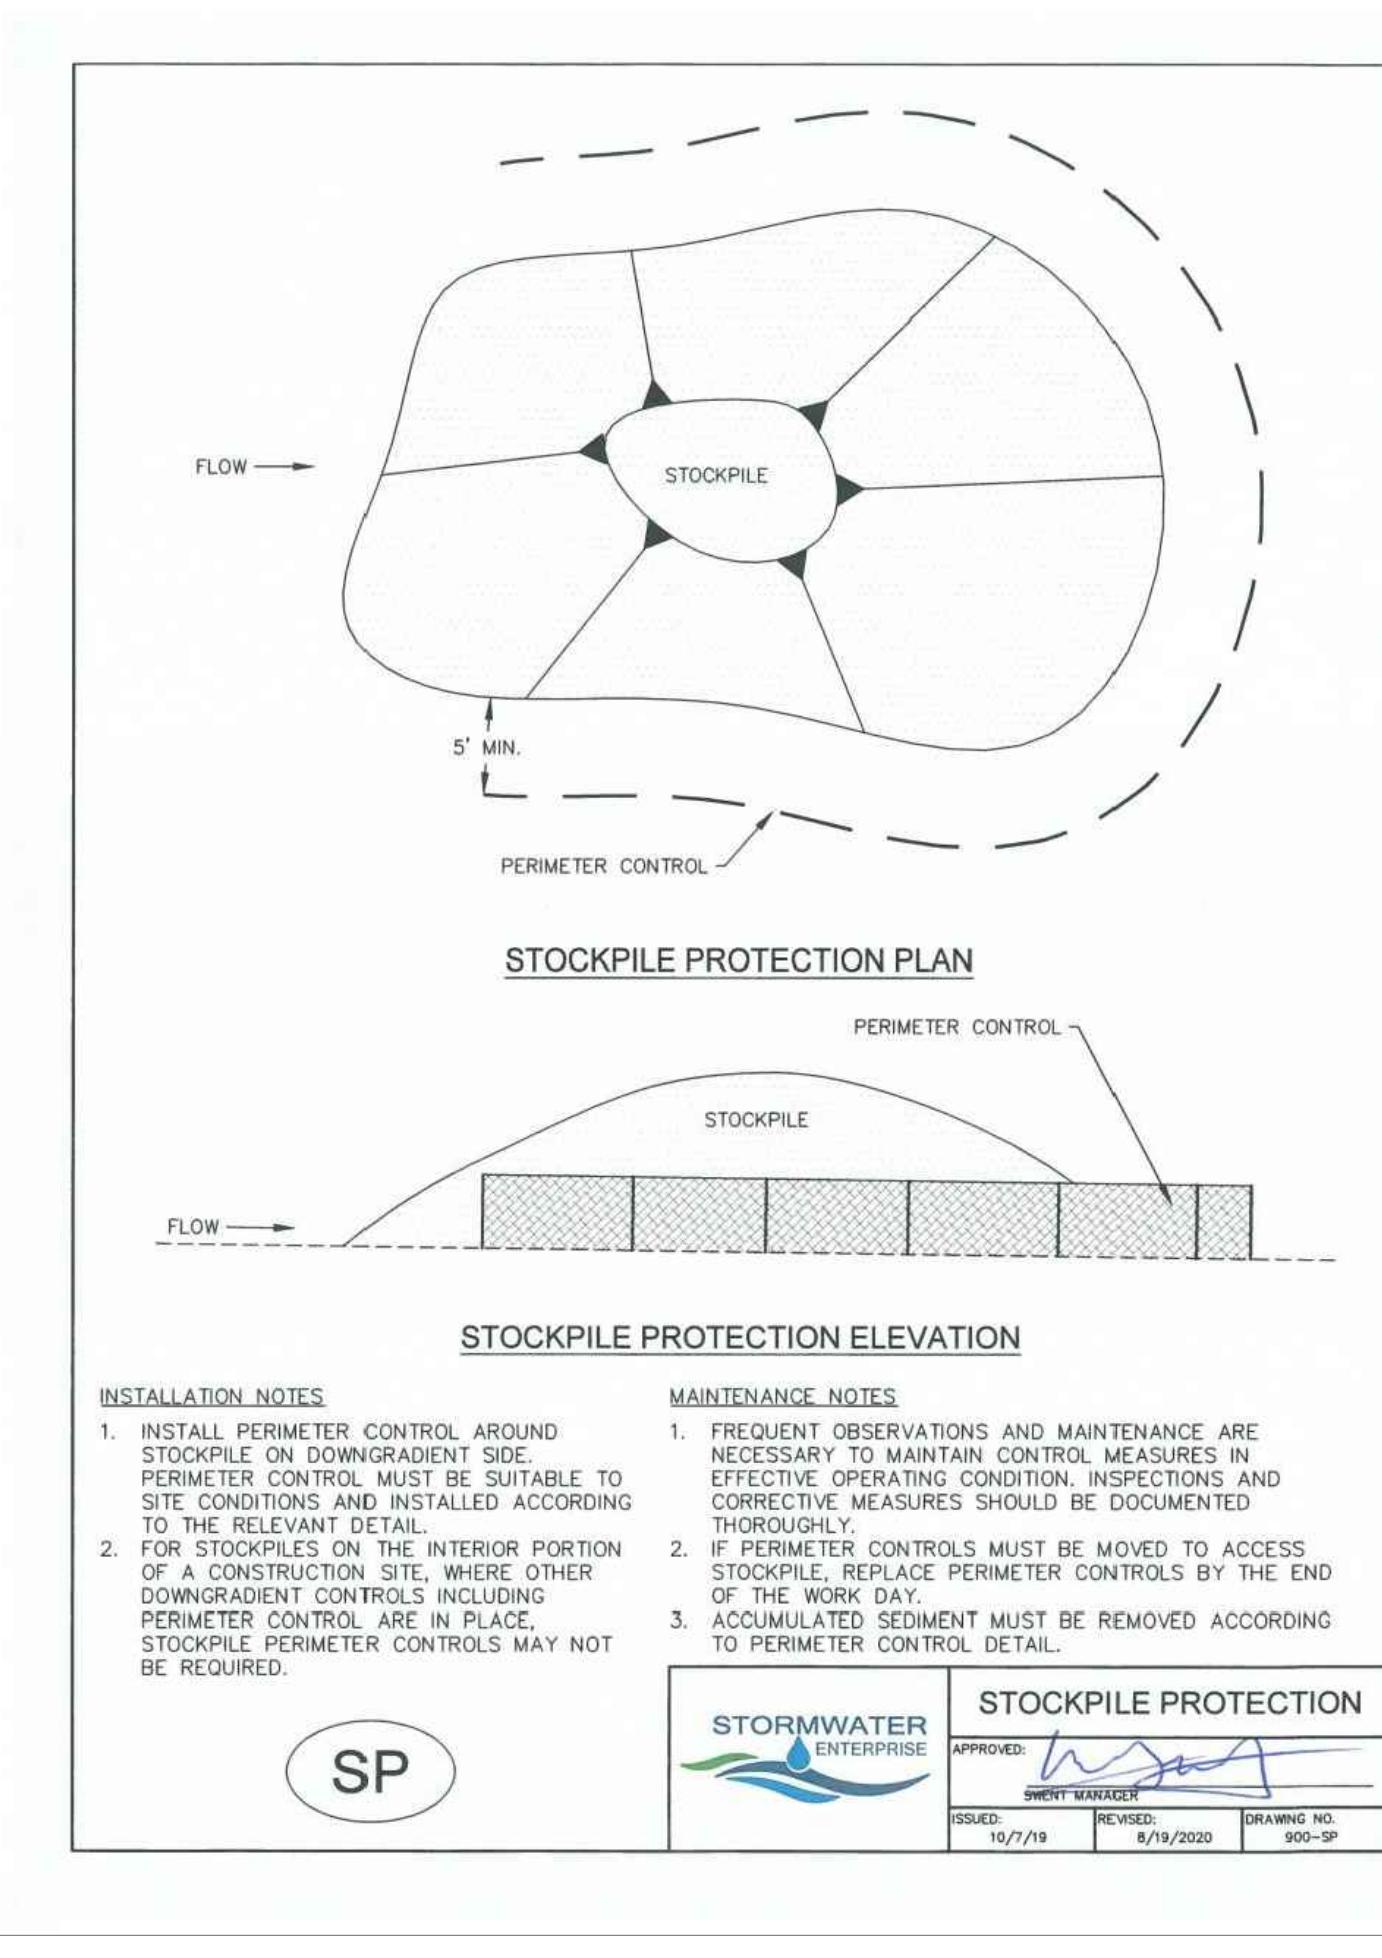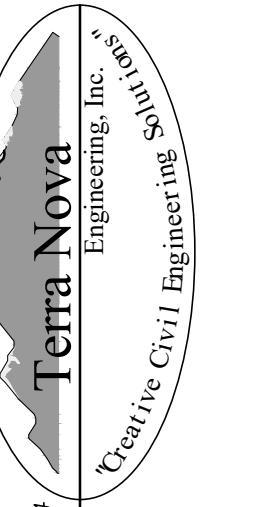

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CHECKED BY: DF	EROSION CONTROL DETAILS
H-SCALE AS SHOWN	V-SCALE N/A
JOB NO. 2419.00	DATE ISSUED 01/15/25
SHEET NO. 16 OF 28	

Chapter 5
Native Vegetation Requirements and Guidelines

REVISIONS NO. _____	DESCRIPTION _____	DATE _____
<p>SEEDING & MULCHING</p> <p>ALL SOIL TESTING, SOILS AMENDMENT AND FERTILIZER DOCUMENTATION, AND SEED LOAD AND BAG TICKETS MUST BE ADDED TO THE CSWMP.</p> <p>SOIL PREPARATION</p> <ol style="list-style-type: none"> IN AREAS TO BE SEEDED, THE UPPER 6 INCHES OF THE SOIL MUST NOT BE HEAVILY COMPACTION, AND SOILS THAT ARE FRIBLIC, COULD LEAVE 85% OF THE DENSITY UNACCEPTABLE. AREAS OF COMPACTON OR GENERAL CONSTRUCTION ACTIVITY MUST BE SCARIFIED TO A DEPTH OF 6 TO 12 INCHES PRIOR TO SPREADING TOPSOIL TO BREAK UP COMPACTED LAYERS AND PROVIDE A BLENDING ZONE BETWEEN DIFFERENT SOIL LAYERS. AREAS TO BE PLANTED SHALL HAVE AT LEAST 4 INCHES OF TOPSOIL SUITABLE TO SUPPORT PLANT GROWTH. THE CITY RECOMMENDS THAT EXISTING AND/OR IMPORTED TOPSOIL BE TESTED TO IDENTIFY SOIL DEFICIENCIES AND ANY SOIL AMENDMENTS NECESSARY TO ADDRESS THESE DEFICIENCIES. SOIL AMENDMENTS AND/OR FERTILIZERS SHOULD BE ADDED TO CORRECT TOPSOIL DEFICIENCIES BASED ON SOIL TESTING RESULTS. TOPSOIL SHALL BE PROTECTED DURING THE CONSTRUCTION PERIOD TO RETAIN ITS STRUCTURE. AVOID COMPACTION, AND TO PREVENT EROSION AND CONTAMINATION. STRIPPED TOPSOIL MUST BE STORED IN AN AREA AWAY FROM MACHINERY AND CONSTRUCTION OPERATIONS, AND CARE MUST BE TAKEN TO PROTECT THE TOPSOIL FROM WEATHERING. TOPSOIL MUST NOT BE STRIPPED DURING UNDESIRABLE WORKING CONDITIONS (E.G. DURING WET WEATHER OR WHEN SOILS ARE SATURATED). TOPSOIL SHALL NOT BE STORED IN SWALES OR IN AREAS WITH POOR DRAINAGE. <p>SEEDING</p> <ol style="list-style-type: none"> ALLOWABLE SEED MIXES ARE INCLUDED IN THE CITY OF COLORADO SPRINGS STORMWATER CONSTRUCTION MANUAL. ALTERNATIVE SEED MIXES ARE ACCEPTABLE IF INCLUDED IN AN APPROVED LANDSCAPING PLAN. SEED SHOULD BE DRILL-SEEDED WHENEVER POSSIBLE. BROADCAST-SEEDED OR HYDRO-SEEDED WITH TACKIFIER MAY BE SUBSTITUTED ON SLOPES STEEPER THAN 3:1 OR ON OTHER AREAS AS PRACTICAL TO DRILL SEEDED. SEEDED RATES MUST BE DOUBLED FOR BROADCAST SEEDED OR INCREASED BY 50% IF USING A BRILLION DRILL OR HYDRO-SEEDED. BROADCAST SEEDED MUST BE LIGHTLY HAND-RAKED INTO THE SOIL. <p>MULCHING</p> <ol style="list-style-type: none"> MULCHING SHOULD BE COMPLETED AS SOON AS PRACTICABLE AFTER SEEDED, HOWEVER PLANTED AREAS MUST BE MULCHED NO LATER THAN 14 DAYS AFTER PLANTING. MULCHING REQUIREMENTS INCLUDE: <ul style="list-style-type: none"> ONLY CERTIFIED WEED-FREE AND CERTIFIED SEEDED-FREE MULCH MAY BE USED. MULCH MUST BE APPLIED AT 2 TONS/ACRE AND ADEQUATELY SECURED BY CRIMPING AND/OR TACKIFIER. CRIMPING MUST NOT BE USED ON SLOPES GREATER THAN 3:1 AND MULCH FIBERS MUST BE TUCKED INTO THE SOIL TO A DEPTH OF 3 TO 4 INCHES. TACKIFIER MUST BE USED IN PLACE OF CRIMPING ON SLOPES STEEPER THAN 3:1. HYDRAULIC MULCHING: <ul style="list-style-type: none"> HYDRAULIC MULCHING IS AN OPTION ON STEEP SLOPES OR WHERE ACCESS IS LIMITED. WOOD CELLULOSE FIBERS MUST BE APPLIED AS SEEDING IS PLANTED. WOOD CELLULOSE FIBERS MIXED WITH WATER MUST BE APPLIED AT A RATE OF 2,000 TO 2,500 POUNDS/ACRE, AND TACKIFIER MUST BE APPLIED AT A RATE OF 100 POUNDS/ACRE. EROSION CONTROL BLANKET: <ul style="list-style-type: none"> EROSION CONTROL BLANKET MAY BE USED IN PLACE OF TRADITIONAL MULCHING METHODS. 		

SM

STORMWATER ENTERPRISE	SEEDING & MULCHING
APPROVED:	PROJECT MANAGER
ISSUED: 10/7/19	REVISED: 8/19/2020
DRAWING NO. 900-SM	


Chapter 5
Native Vegetation Requirements and Guidelines

REVISIONS NO. _____	DESCRIPTION _____	DATE _____
<p>PLATE SELF STORAGE</p> <p>271 S. 23RD STREET COLORADO SPRINGS, CO 80904 PHONE: 719-535-6422 FAX: 719-535-6426 www.tresinc.com</p> <p>GRADING AND EROSION CONTROL PLAN EROSION CONTROL DETAILS</p>		

DESIGNED BY JF	DRAWN BY JF	CHECKED BY DF
<p>PLATE SELF STORAGE</p> <p>City of Colorado Springs Stormwater Enterprise</p> <p>H-SCALE AS SHOWN V-SCALE N/A JOB NO. 2419.00 DATE ISSUED 01/15/25 SHEET NO. 17 OF 28</p>		
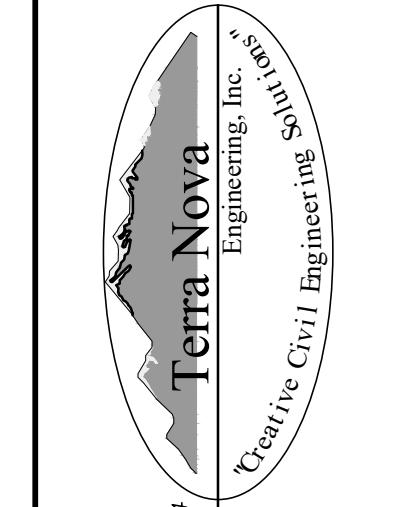
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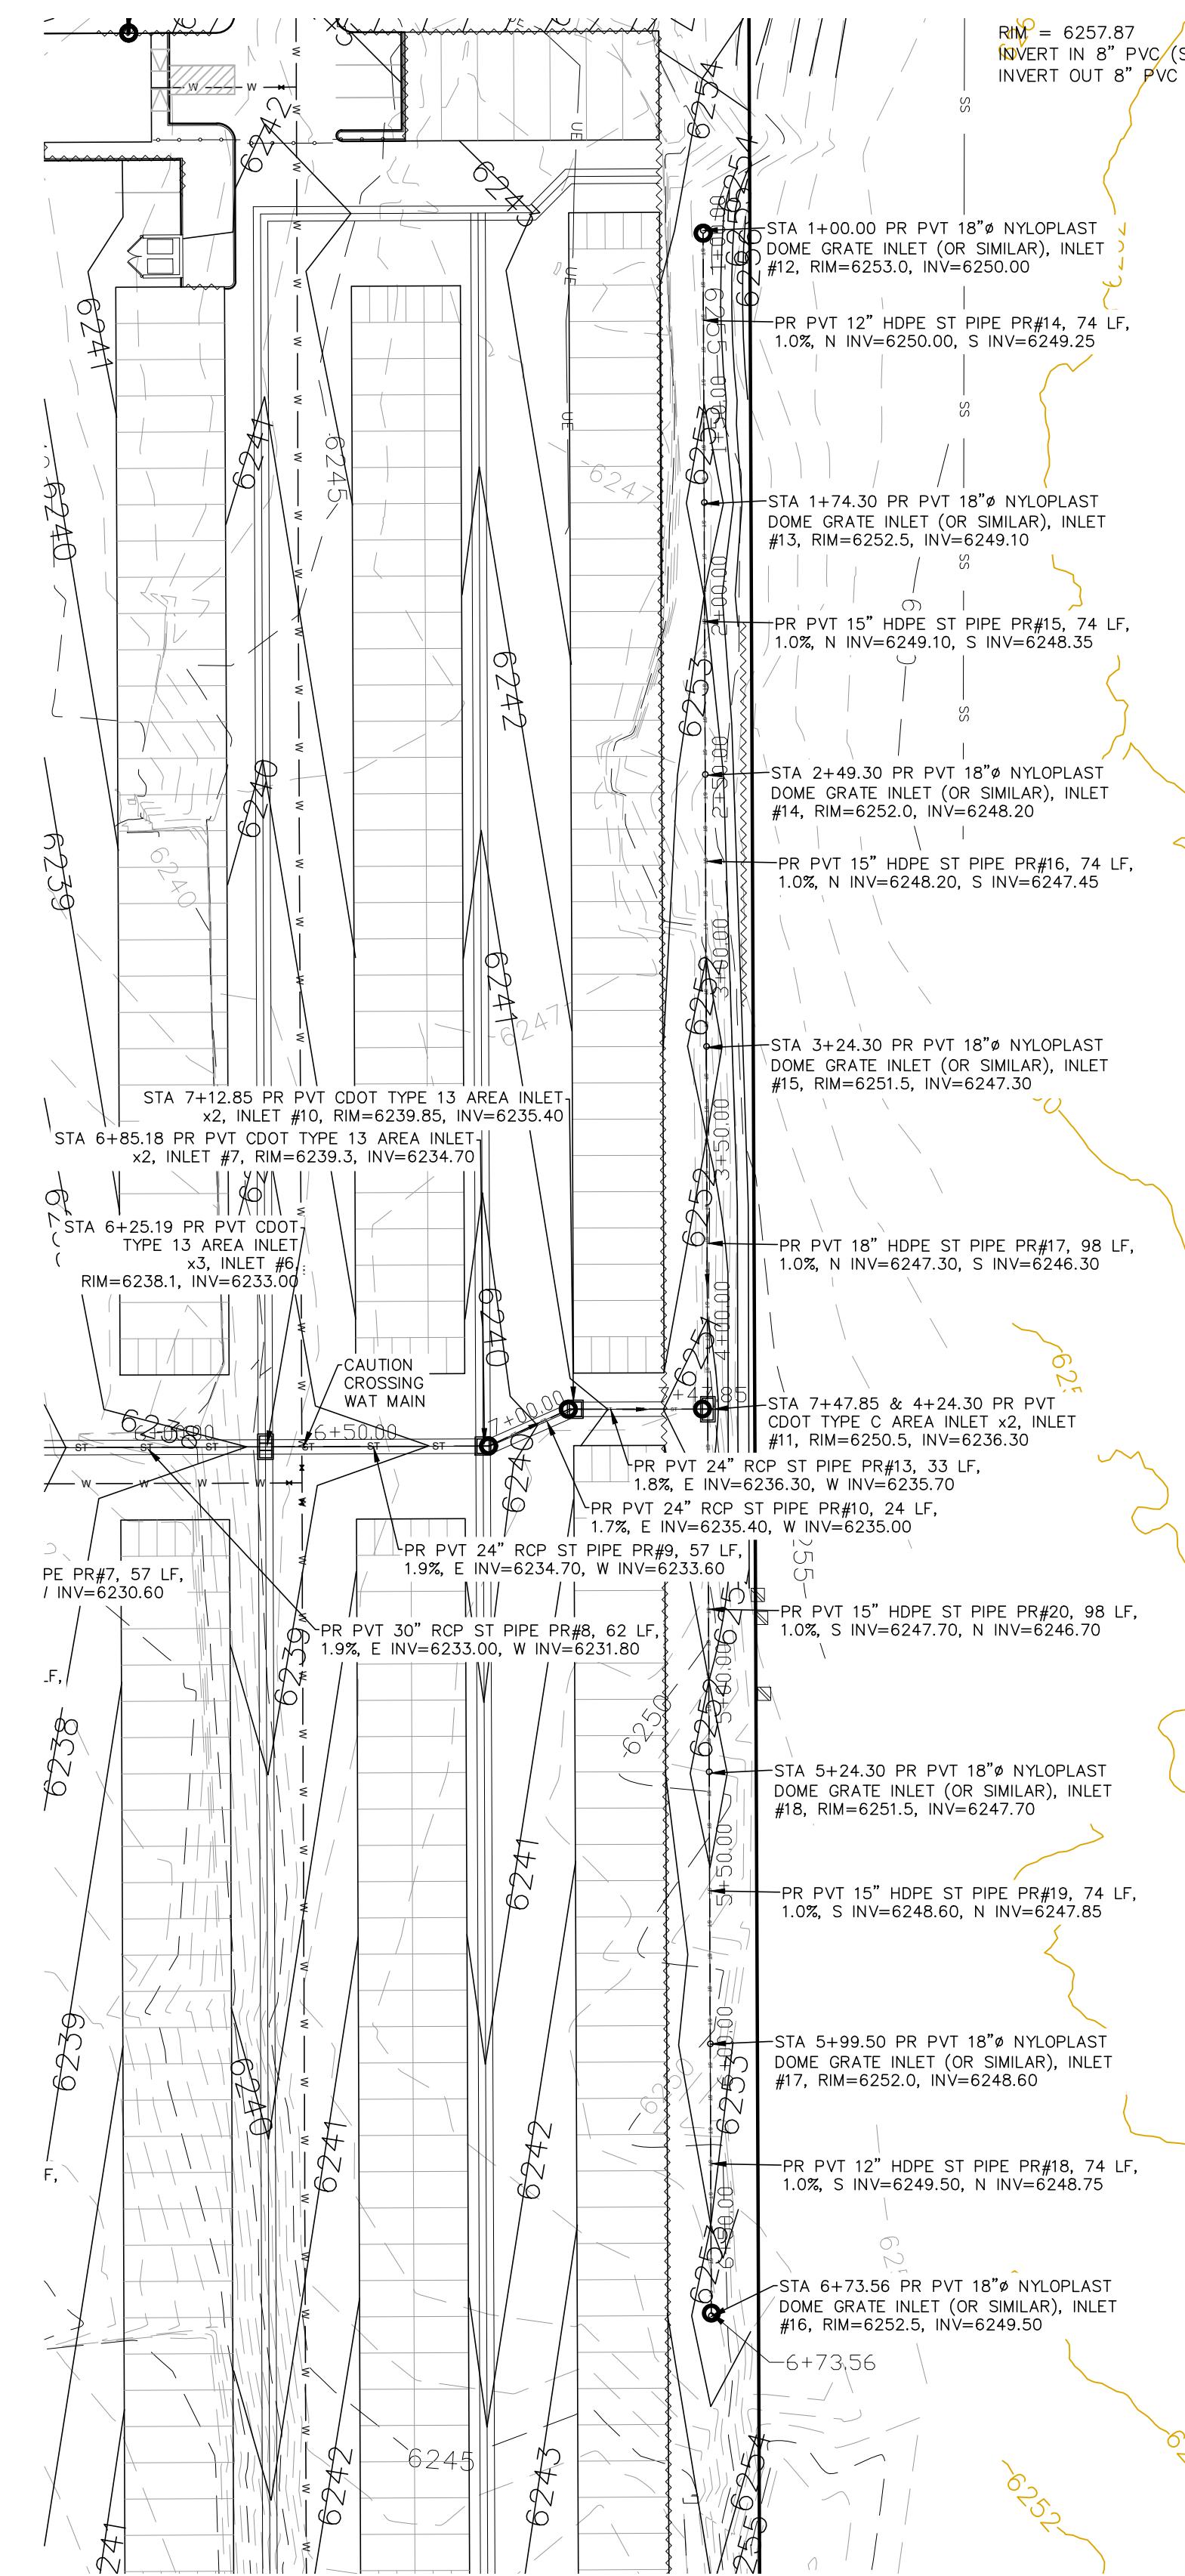
PREPARED FOR: RMG—ROCKY MOUNTAIN GROUP	ATTN: 5085 LIST DR,	Stormwater Construction Manual
<p>5-11</p> <p>COLORADO SPRINGS, CO 80919 719.548.0600</p>		




Engineering, Inc.
Civil / Structural / Geotechnical / Water Resources

PLATE SELF STORAGE	GRADING AND EROSION CONTROL PLAN
<p>PLATE SELF STORAGE</p> <p>City of Colorado Springs Stormwater Enterprise</p> <p>H-SCALE AS SHOWN V-SCALE N/A JOB NO. 2419.00 DATE ISSUED 01/15/25 SHEET NO. 17 OF 28</p>	

DESIGNED BY JF	DRAWN BY JF	CHECKED BY DF
<p>PLATE SELF STORAGE</p> <p>City of Colorado Springs Stormwater Enterprise</p> <p>H-SCALE AS SHOWN V-SCALE N/A JOB NO. 2419.00 DATE ISSUED 01/15/25 SHEET NO. 17 OF 28</p>		



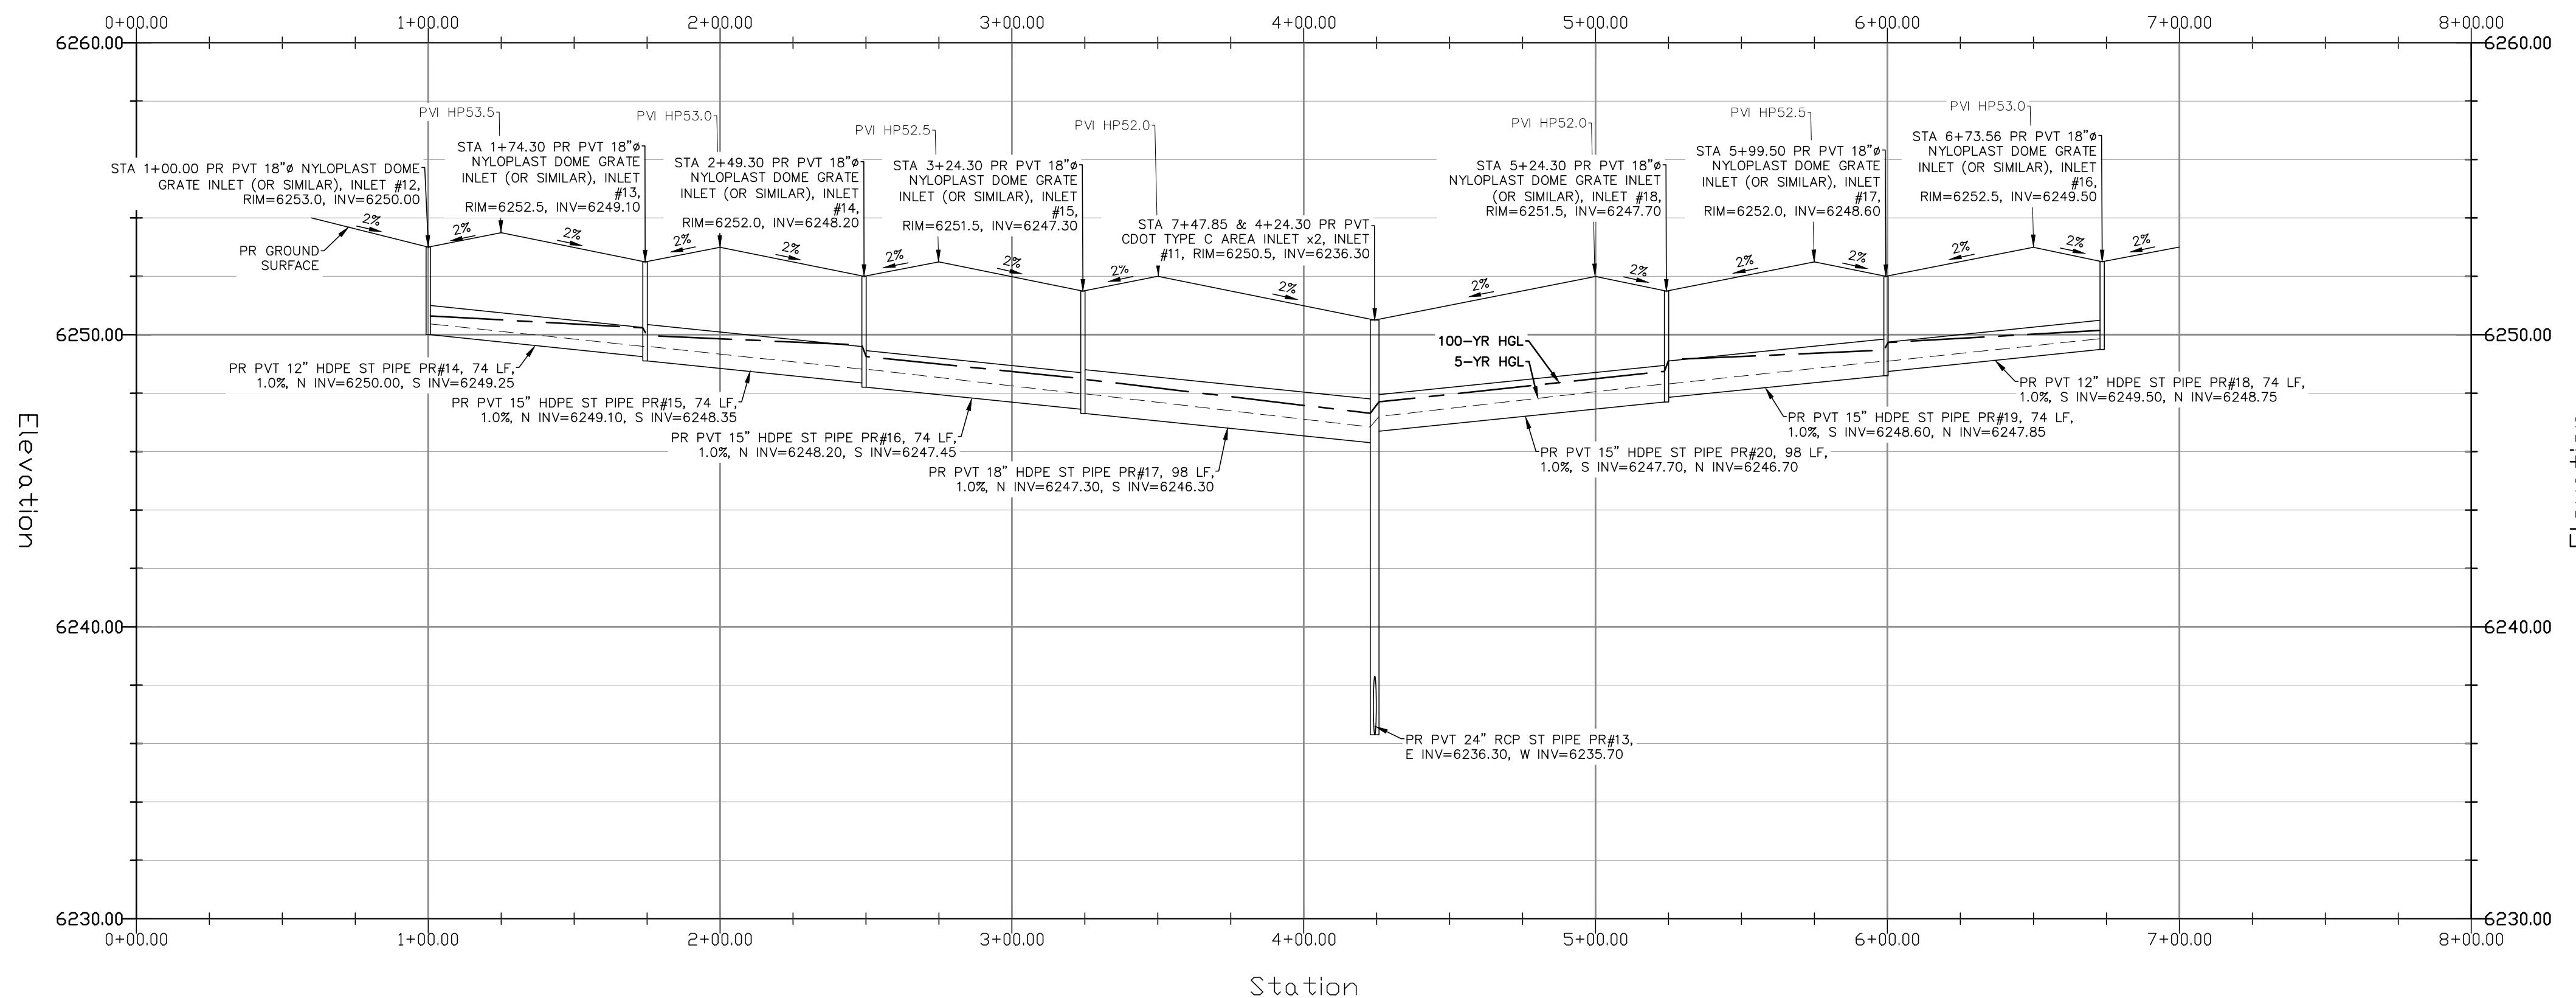STORM SEWER EAST RUN – PLAN & PROFILE
HORZ SCALE: 1"=40' – VERT SCALE: 1"= 4'



GRADING LEGEND

PROPOSED	PR	EXISTING CONTOURS – MINOR
EXISTING	EX	EXISTING CONTOURS – MAJOR
FINISHED SURFACE	FS	PROPOSED CONTOURS – 1'
FINISHED GROUND	FG	EXISTING PROPERTY LINE
TOP OF CURB	TC	PROPOSED RIPRAP
FLOWLINE	FL	WATER LINE
FINISH GROUND AT TOP OF WALL	TW	SANITARY SEWER LINE
FINISHED GROUND AT BOTTOM OF WALL	BW	GAS LINE
LOW POINT	LP	UNDERGROUND ELECTRICAL LINE
HIGH POINT	HP	TELEPHONE LINE
FLOW ARROW	←	FIBER OPTIC LINE
EXISTING CONTOURS (LIDAR)	873Q	STORM SEWER LINE
STORM MANHOLE	○	LIMIT OF CONSTRUCTION
STORM INLET	□	LIMIT OF SOIL DISTURBANCE
		PROPOSED FENCE
		STORM HYDRANT

STORM SEWER NOTES

- ALL HDPE STORM SEWER MUST BE SMOOTH INTERIOR PIPE. ALL RCP MUST BE MINIMUM CLASS 3.
- ALL PIPE CONNECTIONS TO PREFABRICATED INLETS OR BOXES MUST USE A REINFORCED CONCRETE COLLAR.
- ALL TYPE C INLETS SHALL HAVE CLOSE MESH GRATES.
- ALL PRESSURIZED PIPES MUST HAVE WATERTIGHT SEALS.
- GRADING INFORMATION SHOWN ON STORM SEWER PLANS SHALL NOT BE USED FOR CONSTRUCTION, USE THE GRADING PLANS FOR THAT. THE COUNTY REQUIRED REDUNDANT GRADING CALLOUTS BE INCLUDED ON THESE PLANS, AND THAT INFO MAY BE INCORRECT.

REVISIONS
NO. _____ DATE _____

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PREPARED FOR:
RMG—ROCKY MOUNTAIN GROUP
ATTN: #200
5085 LIST DR,
COLORADO SPRINGS, CO 80919
719.548.0600


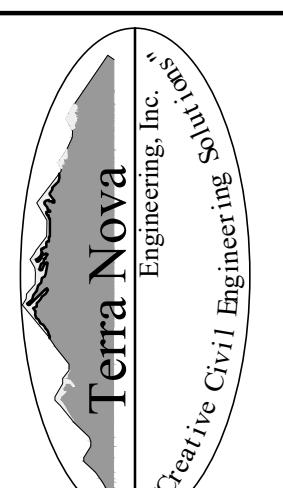





PLATE SELF STORAGE
STORM SEWER PLAN
EAST RUN – PLAN & PROFILE

DESIGNED BY DLF
DRAWN BY DLF
CHECKED BY LD
H-SCALE AS SHOWN
V-SCALE N/A
JOB NO. 2419.00
DATE ISSUED 01/15/25
SHEET NO. 18 OF 28

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FOR AND ON BEHALF OF TERRA NOVA ENGINEERING, INC.

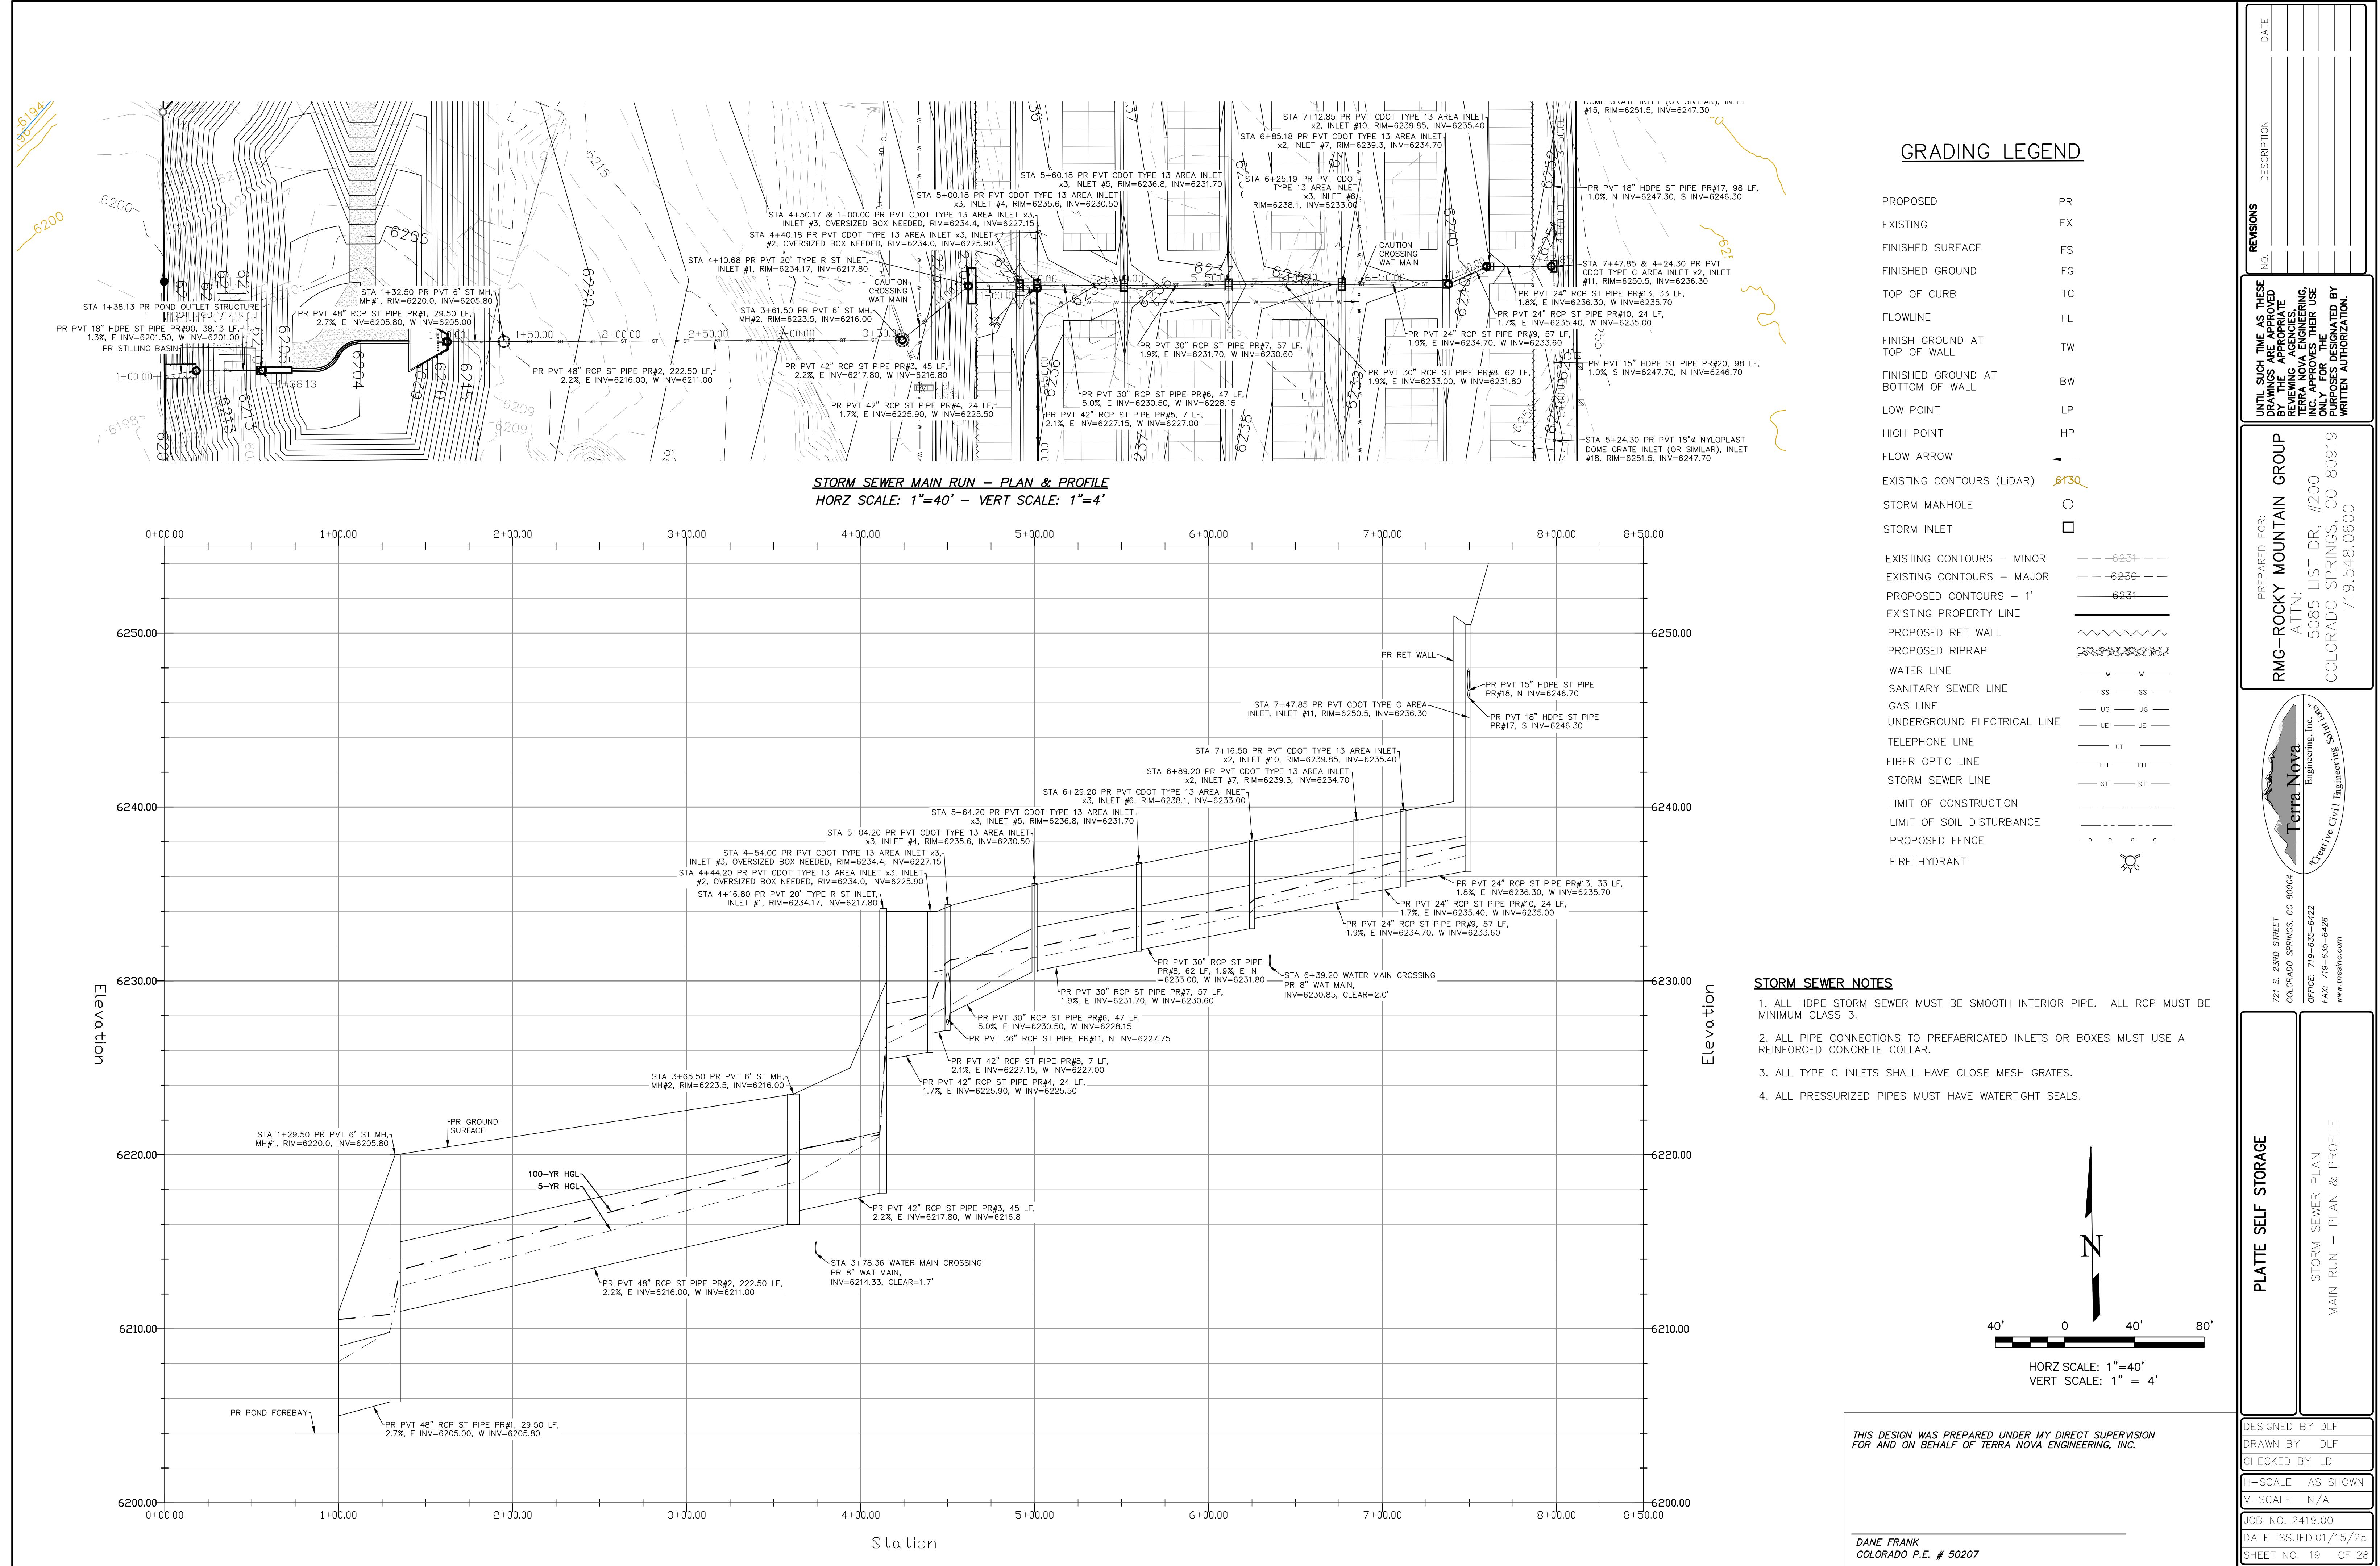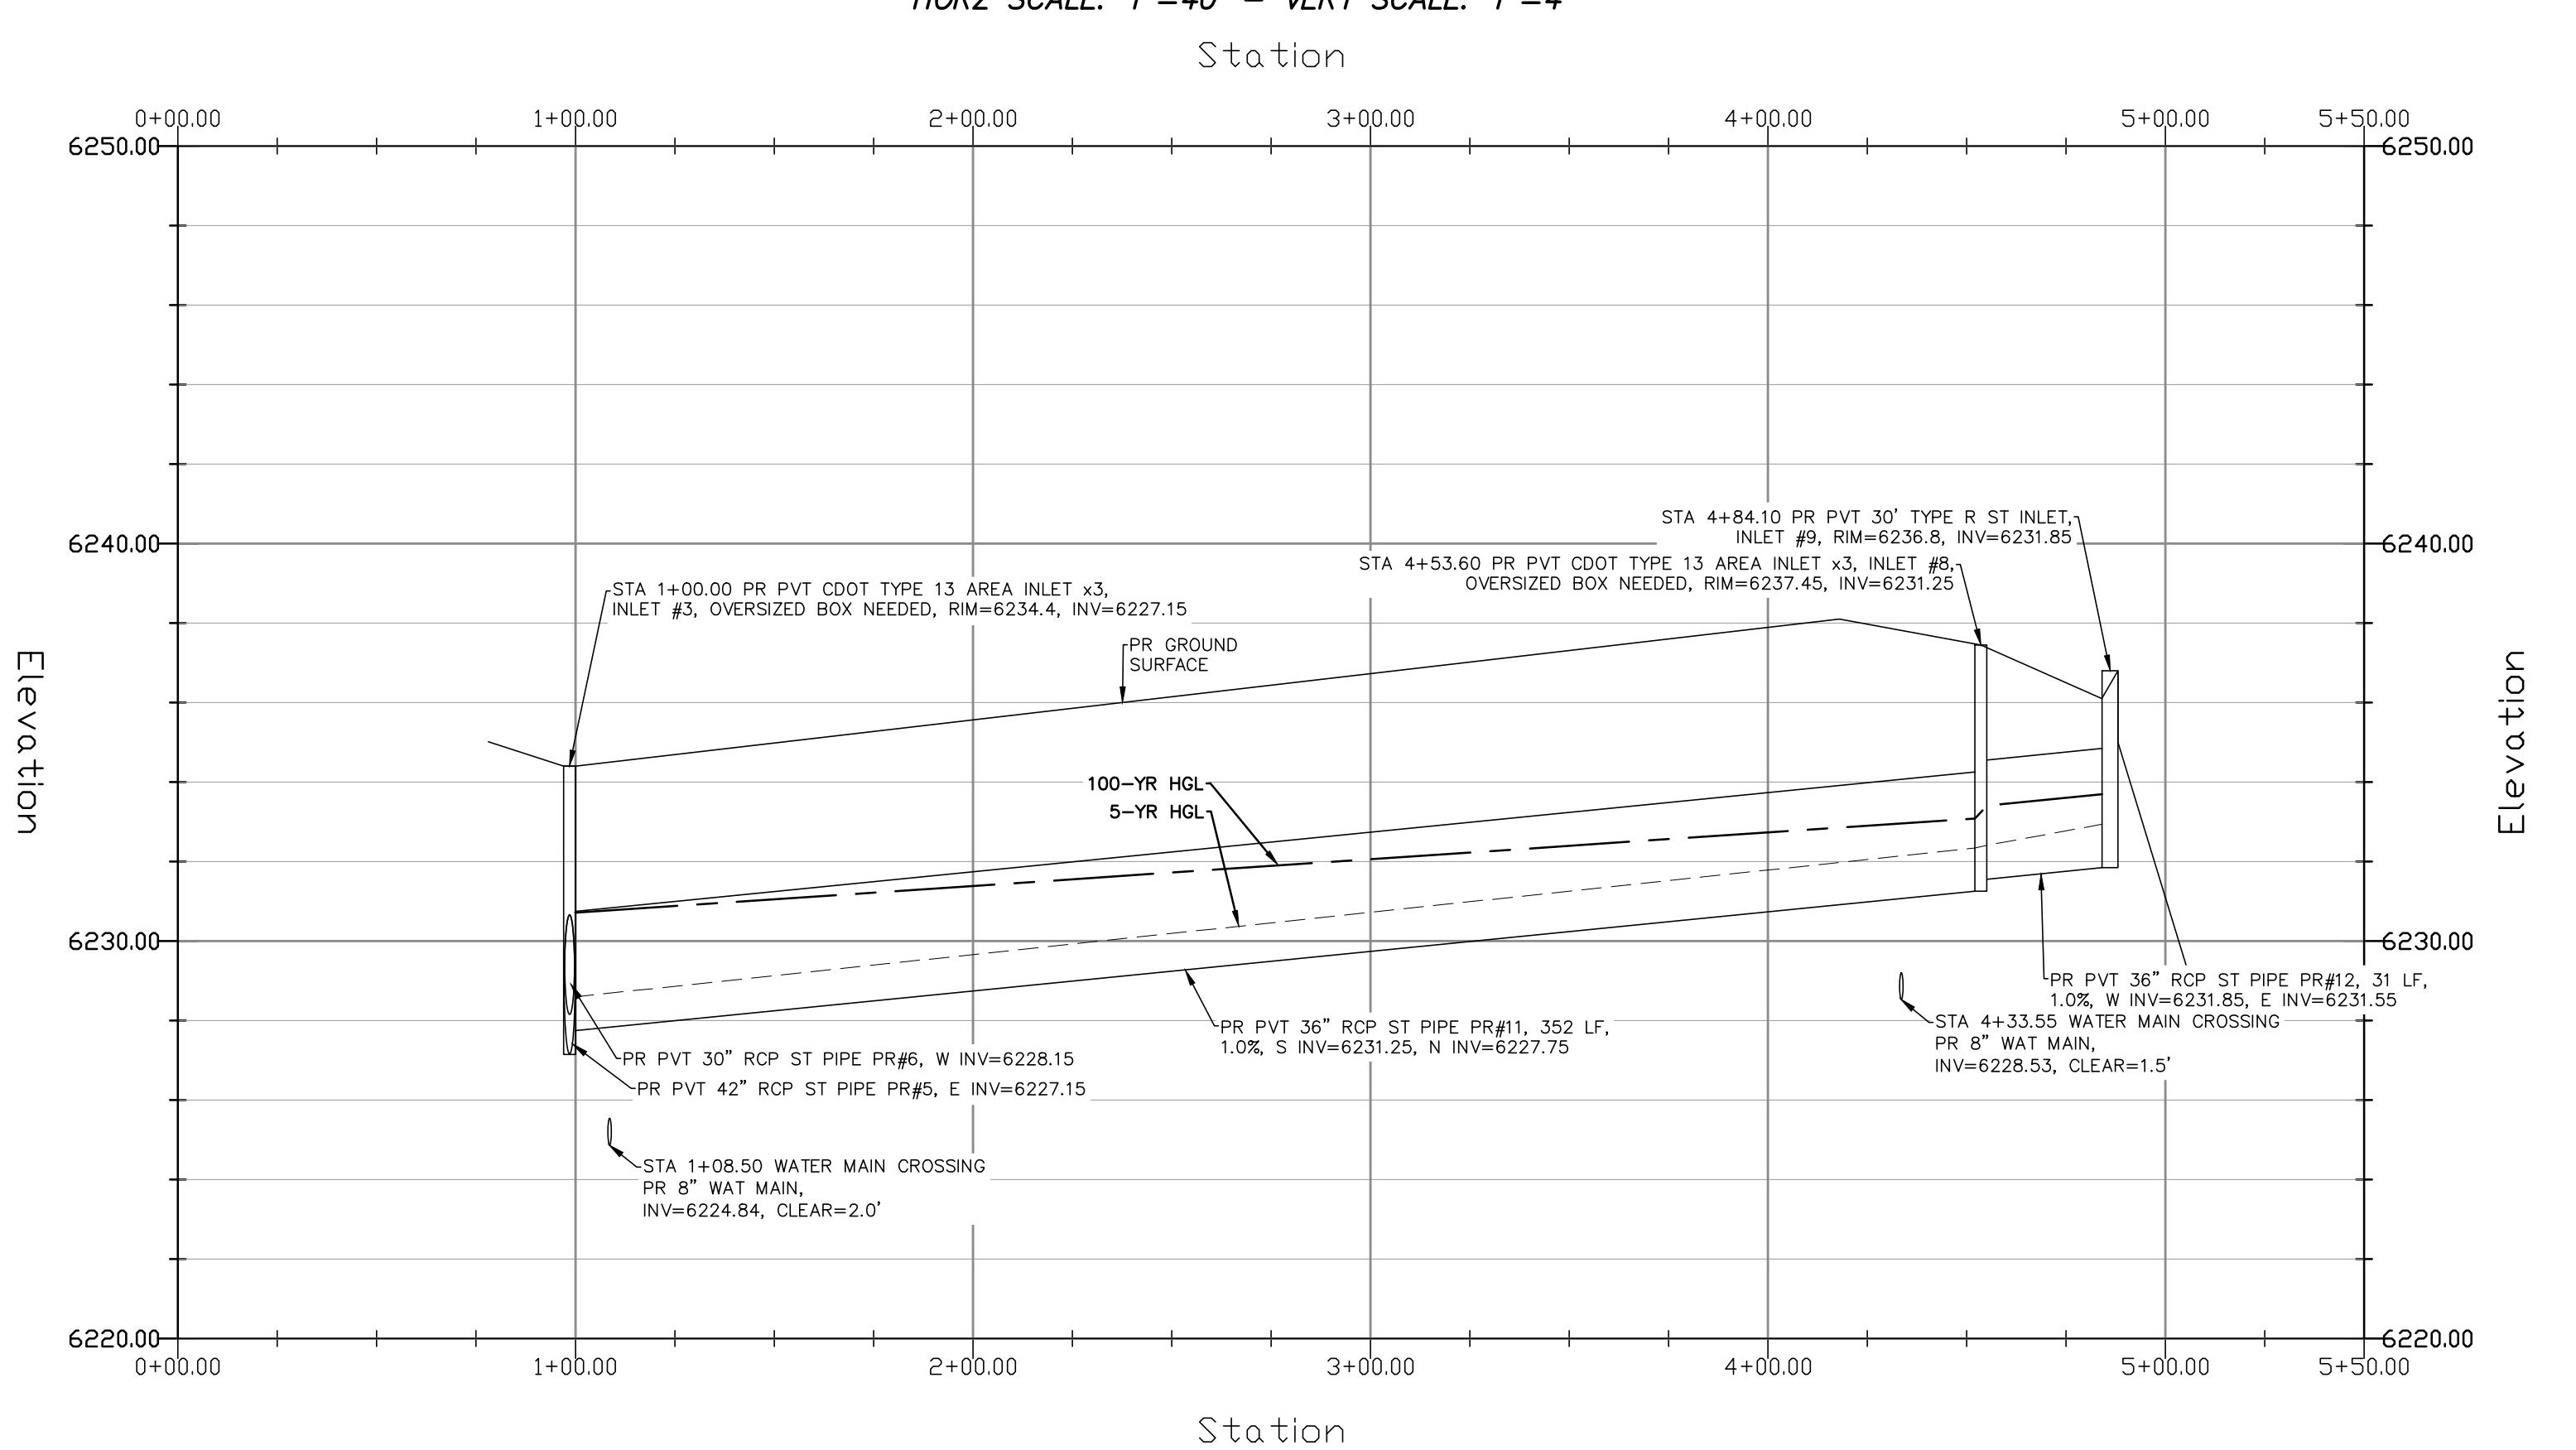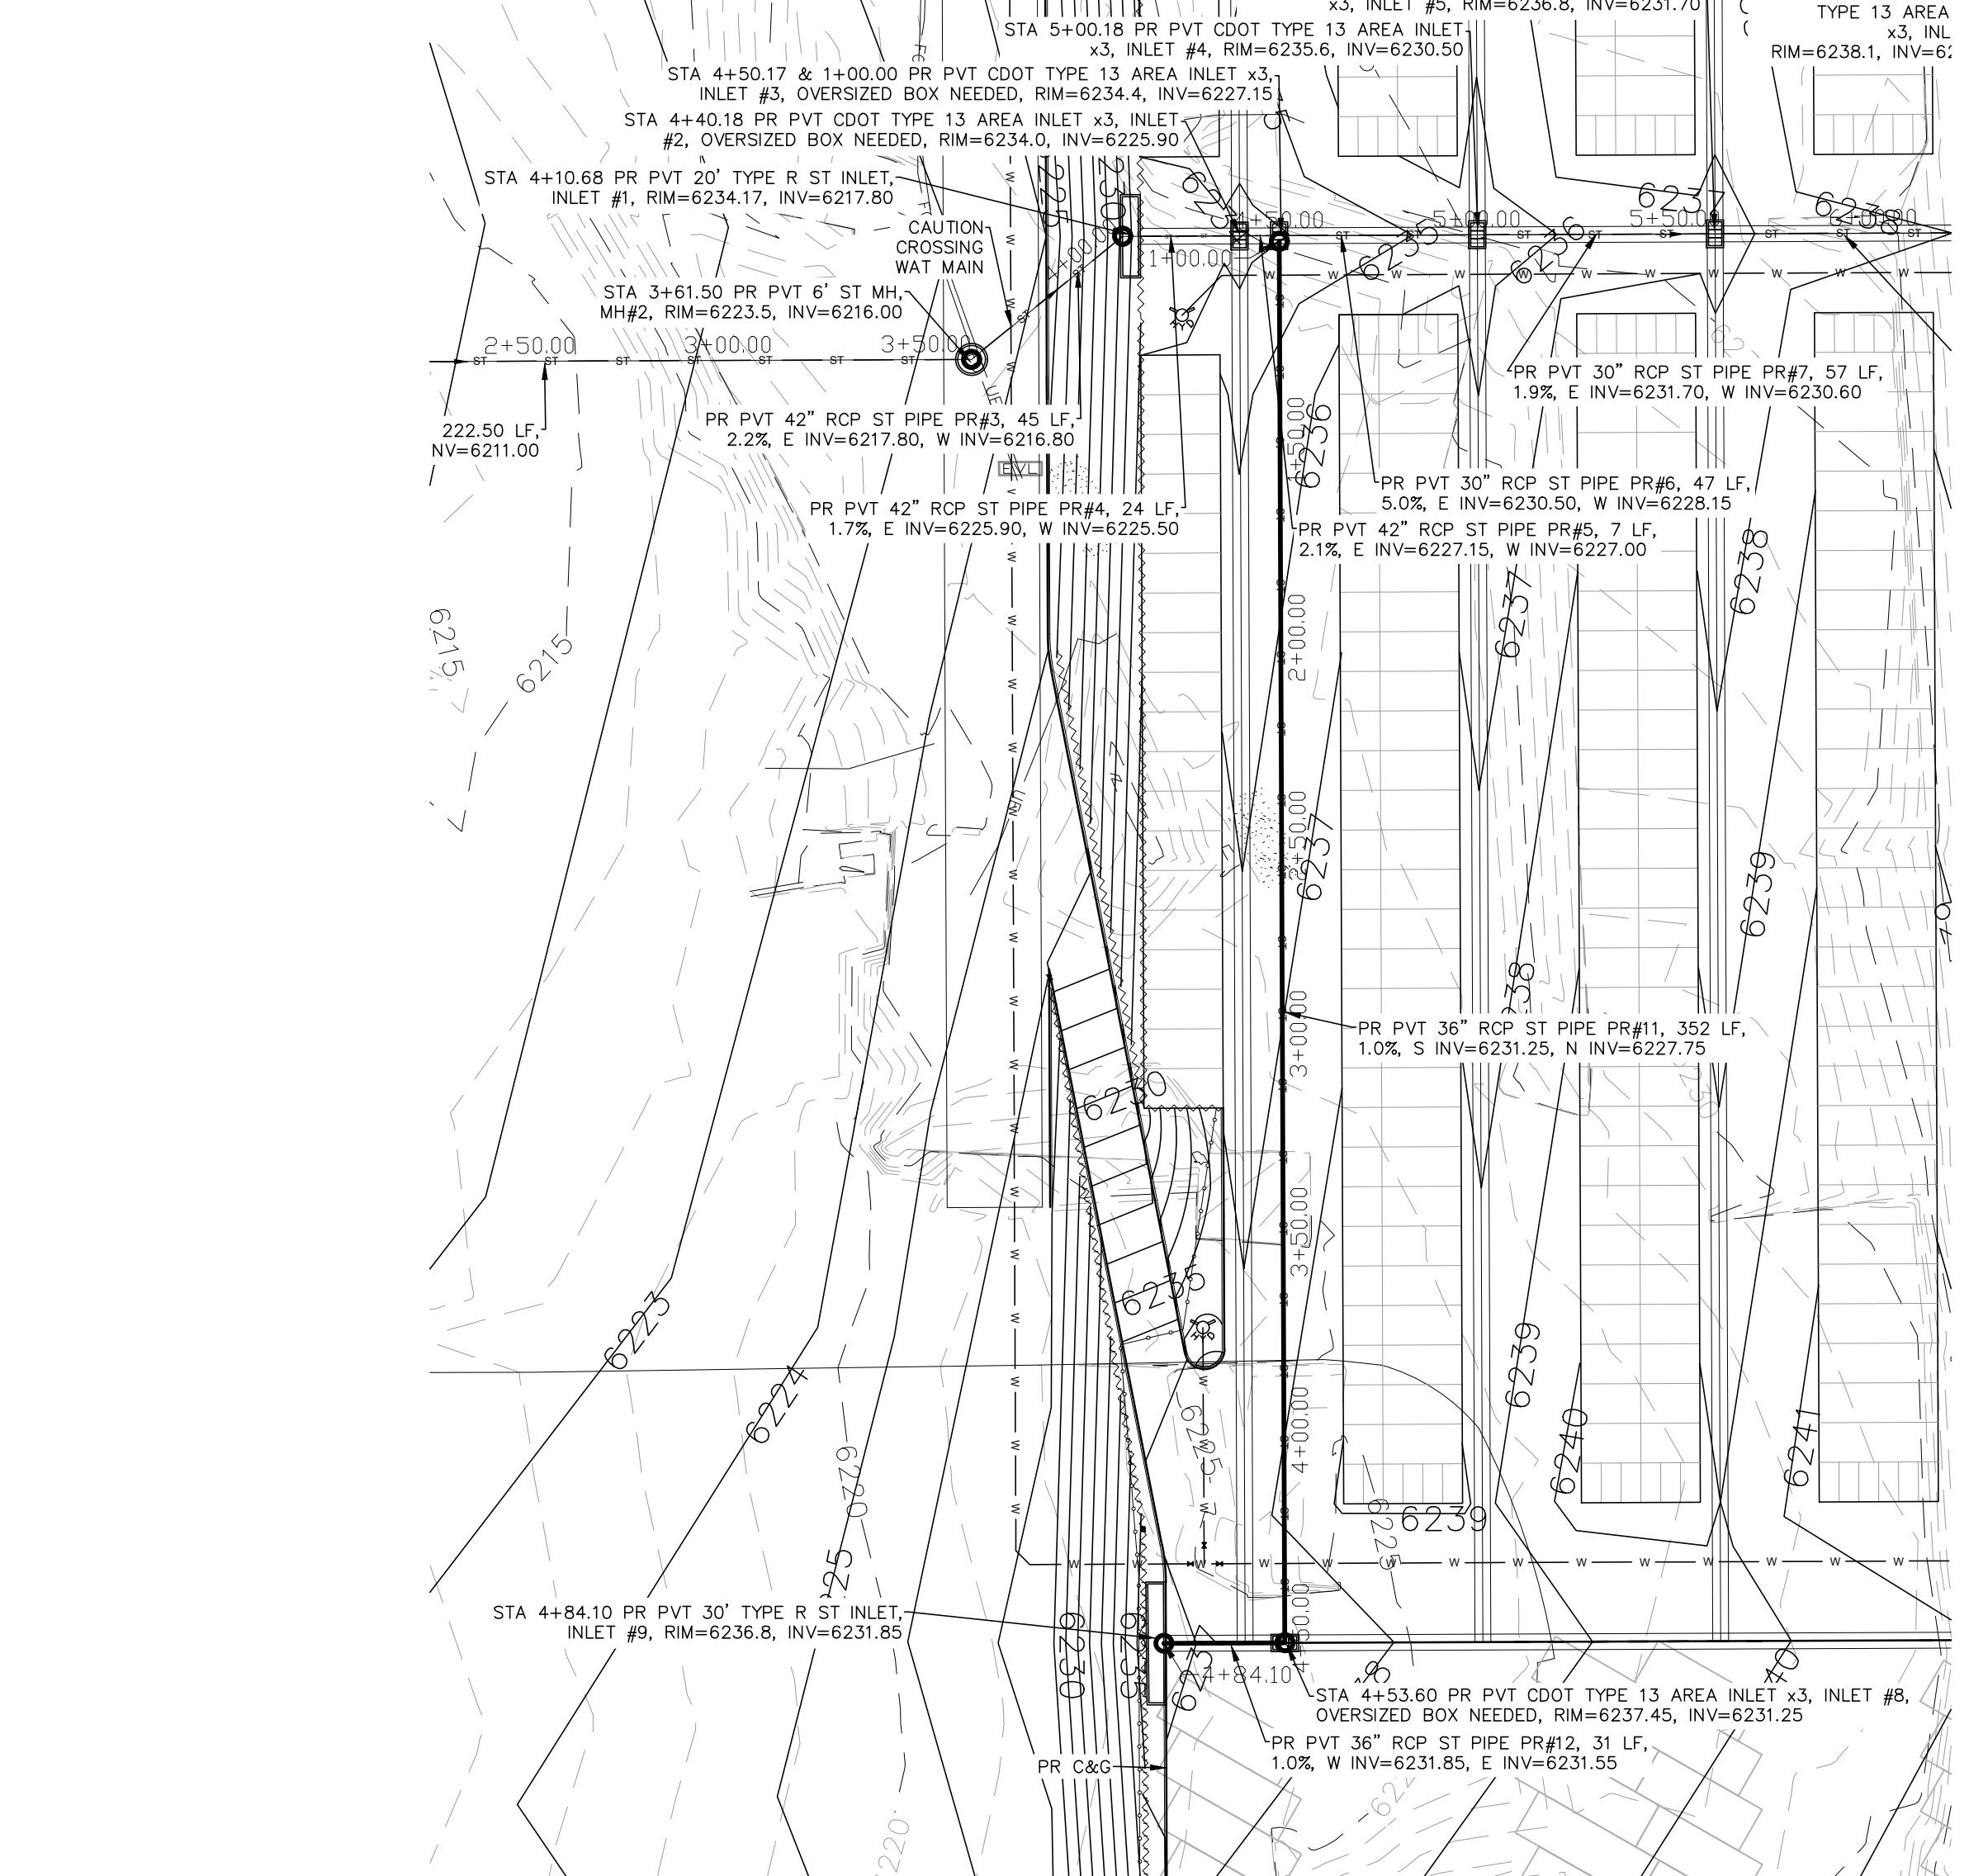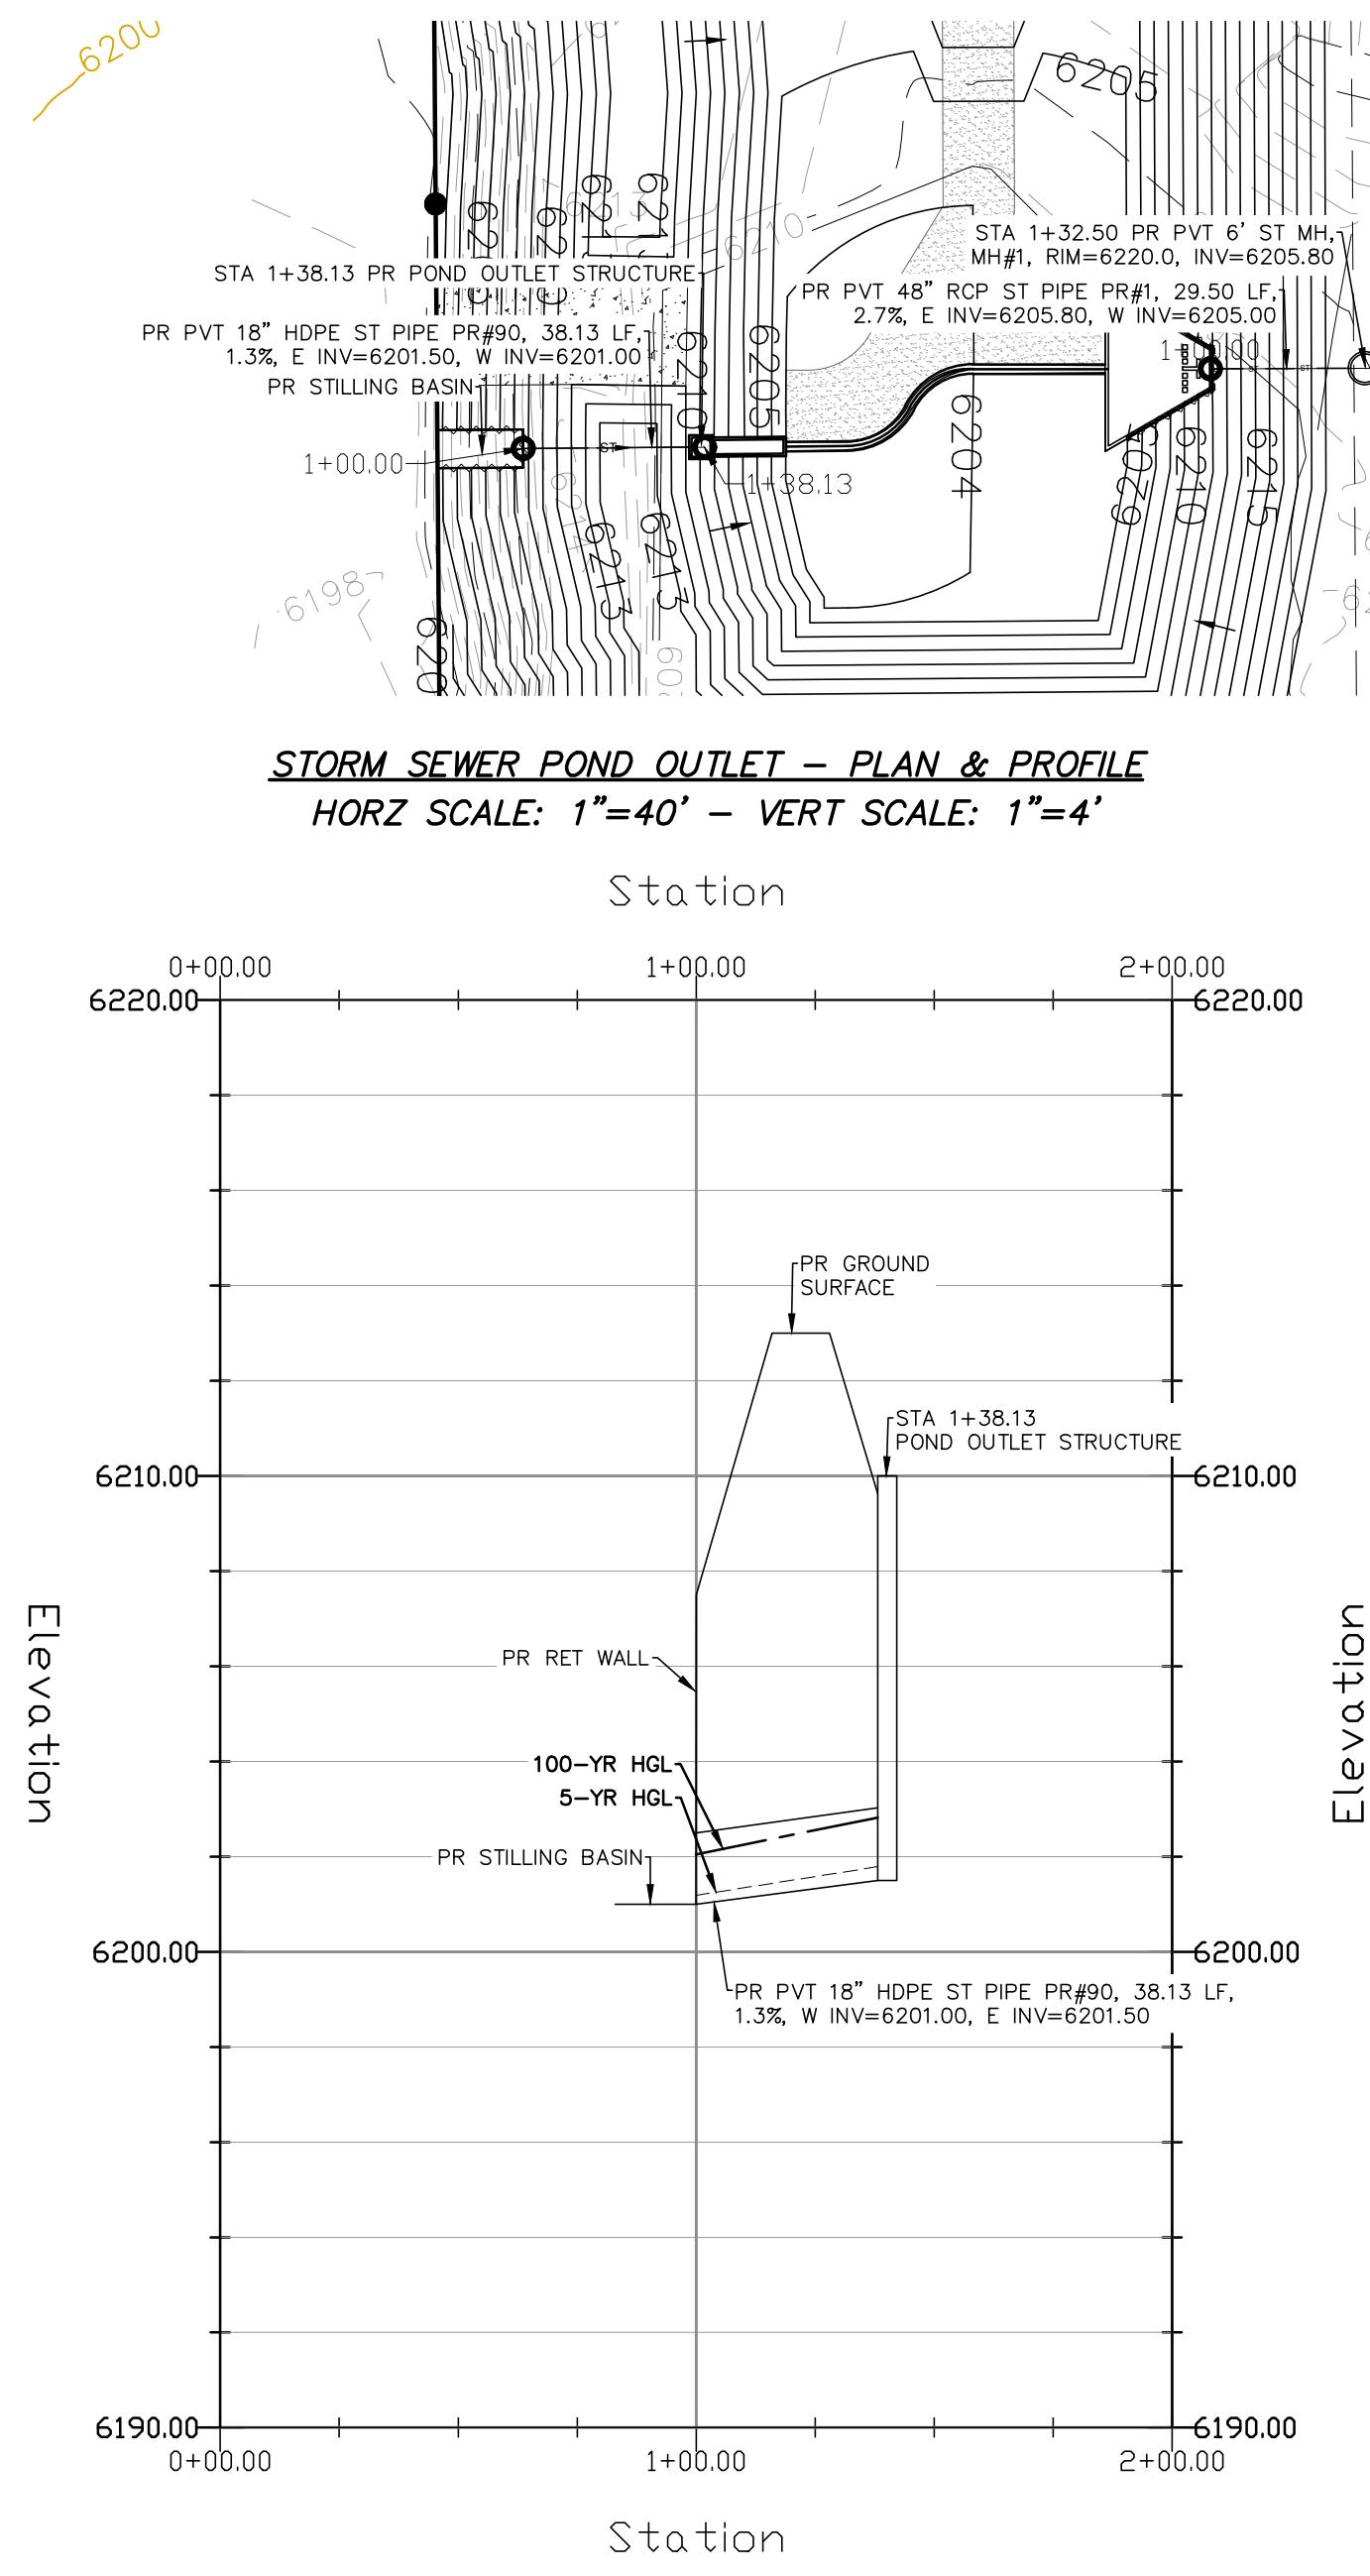DANE FRANK
COLORADO P.E. # 50207






GRADING LEGEND

PROPOSED	PR	EXISTING CONTOURS - MINOR	— — 6231 — —
EXISTING	EX	EXISTING CONTOURS - MAJOR	— — 6230 — —
FINISHED SURFACE	FS	PROPOSED CONTOURS - 1'	6231
FINISHED GROUND	FG	EXISTING PROPERTY LINE	~~~~~
TOP OF CURB	TC	PROPOSED RET WALL	
FLOWLINE	FL	PROPOSED RIPRAP	~~~~~
FINISH GROUND AT TOP OF WALL	TW	WATER LINE	v v
FINISHED GROUND AT BOTTOM OF WALL	BW	SANITARY SEWER LINE	ss ss
TELEPHONE LINE	UE	GAS LINE	ug ug
LOW POINT	LP	UNDERGROUND ELECTRICAL LINE	ue ue
HIGH POINT	HP	TELEPHONE LINE	ut ut
FLOW ARROW	FD	FIBER OPTIC LINE	fd fd
EXISTING CONTOURS (LIDAR)	ST	STORM SEWER LINE	st st
STORM MANHOLE	○	LIMIT OF CONSTRUCTION	— — — —
STORM INLET	□	LIMIT OF SOIL DISTURBANCE	— — — —
		PROPOSED FENCE	— — — —
		FIRE HYDRANT	● ●

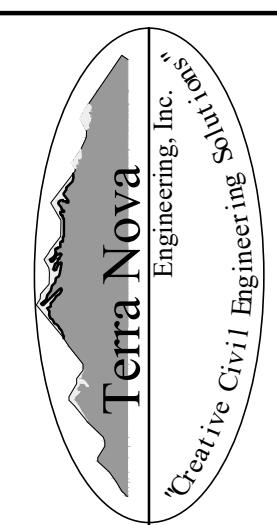
PREPARED FOR:
RMG-ROCKY MOUNTAIN GROUP
ATTN: 5085 LIST DR, #200
COLORADO SPRINGS, CO 80919
719.548.0600



721 S. 23RD STREET
COLORADO SPRINGS, CO 80904
OFFICE: 719-535-6422
FAX: 719-535-6426
www.tnreinc.com

PLATE SELF STORAGE

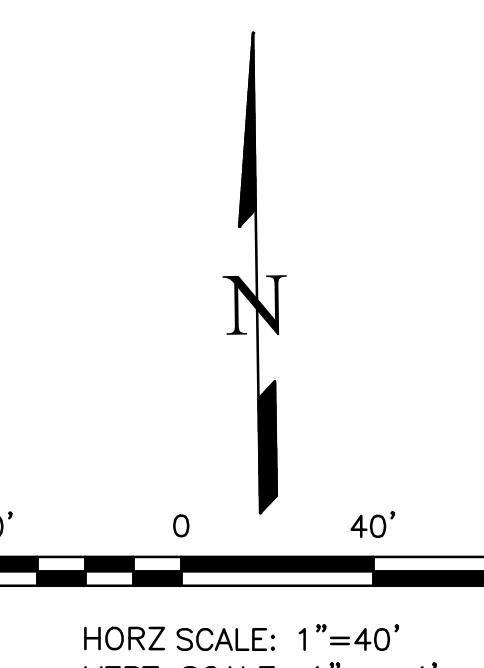STORM SEWER PLAN
SOUTH RUN & POND OUTLET - PLAN & PROFILE



THIS DESIGN WAS PREPARED UNDER MY DIRECT SUPERVISION
FOR AND ON BEHALF OF TERRA NOVA ENGINEERING, INC.

DANE FRANK
COLORADO P.E. # 50207

DESIGNED BY DLF
DRAWN BY DLF
CHECKED BY LD
H-SCALE AS SHOWN
V-SCALE N/A
JOB NO. 2419.00
DATE ISSUED 01/15/25
SHEET NO. 20 OF 28

REVISIONS
NO. _____
DESCRIPTION _____
DATE _____
UNTIL SUCH TIME AS THESE DRAWINGS ARE APPROVED
BY THE APPROPRIATE
REVIVING AGENCIES,
TERRA NOVA ENGINEERING,
INC. APPROVES THEIR USE
ONLY FOR THE PURPOSES DESIGNATED BY
WRITTEN AUTHORIZATION.

PLATTE SELF STORAGE


GRADING AND EROSION CONTROL PLAN

EXTENDED DETENTION BASIN PLAN


JANUARY 2025

GRADING LEGEND


PROPOSED	PR	EXISTING CONTOURS - MINOR	— 6231 —
EXISTING	EX	EXISTING CONTOURS - MAJOR	— 6230 —
FINISHED SURFACE	FS	PROPOSED CONTOURS - 1'	6231
FINISHED GROUND	FG	EXISTING PROPERTY LINE	~~~~~
TOP OF CURB	TC	PROPOSED RET WALL	██████
FLOWLINE	FL	WATER LINE	— v —
FISH GROUND AT TOP OF WALL	TW	SANITARY SEWER LINE	— SS —
FISH GROUND AT BOTTOM OF WALL	BW	UNDERGROUND ELECTRICAL LINE	— UG —
LOW POINT	LP	TELEPHONE LINE	— UT —
HIGH POINT	HP	FIBER OPTIC LINE	— FD —
LIMIT OF CONSTRUCTION		STORM SEWER LINE	— ST —
LIMIT OF SOIL DISTURBANCE			— - - - -
PROPOSED FENCE			— o o —
FLOW ARROW			→

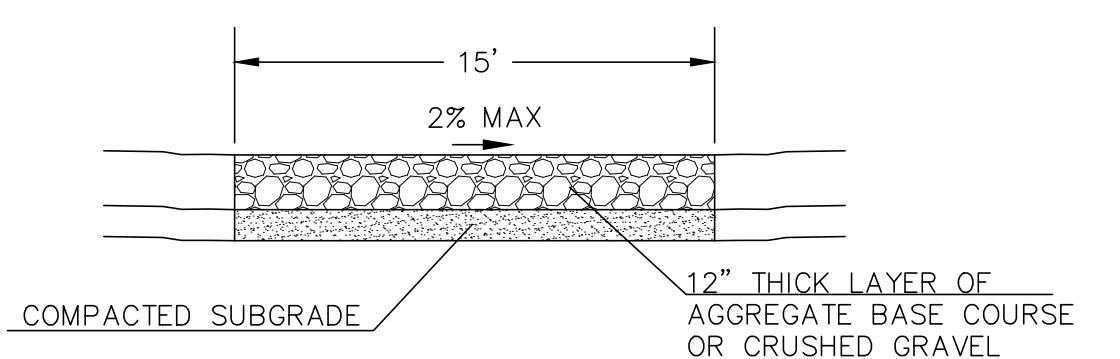

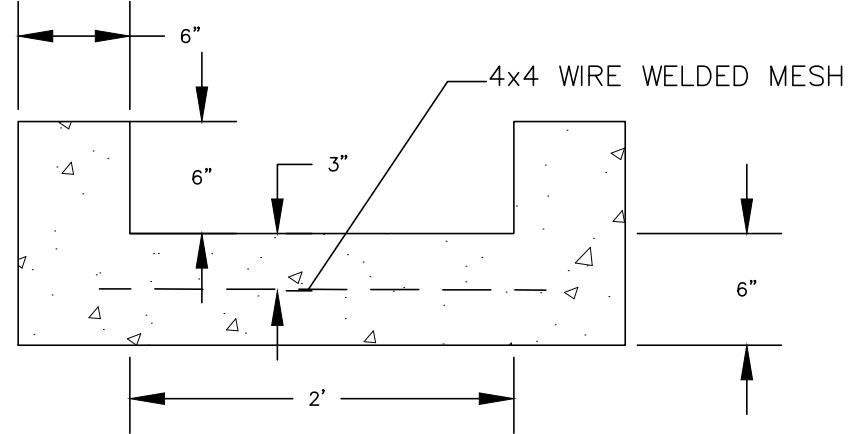
15' MAINTENANCE ACCESS ROAD SECTION
NOT TO SCALE



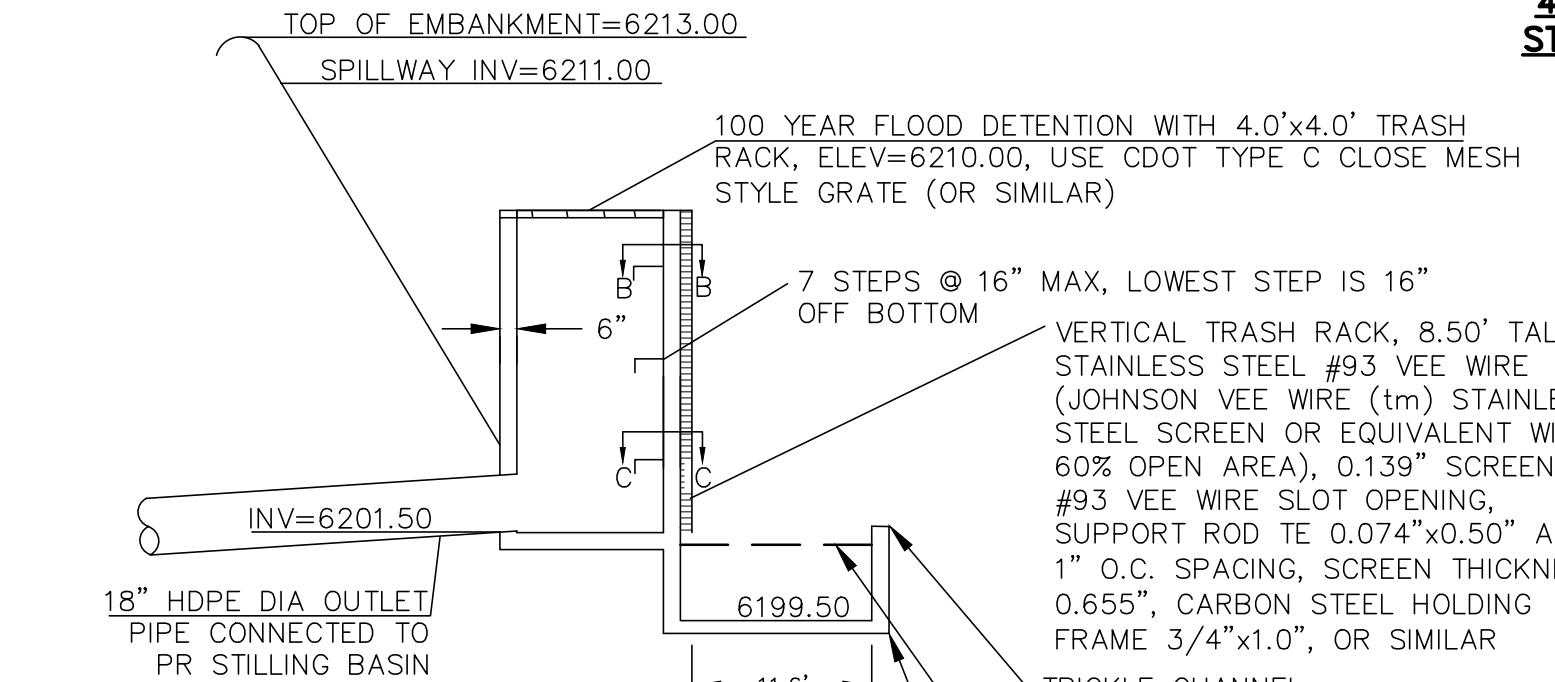
2' CONCRETE TRICKLE CHANNEL
NOT TO SCALE



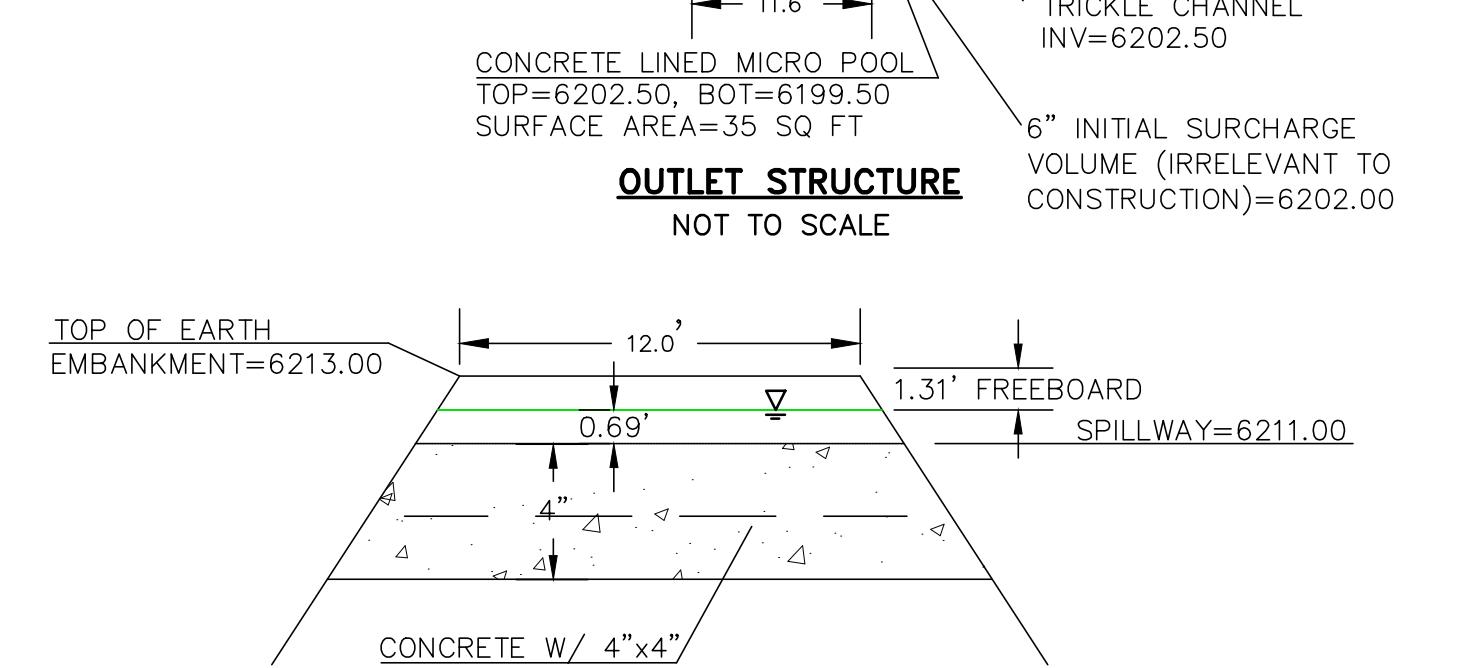4'x4' OUTLET BOX
STRUCTURAL DETAIL
NOT TO SCALE




EDB EMERGENCY WEIR
NOT TO SCALE

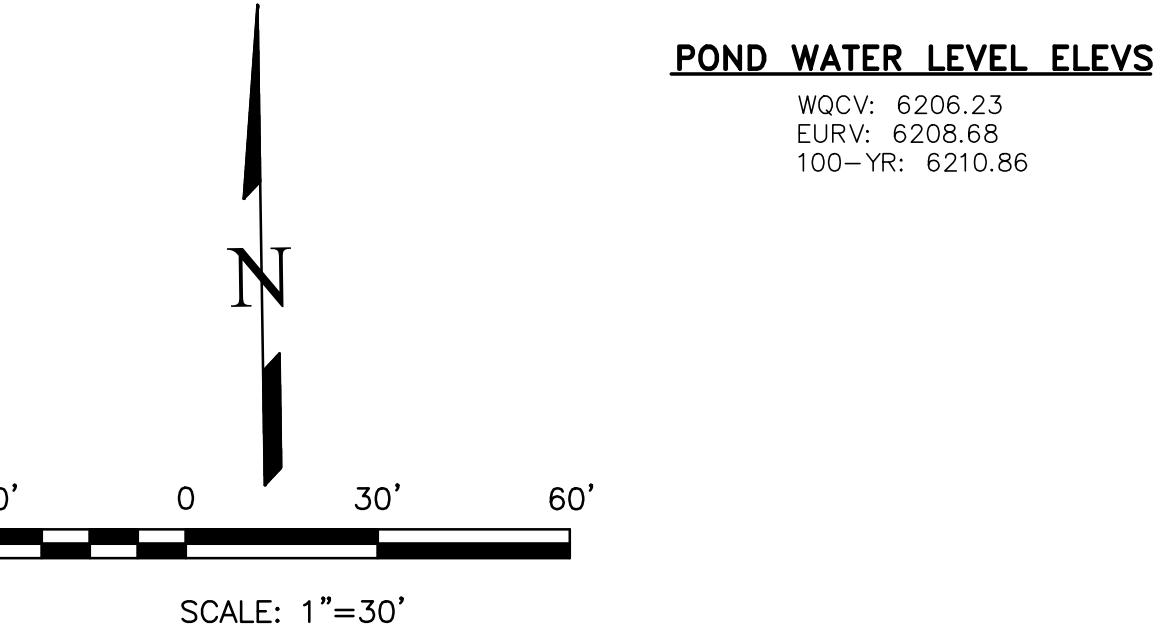


POND WATER LEVEL ELEV

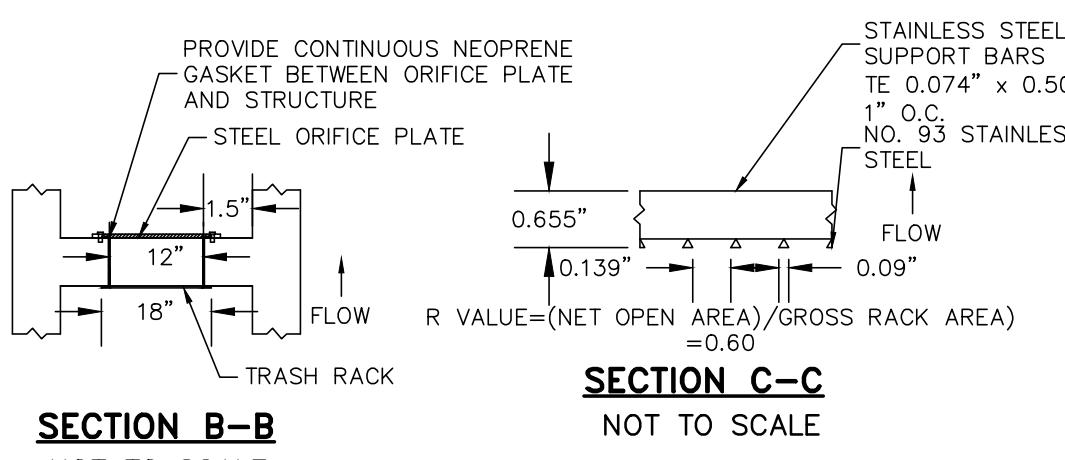
WQCV: 6206.23
EURV: 6208.68
100-YR: 6210.86




SECTION B-B
NOT TO SCALE

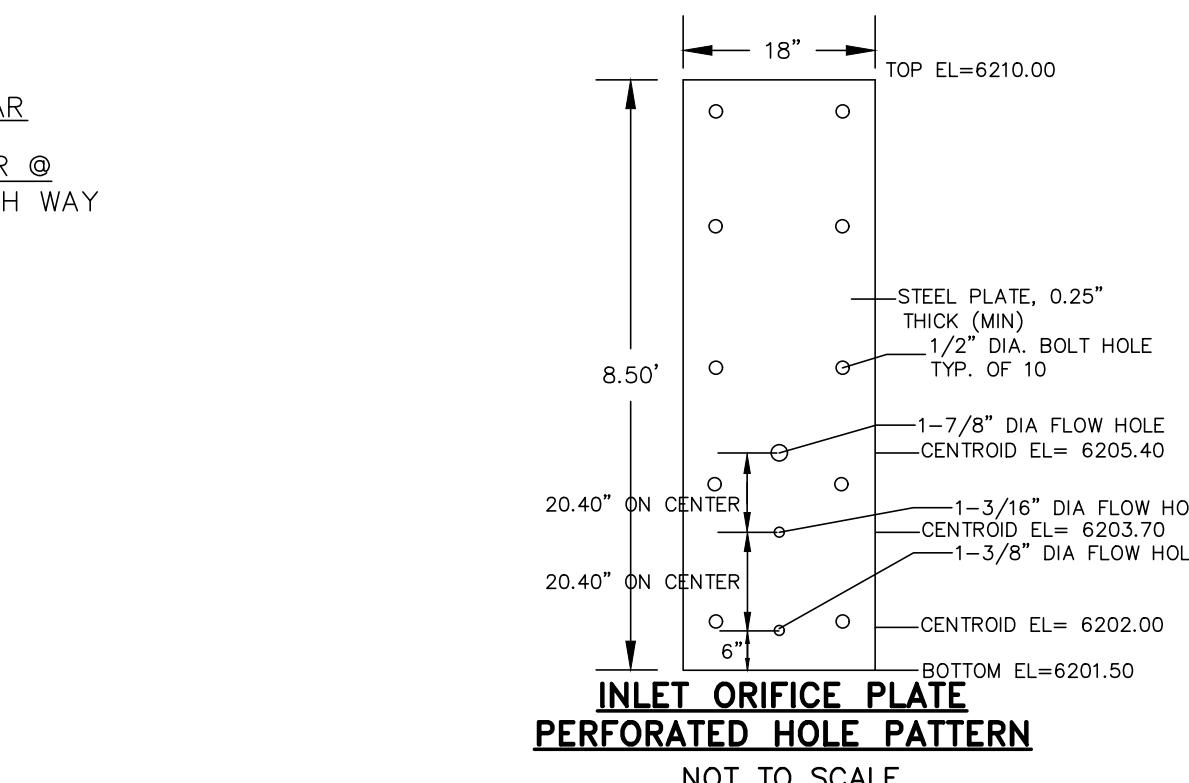

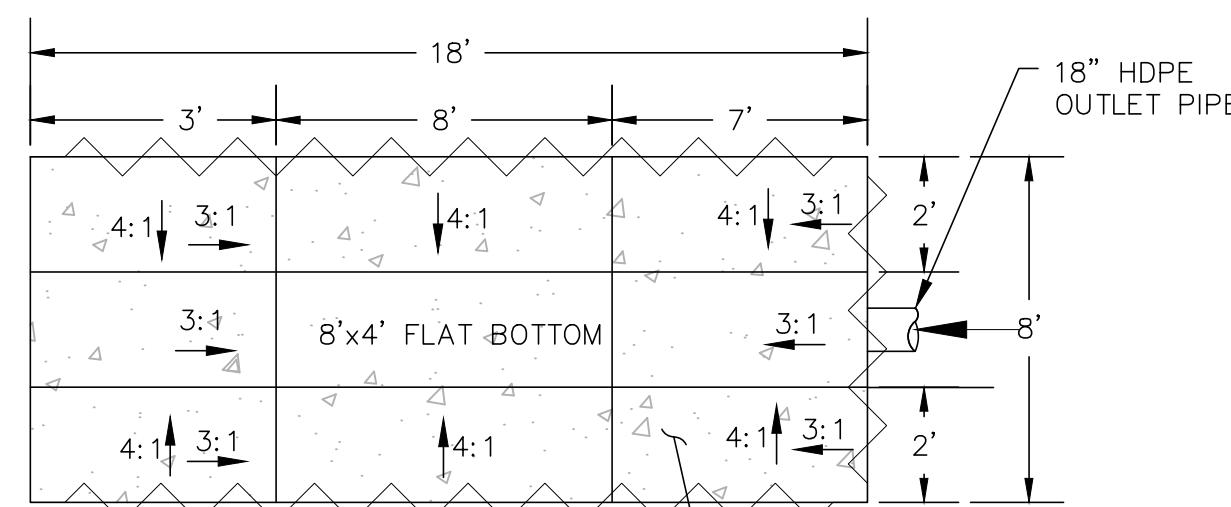INLET ORIFICE PLATE
PERFORATED HOLE PATTERN
NOT TO SCALE




PROFILE VIEW

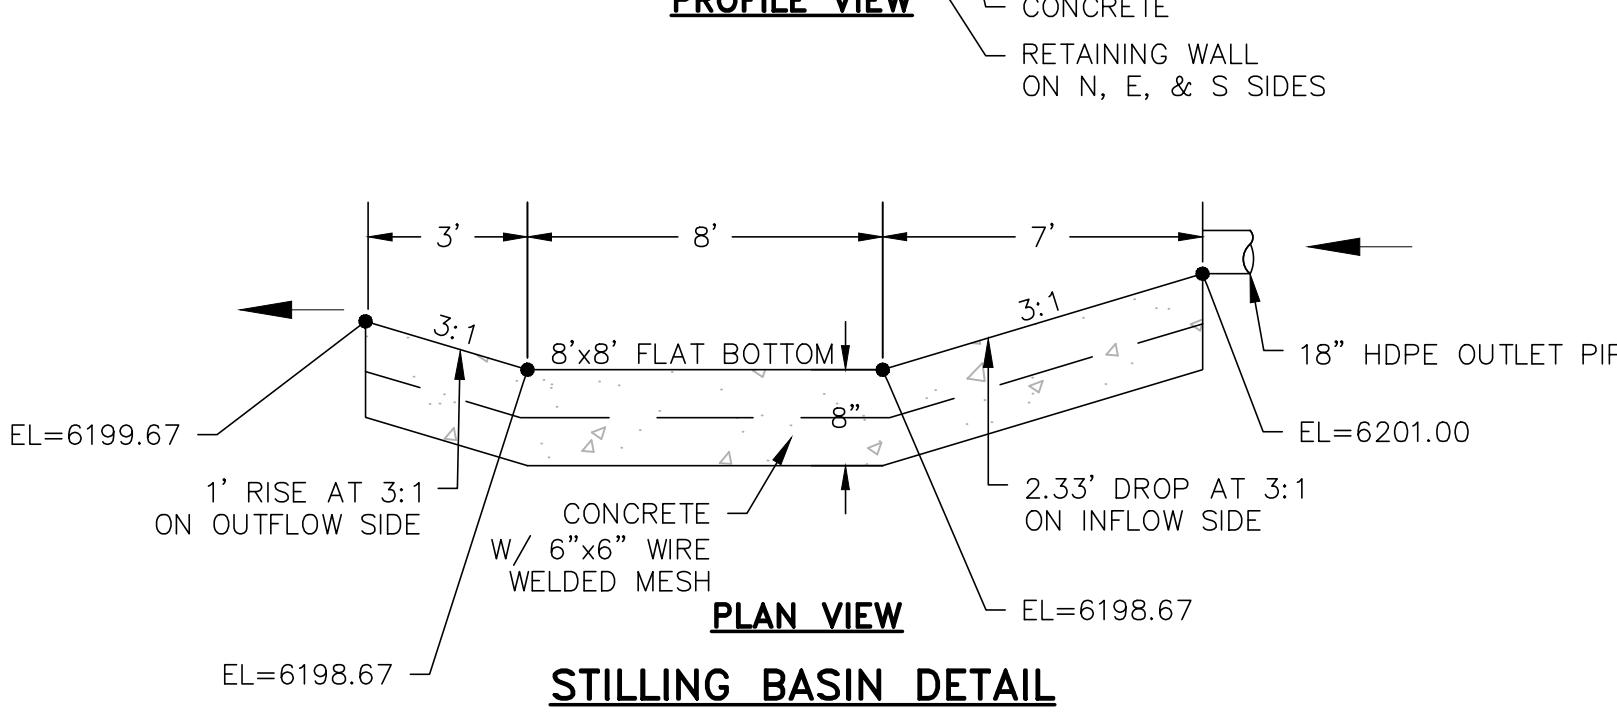

PLAN VIEW
NOT TO SCALE

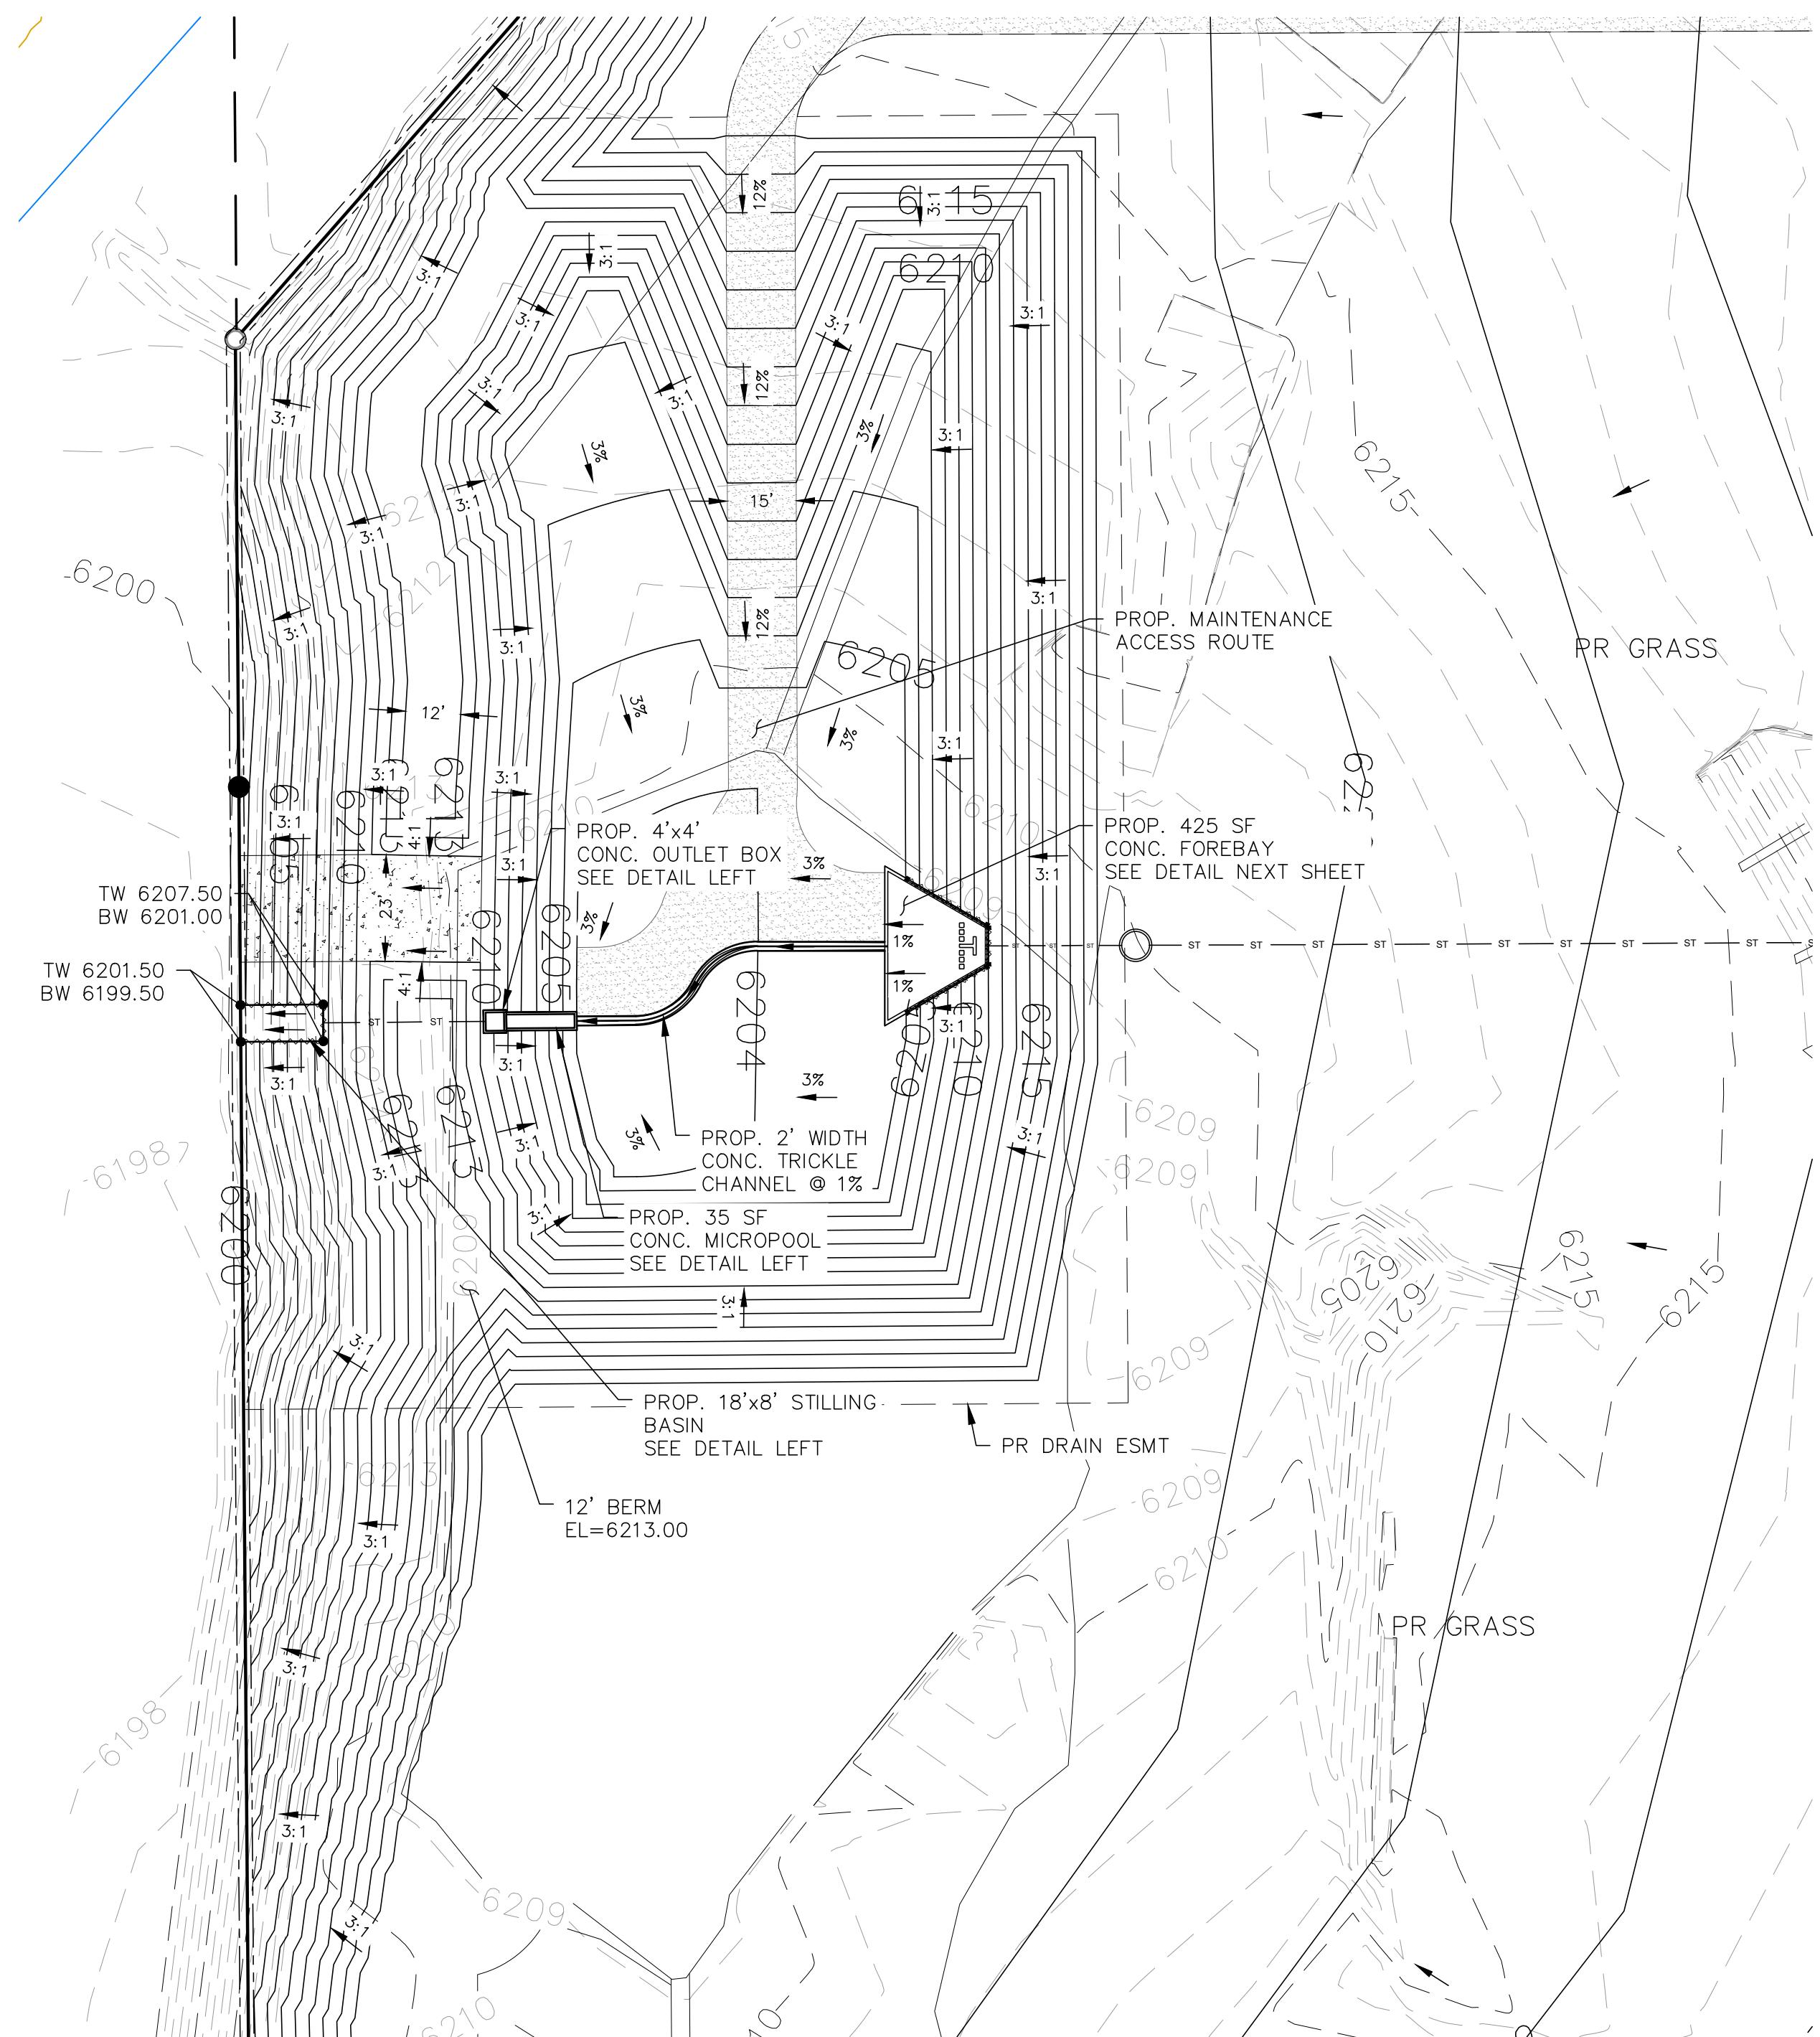STILLING BASIN DETAIL
NOT TO SCALE



NOTES


- ALL HDPE STORM PIPE IS TO BE SMOOTH INTERIOR PIPE.
- LARGE BLOCKS OF TEXT QUOTING STANDARD DRAWINGS OR DETAILS ARE INCLUDED AS A REQUIREMENT OF COUNTY REVIEWERS.

BENCHMARKS

- #5 REBAR WITH ORANGE PLASTIC CAP MARKED "CSAM, LLC PLS 32439", FLUSH WITH GROUND - ELEV.=6513.85 (NAVD-1988) [NORTHWEST PROPERTY CORNER]

REVISIONS	DATE
NO.	
DESCRIPTION	
UNTIL SUCH TIME AS THESE DRAWINGS ARE APPROVED BY THE APPROPRIATE REVIVING AGENCIES, TERRA NOVA ENGINEERING, INC. APPROVES THEIR USE ONLY FOR THE PURPOSES DESIGNATED BY WRITTEN AUTHORIZATION.	

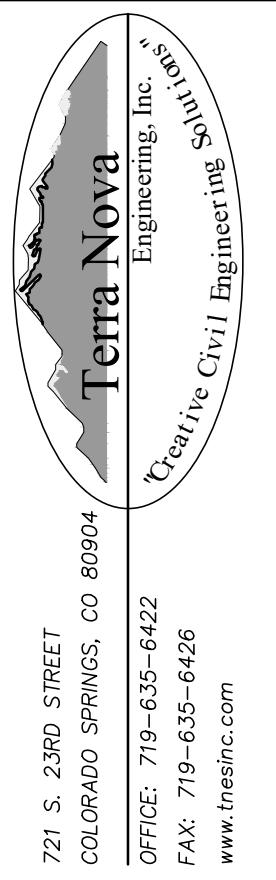PREPARED FOR:
RMG-ROCKY MOUNTAIN GROUP
ATTN: 5085 LIST DR, #200
COLORADO SPRINGS, CO 80919
719.548.0600



PLATTE SELF STORAGE

GRADING AND EROSION CONTROL PLAN
EXTENDED DETENTION BASIN PLAN

DESIGNED BY DLF
DRAWN BY DLF
CHECKED BY LD
H-SCALE AS SHOWN
V-SCALE N/A
JOB NO. 2419.00
DATE ISSUED 01/15/25
SHEET NO. 21 OF 28

THIS DESIGN WAS PREPARED UNDER MY DIRECT SUPERVISION FOR AND ON BEHALF OF TERRA NOVA ENGINEERING, INC.

DANE FRANK
COLORADO P.E. # 50207

**PLATTE SELF STORAGE
GRADING AND EROSION CONTROL PLAN
EXTENDED DETENTION BASIN PLAN
JANUARY 2025**

GRADING LEGEND

WALL, WINGWALL & SLAB STRUCTURAL DETAIL

N.T.S.

WING WALL

#5 E.F. @ 12"

6211.33

2 #5s CONTINUOUS AT TOP

#5 E.F. @ 12"

#5

12" 18"

FLOOR SLAB

7.9' TO 34.8'

#5 @ 12"
O.C. E.W.,

6205.00

6204.00

8"

8"

BAFFLE STRUCTURAL DETAIL

N.T.S.

BAFFLE

#5 E.F. @ 12"

5.0'

12" 18"

#4 BEND BAR @
12" O.C.

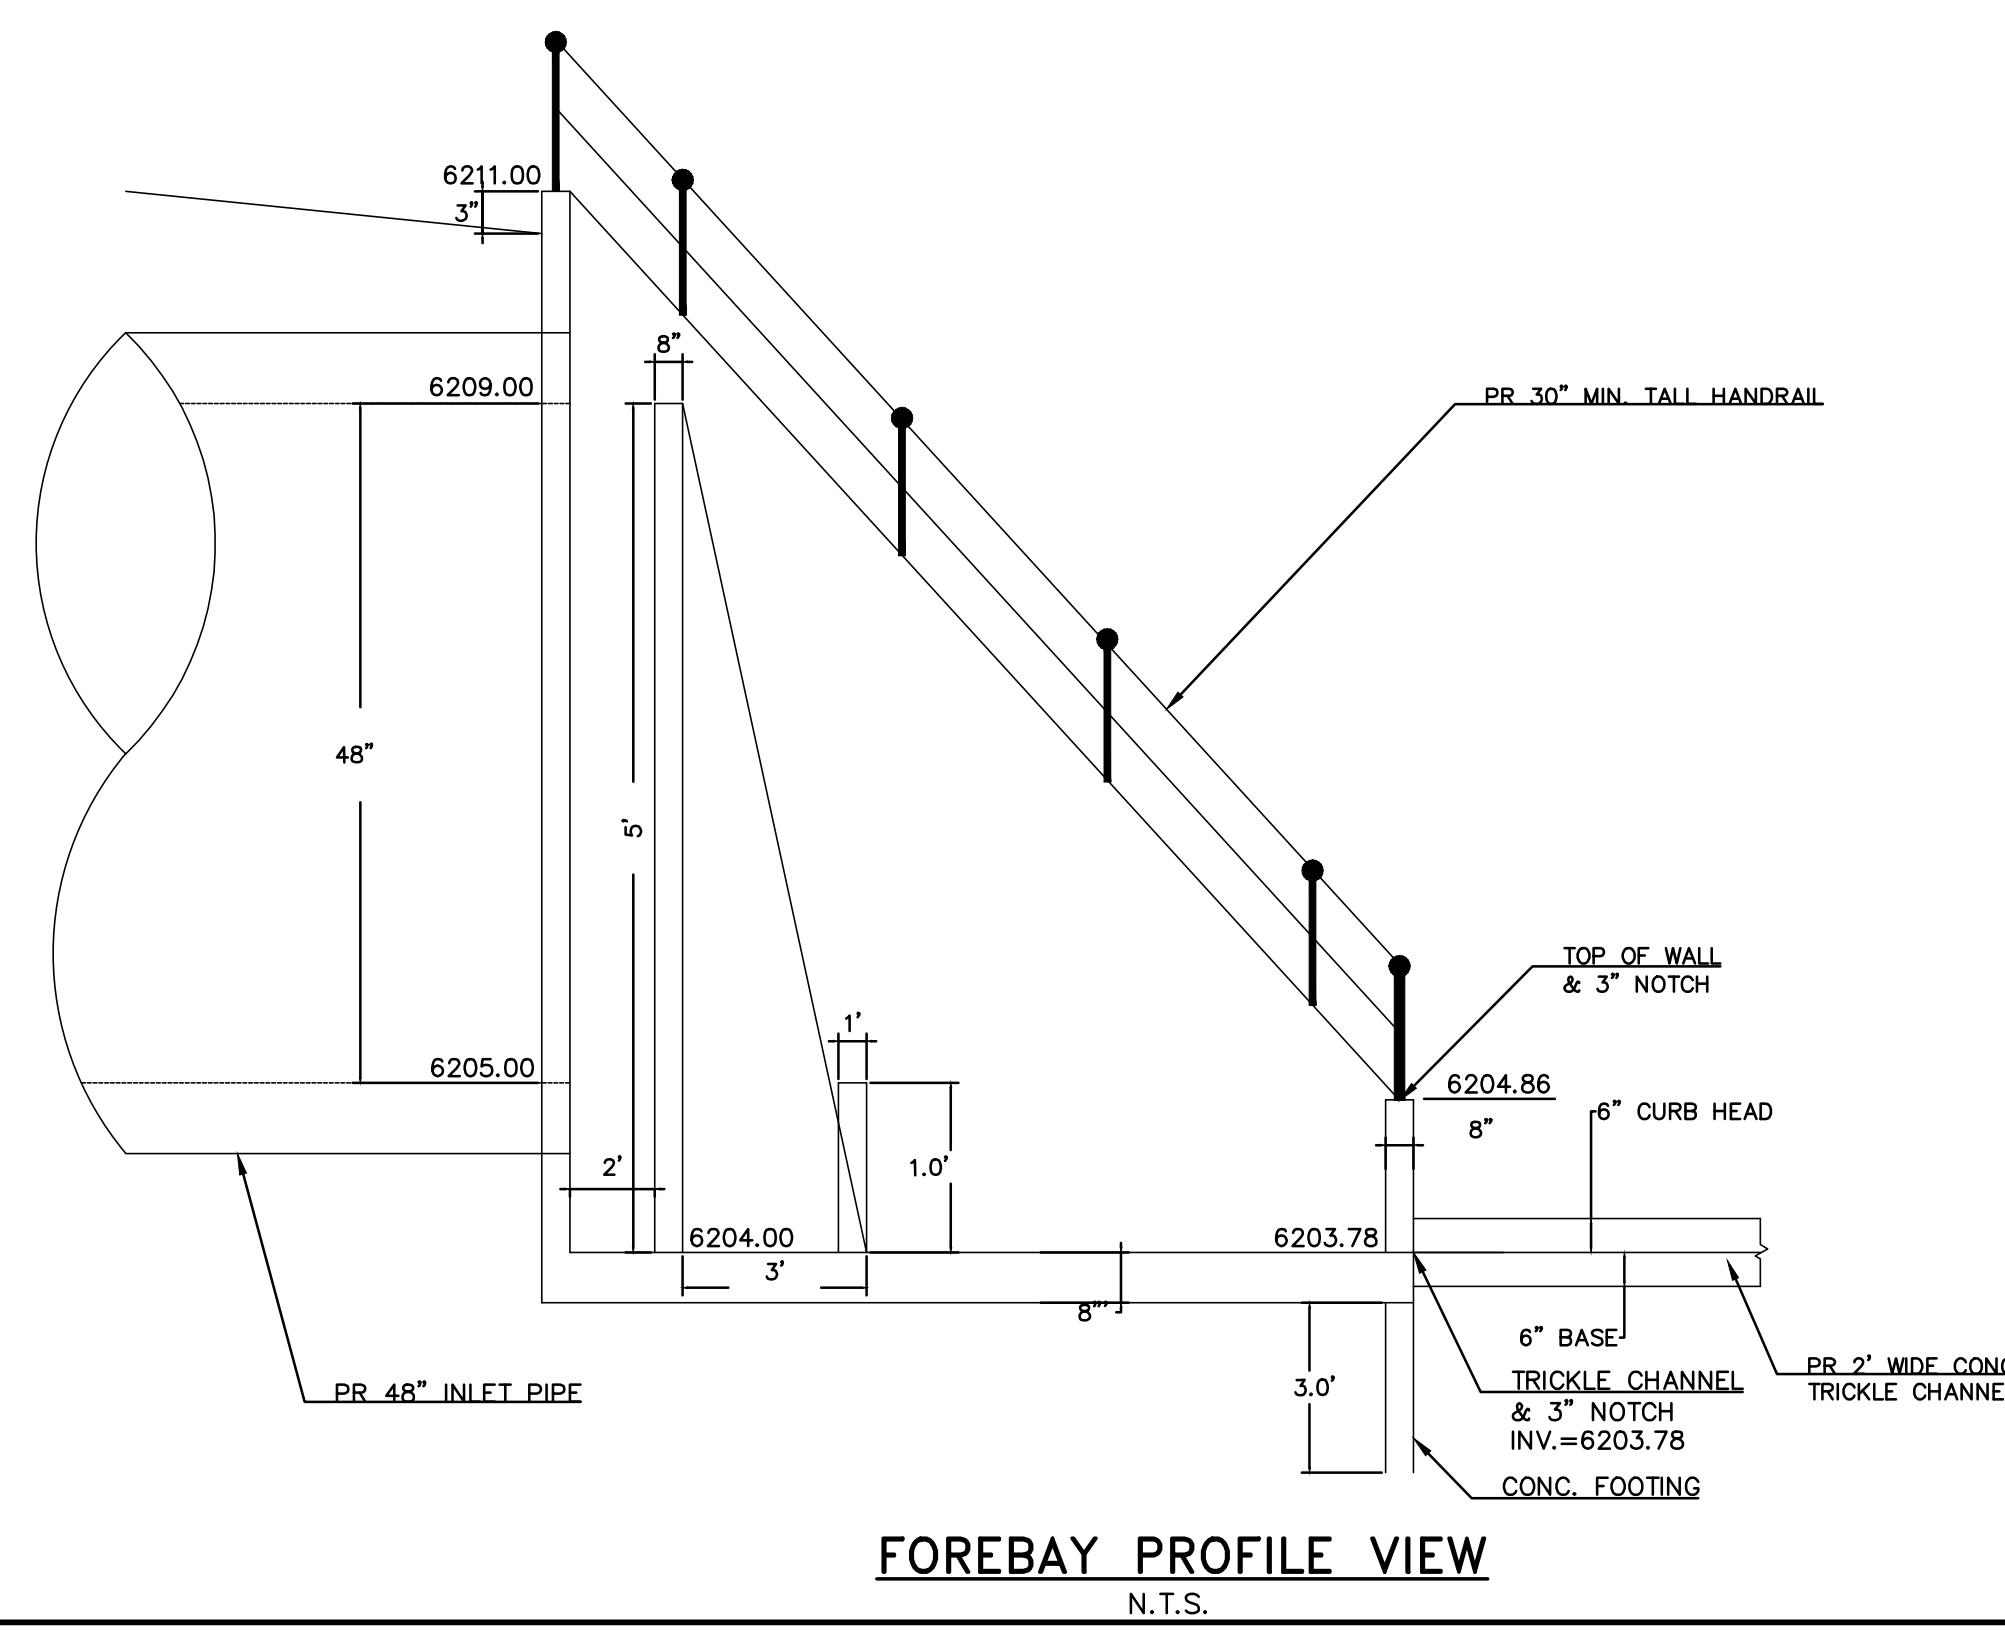
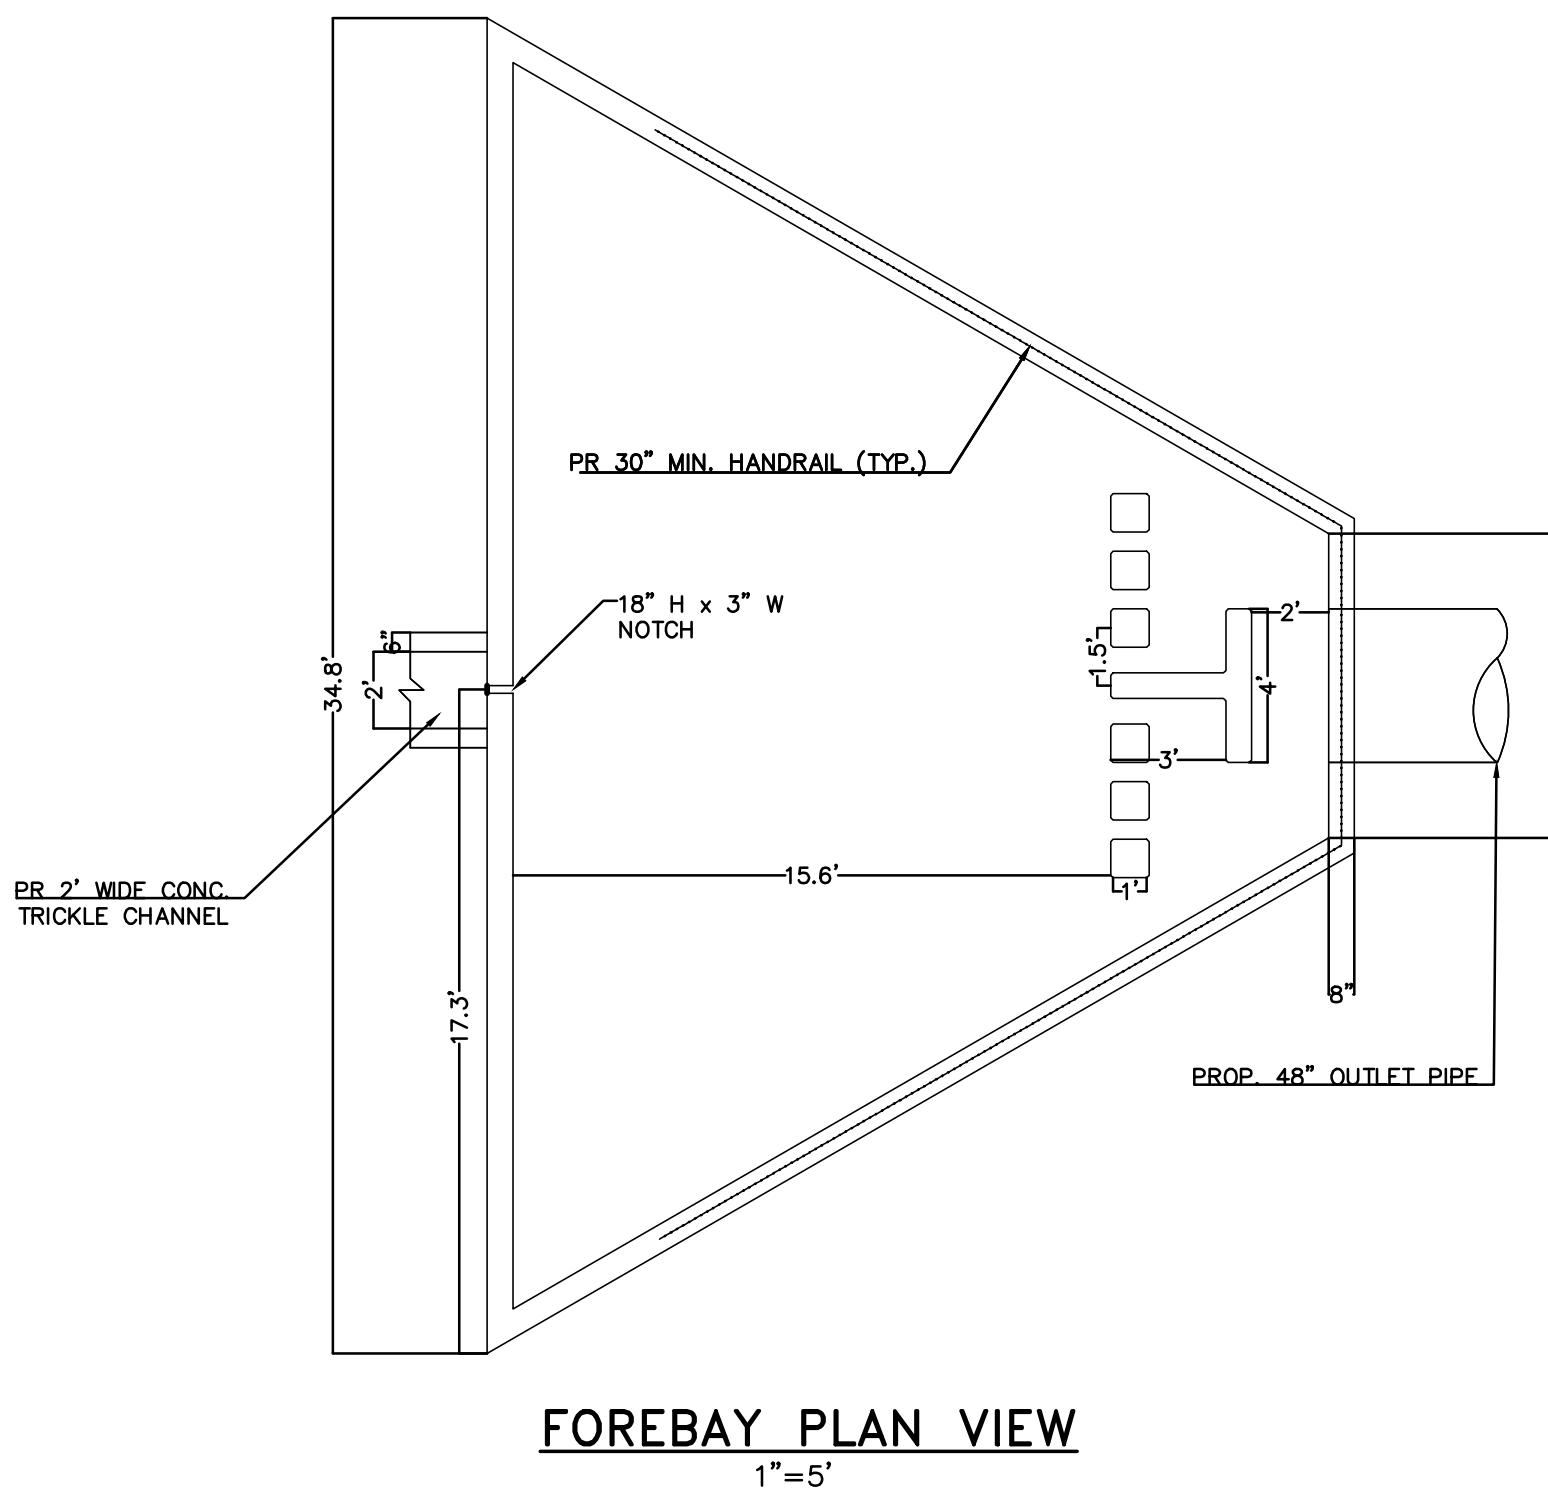
6204.00

8"

FLOOR SLAB

8"

8"




*THIS DESIGN WAS PREPARED UNDER MY DIRECT SUPERVISION
FOR AND ON BEHALF OF TERRA NOVA ENGINEERING, INC.*

DANE FRANK
COLORADO P.E. # 50207

REVISIONS	NO.	DESCRIPTION	DATE

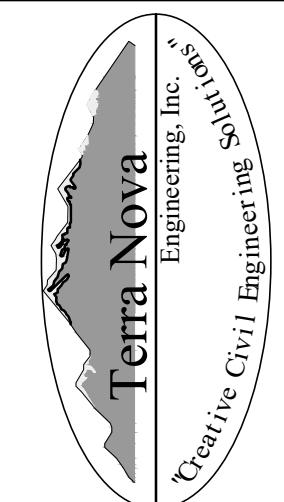PREPARED FOR:
RMG-ROCKY MOUNTAIN GROUP
ATTN:
5085 LIST DR, #200
COLORADO SPRINGS, CO 80915
719.548.0600



PLATTE SELF STORAGE

GRADING AND EROSION CONTROL PLAN EXTENDED DETENTION BASIN PLAN

DESIGNED BY	DLF
DRAWN BY	DLF
CHECKED BY	LD
H-SCALE	AS SHOWN
V-SCALE	N/A
JOB NO. 2419.00	
DATE ISSUED 01/15/25	
SHEET NO.	22 OF 28

NOTE: ALL EXISTING UNDERGROUND AND ABOVE GROUND UTILITY LOCATIONS, INVERTS AND SIZES ARE APPROXIMATE ONLY AND MUST BE FIELD VERIFIED PRIOR TO CONSTRUCTION. TIE IN POINTS SHALL BE POTHOLED AND LOCATIONS, INVERTS AND SIZES SHALL BE FIELD VERIFIED BY THE CONTRACTOR PRIOR TO CONSTRUCTION.

EL PASO COUNTY STANDARD CONSTRUCTION NOTES:

1. ALL DRAINAGE AND ROADWAY CONSTRUCTION SHALL MEET THE STANDARDS AND SPECIFICATIONS OF THE CITY OF COLORADO SPRINGS/EL PASO COUNTY DRAINAGE CRITERIA MANUAL, VOLUMES 1 & 2 AND THE EL PASO COUNTY ENGINEERING CRITERIA MANUAL.
2. CONTRACTOR SHALL BE RESPONSIBLE FOR THE NOTIFICATION AND FIELD NOTIFICATION OF ALL EXISTING UTILITIES, WHETHER SHOWN ON THE PLANS OR NOT, BEFORE BEGINNING CONSTRUCTION. LOCATION OF EXISTING UTILITIES SHALL BE VERIFIED BY THE CONTRACTOR PRIOR TO CONSTRUCTION. CALL 811 TO CONTACT THE UTILITY NOTIFICATION CENTER OF COLORADO (UNCC).
3. CONTRACTOR SHALL KEEP A COPY OF THESE APPROVED PLANS, THE GRADING AND EROSION CONTROL PLAN, THE STORMWATER MANAGEMENT PLAN (SMP), THE SOILS AND GEOTECHNICAL REPORT, AND THE APPROPRIATE DESIGN AND CONSTRUCTION STANDARDS AND SPECIFICATIONS AT THE JOB SITE AT ALL TIMES, INCLUDING THE FOLLOWING:
 - A. EL PASO COUNTY ENGINEERING CRITERIA MANUAL (ECM)
 - B. CITY OF COLORADO SPRINGS/EL PASO COUNTY DRAINAGE CRITERIA MANUAL, VOLUMES 1 & 2
 - C. COLORADO DEPARTMENT OF TRANSPORTATION (CDOT) STANDARD SPECIFICATIONS FOR ROAD AND BRIDGE CONSTRUCTION
 - D. CDOT M & S STANDARDS
4. NOTWITHSTANDING ANYTHING DEPICTED IN THESE PLANS IN WORDS OR GRAPHIC REPRESENTATION, ALL DESIGN AND CONSTRUCTION RELATED TO ROADS, STORM DRAINAGE AND EROSION CONTROL SHALL CONFORM TO THE STANDARDS AND REQUIREMENTS OF THE MOST RECENT VERSION OF THE RELEVANT ADOPTED EL PASO COUNTY STANDARDS, INCLUDING THE LAND DEVELOPMENT CODE, THE ENGINEERING CRITERIA MANUAL, THE DRAINAGE CRITERIA MANUAL, AND THE DRAINAGE CRITERIA MANUAL VOLUME 2. ANY DEVIATIONS FROM REGULATIONS AND STANDARDS MUST BE REQUESTED, AND APPROVED, IN WRITING. ANY MODIFICATIONS NECESSARY TO MEET CRITERIA AFTER-THE-FACE WILL BE ENTIRELY THE DEVELOPER'S RESPONSIBILITY TO RECTIFY.
5. IT IS THE DESIGN ENGINEER'S RESPONSIBILITY TO ACCURATELY SHOW EXISTING CONDITIONS, BOTH ON SITE AND OFF-SITE, ON THE CONSTRUCTION PLANS. ANY MODIFICATIONS NECESSARY DUE TO CONFLICTS, OMISSIONS, OR CHANGED CONDITIONS WILL BE ENTIRELY THE DEVELOPER'S RESPONSIBILITY TO RECTIFY.
6. CONTRACTOR SHALL SCHEDULE A PRE-CONSTRUCTION MEETING WITH EL PASO COUNTY PLANNING AND COMMUNITY DEVELOPMENT (PCD) INSPECTIONS, PRIOR TO STARTING CONSTRUCTION.
7. IT IS THE CONTRACTORS RESPONSIBILITY TO UNDERSTAND THE REQUIREMENTS OF ALL JURISDICTIONAL AGENCIES AND TO OBTAIN ALL REQUIRED PERMITS, INCLUDING BUT NOT LIMITED TO EL PASO COUNTY EROSION AND STORMWATER QUALITY CONTROL PERMIT (ESQCP), REGIONAL BUILDING FLOODPLAIN DEVELOPMENT PERMIT, U.S. ARMY CORPS OF ENGINEERS-ISSUED 401 AND/OR 404 PERMITS, AND COUNTY AND STATE FUGITIVE DUST PERMITS.
8. CONTRACTOR SHALL NOT DEVIATE FROM THE PLANS WITHOUT FIRST OBTAINING WRITTEN APPROVAL FROM THE DESIGN ENGINEER AND PCD. CONTRACTOR SHALL NOTIFY THE DESIGN ENGINEER IMMEDIATELY UPON DISCOVERY OF ANY ERRORS OR INCONSISTENCIES.
9. ALL STORM DRAIN PIPE SHALL BE CLASS III RCP UNLESS OTHERWISE NOTED AND APPROVED BY PCD.
10. CONTRACTOR SHALL COORDINATE GEOTECHNICAL TESTING PER ECM STANDARDS. PAVEMENT DESIGN SHALL BE APPROVED BY EL PASO COUNTY PCD PRIOR TO PLACEMENT OF CURB AND GUTTER AND PAVEMENT.
11. ALL CONSTRUCTION TRAFFIC MUST ENTER/EXIT THE SITE AT APPROVED CONSTRUCTION ACCESS POINTS.
12. SIGHT VISIBILITY TRIANGLES AS IDENTIFIED IN THE PLANS SHALL BE PROVIDED AT ALL INTERSECTIONS. OBSTRUCTIONS GREATER THAN 18 INCHES ABOVE FLOWLINE ARE NOT ALLOWED WITHIN SIGHT TRIANGLES.
13. SIGNING AND STRIPING SHALL COMPLY WITH EL PASO COUNTY PUBLIC WORK DEPARTMENT AND MUTCD CRITERIA.
14. CONTRACTOR SHALL OBTAIN ANY PERMITS REQUIRED BY EL PASO COUNTY PWD, INCLUDING WORK WITHIN THE RIGHT-OF-WAY AND SPECIAL TRANSPORT PERMITS.
15. THE LIMITS OF CONSTRUCTION SHALL REMAIN WITHIN THE PROPERTY LINE UNLESS OTHERWISE NOTED. THE OWNER/DEVELOPER SHALL OBTAIN WRITTEN PERMISSION AND EASEMENTS, WHERE REQUIRED, FROM ADJOINING PROPERTY OWNER(S) PRIOR TO ANY OFF-SITE DISTURBANCE, GRADING OR CONSTRUCTION.

GENERAL NOTES

1. IT SHALL BE THE RESPONSIBILITY OF THE CONTRACTOR TO VERIFY THE EXISTENCE AND LOCATION OF ALL UNDERGROUND UTILITIES ALONG THE SITE. THE OMISSION FROM OR THE INCLUSION OF UTILITY LOCATIONS ON THE PLANS IS NOT TO BE CONSIDERED AS THE NON-EXISTENCE OR OF A DEFINITE LOCATION OF EXISTING UNDERGROUND UTILITIES.
2. THE CONTRACTOR WILL TAKE THE NECESSARY PRECAUTIONS TO PROTECT EXISTING UTILITIES, BUILDINGS, FENCES, AND ROADWAYS FROM DAMAGE DUE TO THIS OPERATION. ANY DAMAGE TO THE ABOVE WILL BE REPAIRED AT THE CONTRACTOR'S EXPENSE, AND ANY SERVICE DISRUPTION WILL BE SETTLED BY THE CONTRACTOR.
3. BULK GRADING SHALL BE COMPLETED TO A SUBGRADE TOLERANCE OF PLUS OR MINUS 0.2".
4. CONTRACTOR TO OBTAIN COPIES OF THE SOILS REPORT FROM THE GEOTECHNICAL ENGINEER AND TO BE KEPT ON SITE DURING ALL EARTHWORK OPERATIONS. CONTRACTOR SHALL REVIEW GEOTECHNICAL REPORT BY GEOTECHNICAL ENGINEER PRIOR TO CONSTRUCTION.
5. MAXIMUM CUT/FILL SLOPES SHALL NOT EXCEED 3:1, UNLESS OTHERWISE NOTED.
6. EROSION CONTROL MEASURES SHALL BE IMPLEMENTED IN A MANNER THAT WILL PROTECT PROPERTIES AND PUBLIC FACILITIES FROM THE ADVERSE EFFECTS OF EROSION AND SEDIMENTATION AS A RESULT OF CONSTRUCTION AND EARTHWORK ACTIVITIES WITHIN THE PROJECT SITE.
7. EROSION CONTROL DEVICES SHOULD BE CHECKED AFTER EVERY STORM. REPAIRS OR REPLACEMENT SHOULD BE MADE AS NECESSARY TO MAINTAIN PROPER PROTECTION.
8. CONTRACTOR SHALL REVIEW GEOTECHNICAL REPORT BY GEOTECHNICAL ENGINEER PRIOR TO CONSTRUCTION.
9. BROWN GROUND SURFACE CONTOURS ARE LIDAR DATA DOWNLOADED FROM THE COLORADO HAZARD MAPPING & RISK MAP PORTAL, DATA SET: 2018_3DEP_EAST_CO_EL_PASO. THIS DATA IS APPROXIMATE. LIDAR DATA IS FROM 2018 AND AT 2' INTERVALS.

PLATTE SELF STORAGE STREET IMPROVEMENT PLAN COVER SHEET JANUARY 2025



SITE ADDRESS
6001 E PLATTE AVE, COLORADO SPRINGS

TAX ID
5418000075

LEGAL DESCRIPTION

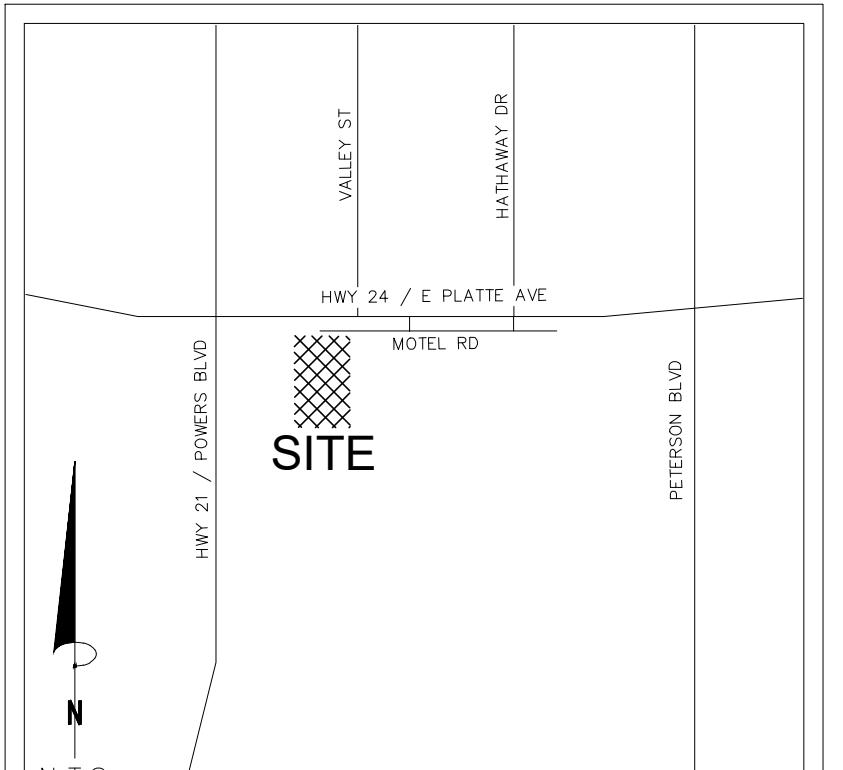
TRACT IN NW4 OF SEC 18-14-65 AS FOLS, BEG AT A PT ON S R/W LN OF US HWY 24 940 FT E OF W LN OF SD SEC, TH E ON SD LN 310 FT, ANG R 90< S 25 FT, ANG L 90< E 155.2 FT M/L, S 931.8 FT, W PARA WITH S LN OF N2 426.1 FT M/L TO A PT, TH ANG R 89<59' N 958.2 FT TO POB, W 349.88 FT OF NE4NW4 OF SEC 18 EX HWY BY BK 6509-223 & REC #201040780

SOIL TYPES


ONSITE SOILS ARE HYDROLOGIC GROUP "A", BLAKELAND LOAMY SAND (8), 1 TO 9 PERCENT SLOPES (PER NRCS WEB SOIL SURVEY MAP)

BENCHMARKS

CDOT RIGHT OF WAY MONUMENT #3014 – ELEV=6232.52 (NAVD-1988)
[NORTHEAST OF SITE ENTRANCE]



VICINITY MAP
N.T.S.

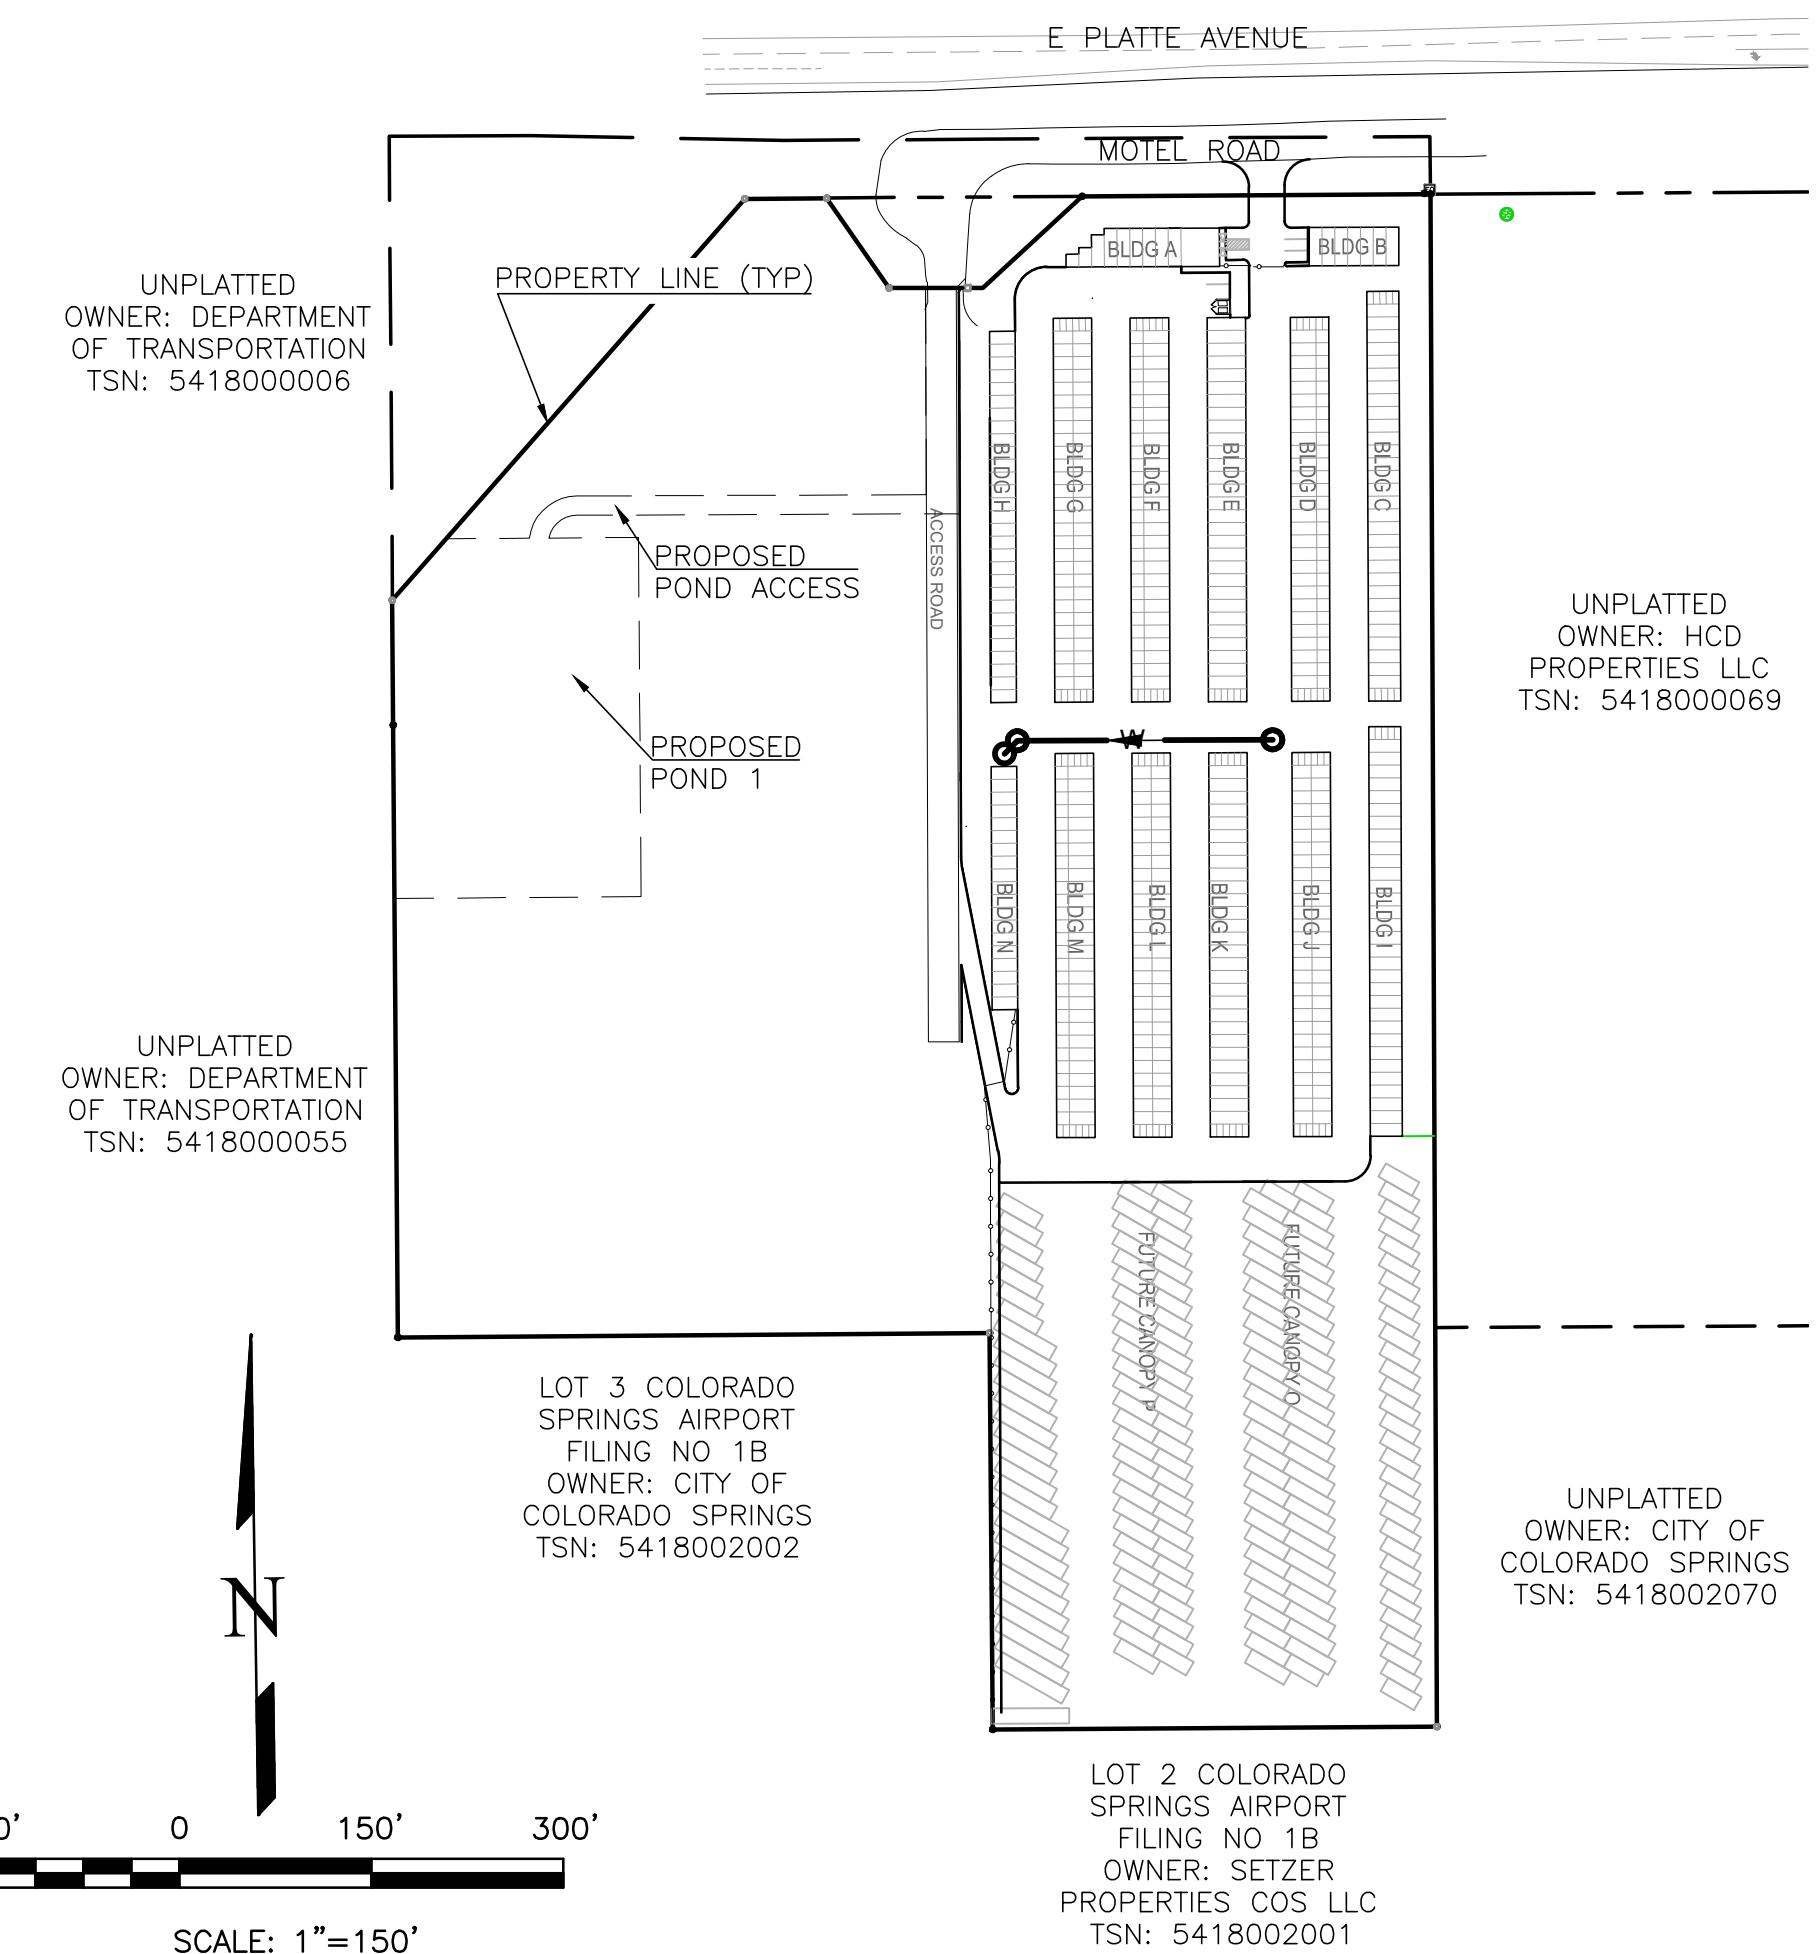

CONTACT INFORMATION:

OWNER: DONALD HUMPHREY
5780 SAYRES ROAD
COLORADO SPRINGS, CO 80927
(719) 492-8649

CIVIL ENGINEER: TERRA NOVA ENGINEERING, INC.
721 S. 23RD STREET
COLORADO SPRINGS, COLORADO 80904
DALE FRANK, P.E., (719) 635-6422

EL PASO COUNTY: PLANNING AND COMMUNITY DEVELOPMENT
2880 INTERNATIONAL CIRCLE
COLORADO SPRINGS, COLORADO 80910
(719) 520-6300

CIMARRON HILLS FIRE DEPT: HEADQUARTERS
1835 TUSKEGEE PL
COLORADO SPRINGS, COLORADO 80915
(719) 591-0960

CHEROKEE METRO DISTRICT: 6250 PALMER PARK BOULEVARD
COLORADO SPRINGS, COLORADO 80915
(719) 597-5080

ENGINEER'S STATEMENT

THESE DETAILED PLANS AND SPECIFICATIONS WERE PREPARED UNDER MY DIRECTION AND SUPERVISION. SAID PLANS AND SPECIFICATIONS HAVE BEEN PREPARED ACCORDING TO THE CRITERIA ESTABLISHED BY THE COUNTY FOR DETAILED ROADWAY, DRAINAGE, GRADING AND EROSION CONTROL PLANS AND SPECIFICATIONS, AND SAID PLANS AND SPECIFICATIONS ARE IN CONFORMITY WITH APPLICABLE MASTER DRAINAGE PLANS AND MASTER TRANSPORTATION PLANS. SAID PLANS AND SPECIFICATIONS MEET THE PURPOSES FOR WHICH THE PARTICULAR ROADWAY AND DRAINAGE FACILITIES ARE DESIGNED AND ARE CORRECT TO THE BEST OF MY KNOWLEDGE AND BELIEF. I ACCEPT RESPONSIBILITY FOR ANY LIABILITY CAUSED BY ANY NEGIGENT ACTS, ERRORS OR OMISSIONS ON MY PART IN PREPARATION OF THESE DETAILED PLANS AND SPECIFICATIONS.

ENGINEER OF RECORD SIGNATURE DATE
DALE FRANK, P.E. #50207
FOR AND ON BEHALF OF TERRA NOVA ENGINEERING, INC.

OWNER/DEVELOPER'S STATEMENT

I, THE OWNER/DEVELOPER HAVE READ AND WILL COMPLY WITH ALL OF THE REQUIREMENTS SPECIFIED IN THESE DETAILED PLANS AND SPECIFICATIONS.

OWNER NAME, TITLE DATE

BUSINESS NAME, ADDRESS

EL PASO COUNTY APPROVAL

COUNTY PLAN REVIEW IS PROVIDED ONLY FOR GENERAL CONFORMANCE WITH COUNTY DESIGN CRITERIA. THE COUNTY IS NOT RESPONSIBLE FOR THE ACCURACY AND ADEQUACY OF THE DESIGN, DIMENSIONS, AND/OR ELEVATIONS WHICH SHALL BE CONFIRMED AT THE JOB SITE. THE COUNTY THROUGH THE APPROVAL OF THIS DOCUMENT ASSUMES NO RESPONSIBILITY FOR COMPLETENESS AND/OR ACCURACY OF THIS DOCUMENT.

FILED IN ACCORDANCE WITH THE REQUIREMENTS OF THE EL PASO COUNTY LAND DEVELOPMENT CODE, DRAINAGE CRITERIA MANUAL, VOLUMES 1 AND 2, AND ENGINEERING CRITERIA MANUAL AS AMENDED.


IN ACCORDANCE WITH ECM SECTION 1.12, THESE CONSTRUCTION DOCUMENTS WILL BE VALID FOR CONSTRUCTION FOR A PERIOD OF 2 YEARS FROM THE DATE SIGNED BY THE EL PASO COUNTY ENGINEER. IF CONSTRUCTION HAS NOT STARTED WITHIN THOSE 2 YEARS, THE PLANS WILL NEED TO BE RESUBMITTED FOR APPROVAL, INCLUDING PAYMENT OF REVIEW FEES AT THE PLANNING AND COMMUNITY DEVELOPMENT DIRECTOR'S DISCRETION.

JENNIFER IRVINE, P.E.
COUNTY ENGINEER / ECM ADMINISTRATOR

DATE
H-SCALE AS SHOWN
V-SCALE N/A

JOB NO. 2419.00
DATE ISSUED 01/14/25
SHEET NO. 23 OF 28


PREPARED FOR:	RMG-ROCKY MOUNTAIN GROUP
ATTN:	5085 LIST DR, #200
ADDRESS:	COLORADO SPRINGS, CO 80919
TEL:	719.548.0600
EMAIL:	www.tresinc.com

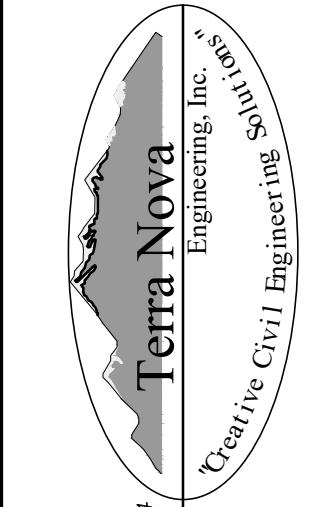


DESIGNED BY DLF
DRAWN BY DLF
CHECKED BY LD
H-SCALE AS SHOWN
V-SCALE N/A
JOB NO. 2419.00
DATE ISSUED 01/14/25
SHEET NO. 23 OF 28

PPR2418

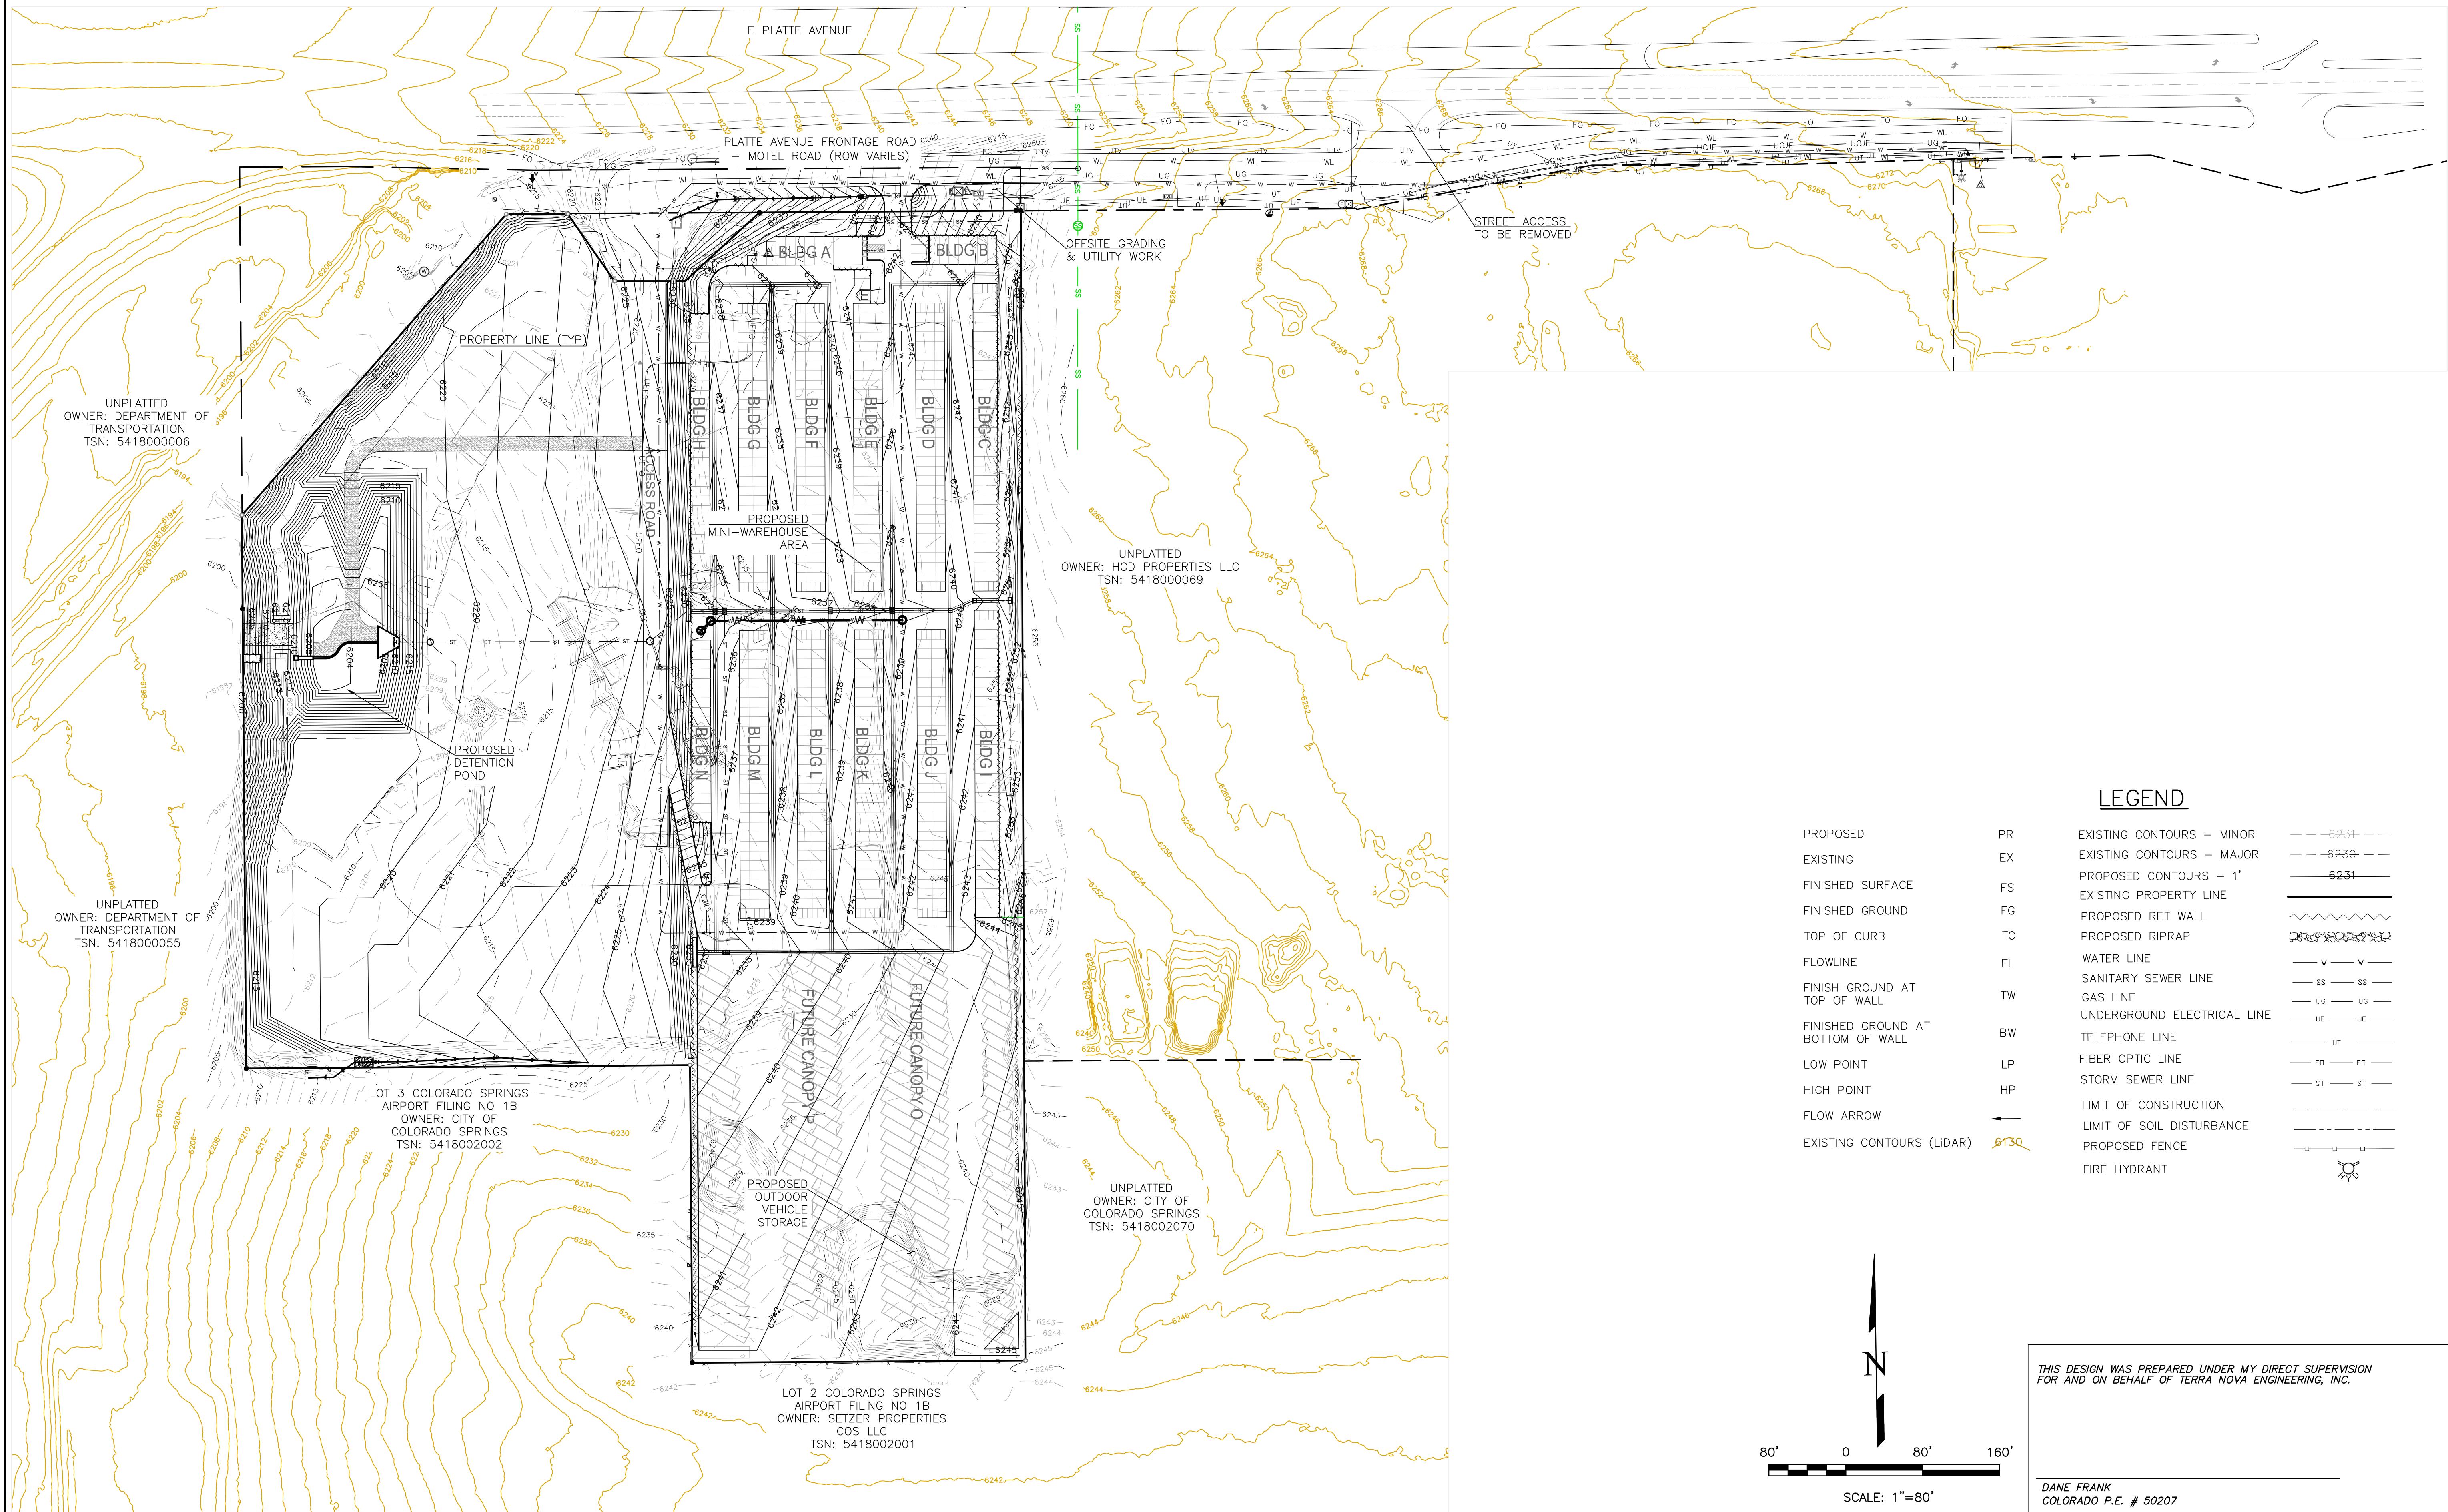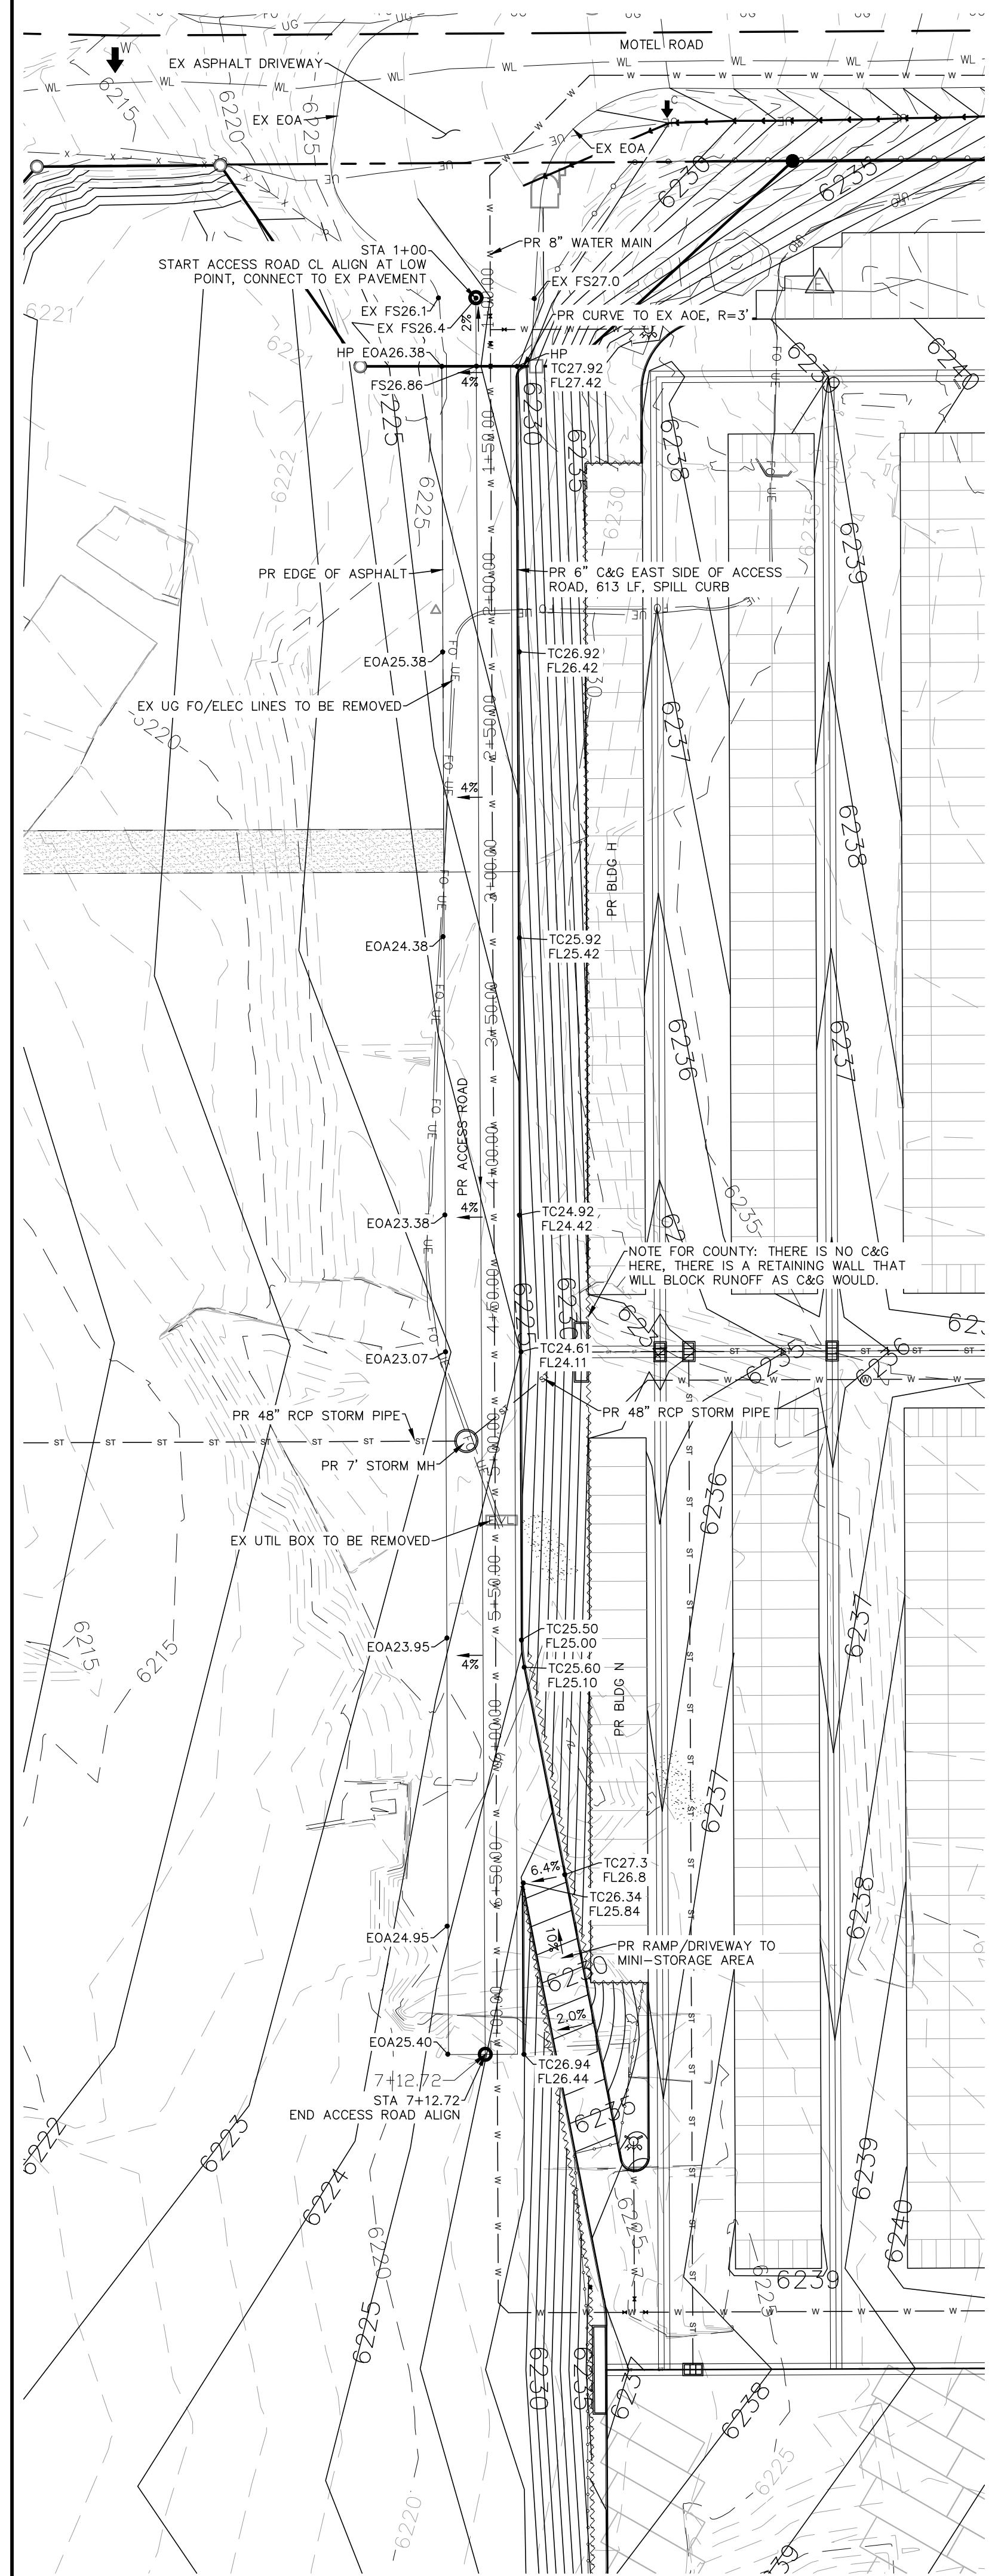**PLATTE SELF STORAGE
STREET IMPROVEMENT PLAN
OVERVIEW SHEET**
JANUARY 2025





ACCESS ROAD PAVEMENT NOTES

1. FINAL PAVEMENT DESIGN WILL BE DETERMINED BY A GEOTECHNICAL ENGINEER, PER THE COUNTY'S PAVEMENT DESIGN REQUIREMENTS, FOLLOWING FINAL GRADING OF THE STREET.

2. FOR COST EXERCISES THE FOLLOWING PAVEMENT DESIGN CAN BE ASSUMED:
5" HMA OVER 9" BASE.

SIDWALK: WIDTH	<input type="checkbox"/> ATTACHED	<input type="checkbox"/> DETACHED			
LOCATION:					
DESIGN SPEED: 25 MPH (POSTED)					
CURB TYPE:	<input checked="" type="checkbox"/> 1	<input type="checkbox"/> 2	<input type="checkbox"/> 3	<input type="checkbox"/> 4	<input type="checkbox"/> 5
ROW WIDTH:	FL-FL: 28'				
STREET TYPE:	CUSTOM				
PAVEMENT TYPE:	<input type="checkbox"/> HMA	<input type="checkbox"/> PCC			
THICKNESS:					
COMPOSITE SECTION:	<input type="checkbox"/> HMA	<input type="checkbox"/> BASE			
SUBGRADE STABILIZATION:	<input type="checkbox"/> CHEMICAL	<input type="checkbox"/> MECHANICAL			
TYPE	<input type="checkbox"/>	<input type="checkbox"/> THICKNESS			


LEGEND

PROPOSED	PR	EXISTING CONTOURS - MINOR
EXISTING	EX	EXISTING CONTOURS - MAJOR
FINISHED SURFACE	FS	PROPOSED CONTOURS - 1'
FINISHED GROUND	FG	EXISTING PROPERTY LINE
TOP OF CURB	TC	PROPOSED RET WALL
FLOWLINE	FL	PROPOSED RIPRAP
FINISH GROUND AT TOP OF WALL	TW	WATER LINE
FINISHED GROUND AT BOTTOM OF WALL	BW	SANITARY SEWER LINE
LOW POINT	LP	GAS LINE
HIGH POINT	HP	UNDERGROUND ELECTRICAL LINE
FLOW ARROW		TELEPHONE LINE
EXISTING CONTOURS (LIDAR)	BT3Q	FIBER OPTIC LINE
		STORM SEWER LINE
		LIMIT OF CONSTRUCTION
		LIMIT OF SOIL DISTURBANCE
		PROPOSED FENCE
		FIRE HYDRANT

REVISIONS
NO. _____ DESCRIPTION _____ DATE _____

UNTIL SUCH TIME AS THESE DRAWINGS ARE APPROVED BY THE APPROPRIATE REVIEWING AGENCIES, TERRA NOVA ENGINEERING, INC. APPROVES THEIR USE ONLY FOR THE PURPOSES DESIGNATED BY WRITTEN AUTHORIZATION.

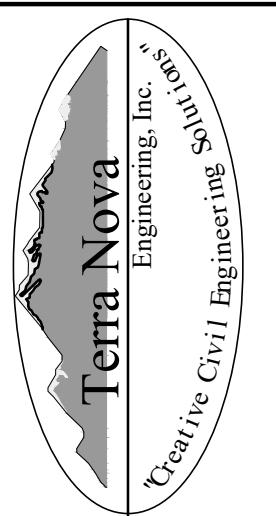
PREPARED FOR:
RMG—ROCKY MOUNTAIN GROUP
ATTN: #200
5085 LIST DR, COLORADO SPRINGS, CO 80919
719.548.0600




271 S. 23RD STREET
COLORADO SPRINGS, CO 80904
OFFICE: 719-535-6422
FAX: 719-535-6426
www.tnresinc.com

PLATE SELF STORAGE

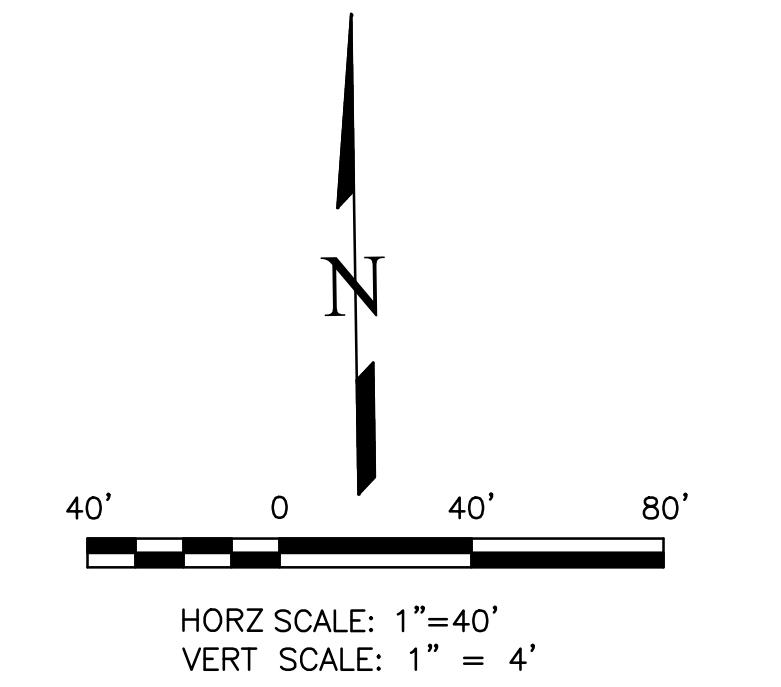DESIGNED BY DLF
DRAWN BY DLF
CHECKED BY LD
H-SCALE AS SHOWN
V-SCALE N/A
JOB NO. 2419.00
DATE ISSUED 01/14/25
SHEET NO. 25 OF 28



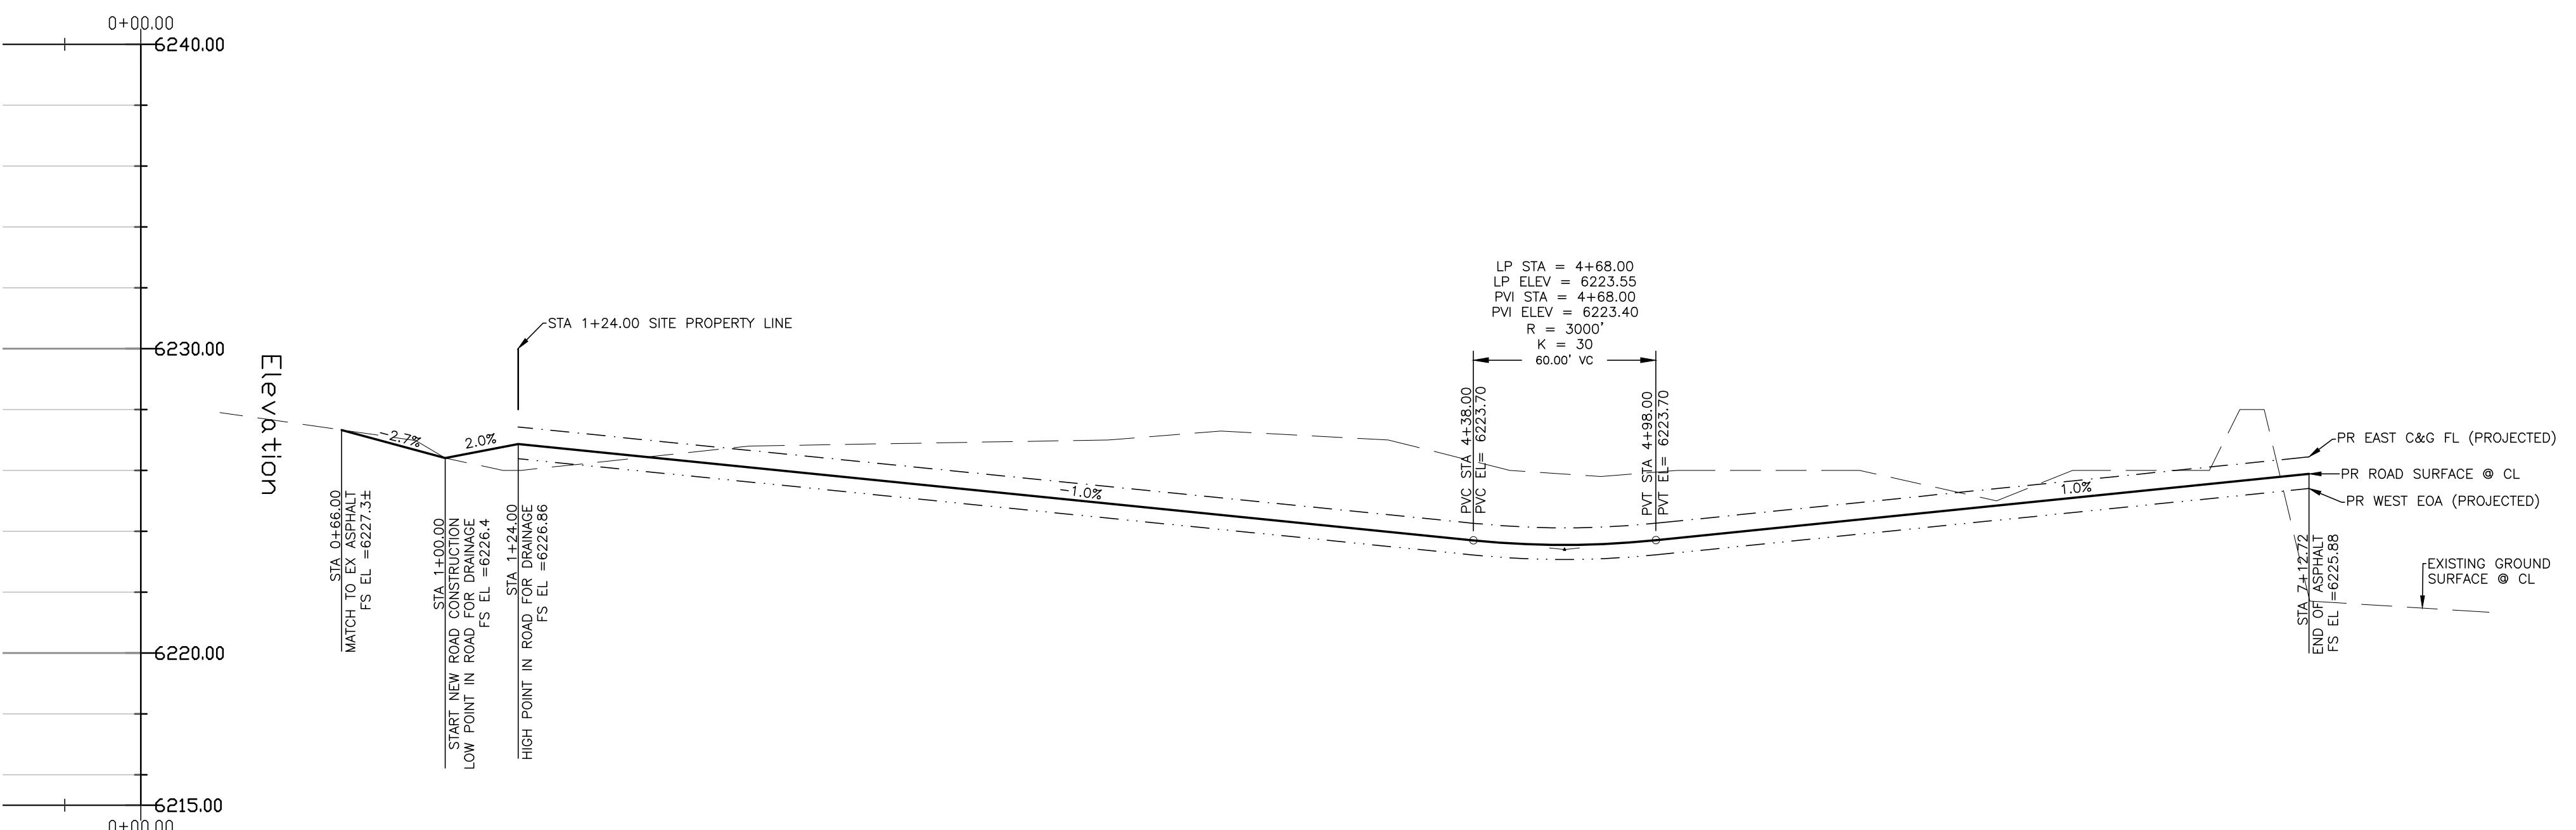ACCESS ROAD - PLAN & PROFILE
HORZ SCALE: 1"=40' - VERT SCALE: 1"=4"



THIS DESIGN WAS PREPARED UNDER MY DIRECT SUPERVISION FOR AND ON BEHALF OF TERRA NOVA ENGINEERING, INC.

DANE FRANK
COLORADO P.E. # 50207

PLATTE SELF STORAGE



STREET IMPROVEMENT PLAN

DETAILS SHEET

JANUARY 2025



LEGEND

PROPOSED	PR	EXISTING CONTOURS - MINOR
EXISTING	EX	EXISTING CONTOURS - MAJOR
FINISHED SURFACE	FS	PROPOSED CONTOURS - 1'
FINISHED GROUND	FG	EXISTING PROPERTY LINE
TOP OF CURB	TC	PROPOSED RET WALL
FLOWLINE	FL	PROPOSED RIPRAP
FINISH GROUND AT TOP OF WALL	TW	WATER LINE
FINISHED GROUND AT BOTTOM OF WALL	BW	SANITARY SEWER LINE
LOW POINT	LP	GAS LINE
HIGH POINT	HP	UNDERGROUND ELECTRICAL LINE
FLOW ARROW		TELEPHONE LINE
EXISTING CONTOURS (LIDAR)	813Q	FIBER OPTIC LINE
		STORM SEWER LINE
		LIMIT OF CONSTRUCTION
		LIMIT OF SOIL DISTURBANCE
		PROPOSED FENCE
		FIRE HYDRANT

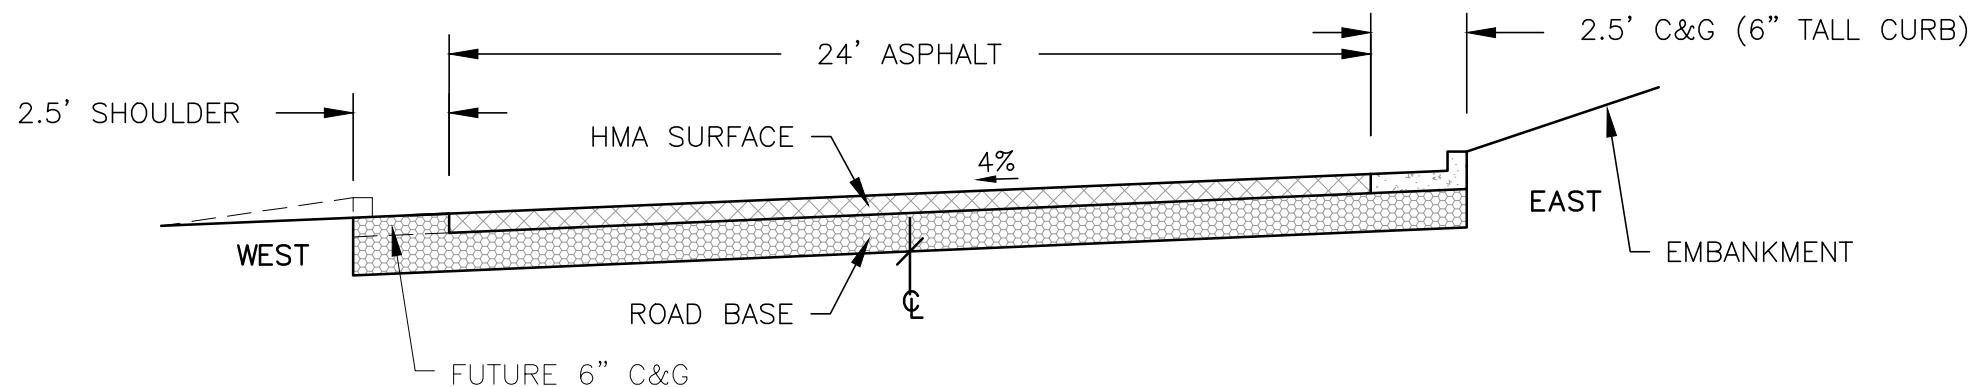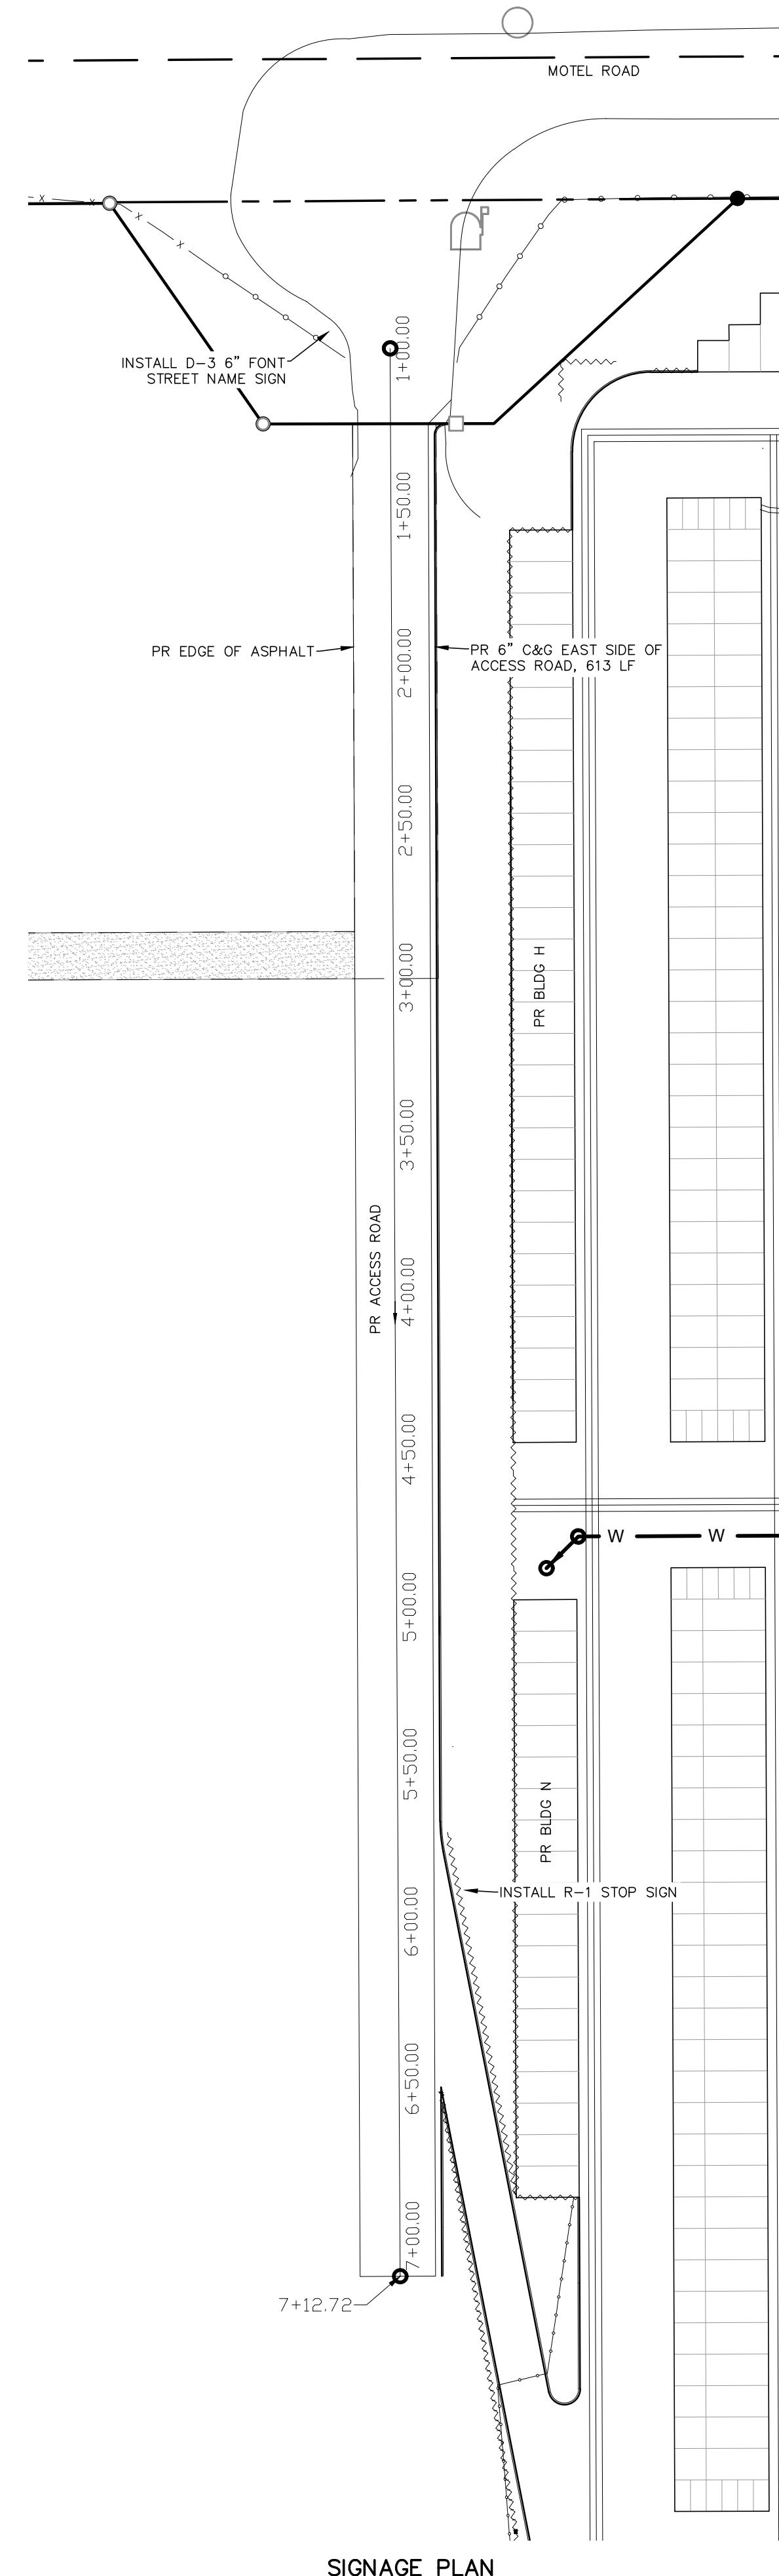


TYPICAL STREET SECTION (CUSTOM) - ACCESS ROAD (PRIVATE)

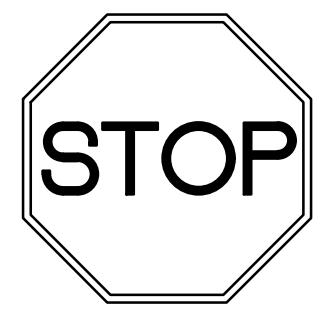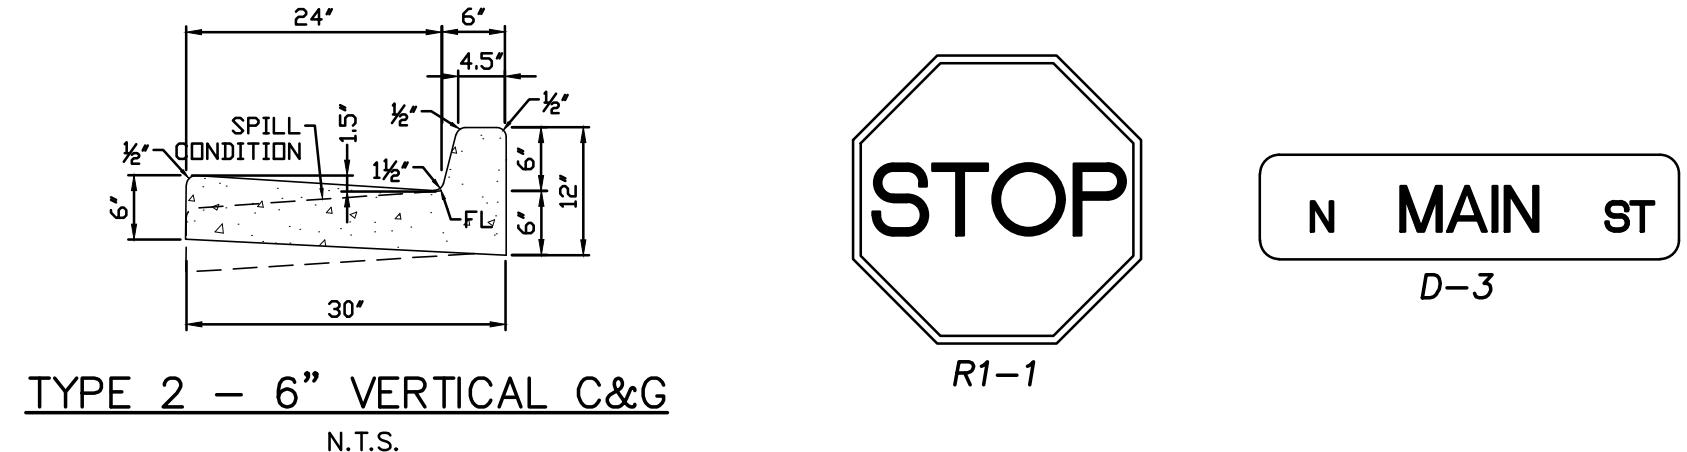NOT TO SCALE



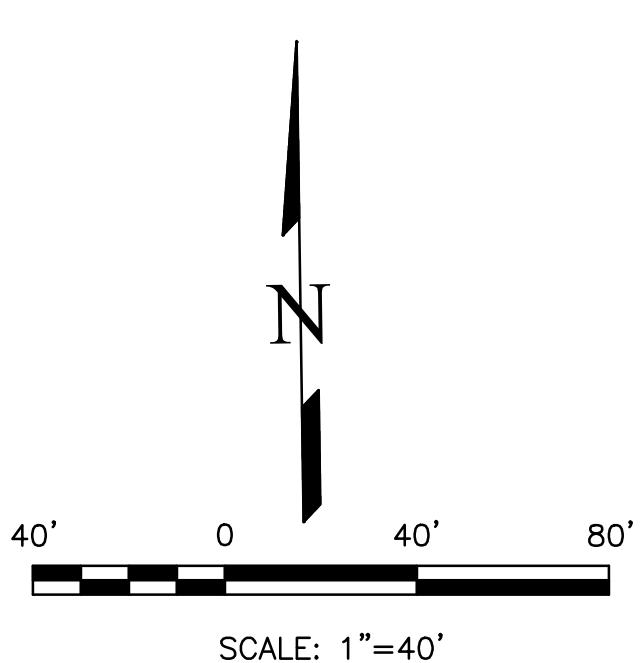STREET NAME SIGNS
1 - ACCESS ROAD NAME TBD, 6"/4.5" TALL FONT, 12" TALL SIGN




THIS DESIGN WAS PREPARED UNDER MY DIRECT SUPERVISION
FOR AND ON BEHALF OF TERRA NOVA ENGINEERING, INC.

DANE FRANK
COLORADO P.E. # 50207

REVISIONS
NO. _____ DATE _____

UNTIL SUCH TIME AS THESE DRAWINGS ARE APPROVED BY THE APPROPRIATE REVIEWING AGENCIES, TERRA NOVA ENGINEERING, INC. APPROVES THEIR USE ONLY FOR THE PURPOSES DESIGNATED BY WRITTEN AUTHORIZATION.

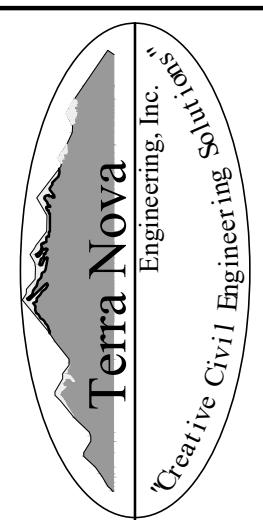PREPARED FOR:
RMG-ROCKY MOUNTAIN GROUP
ATTN: 5085 LIST DR, #200
COLORADO SPRINGS, CO 80919
719.548.0600




PLATTE SELF STORAGE
721 S. 23RD STREET
COLORADO SPRINGS, CO 80904
OFFICE: 719-535-6422
FAX: 719-535-6426
www.tnreinc.com

STREET IMPROVEMENT PLAN
DETAILS SHEET

DESIGNED BY DLF
DRAWN BY DLF
CHECKED BY LD
H-SCALE AS SHOWN
V-SCALE N/A
JOB NO. 2419.00
DATE ISSUED 01/14/25
SHEET NO. 26 OF 28

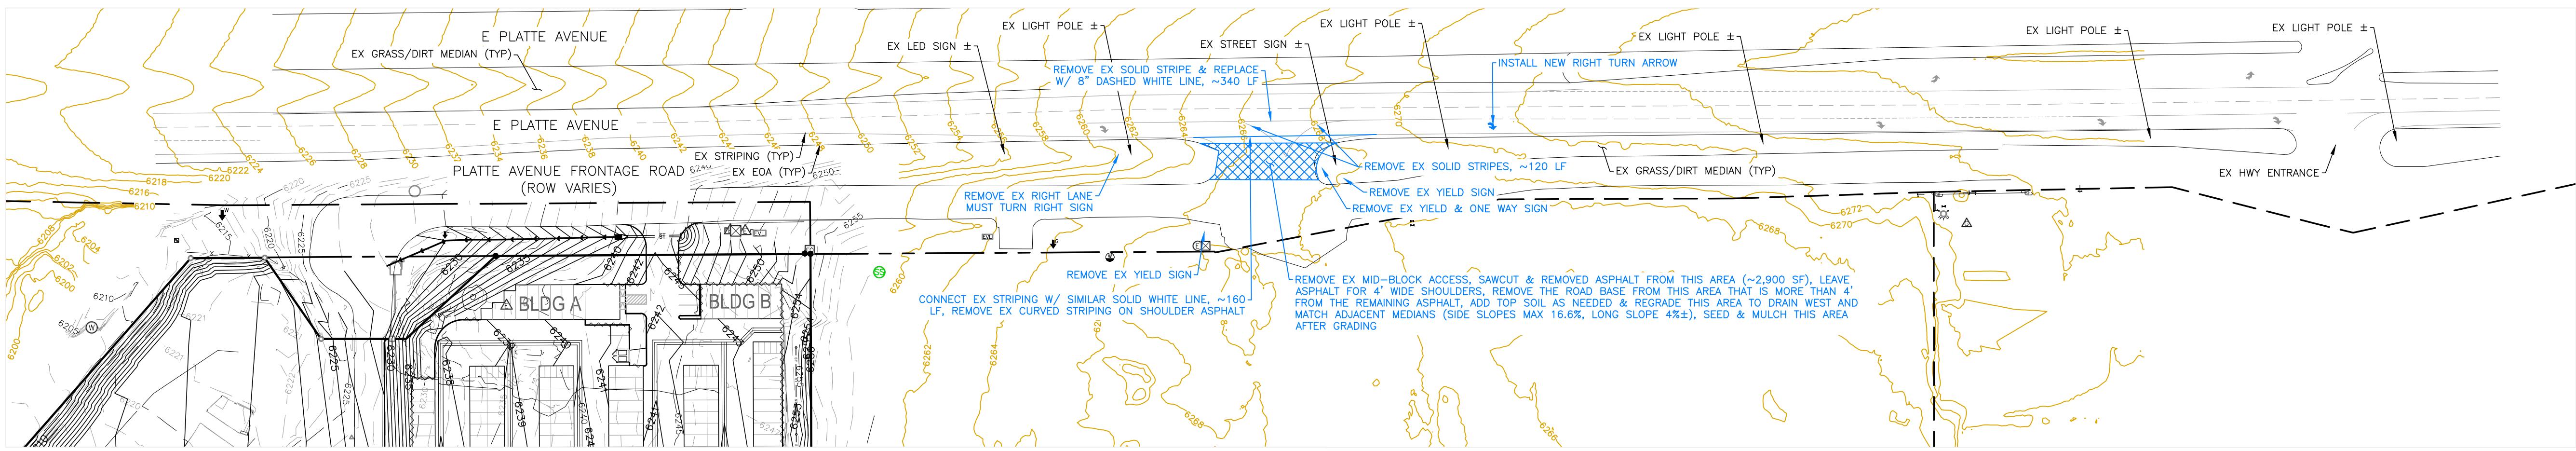**PLATTE SELF STORAGE
STREET IMPROVEMENT PLAN
HWY 24 MID BLOCK ACCESS REMOVAL
JANUARY 2025**




NOTES

1. THE MID-BLOCK ACCESS REMOVAL WORK SHALL BE PER CDOT STANDARDS.
 2. INFO SHOWN IN BLUE IS THE PROPOSED WORK.

LEGEND

PROPOSED	PR	EXISTING CONTOURS – MINOR
EXISTING	EX	EXISTING CONTOURS – MAJOR
FINISHED SURFACE	FS	PROPOSED CONTOURS – 1'
FINISHED GROUND	FG	EXISTING PROPERTY LINE
TOP OF CURB	TC	PROPOSED RET WALL
FLOWLINE	FL	PROPOSED RIPRAP
FINISH GROUND AT TOP OF WALL	TW	WATER LINE
FINISHED GROUND AT BOTTOM OF WALL	BW	SANITARY SEWER LINE
LOW POINT	LP	GAS LINE
HIGH POINT	HP	UNDERGROUND ELECTRICAL LINE
FLOW ARROW	←	TELEPHONE LINE
EXISTING CONTOURS (LiDAR)	6130	FIBER OPTIC LINE
		STORM SEWER LINE
		LIMIT OF CONSTRUCTION
		LIMIT OF SOIL DISTURBANCE
		PROPOSED FENCE
		FIRE HYDRANT

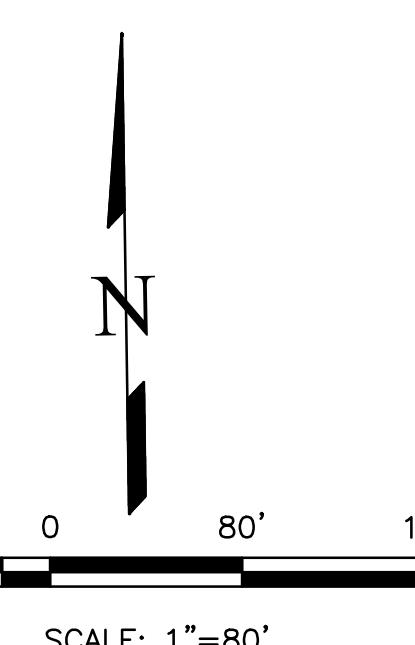

THIS DESIGN WAS PREPARED UNDER MY DIRECT SUPERVISION
FOR AND ON BEHALF OF TERRA NOVA ENGINEERING, INC.

80'

0

80'

1

SCALE: 1"=80'

DANE FRANK
COLORADO P.E. # 50207

PLATTE SELF STORAGE		721 S. 23RD STREET COLORADO SPRINGS, CO 80904	OFFICE: 719-635-6422 FAX: 719-635-6426 www.tnesinc.com
DESIGNED BY DLF		STREET IMPROVEMENT PLAN HWY 24 MID BLOCK ACCESS REMOVAL	
DRAWN BY DLF			
CHECKED BY LD			
H-SCALE	AS SHOWN		
V-SCALE	N/A		
JOB NO. 2419.00			
DATE ISSUED 01/14/25			
SHEET NO. 27 OF 28			

PREPARED FOR:
RMG-ROCKY MOUNTAIN GROUP
ATTN:
5085 LIST DR, #2000
COLORADO SPRINGS, CO 80919
719.548.0600

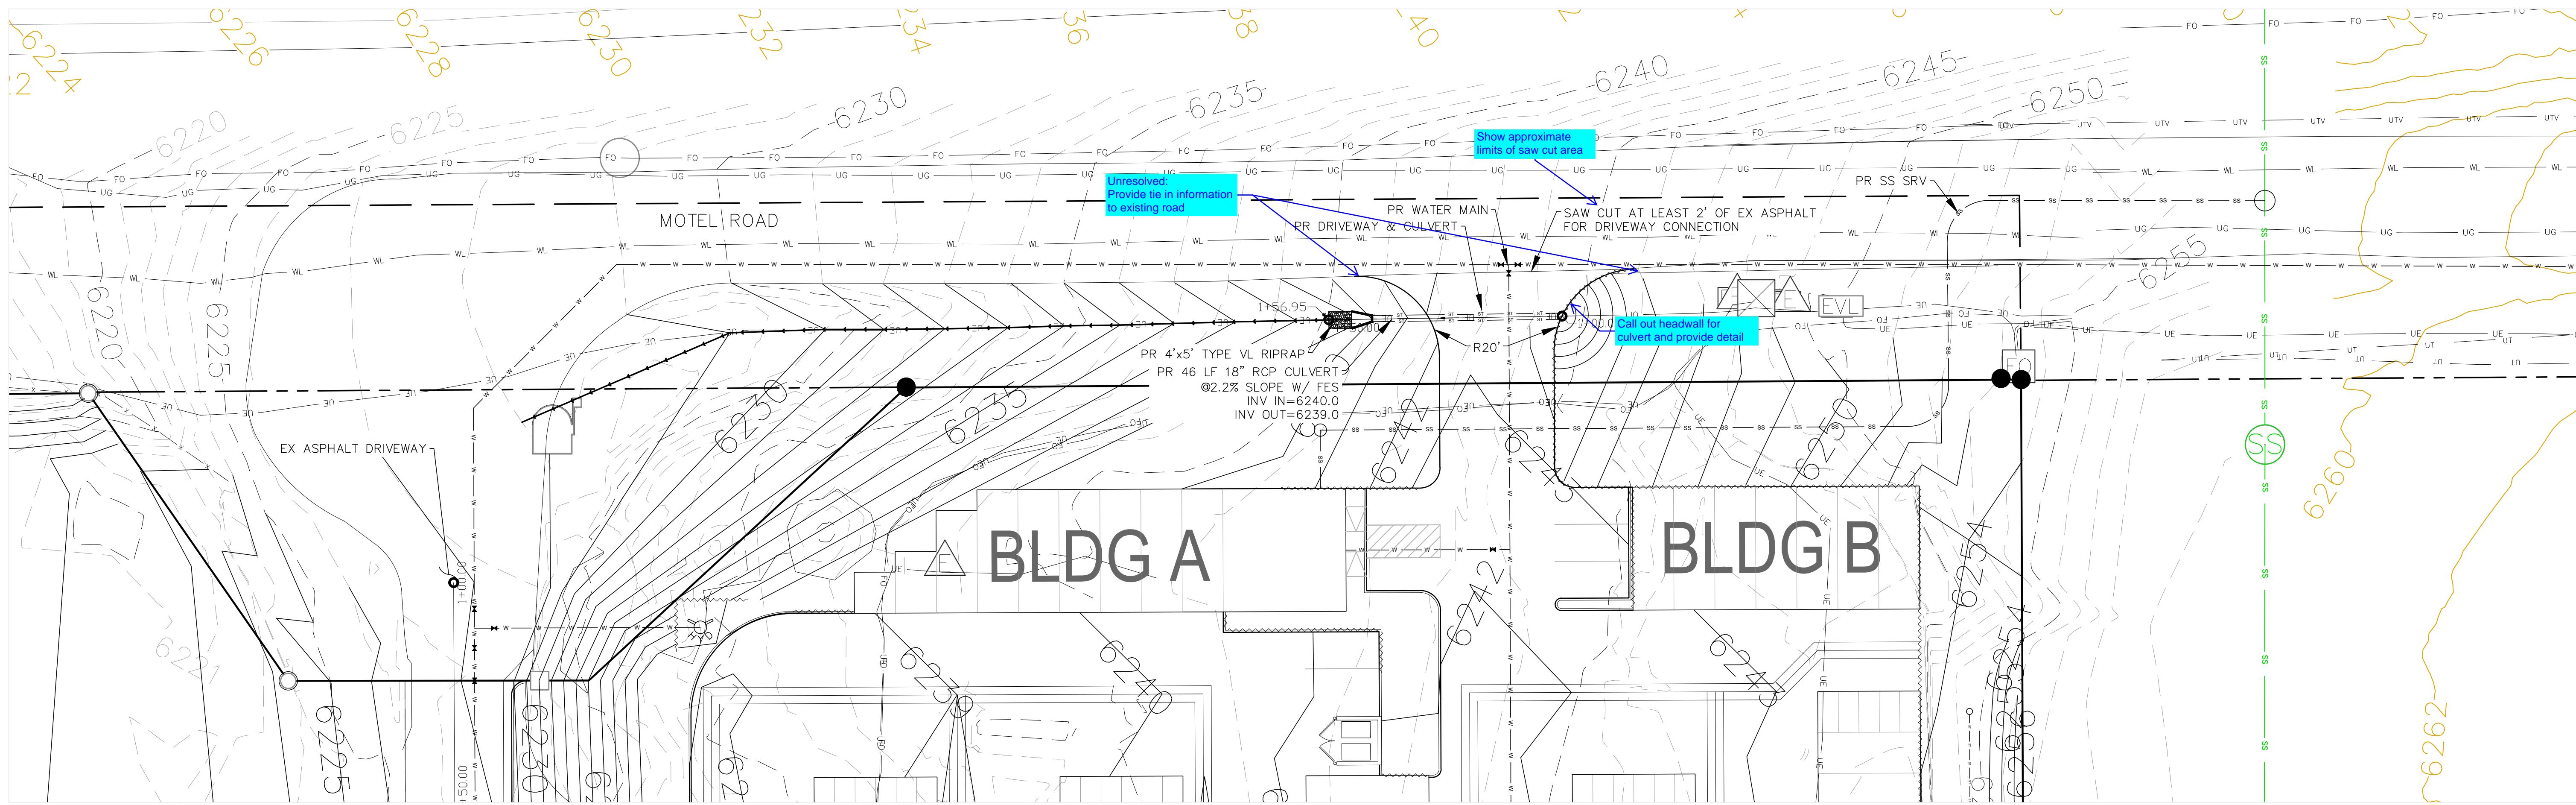
UNTIL SUCH TIME AS THESE DRAWINGS ARE APPROVED BY THE APPROPRIATE REVIEWING AGENCIES, TERRA NOVA ENGINEERING, INC. APPROVES THEIR USE ONLY FOR THE PURPOSES DESIGNATED BY WRITTEN AUTHORIZATION.

REVISIONS
NO. _____
DESCRIPTION _____
DATE _____



Terra Nova
Engineering, Inc.
"Creative Civil Engineering Solutions"


PLATTE SELF STORAGE
STREET IMPROVEMENT PLAN
RIGHT OF WAY IMPROVEMENTS SHEET
JANUARY 2025



REVISIONS
NO. _____
DESCRIPTION _____
DATE _____

UNTIL SUCH TIME AS THESE DRAWINGS ARE APPROVED BY THE APPROPRIATE REVIEWING AGENCIES, INC. APPROVES THEIR USE ONLY FOR THE PURPOSES DESIGNATED BY WRITTEN AUTHORIZATION.

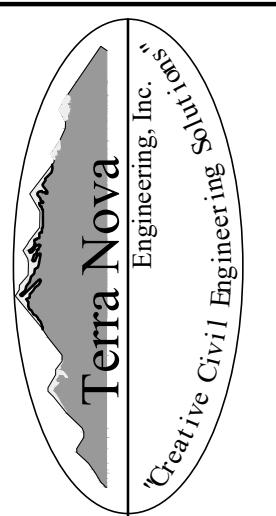PREPARED FOR:
RMG—ROCKY MOUNTAIN GROUP
ATTN: 5085 LIST DR, #200
COLORADO SPRINGS, CO 80919
719.548.0600



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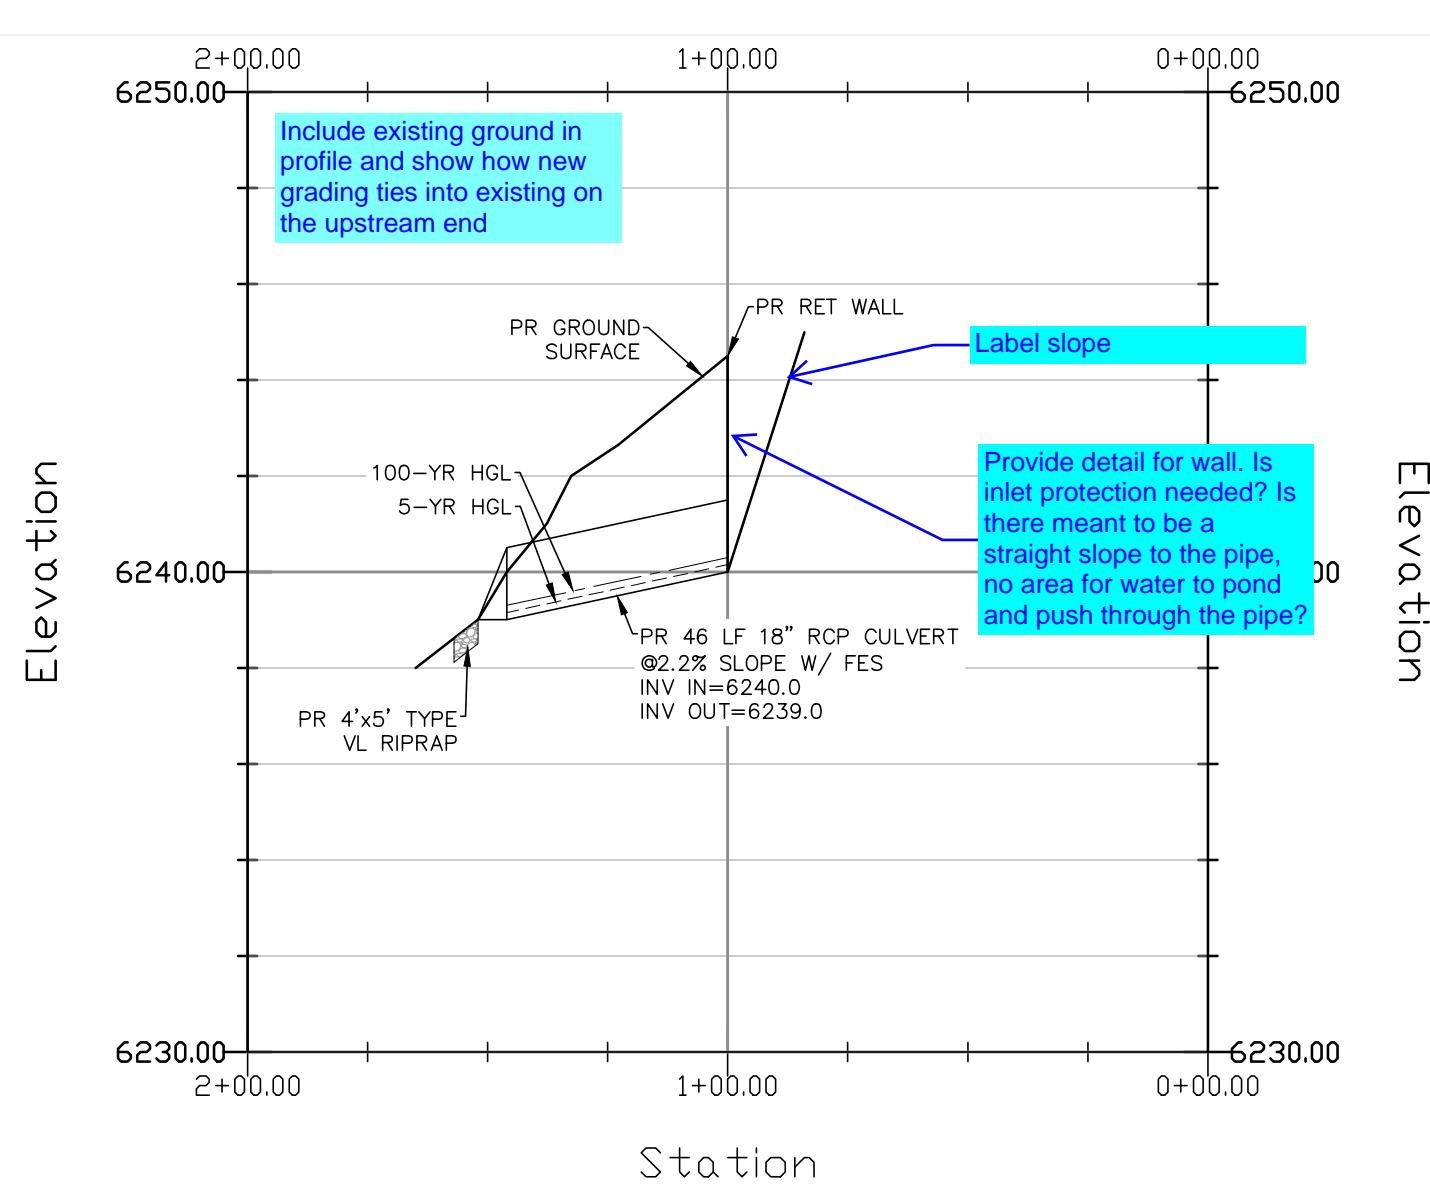
PLATTE SELF STORAGE
STREET IMPROVEMENT PLAN
RIGHT OF WAY IMPROVEMENTS SHEET

LEGEND

PROPOSED	PR	EXISTING CONTOURS — MINOR
EXISTING	EX	EXISTING CONTOURS — MAJOR
FINISHED SURFACE	FS	PROPOSED CONTOURS — 1'
FINISHED GROUND	FG	EXISTING PROPERTY LINE
TOP OF CURB	TC	PROPOSED RET WALL
FLOWLINE	FL	PROPOSED RIPRAP
WATER LINE	WL	WATER LINE
SANITARY SEWER LINE	SS	SANITARY SEWER LINE
GAS LINE	UG	GAS LINE
UNDERGROUND ELECTRICAL LINE	UE	UNDERGROUND ELECTRICAL LINE
TELEPHONE LINE	UT	TELEPHONE LINE
FIBER OPTIC LINE	FO	FIBER OPTIC LINE
STORM SEWER LINE	ST	STORM SEWER LINE
LIMIT OF CONSTRUCTION	LC	LIMIT OF CONSTRUCTION
LIMIT OF SOIL DISTURBANCE	SD	LIMIT OF SOIL DISTURBANCE
PROPOSED FENCE	PF	PROPOSED FENCE
FIRE HYDRANT	FH	FIRE HYDRANT

NOTES

1. THE COUNTY REQUIRED THIS SHEET BE ADDED TO THE PLAN SET. NO NEW INFO IS INCLUDED HERE.
2. CULVERT INFO SHOWN ON THESE PLANS IS SECONDARY TO THE INFO SHOWN ON THE GRADING PLANS. IN THE EVENT OF A DISCREPANCY THE GRADING PLANS SHALL DICTATE.




THIS DESIGN WAS PREPARED UNDER MY DIRECT SUPERVISION FOR AND ON BEHALF OF TERRA NOVA ENGINEERING, INC.

DANE FRANK
COLORADO P.E. # 50207

DESIGNED BY DLF
DRAWN BY DLF
CHECKED BY LD
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V-SCALE N/A
JOB NO. 2419.00
DATE ISSUED 01/14/25
SHEET NO. 28 OF 28

V4_Grading and Erosion Control Plan.pdf Markup Summary

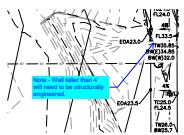Callout (7)




Subject: Callout
Page Label: [1] 241900 GEC-GRAD-VERT-N
Author: CDurham
Date: 1/30/2025 12:58:28 PM
Status:
Color:
Layer:
Space:

Note - Wall taller than 4' will need to be structurally engineered.




Subject: Callout
Page Label: [1] 241900 GEC-GRAD-VERT-S
Author: CDurham
Date: 1/30/2025 12:59:00 PM
Status:
Color:
Layer:
Space:

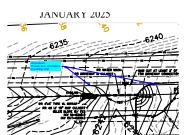Note - Wall taller than 4' will need to be structurally engineered.



Subject: Callout
Page Label: [1] 241900 SIP-ROW SHEET
Author: CDurham
Date: 1/30/2025 1:05:38 PM
Status:
Color:
Layer:
Space:

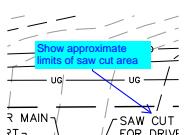Unresolved:
Provide tie in information to existing road




Subject: Callout
Page Label: [1] 241900 SIP-ROW SHEET
Author: CDurham
Date: 1/30/2025 1:06:25 PM
Status:
Color:
Layer:
Space:

Show approximate limits of saw cut area




Subject: Callout
Page Label: [1] 241900 SIP-ROW SHEET
Author: CDurham
Date: 1/30/2025 1:08:29 PM
Status:
Color:
Layer:
Space:

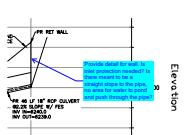Call out headwall for culvert and provide detail



Subject: Callout
Page Label: [1] 241900 SIP-ROW SHEET
Author: CDurham
Date: 1/30/2025 1:09:47 PM
Status:
Color:
Layer:
Space:

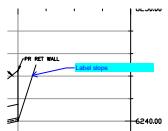
Provide detail for wall. Is inlet protection needed?
Is there meant to be a straight slope to the pipe, no area for water to pond and push through the pipe?



Subject: Callout
Page Label: [1] 241900 SIP-ROW SHEET
Author: CDurham
Date: 1/30/2025 1:10:05 PM
Status:
Color:
Layer:
Space:

Label slope

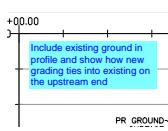Text Box (1)



Subject: Text Box
Page Label: [1] 241900 SIP-ROW SHEET
Author: CDurham
Date: 1/30/2025 1:11:13 PM
Status:
Color:
Layer:
Space:

Include existing ground in profile and show how new grading ties into existing on the upstream end