CITY OF COLORADO SPRINGS STANDARD NOTES

- 1. NO CLEARING, GRADING, EXCAVATION, OR OTHER LAND DISTURBING ACTIVITIES SHALL BE ALLOWED (EXCEPT FOR WORK DIRECTLY RELATED TO THE INSTALLATION OF INITIAL CONTROL MEASURES) UNTIL A CITY GEC PERMIT HAS BEEN ISSUED.
- 2. ALL LAND DISTURBING ACTIVITIES MUST BE PERFORMED IN ACCORDANCE WITH AND THE APPROVED GEC PLAN AND CSWMP.
- 3. INITIAL CONTROL MEASURES SHALL BE INSTALLED AND INSPECTED PRIOR TO ANY LAND DISTURBANCE ACTIVITIES TAKING PLACE. AN INITIAL SITE INSPECTION WILL NOT BE SCHEDULED UNTIL A CITY GEC PERMIT HAS BEEN "CONDITIONALLY APPROVED." CALL CITY STORMWATER INSPECTIONS, 385-5980, AT LEAST 48 HOURS PRIOR TO CONSTRUCTION TO SCHEDULE AN INITIAL INSPECTION AND OBTAIN FULL PERMIT APPROVAL.
- 4. INDIVIDUALS SHALL COMPLY WITH THE "COLORADO WATER QUALITY CONTROL ACT" (TITLE 25, ARTICLE 8, CRS) AND THE "CLEAN WATER ACT" (33 USC 1344), INCLUDING REGULATIONS PROMULGATED AND CERTIFICATIONS OR PERMITS ISSUED, IN ADDITION TO THE REQUIREMENTS INCLUDED IN THE CITY'S MS4 PERMIT, STORMWATER CONSTRUCTION MANUAL. IN THE EVENT OF CONFLICTS BETWEEN THESE REQUIREMENTS AND WATER QUALITY CONTROL LAWS, RULES, OR REGULATIONS OF OTHER FEDERAL OR STATE AGENCIES, THE MORE RESTRICTIVE LAWS, RULES, OR REGULATIONS SHALL APPLY.
- 5. STORMWATER DISCHARGES FROM CONSTRUCTION SITES SHALL NOT CAUSE OR THREATEN TO CAUSE POLLUTION, CONTAMINATION, OR DEGRADATION OR STATE WATERS.
- 6. ALL CONSTRUCTION CONTROL MEASURES SHALL BE MAINTAINED UNTIL PERMANENT STABILIZATION MEASURES ARE IMPLEMENTED. TEMPORARY CONSTRUCTION CONTROL MEASURES MUST BE REMOVED PRIOR TO PERMIT CLOSEOUT.
- 7. CONCRETE WASH WATER SHALL NOT BE DISCHARGED TO ALLOW OR ALLOWED TO RUNOFF TO STATE WATERS OR ANY SURFACE OR SUBSURFACE STORM DRAINAGE SYSTEM OR FACILITIES.
- 8. BUILDING, CONSTRUCTION, EXCAVATION, OR OTHER WASTE MATERIALS SHALL NOT BE TEMPORARILY PLACED OR STORED IN THE STREET, ALLEY, OR OTHER PUBLIC WAY, UNLESS IN ACCORDANCE WITH AN APPROVED TRAFFIC CONTROL PLAN. CONSTRUCTION CONTROL MEASURES MAY BE REQUIRED BY THE GEC INSPECTOR IF DEEMED NECESSARY BASED ON SPECIFIC CONDITIONS AND CIRCUMSTANCES (E.G., ESTIMATED TIME OF EXPOSURE, SEASON OF YEAR, ETC.)
- 9. ALL WASTES COMPOSED OF BUILDING MATERIALS MUST BE REMOVED FROM THE CONSTRUCTION SITE FOR DISPOSAL IN ACCORDANCE WITH LOCAL AND STATE REGULATORY REQUIREMENTS. NO BUILDING MATERIAL WASTES OR UNUSED BUILDING MATERIALS SHALL BE BURIED, DUMPED, OR DISCHARGED AT THE SITE.
- 10. THE PERMITTEE SHALL BE RESPONSIBLE FOR THE REMOVAL OF ALL CONSTRUCTION DEBRIS, DIRT, TRASH, ROCK, SEDIMENT, AND SAND THAT MAY ACCUMULATE IN THE STORM SEWER OR OTHER DRAINAGE CONVEYANCE SYSTEM AS A RESULT OF CONSTRUCTION ACTIVITIES.
- 11. THE QUANTITY OF MATERIALS STORED ON THE PROJECT SITE SHALL BE LIMITED, AS MUCH AS PRACTICAL, TO THAT QUANTITY REQUIRED TO PERFORM THE WORK IN AN ORDERLY SEQUENCE. ALL MATERIALS STORED ON-SITE SHALL BE STORED IN A NEAT, ORDERLY MANNER, IN THEIR ORIGINAL CONTAINERS, WITH ORIGINAL MANUFACTURER'S LABELS. MATERIALS SHALL NOT BE STORED IN A LOCATION WHERE THEY MAY BE CARRIED BY STORMWATER RUNOFF INTO THE STORM SEWER SYSTEM AT ANY TIME.
- 12. SPILL PREVENTION AND CONTAINMENT MEASURES SHALL BE USED AT ALL STORAGE, EQUIPMENT FUELING, AND EQUIPMENT SERVICING AREAS SO AS TO CONTAIN ALL SPILLS AND PREVENT ANY SPILLED MATERIAL FROM ENTERING THE MS4, INCLUDING ANY SURFACE OR SUBSURFACE STORM DRAINAGE SYSTEM OR FACILITY. BULK STORAGE STRUCTURES FOR PETROLEUM PRODUCTS AND OTHER CHEMICALS SHALL HAVE SECONDARY CONTAINMENT OR EQUIVALENT ADEQUATE PROTECTION. ALL SPILLS SHALL BE CLEANED UP IMMEDIATELY AFTER DISCOVERY, OR CONTAINED UNTIL APPROPRIATE CLEANUP METHODS CAN BE EMPLOYED. MANUFACTURER'S RECOMMENDED METHODS FOR SPILL CLEANUP SHALL BE FOLLOWED, ALONG WITH PROPER DISPOSAL METHODS.
- 13. SEDIMENT (MUD AND DIRT) TRANSPORTED ONTO TO A PUBLIC ROAD, REGARDLESS OF THE SIZE OF THE SITE, SHALL BE CLEANED AS SOON AS POSSIBLE AFTER DISCOVERY.
- 14. NO CHEMICALS ARE TO BE ADDED TO THE DISCHARGE UNLESS PERMISSION FOR THE USE OF A SPECIFIC CHEMICAL IS GRANTED BY THE STATE. IN GRANTING THE USE OF SUCH CHEMICALS, SPECIAL CONDITIONS AND MONITORING MAY BE REQUIRED.
- 15. CONTROL MEASURES FOR ALL SLOPES, CHANNELS, DITCHES, OR ANY DISTURBED LAND AREA SHALL BE COMPLETED WITHIN FOURTEEN (14) CALENDAR DAYS AFTER FINAL GRADING OR FINAL LAND DISTURBANCE HAS BEEN COMPLETED. DISTURBED AREAS WHICH ARE NOT AT FINAL GRADE BUT WILL REMAIN DORMANT FOR LONGER THAN FOURTEEN (14) DAYS SHALL BE ROUGHENED, MULCHED, TACKIFIED, OR STABILIZED WITH TARPS WITHIN FOURTEEN (14) DAYS AFTER INTERIM GRADING. AN AREA THAT IS GOING TO REMAIN IN AN INTERIM STATE FOR MORE THAN SIXTY (60) DAYS SHALL ALSO BE SEEDED, UNLESS AN ALTERNATIVE STABILIZATION MEASURE IS ACCEPTED AT THE INSPECTOR'S DISCRETION. ALL TEMPORARY CONSTRUCTION CONTROL MEASURES SHALL BE MAINTAINED UNTIL FINAL STABILIZATION IS ACHIEVED.
- 16. THE GEC PLAN WILL BE SUBJECT TO RE-REVIEW AND RE-ACCEPTANCE BY THE STORMWATER ENTERPRISE SHOULD ANY OF THE FOLLOWING OCCUR: GRADING DOES NOT COMMENCE WITHIN TWELVE (12) MONTHS OF THE CITY'S ACCEPTANCE OF THE PLAN, THE CONSTRUCTION SITE IS IDLE FOR TWELVE (12) CONSECUTIVE MONTHS, A CHANGE IN PROPERTY OWNERSHIP OCCURS, THE PLANNED DEVELOPMENT CHANGES, OR ANY OTHER MAJOR MODIFICATIONS ARE PROPOSED AS DEFINED IN THE STORMWATER CONSTRUCTION MANUAL.
- 17. IT IS NOT PERMISSIBLE FOR ANY PERSON TO MODIFY THE GRADE OF THE EARTH ON ANY UTILITY EASEMENT OR UTILITY RIGHT-OF-WAY WITHOUT WRITTEN APPROVAL FROM THE UTILITY OWNER. CITY ACCEPTANCE OF THE GEC PLAN AND CSWMP DOES NOT SATISFY THIS REQUIREMENT. THE PLAN SHALL NOT INCREASE OR DIVERT WATER TOWARDS UTILITY FACILITIES. ANY CHANGES TO EXISTING UTILITY FACILITIES TO ACCOMMODATE THE PLAN MUST BE APPROVED BY THE AFFECTED UTILITY OWNER PRIOR TO IMPLEMENTING THE PLAN. THE COST TO RELOCATED OR PROTECT EXISTING UTILITIES OR TO PROVIDE INTERIM ACCESS SHALL BE AT THE APPLICANT'S EXPENSE.
- 18. APPLICANT REPRESENTS AND WARRANTS THAT THEY HAVE THE LEGAL AUTHORITY TO GRADE AND/OR CONSTRUCT IMPROVEMENTS ON ADJACENT PROPERTY. THE CITY HAS NOT REVIEWED THE DEVELOPER'S AUTHORITY TO MODIFY ADJACENT PROPERTY. AN APPROVED GEC PERMIT DOES NOT PROVIDE APPROVAL FOR THE APPLICANT TO PERFORM WORK ON ADJACENT PROPERTY.
- 19. ALL UTILITY INSTALLATIONS WITHIN THE LIMITS OF DISTURBANCE SHOWN ON THIS PLAN ARE COVERED UNDER THIS PLAN. LOCATIONS OF UTILITIES WITHIN THE LIMITS OF DISTURBANCE MAY BE MODIFIED AFTER PLAN APPROVAL AS A FIELD CHANGE. UTILITY INSTALLATIONS RELATED TO THE PRIVATE DEVELOPMENT THAT EXTEND BEYOND THE LIMITS OF DISTURBANCE SHOWN ON THIS PLAN ARE CONSIDERED TO BE A PART OF THE LARGER DEVELOPMENT, AND THEREFORE REQUIRE A PLAN MODIFICATION OR SEPARATE PLAN FOR THE ADDITIONAL DISTURBANCE AREA.

FINANCIAL ASSURANCE

DESCRIPTION	QUANTITY	UNITS	UNIT COST	TOTAL
CURB / GUTTER, TYPE 2	1,285	LF	\$ 29	\$ 37,265
PEDESTRIAN RAMP	563	SF	\$ 38	\$ 21,394
SIDEWALK / TRAIL, 10'	860	SY	\$79	\$ 67,940
CONCRETE CROSSPAN & SQUARED RETURN / COMMERCIAL DRIVEWAY APRON	155	SY	\$ 134	\$ 20,770
CURB CHASE	375	SF	\$ 318	\$ 119,250
SUB-TOTAL				\$ 266,619
INCIDENETALS (20%)				\$ 53,324
TOTAL				\$ 319,943




CAUTION - NOTICE TO CONTRACTOR

THE CONTRACTOR IS SPECIFICALLY CAUTIONED THAT THE LOCATION AND/OR ELEVATION OF EXISTING UTILITIES AS SHOWN ON THESE PLANS IS BASED ON RECORDS OF THE VARIOUS UTILITY COMPANIES AND, WHERE POSSIBLE, MEASUREMENTS TAKEN IN THE FIELD. THE INFORMATION IS NOT TO BE RELIED ON AS BEING EXACT OR COMPLETE. THE CONTRACTOR MUST CALL THE LOCAL UTILITY LOCATION CENTER AT LEAST 48 HOURS BEFORE ANY EXCAVATION TO REQUEST EXACT FIELD LOCATIONS OF THE UTILITIES. IT SHALL BE THE RESPONSIBILITY OF THE CONTRACTOR TO RELOCATE ALL EXISTING UTILITIES WHICH CONFLICT WITH THE PROPOSED IMPROVEMENTS SHOWN ON THE PLANS.

Know what's **below**. **Call** before you dig.

THE CONTRACTOR SHALL BE RESPONSIBLE FOR ANY DAMAGE TO EXISTING IMPROVEMENTS AND UTILITIES AND SHALL REPAIR ANY DAMAGE AT HIS EXPENSE.

SPACE VILLAGE FILING NO. 4 A PORTION OF THE NW 1/4 OF SEC. 17, T14S R65W, OF THE 6th P.M., EL PASO COUNTY, COLORADO ROADWAY PLAN

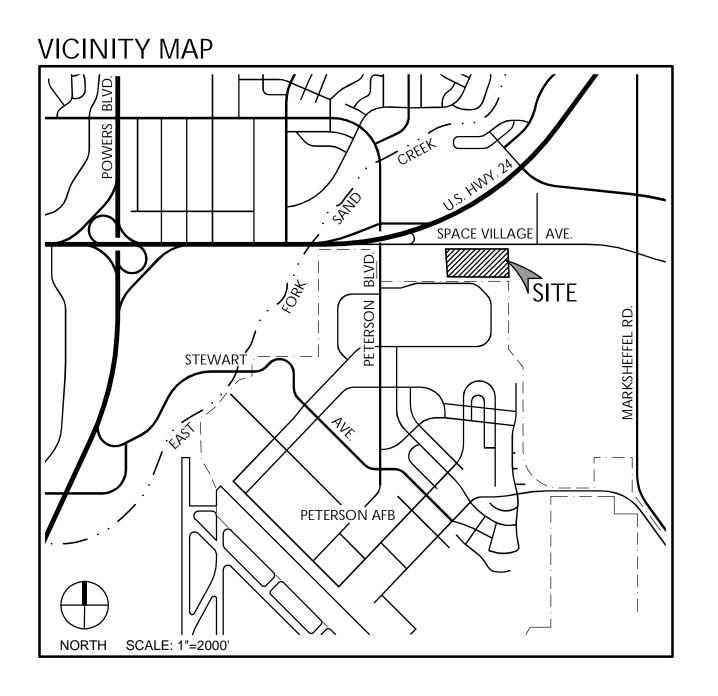

REVIEW

TRAFFIC ENGINEERING

ENGINEER'S STATEMENT

THIS GRADING AND EROSION CONTROL PLAN WAS PREPARED UNDER MY DIRECT SUPERVISION AND IS CORRECT TO THE BEST OF MY KNOWLEDGE AND BELIEF. IF SUCH WORK IS PERFORMED IN ACCORDANCE WITH THE GRADING AND EROSION CONTROL PLAN, THE WORK SHOULD NOT BECOME A HAZARD TO LIFE AND LIMB, ENDANGER PROPERTY, OR ADVERSELY AFFECT THE SAFETY, USE, OR STABILITY OF A PUBLIC WAY, DRAINAGE CHANNEL, OR OTHER PROPERTY.

JAY M. NEWELL, PE FOR AND ON BEHALF OF STERLING DESIGN ASSOCIATES, LLC 303-794-4727

SHEET INDEX

1	C800	COVER SHEET
2	C803	ROADWAY PLAN
3	C805	EROSION CONTROL PLAN
		(SWMP - SITE MAP)
4	C810	DETAILS
5	C811	DETAILS
6	C815	EROSION CONTROL DETAILS
		(SWMP - SITE MAP)
7	C816	EROSION CONTROL DETAILS

(SWMP - SITE MAP)

STATEMENT

THE CITY OF COLORADO SPRINGS RECOGNIZES THE DESIGN ENGINEER AS HAVING RESPONSIBILITY FOR THE DESIGN. THE CITY HAS LIMITED ITS SCOPE OF REVIEW ACCORDINGLY. RESUBMITTAL REQUIRED IF CONSTRUCTION HAS NOT COMMENCED WITHIN 180 DAYS AFTER REVIEW DATE.

DESIGN DATA

IDEWALKS: DCATION: ESIGN SPEED:	
URB TYPE:	TYPE 2
ow width:	100 FT. / EOA-EOA ±50 FT.
TREET TYPE:	MINOR ARTERIAL
AVEMENT:	
YPE:	HMA
THICKNESS:	
OMPOSITE SECTION	ON:
HMA	BASE
UBGRADE STABIL	IZATION:

TYPE: _____ THICKNESS: ___

FLOODPLAIN

ZONE X, "AREAS DETERMINED TO BE OUTSIDE THE 0.2% ANNUAL CHANCE FLOODPLAIN." AS SHOWN ON FEMA FIRM MAP NO. 08041C0754G, EFFECTIVE DATE, DECEMBER 7, 2018.

CONTRACTOR'S STATEMENT

I WILL COMPLY WITH THE REQUIREMENTS OF THE GRADING AND EROSION CONTROL PLAN INCLUDING CONSTRUCTION CONTROL MEASURE INSPECTION REQUIREMENTS AND FINAL STABILIZATION REQUIREMENTS. I ACKNOWLEDGE THE RESPONSIBILITY TO DETERMINE WHETHER THE CONSTRUCTION ACTIVITIES ON THESE PLANS REQUIRE COLORADO DISCHARGE PERMIT SYSTEM (CDPS) PERMITTING FOR STORMWATER DISCHARGES ASSOCIATED WITH CONSTRUCTION ACTIVITY.

NAME OF CONTRACTOR:

AUTHORIZED SIGNATURE:

TITLE:

PHONE NUMBER:

ADDRESS:

EMAIL ADDRESS:

OWNER'S STATEMENT

THE OWNER WILL COMPLY WITH THE REQUIREMENTS OF THE GRADING AND EROSION CONTROL PLAN INCLUDING CONSTRUCTION CONTROL MEASURE INSPECTION REQUIREMENTS AND FINAL STABILIZATION REQUIREMENTS ACCORDING TO THE CITY OF COLORADO SPRINGS STORMWATER CONSTRUCTION MANUAL. I ACKNOWLEDGE THE RESPONSIBILITY TO DETERMINE WHETHER THE CONSTRUCTION ACTIVITIES ON THESE PLANS REQUIRE COLORADO DISCHARGE PERMIT SYSTEM (CDPS) PERMITTING FOR STORMWATER DISCHARGES ASSOCIATED WITH CONSTRUCTION ACTIVITY.

OWNER SIGNATURE:_

NAME OF OWNER:

TITLE:

CONTROL REVIEW

FOR THE SWENT MANAGER

NOTES:

STREET DESIGN FOR CITY ENGINEERING:	
UTILITY GRADE REVIEW	DATE
CURB & GUTTER REVIEW	DATE
FINAL REVIEW	DATE

SIGNAGE AND STRIPING REVIEW

DATE



DA	Т	E

DATE:

PHONE:

EMAIL:

CITY OF COLORADO SPRINGS GRADING & EROSION

THIS GRADING AND EROSION CONTROL PLAN IS FILED IN ACCORDANCE WITH CITY CODE. THIS PLAN IS REVIEWED IN ACCORDANCE WITH THE STORMWATER CONSTRUCTION MANUAL; LATEST REVISIONS.

DATE:

STERLING DESIGN ASSOCIATES, LLC

ISSUES & REVISIONS	
NO.: 1 DATE:	BY:
DESCRIPTION:	
NO.: 2 DATE: -	BY: -
DESCRIPTION: -	
NO.: 3 DATE: -	BY: -
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NO.: 4 DATE: -	BY: -
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NO.: 5 DATE: -	BY: -
DESCRIPTION: -	
NO.: 6 DATE: -	BY: -
DESCRIPTION: -	
DATE:	SCALE:
6/2023	N/A
PROJECT MANAGER:	PROJECT NO.:

DRAWING FILE:

DRAWN BY:	

PROJECT:

JN.

SPACE VILLAGE FILING NO. 4 EL PASO COUNTY, CO

CLIENT

COMMERCIAL BUILDING SERVICES 7561 S. GRANT STR., SUITE A-4 LITTLETON, COLORADO 80122


TEL: (303) 730-3001

SHEET TITLE:

COVER SHEET


SHEET NUMBER:

C800

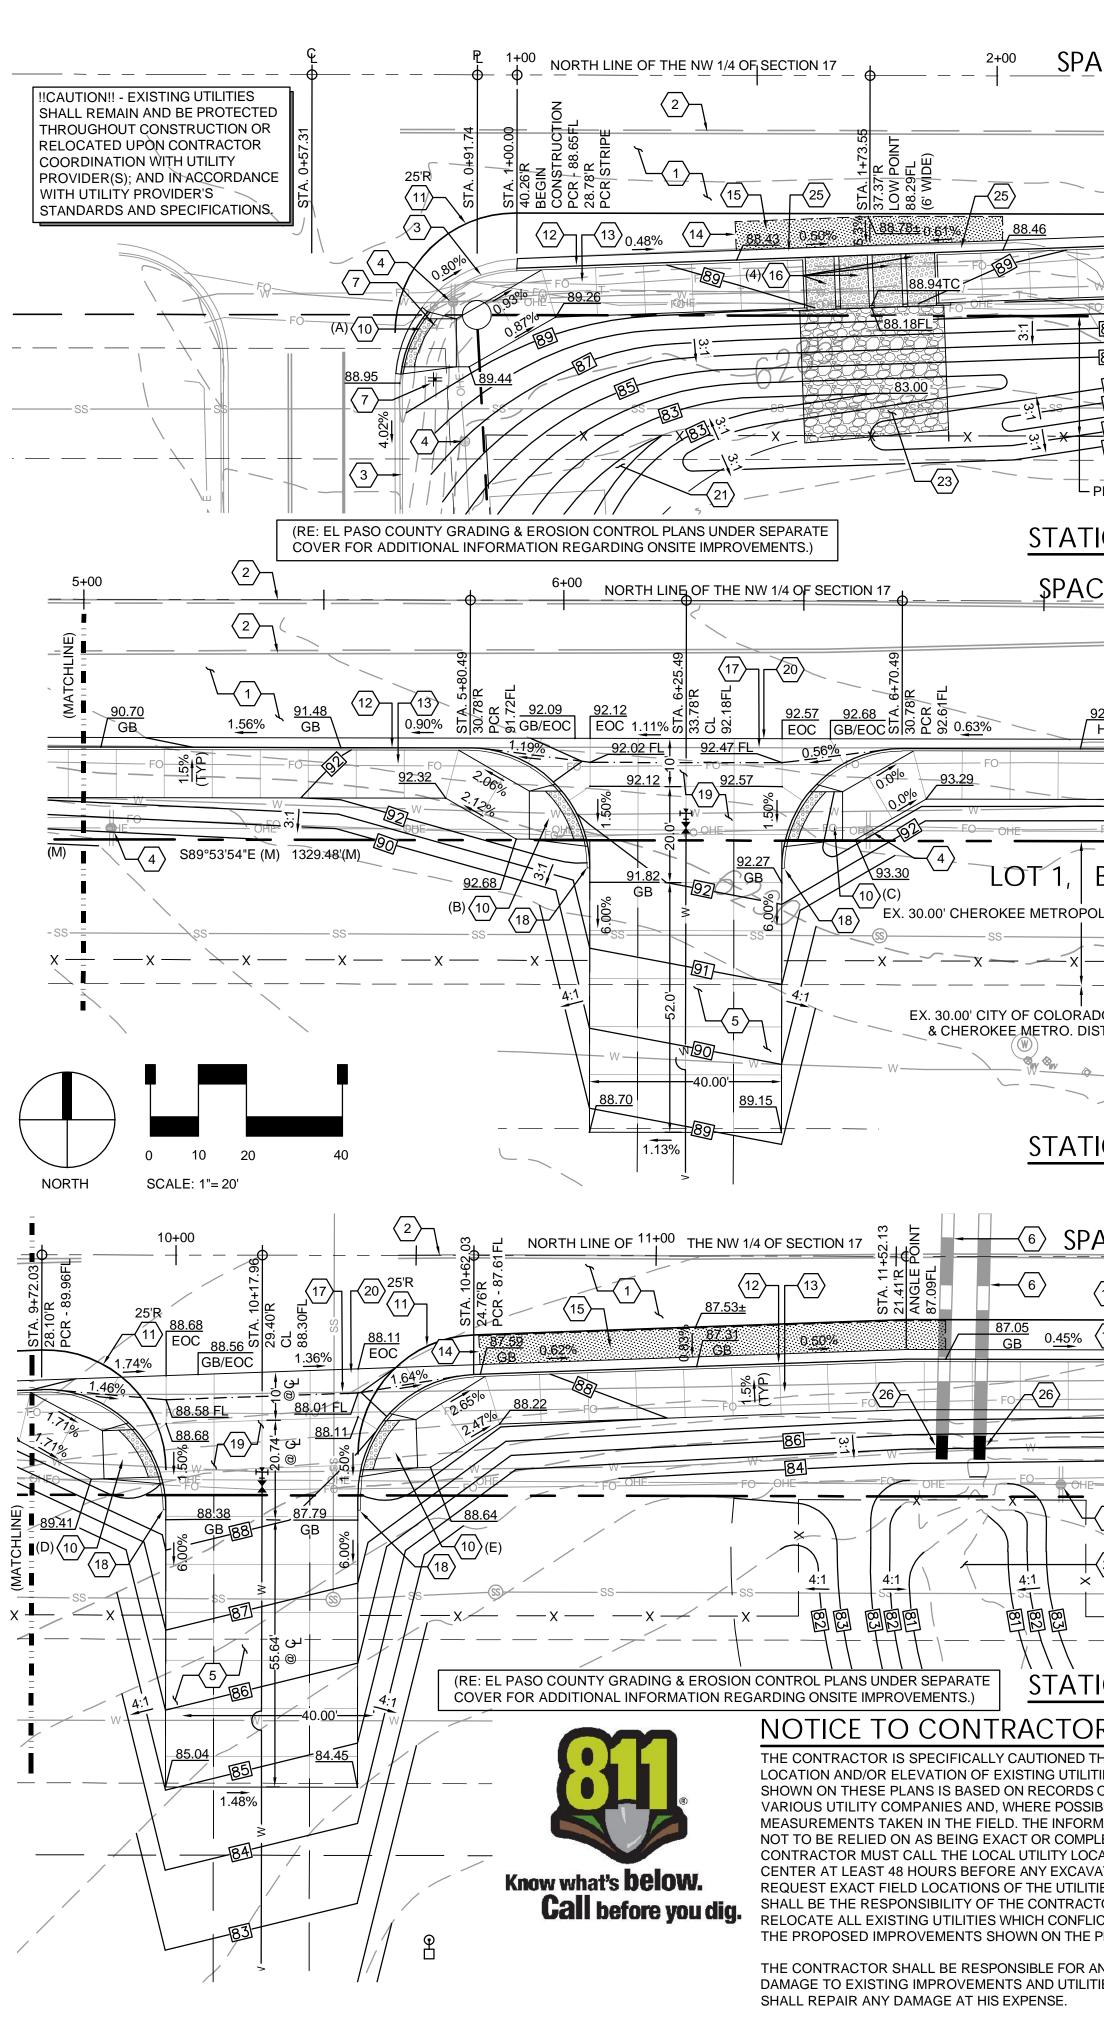

SPACE VILLAGE FILING NO. 4 A PORTION OF THE NW 1/4 OF SEC. 17, T14S, R65W, OF THE 6th P.M., EL PASO COUNTY, COLORADO ROADWAY PLAN

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	JTILITY PROVIDER'S DARDS AND SPECIFICATIONS.				
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BENCHMARK

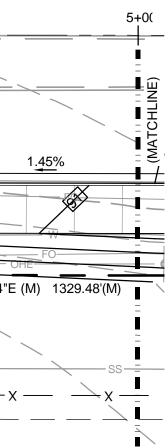AS PROVIDED ON ALTA/NSPS LAND TITLE SURVEY PREPARED BY ALTURA LAND CONSULTANTS, DATED APRIL 28, 2022 FOR THIS PROJECT:

"NGS BENCHMARK "R 76" - LOCATED 0.2 MILE EAST ALONG HIGHWAY 94, FROM PETERSON ROAD, 22 FEET SOUTH-SOUTHEAST OF THE SOUTHEAST CORNER OF AN ADDITION TO THE BUILDING (SANDY'S RESTAURANT), 48 FEET NORTH OF THE CENTERLINE OF THE HIGHWAY, 3.5 FEET SOUTH OF A POWER POLE AND 3 FEET SOUTH OF A FIBERGLASS WITNESS POST ELEVATION = 6289.86 FEET (NAVD 1988)"

CONSTRUCTION NOTES

- (1) EXISTING ASPHALT TO REMAIN AND BE PROTECTED THROUGHOUT CONSTRUCTION.
- $\langle 2 \rangle$ EXISTING STRIPING TO REMAIN AND BE PROTECTED THROUGHOUT CONSTRUCTION.
- $\langle 3 \rangle$ EXISTING CURB & GUTTER TO REMAIN AND BE PROTECTED THROUGHOUT CONSTRUCTION.
- $\langle 4 \rangle$ EXISTING UTILITY POLE & OVERHEAD UTILITY TO REMAIN AND BE PROTECTED THROUGHOUT CONSTRUCTION.
- $\overline{(5)}$ CONSTRUCT HEAVY DUTY CONCRETE PAVEMENT WITH #4 REINFORCING AT 18" O.C.E.W. RE: GRADING & EROSION CONTROL PLANS UNDER SEPARATE COVER FOR ADDITIONAL INFORMATION.
- $\langle 6 \rangle$ EXISTING CULVERT TO REMAIN AND BE PROTECTED THROUGHOUT CONSTRUCTION.
- $\langle 7 \rangle$ EXISTING SIGN TO BE RELOCATED OR REPLACED IN KIND TO MATCH EXISTING INSTALLATION AS SHOWN.
- $\langle 8 \rangle$ EXISTING UTILITY VAULT & LID TO BE ADJUSTED AS NECESSARY TO MATCH PROPOSED IMPROVEMENTS.
- $\langle 9 \rangle$ REMOVE, RELOCATE, OR PROTECT EXISTING UTILITY AND/OR UTILITY APPURTENANCE TO REMAIN. CONTRACTOR SHALL COORDINATE SAID WORK WITH OWNER/DEVELOPER AND UTILITY PROVIDER PRIOR TO COMMENCEMENT OF WORK.
- $\langle 10 \rangle$ CONSTRUCT PUBLIC CURB RAMP, TYPE AS SHOWN. RE: SHEET C810, DETAIL B, AND CITY OF COLORADO SPRINGS DETAILS D8-A, D8-B, AND D8-L.
- (11) PAINT 4-INCH WIDE WHITE STRIPE AS SHOWN IN ACCORDANCE WITH CITY OF COLORADO SPRINGS. CDOT AND MUTCD STANDARDS AND SPECIFICATIONS.
- (12) CONSTRUCT TYPE 2. 6-INCH CONCRETE VERTICAL CURB & GUTTER. RE: SHEET C811, CITY OF COLORADO SPRINGS DETAIL 6B.
- (13) CONSTRUCT 10-FOOT WIDE, 4-INCH THICK CONCRETE SIDEWALK IN ACCORDANCE WITH CITY OF COLORADO SPRINGS STANDARDS AND REGULATIONS INCLUDING, BUT NOT LIMITED TO MATERIALS, SUB-GRADE, COMPACTION, AND JOINTING.
- $\langle 14 \rangle$ SAWCUT AND REMOVE EXISTING PAVEMENT AS SHOWN.
- $\langle 15 \rangle$ CONSTRUCT ASPHALT PAVEMENT IN SHOULDER AS SHOWN IN ACCORDANCE WITH THE CITY OF COLORADO SPRINGS PAVEMENT DESIGN CRITERIA MANUAL, CITY OF COLORADO SPRINGS STANDARD SPECIFICATIONS, AND PIKES PEAK REGION ASPHALT PAVING SPECIFICATIONS WHICH STATES THAT THE CONTRACTOR SHALL SUBMIT A MIX DESIGN TO THE CITY A MINIMUM OF 7 DAYS PRIOR TO THE BEGINNING OF PAVING OPERATIONS. THE SUBMITTAL SHALL INCLUDE, BUT NOT BE LIMITED TO THE PAVEMENT SECTION, MATERIALS, SUB-GRADE, AND COMPACTION.
- $\langle 16 \rangle$ CONSTRUCT CURB OPENING WITH DRAINAGE CHASE TO WIDTH SHOWN. RE: SHEET C811, CITY OF COLORADO SPRINGS DETAILS D-21A AND D-21B.
- $\langle 17 \rangle$ SAWCUT AND REMOVE EXISTING EDGE OF ASPHALT (TYP.)
- (18) TAPER END OF VERTICAL CURB TO FLUSH WITH ADJACENT PAVEMENT OVER 3' HORIZONTAL.
- (19) CONSTRUCT HEAVY DUTY CONCRETE PAVEMENT WITH #4 REINFORCING AT 18" O.C.E.W., SEE PAVING NOTE (THIS SHEET).
- $\langle 20 \rangle$ CONSTRUCT CONCRETE CROSS PAN. RE: SHEET C811, CITY OF COLORADO SPRINGS DETAILS D7A AND D7B.
- $\langle 21 \rangle$ CONSTRUCT DRAINAGE SWALE. RE: GRADING & EROSION CONTROL PLANS UNDER SEPARATE COVER.
- $\langle 22 \rangle$ CONSTRUCT DRAINAGE CHANNEL. RE: GRADING & EROSION CONTROL PLANS UNDER SEPARATE COVER.
- 23 CONSTRUCT RIPRAP APRON. RE: GRADING & EROSION CONTROL PLANS UNDER SEPARATE COVER.
- (24) CONSTRUCT 6.0' X 6.0' TYPE L RIPRAP APRON. RE: SHEET C810, DETAIL A.
- $\langle 25 \rangle$ DEPRESS GUTTER 2" TO ACCOMPLISH 8" VERTICAL CURB AT CURB OPENING. TRANSITION OVER 2' HORIZONTAL PAST OUTSIDE EDGE OF CURB OPENING, EITHER SIDE OF TOTAL OPENING(S).
- $\langle 26 \rangle$ EXTEND CULVERT, INSTALL END SECTION, AND CONSTRUCT TOE WALL. RE: GRADING & EROSION CONTROL PLANS UNDER SEPARATE COVER.

PAVING NOTE

ALL PAVING, INCLUDING CURB, GUTTER, AND SIDEWALK, TO BE INSTALLED OUTSIDE OF THE RIGHT OF WAY SHALL BE IN ACCORDANCE WITH THE GEOTECHNICAL INVESTIGATION PAVEMENT RECOMMENDATIONS INCLUDING, BUT NOT LIMITED TO, THE PAVEMENT SECTION, MATERIAL, AND SUBGRADE PREPARATION. THE CONTRACTOR SHALL COORDINATE APPROVAL FOR INSTALLATION OF ANY ALTERNATE RECOMMENDATIONS INCLUDED IN THE INVESTIGATION OR DESIRED MODIFICATIONS TO THE RECOMMENDATIONS WITH THE OWNER/DEVELOPER AND/OR THEIR CONSTRUCTION MANAGER PRIOR TO BID AND PRIOR TO CONSTRUCTION. FOR GEOTECHNICAL INVESTIGATIONS WHICH DO NOT SPECIFICALLY ADDRESS CURB, GUTTER, SIDEWALK AND SIMILAR IMPROVEMENTS NOT SUBJECT TO VEHICULAR LOADS, CONCRETE SHALL BE CDOT CLASS B, IN ACCORDANCE WITH CDOT STANDARDS AND SPECIFICATIONS.



Civil Engineers | Landscape Architects 2009 W. Littleton Blvd. #300 Littleton, CO 80120 303.794.4727 | www.SterlingDesignAssociates.com

PREPARED UNDER THE DIRECT SUPERVISION OF JAY M. NEWELL, PE COLORADO REGISTRATION 35219 FOR & ON BEHALF OF STERLING DESIGN ASSOCIATES, LLC

STERLING DESIGN ASSOCIATES, LLC

NO.: 1 DATE:	BY:
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	BY: -

SCALE. 6/2023 1" = 20'-0" PROJECT MANAGER: PROJECT NO .: JS DRAWN BY: DRAWING FILE: JN

PROJECT:

SPACE VILLAGE FILING NO. 4 EL PASO COUNTY, CO

CLIENT

COMMERCIAL BUILDING SERVICES 7561 S. GRANT STR., SUITE A-4 LITTLETON, COLORADO 80122


TEL: (303) 730-3001

SHEET TITLE:

ROADWAY PLAN

SHEET NUMBER:

2

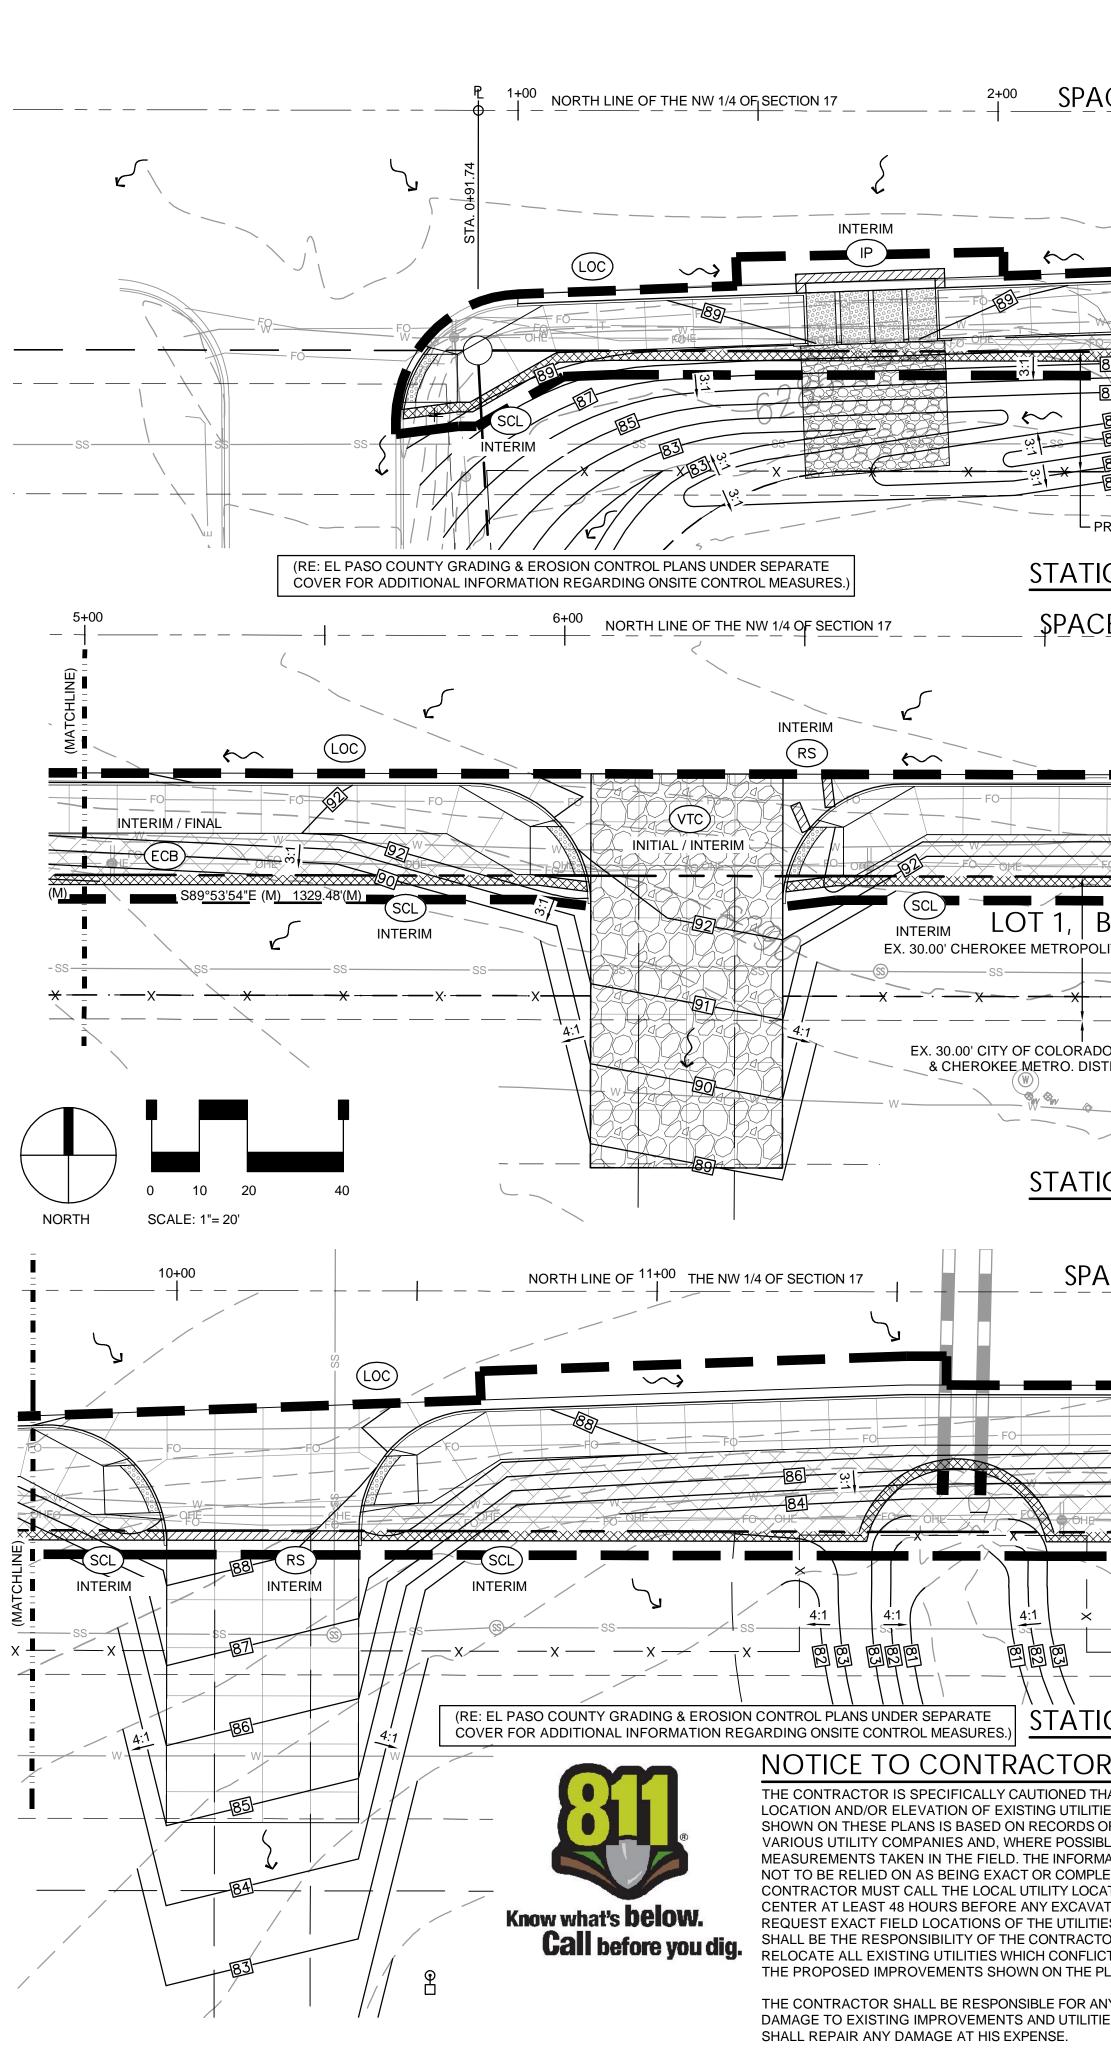

SPACE VILLAGE FILING NO. 4 A PORTION OF THE NW 1/4 OF SEC. 17, T14S, R65W, OF THE 6th P.M., EL PASO COUNTY, COLORADO ROADWAY PLAN

CE_VILLAGE_AVENUE_ PUBLIC R.O.W. (WIDTH VARIES)		PETERSON AFB MS4; EAST FORK SAND CREEK; ± 5 MI. TO FOUNTAIN CREEK. (AS DESCRIBED IN NPDES PERMIT NO. CO-R042006, 12/5/15)	4+00 	
		FINAL - INTERIM / FO B8 OF SM FO ECB	FINAL	F0 F0 OHE OHE SCL S89°53'54"E (M)
851 861 851 851 851 841 841 841 841 841 841 841 841 851 851 851 851 851 851 851 851 851 85	EX. 30.00' CHEROKEE METROPOI	LITAN DISTRICT UTIL. ESMT. 		INTERIM
ON 1+00 - 5+00	EX. 30.00' CITY OF COLORAD PETERSON AFB MS4; EAST FOR SAND CREEK; ± 5 MI. TO FOUNT CREEK. (AS DESCRIBED IN NPDI	AIN	TRO. DISTRICT UŤI⊾. ESMT.	
E VILLAGE AVENUE PUBLIC R.O.W. (WIDTH VARIES)	PERMIT NO. CO-R042006, 12/5/15	5)	53'54" <u>E</u> LOC	
FO FO FO FO FO FO FO FO FO FO FO FO FO F				
BLOCK 1 LITAN DISTRICT UTIL. ESMT.		PASO COUNTY GRADING & EROSION-CO FOR ADDITIONAL INFORMATION REGARD		
O SPRINGS UTIL. ESMT.	PETERSON AFB MS4; EAST F SAND CREEK; ± 5 MI. TO FOU CREEK. (AS DESCRIBED IN N PERMIT NO. CO-R042006, 12/3	INTÁIN IPDES	×	
ON 5+00 - 9+70	W W			
		00		00 PL 00 FO
S89°53'54"E (M) 1329.48'(M)				
$\frac{1}{2} = \frac{1}{2} = \frac{1}$	SS SS SS SS 83 SS 83	OLORADO SPRINGS UTIL. ESMT. & CHERO		
$\frac{14+14.90}{\text{LEGEND}}$	V PETERSON AFB MS4; EAST FC MI. TO FOUNTAIN CREEK. (AS NPDES PERMIT NO. CO-R0420	DESCRIBED IN		
ES AS DF THE LE, ATION IS ETE. THE ATION TO ES. IT OR TO CT WITH ES AS OF THE COMPANY OHE OHE	PROPERTY LINE ADJACENT PROPERTY EASEMENT LINE EXIST. MAJOR CONTOL EXIST. MINOR CONTOU PROP. CONTOUR EXIST. FENCE EXIST. EDGE OF ASPH/ EXIST. CURB AND GUT EXIST. OVERHEAD ELE	JR JR ALT TER	PROP. CONCRETE PROP. FENCE PROP. RIPRAP VEHICLE TRACKING CONTROL (RE: EL PASO COUNTY GRADING &	SM SEI (RE GR CO SEI CO SEI FLC LIM



2009 W. Littleton Blvd. #300 Littleton, CO 80120 303.794.4727 | www.SterlingDesignAssociates.com

PREPARED UNDER THE DIRECT SUPERVISION OF JAY M. NEWELL, PE COLORADO REGISTRATION 35219 FOR & ON BEHALF OF STERLING DESIGN ASSOCIATES, LLC

BENCHMARK

5+00

INLET PROTECTION

SEEDING & MULCHING

(RE: EL PASO COUNTY

GRADING & EROSION

SEPARATE COVER)

FLOW DIRECTION

WATERS

CONTROL PLANS UNDER

LIMITS OF CONSTRUCTION

DISCHARGE POINT / RECEIVING

EROSION CONTROL BLANKET

AS PROVIDED ON *ALTA/NSPS LAND TITLE SURVEY* PREPARED BY ALTURA LAND CONSULTANTS, DATED APRIL 28, 2022 FOR THIS PROJECT:

"NGS BENCHMARK "R 76" - LOCATED 0.2 MILE EAST ALONG HIGHWAY 94, FROM PETERSON ROAD, 22 FEET SOUTH-SOUTHEAST OF THE SOUTHEAST CORNER OF AN ADDITION TO THE BUILDING (SANDY'S RESTAURANT), 48 FEET NORTH OF THE CENTERLINE OF THE HIGHWAY, 3.5 FEET SOUTH OF A POWER POLE AND 3 FEET SOUTH OF A FIBERGLASS WITNESS POST. ELEVATION = 6289.86 FEET (NAVD 1988)"

GENERAL NOTES

- 1. REFER TO SHEET C800 AND EL PASO COUNTY GRADING & EROSION CONTROL PLAN UNDER SEPARATE COVER FOR ADDITIONAL PROJECT GENERAL NOTES.
- 2. THE PLAN SHALL NOT SUBSTANTIALLY CHANGE THE DEPTH OF COVER, OR ACCESS TO UTILITY FACILITIES. ADDITIONALLY, THE PLAN SHALL NOT INCREASE OR DIVERT WATER TOWARDS UTILITY FACILITIES. ANY CHANGES TO UTILITY FACILITIES TO ACCOMODATE THE PLAN, MUST BE DISCUSSED AND AGREED TO BY THE AFFECTED UTILITY PRIOR TO IMPLEMENTING THE PLAN. THE RESULTING COST TO RELOCATE OR PROTECT UTILITIES, OR PROVIDE INTERIM ACCESS IS AT THE EXPENSE OF THE PLAN APPLICANT.
- 3. REFER TO EL PASO COUNTY GRADING & EROSION CONTROL PLANS FOR LOCATION(S) OF SOIL STOCKPILE(S), CONCRETE WASHOUT AREA(S), STAGING AREA(S), ADDITIONAL CONTROL MEASURES SUCH AS STREET SWEEPING, SEEDING & MULCHING AND VEHICLE TRACKING CONTROL; AND ADDITIONAL ON SITE CONTROL MEASURES.
- 4. AREA OF LAND DISTURBANCE: ±0.75 AC (W/IN R.O.W). REFER TO EL PASO COUNTY GRADING & EROSION CONTROL PLANS FOR ON SITE AREA OF LAND DISTURBANCE.
- 5. ANTICIPATED START: SUMMER 2023 ANTICIPATED COMPLETION: SPRING 2024 ANTICIPATED FINAL STABILIZATION: SPRING 2024

STERLING DESIGN ASSOCIATES, LLC

NO.: 1	DATE:	BY:
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DATE: 6/2023	SCALE: 1" = 20'-0"
PROJECT MANAGER: JS	PROJECT NO.:
DRAWN BY:	DRAWING FILE:

JN

PROJECT:

SPACE VILLAGE FILING NO. 4 EL PASO COUNTY, CO

CLIENT:


COMMERCIAL BUILDING SERVICES 7561 S. GRANT STR., SUITE A-4 LITTLETON, COLORADO 80122

TEL: (303) 730-3001

SHEET TITLE:

EROSION CONTROL PLAN (SWMP-SITE MAP)

SHEET NUMBER:

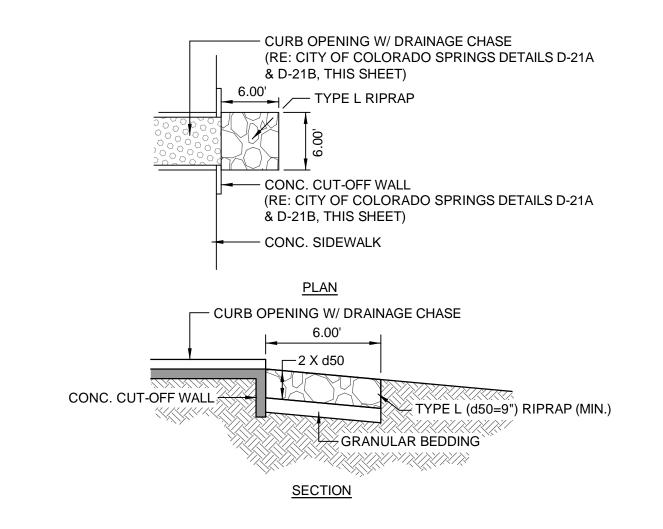

RIPRAP SIZE	% SMALLER THAN GIVEN SIZE BY WEIGHT	INTERMEDIATE ROCK DIMENSION (INCHES)	d50 (INCHES)
	70 - 100	15	
	50 - 70	12	9
	35 - 50	9	9
	2 - 10	3	


d50 = MEAN ROCK SIZE

THICKNESS REQUIREMENTS FOR GRANULAR BEDDING				
RIPRAP MINIMUM BEDDING THICKNESS (INCHES)			SS (INCHES)	
DESIGNATION	FINE-GRAINED SOILS ¹		COARSE-GRAINED SOILS ²	
	TYPE I (LOWER LAYER) TYPE II (UPPER LAYER)		TYPE II	
L	4 4		6	

¹ MAY SUBSTITUTE ONE 12-INCH LAYER OF TYPE II BEDDING. ² FIFTY PERCENT OR MORE BY WEIGHT RETAINED ON THE # 40 SIEVE.

GRADATION FOR GRANULAR BEDDING				
U.S. STANDARD	% PASSING BY WEIGHT			
SIEVE SIZE	TYPE I CDOT SECT. 703.01	TYPE II CDOT SECT. 703.09 CLASS A		
3 INCHES -		90 - 100		
1 ¹ / ₂ INCHES -		-		
34 INCHES	-	20 - 90		
38 INCHES	100	-		
# 4 95 - 100		0 - 20		
# 16 45 - 80		-		
# 50 10 - 30		-		
# 100	2 - 10	_		
# 200 0 - 2		0 - 3		



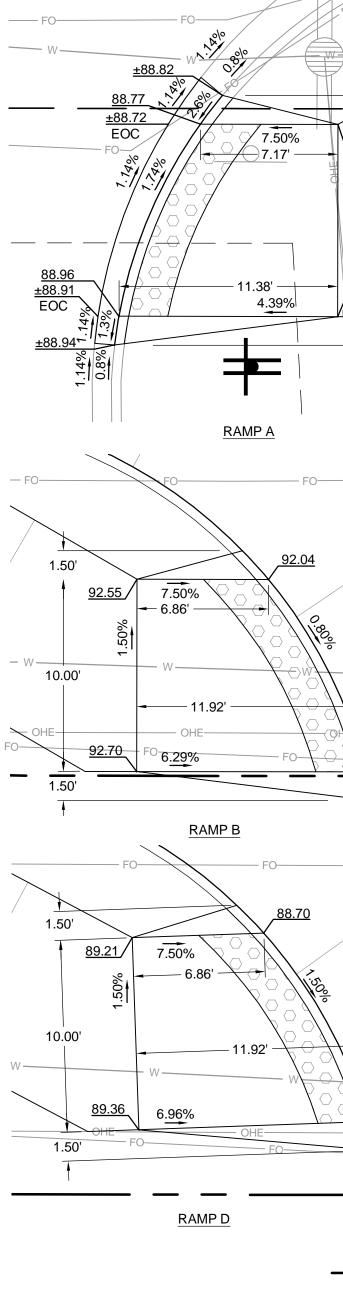

89.31

89.46

1 50

91.95

88.53

OHE-----

— FO-

<u>92.62</u>

F----- FO:

<u>92.41</u>

<u>87.94</u>

— W-

____0

FO----

7.50%

- 6.86' -

- 11.92' --

RAMP C

7.29%

7.50%

6.21%

- 6.86'

- 11.92' -

93.13

<u>93.28</u>

88.53

88.68

- OHE-


10.00'

1.50

1.50'

10.00'

- 1.50'

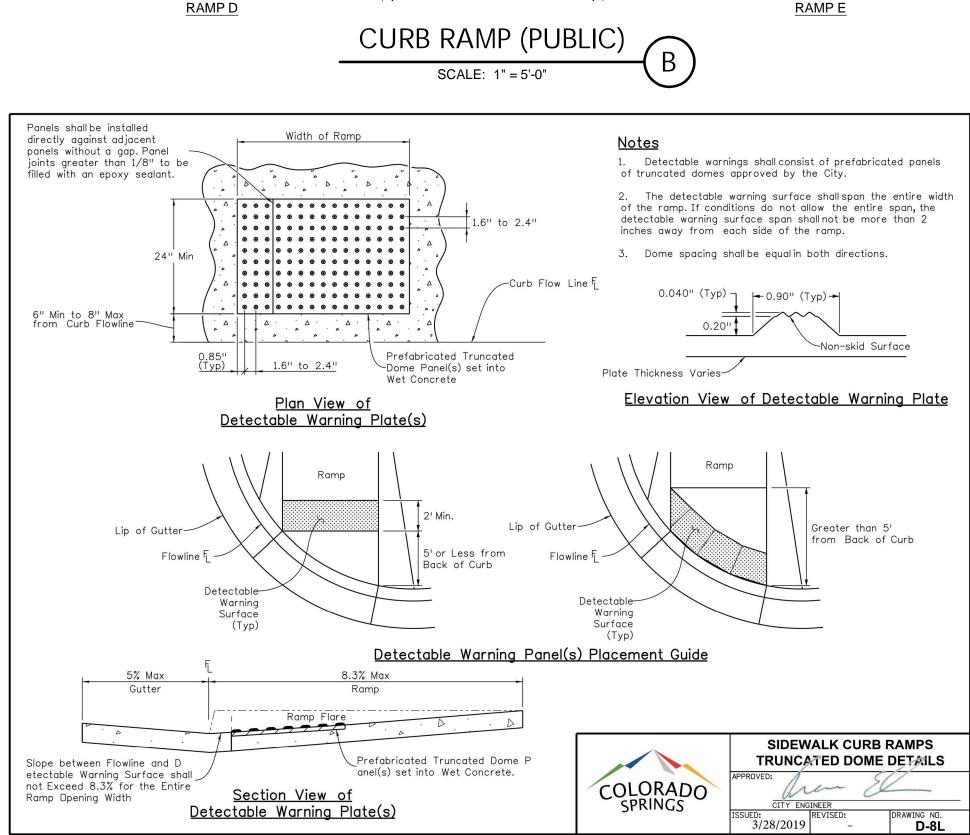

a square grid pattern and aligned with pedestrian traffic. constructed within the curved portion of the return as approved by the City. 8. Ramp and detectable warning running slope shall be 8.3% or flatter except on long ramps as specified by Note 14. 9. Drainage structures, traffic signal equipment, or other obstructions shall not be installed in the ramp or turning space areas. 10. If a traffic signal pedestrian push button cannot be mounted within 10 inches horizontally of the pedestrian path or is obstructed from reach then a separate pedestrian push button post assembly shall be installed. Push buttons shall meet the requirements of MUTCD Chapter 4 for pedestrian detectors.

roadway surface and gutter pan shallbe flush.

that it is unlikely for a pedestrian to walk across the flared side slope.

e Notes 1 and 2

└─6'' Min

<u>Section A-A</u>

8.3% Max

Flare

<u>Section B-B</u>

Prefabricated Truncated Dome

5' Min, 2% Max Any Direction

Turning Space

Expansion Joint

Lip of Gutter-

Detectable Warning

Surface (Typ)


⊢4" Min


Panel Set Into Wet Concrete-

length is not required to exceed 15 feet.

blended transition shall not exceed 5.0%.

- All detectable warning surfaces at the base of ramps shall start a minimum of 6 inches from the flowline of the curb and not be more than 8 inches from any point on the flowline of the curb, with the exception for ramps that are
- 6. Detectable warnings shall be installed at sidewalk to street transitions and shall consist of prefabricated truncated dome panels approved by the City. The detectable warning panels shall be set into the wet concrete. The domes shall be in
- 4. A broom finish, with sweeps perpendicular to the direction of pedestrian traffic, shall be applied to all ramp surfaces. 5. The Contractor shall stamp their company name and construction date at the top right corner of the ramp as viewed from the street.
- 3. Concrete shall have a minimum compressive strength of 4,000 psi and use a City-approved concrete mix.
- 2. The Contractor shall obtain all required permits and notify City Engineering by 1500 hours the business day before inspection is required.
- Engineering Division (the City) Standard Specifications.
- <u>General Notes</u> . All work shall be done in accordance with the current City of Colorado Springs

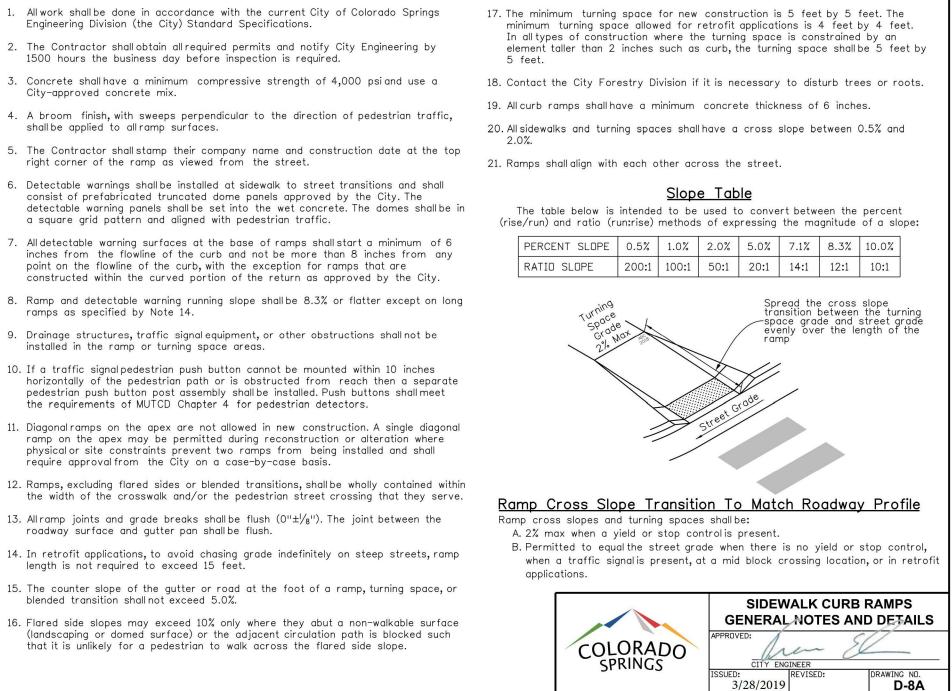

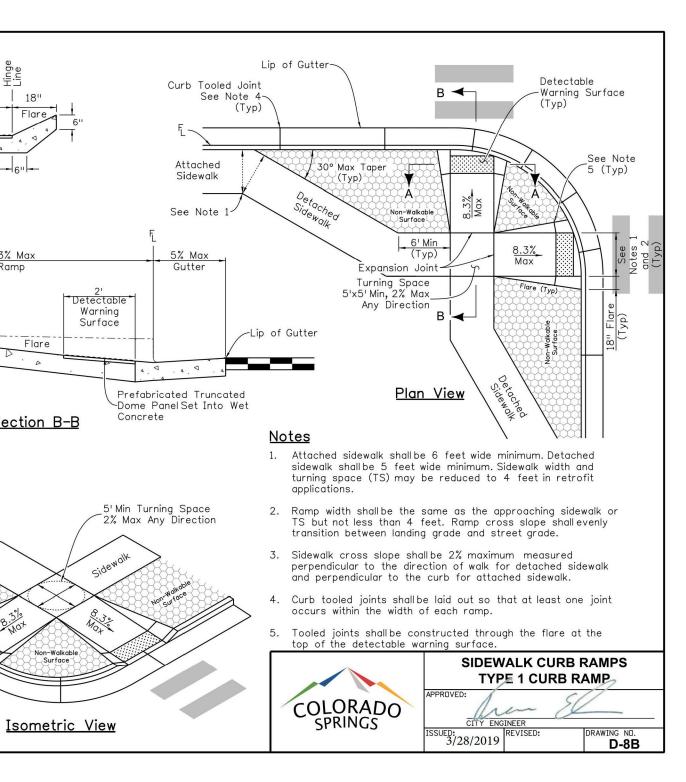



ISSUES & REVISIONS	
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DESCRIPTION: -	
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NO.: 5 DATE: -	BY: -
DESCRIPTION: -	
NO.: 6 DATE: -	BY: -
DESCRIPTION: -	
DATE:	SCALE:
6/2023	N/A
PROJECT MANAGER:	PROJECT NO.:

STERLING DESIGN ASSOCIATES, LLC

DATE: 6/2023	SCALE: N/A
PROJECT MANAGER: JS	PROJECT NO.:
DRAWN BY: JN	DRAWING FILE:

SPACE VILLAGE FILING NO. 4 EL PASO COUNTY, CO


CLIENT: COMMERCIAL BUILDING SERVICES 7561 S. GRANT STR., SUITE A-4 LITTLETON, COLORADO 80122

TEL: (303) 730-3001

SHEET TITLE: DETAILS

PROJECT:

SHEET NUMBER:

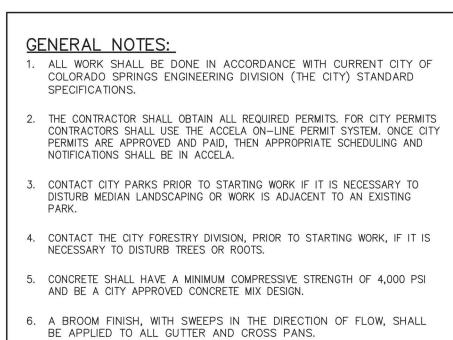



PRIOR TO OPENING TO TRAFFIC, CONCRETE SHALL HAVE A MINIMUM COMPRESSIVE STRENGTH OF 3,200 PSI AS DEMONSTRATED BY FIELD


CURE CYLINDERS.


SPECIFICATION OF SECTION 500.


- 8. NEW ASPHALT SHALL NOT BE PLACED AGAINST FRESHLY POURED CONCRETE. CONCRETE SHALL BE 5-DAYS OLD OR HAVE A COMPRESSIVE STRENGTH OF 3,200 PSI AS DEMONSTRATED BY FIELD CURE CYLINDERS. WHERE PATCHING IN AN EXISTING ROADWAY, PATCHING SHALL BE IN ACCORDANCE WITH ASPHALT REPAIR DRAWINGS.
- 9. THE CONTRACTOR SHALL STAMP THEIR COMPANY NAME AND CONSTRUCTION DATE ON FRONT FACE OF CURB. 10. WHITE CURE SHALL BE PLACED WITH 100% COVERAGE, AND MEET THE

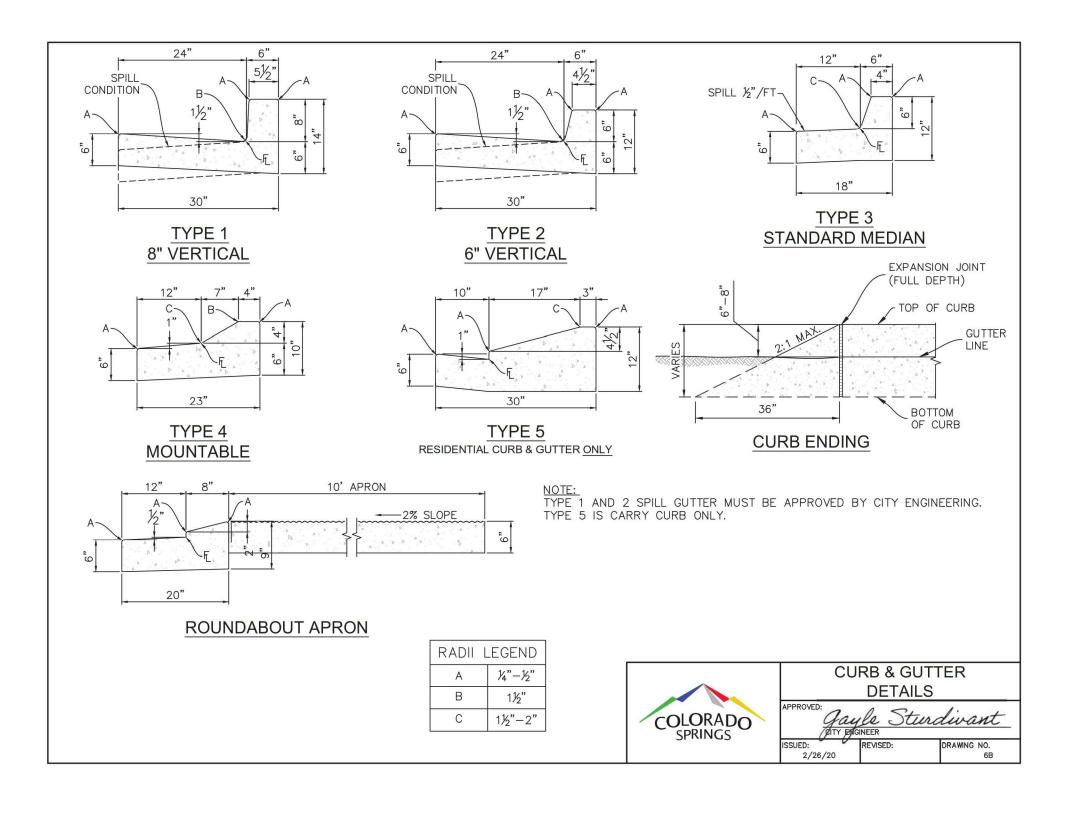

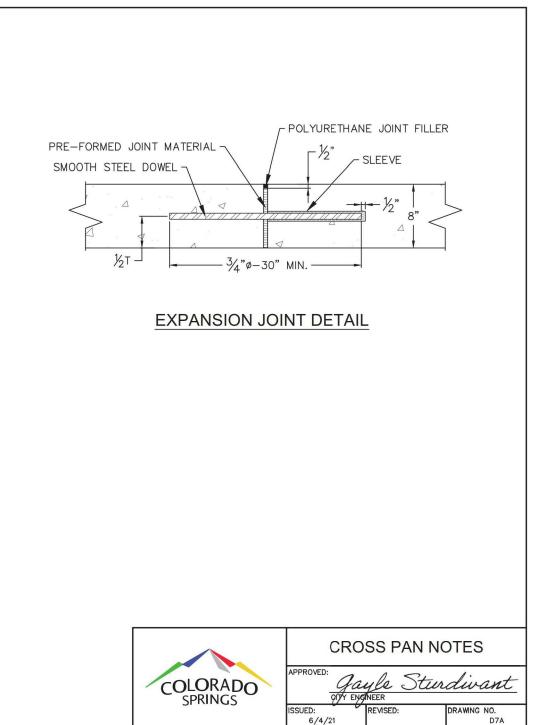

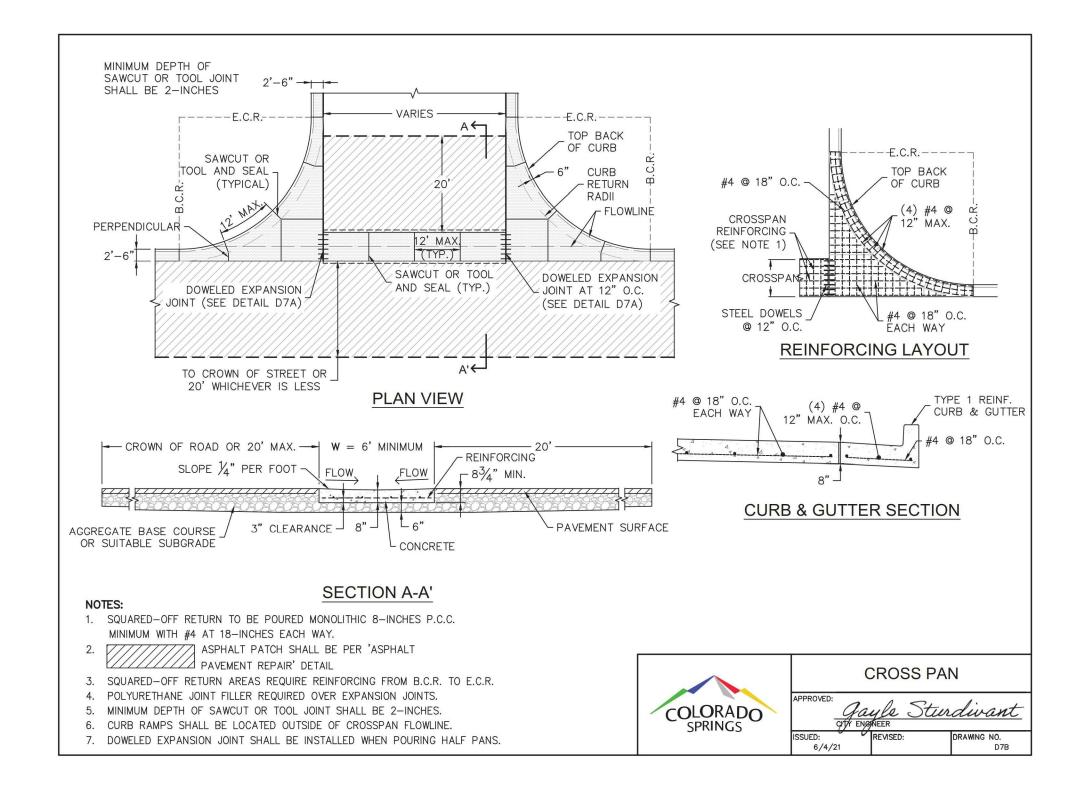

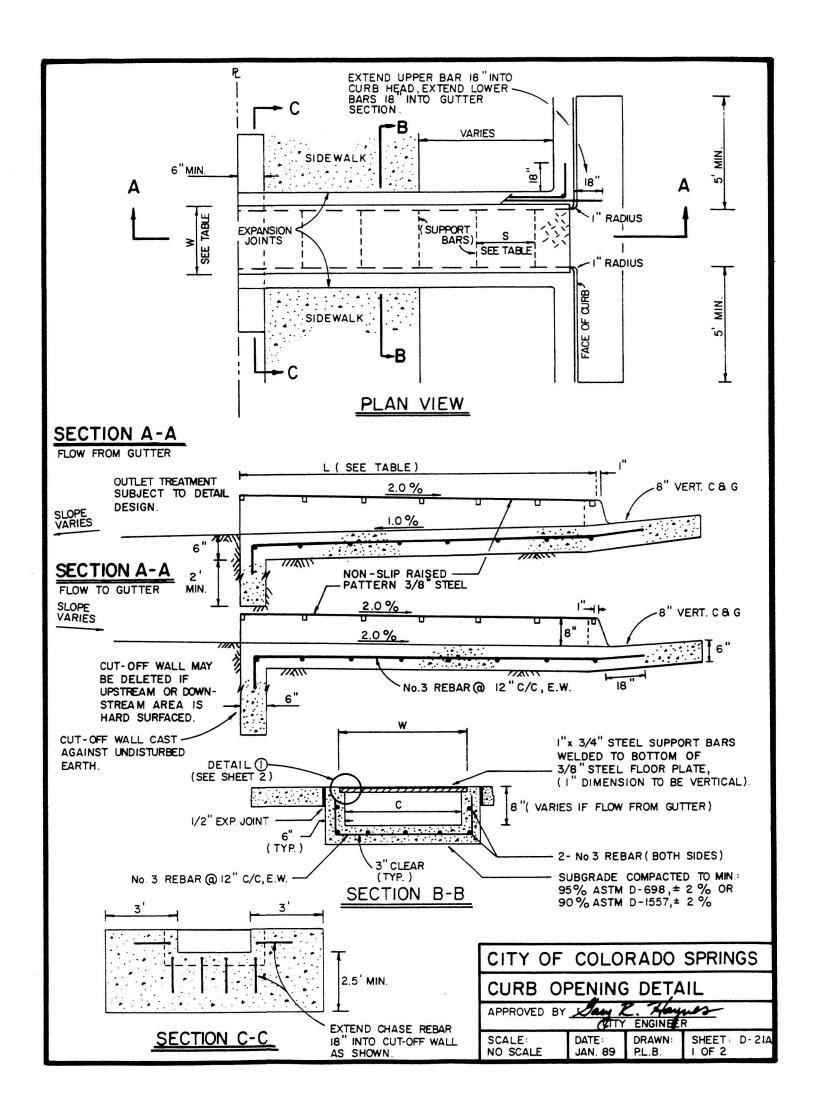

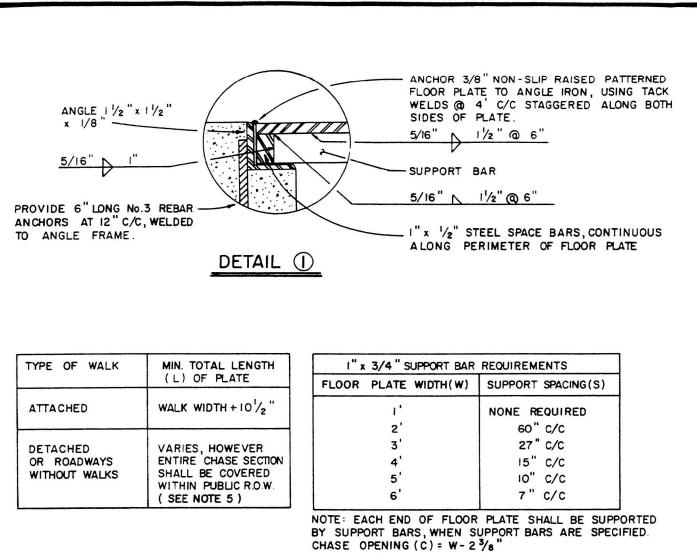

- NOTES:
- I. ALL EXPOSED METAL TO BE HOT FIELD WELDS TO BE TOUCH-UP 2. WHEN OTHER THAN TYPE I (8") CONTRACTOR SHALL REMOVE T FOR THE REQUIRED TRANSITIONS BEGINNING AT THE EDGE OF THE
- SHALL BE A MINIMUM OF 5 FEE FEET OF TRANSITION TO EXIST 3. ALL REMOVAL OF EXISTING CUR OR BY REMOVAL TO AN EXISTING EXPANSION OR COLD JOINT REMAINING SECTION AFTER SAW CUTTING TO BE MINIMUM 4' IN LENGTH.
- 4. CHASE SECTION TO BE POURED MONOLITHICALLY WITH CURB & GUTTER SECTION AND CUT- OFF WALL. 5. WHEN CHASE SECTION LENGTH (L) EXCEEDS 15' PROVIDE TOOL JOINT IN CONCRETE AT MAXIMUM OF 10 SPACING FABRICATE

LENGTH.

IGTH	I" x 3/4" SUPPORT BAR REQUIREMENTS		
	FLOOR PLATE WIDTH(W)	SUPPORT SPACING(S)	
)'/2"	۱'	NONE REQUIRED	
	2'	60" c/c	
ER	3'	27 " C/C	
ECTION	4'	15" C/C	
RED	5'	10" C/C	
	6'	7" c/c	
	NOTE: EACH END OF FLOOR	PLATE SHALL BE SUPPO	

T	DIPPE	ED ZI	NE CO	DATED.
	WITH	COLD	ZINE	COATING

CURB EXISTS, THE
THE EXISTING CURB TO ALLOW
S, AS FOLLOWS:
CHASE SECTION, THERE
ET OF TYPE I CURB PLUS IO
TING CURB TYPE.
RB SHALL BE BY SAW-CUT.

FLOOR PLATES IN MULTIPLE SECTION NOT TO EXCEED IO' IN

CITY OF	COLO	RADOS	SPRINGS
CURB OPENING DETAIL			
APPROVED BY	CEITY	ENGINEE	R
SCALE: NO SCALE	DATE: JAN. 89	DRAWN: P.L.B.	SHEET: D-21B 2 OF 2



STERLING DESIGN ASSOCIATES, LLC

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DESCRIPTION: -	
NO.: 3 DATE: -	BY: -
DESCRIPTION: -	
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DESCRIPTION: -	
NO.: 5 DATE: -	BY: -
DESCRIPTION: -	
NO.: 6 DATE: -	BY: -
DESCRIPTION: -	
DATE:	SCALE:
6/2023	N/A
	PROJECT NO.:
PROJECT MANAGER: JS	

PROJECT:

SPACE VILLAGE FILING NO. 4 EL PASO COUNTY, CO

CLIENT:

COMMERCIAL BUILDING SERVICES 7561 S. GRANT STR., SUITE A-4 LITTLETON, COLORADO 80122


TEL: (303) 730-3001

SHEET TITLE:

DETAILS

SHEET NUMBER:

5

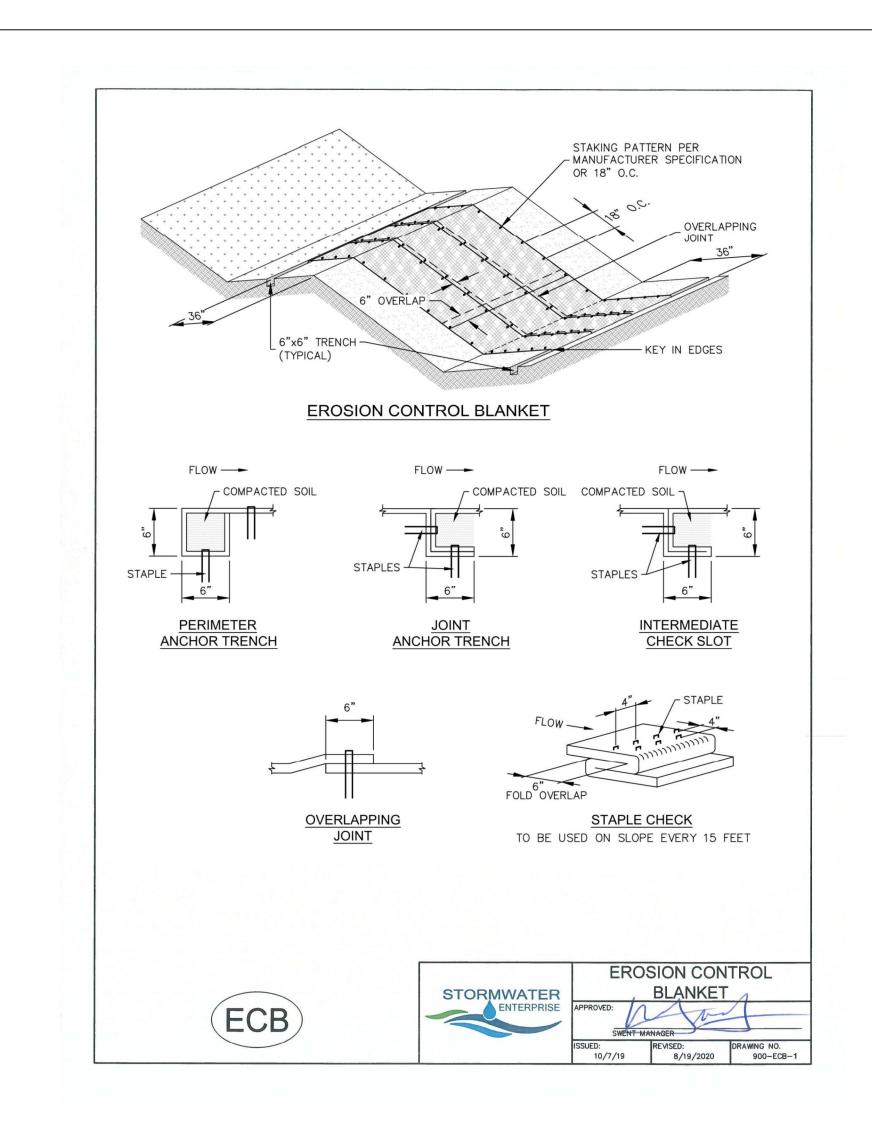

INSTALLATION NOTES

- 100% NATURAL AND BIODEGRADABLE MATERIALS ARE REQUIRED FOR EROSION CONTROL BLANKETS. TRM PRODUCTS MAY ME USED WHERE APPROPRIATE AS DESIGNATED BY THE ENGINEER.
- 2. IN AREAS WHERE EROSION CONTROL BLANKETS ARE SHOWN ON THE PLANS, THE PERMITTEE SHALL PLACE TOPSOIL AND PERFORM FINAL GRADING, SURFACE PREPARATION, AND SEEDING AND MULCHING. SUBGRADE SHALL BE SMOOTH AND MOIST PRIOR TO EROSION CONTROL BLANKET INSTALLATION, AND THE EROSION CONTROL BLANKET SHALL BE IN FULL CONTACT WITH THE SUBGRADE. NO GAPS OR VOIDS SHALL EXIST UNDER THE
- BI ANKET . PERIMETER ANCHOR TRENCH SHALL BE USED ALONG THE OUTSIDE PERIMETER OF ALL BLANKET AREAS.
- 4. JOINT ANCHOR TRENCH SHALL BE USED TO JOIN ROLLS OF EROSION CONTROL BLANKETS TOGETHER (LONGITUDINALLY AND TRANSVERSELY) FOR ALL EROSION CONTROL BLANKETS. INTERMEDIATE CHECK SLOT OR STAPLE
- CHECK SHALL BE INSTALLED EVERY 15' DOWN SLOPES. IN DRAINAGEWAYS, INSTALL CHECK SLOTS EVERY 25' PERPENDICULAR TO FLOW DIRECTION. 6. OVERLAPPING JOINT DETAIL SHALL BE
- USED TO JOIN ROLLS OF EROSION CONTROL BLANKETS TOGETHER FOR EROSION CONTROL BLANKETS ON SLOPES. 7. MATERIAL SPECIFICATIONS OF EROSION
- CONTROL BLANKETS SHALL CONFORM TO TABLE ECB-1. 8. ANY AREAS OF SEEDING AND MULCHING
- DISTURBED IN THE PROCESS OF INSTALLING EROSION CONTROL BLANKETS SHALL BE RESEEDED AND MULCHED. 9. STRAW EROSION CONTROL BLANKETS SHALL NOT BE USED WITHIN STREAMS


ECB


AND DRAINAGE CHANNELS. 10. COMPACT ALL TRENCHES.


MAINTENANCE NOTES

- 1. FREQUENT OBSERVATIONS AND MAINTENANCE ARE NECESSARY TO MAINTAIN CONTROL MEASURES IN EFFECTIVE OPERATING CONDITION. INSPECTIONS AND CORRECTIVE MEASURES SHOULD BE DOCUMENTED
- THOROUGHLY. 2. EROSION CONTROL BLANKETS SHALL BE LEFT IN PLACE TO EVENTUALLY BIODEGRADE. TRM MUST BE REMOVED AT THE DISCRETION OF THE GEC INSPECTOR. 3. ANY EROSION CONTROL BLANKET PULLED OUT. TORN. OR OTHERWISE DAMAGED SHALL BE REPAIRED OR
- REINSTALLED. ANY SUBGRADE AREAS BELOW GEOTEXTILE THAT HAVE ERODED TO CREATE A VOID UNDER THE BLANKET, OR THAT REMAIN DEVOID OF GRASS SHALL BE REPAIRED, RESEEDED AND MULCHED AND THE EROSION CONTROL BLANKET REINSTALLED.


TABLE ECB-1, EROSION CONTROL BLANKET MATERIAL SPECIFICATIONS						
TYPE	COCONUT CONTENT	STRAW CONTENT	EXCELSIOR CONTENT	RECOMMENDED NETTING		
STRAW	_	100%	-	DOUBLE/ NATURAL		
STRAW- COCONUT	30% MIN.	70% MAX.	<u> </u>	DOUBLE/ NATURAL		
COCONUT	100%	°. <mark>-}-</mark> ⊒∎∎	-	DOUBLE/ NATURAL		
EXCELSIOR		-	100%	DOUBLE/ NATURAL		

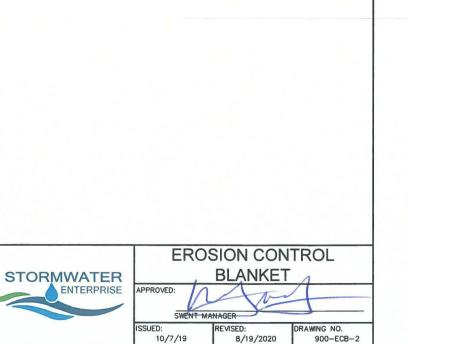


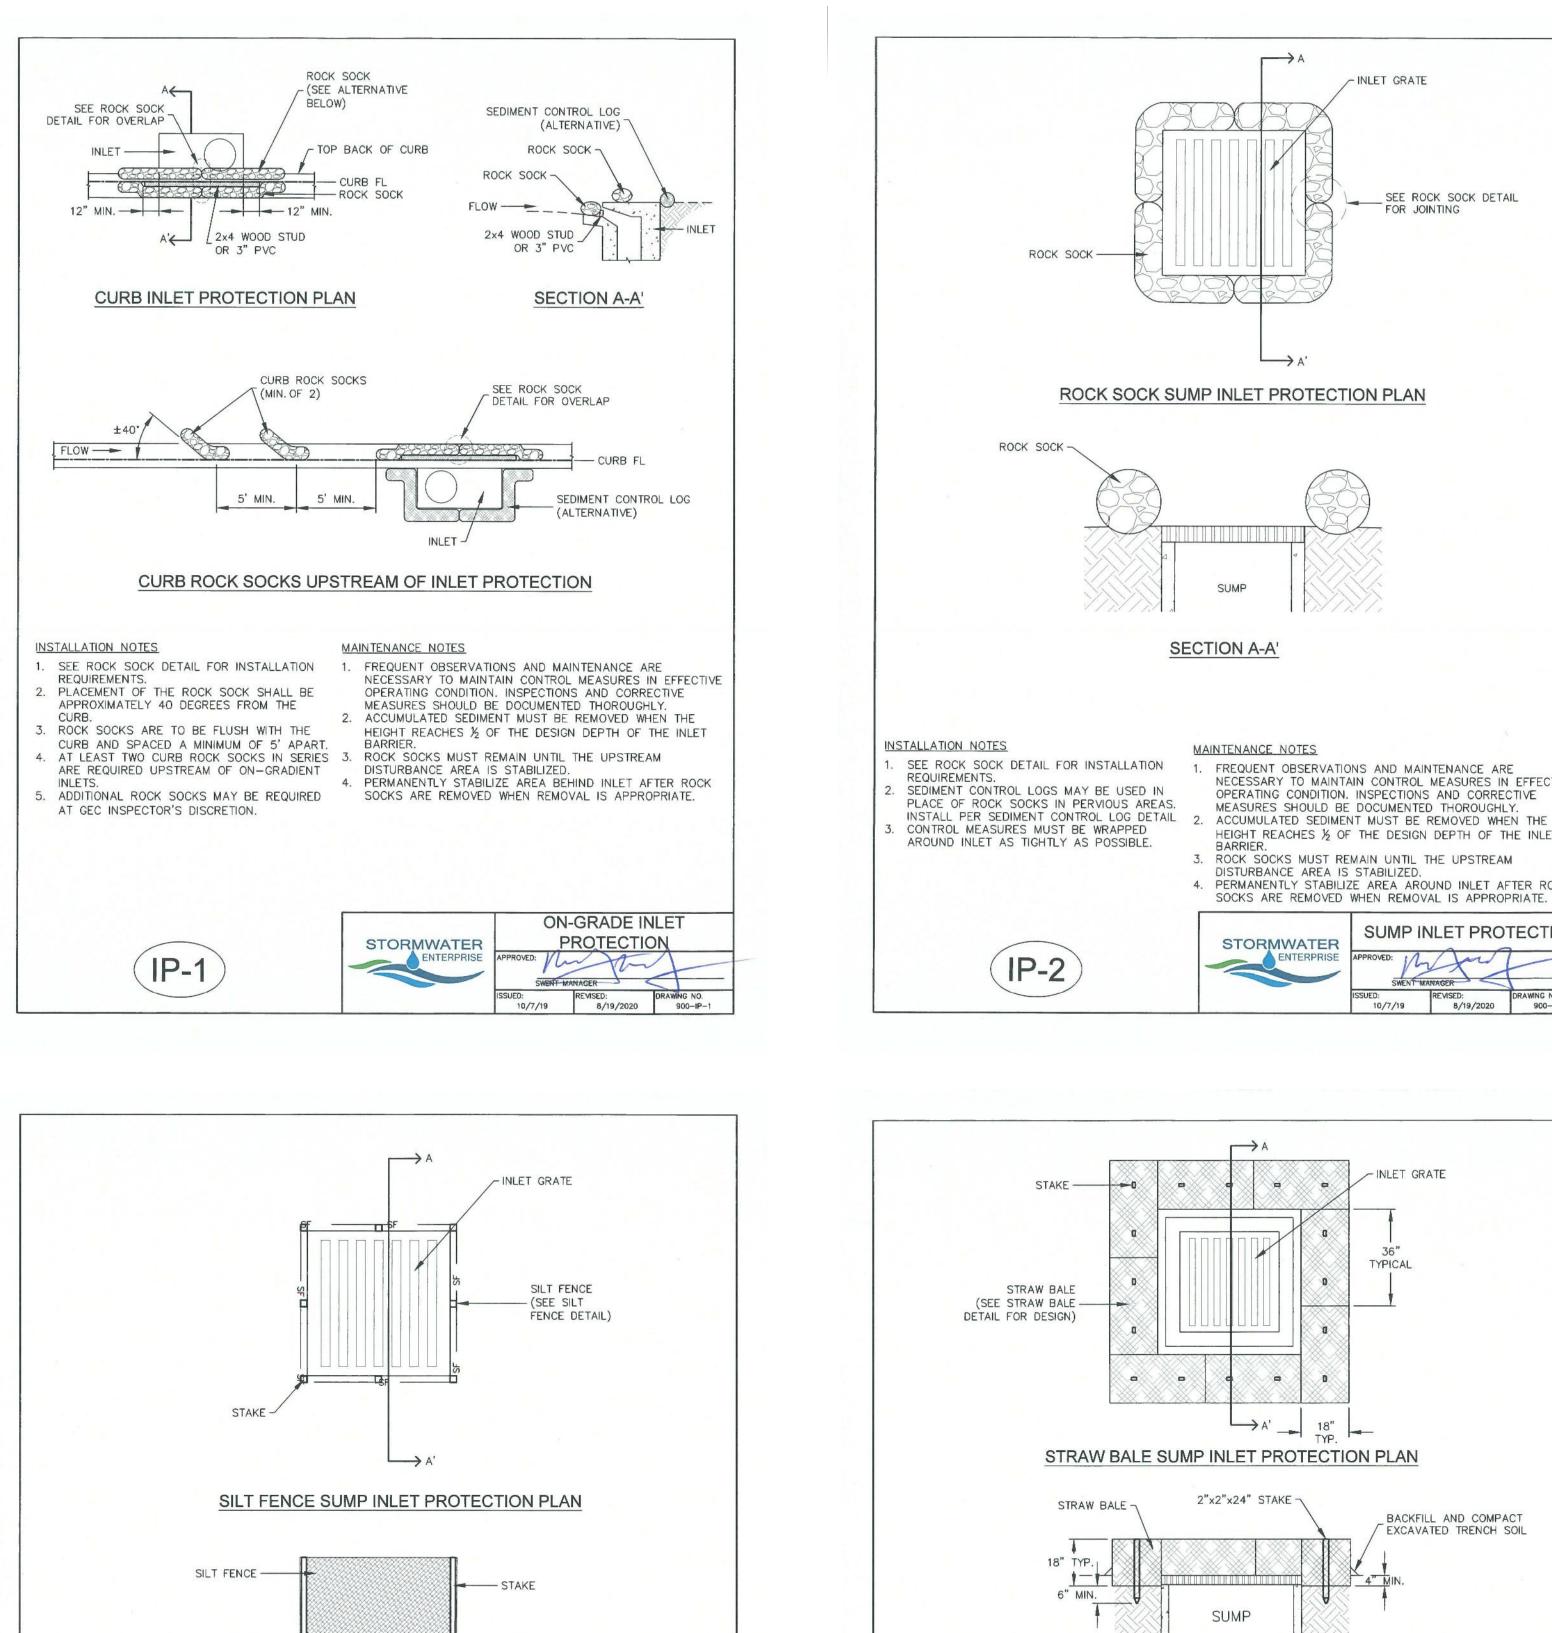

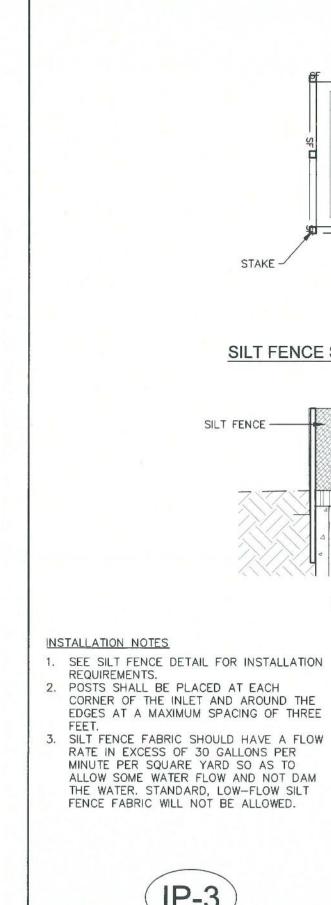



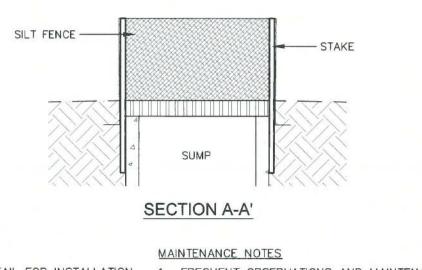

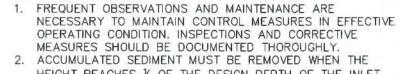

- HEIGHT REACHES 1/2 OF THE DESIGN DEPTH OF THE INLET BARRIFR
- 3. SILT FENCE MUST REMAIN UNTIL THE UPSTREAM DISTURBANCE AREA IS STABILIZED.
- PERMANENTLY STABILIZE AREA AROUND INLET AFTER SILT FENCE IS REMOVED WHEN REMOVAL IS APPROPRIATE.



SECTION A-A'

MAINTENANCE NOTES

THOROUGHLY.

APPROPRIATE.

BARRIEF

INSTALLATION NOTES . BALES SHALL BE PLACED IN A SINGLE ROW AROUND THE INLET WITH THE ENDS OF THE BALES TIGHTLY ABUTTING ONE ANOTHER. STRAW BALES SHALL CONSIST OF CERTIFIED WEED FREE STRAW OR HAY. LOCAL JURISDICTIONS MAY REQUIRE PROOF THAT BALES ARE WEED FREE. 3. STRAW BALES SHALL CONSIST OF APPROXIMATELY 5 CUBIC FEET OF STRAW OR 3. STRAW BALES MUST REMAIN UNTIL THE UPSTREAM HAY AND WEIGH NOT LESS THAN 35 POUNDS.

- 4. STRAW BALE DIMENSIONS SHALL BE APPROXIMATELY 36"x18"x18". 5. A UNIFORM ANCHOR TRENCH SHALL BE
- EXCAVATED TO A DEPTH OF 4". STRAW BALES 5. STRAW BALES SHALL BE REPLACED IF THEY BECOME SHALL BE PACED SO THAT THE BINDING TWINE IS ENCOMPASSING THE VERTICAL SIDES OF THE BALE(S) 5. TWO (2) WOODEN STAKES SHALL BE USED TO
- HOLD EACH BALE IN PLACE. WOODEN STAKED SHALL BE 2"x2"x24 (MIN.)". WOODEN STAKES SHALL BE DRIVEN A MINIMUM OF 6" INTO THE GROUND.

STORMWATER **ENTERPRIS** IP-4

SUMPI	NLET PRO	TECTION
PPROVED:	An	~
//	when	
SWENT	MANAGER	
SUED:	REVISED:	DRAWING NO.
10/7/19	8/19/2020	900-IP-4

DISTURBANCE AREA IS STABILIZED. PERMANENTLY STABILIZE AREA AROUND INLET AFTER STRAW BALES ARE REMOVED WHEN REMOVAL IS HEAVILY SOILED, ROTTEN OR DAMAGED BEYOND REPAIR.

CORRECTIVE MEASURES SHOULD BE DOCUMENTED ACCUMULATED SEDIMENT MUST BE REMOVED WHEN THE HEIGHT REACHES 1/2 OF THE DESIGN DEPTH OF THE INLET

EFFECTIVE OPERATING CONDITION. INSPECTIONS AND

FREQUENT OBSERVATIONS AND MAINTENANCE ARE NECESSARY TO MAINTAIN CONTROL MEASURES IN

BACKFILL AND COMPACT EXCAVATED TRENCH SOIL

TYPICAL

SWENT MANAGER REVISED: 10/7/19 8/19/2020 900-IP-2

NECESSARY TO MAINTAIN CONTROL MEASURES IN EFFECTIVE OPERATING CONDITION. INSPECTIONS AND CORRECTIVE MEASURES SHOULD BE DOCUMENTED THOROUGHLY. HEIGHT REACHES 1/2 OF THE DESIGN DEPTH OF THE INLET 4. PERMANENTLY STABILIZE AREA AROUND INLET AFTER ROCK SOCKS ARE REMOVED WHEN REMOVAL IS APPROPRIATE. SUMP INLET PROTECTION

SEE ROCK SOCK DETAIL FOR JOINTING

DESIGN ASSOCIATES

Civil Engineers | Landscape Architects 2009 W. Littleton Blvd. #300 Littleton, CO 80120 303.794.4727 | www.SterlingDesignAssociates.com

JAY M. NEWELL. PE COLORADO REGISTRATION 35219

FOR & ON BEHALF OF STERLING DESIGN ASSOCIATES, LLC

PREPARED UNDER THE DIRECT SUPERVISION OF

SCALE:

N/A

SPACE VILLAGE FILING NO. 4

COMMERCIAL BUILDING SERVICES

EROSION CONTROL DETAILS

C815

7561 S. GRANT STR., SUITE A-4

LITTLETON, COLORADO 80122

TEL: (303) 730-3001

(SWMP-SITE MAP)

EL PASO COUNTY, CO

PROJECT NO.

DRAWING FILE:

BY:

BY: -

BY: -

BY: -

BY: -

BY: -

STERLING DESIGN ASSOCIATES, LLC

ISSUES & REVISIONS NO.: 1 DATE:

DESCRIPTION:

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DATE:

JS

JN

6/2023

DRAWN BY

PROJECT:

CLIENT:

SHEET TITLE:

SHEET NUMBER:

NO.: 4 DATE:

NO.: 5 DATE:

NO.: 6 DATE:

PROJECT MANAGER

NO.: 2 DATE:

NO.: 3 DATE:

