any on-site or off-site waters, including wetlands. Notwithstanding anything depicted in these plans in words or graphic representation, all design and construction related to roads, storm drainage and erosion control shall conform to the standards and requirements of the most recent version of the relevant adopted El Paso County standards, including the Land Development Code, the Engineering Criteria Manual, the Drainage Criteria Manual, and the Drainage Criteria Manual Volume 2. Any

deviations from regulations and standards must be requested, and approved, in writing. A separate Stormwater Management Plan (SMWP) for this project shall be completed and an Erosion and Stormwater Quality Control Permit (ESQCP) issued prior to commencing construction. Management of the SWMP during construction is the responsibility of the designated Qualified Stormwater Manager or Certified Erosion Control Inspector. The SWMP shall be located on site at all times during construction and shall be kept up to date

Once the ESQCP is approved and a "Notice to Proceed" has been issued, the contractor may install the initial stage erosion and sediment control measures as indicated on the approved GEC. A Preconstruction Meeting between the contractor, engineer, and El Paso County will be held prior to any construction. It is the responsibility

of the applicant to coordinate the meeting time and place with County staff. Control measures must be installed prior to commencement of activities that could contribute pollutants to stormwater. Control measures for all slopes, channels, ditches, and disturbed land areas shall be installed immediately upon completion of the disturbance.

All temporary sediment and erosion control measures shall be maintained and remain in effective operating condition until permanent soil erosion control measures are implemented and final stabilization is established. All persons engaged in land disturbance activities shall assess the adequacy of control measures at the site and identify if changes to those control measures are needed to ensure the continued effective performance of the control measures. All changes to temporary sediment and erosion control measures must be incorporated into the

Temporary stabilization shall be implemented on disturbed areas and stockpiles where ground disturbing

construction activity has permanently ceased or temporarily ceased for longer than 14 days. Final stabilization must be implemented at all applicable construction sites. Final stabilization is achieved when all ground disturbing activities are complete and all disturbed areas either have a uniform vegetative cover with individual plant density of 70 percent of pre-disturbance levels established or equivalent permanent alternative stabilization method is implemented. All temporary sediment and erosion control measures shall be removed upon final stabilization and before permit closure.

All permanent stormwater management facilities shall be installed as designed in the approved plans. Any proposed changes that affect the design or function of permanent stormwater management structures must be approved by the ECM Administrator prior to implementation.

Earth disturbances shall be conducted in such a manner so as to effectively minimize accelerated soil erosion and resulting sedimentation. All disturbances shall be designed, constructed, and completed so that the exposed area of any disturbed land shall be limited to the shortest practical period of time. Pre-existing vegetation shall be protected and maintained within 50 horizontal feet of a waters of the state unless shown to be infeasible and specifically requested and approved.

Compaction of soil must be prevented in areas designated for infiltration control measures or where final stabilization will be achieved by vegetative cover. Areas designated for infiltration control measures shall also be protected from sedimentation during construction until final stabilization is achieved. If compaction prevention is not feasible due to site constraints, all areas designated for infiltration and vegetation control measures must be loosened prior to installation of the control measure(s).

Any temporary or permanent facility designed and constructed for the conveyance of stormwater around, through, or from the earth disturbance area shall be a stabilized conveyance designed to minimize erosion and the

Concrete wash water shall be contained and disposed of in accordance with the SWMP. No wash water shall be discharged to or allowed to enter State Waters, including any surface or subsurface storm drainage system or facilities. Concrete washouts shall not be located in an area where shallow groundwater may be present, or within 50 feet of a surface water body, creek or stream.

During dewatering operations of uncontaminated ground water may be discharged on site, but shall not leave the site in the form of surface runoff unless an approved State dewatering permit is in place. Erosion control blanketing or other protective covering shall be used on slopes steeper than 3:1.

16. Contractor shall be responsible for the removal of all wastes from the construction site for disposal in accordance with local and State regulatory requirements. No construction debris, tree slash, building material wastes or unused building materials shall be buried, dumped, or discharged at the site.

Waste materials shall not be temporarily placed or stored in the street, alley, or other public way, unless in accordance with an approved Traffic Control Plan. Control measures may be required by El Paso County

Engineering if deemed necessary, based on specific conditions and circumstances. 18. Tracking of soils and construction debris off-site shall be minimized. Materials tracked off-site shall be cleaned up and properly disposed of immediately.

The owner/developer shall be responsible for the removal of all construction debris, dirt, trash, rock, sediment, soil, and sand that may accumulate in roads, storm drains and other drainage conveyance systems and stormwater appurtenances as a result of site development.

The quantity of materials stored on the project site shall be limited, as much as practical, to that quantity required to perform the work in an orderly sequence. All materials stored on-site shall be stored in a neat, orderly manner, in their original containers, with original manufacturer's labels.

No chemical(s) having the potential to be released in stormwater are to be stored or used onsite unless permission for the use of such chemical(s) is granted in writing by the ECM Administrator. In granting approval for the use of such chemical(s), special conditions and monitoring may be required.

22. Bulk storage of allowed petroleum products or other allowed liquid chemicals in excess of 55 gallons shall require adequate secondary containment protection to contain all spills onsite and to prevent any spilled materials from entering State Waters, any surface or subsurface storm drainage system or other facilities.

23. No person shall cause the impediment of stormwater flow in the curb and gutter or ditch except with approved sediment control measures.

24. Owner/developer and their agents shall comply with the "Colorado Water Quality Control Act" (Title 25, Article 8, CRS), and the "Clean Water Act" (33 USC 1344), in addition to the requirements of the Land Development Code, DCM Volume II and the ECM Appendix I. All appropriate permits must be obtained by the contractor prior to construction (1041, NPDES, Floodplain, 404, fugitive dust, etc.). In the event of conflicts between these requirements and other laws, rules, or regulations of other Federal, State, local, or County agencies, the most restrictive laws, rules, or regulations shall apply.

25. All construction traffic must enter/exit the site only at approved construction access points. 26. Prior to construction the permittee shall verify the location of existing utilities.

27. A water source shall be available on site during earthwork operations and shall be utilized as required to minimize dust from earthwork equipment and wind.

Colorado Department of Public Health and Environment, Water Quality Division. The application contains

28. The soils report for this site has been prepared by RMG Engineers/Architects, Inc (Dated: March 11, 2024) and shall be considered a part of these plans. At least ten (10) days prior to the anticipated start of construction, for projects that will disturb one (1) acre or more, the owner or operator of construction activity shall submit a permit application for stormwater discharge to the

certification of completion of a stormwater management plan (SWMP), of which this Grading and Erosion Control Plan may be a part. For information or application materials contact: Colorado Department of Public Health and Environment

Water Quality Control Division WQCD - Permits

4300 Cherry Creek Drive South Denver, CO 80246-1530

SIDEOATS GRAMA

LITTLE BLUESTEM

SAND DROPSEED

WEEPING LOVE GRASS

SWITCH GRASS

30. Base mapping was provided by Land Development Consultants. The date of the last survey update was July 27, 2021.

31. Proposed Construction Schedule: Begin Construction: Summer 2024 End Construction: Winter 2024

Total Site Area = 3.25 Acres 32. Area to be disturbed = 3.26 Acres. Existing 100-year runoff coefficient = 0.37 Proposed 100-year runoff coefficient = 0.70

Existing Hydrologic Soil Groups: A

(A--Truckton sandy loam) 33. Site is currently undeveloped and covered with native grasses on moderate to steep slopes (2%-25%).


34. Site is located in the West Fork Jimmy Camp Creek Drainage Basin. 35. No Asphalt Batch Plants will be utilized at the site.

SEED MIX AREAS DISTURBED BY THE EARTHWORK ACTIVITIES AND NOT RECEIVING OTHER TREATMENT SHALL BE PERMANENTLY REVEGETATED WITH THE FOLLOWING SEED MIX. El Reno WESTERN WHEAT GRASS BartonSLENDER WHEAT GRASS PasturaNativeNebraska 28 Morpha

SEEDING APPLICATION: DRILL SEED 1/4" TO 1/2" INTO TOPSOIL. IN AREAS NACCESSIBLE TO A DRILL, HAND BROADCAST AT DOUBLE THE RATE AND RAKE 1/4" TO 1/2" INTO THE TOPSOIL. <u>MULCHING APPLICATION</u>: 1-1/2 TONS NATIVE HAY PER ACRE, MECHANICALLY CRIMPED INTO THE TOPSOIL

NORTHCRESTCENTER

GRADING AND EROSION CONTROL PLANS PREPARED FOR LEISURE CONSTRUCTION

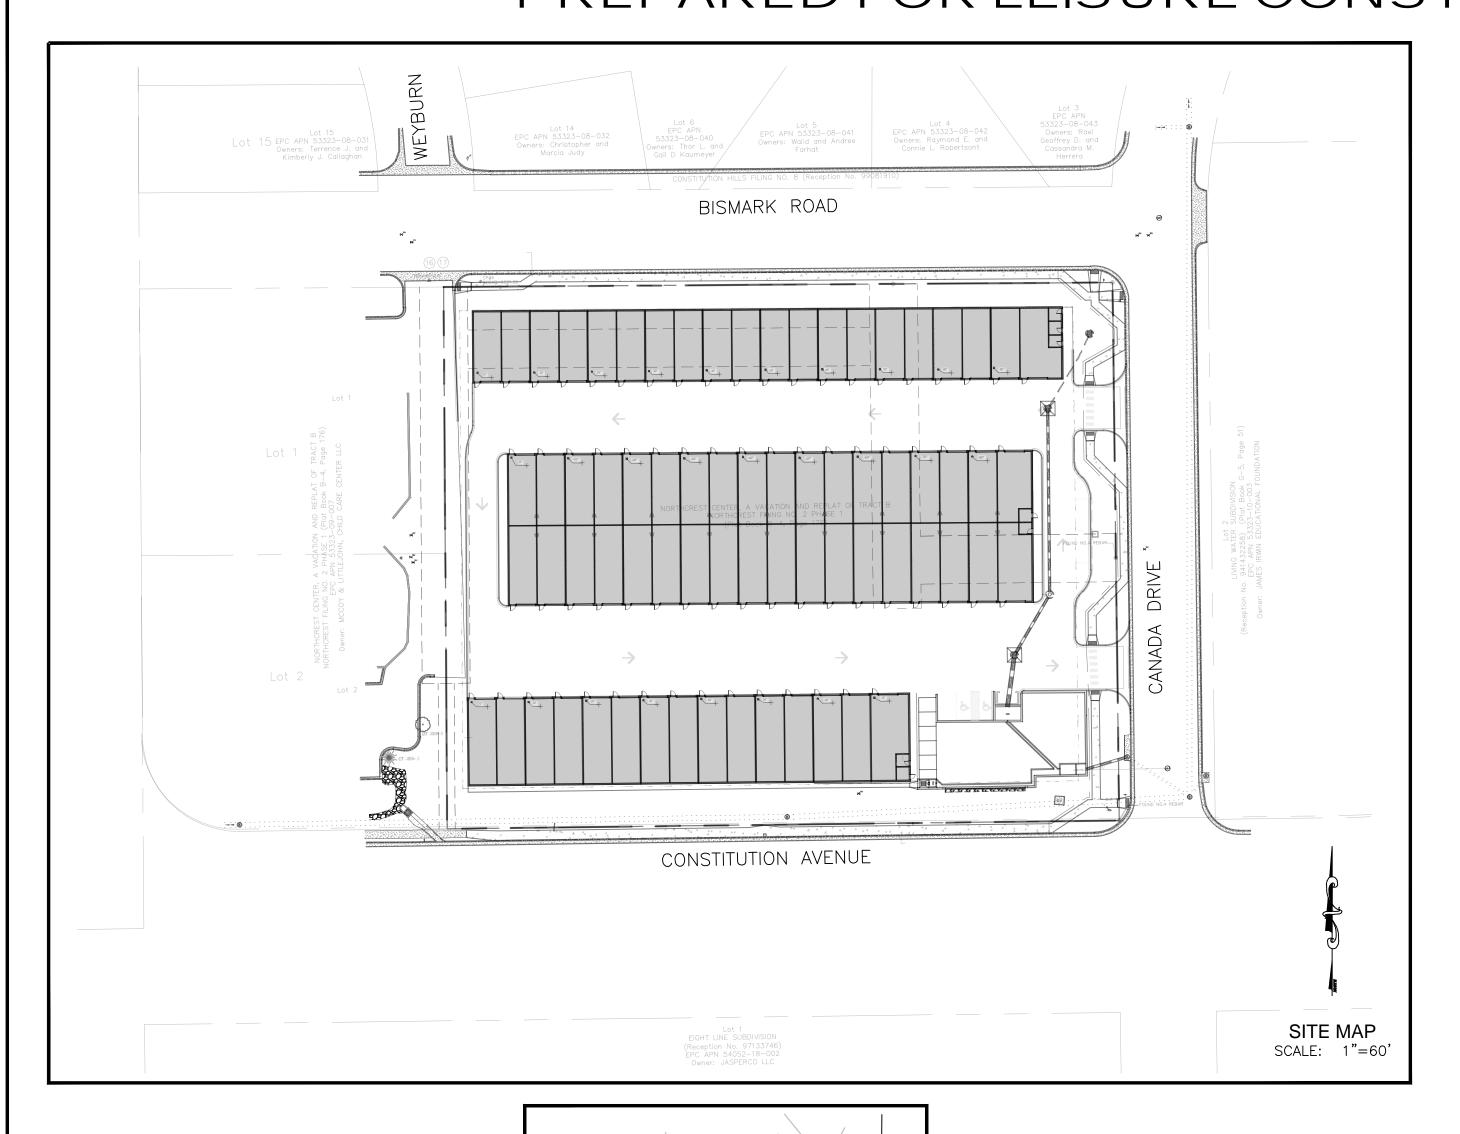

STANDARD NOTES FOR EL PASO COUNTY CONSTRUCTION PLANS

- 1. All drainage and roadway construction shall meet the standards and specifications of the City of Colorado Springs/El Paso County Drainage Criteria Manual, Volumes 1 and 2, and the El Paso County Engineering Criteria Manual.
- 2. Contractor shall be responsible for the notification and field notification of all existing utilities, whether shown on the plans or not, before beginning construction. Location of existing utilities shall be verified by the contractor prior to construction. Call 811 to contact the Utility Notification Center of Colorado (UNCC).
- 3. Contractor shall keep a copy of these approved plans, the Grading and Erosion Control Plan, the Stormwater Management Plan (SWMP), the soils and geotechnical report, and the appropriate design and construction standards and specifications at the job site at all times, including the following: a. El Paso County Engineering Criteria Manual (ECM)

b. City of Colorado Springs/El Paso County Drainage Criteria Manual, Volumes 1 and 2 c. Colorado Department of Transportation (CDOT) Standard Specifications for Road and Bridge Construction

4. Notwithstanding anything depicted in these plans in words or graphic representation, all design and construction related to roads, storm drainage and erosion control shall conform to the standards and requirements of the most recent version of the relevant adopted El Paso County standards, including the Land Development Code, the Engineering Criteria Manual, the Drainage Criteria Manual, and the Drainage Criteria Manual Volume 2. Any deviations from regulations and standards must be requested, and approved, in writing. Any modifications necessary to meet criteria after-the-fact will be entirely the developer's responsibility to rectify.

5. It is the design engineer's responsibility to accurately show existing conditions, both onsite and offsite, on the construction plans. Any modifications necessary due to conflicts, omissions, or changed conditions will be entirely the developer's responsibility to rectify.

6. Contractor shall schedule a pre-construction meeting with El Paso County Planning and Community Development (PCD) -Inspections, prior to starting construction.

7. It is the contractor's responsibility to understand the requirements of all jurisdictional agencies and to obtain all required permits, including but not limited to El Paso County Erosion and Stormwater Quality Control Permit (ESQCP), Regional Building Floodplain Development Permit, U.S. Army Corps of Engineers-issued 401 and/or 404 permits, and county and state fugitive dust permits.

8. Contractor shall not deviate from the plans without first obtaining written approval from the design engineer and PCD. Contractor shall notify the design engineer immediately upon discovery of any errors or inconsistencies.

9. All public storm drain pipe shall be Class III RCP unless otherwise noted and approved by PCD.

10. Contractor shall coordinate geotechnical testing per ECM standards. Pavement design shall be approved by El Paso County PCD prior to placement of curb and gutter and pavement.

11. All construction traffic must enter/exit the site at approved construction access points.

12. Signing and striping shall comply with El Paso County DOT and MUTCD criteria. [If applicable, additional signing and striping notes will be provided.]

13. Contractor shall obtain any permits required by El Paso County DOT, including Work Within the Right-of-Way and Special

14. The limits of construction shall remain within the property line unless otherwise noted. The owner/developer shall obtain written permission and easements, where required, from adjoining property owner(s) prior to any off-site disturbance, grading, or construction.

EROSION CONTROL INSPECTION AND MAINTENANCE

A Thorough Inspection of the Erosion Control Plan/Stormwater Management System shall be performed every 14 days as well as after any rain or snowmelt event that causes Surface Erosion: * When Silt Fences have silted up to half their heiaht, the silt shall be removed, final grade re-established and slopes re-seeded, if necessary. Any silt fence that has shifted or decayed shall be repaired or replaced. Any Accumulated Trash or debris shall be removed

from outlets.

An inspection and maintenance log shall be kept.

SCALE: 1"=50'

OPINION OF COST FOR EROSION CONTROL REQUIREMENTS							
TEM	QUANTITY	UNIT	UNIT COST	AMOUNT			
VEHICLE TRACKING CONTROL SILT FENCE STRAW BALES NLET PROTECTION CONCRETE WASH OUT ROCK SOCKS SURFACE ROUGHENING TEMPORARY SEEDING AND MULCH	2 6,320 18 6 2 100 1.0 0.7	EA LF EA EA EA AC AC	\$3,085.00 \$33.00 \$217.00 \$1,172.00 \$24.00 \$269.00 \$1793.00	\$6,170.00 \$18,960.00 \$594.00 \$1,302.00 \$2,344.00 \$2,400.00 \$269.00 \$1,255.00			
MAINTAINANCE (25% OF EROSION CONTROL)) 1	LS	\$8,323.50 TOTAL	\$8,175.00 \$41,023.50			
			•				

INDEX OF SHEETS

COVER SHEET C301 INITIAL CONDITIONS C302 INTERIM CONDITIONS C303 FINAL CONDITIONS C304 GEC DETAILS C305 GEC DETAILS C306 GEC DETAILS

I Paso County (standalone GEC Plan): County plan review is provided only for general conformance with County Design Criteria. The County is not responsible for the accuracy and adequacy of the design, dimensions, and/or elevations which shall be confirmed at the job site. The County through the approval of this document assumes no responsibility for completeness and/or accuracy of this document. Filed in accordance with the requirements of the El Paso County Land Development Code. Drainage Criteria Manuals Volumes 1 and 2, and Engineering Criteria Manmual, as amended. In accordance with ECM Section 1.12, these construction documents will be valid for construction for a period of 2 years from the date signed by the El Paso County Engineer. If construction has not started within those 2 years, the plans will need to be resubmitted for approval, including payment of review fees at the Planning and Community Development Director's discretion. County Engineer/ECM Administrator JENNIFER IRVINE, P.E.

This grading and erosion control plan was prepared under my direction and supervision and is correct to the best of my knowledge and belief. Said plan has been prepared according to the criteria established by the County for grading and erosion control plans. I accept responsibility for any liability caused by any negligent acts, errors or omissions on my part

Engineer of Record Signature ANDREW W. McCORD P.E. 25057

Erosion Contro IPlan.

LEISURE CONSTRUCTION 3443 TAMPA ROAD, SUITE B PALM HARBOR, FL 34684

l, the owner/developer have read and will comply with the requirements of the Grading and

SILT FENCE

DEVELOPER:

LEISURE CONSTRUCTION 3443 TAMPA ROAD, SUITE B PALM HARBOR, FL 34684 (727) 242-5121

PREPARED BY:



1604 South 21st Street Colorado Springs, Colorado 80904 $(719)^{\circ}630-7342$

*A.G.A./A.P.W.A. STANDARD UTILITY MARKING COLOR CODE NATURAL GAS YELLOW ELECTRIC RED WATER BLUE WASTEWATER GREEN 1-800-922-1987

Kiowa Project No. 23049 April 2, 2024

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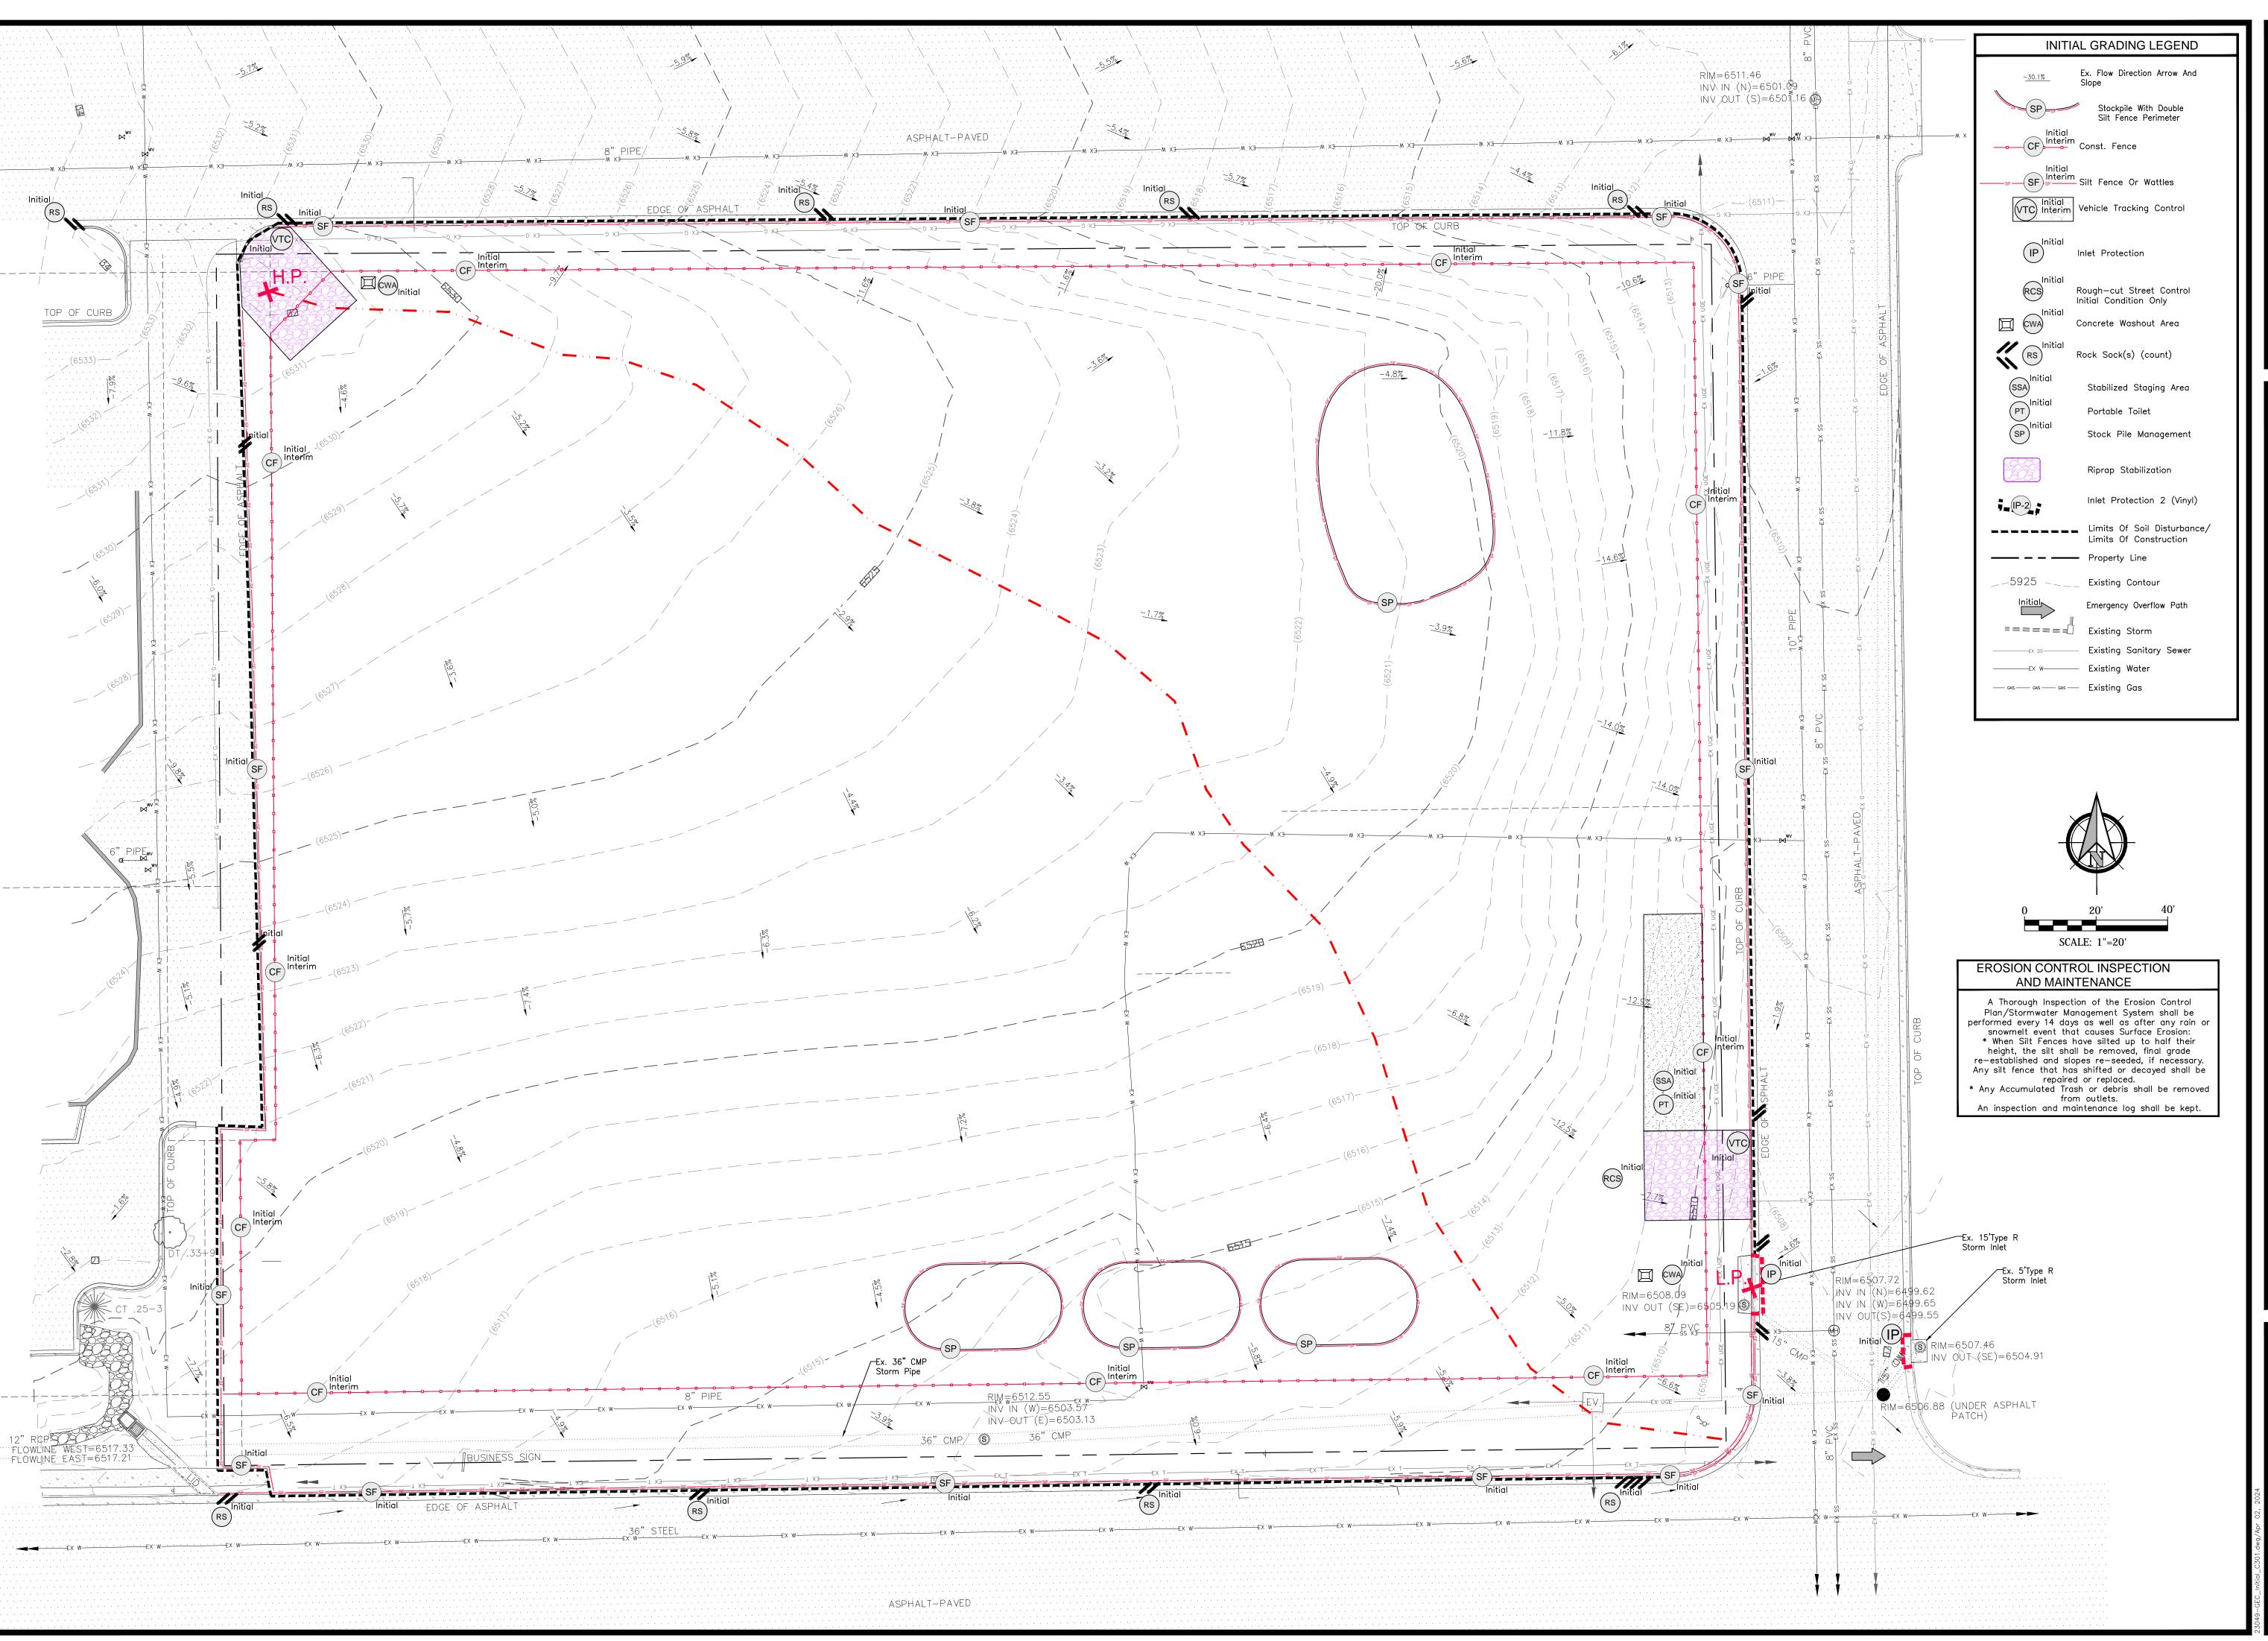
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Project No.: 23049

Drawn: MJK

Check: AMcC

04/02/2024



Northcrest Center
Grading Erosion Control Plan
INITIAL CONDITIONS

Project No.: 23049

Date: 04/02/2024

Design: MJK


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Check: AMcC

Revisions:

2 of 6 Sheet


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Engineering Corporation
1604 South 21st Street
Colorado Springs, Colorado 80904
(719) 630-7342

Northcrest Center
Grading Erosion Control Plan
INTERIM CONDITIONS
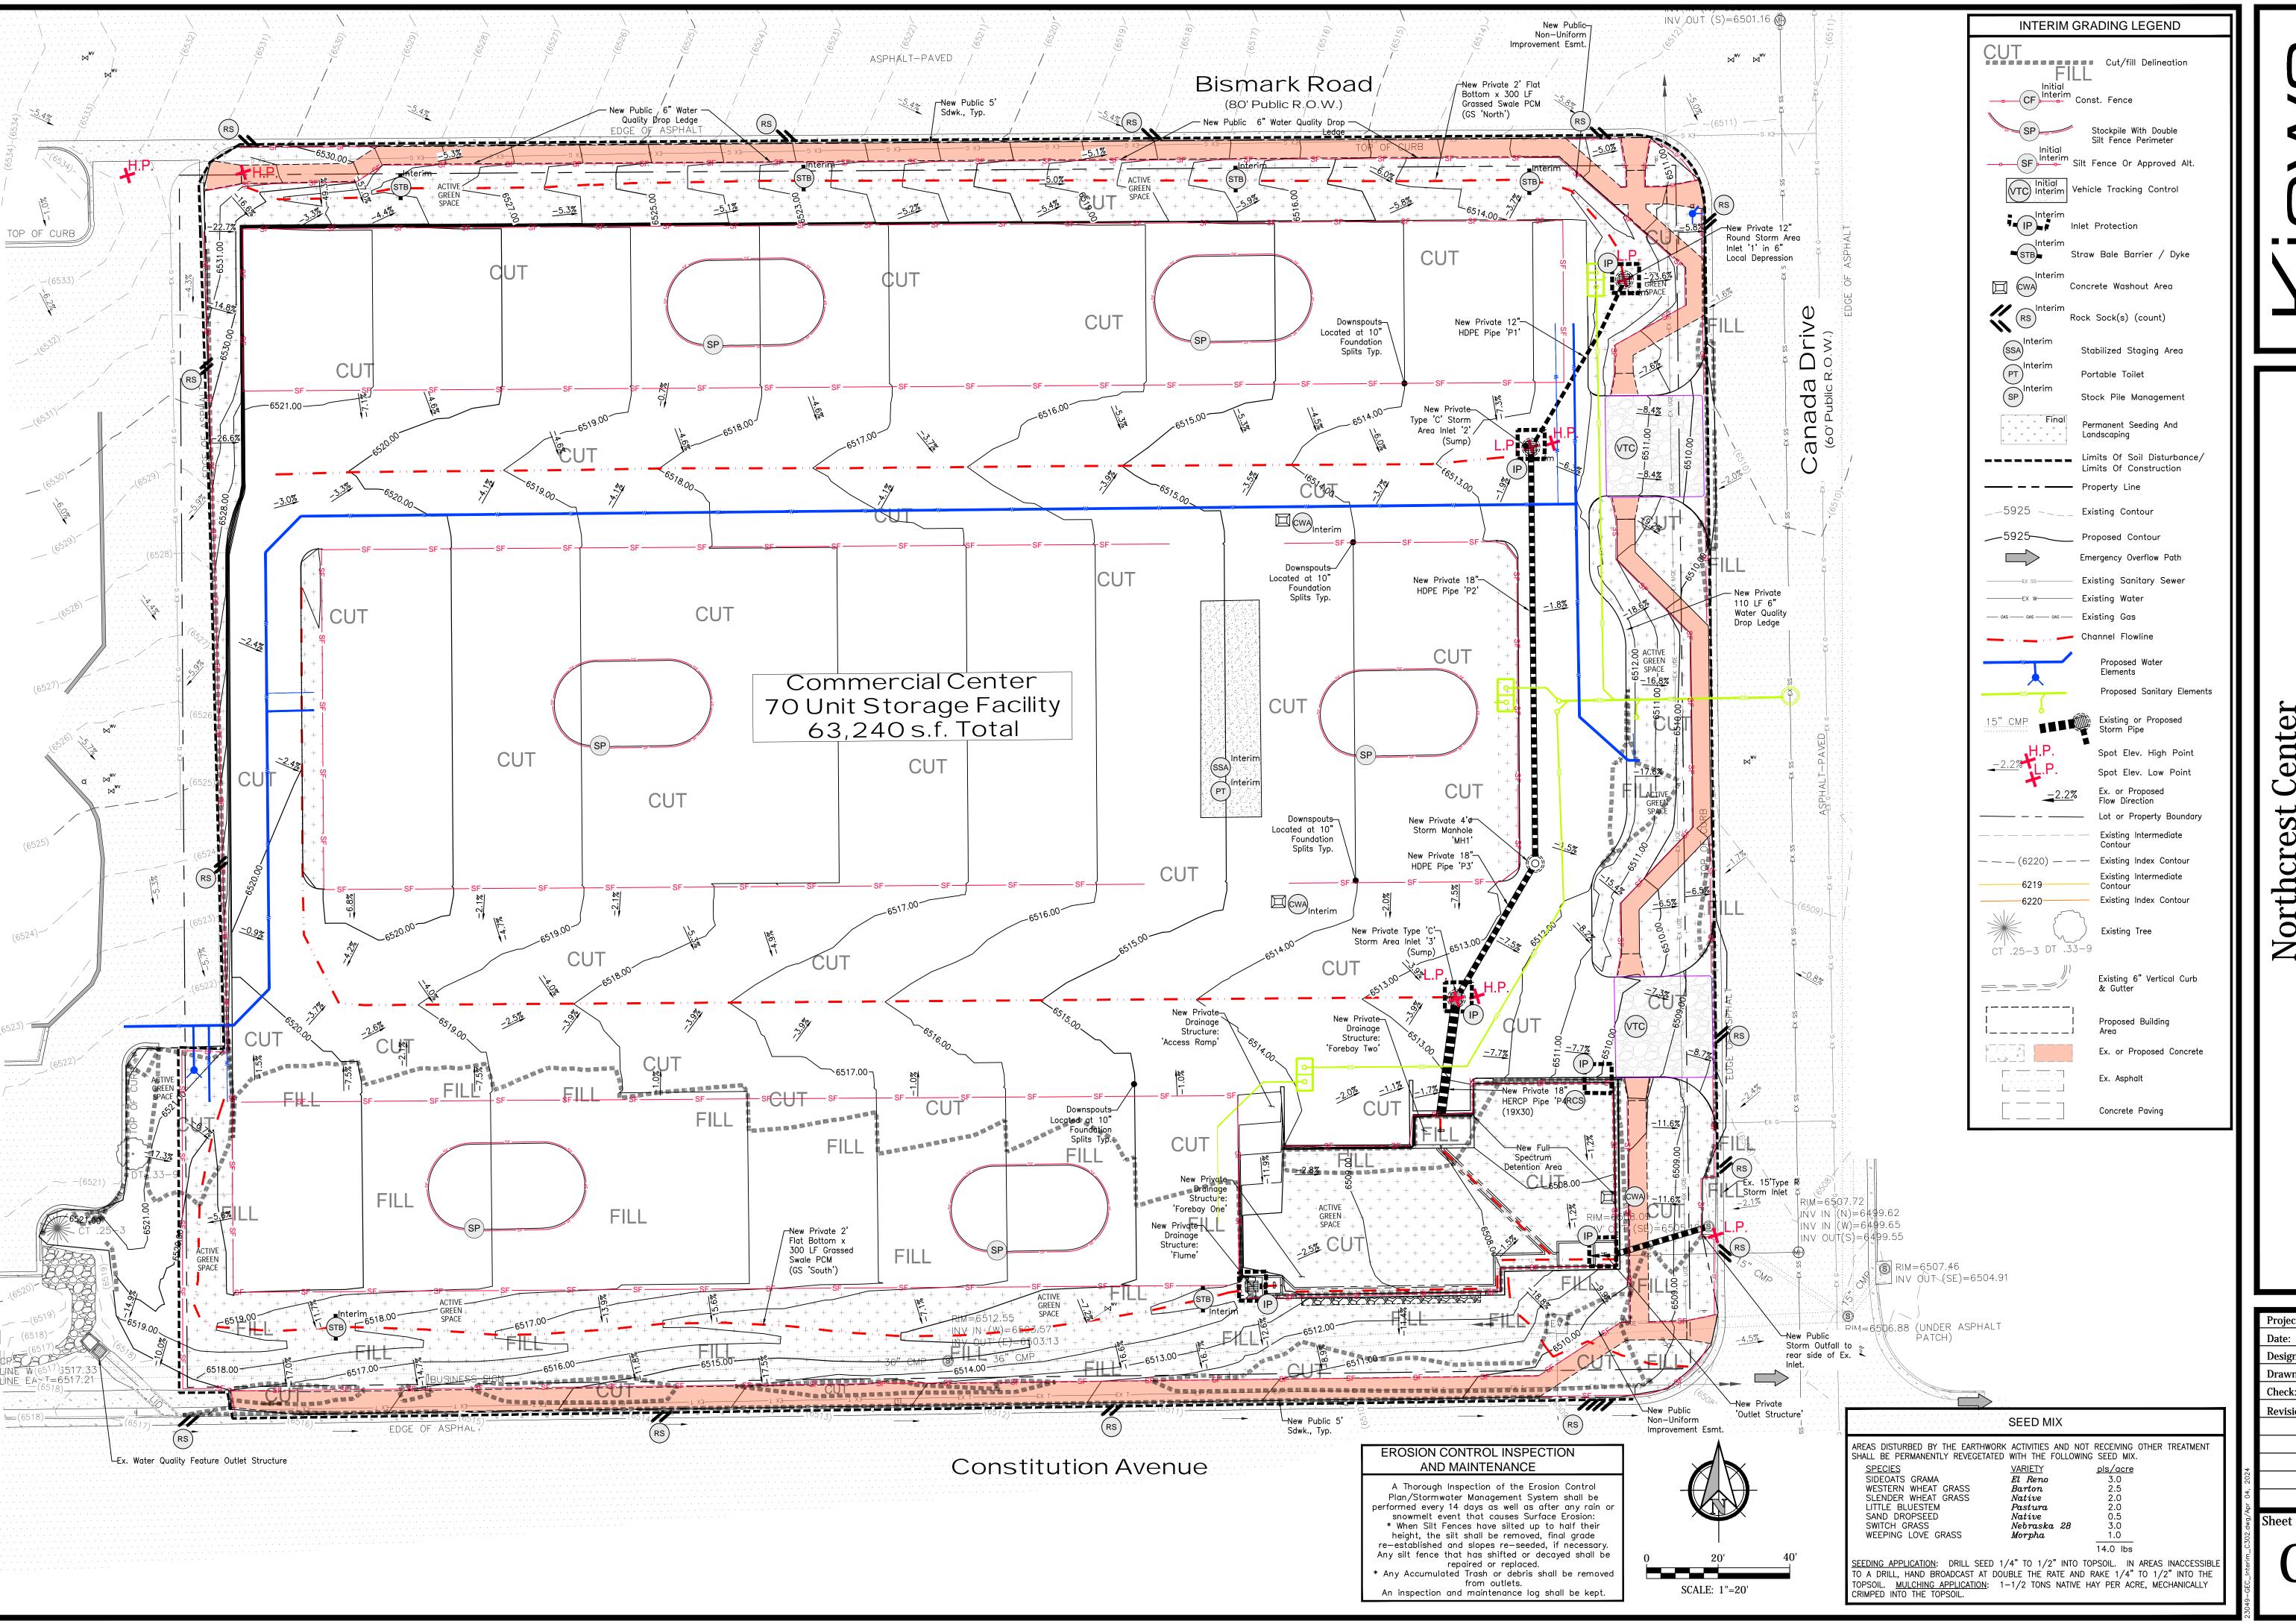
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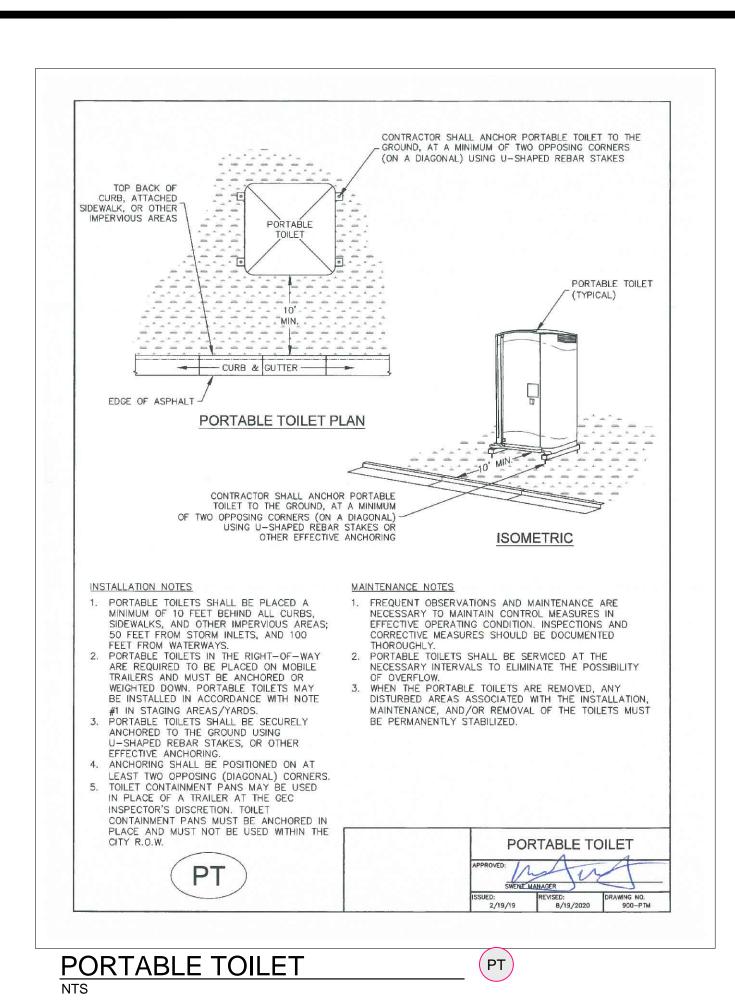





Northcrest Center
Grading Erosion Control Plan
FINAL CONDITIONS

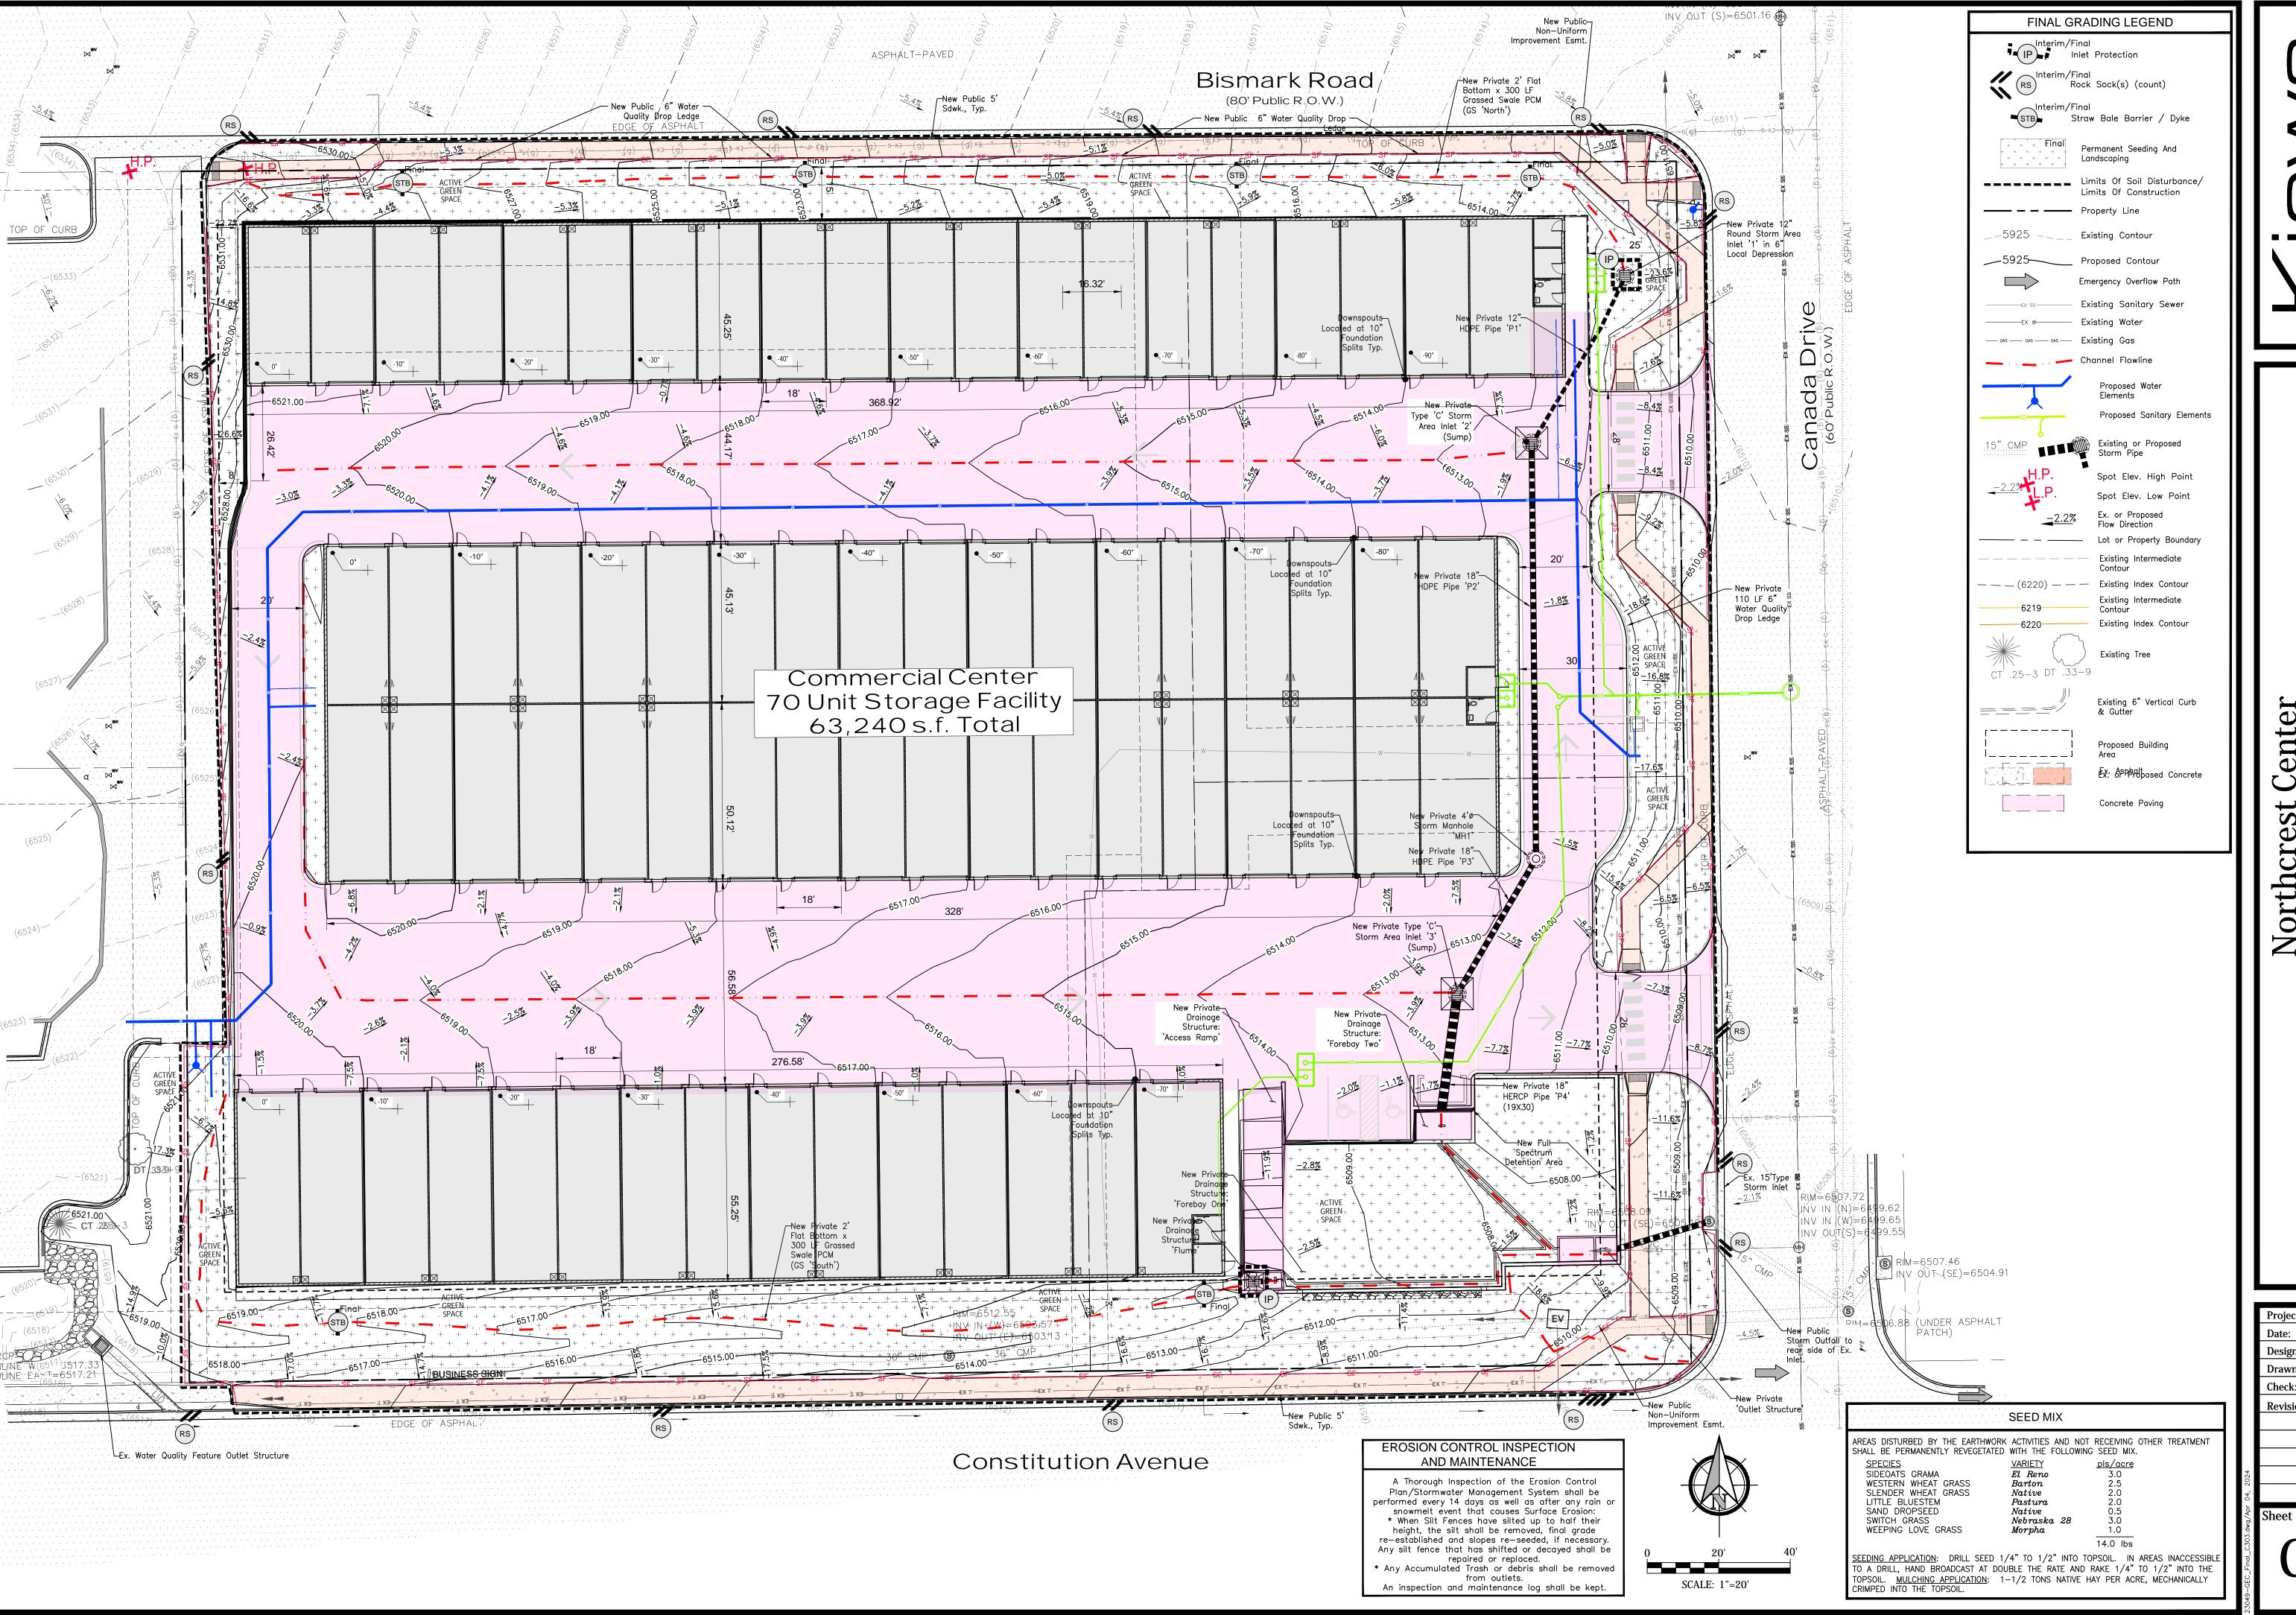
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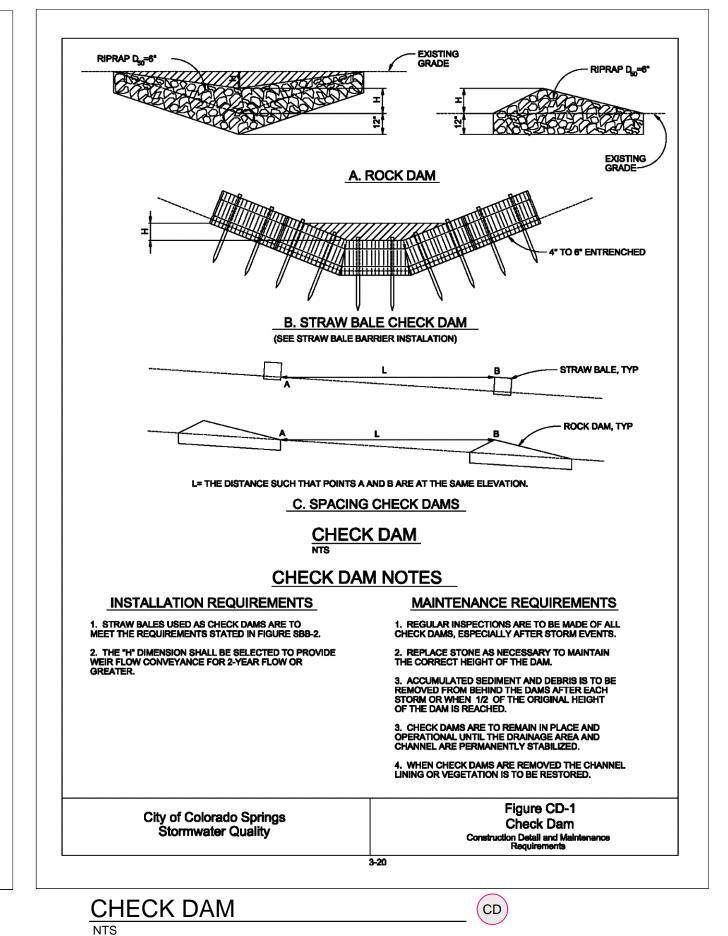
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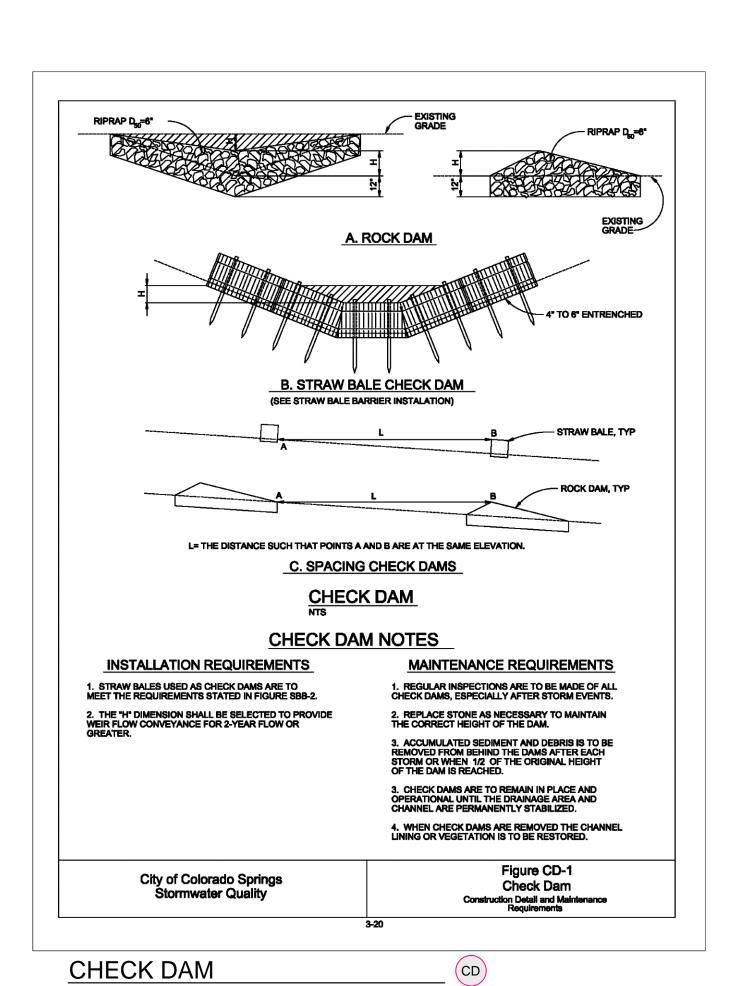






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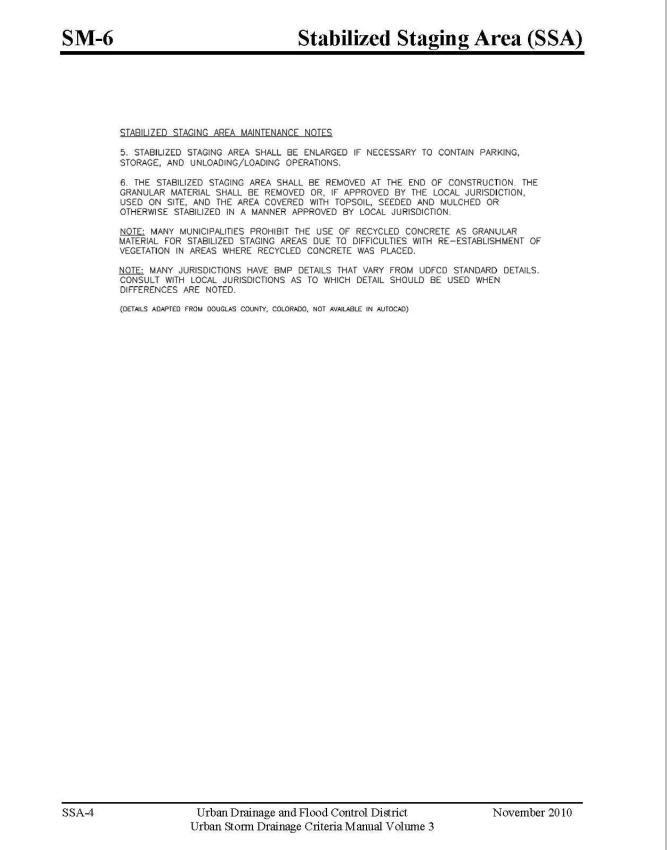


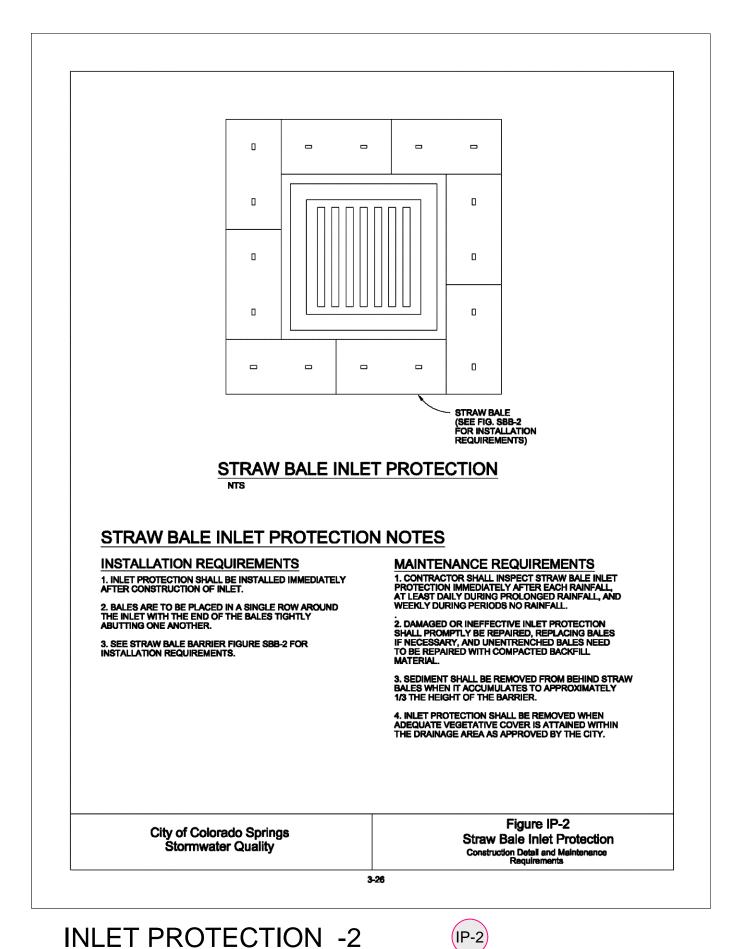




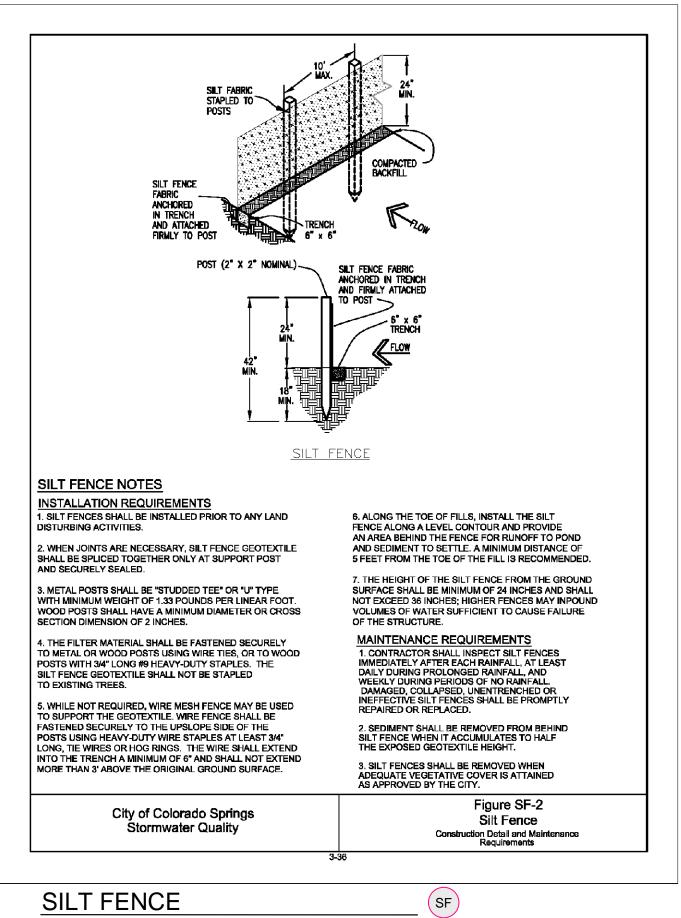

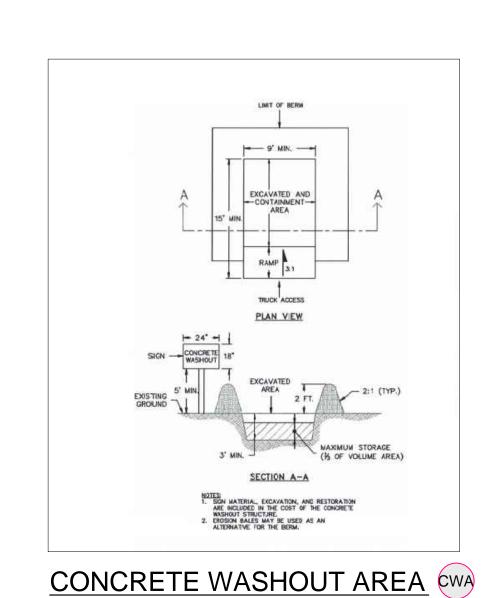Stabilized Staging Area (SSA)

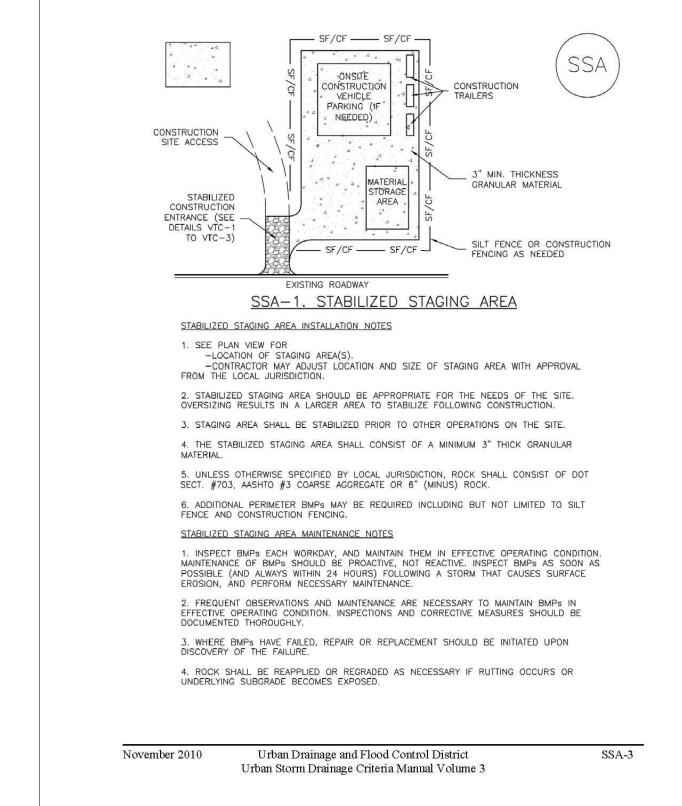

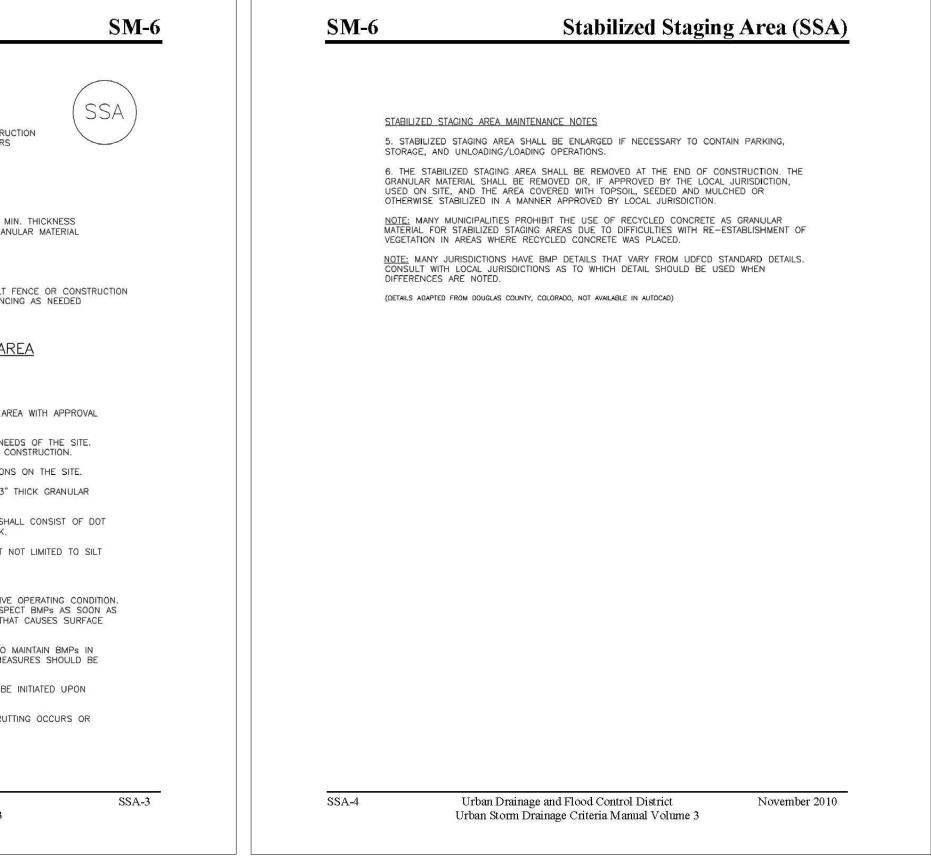

STABILIZED STAGING AREA

23049-GEC_DTLS.dwg/Apr 04, 2024

Project No.: 23049

Date: 04/02/2024

Design: MJK

Drawn: MJK

Check: AMcC

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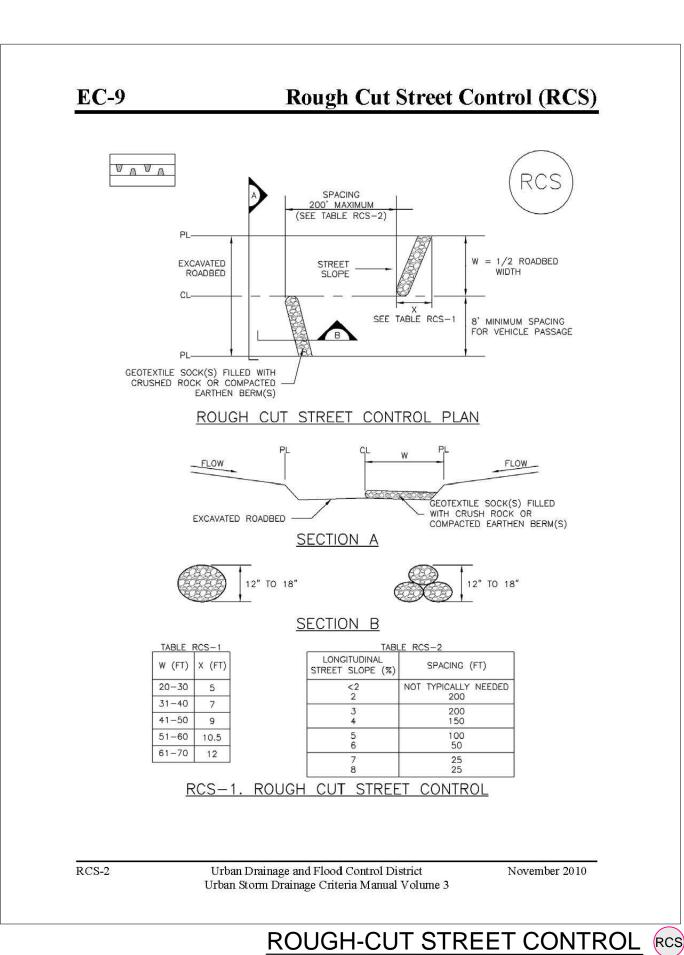
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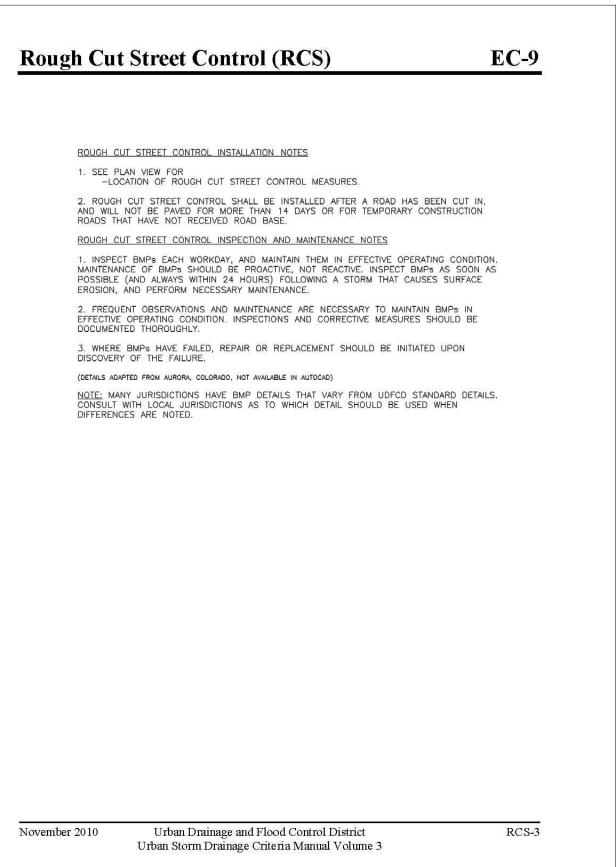
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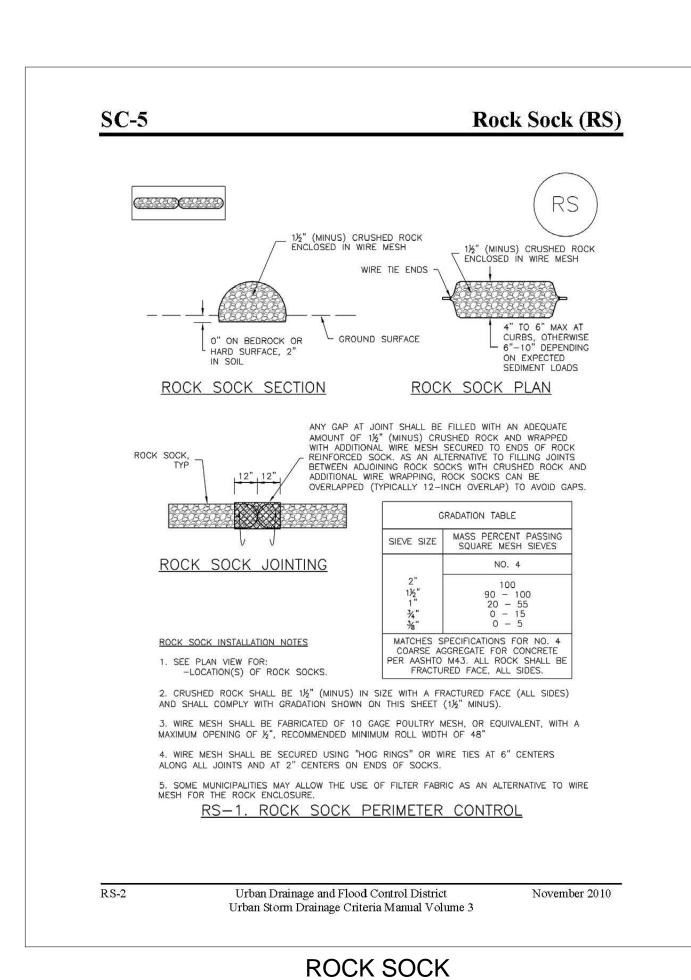
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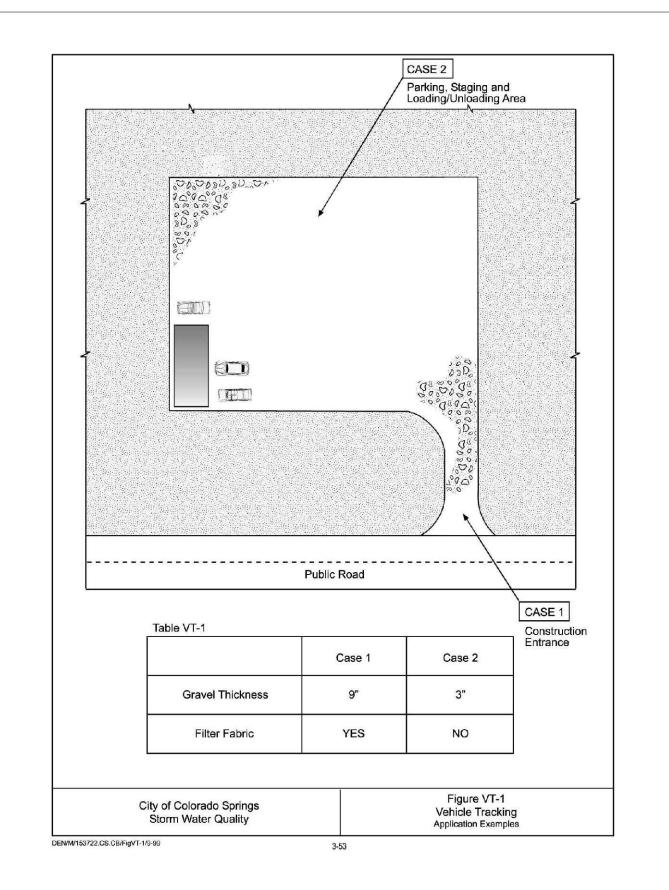
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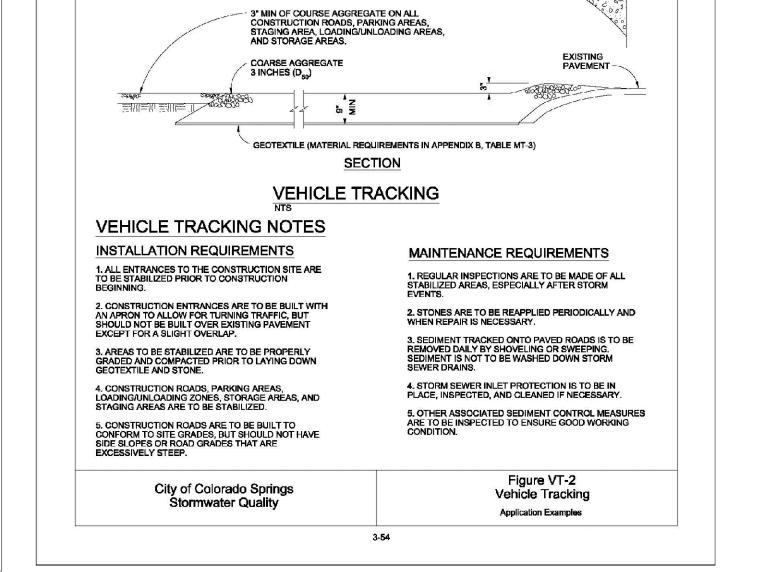












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Project No.: 23049

Date: 04/02/2024

Design: MJK

Drawn: MJK

Check: AMcC

Revisions:

VEHICLE TRACKING CONTROL VTC

6 of 6 Sheets