



PLANTING DETAILS

- NOTES:
- DO NOT REMOVE OR CUT LEADER.
 - PRUNE ONLY DEAD OR BROKEN BRANCHES AND WEAK OR NARROW CROTCHES.
 - DO NOT REMOVE LOWER LIMBS AND SPROUTS FOR AT LEAST TWO GROWING SEASONS.
 - KEEP PLANTS MOIST AND SHADED UNTIL PLANTED.
 - DO NOT FERTILIZE FOR AT LEAST ONE GROWING SEASON.
 - WRAP TRUNK ON EXPOSED SITES OR SPECIES WITH THIN BARK. USE ELECTRICAL TAPE NOT TWINE. WRAP OCTOBER 15 AND REMOVE BY MARCH 31.

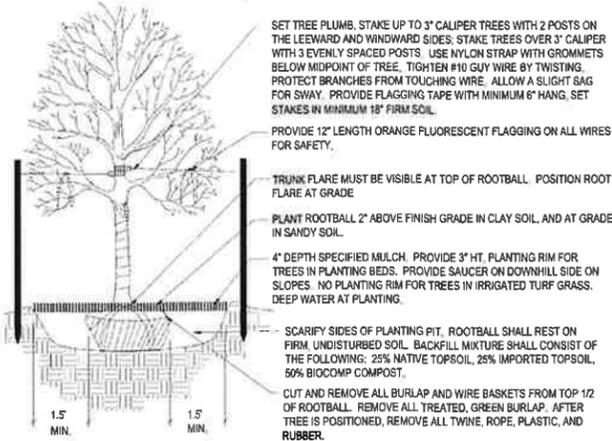


1 Deciduous Tree Planting Detail

NOT TO SCALE

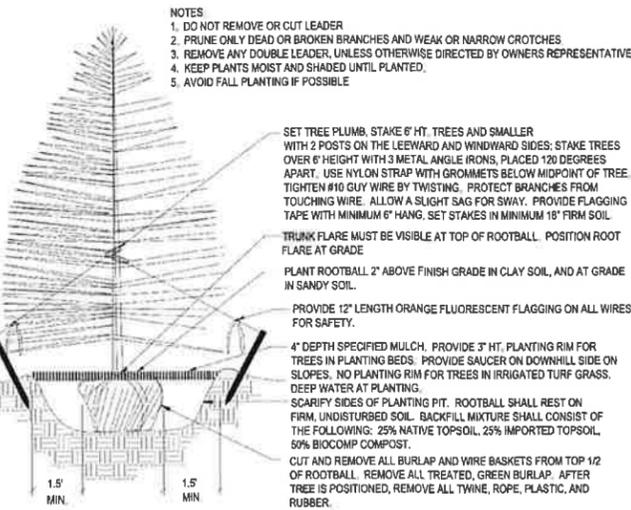


2 Coniferous Tree Planting Detail

NOT TO SCALE

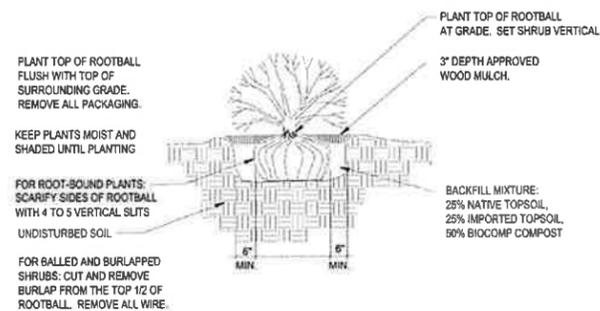

3 Shrub Planting Detail

SCALE: NOT TO SCALE

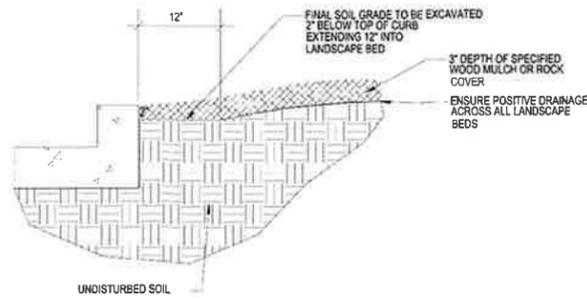

4 Rock Cover / Mulch Bed Excavation

SCALE: NOT TO SCALE

NATIVE SEED ESTABLISHMENT

INITIAL PLANTING
STOCKPILED TOPSOIL SHOULD BE SPREAD EVENLY OVER ALL AREAS TO RECEIVE NATIVE SEED. SEED BED IS TO BE WEED-FREE. SPECIFIED SOIL AMENDMENTS SHOULD BE SPREAD AND INCORPORATED INTO TOP 6" OF SOIL. SEED BED IS TO BE RAKED SMOOTH AND FREE OF DEBRIS LARGER THAN 1" IN DIAMETER. ANY AREAS THAT THE CONTRACTOR BELIEVES TO BE SUSCEPTIBLE TO EROSION ARE TO BE BROUGHT TO THE ATTENTION OF THE OWNER AND/OR GENERAL CONTRACTOR PRIOR TO SEEDING. THE SPECIFIED SEED MIX IS TO BE APPLIED BY HYDRO-MULCH SEEDING AT THE RATE SPECIFIED. SEED IS TO BE APPLIED BETWEEN APRIL 15 AND SEPTEMBER 15. SEED SHALL NOT BE SOWN IF GROUND IS IN A FROZEN STATE. SPECIFIED EROSION CONTROL BLANKET IS TO BE INSTALLED IMMEDIATELY AFTER SEEDING. BLANKET SHALL BE LAID AND SECURED WITH 6" METAL STAPLES AS PER MANUFACTURER'S INSTRUCTIONS. CONTRACTOR IS TO PROVIDE INCIDENTAL WATERING OF ALL SEEDING AREAS THREE TIMES A WEEK DURING GROWING SEASON FOR A MINIMUM OF 8 WEEKS, OR UNTIL ESTABLISHED AND MEETING COVERAGE REQUIREMENTS. MOWING MAY BE NECESSARY DURING THE FIRST GROWING SEASON TO KEEP INVASIVE WEEDS FROM SETTING SEEDS. CONTRACTOR IS RESPONSIBLE FOR KEEPING BROADLEAF WEEDS UNDER CONTROL FOR 12 MONTHS AFTER INITIAL SEEDING AND IS ALSO RESPONSIBLE FOR OVER SEEDING BARE AREAS UNTIL SPECIFIED NATIVE GRASSES COVER ALL AREAS AND AREAS WITHOUT SPECIFIED NATIVE GRASS DO NOT EXCEED 6" X 6".

OVER SEEDING
SIX WEEKS AFTER THE INITIAL SEEDING DURING THE FIRST GROWING SEASON AND/OR DURING THE SPRING OF THE SECOND GROWING SEASON CONTRACTOR IS TO REPAIR ANY ERODED AREAS AND OVER SEED ALL BARE NATIVE GRASS AREAS. CONTRACTOR IS TO USE SPECIFIED SEED MIX BY BROADCAST AND RAKING INTO TOP 1/4" TO 1/2" OF SOIL. INCIDENTAL WATERING IS TO BE PROVIDED TO ESTABLISH OVER-SEEDING AREAS. BROADLEAF WEEDS ARE TO BE KEPT UNDER CONTROL BY MANUALLY PULLING OR CUTTING WEEDS OR SPRAYING OF BROADLEAF WEED HERBICIDE. HERBICIDE AND APPLICATION SHALL CONFORM TO ALL APPLICABLE LAWS OF THE STATE OF COLORADO AND MANUFACTURER'S INSTRUCTIONS.

PROJECT DATA

PROPERTY SIZE:	52,730 s.f. total
BUILDING AREA:	8,464 s.f.
PAVEMENT AREA:	17,037 s.f.
LANDSCAPE AREA:	27,229 s.f.
TOTAL PARKING SPACES:	8 spaces

GENERAL NOTES

- ALL REFERENCES TO 'CONTRACTOR' REFER TO LANDSCAPE CONTRACTOR, UNLESS OTHERWISE NOTED.
- CONTRACTOR IS RESPONSIBLE FOR GETTING ALL UTILITY LOCATES PRIOR TO STARTING ANY WORK ON SITE AND ALSO HAVING UTILITIES RELOCATED AS NECESSARY FOR THE DURATION OF CONSTRUCTION.
- CONTRACTOR IS RESPONSIBLE FOR INSTALLING ALL LANDSCAPE SHOWN ON THIS PLAN. ANY DEFICIENCIES OR DEVIATIONS FROM THIS PLAN ARE TO BE APPROVED BY OWNER'S REPRESENTATIVE OR LANDSCAPE ARCHITECT. ANY CHANGES FROM THE APPROVED PLANS MAY REQUIRE APPROVAL FROM THE EL PASO COUNTY PLANNING DEPARTMENT AND MAY DELAY COMPLETION OF PROJECT.
- CONTRACTOR IS RESPONSIBLE FOR VERIFYING QUANTITIES OF MATERIALS NEEDED TO COMPLETE THIS PLAN IN THE FIELD. NOTIFY OWNER'S REPRESENTATIVE OF DISCREPANCIES BETWEEN THE DRAWINGS AND CONDITIONS IN THE FIELD. SUBSTITUTIONS OF LANDSCAPE MATERIALS ARE NOT ALLOWED WITHOUT APPROVAL FROM LANDSCAPE ARCHITECT GIVEN PRIOR TO INSTALLATION. NOTIFY LANDSCAPE ARCHITECT PRIOR TO CONSTRUCTION IF LANDSCAPE MATERIAL LOCATIONS NEED TO BE ALTERED DUE TO ON-SITE CONDITIONS.
- CONTRACTOR IS TO PROVIDE A ONE YEAR WARRANTY ON ALL PLANT MATERIALS, IRRIGATION COMPONENTS, NATIVE GRASS, AND WORKMANSHIP. CONTRACTOR IS TO PROVIDE OWNER WITH WARRANTY CONDITIONS AND COMMENCE WARRANTY PERIOD UPON FINAL ACCEPTANCE OF LANDSCAPE INSTALLATION.
- THE OWNER OF THIS PROPERTY AND ANY FUTURE OWNERS SHALL BE RESPONSIBLE FOR THE PROPER LANDSCAPE AND IRRIGATION MAINTENANCE OF THIS SITE. MAINTENANCE OF THIS SITE INCLUDES, BUT IS NOT LIMITED TO, IRRIGATION INSPECTIONS AND ADJUSTMENTS, IRRIGATION SYSTEM SHUT DOWN AND START UP, IRRIGATION LEAK REPAIR, LANDSCAPE WEEDING, MOWING, SEEDING, FERTILIZATION, WOOD MULCH AND ROCK COVER REPLACEMENT, PRUNING, AND PLANT MATERIAL REPLACEMENT. OWNER SHOULD CONTACT LANDSCAPE CONTRACTOR OR LANDSCAPE ARCHITECT REGARDING ANY QUESTIONS RELATING TO THE LANDSCAPE OR IRRIGATION MAINTENANCE OF THIS SITE.

PROJECT NOTES

- FINE GRADING TO BE PERFORMED BY LANDSCAPE CONTRACTOR TO REFLECT FINISHED GRADES SHOWN ON THE PROJECT GRADING PLANS. ALL FINISHED GRADES ARE TO HAVE A MINIMUM 2% SLOPE. CONTRACTOR IS TO REPORT POOR DRAINAGE CONDITIONS OR ANY GRADES IN LANDSCAPE AREAS LESS THAN 2% TO GENERAL CONTRACTOR AND LANDSCAPE ARCHITECT PRIOR TO LANDSCAPE CONSTRUCTION WORK. FINISHED GRADES SHALL BE FREE OF WEEDS AND FREE OF DEBRIS AND ROCKS GREATER THAN ONE INCH.
- CONTRACTOR IS TO PROVIDE FINAL GRADES ADJACENT TO HARDSCAPE SURFACES AT THE FOLLOWING SPECIFICATIONS:
2" BELOW TOP OF CONCRETE OR RETAINING WALLS FOR ALL MULCH AND ROCK COVER BEDS.
1" BELOW TOP OF CONCRETE OR RETAINING WALLS FOR NATIVE SEED AREAS.
CONTRACTOR IS TO COORDINATE THESE GRADING SPECIFICATIONS WITH GENERAL CONTRACTOR AND/OR WHOEVER IS PROVIDING ROUGH GRADING. FINAL GRADES IN ALL LANDSCAPE AREAS ARE TO BE ESTABLISHED USING ON-SITE STOCKPILED TOPSOIL.
- ALL AREAS SHOWN AS 'NON-IRRIGATED NATIVE SEED' TO BE SEEDING WITH 'NATIVE PRAIRIE MIX' (PAWNEE BUTTE SEED, INC.) BY DRILL SEEDING AND HYDRO-MULCH SEEDING AT A RATE OF 1 LB. PER 1,000 SQ. FT. REFER TO NATIVE SEED ESTABLISHMENT SPECIFICATION FOR MORE DETAILED INSTRUCTIONS. ALL SEEDING AREAS TO RECEIVE EROSION CONTROL BLANKET- 'R1 EXCEL' WESTERN EXCELSIOR PHOTO-DEGRADABLE EROSION CONTROL BLANKET. INSTALL PER MANUFACTURER'S INSTRUCTIONS.
- ROCK COVER AREAS TO CONSIST OF 1.5" DIAMETER 'ROYAL GRANITE' CRUSHED ROCK (C&C SAND), SPREAD 3" DEPTH OVER LANDSCAPE FABRIC. LANDSCAPE FABRIC TO CONSIST OF 'DEWITT' WEED BARRIER PRO, 3 OZ BLACK WOVEN POLYPROPYLENE FABRIC. FABRIC TO OVERLAP 6" MINIMUM AT ALL SEAMS. 6" STEEL ANCHOR PINS TO BE INSTALLED 6" O.C. MAX.
- CASCADE CEDAR WOOD MULCH IS TO BE USED IN SPECIFIED BEDS, 3" DEPTH, AND ALSO PROVIDED AROUND ALL THE BASE OF ALL TREES, 4" DIAMETER, 3" DEPTH. NO LANDSCAPE FABRIC TO BE INSTALLED BENEATH MULCH.
- ALL PROPOSED PLANTING BEDS ARE TO BE ROTO-TILLED TO A 6" DEPTH. PLANTING BEDS ARE TO BE RAKED SMOOTH AND FINISHED GRADES ARE TO BE ESTABLISHED AND VERIFIED TO THE TOLERANCES LISTED ABOVE PRIOR TO PLANTING.
- AFTER PLANTING, BUT BEFORE LANDSCAPE FABRIC IS INSTALLED, ALL PLANTING BEDS ARE TO RECEIVE A GRANULAR PRE-EMERGENT HERBICIDE (PREEN OR SNAPSHOT). APPLY PER MANUFACTURER'S INSTRUCTIONS. CONTRACTOR IS TO SPRAY ALL PLANTING BEDS WITH WATER IMMEDIATELY AFTER MULCH IS INSTALLED TO REMOVE PRE-EMERGENT FROM FOLIAGE AND ACTIVATE HERBICIDE.
- STEEL EDGING IS TO CONSIST OF 16 GAUGE PERFORATED GALVANIZED ROLLED-TOP STEEL EDGING. EDGING IS TO BE USED TO SEPARATE NATIVE GRASS, WOOD MULCH, AND ROCK COVER AREAS, UNLESS OTHERWISE NOTED ON PLAN. EDGING IS TO BE PARTIALLY BURIED SO THAT HALF OF EDGING HEIGHT IS BELOW FINISHED SOIL GRADE. 12" STEEL EDGING PINS TO BE INSTALLED EVERY 4' O.C. MAX.. ENDS OF STEEL EDGING TO OVERLAP 6" MINIMUM WITH AND HAVE TWO PINS SECURING OVERLAPPED ENDS.

SOIL PREPARATION NOTES

- PROPOSED NATIVE GRASS AREAS:** ALL SEEDING AREAS TO RECEIVE 2 CU. YDS. PER 1,000 SQ. FT. OF 'BIOCOMP' SOIL AMENDMENTS (C&C SAND) INCORPORATED INTO EXISTING SOIL AND ROTO-TILLED TO A 6" DEPTH.
- PROPOSED TREES AND SHRUBS:** ALL PROPOSED TREES ARE TO BE BACKFILLED WITH A MIXTURE OF 'BIOCOMP' SOIL AMENDMENT AND IMPORTED GRADE A TOPSOIL (C&C SAND). REFER TO PLANTING DETAILS.

IRRIGATION NOTES

- ALL PROPOSED TREES AND SHRUBS ARE TO BE WATERED BY A PROPOSED DRIP IRRIGATION SYSTEM. IRRIGATION SYSTEM SHALL INCLUDE AUTOMATIC CONTROLLER, RAIN SENSOR, BACKFLOW PREVENTER (INSTALLED PER LOCAL CODES), AND A QUICK COUPLER ALONG MAINLINE. TREES TO HAVE (4) 1 GPH EMITTERS EACH EVENLY SPACED AT EDGE OF ROOT BALL. SHRUBS / ORNAMENTAL GRASSES TO HAVE (2) 1 GPH EMITTERS EACH EVENLY SPACED AT EDGE OF ROOT BALL. ALL DRIP PIPE SHALL BE SECURED WITH 6" METAL STAKES AND BURIED.
- ALL DISTURBED NATIVE SEED AREAS TO RECEIVE TEMPORARY IRRIGATION UNTIL NATIVE GRASS IS ESTABLISHED. REFER TO NATIVE SEED ESTABLISHMENT NOTES. HOSES ARE TO BE CONNECTED TO BUILDING HOSE BIBS AND IRRIGATION QUICK COUPLERS TO MANUALLY WATER PROPOSED NATIVE SEED AREAS WITH PORTABLE SPRINKLERS UNTIL ESTABLISHED. TEMPORARY SPRAY IRRIGATION ZONES CAN BE CREATED TO IRRIGATE NATIVE SEED AREAS UNTIL ESTABLISHED.



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PROJECT FILE: Security FS4-LS.dwg

DEVELOPMENT PLAN FOR
SECURITY FIRE STATION NO. 4
 0 Mesa Ridge Parkway
 Security, CO

PROJECT NAME:

FINAL LANDSCAPE PLAN

SHEET TITLE:


REVISION DATE: September 11, 2020

REVISION DATE: December 7, 2020

REVISION DATE: December 16, 2022

SHEET NO. / STAMP:

LS-2
Sheet 2 of 2

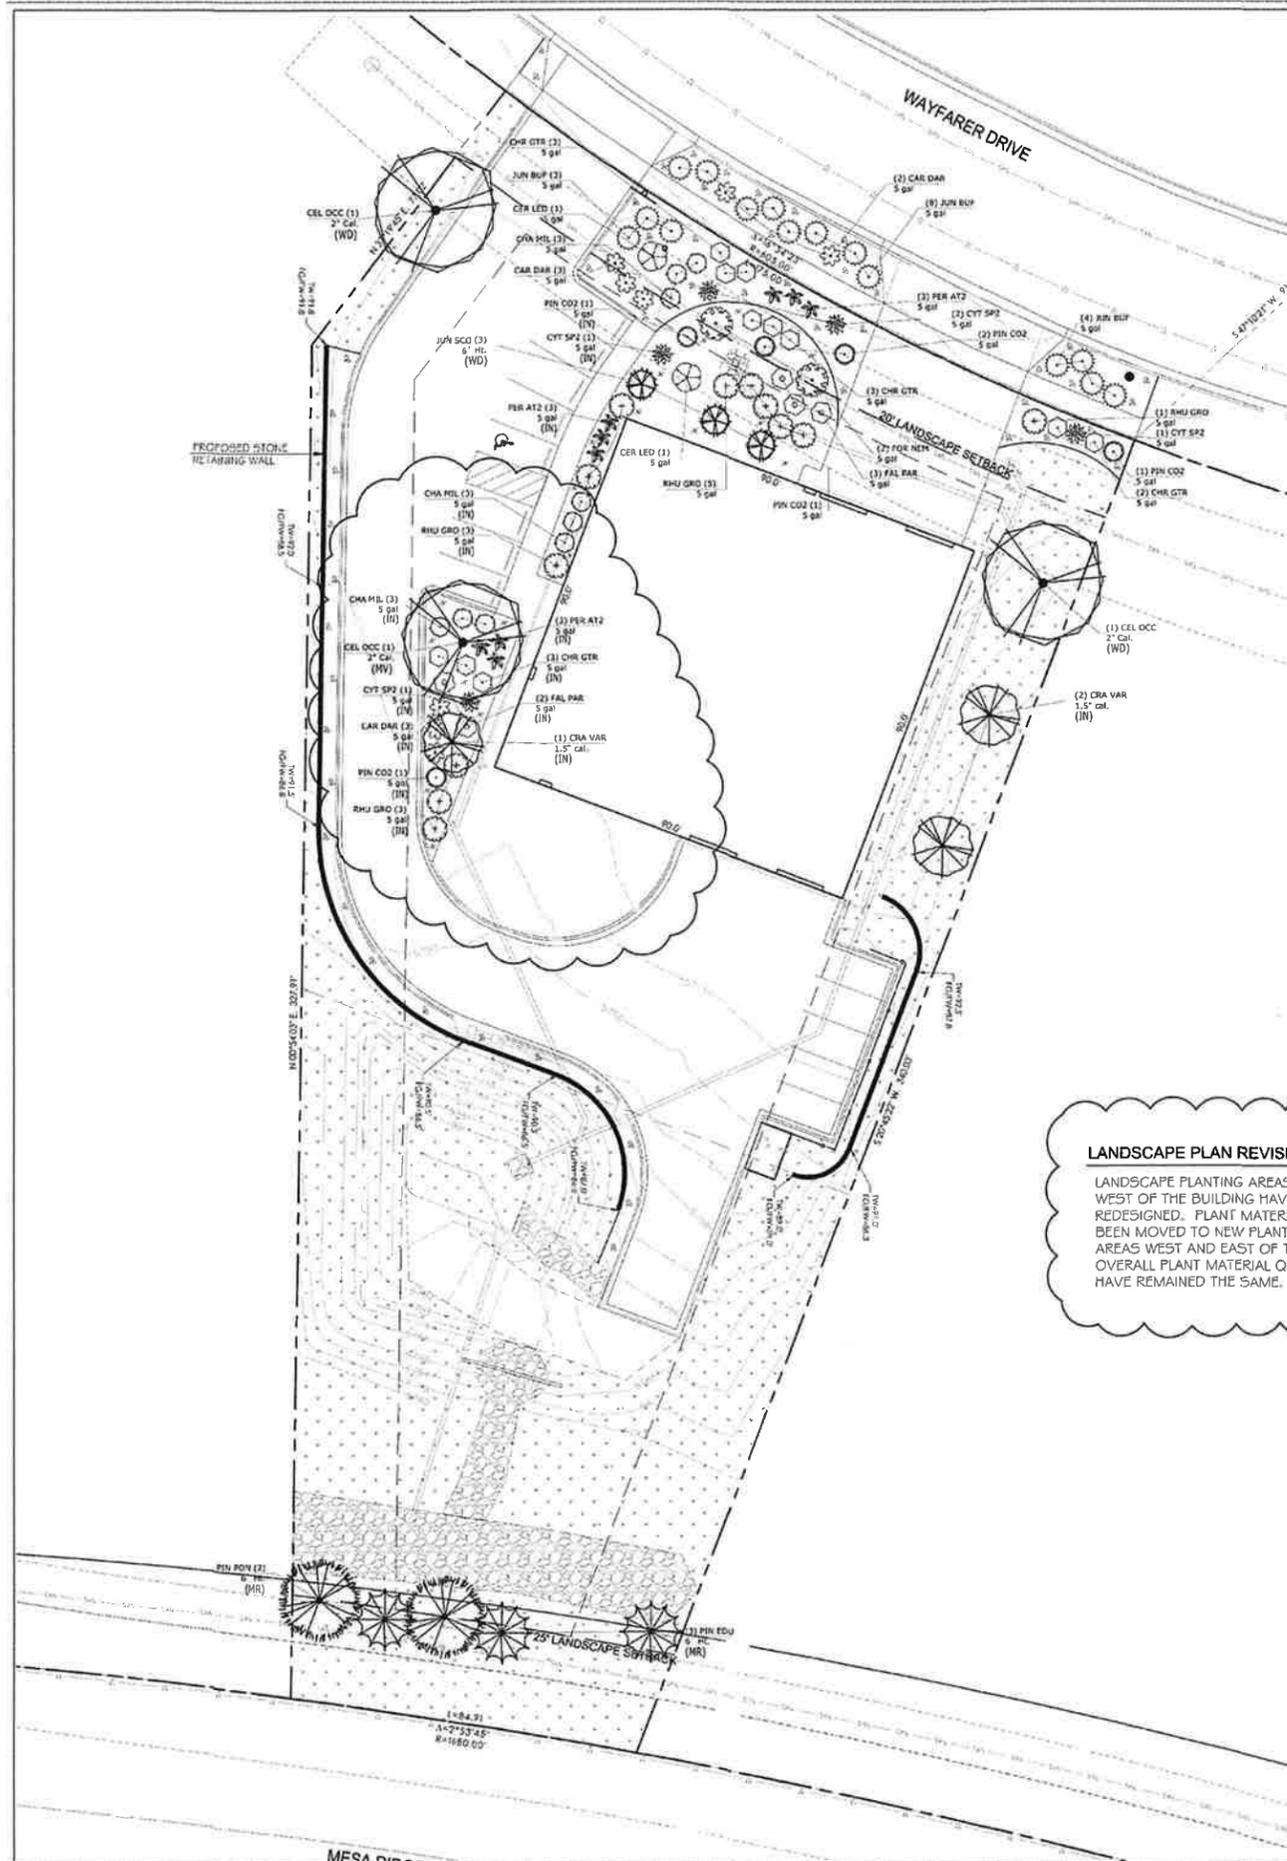

LANDSCAPE PLAN REVISIONS 12-16-22
 LANDSCAPE PLANTING AREAS SOUTH AND WEST OF THE BUILDING HAVE BEEN REDESIGNED. PLANT MATERIALS HAVE BEEN MOVED TO NEW PLANTING BED AREAS WEST AND EAST OF THE BUILDING. OVERALL PLANT MATERIAL QUANTITIES HAVE REMAINED THE SAME.

SITE CATEGORY CALCULATIONS:

Landscape Setbacks

Street Name or Boundary	Street Classification	Width (in Ft.)	Linear Req./Prov.	Linear Footage	Tree/Foot Required	No. of Trees Req./Prov.	Setback Plant Abbr. Denoted on Plan
Mesa Ridge Parkway	Principal Arterial	25' / 25'	85'	1 / 20'	5 / 5	(MR)	
Wayfarer Drive	Minor Arterial	20' / 20'	175'	1 / 25'	7 / 5	(WD)	

*REQUEST ALTERNATIVE COMPLIANCE: Cannot put trees in R.O.W. or in sanitary sewer easement. Have placed 5 trees along back edge sanitary sewer easement and cannot fit anymore. Have placed additional shrubs in R.O.W. and in easement to compensate for the 2 missing trees.

Parking

No. of Vehicles Spaces Provided	Shade Trees Required/Provided	Abbr. on Plan	Vehicle Lot Frontages	Length of Frontage (excluding driveways)	2/3 Length of Frontage (ft.)
8	1 / 1	(PK)	Wayfarer Drive	20'	

Min. 3' Screening Plans Req. / Prov.	Evergreen Plants Req. (50%) / Prov.	Length of Screening Wall or Berm Provided	Vehicle Lot Plant Abbr. on Plan	Percent Ground Plane Veg. Req. / Prov.
3 / 3	2 / 2		(PS)	75% / 75%

Internal Landscaping

Net Site Area (SF) (less public ROW)	Percent Minimum Internal Area (%)	Internal Area (SF) Required / Provided	Internal Trees (1/500 SF) Required / Provided
52,730 s.f.	5%	2,637 s.f. / 9,500 s.f.	6 / 3*

Shrub Substitutes Required / Provided: 30 / 30 (IN)
 Internal Plant Abbr. Denoted on Plan: (IN)
 *REQUEST ALTERNATIVE COMPLIANCE: Landscape design has utilized more shrubs than required to fill large sanitary sewer easement area where trees are not allowed. Substitution of half the required internal trees for shrubs is requested.

Landscape Buffer & Screens

Street Name or Property Line	Width (in Ft.)	Linear Footage	Buffer Trees (1/15) Required / Provided	Evergreen Trees (1/3) / Provided
None	- / -	- / -	- / -	- / -


Length of 6 Ft. Opaque Structure Req. / Prov.	Buffer Tree Abbr. Denoted on Plan	Percent Ground Plane Veg. Req. / Prov.
- / -	- / -	- / -

PLANT SCHEDULE

TREES	CODE	QTY	BOTANICAL NAME	COMMON NAME	SIZE	TYPE
	CEL OCC	3	Cellis occidentalis	Common Hackberry	2" Cal.	B & B
	CRA VAR	3	Crataegus crus-galli inermis TM	Thornless Cockspur Hawthorn	1.5" cal.	B & B
	JUN SCO	3	Juniperus scopulorum	Rocky Mountain Juniper	6' Ht.	
	PIN EDU	3	Pinus cambroides edulis	Pinyon Pine	6' Ht.	B & B
	PIN PON	2	Pinus ponderosa	Ponderosa Pine	6' Ht.	B & B
SHRUBS	CODE	QTY	BOTANICAL NAME	COMMON NAME	SIZE	TYPE
	CAR DAR	8	Caryopteris x clandonensis 'Dark Knight'	Dark Knight Blue Mist Shrub	5 gal	
	CER LED	2	Cercocarpus ledifolius	Curl-Leaf Mountain Mahogany	5 gal	
	CHA MIL	9	Chamaebatiaria millefolium	Fernbush	5 gal	
	CHR GTR	11	Chrysothamnus nauseosus graveolens	Tall Green Rabbitbrush	5 gal	
	CYT SP2	5	Cytisus purgans 'Spanish Gold'	Spanish Gold Broom	5 gal	
	FAL PAR	5	Fallugia paradoxa	Apache Plume	5 gal	
	FOR NEM	2	Forsytheria neomexicana	New Mexico Privet	5 gal	
	JUN BUF	15	Juniperus sabina 'Buffalo'	Buffalo Juniper	5 gal	
	PER AT2	9	Perovskia atriplicifolia	Russian Sage	5 gal	
	PIN CO2	5	Pinus mugo 'Compacta'	Dwarf Mugo Pine	5 gal	
	RHU GRO	12	Rhus aromatica 'Gro-Low'	Gro-Low Fragrant Sumac	5 gal	

PROPOSED GROUND PLANE TREATMENT

- PROPOSED 1.5" 'ROYAL GRANITE' CRUSHED ROCK, 3" DEPTH, OVER DEWITT LANDSCAPE FABRIC
- PROPOSED 'CASCADE CEDAR' WOOD MULCH, 3" DEPTH (NO FABRIC BENEATH)
- PROPOSED NON-IRRIGATED NATIVE SEED WITH EROSION CONTROL BLANKET (ALL DISTURBED AREAS)
- PROPOSED RIP-RAP (REFER TO CIVIL PLANS)
- PROPOSED COMPACTED CLASS 6 ROAD BASE, 4" DEPTH

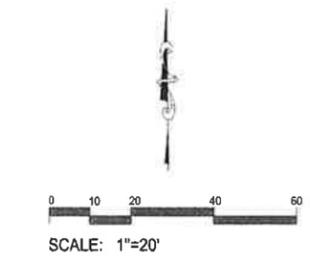

PCD File # COM22-059

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PROJECT FILE: Security F84-L3 12-16-22.dwg

DEVELOPMENT PLAN FOR
SECURITY FIRE STATION NO. 4
 0 Mesa Ridge Parkway
 Security, CO

PROJECT NAME

FINAL LANDSCAPE PLAN

SHEET TITLE

DATE: September 11, 2020

REVISED: December 7, 2020

December 16, 2022

STAMP:

LS-1
 Sheet 1 of 2