SOLACE APARTMENTS FILING NO. 1 A PORTION OF SECTION 7, TOWNSHIP 14 SOUTH, RANGE 65 WEST OF THE 6TH P.M.

ABBREVIATIONS

Strategy and the strategy of the strategy of	
AD AH ARCH	ACRE ALGEBRAIC DIFFERENCE AHEAD ARCHITECT AMERICAN SOCIETY OF CIVIL
	ENGINEERS ASSEMBLY AVENUE BOX BASE BACK BOUNDARY
BOP BOV BFV BLVD BW	BLOW OFF VALVE BUTTERFLY VALVE BOULEVARD BOTTOM OF WALL
C&G CATV CB CBC CDOT	CURB & GUTTER CABLE TELEVISION CATCH BASIN CONCRETE BOX CULVERT COLORADO DEPARTMENT OF TRANSPORTATION
CDS CFS CL CLOMR	CUL-DE-SAC CUBIC FEET PER SECOND CENTER LINE CONDITIONAL LETTER OF MAP REVISION
CLR CMP CO CONC CR CSP CT	CLEAR CORRUGATED METAL PIPE CLEAN OUT CONCRETE CIRCLE CORRUGATED STEEL PIPE COURT
CTRB CY	CONCRETE THRUST REDUCER BLOCK CUBIC YARD
DBPS	STUDY
DE DIA DIP DR DRC DU	DRAINAGE EASEMENT DIAMETER DUCTILE IRON PIPE DRIVE DESIGN REVIEW COMMITTEE DWELLING UNITS
E EA EGL EL	EAST EACH ENERGY GRADE LINE ELEVATION ELECTRIC
EOA ESMT	EDGE OF ASPHALT EASEMENT ESTIMATE EXISTING

FDR FES FG FH FL FIL FO GB GE	FINAL DEVELOPMENT PLAN FINAL DRAINAGE REPORT FLARED END SECTION FINISHED GRADE FIRE HYDRANT FLOWLINE FILING FIBER OPTIC CABLE GRADE BREAK GAS EASEMENT GEOGRAPHIC INFORMATION	
HDC HDPE	SYSTEM GAS LINE GLOBAL POSITIONING SYSTEM GATE VALVE HANDICAP HIGH DEFLECTION COUPLING HIGH DENSITY POLYETHYLENE HYDRAULIC GRADE LINE HOME OWNERS ASSOCIATION HIGH POINT INLET	
IE INT IRR KB LE LF LN	IRRIGATION EASEMENT INTERSECTION INVERT IRRIGATION KICK (THRUST) BLOCK LANDSCAPE EASEMENT LINEAR FEET LANE	
LOMR LP LS LT MAX MDDP	LETTER OF MAP REVISION LOW POINT LUMP SUM LEFT MAXIMUM MASTER DEVELOPMENT DRAINAGE PLAN	
MH MIN N NRCP	PIPE	
	OFFICIAL DEVELOPMENT PLAN OVERHEAD ELECTRIC OVERHEAD UTILITY POINT OF CURVATURE POINT OF COMPOUND CURVATURE	
PDP	POINT OF CURB RETURN PRELIMINARY DEVELOPMENT PLAN	
DI	PROFESSIONAL ENGINEER POINT OF INTERSECTION	

PKWY PARKWAY

-21



THE EASTERLY LINE OF LOT 2, POWERS & GALLEY PLAZA FILING NO. 1 RECORDED IN PLAT BOOK A-4 AT PAGE 30, SAID LINE BEING MONUMENTED BY A 1-1/4" YELLOW PLASTIC CAP STAMPED "LS 22106" AT THE SOUTH END AND A 1" O.D. PIPE AT THE NORTH END, SAID LINE BEARING NO0"27'47"E AS SHOWN ON SAID PLAT.

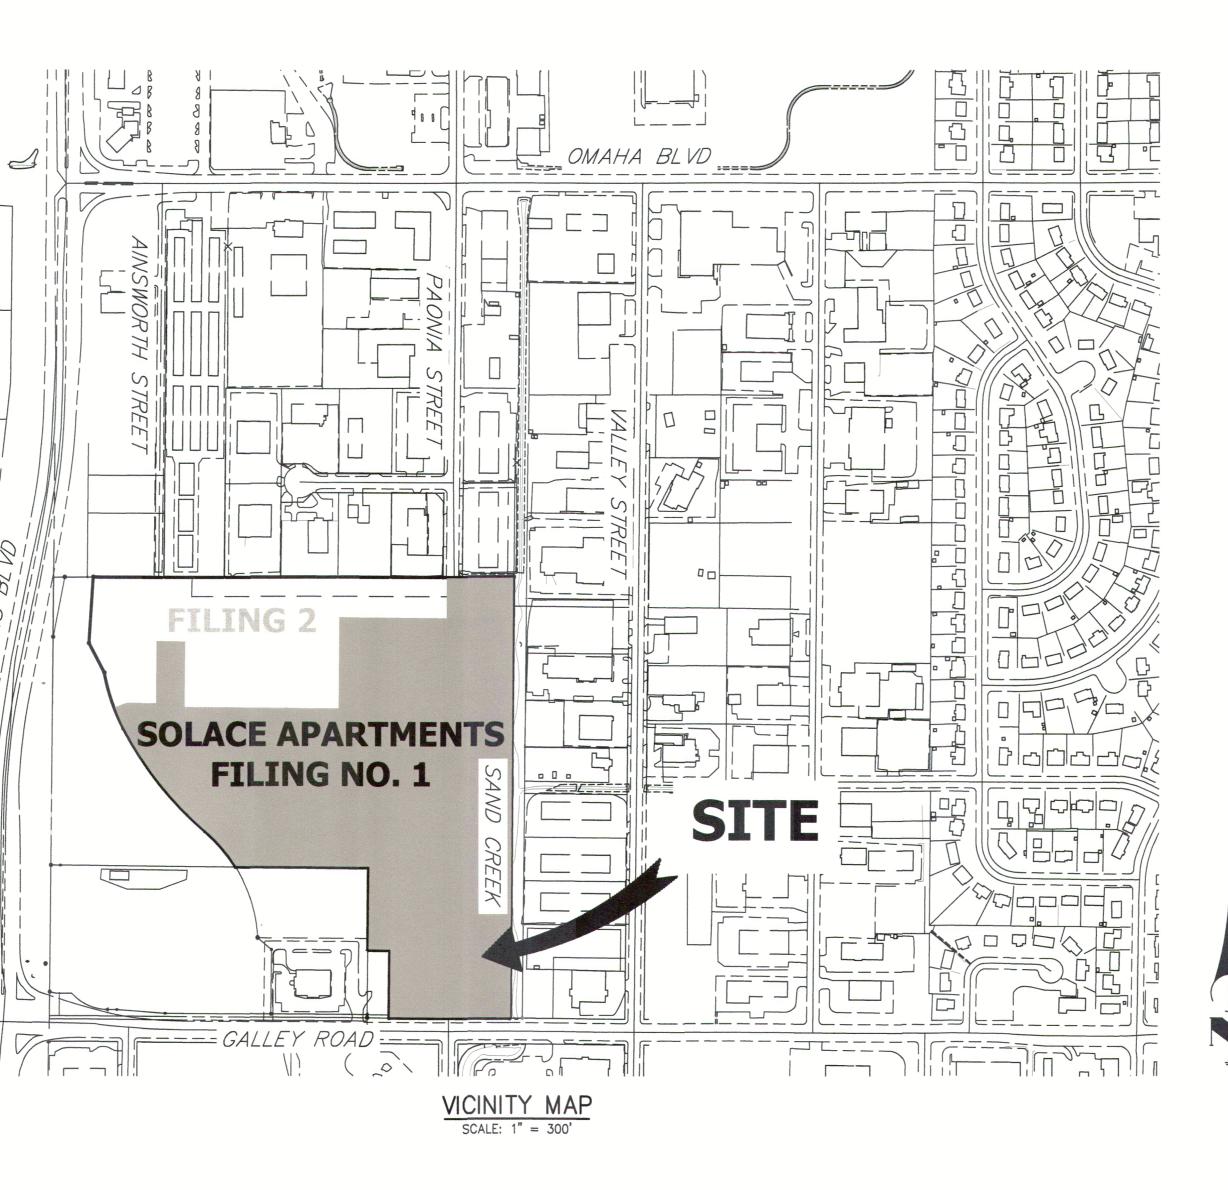
BENCHMARK

FIMS MONUMENT F81, BEING MONUMENTED BY A 3-1/4" ALUMINUM CAP IN RANGE BOX WITH NO TOP, LOCATED 900 FEET EAST OF THE INTERSECTION OF E. PLATTE AVENUE AND VALLEY STREET, APPROXIMATLEY 80 FEET NORTH OF THE CENTERLINE OF E PLATTE AVENUE. SAID MONUMENT HAVING A PUBLISHED ELEVATION OF 6275.86 FEET, NAVD88.

FAILURE TO EXACTLY LOCATE AND PRESERVE ANY AND ALL PCD FILE NO. PPR2047		IPCD			SF2032 PPR2047	
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EL PASO COUNTY, COLORADO

CONSTRUCTION DOCUMENTS



SHEET INDEX

1 2 3-4 5-11 12-15 16-17 18-19 20-21 22-23 24-26 27-28 29-32	COVER SHEET LEGEND & NOTES SITE AND OVERALL UTILITY PLAN DETAIL GRADING PLAN STORM SEWER PLAN AND PROFILE POND A PLAN & CROSS SECTIONS POND A DETAILS POND B PLAN & CROSS SECTIONS POND B DETAILS ROOF DRAIN AND AREA DRAIN PLANS SIGNAGE AND STRIPING PLAN DETAIL SHEETS	
TOTAL	32	

OWNER/DEVELOPER STA

I, THE OWNER/DEVELOPER HAVE READ AND THE REQUIREMENTS SPECIFIED IN THESE DE SPECIFICATIONS.

1 Jan UMITC DANE OLMSTEAD

CS POWERS & GALLEY LLC 510 S NEIL ST CHAMPAIGN, IL 61820

			THESE DRAWINGS ARE APPROVED BY THE	APPROPRIATE REVIEWING	APPROVES THEIR USE	SIGNATED BY	
OWNER CS POWERS & GALLEY LLC 510 S NEIL ST CHAMPAIGN, IL 61820 P~734.216.2577 CIVIL ENGINEER		PREPARED FOR	s & gai	510 S NEIL ST	, IL 010 PHONE	216-	
JR ENGINEERING 5475 TECH CENTER DR SUITE 235 COLORADO SPRINGS, CO 80919 CONTACT: MIKE BRAMLETT C~719.659.7679 PLANNER N.E.S. INC. 619 N. CASCADE AVE SUITE 200 COLORADO SPRINGS, CO 80903 CONTACT: TAMARA BAXTER P~719.471.0073 ARCHITECT LCM ARCHITECTS 819 S. WABASH AVE, FIFTH FLC CHICAGO, IL 60605 P~312.995.5305 GEOTECHNICAL EP CTL THOMPSON, INC 5170 MARK DABLING BLVD COLORADO SPRINGS, CO 80918	OOR		I-R ENGINEERING	· _	S.	Centennial 303-740-9393 • Colorado Springs 719-593-2593 Ent Colline 970-704-0998 • www.iranoinaoring.com	
P~719.528.8300 FIRE PROTECTION CIMARRON HILLS FIRE DEPARTM 1835 TUSKEGEE PL COLORADO SPRINGS, CO 80915 P~(719) 591–0960	DISTRICT IENT	EVISION BY DATE					
	ELEVATIONS WHICH SHALL BE CONFIRMED AT THE JOB SITE. THE COUNTY THROUGH THE APPROVAL OF THIS DOCUMENT ASSUMES NO RESPONSIBILITY FOR COMPLETENESS AND/OR ACCURACY OF THIS DOCUMENT. FILED IN ACCORDANCE WITH THE REQUIREMENTS OF THE EL PASO COUNTY LAND DEVELOPMENT CODE, DRAINAGE CRITERIA MANUAL,	300' No. RE		/21	Σ	W	
	VOLUMES 1 AND 2, AND ENGINEERING CRITERIA MANUAL AS AMENDED. IN ACCORDANCE WITH ECM SECTION 1.12, THESE CONSTRUCTION DOCUMENTS WILL BE VALID FOR CONSTRUCTION FOR A PERIOD OF 2 YEARS FROM THE DATE SIGNED BY THE EL PASO COUNTY ENGINEER. IF CONSTRUCTION HAS NOT STARTED WITHIN THOSE 2 YEARS, THE PLANS WILL NEED TO BE RESUBMITTED FOR APPROVAL, INCLUDING PAYMENT OF REVIEW FEES AT THE PLANNING AND COMMUNITY DEVELOPMENT DIRECTORS DISCRETION.	H-SCALE 1"=	щ	1) BY	DRAWN BY JRM	СНЕСКЕД ВҮ
Example 2 Control of the second state of the	JENNIFER IRVINE, P.E. DATE COUNTY ENGINEER/ECM ADMINISTRATOR ENGINEER'S STATEMENT THESE DETAILED PLANS AND SPECIFICATIONS WERE PREPARED UNDER MY DIRECT SUPERVISION. SAID PLANS AND SPECIFICATIONS HAVE BEEN PREPARED ACCORDING TO THE CRITERIA ESTABLISHED BY THE COUNTY FOR DETAILED ROADWAY, DRAINAGE, GRADING AND EROSION CONTROL PLANS AND SPECIFICATIONS, AND SAID PLANS AND SPECIFICATIONS ARE IN CONFORMITY WITH APPLICABLE MASTER DRAINAGE PLANS AND MASTER TRANSPORTATION PLANS. SAID PLAN AND SPECIFICATIONS MEET THE PURPOSES FOR WHICH THE PARTICULAR ROADWAY AND DRAINAGE FACILITIES ARE DESIGNED AND ARE CORRECT TO THE BEST OF MY KNOWLEDGE AND BELIEF. I ACCEPT RESPONSIBILITY FOR ANY LIABILITY CAUSED BY ANY NEGLIGENT ACTS, ERRORS OR OMISSIONS ON MY PART IN PREPARATION OF THESE DETAILED PLANS AND SPECIFICATIONS. MAMA MAMANA 32314 HIMMEDIA MAMA	SOLACE APARTMENTS	ING NO. 1	COVER SHEFT			
DATE	MIKE A. BRAMLETT, P.E. COLORADO P.E. 32314 FOR AND ON BEHALF OF JR ENGINEERING, LOO AL	SHE	ET NO.	1	OF 2 517	- 3 '4.0	

LAYER LINETYPE LEGEND

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100 YEAR HGL					· · · ·	·

STANDARD NOTES FOR EL PASO COUNTY CONSTRUCTION PLANS

- 1. ALL DRAINAGE AND ROADWAY CONSTRUCTION SHALL MEET THE STANDARDS AND SPECIFICATIONS OF THE CITY OF COLORADO SPRINGS/EL PASO COUNTY DRAINAGE CRITERIA MANUAL, VOLUMES 1 AND 2, AND THE EL PASO COUNTY ENGINEERING CRITERIA MANUAL.
- 2. CONTRACTOR SHALL BE RESPONSIBLE FOR THE NOTIFICATION AND FIELD NOTIFICATION OF ALL EXISTING UTILITIES. WHETHER SHOWN ON THE PLANS OR NOT, BEFORE BEGINNING CONSTRUCTION. LOCATION OF EXISTING UTILITIES SHALL BE VERIFIED BY THE CONTRACTOR PRIOR TO CONSTRUCTION. CALL 811 TO CONTACT THE UTILITY NOTIFICATION CENTER OF COLORADO (UNCC).
- 3. CONTRACTOR SHALL KEEP A COPY OF THESE APPROVED PLANS, THE GRADING AND EROSION CONTROL PLAN, THE STORMWATER MANAGEMENT PLAN (SWMP), THE SOIL AND GEOTECHNICAL REPORT, AND THE APPROPRIATE DESIGN AND CONSTRUCTION STANDARDS AND SPECIFICATIONS AT THE JOB SITE AT ALL TIMES, INCLUDING THE FOLLOWING: 3.1. EL PASO COUNTY ENGINEERING CRITERIA MANUAL (ECM)
- 3.2. CITY OF COLORADO SPRINGS/ EL PASO COUNTY DRAINAGE CRITERIA MANUAL, VOLUMES 1 AND 2 3.3. COLORADO DEPARTMENT OF TRANSPORTATION (CDOT) STANDARD SPECIFICATIONS AND BRIDGE CONSTRUCTION

3.4. CDOT M&S STANDARDS

- 4. NOTWITHSTANDING ANYTHING DEPICTED IN THESE PLANS IN WORDS OR GRAPHIC REPRESENTATION, ALL DESIGN AND CONSTRUCTION RELATED TO ROADS, STORM DRAINAGE AND EROSION CONTROL SHALL CONFORM TO THE STANDARDS AND REQUIREMENTS OF THE MOST RECENT VERSIONS OF THE RELEVANT ADOPTED EL PASO COUNTY STANDARDS, INCLUDING THE LAND DEVELOPMENT CODE, THE EINGEERIONG CRITERIA MANUAL, THE DRAINAGE CRITERIA MANUAL, AND THE DRAINAGE CRITERIA MANUAL VOLUME 2. ANY DEVIATIONS FROM REGULATIONS AND STANDARDS MUST BE REQUESTED, AND APPROVED, IN WRITING. ANY MODIFICATIONS NECESSARY TO MEET CRITERIA AFTER-THE-FACT WILL BE ENTIRELY THE DEVELOPER'S RESPONSIBILITY TO RECTIFY.
- 5. IT IS THE DESIGN ENGINEER'S RESPONSIBILITY TO ACCURATELY SHOW EXISTING CONDITIONS, BOTH ONSITE AND OFFSITE, ON THE CONSTRUCTION PLANS. ANY MODIFICATIONS NECESSARY DUE TO CONFLICTS, OMISSIONS, OR CHANGED CONDITIONS WILL BE ENTIRELY THE DEVELOPER'S RESPONSIBILITY TO RECTIFY.
- 6. CONTRACTOR SHALL SCHEDULE A PRE-CONSTRUCTION MEETING WITH EL PASO COUNTY PLANNING AND COMMUNITY DEVELOPMENT INSPECTIONS, PRIOR TO STARTING CONSTRUCTION.
- 7. IT IS THE CONTRACTOR'S RESPONSIBILITY TO UNDERSTAND THE REQUIREMENTS OF ALL JURISDICTIONAL AGENCIES TO OBTAIN ALL REQUIRED PERMITS, INCLUDING BUT NOT LIMITED TO EL PASO COUNTY EROSION AND STORMWATER QUALITY CONTROL PERMIT (ESQCP), REGIONAL BUILDING FLOODPLAIN DEVELOPMENT PERMIT, U.S. ARMY CORPS OF ENGINEERS-ISSUED 401 AND/OR 404 PERMITS, AND COUNTY AND STATE FUGITIVE DUST PERMITS.
- 8. CONTRACTOR SHALL NOT DEVIATE FROM THE PLANS WITHOUT FIRST OBTAINING WRITTEN APPROVAL FROM THE DESIGN ENGINEER AND PCD. CONTRACTOR SHALL NOTIFY THE DESIGN ENGINEER IMMEDIATELY UPON DISCOVERY OF ANY ERRORS OR INCONSISTENCIES. 9. ALL STORM DRAIN PIPE SHALL BE CLASS III RCP UNLESS OTHERWISE NOTED AND APPROVED BY PLANNING AND COMMUNITY
- DEVELOPMENT. 10. CONTRACTOR SHALL COORDINATE GEOTECHNICAL TESTING PER ECM STANDARDS. PAVEMENT DESIGN SHALL BE APPROVED BY EL PASO COUNTY PCD PRIOR TO PLACEMENT OF CURB AND GUTTER AND PAVEMENT.
- 11. ALL CONSTRUCTION TRAFFIC MUST ENTER/EXIT THE SITE AT APPROVED CONSTRUCTION ACCESS POINTS.
- 12. SIGHT VISIBILITY TRIANGLES ARE IDENTIFIED IN THE PLANS SHALL BE PROVIDED AT ALL INTERSECTIONS. OBSTRUCTIONS GREATER THAN 18 INCHES ABOVE FLOWLINE ARE NOT ALLOWED IN SIGHT TRIANGLES.
- 13. SIGNING AND STRIPING SHALL COMPLY WITH EL PASO COUNTY DEPARTMENT OF PUBLIC WORKS AND MUTCD CRITERIA.
- 14. CONTRACTOR SHALL OBTAIN ANY PERMITS REQUIRED BY EL PASO COUNTY DEPARTMENT OF PUBLIC WORKS, INCLUDING WORK WITHIN THE RIGHT-OF-WAY AND SPECIAL TRANSPORT PERMITS.
- 15. THE LIMITS OF CONSTRUCTION SHALL REMAIN WITHIN THE PROPERTY LINE UNLESS OTHERWISE NOTED. THE OWENER/DEVELOPER SHALL OBTAIN WRITTEN PERMISSION AND EASEMENTS, WHERE REQUIRED, FROM ADJOINING PROPERTY OWNER(S) PRIOR TO ANY OFF-SITE DISTURBANCE, GRADING, OR CONSTRUCTION.

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UTILITY POLE

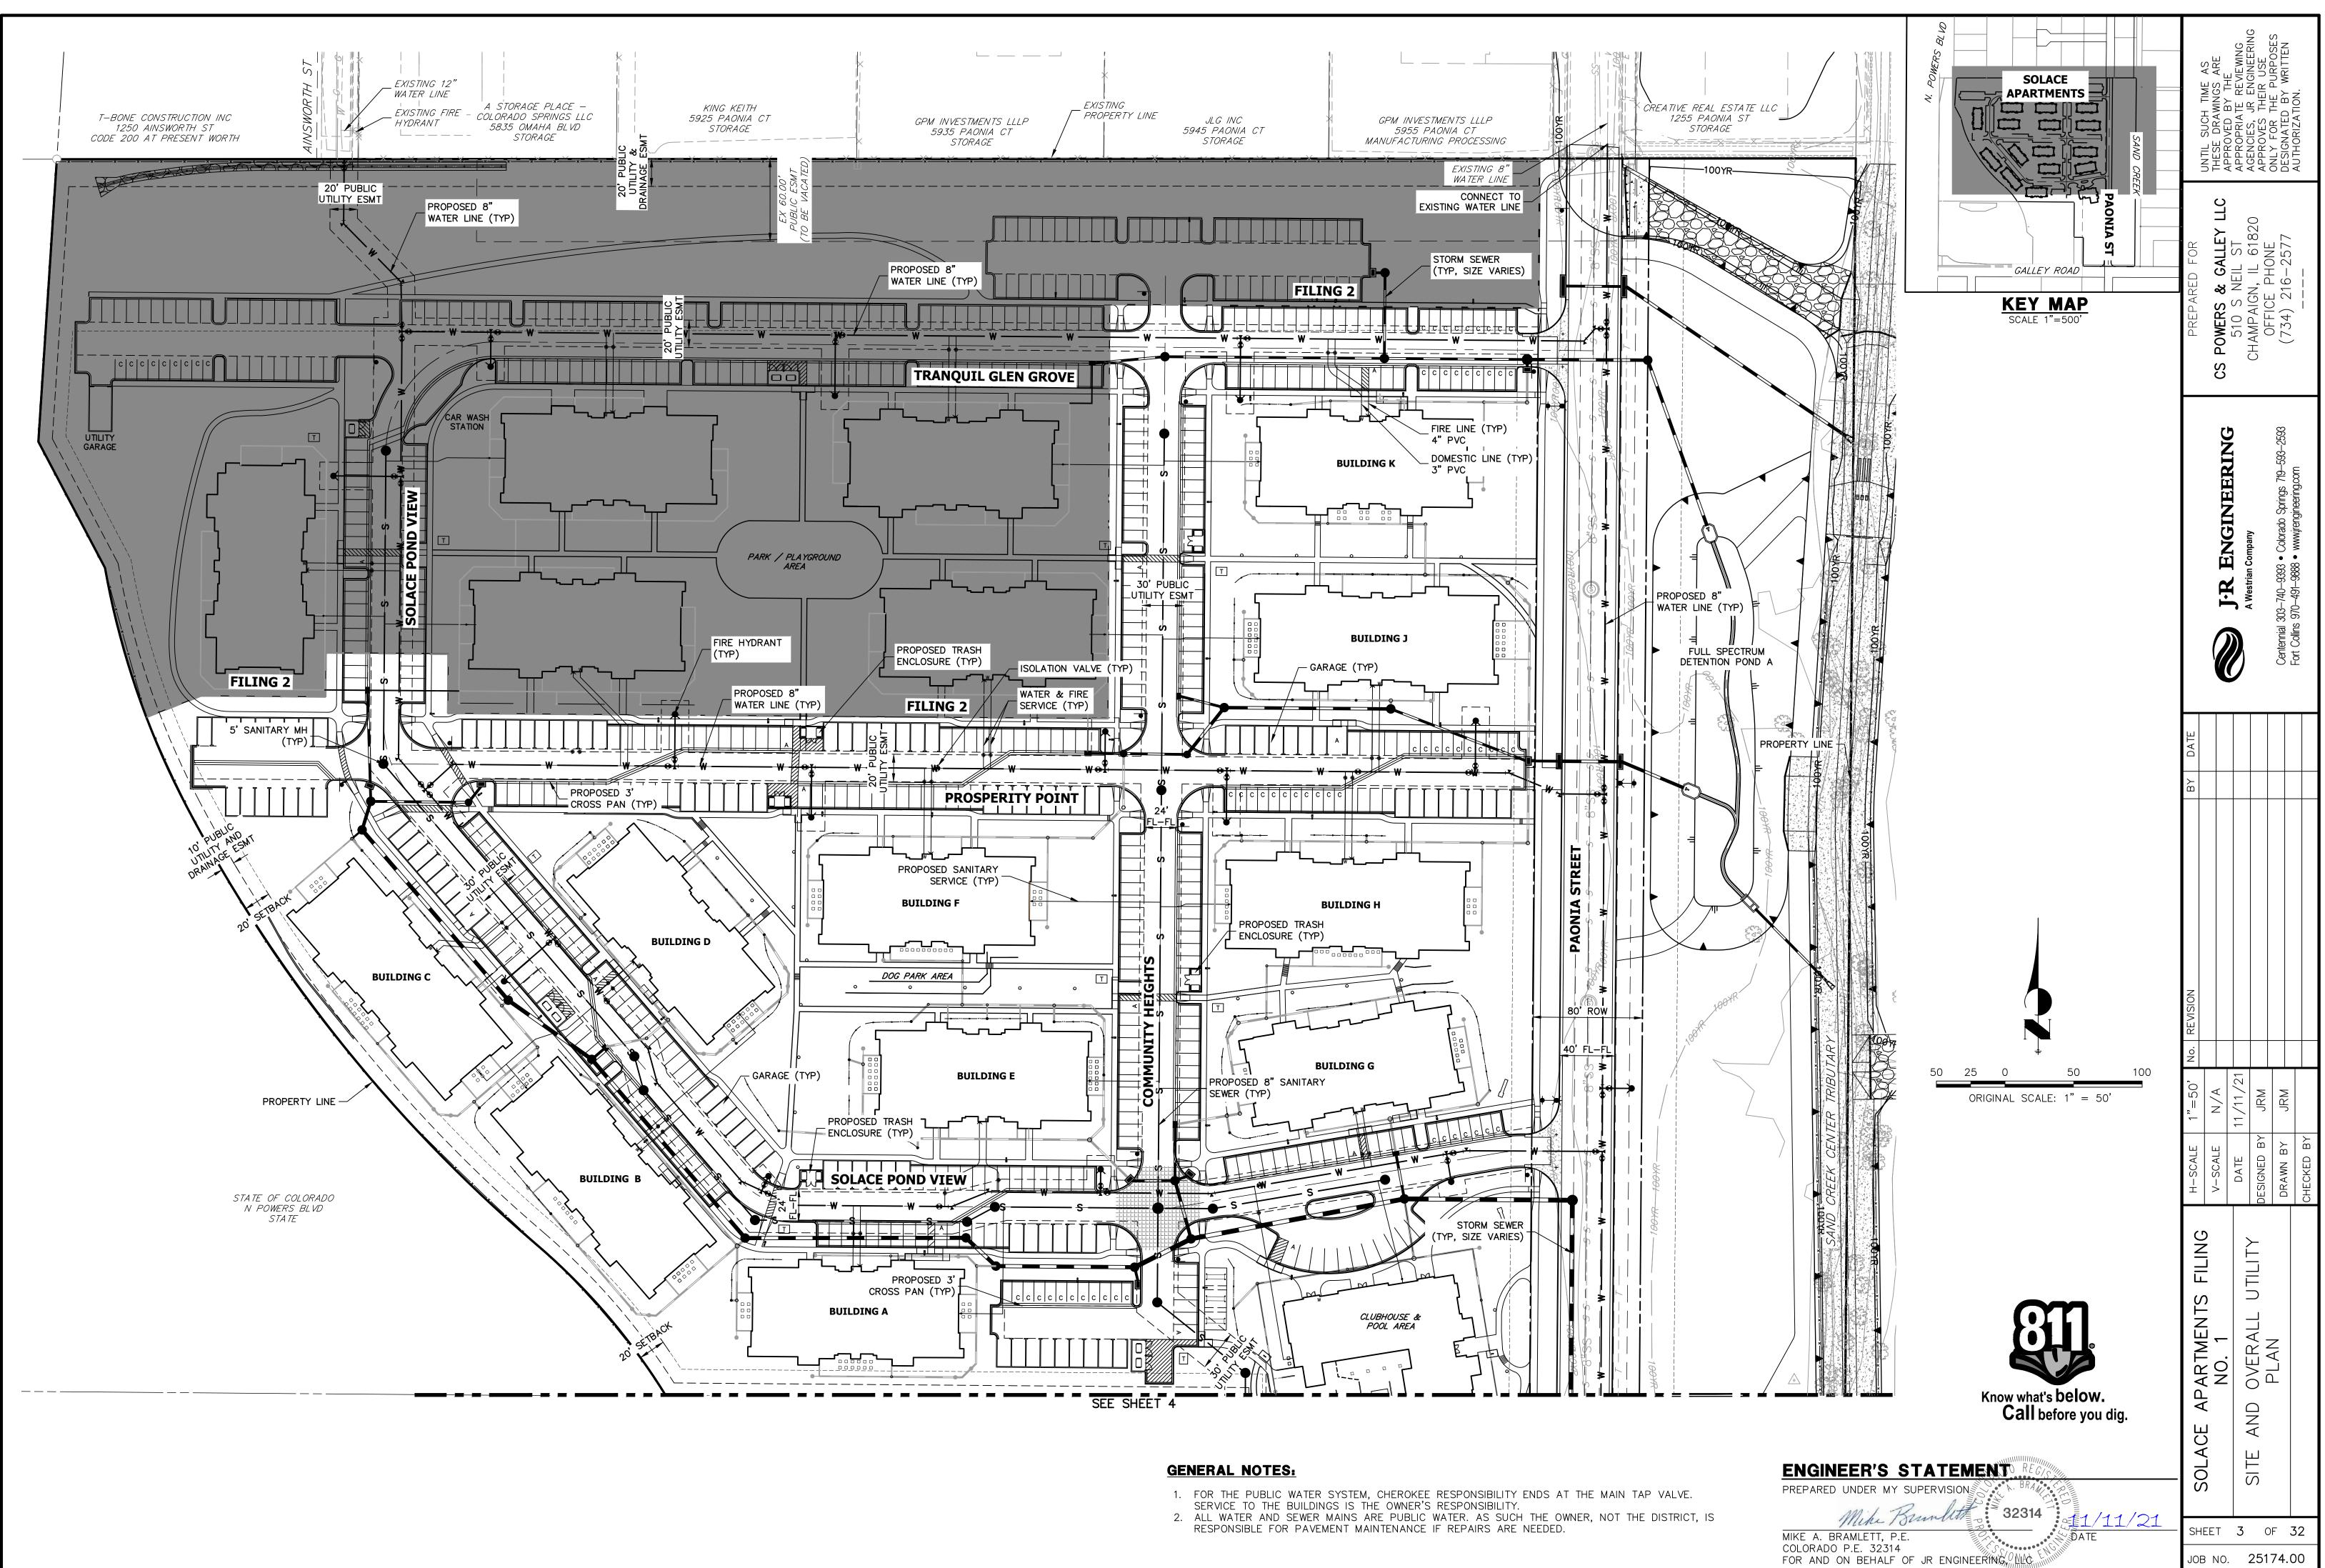
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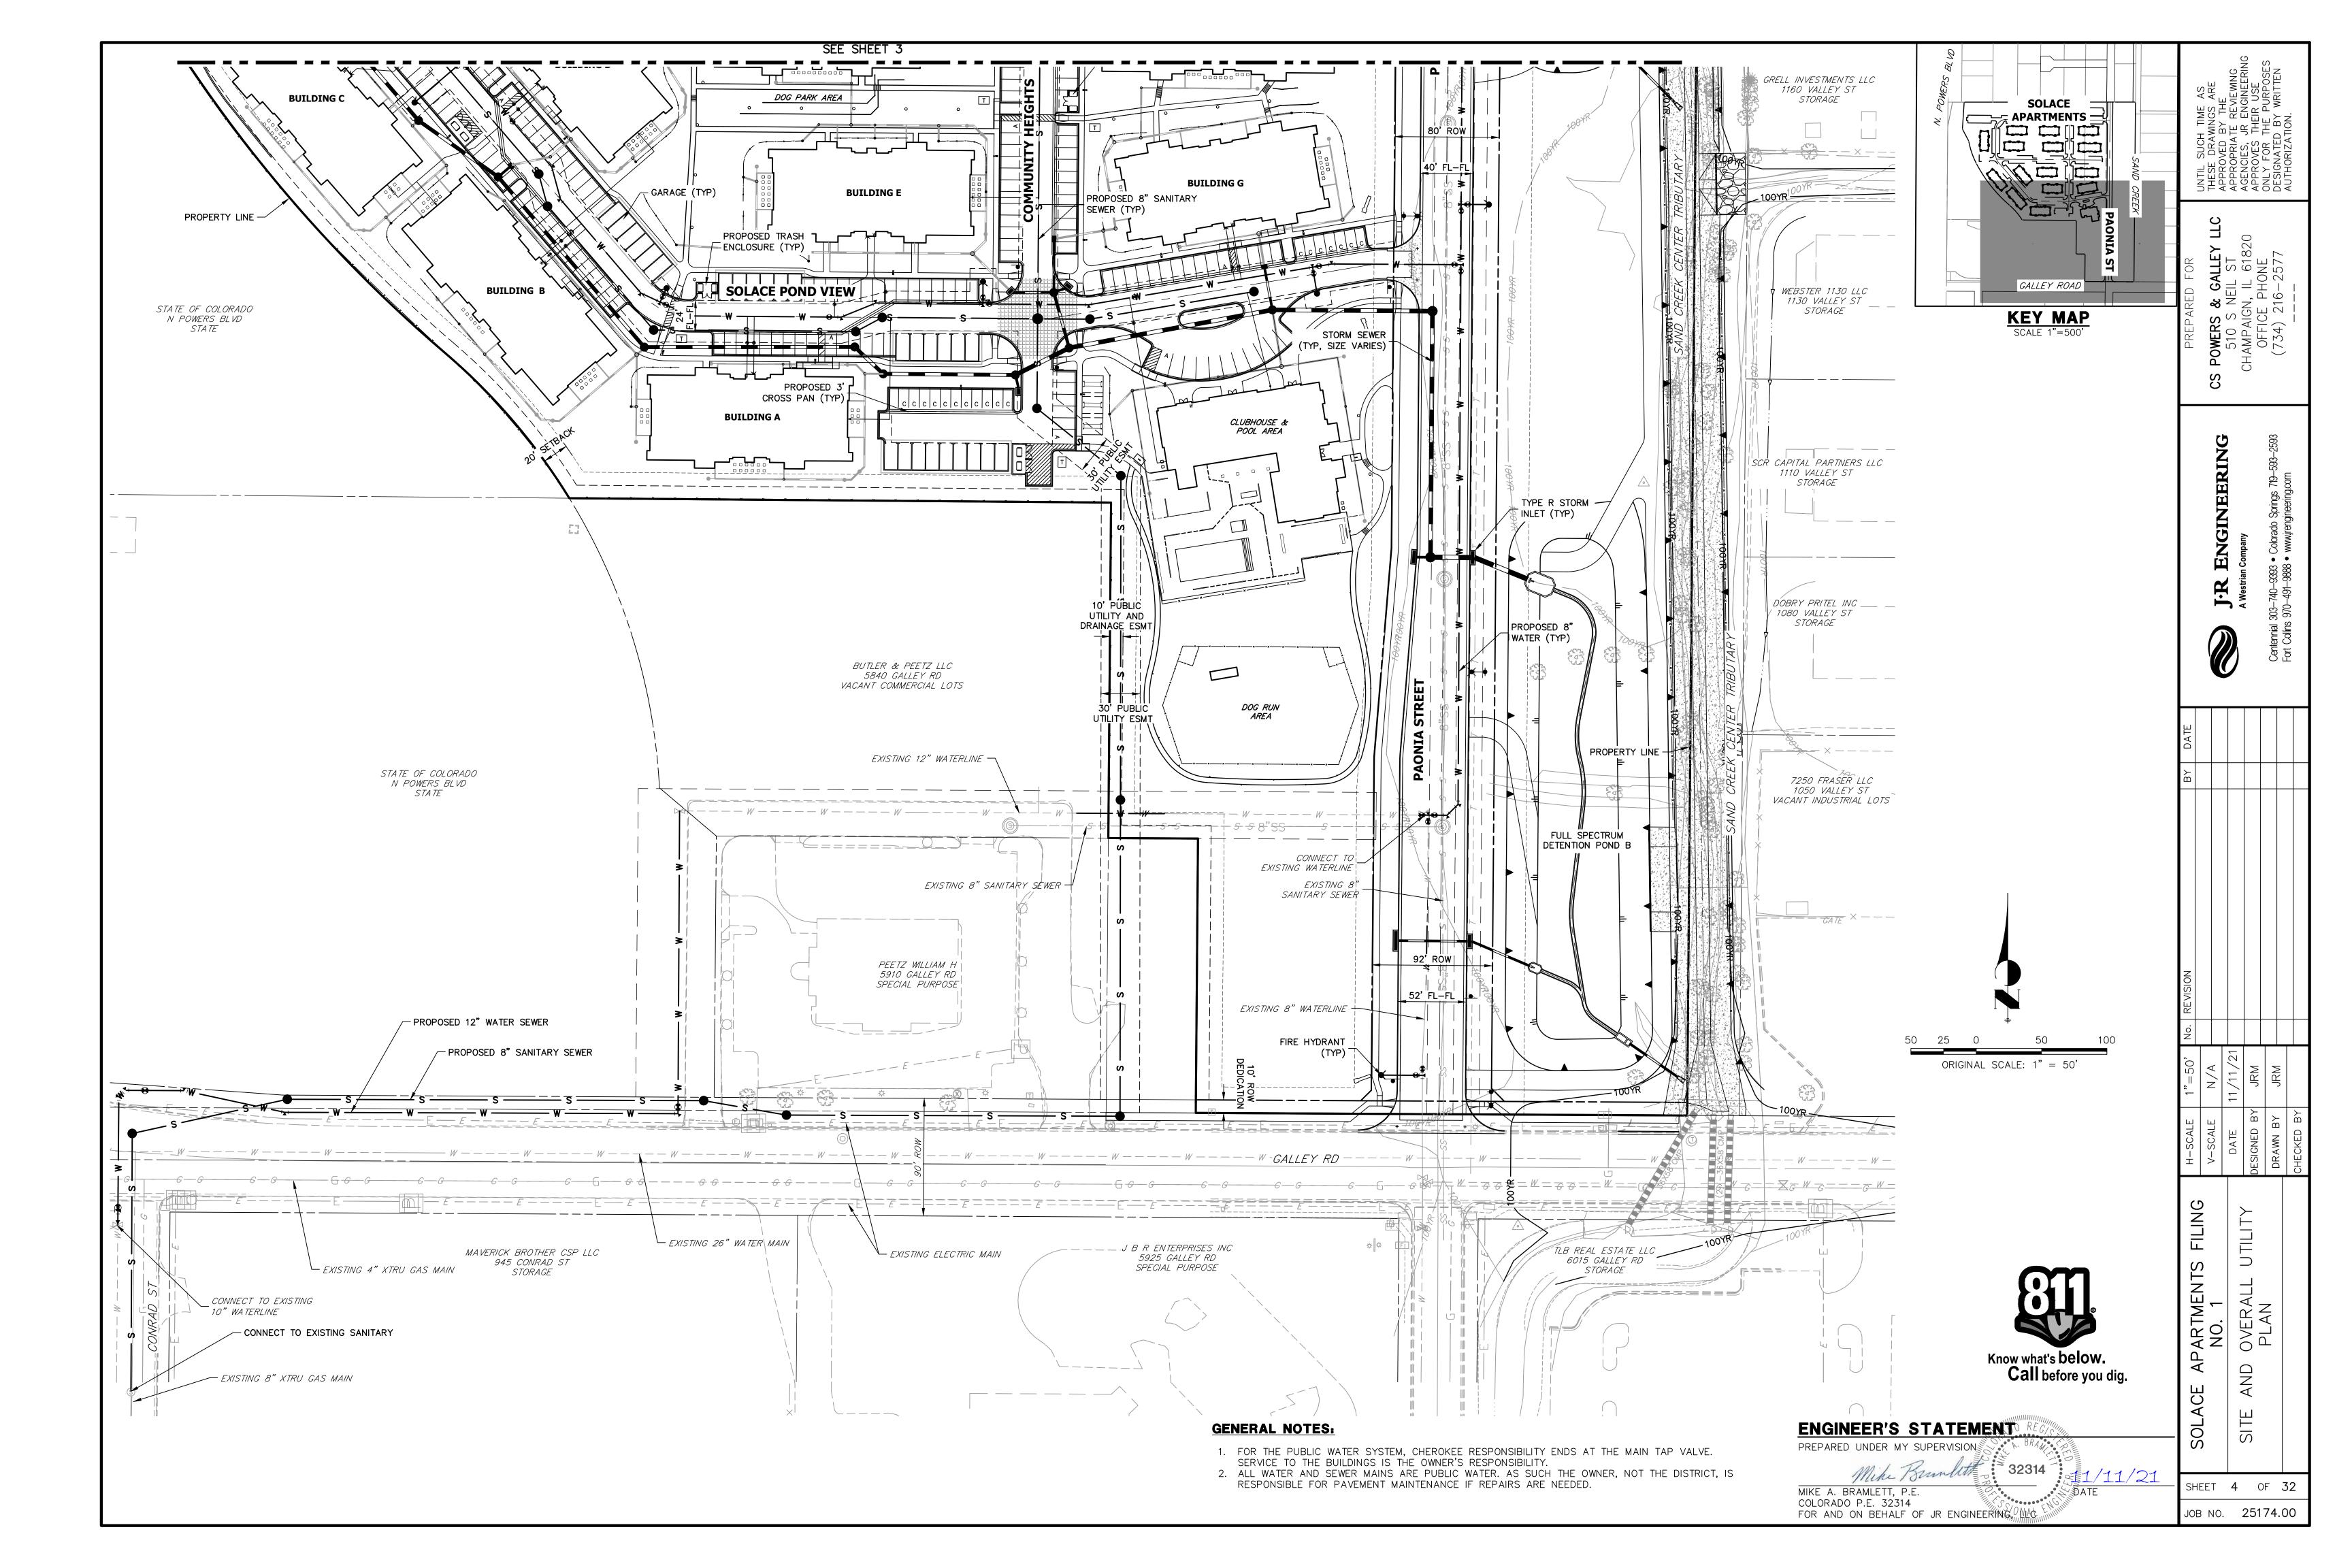
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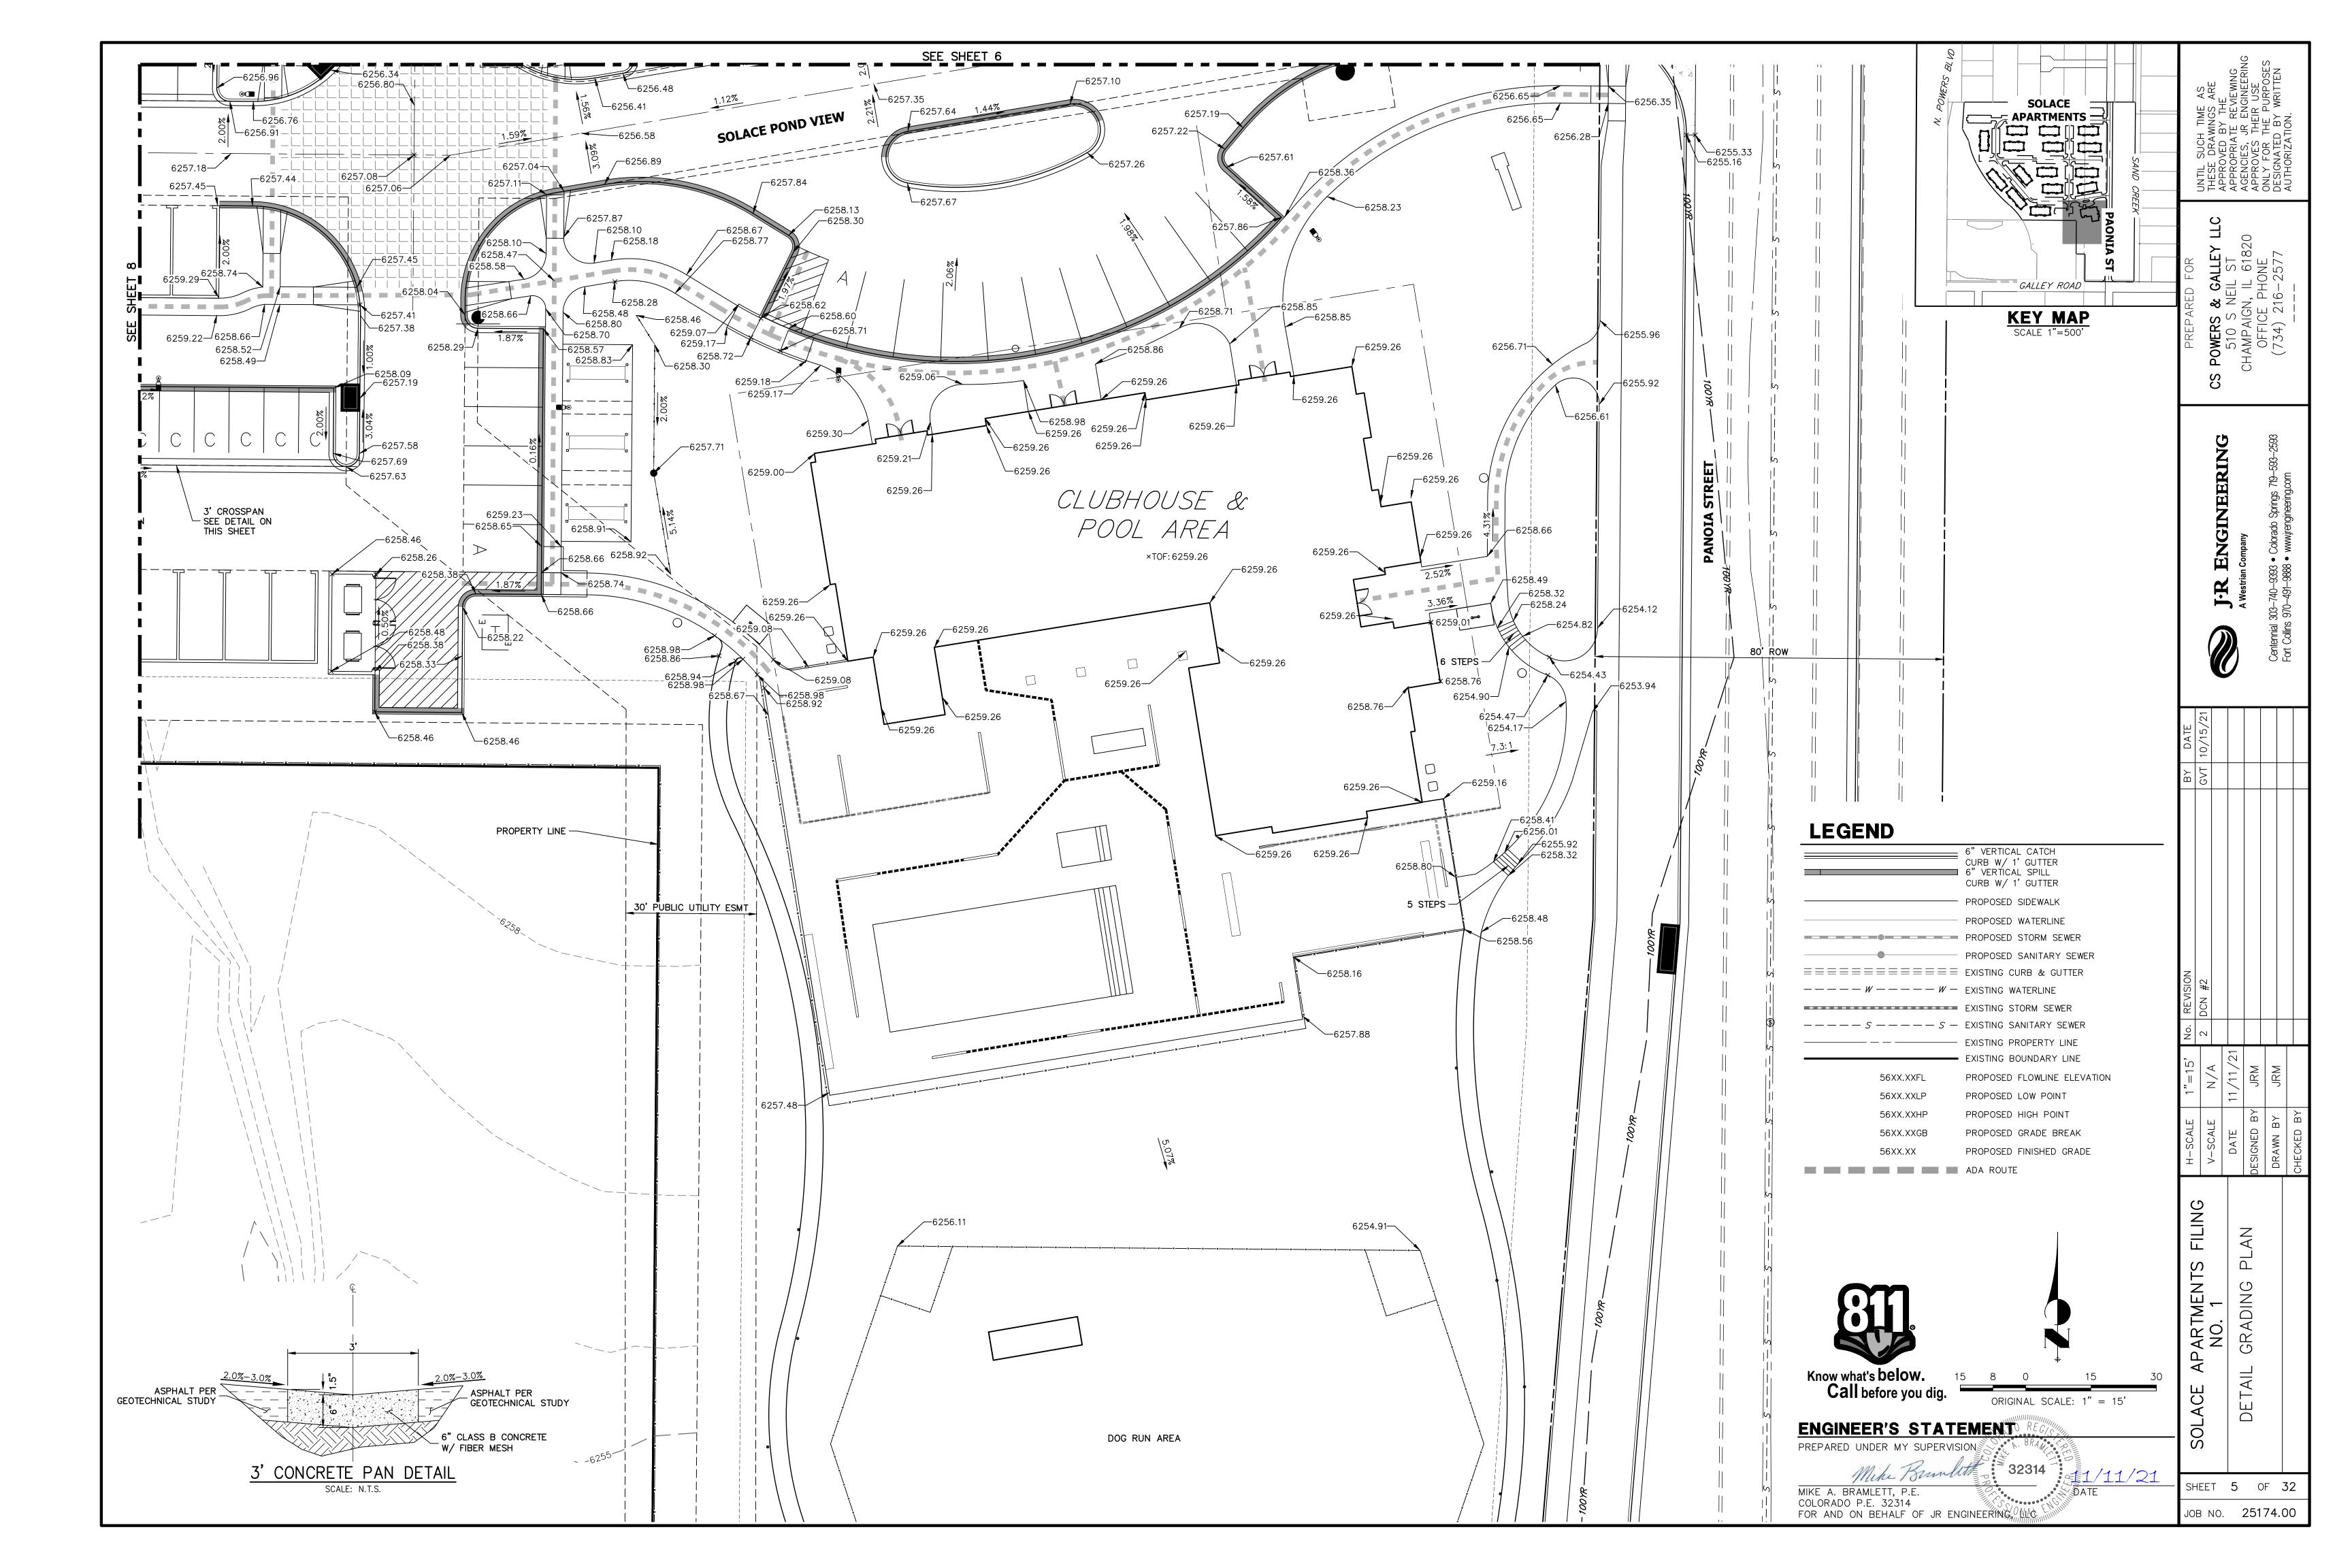
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MONUMENTATION LEGEND	DRAINAGE REPORT PLANS	LANDSCAPE LEGEND	E AS S ARE HE FIE VIEWIT VICE VICE WRITTI
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(ALTERNATE 3)	ANALISYS POINT		PRE 510 510 0FF 0FF (734)
(ALTERNATE 4)	BASIN DESIGNATION		d 7
(ALTERNATE 5)	(HISTORIC)		CS
(ALTERNATE 6)	\frown		
(ALTERNATE 7)	BASIN DESIGNATION (# (DEVELOPED) #.#		3-2593 NG
NAIL & WASHER – FOUND NAIL & WASHER PANEL – FOUND	SUB-BASIN DESIGNATION		JI9-5 93
PK NAIL – FOUND PK NAIL	(DEVELOPED)		VEF brings neering.
	DRAINAGE PIPE		NGINEER mpany Colorado Springs 719–5 wwwjrengineering.com
ROW MARKER – FOUND	IDENTIFIER		
	DRAINAGE POINT IDENTIFIER (HEXAGONAL) (##)		Se S
SECTION CORNER - SET			Centennial 303-740-9 Fort Collins 970-491-6
QUARTER-SECTION CORNER - SET	DRAINAGE POINT IDENTIFIER (TRIANGULAR)		t Collins
SECTION CENTER - FOUND	SWMM DESIGNATION 1 #		Lec U
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	SWMM DESIGNATION 3 $\langle \# \rangle$		
	SWMM DESIGNATION 4		
AND STRIPING NOTES			
AND PAVEMENT MARKING SHALL BE IN COMPLIANCE WITH THE UNIFORM TRAFFIC CONTROL DEVICES (MUTCD).	CURRENT		
F EXISTING PAVEMENT MARKINGS SHALL BE ACCOMPLISHED B NOT MATERIALLY DAMAGE THE PAVEMENT. THE PAVEMENT M			NISION
TO THE EXTENT THEY WILL NOT BE VISIBLE UNDER DAY OR AT NO TIME WILL IT BE ACCEPTABLE TO PAINT OVER EXISTI	NIGHT		REV
ION FROM THE STRIPING AND SIGNING PLAN SHALL BE APPRO	VED BY EL		ÖZ
TY PLANNING AND COMMUNITY DEVELOPMENT. SHO9WN ON THE SIGNING AND STRIPING PLANN SHALL BE NE	/ SIGNS.		N/A N/A JRM JRM JRM
GNS MAY REMAIN OR BE REUSED IF THEY MEET CURRENT EL STANDARDS.			N N/ N/ N/ N/ N/ N/
ME AND REGULATORY STOP SIGNS SHALL BE ON THE SAME P DNS.	ST AT		LE BY BY
ED SIGNS SHALL BE DISPOSED OF IN A PROPER MANNER BY R.	HE		H-SCAL V-SCAL DATE DESIGNED DRAWN E CHECKED
NAME SIGNS SHALL BE "D" SERIES LETTERS, WITH LOCAL ROPPER-LOWER CASE LETTERING ON 8" BLANK AND NON-LOCA			DESI CHE
G 6" LETTERING. UPPER-LOWER CASE ON 12" BLANK, WITH A T RECESSED. MULTI-LANE ROADWAYS WITH SPEED LIMITS OF	WHITE BORDER HO MPH OR		S
ALL HAVE 8" UPPER-LOWER CASE LETTERING ON 18" BLANK ' AT IS NOT RECESSED. THE WIDTH OF THE NON-RECESSED WH CH PAGE 255 OF THE 2012 MUTCD "STANDARD HIGHWAY SIGN	TE BORDERS		
C SIGNS SHALL HAVE A MINIMUM HIGH INTENSITY PRISMATIC (RADE SHEETING.		
RESIDENTIAL STREET SIGNS SHALL BE MOUNTED ON A 1.75" POST AND STUB POST BASE,. FOR OTHER APPLICATIONS, REF DARD S–614–8 REGARDING USE OF THE P2 TUBULAR STEEL	IR TO THE		NTS OTE
SHALL BE SINGLE SHEET ALUMINUM WITH 0.100" THICKNESS.			ARTMEN NO. 1 D & NC
A MINIMUM 125 MIL THICKNESS PREFORMED THERMOPLASTIC P WITH TAPERED LEADING EDGES PER CDOT STANDARD S-627- RKINGS SHALL BE THE NARROW TYPE, STOP BARS SHALL BE	VEMENT . WORD AND 24" IN WIDTH,	Know what's below. Call before you dig.	
LINES SHALL BE 12" WIDE AND 8' LONG PER CDOT S-627-			CE AI LEGE
JDINAL LINES SHALL BE A MINIMUM 15MIL THICKNESS EPOXY . RESIDENTIAL ROADWAYS SHALL INCLUDE BOTH RIGHT AND LE ND ANY ADDITIONAL STRIPING AS REQUIRED BY CDOT S-627-	FT EDGE LINE I.		
ACTOR SHALL NOTIFY EL PASO COUNTY PLANNING AND COMM NT (719) 520–6819 PRIOR TO AND UPON COMPLETION OF TH		PARED UNDER MY SUPERVISION	- SOL
ACTOR SHALL OBTAIN A WORK IN THE RIGHT OF WAY PERMIT		Mike Bunlith 32314 1/11/21	
TY DEPARTMENT OF PUBLIC WORKS (DPW) PRIOR TO ANY SIG ORK WITHIN AN EXISTING EL PASO COUNTY ROADWAY.	IAGE OR MIK	KE A. BRAMLETT, P.E. LORADO P.E. 32314	- SHEET 2 OF 32
			-


SIGNING

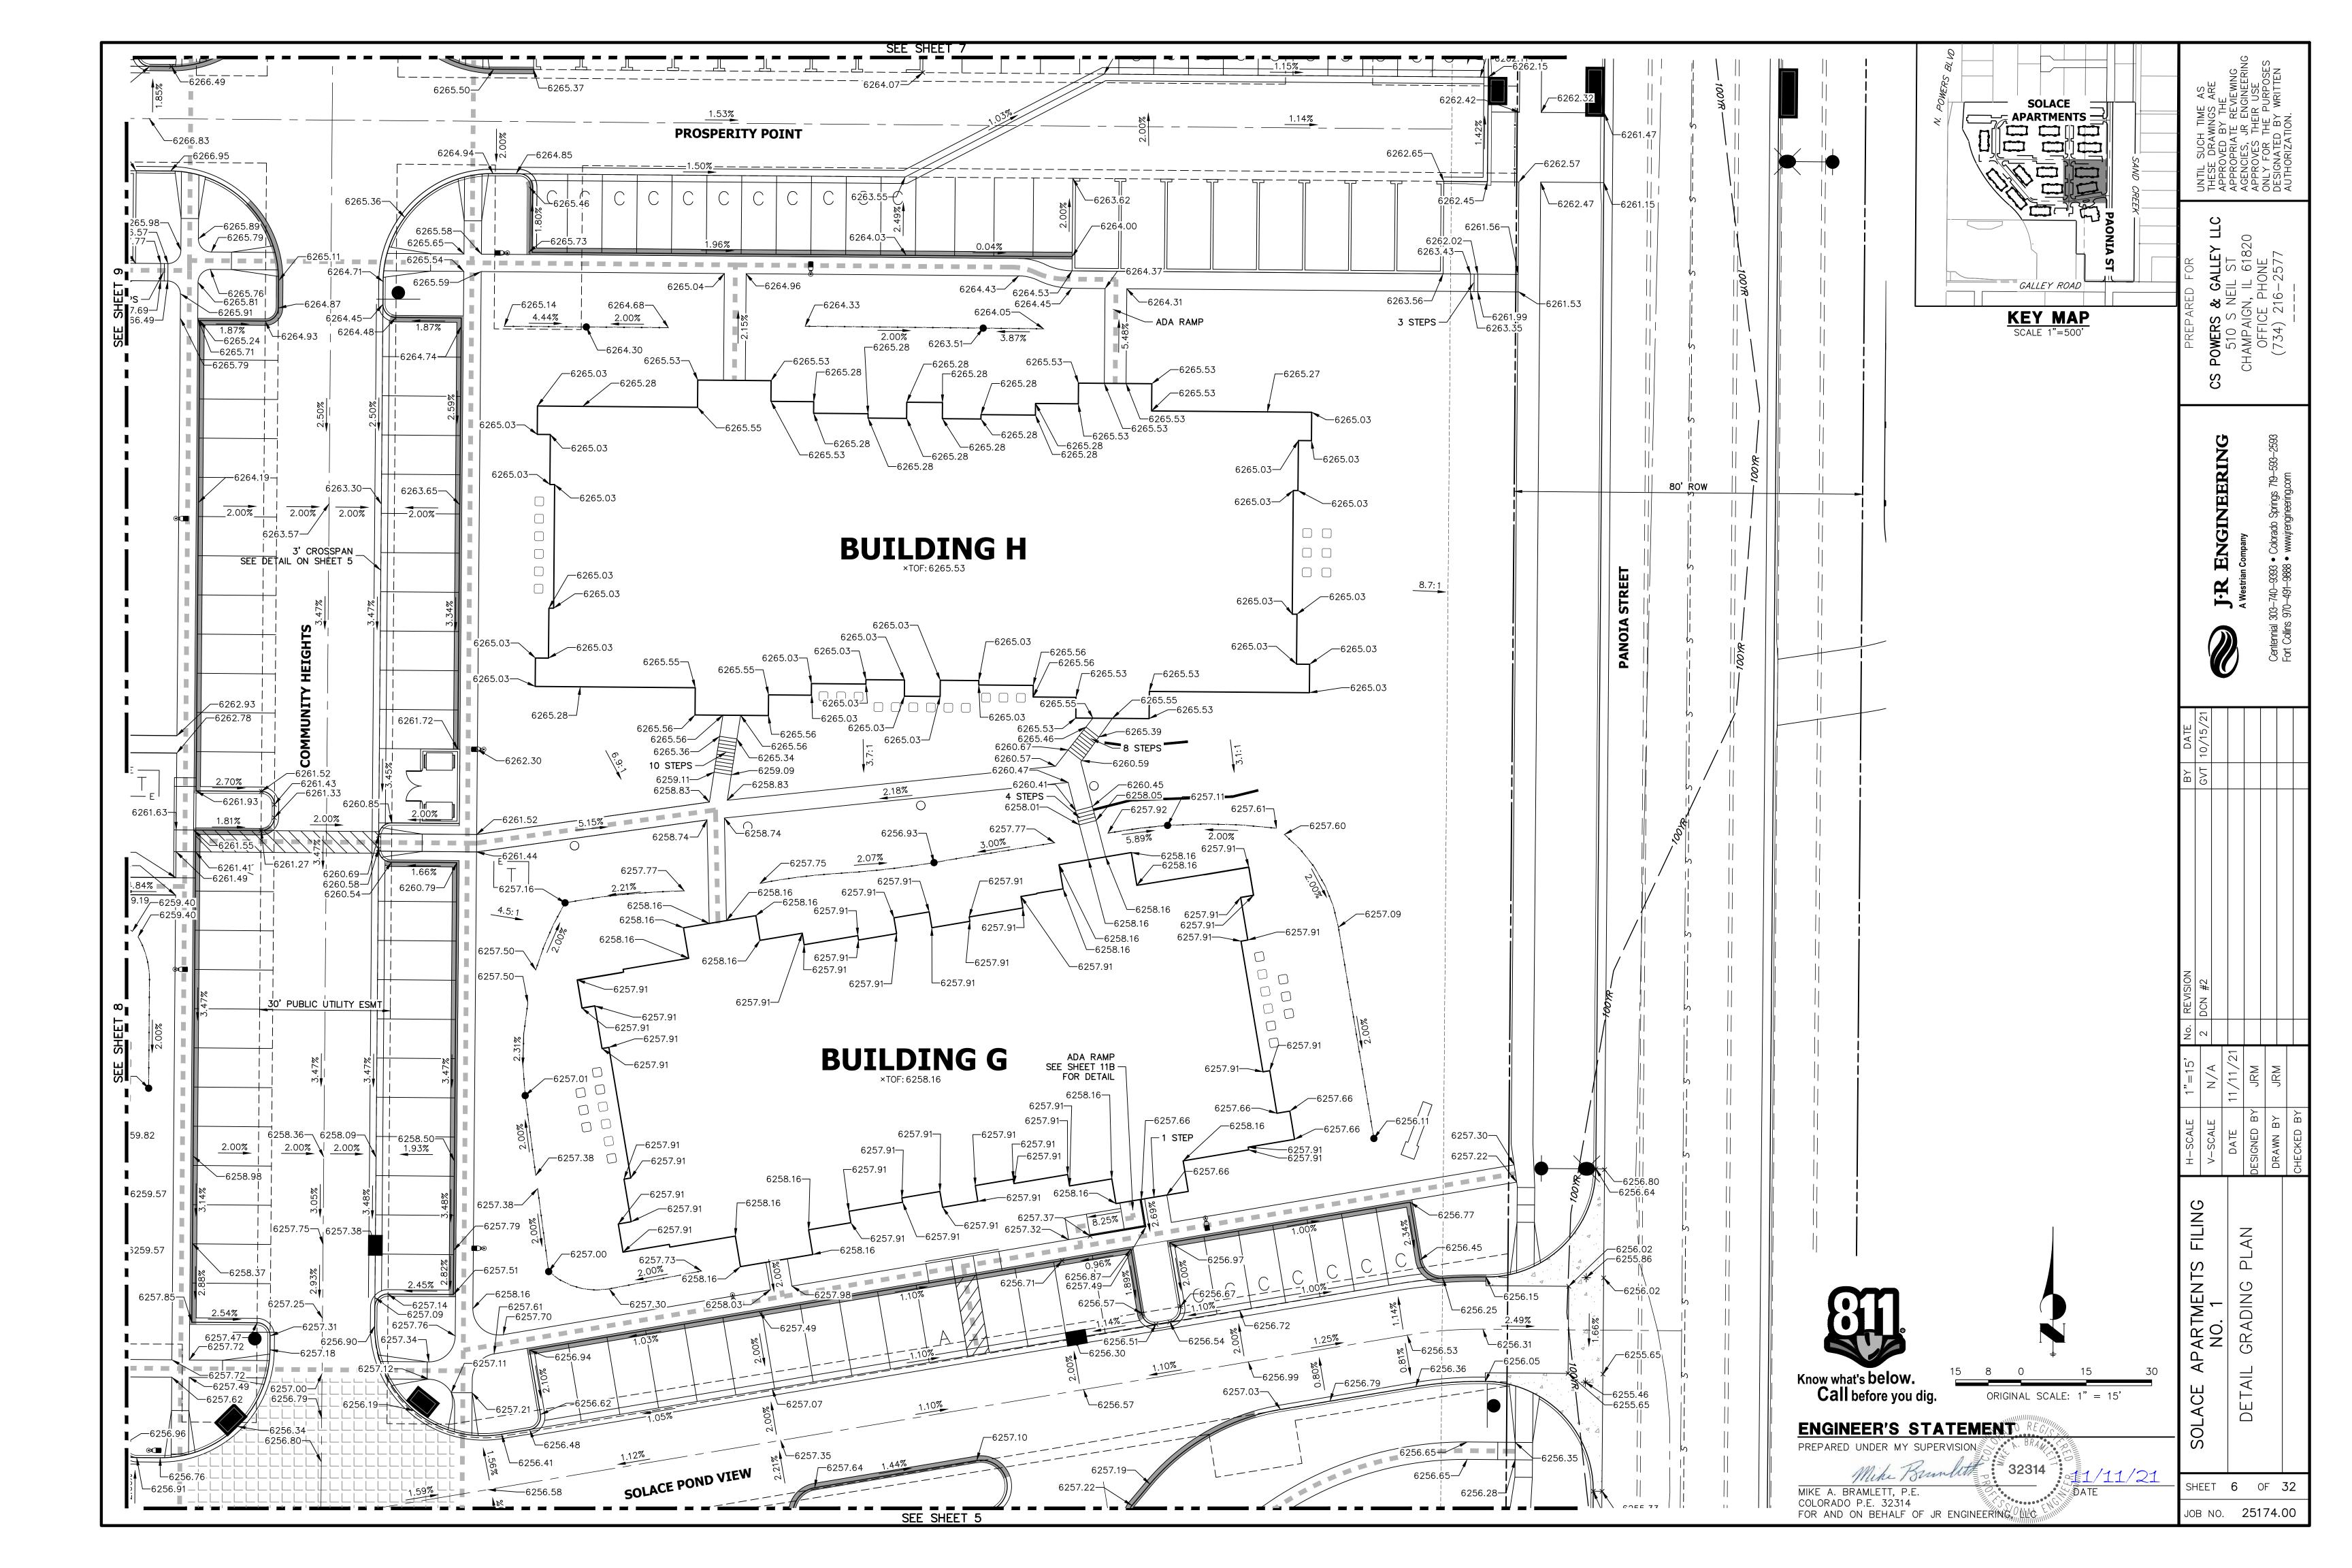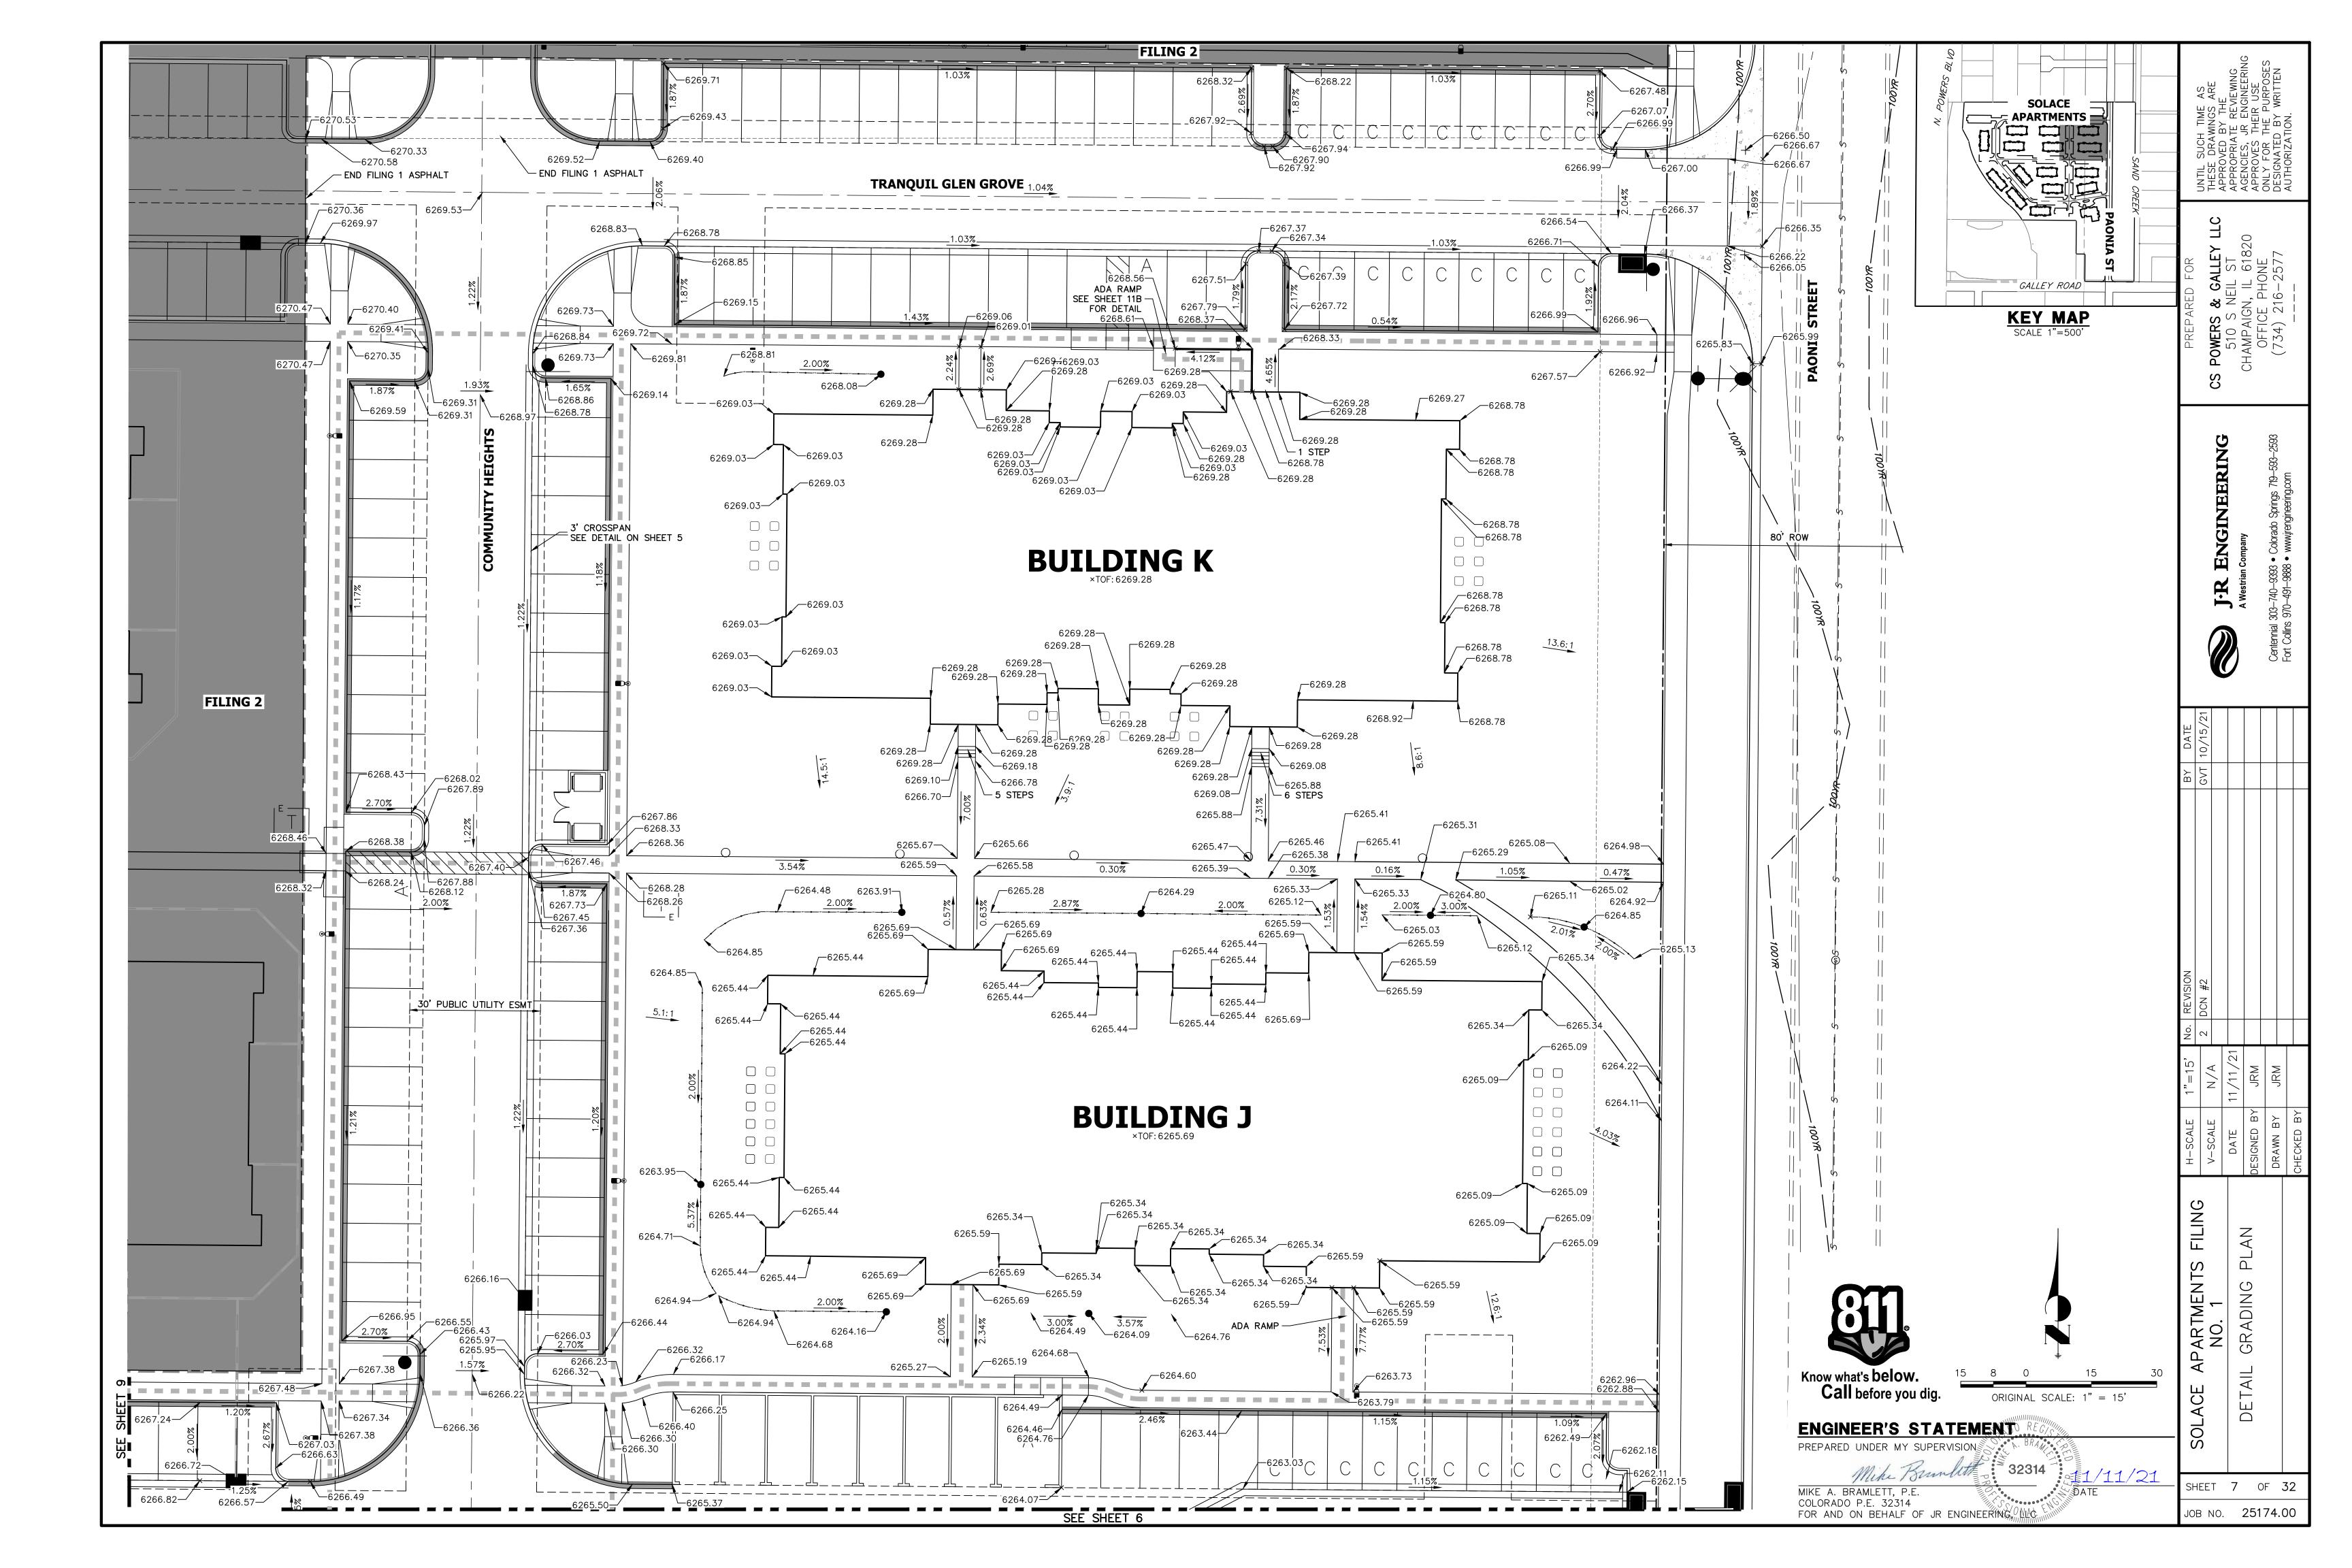
- 1. ALL SIGNS AN MANUAL ON U
- 2. REMOVAL OF E THAT DOES NO BE REMOVED CONDITIONS. A MARKINGS.
- 3. ANY DEVIATION PASO COUNTY
- 4. ALL SIGNS SHO EXISTING SIGNS AND MUTCD S
- 5. STREET NAME INTERSECTIONS
- 6. ALL REMOVED CONTRACTOR.
- 7. ALL STREET NA BEING 4" UPPE SIGNS BEING 6 THAT IS NOT HIGHER SHALL BORDER THAT SHALL MATCH
- 8. ALL TRAFFIC S
- 9. ALL LOCAL RES TUBE SIGN POS CDOT STANDAF DESIGN.
- 10. ALL SIGNS SHA
- 11. ALL LIMIT LINE SHALL BE A M MARKINGS WITH SYMBOL MARKI CROSSWALK LI
- 12. ALL LONGITUDI NON-LOCAL R STRIPING AND
- 13. THE CONTRACT DEVELOPMENT STRIPING.
- 14. THE CONTRACT PASO COUNTY STRIPING WORK

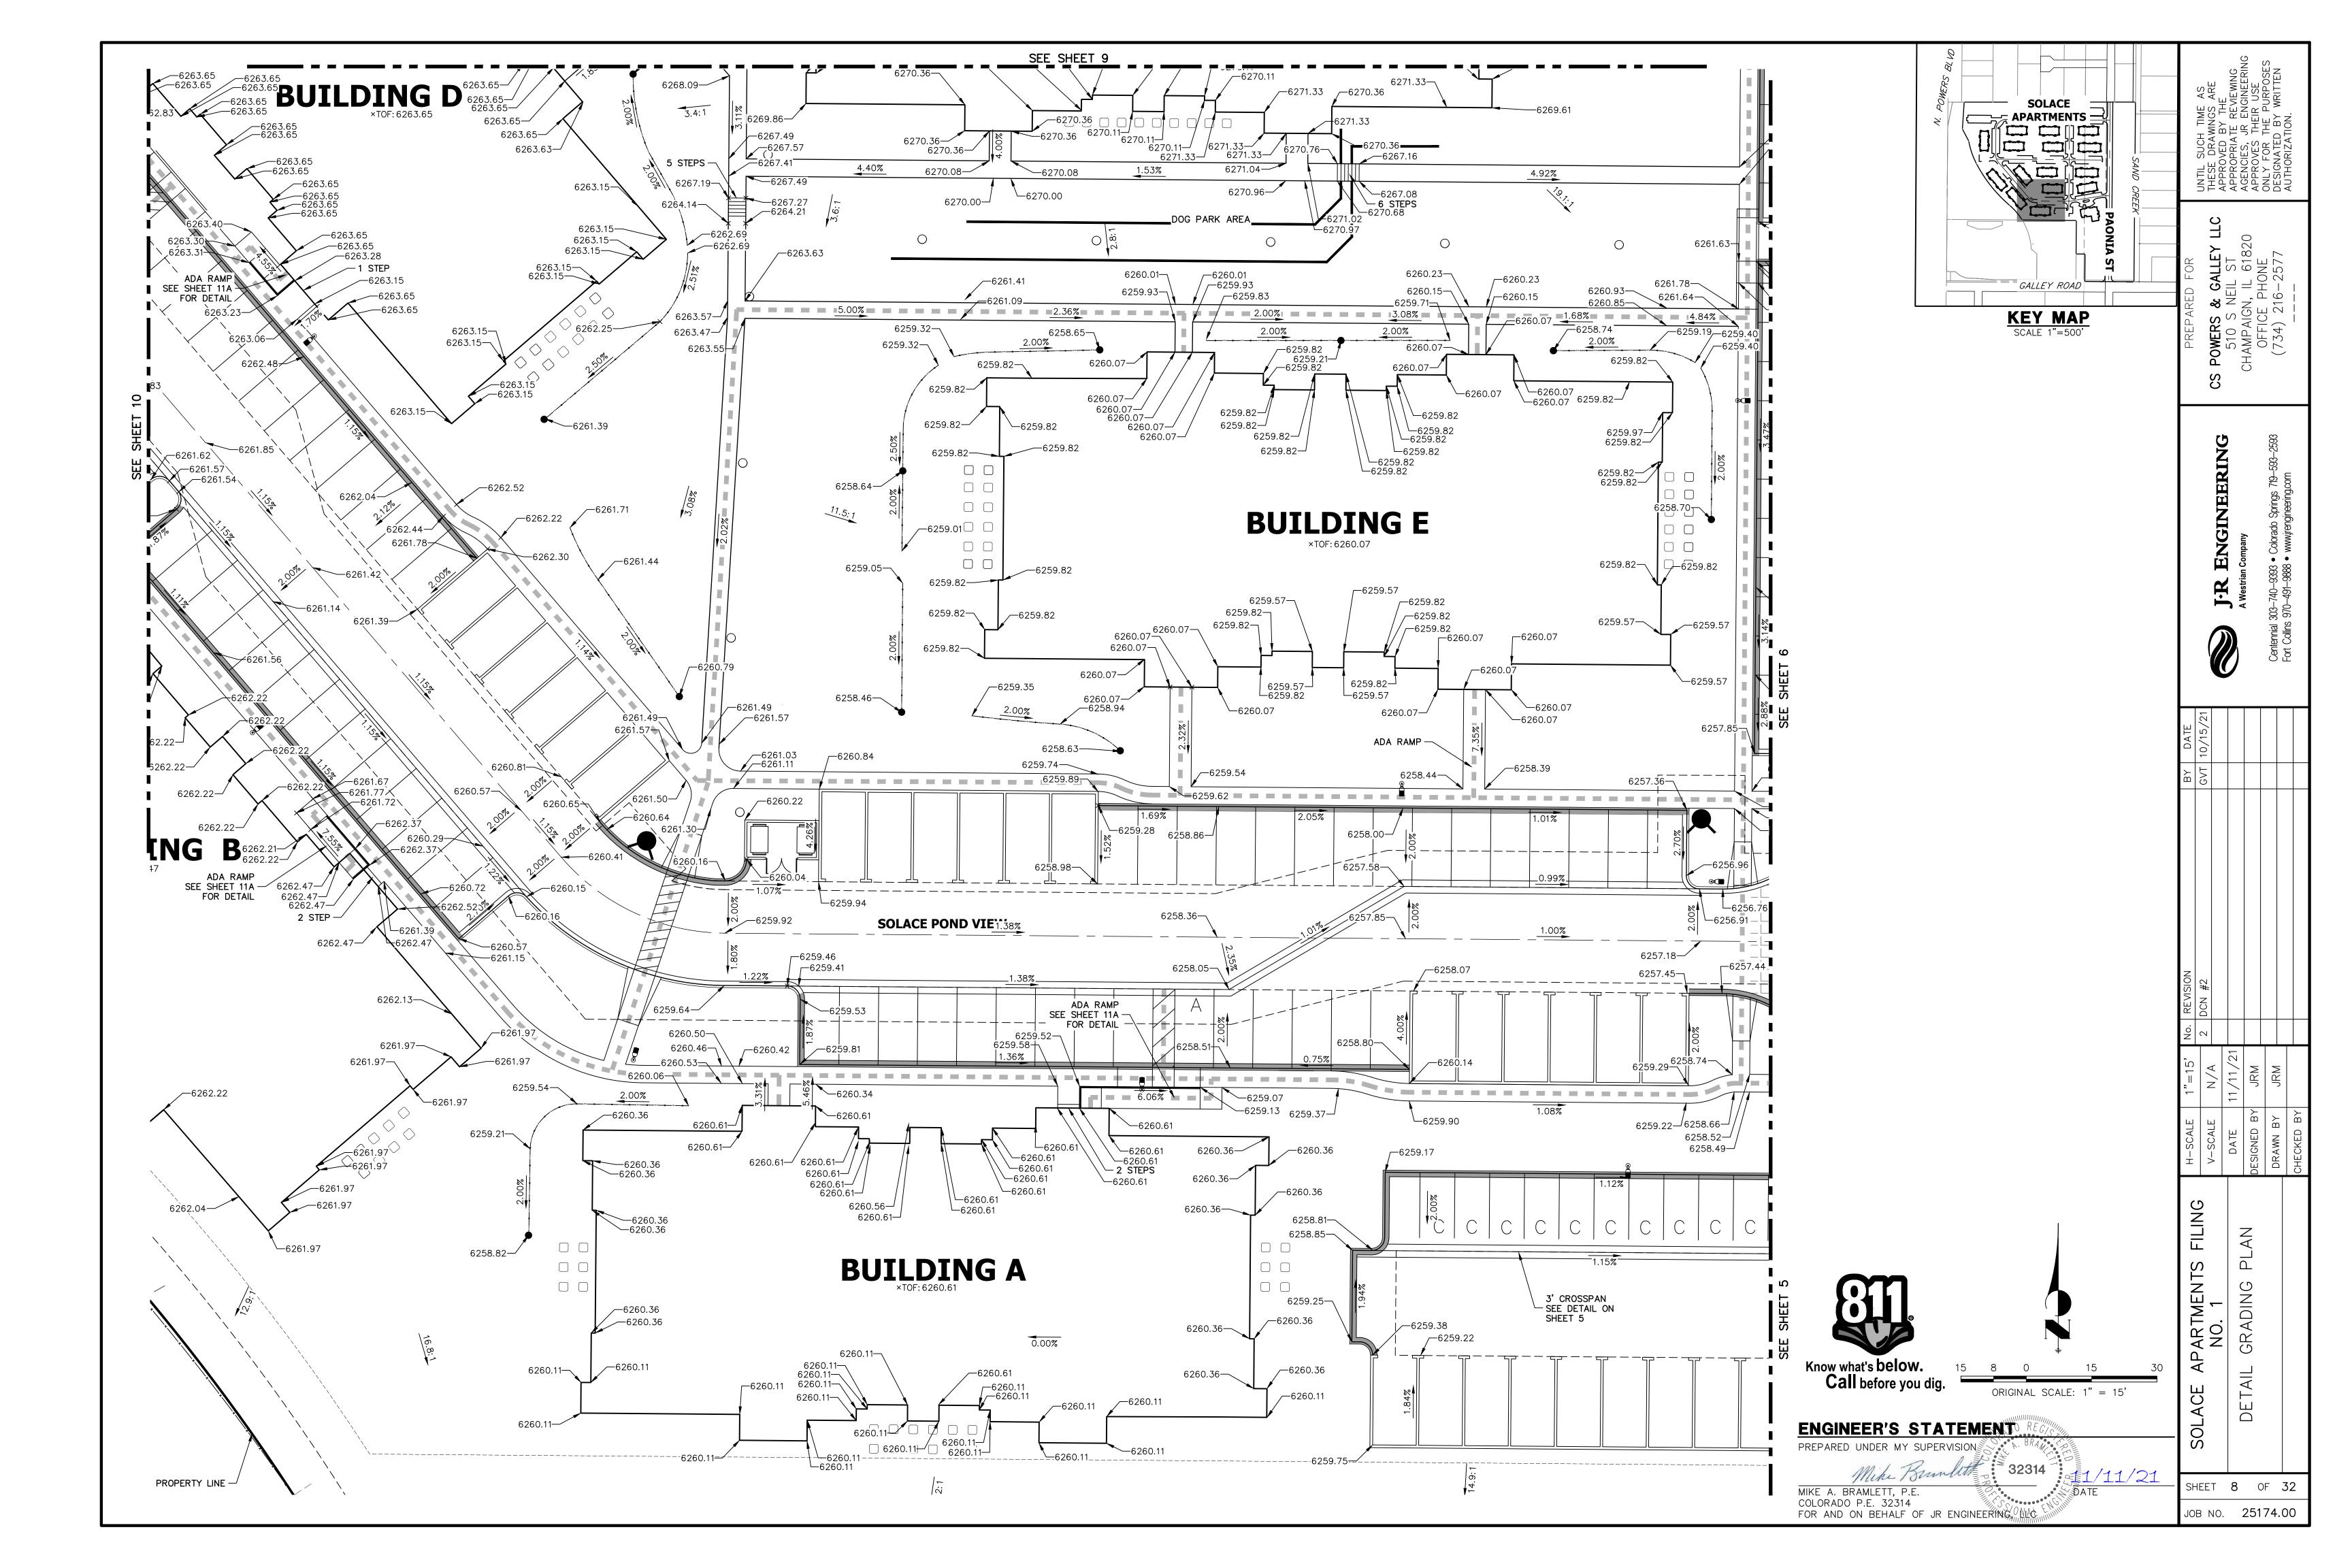


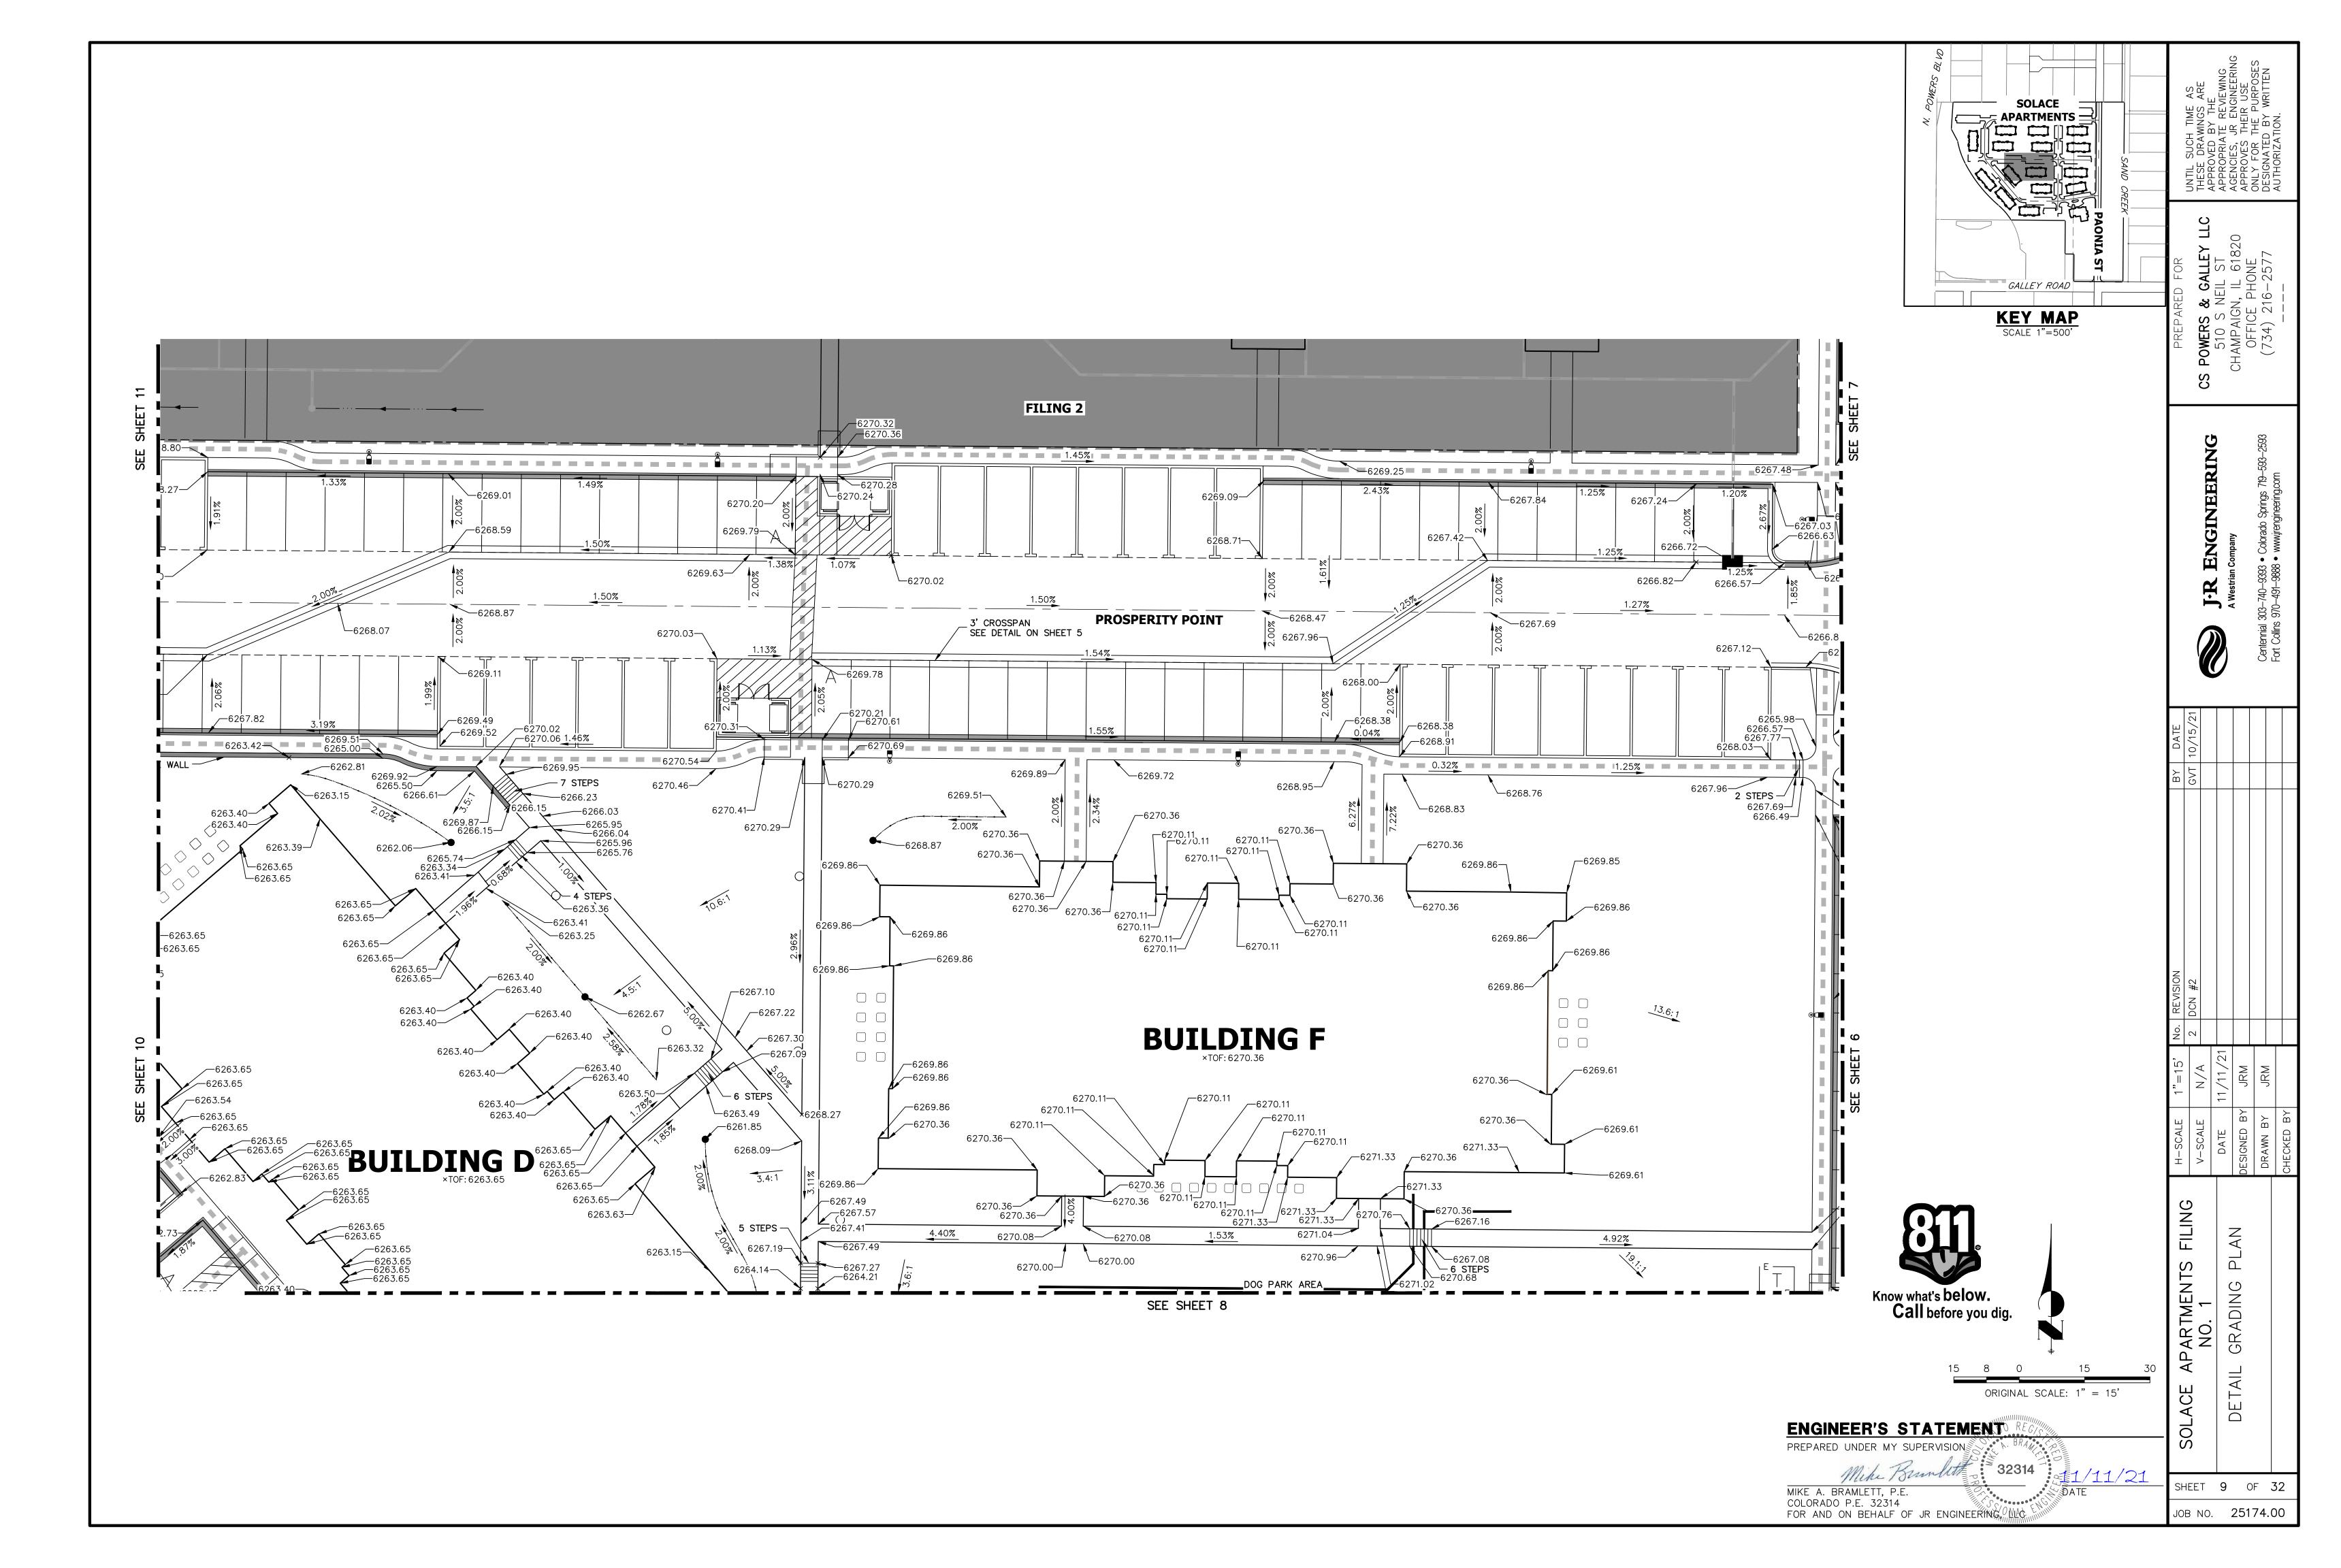


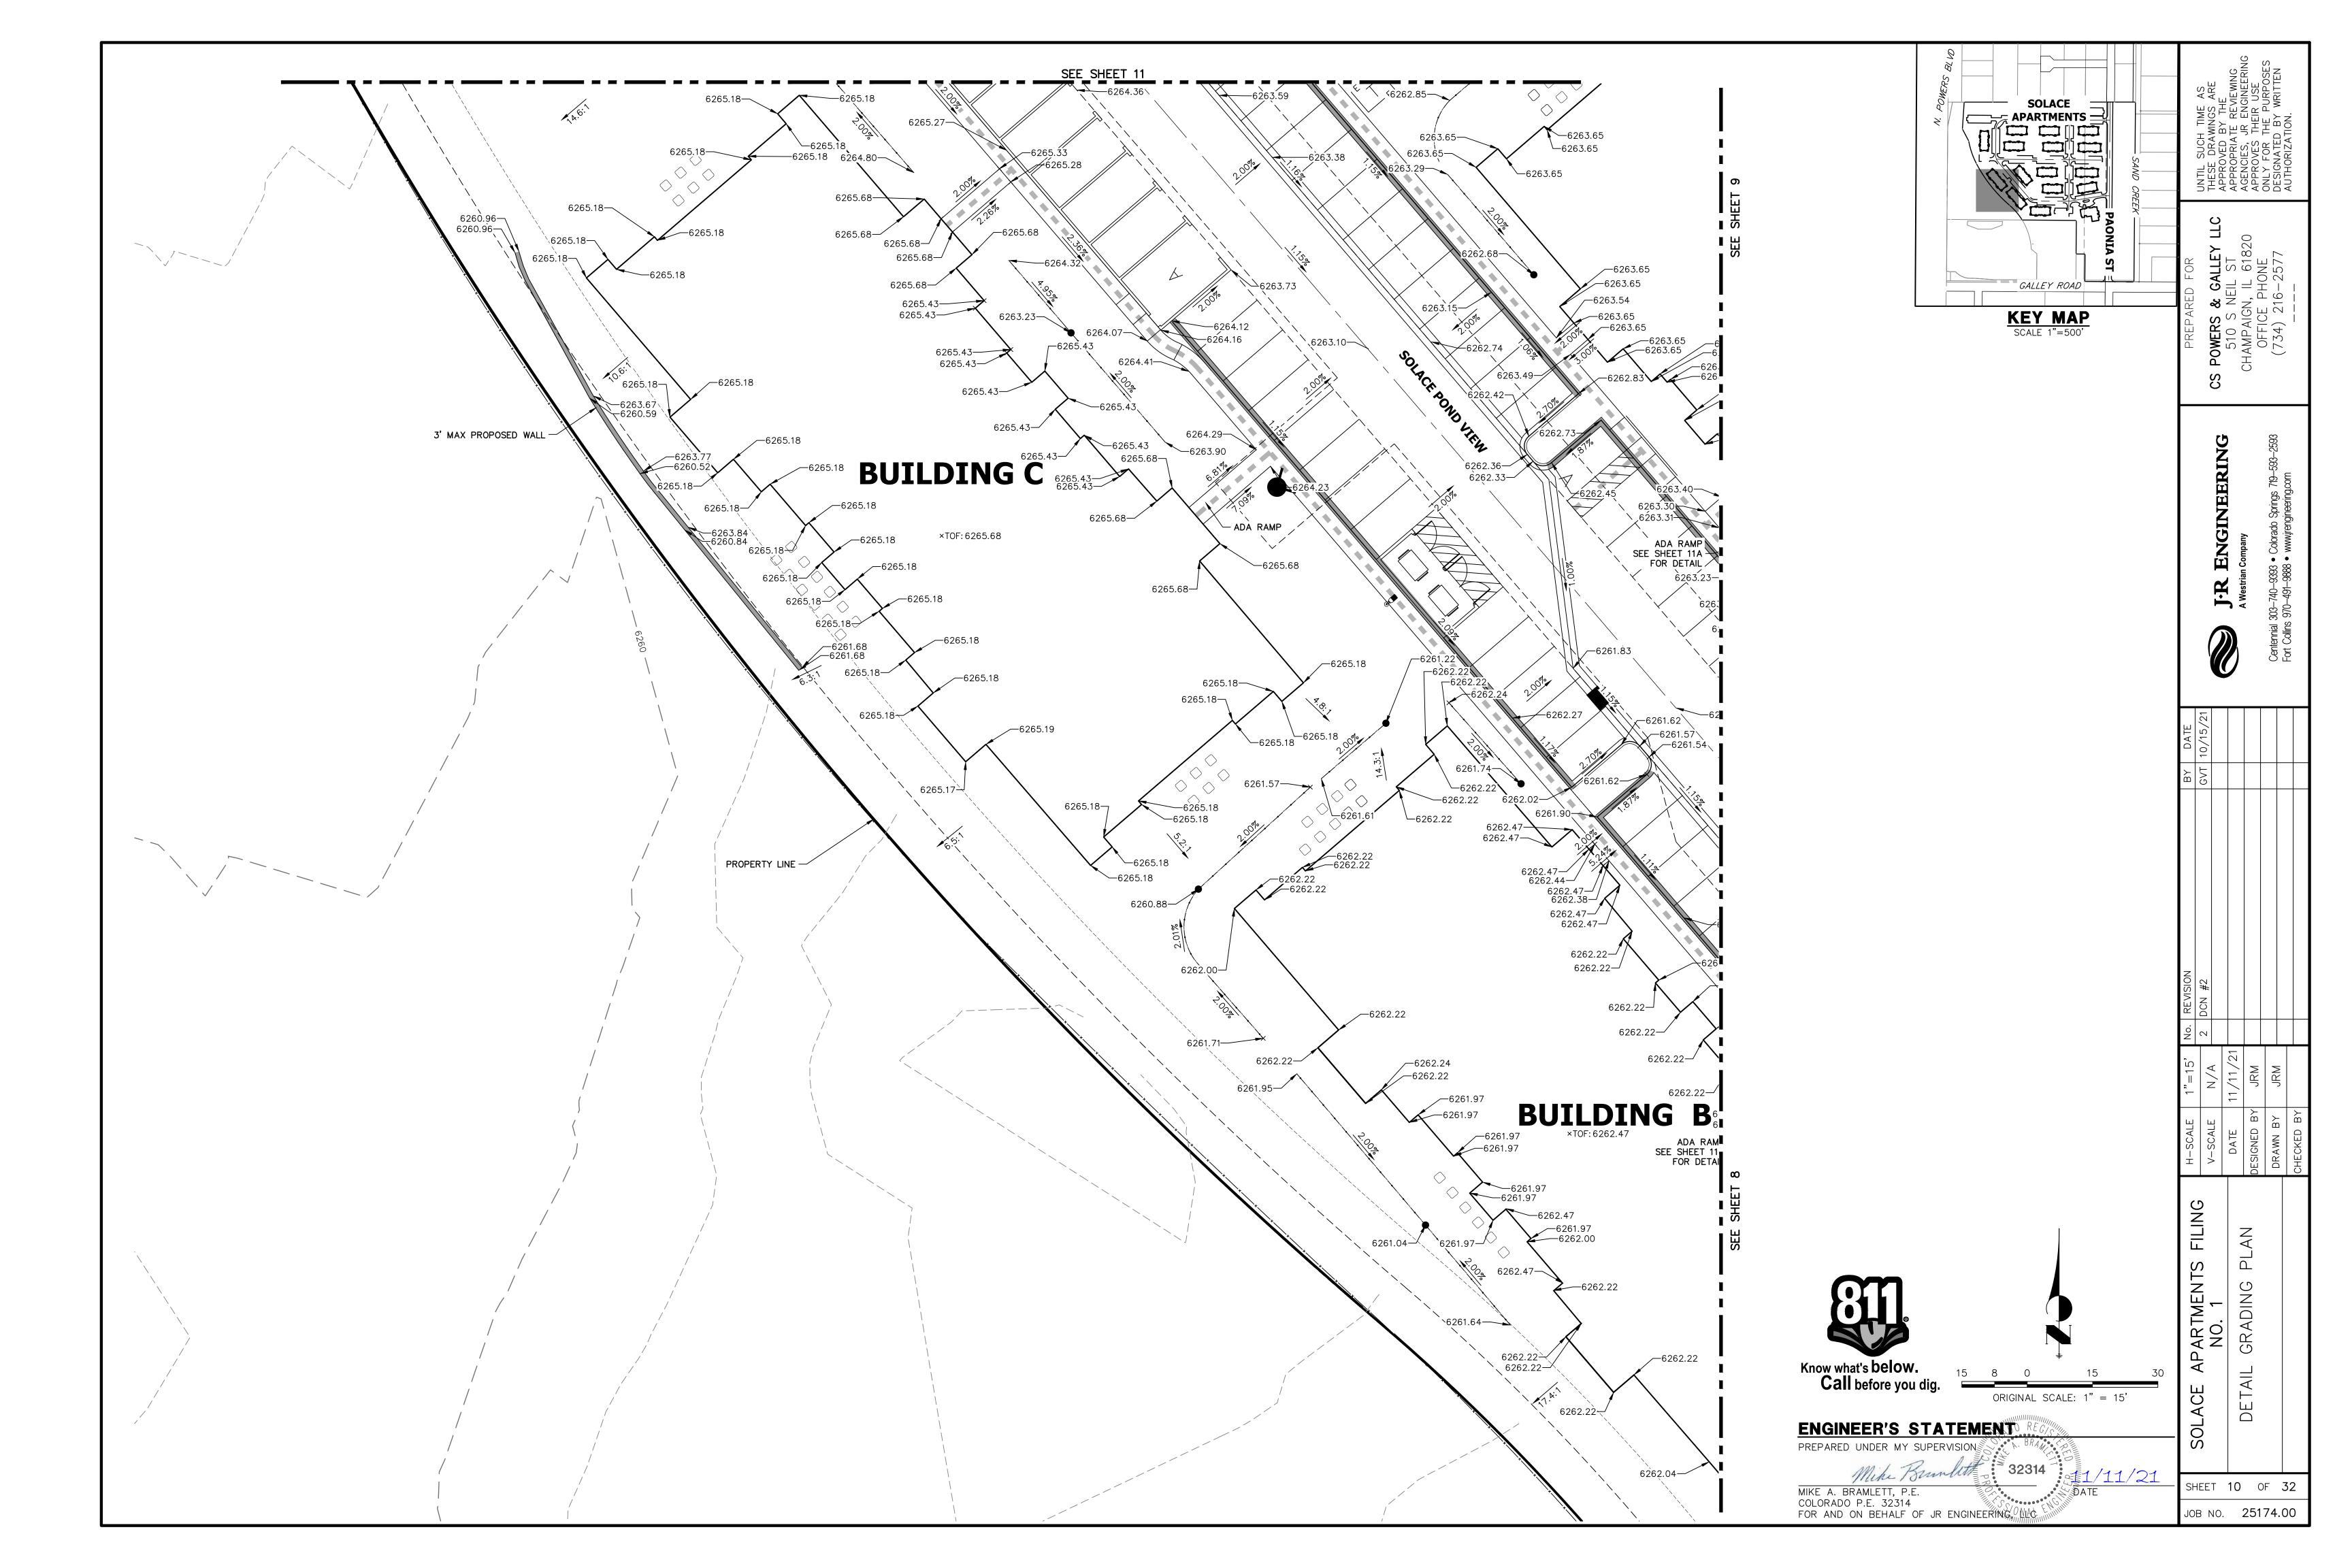


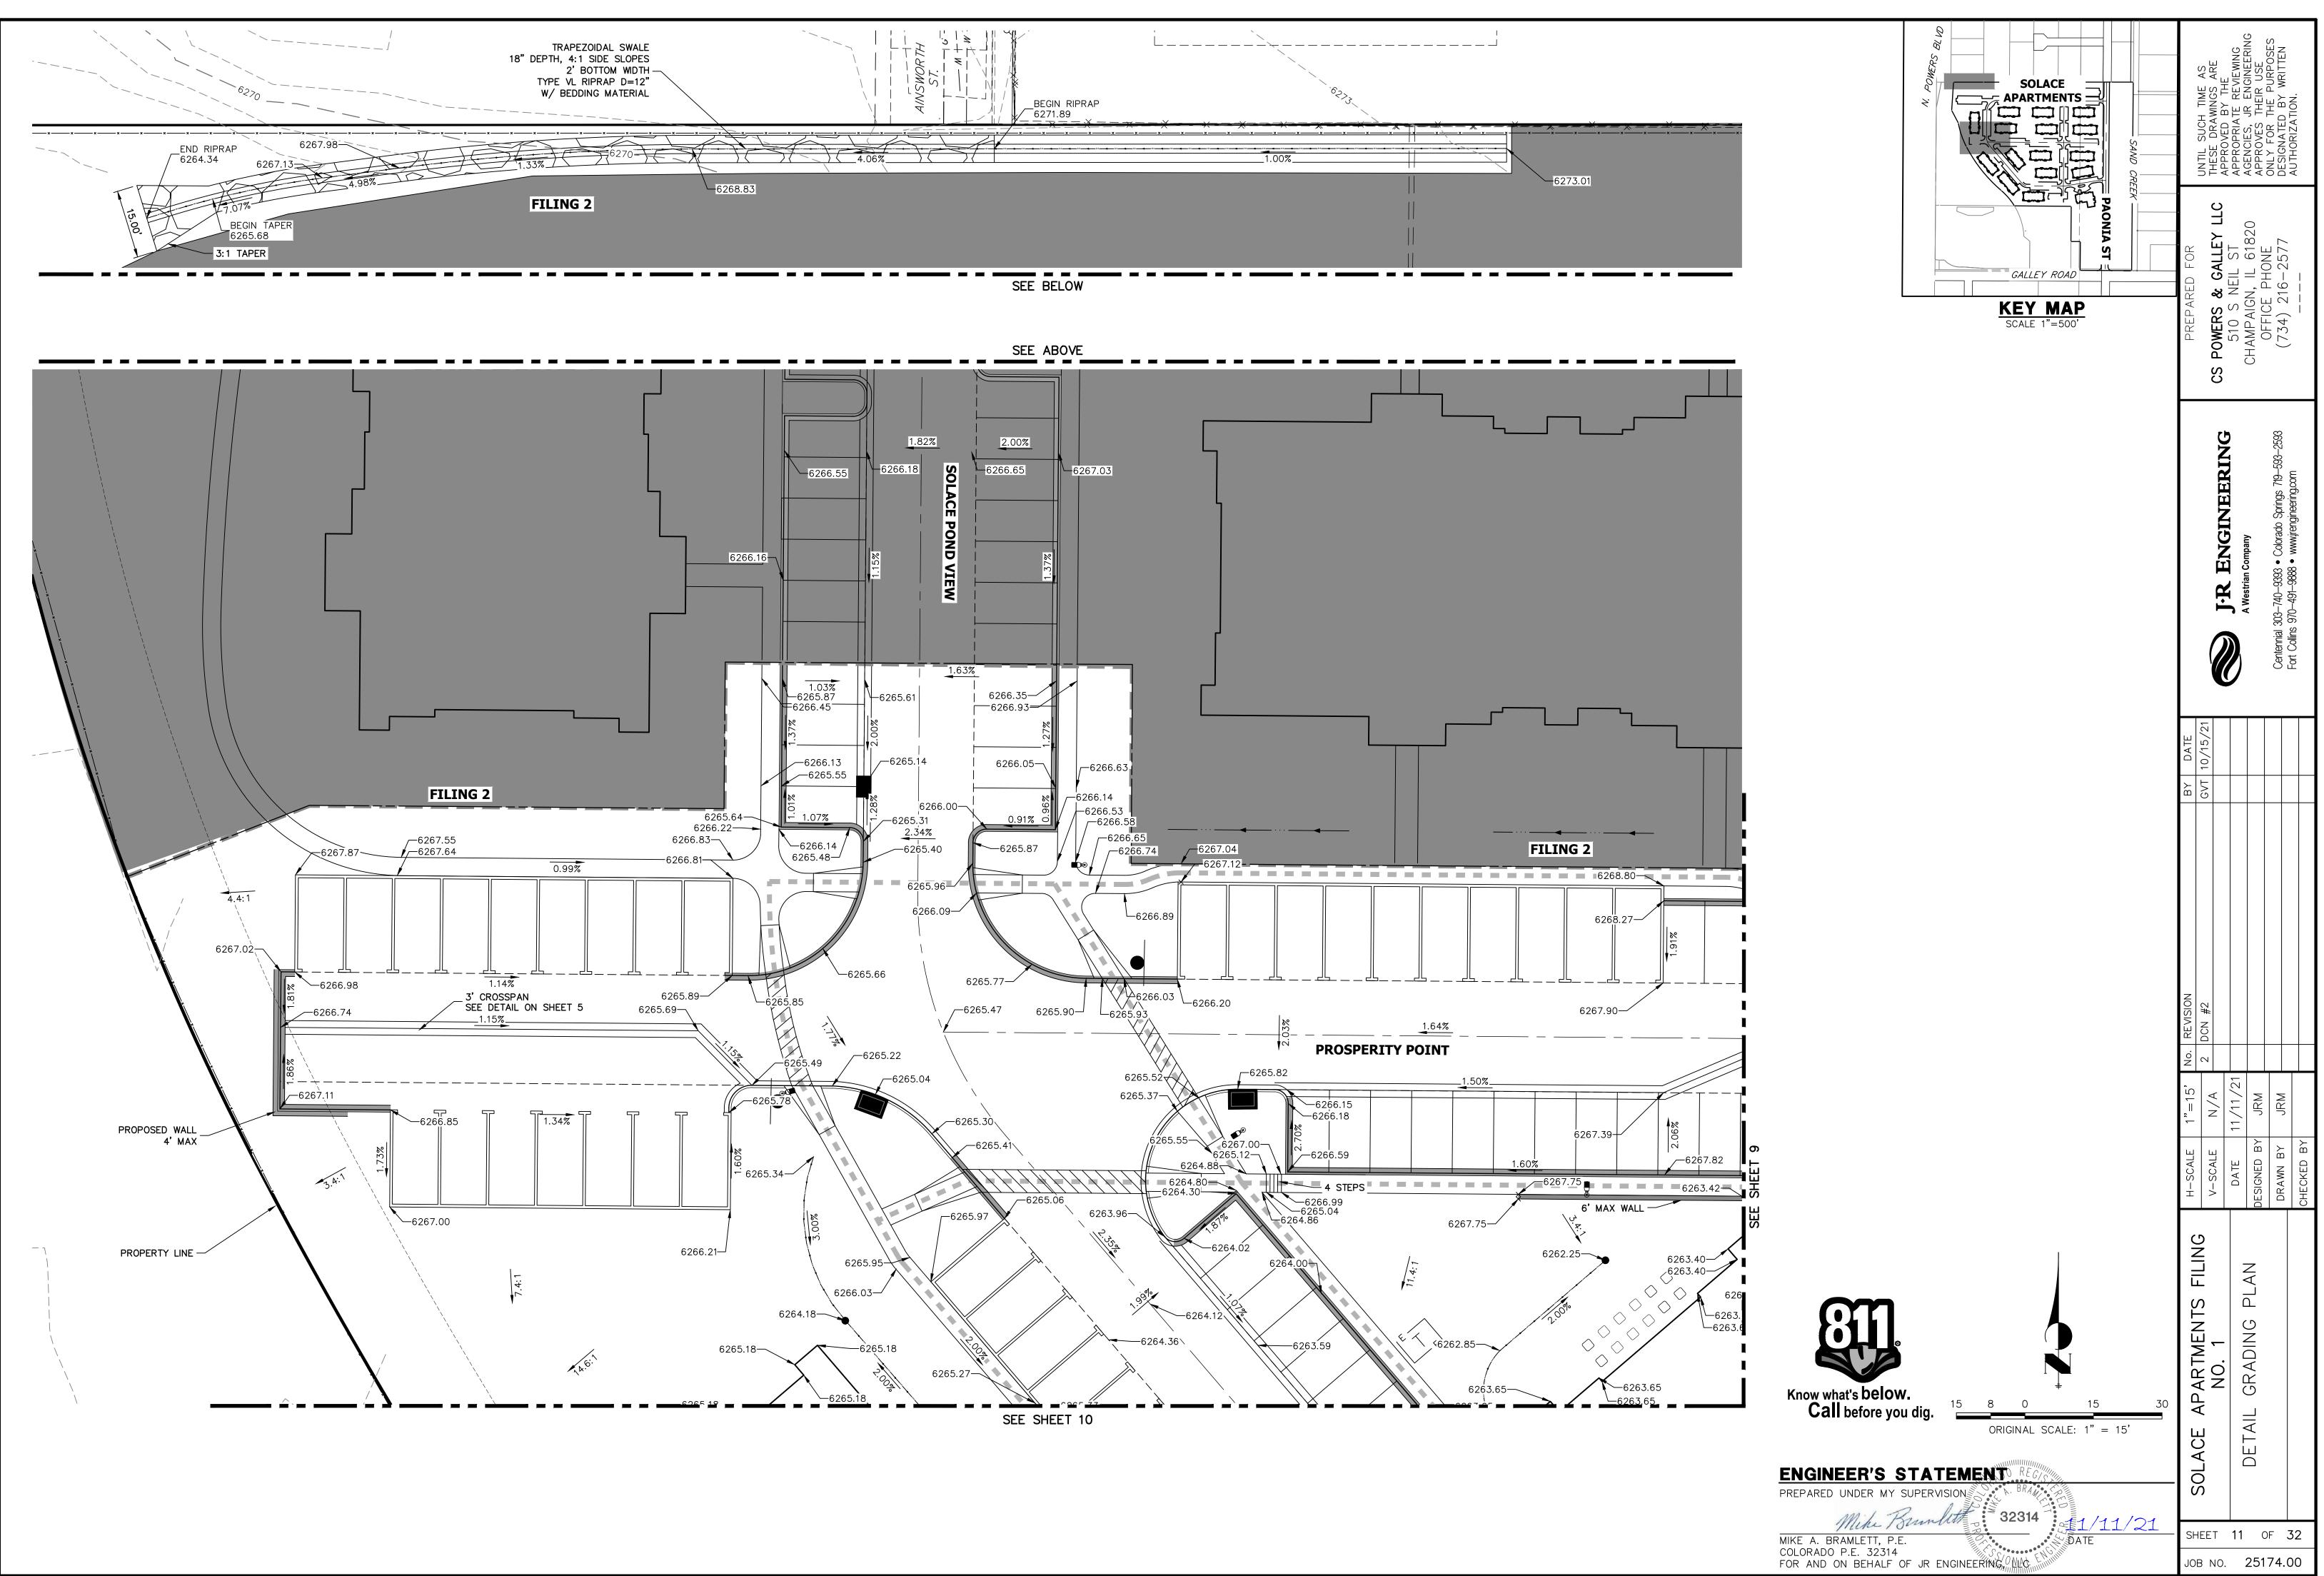


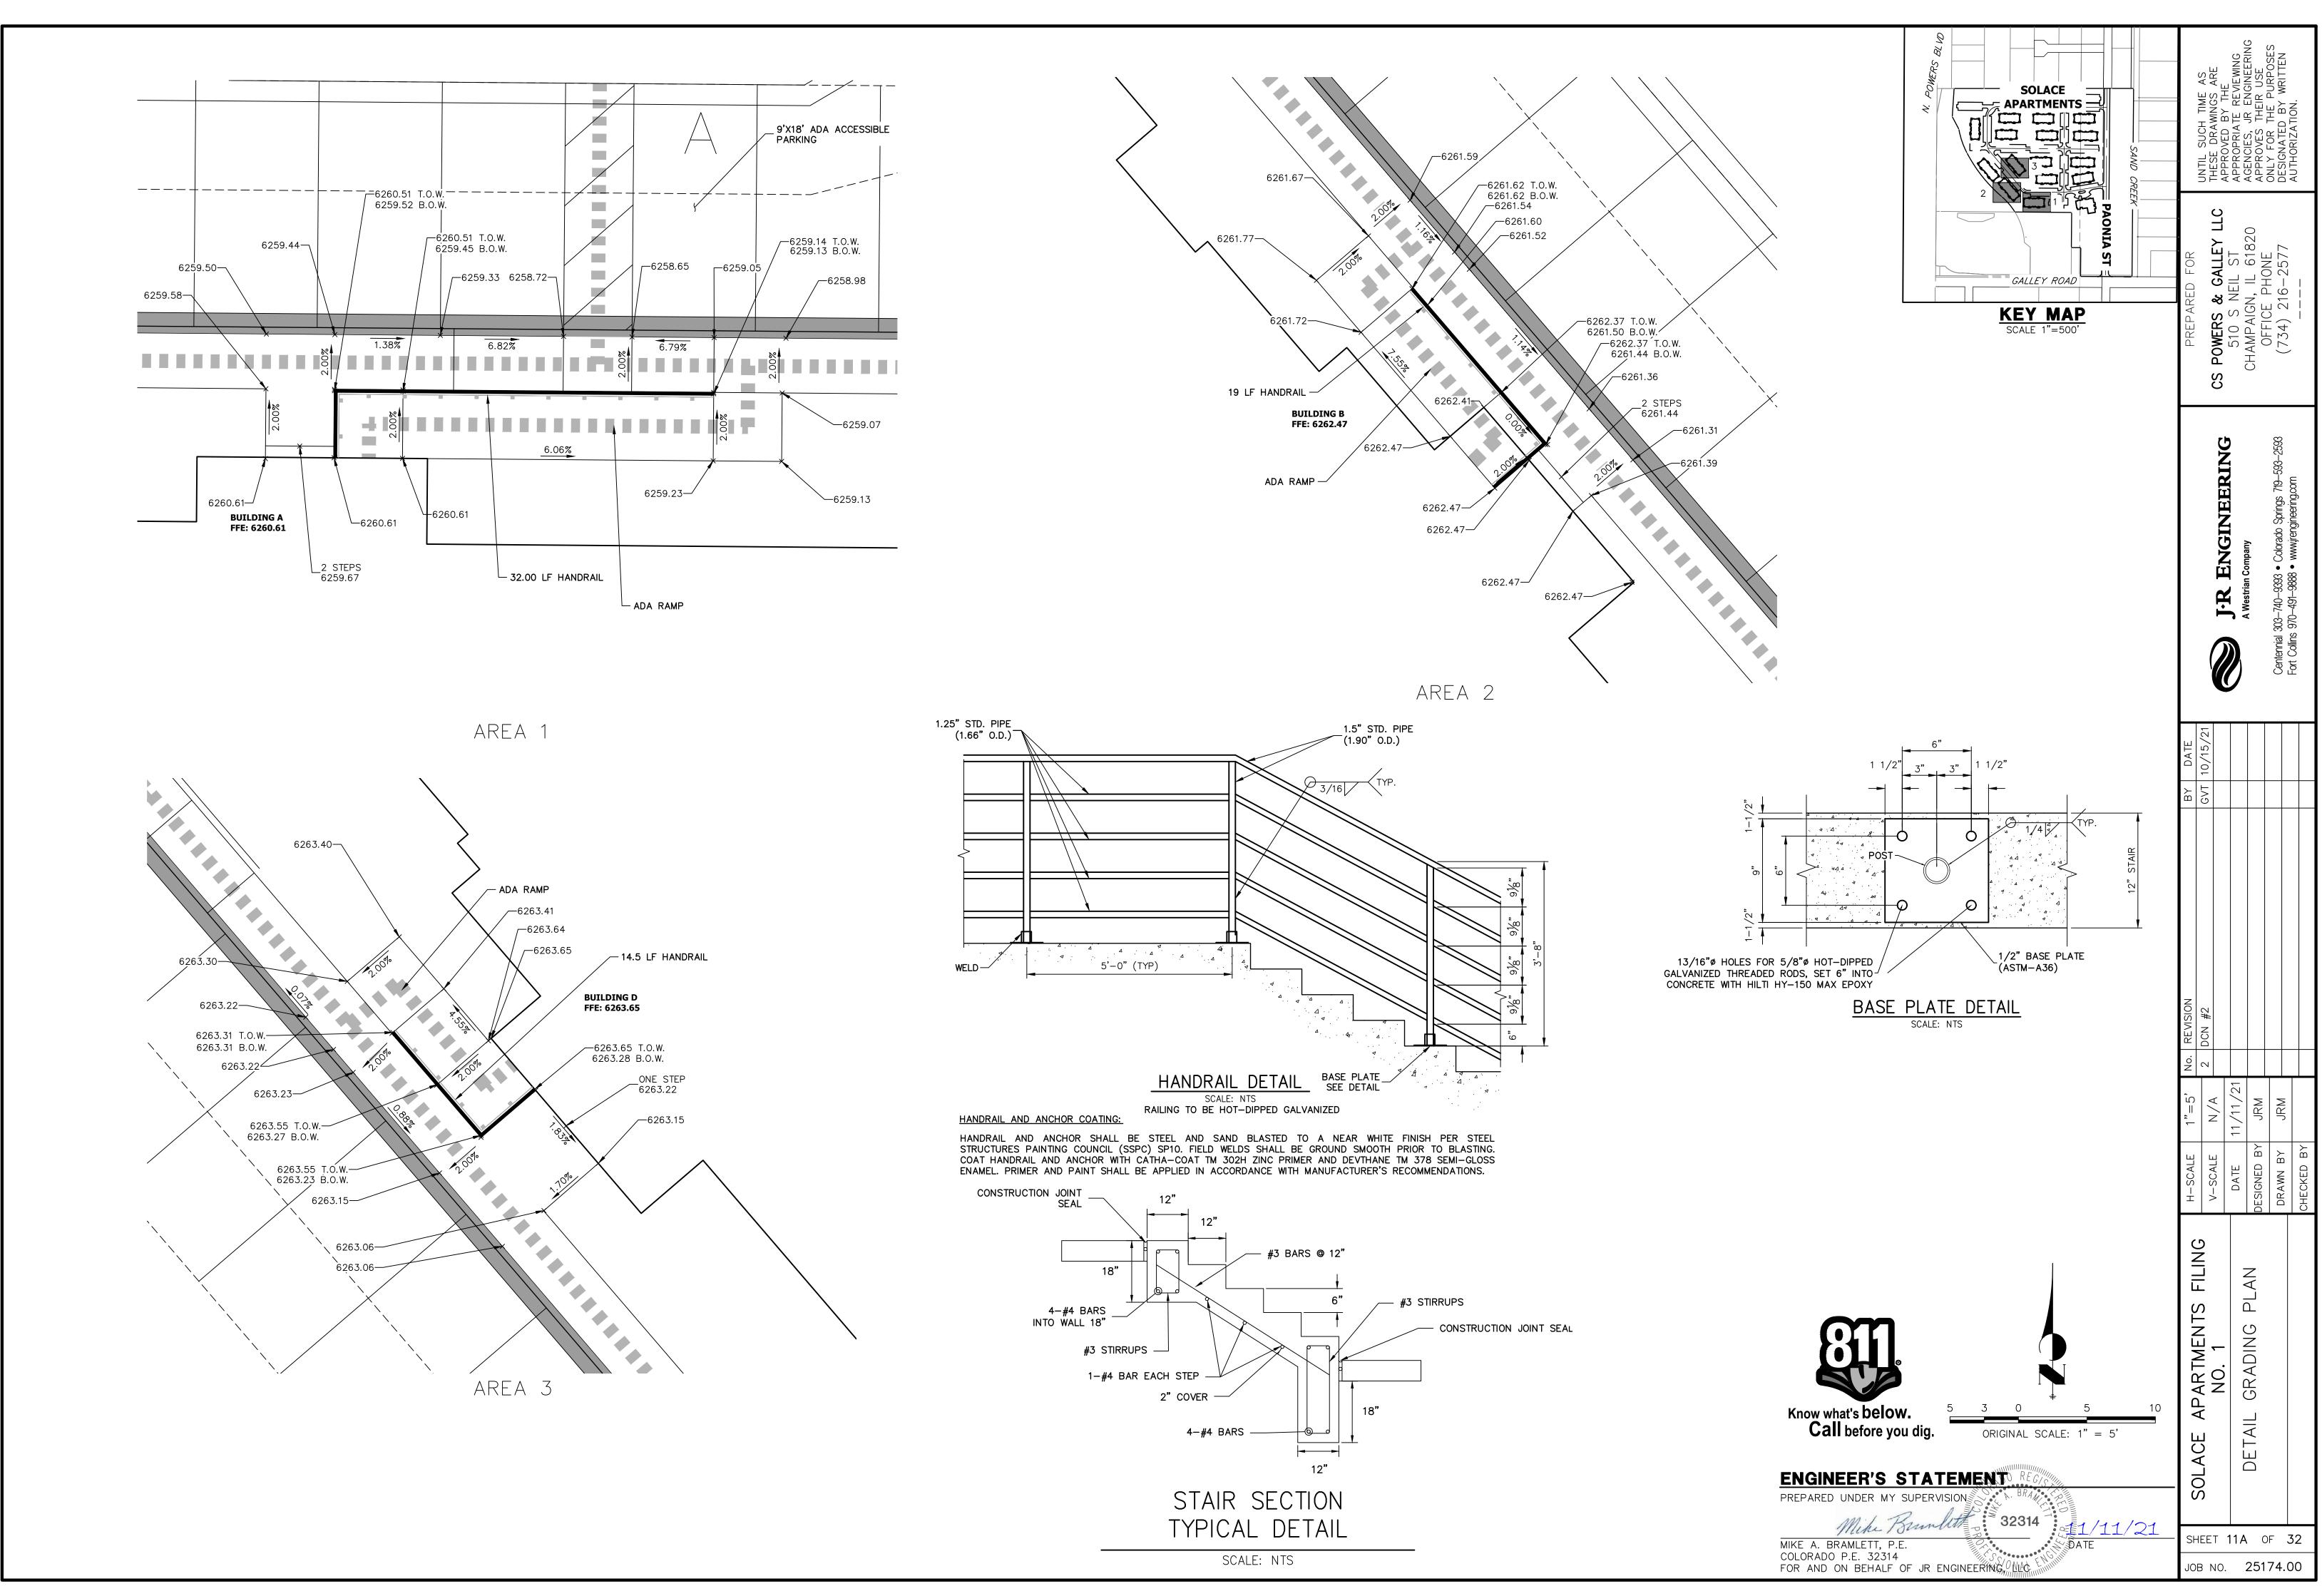


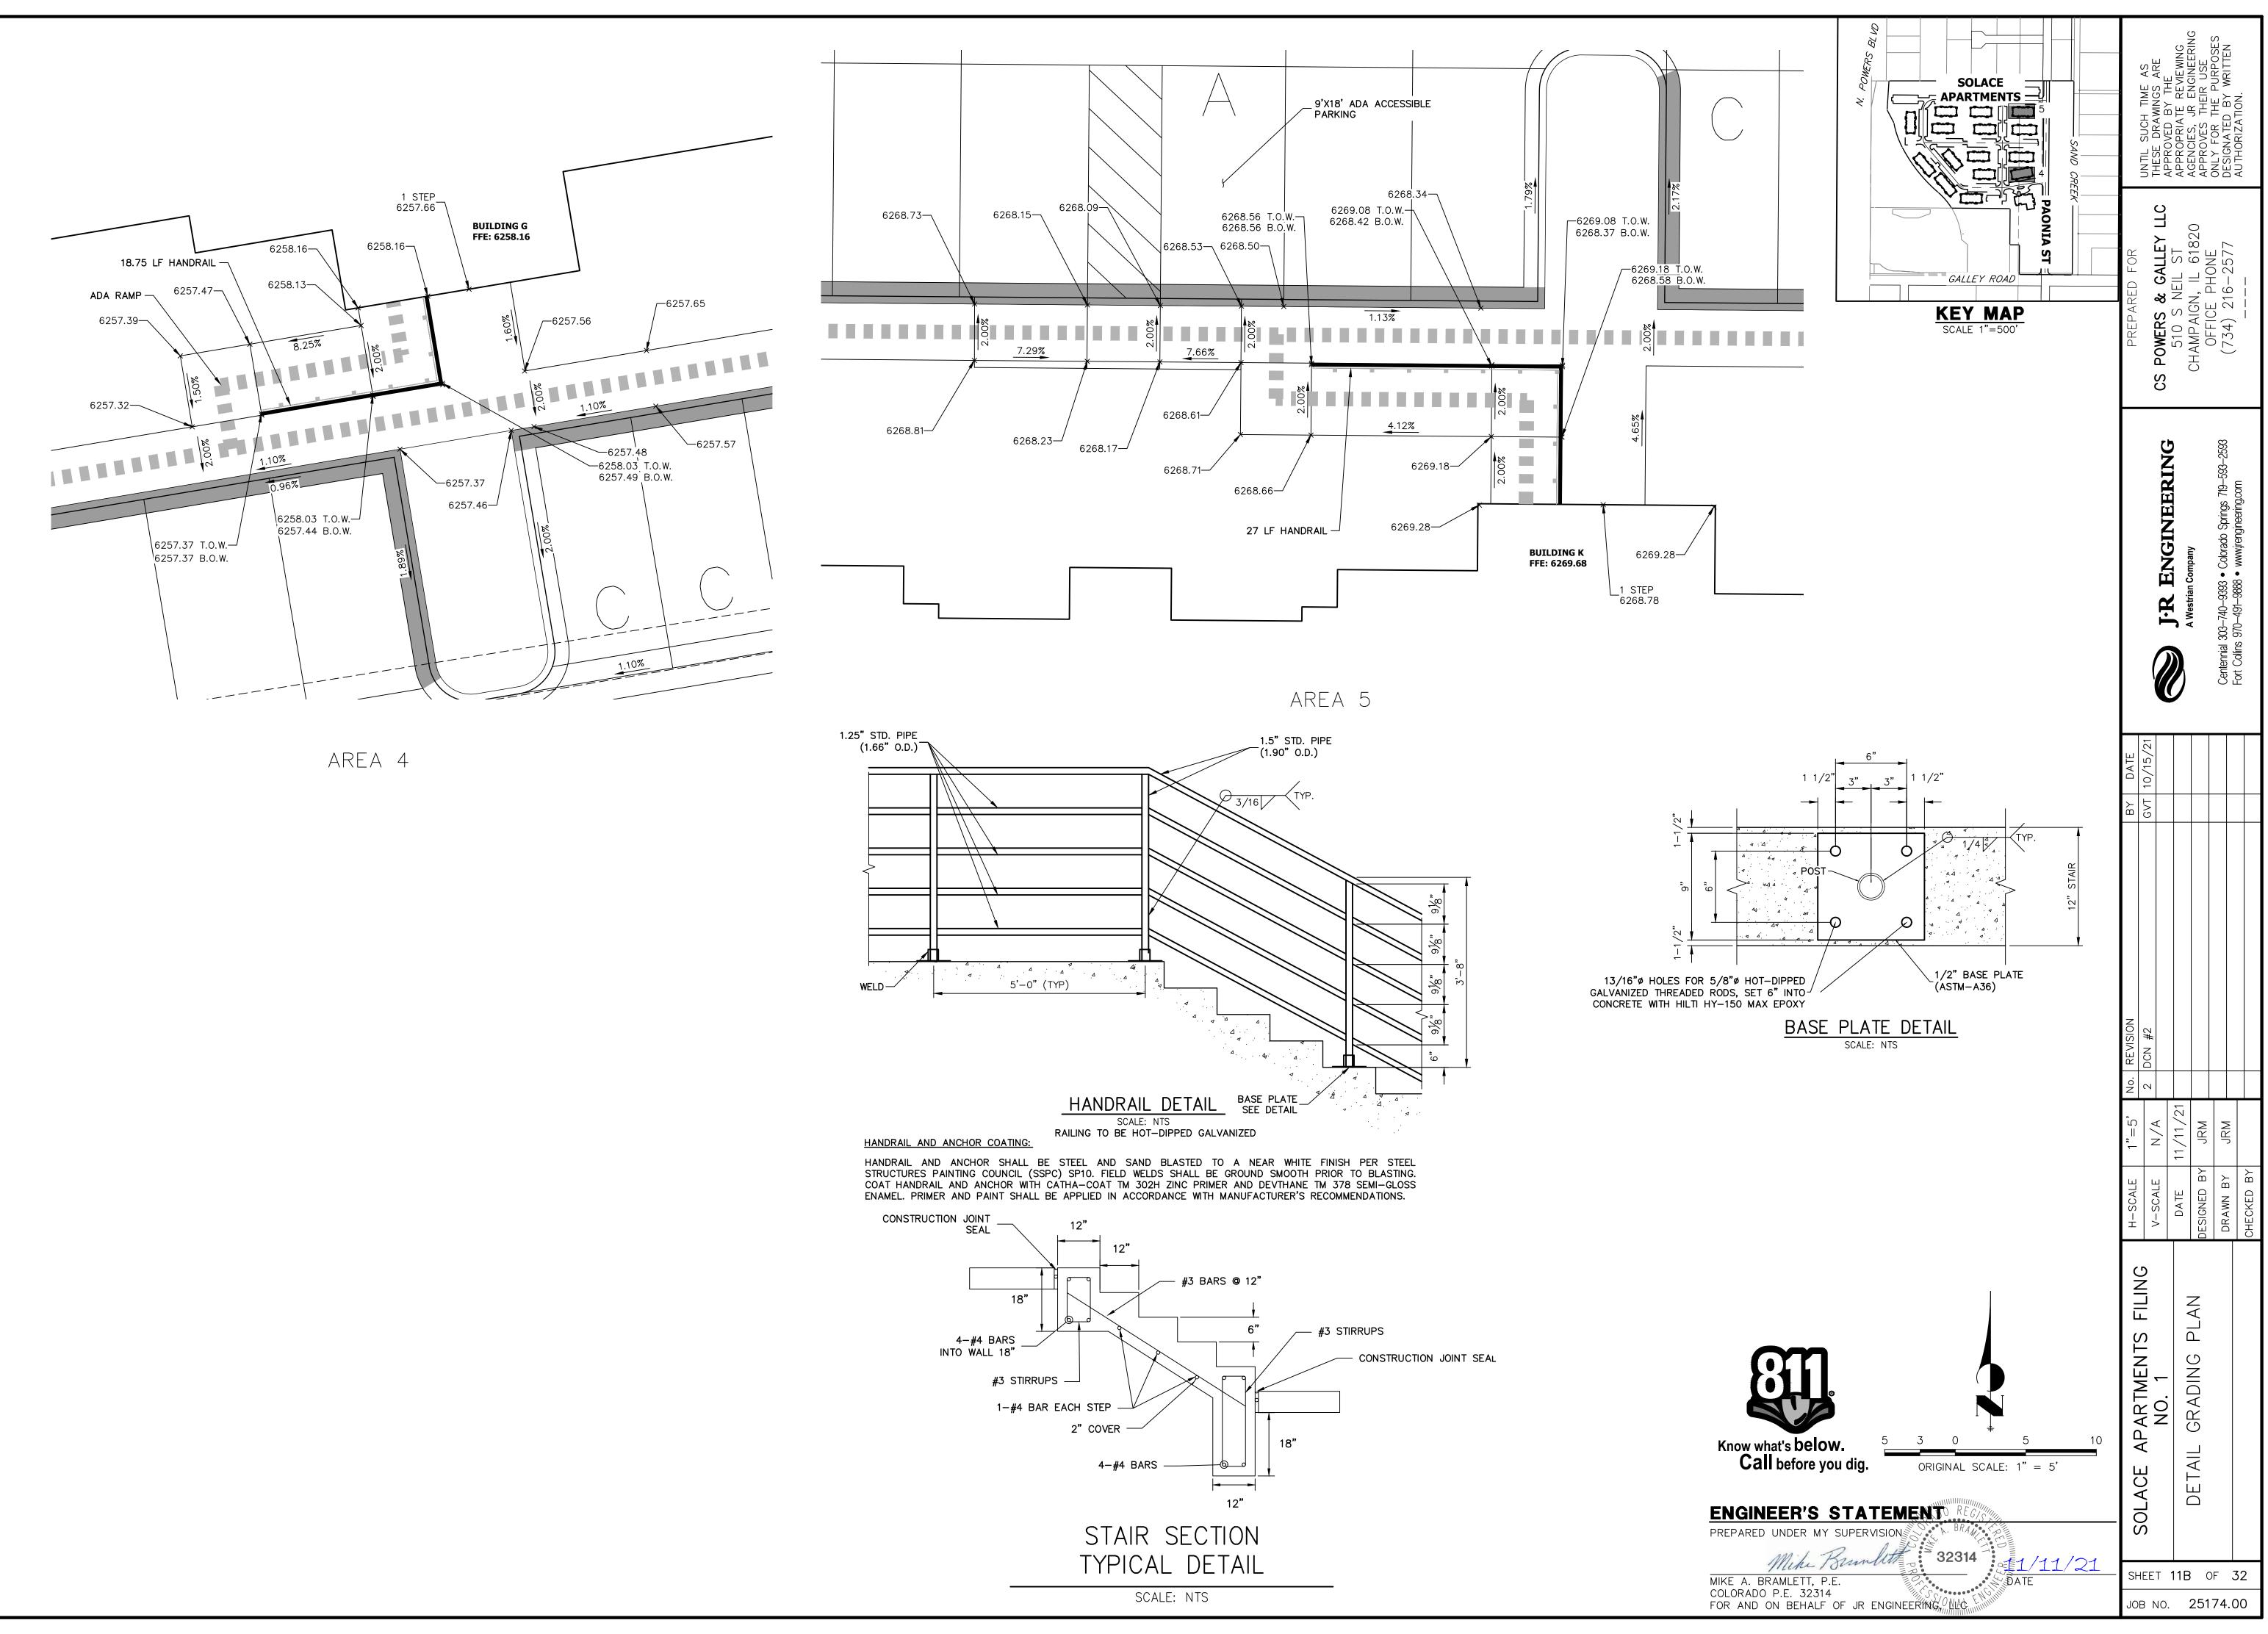


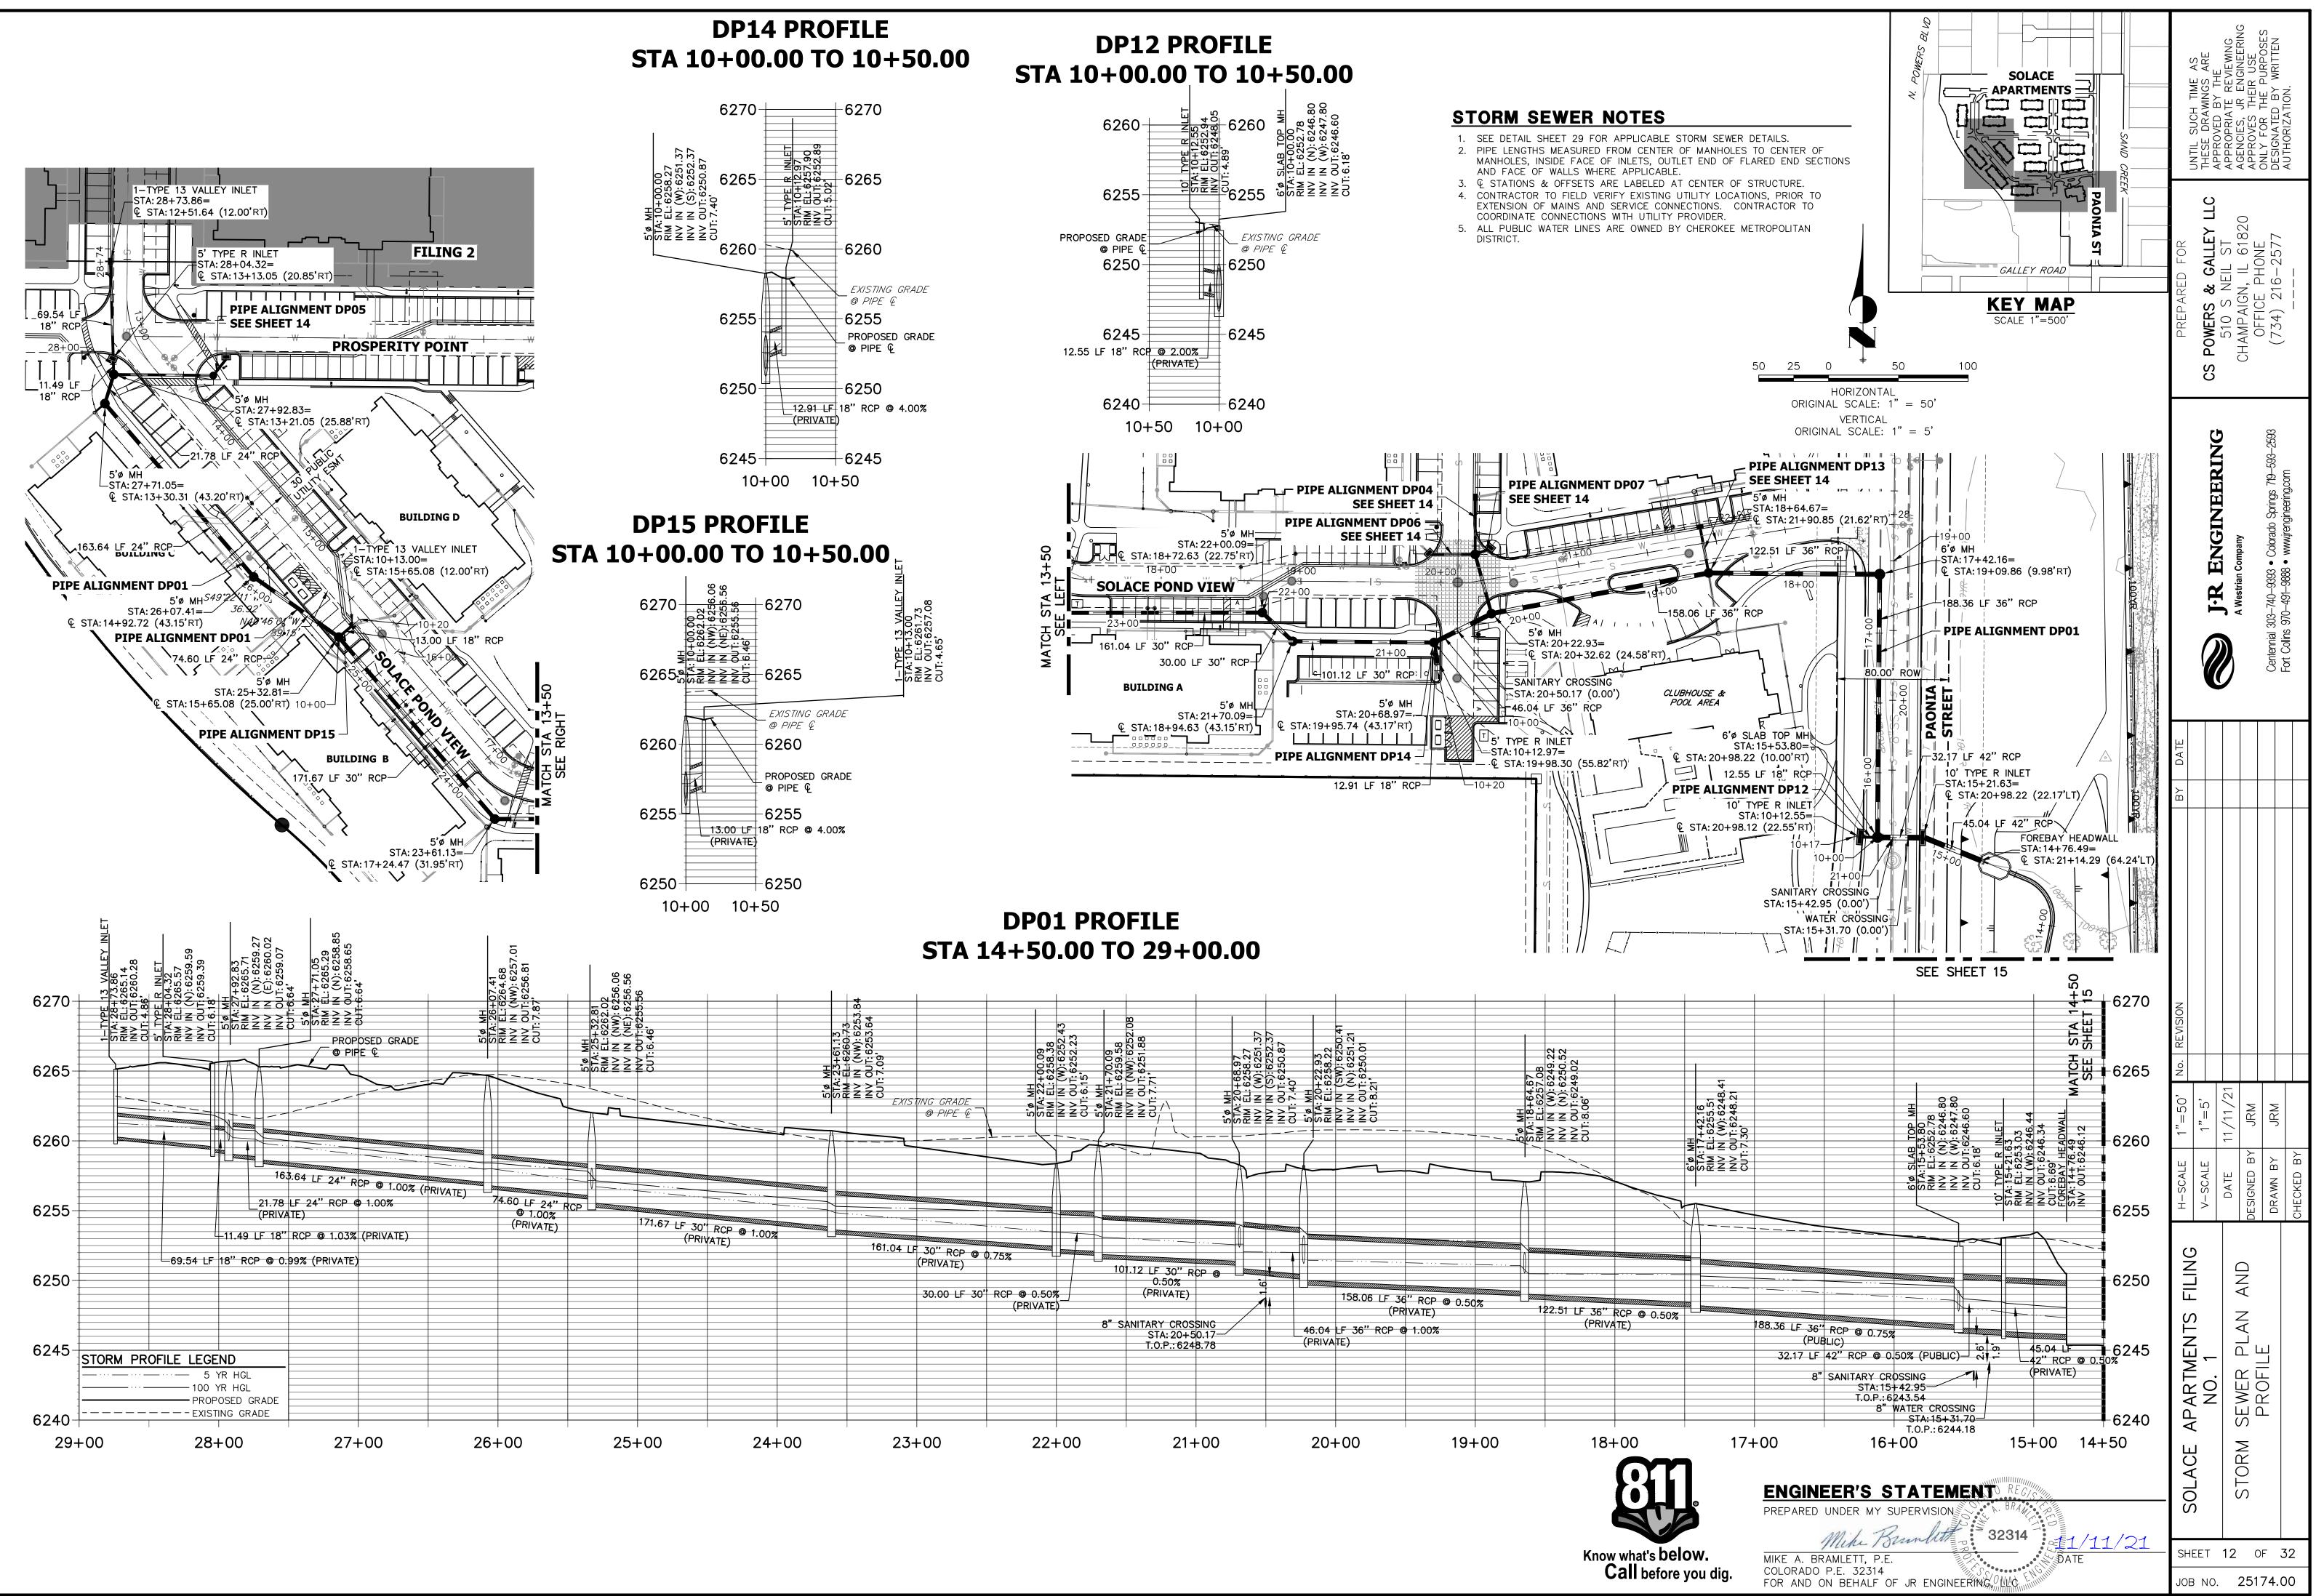


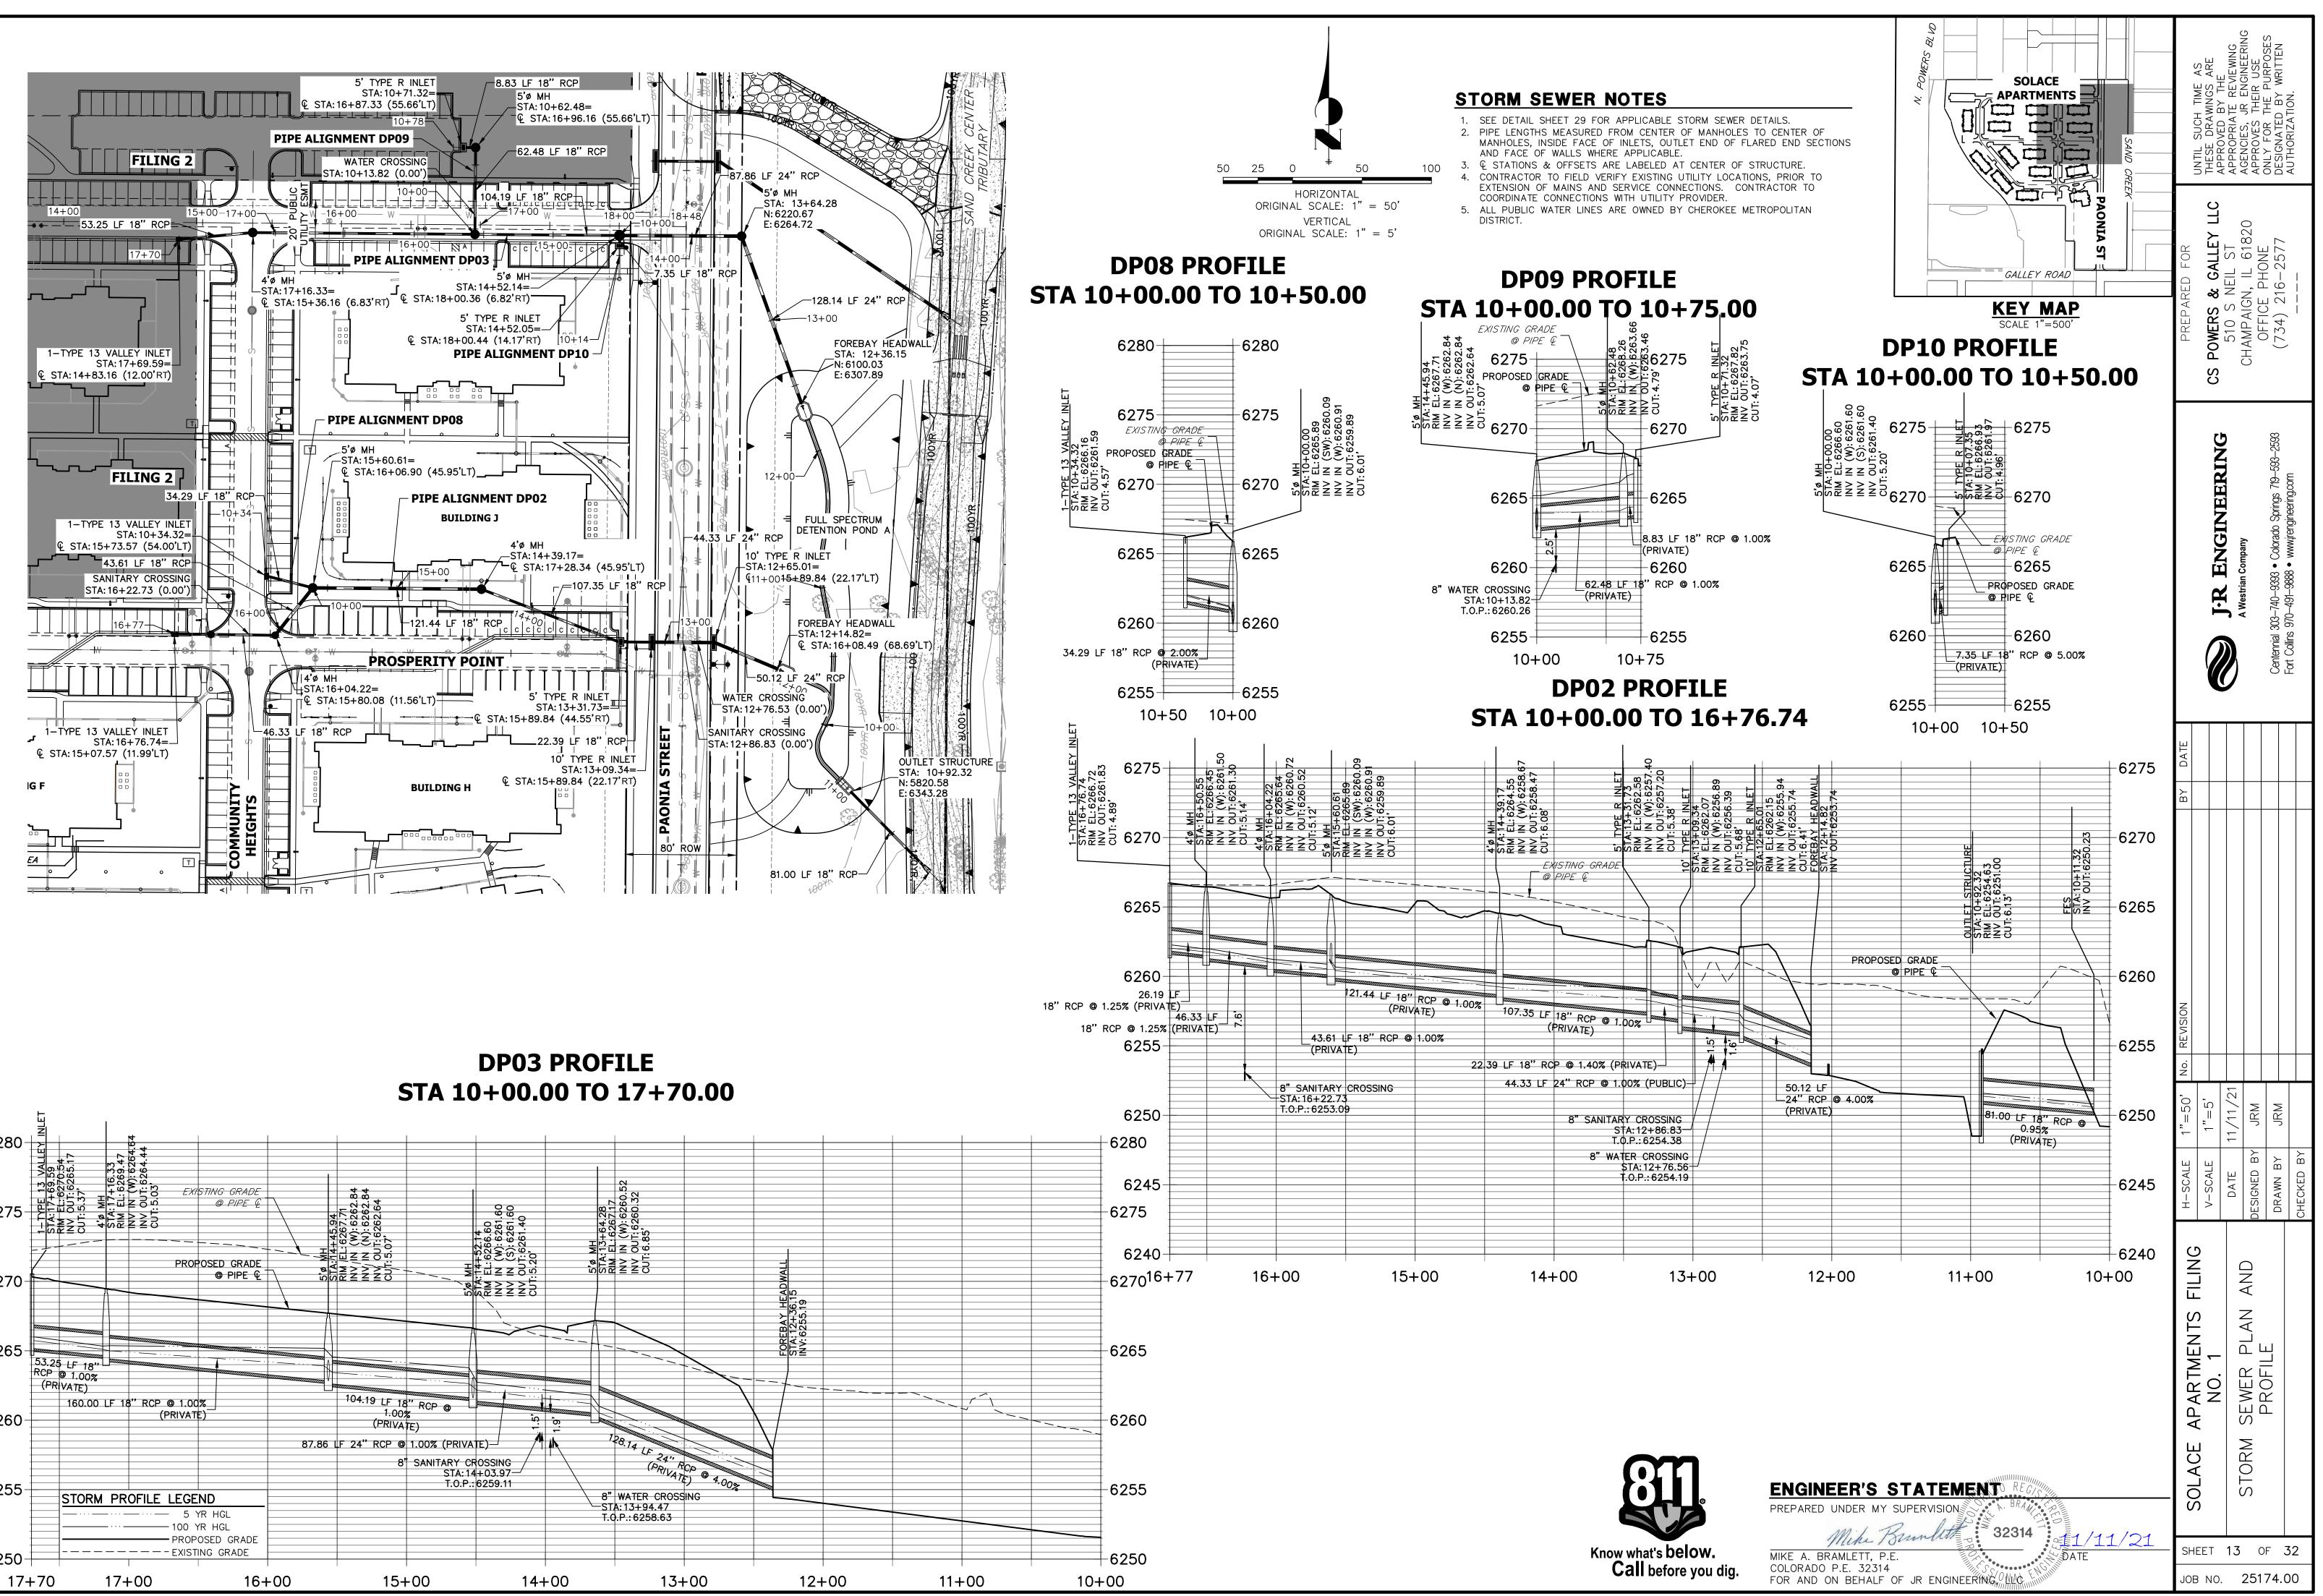


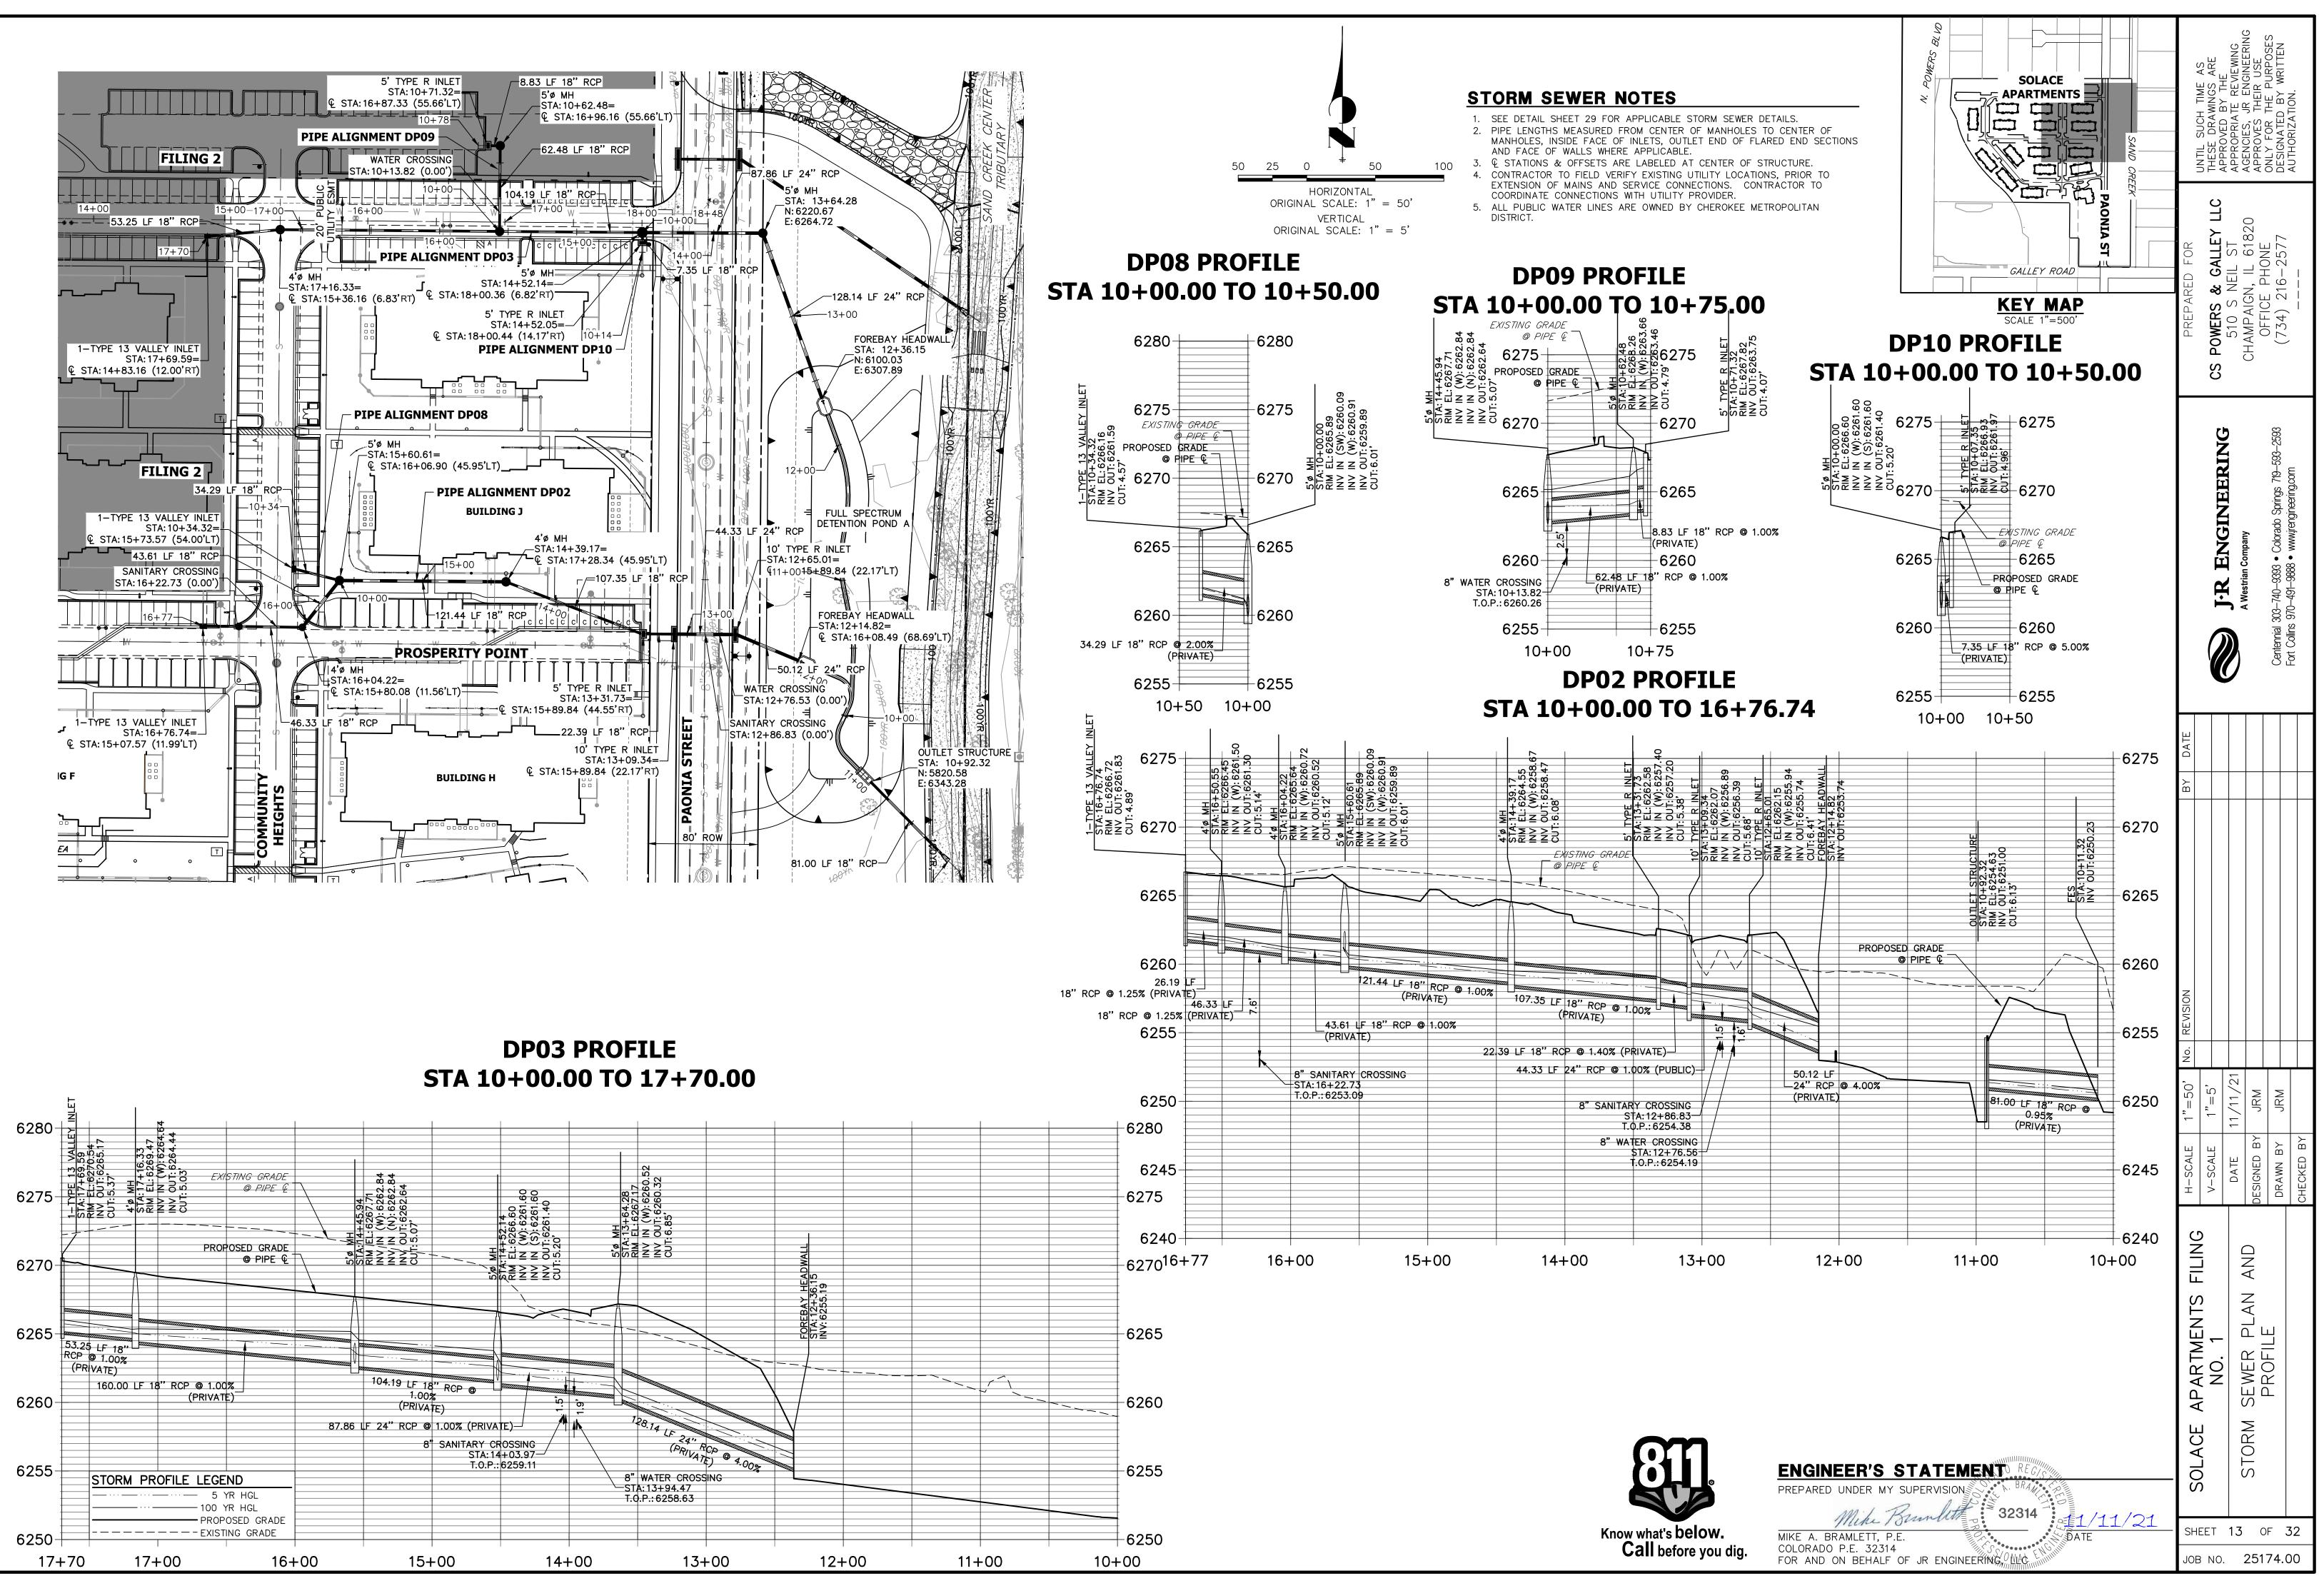


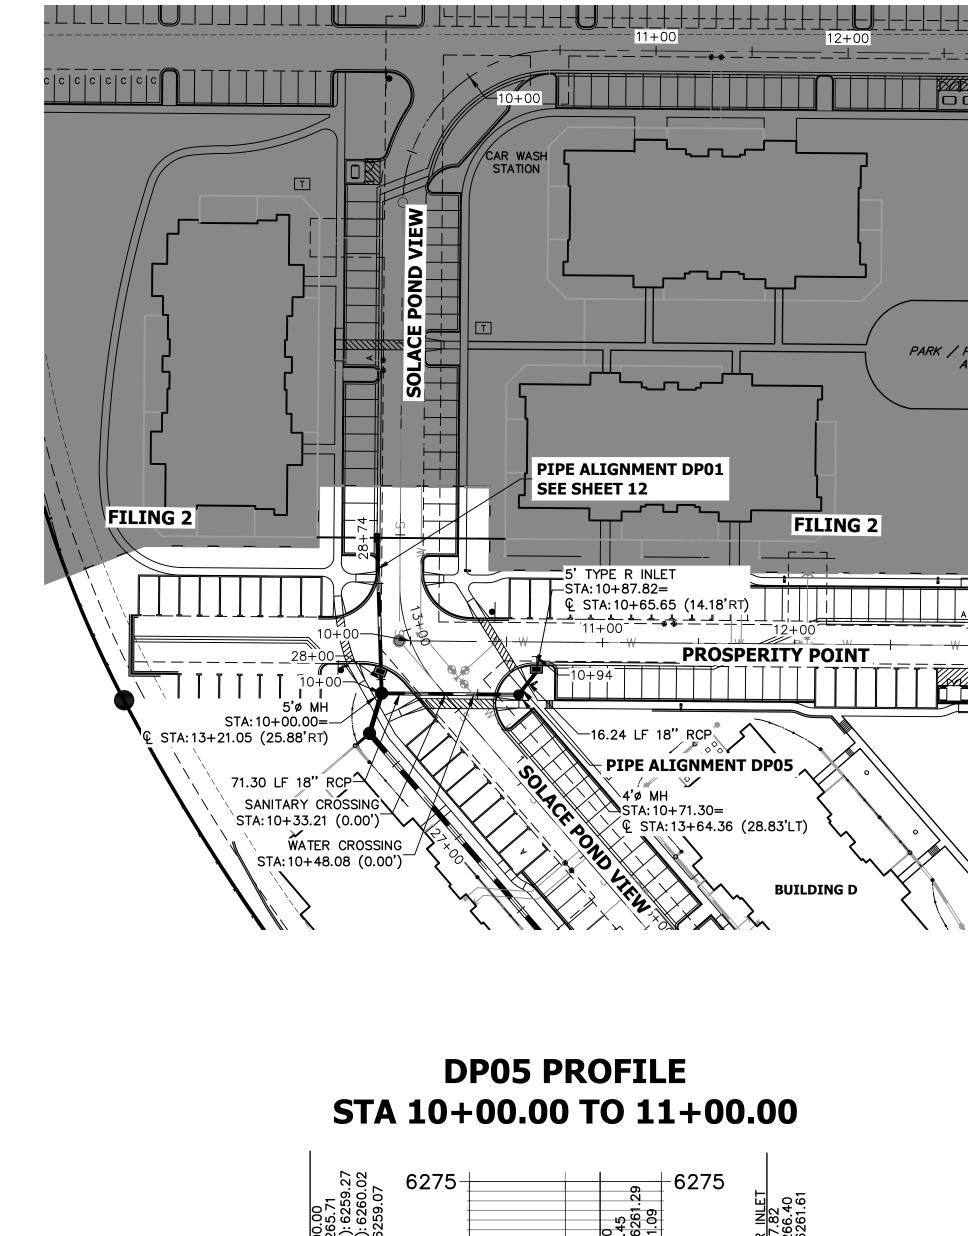


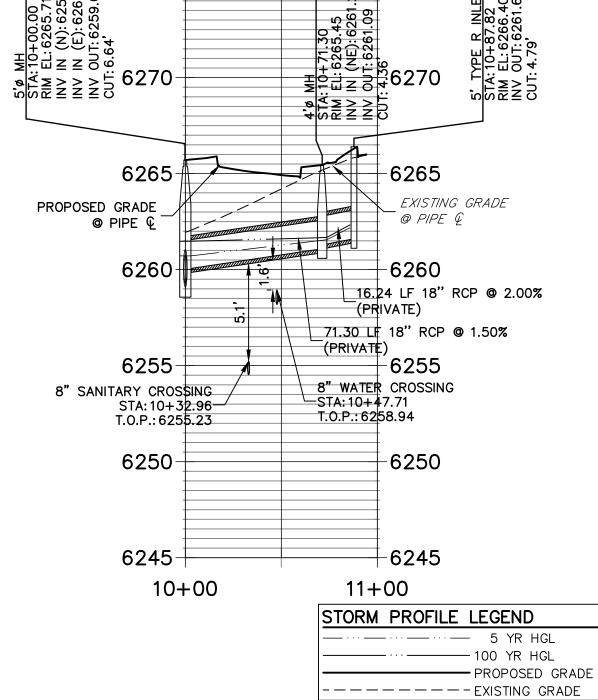


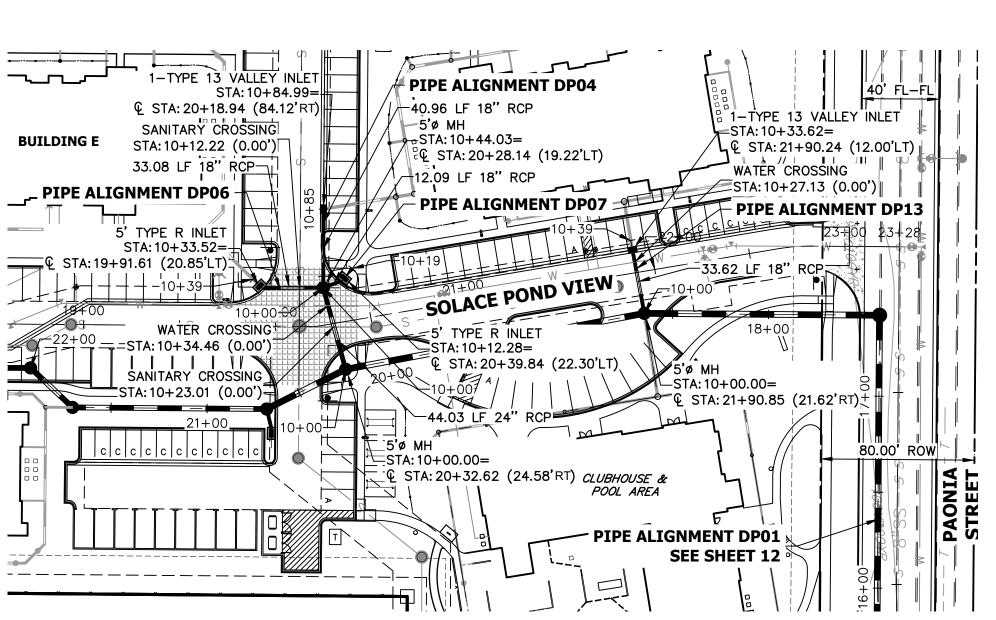














DP04 PROFILE STA 10+00.00 TO 11+00.00

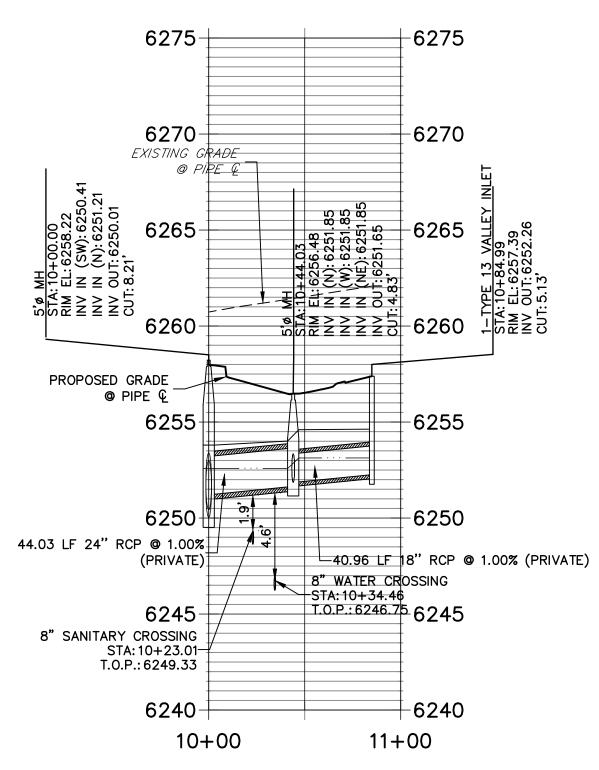


DP06 PROFILE

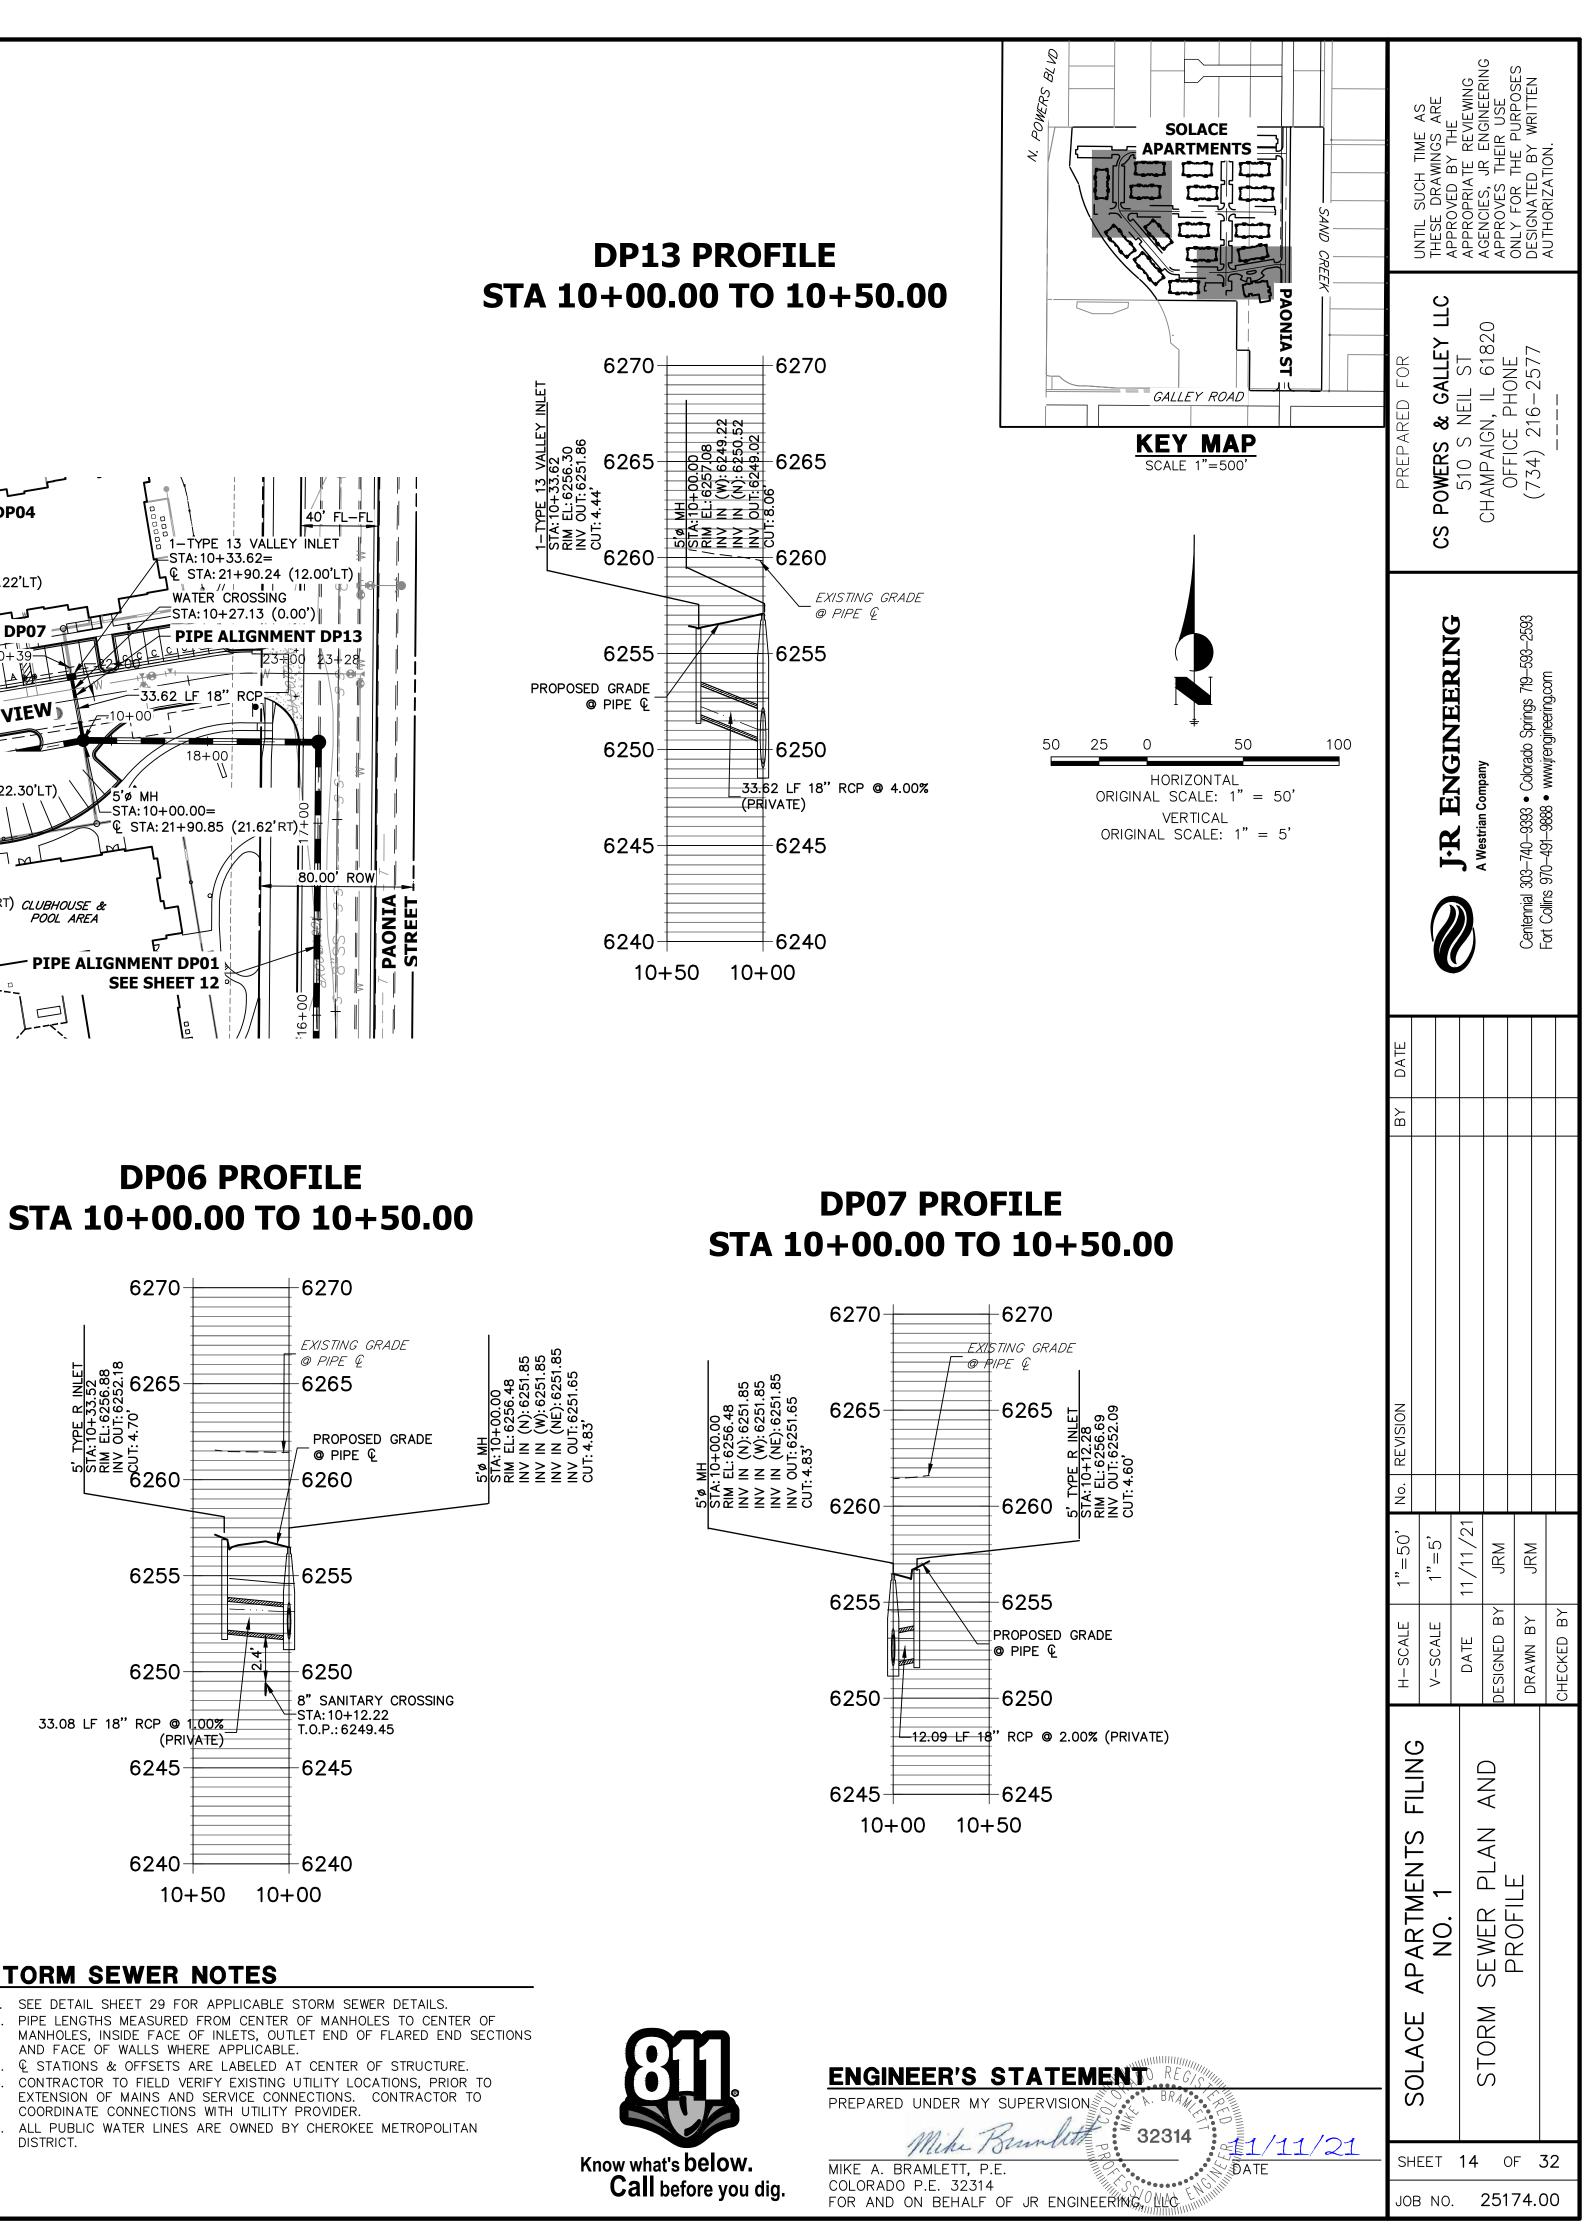


STORM SEWER NOTES

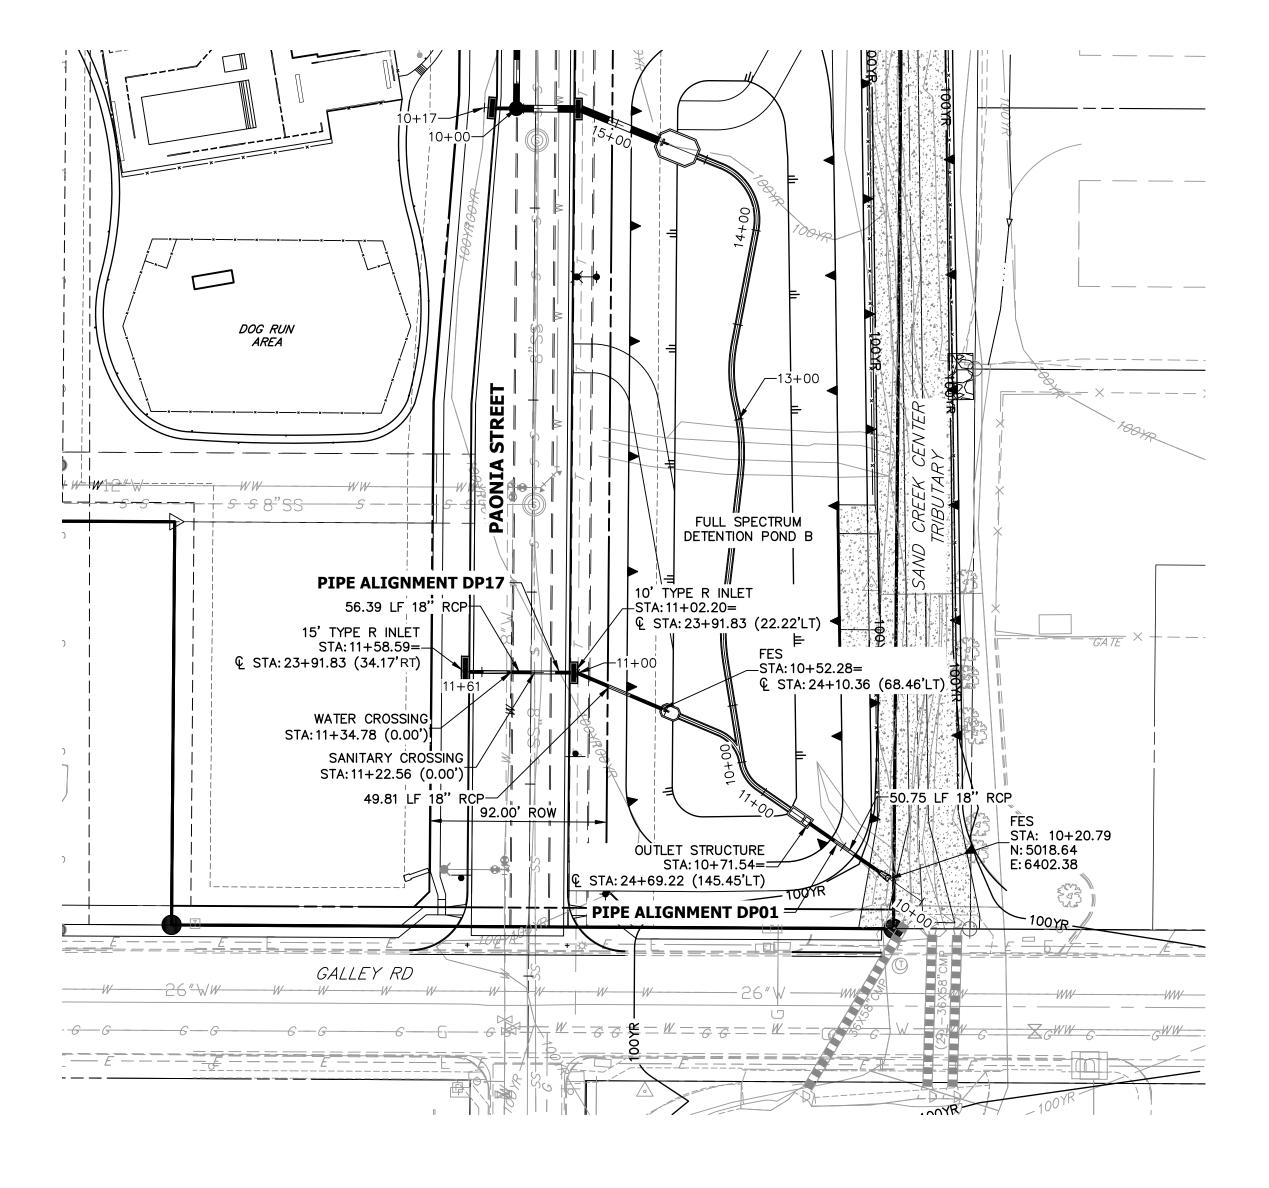
- 1. SEE DETAIL SHEET 29 FOR APPLICABLE STORM SEWER DETAILS. 2. PIPE LENGTHS MEASURED FROM CENTER OF MANHOLES TO CENTER OF
- 3. Q STATIONS & OFFSETS ARE LABELED AT CENTER OF STRUCTURE. 4. CONTRACTOR TO FIELD VERIFY EXISTING UTILITY LOCATIONS, PRIOR TO EXTENSION OF MAINS AND SERVICE CONNECTIONS. CONTRACTOR TO
- 5. ALL PUBLIC WATER LINES ARE OWNED BY CHEROKEE METROPOLITAN




DP17 PROFILE STA 10+00.00 TO 11+60.76

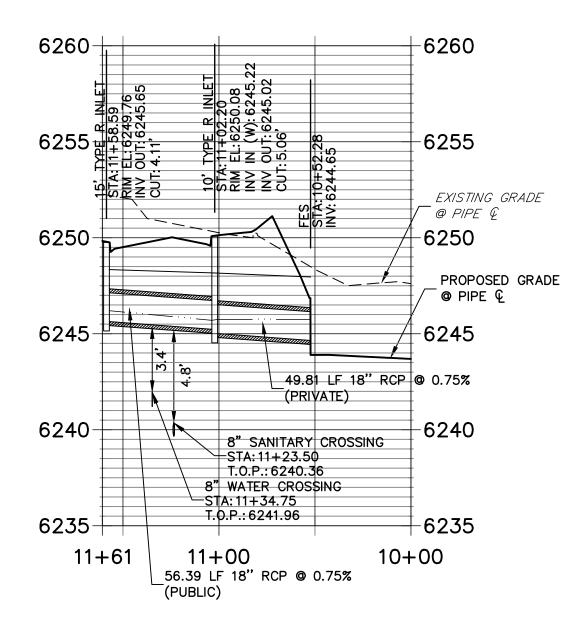





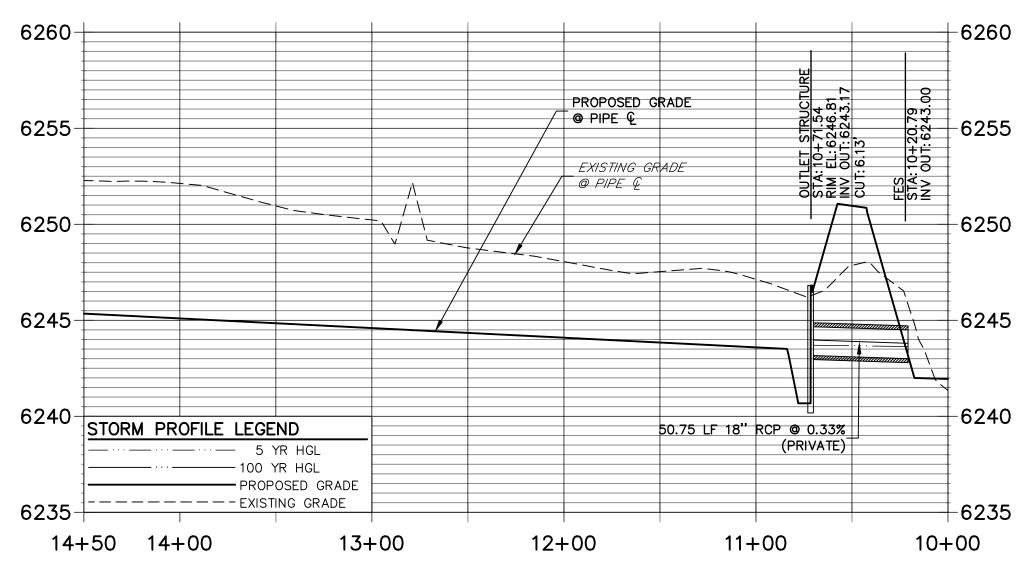


- DISTRICT.

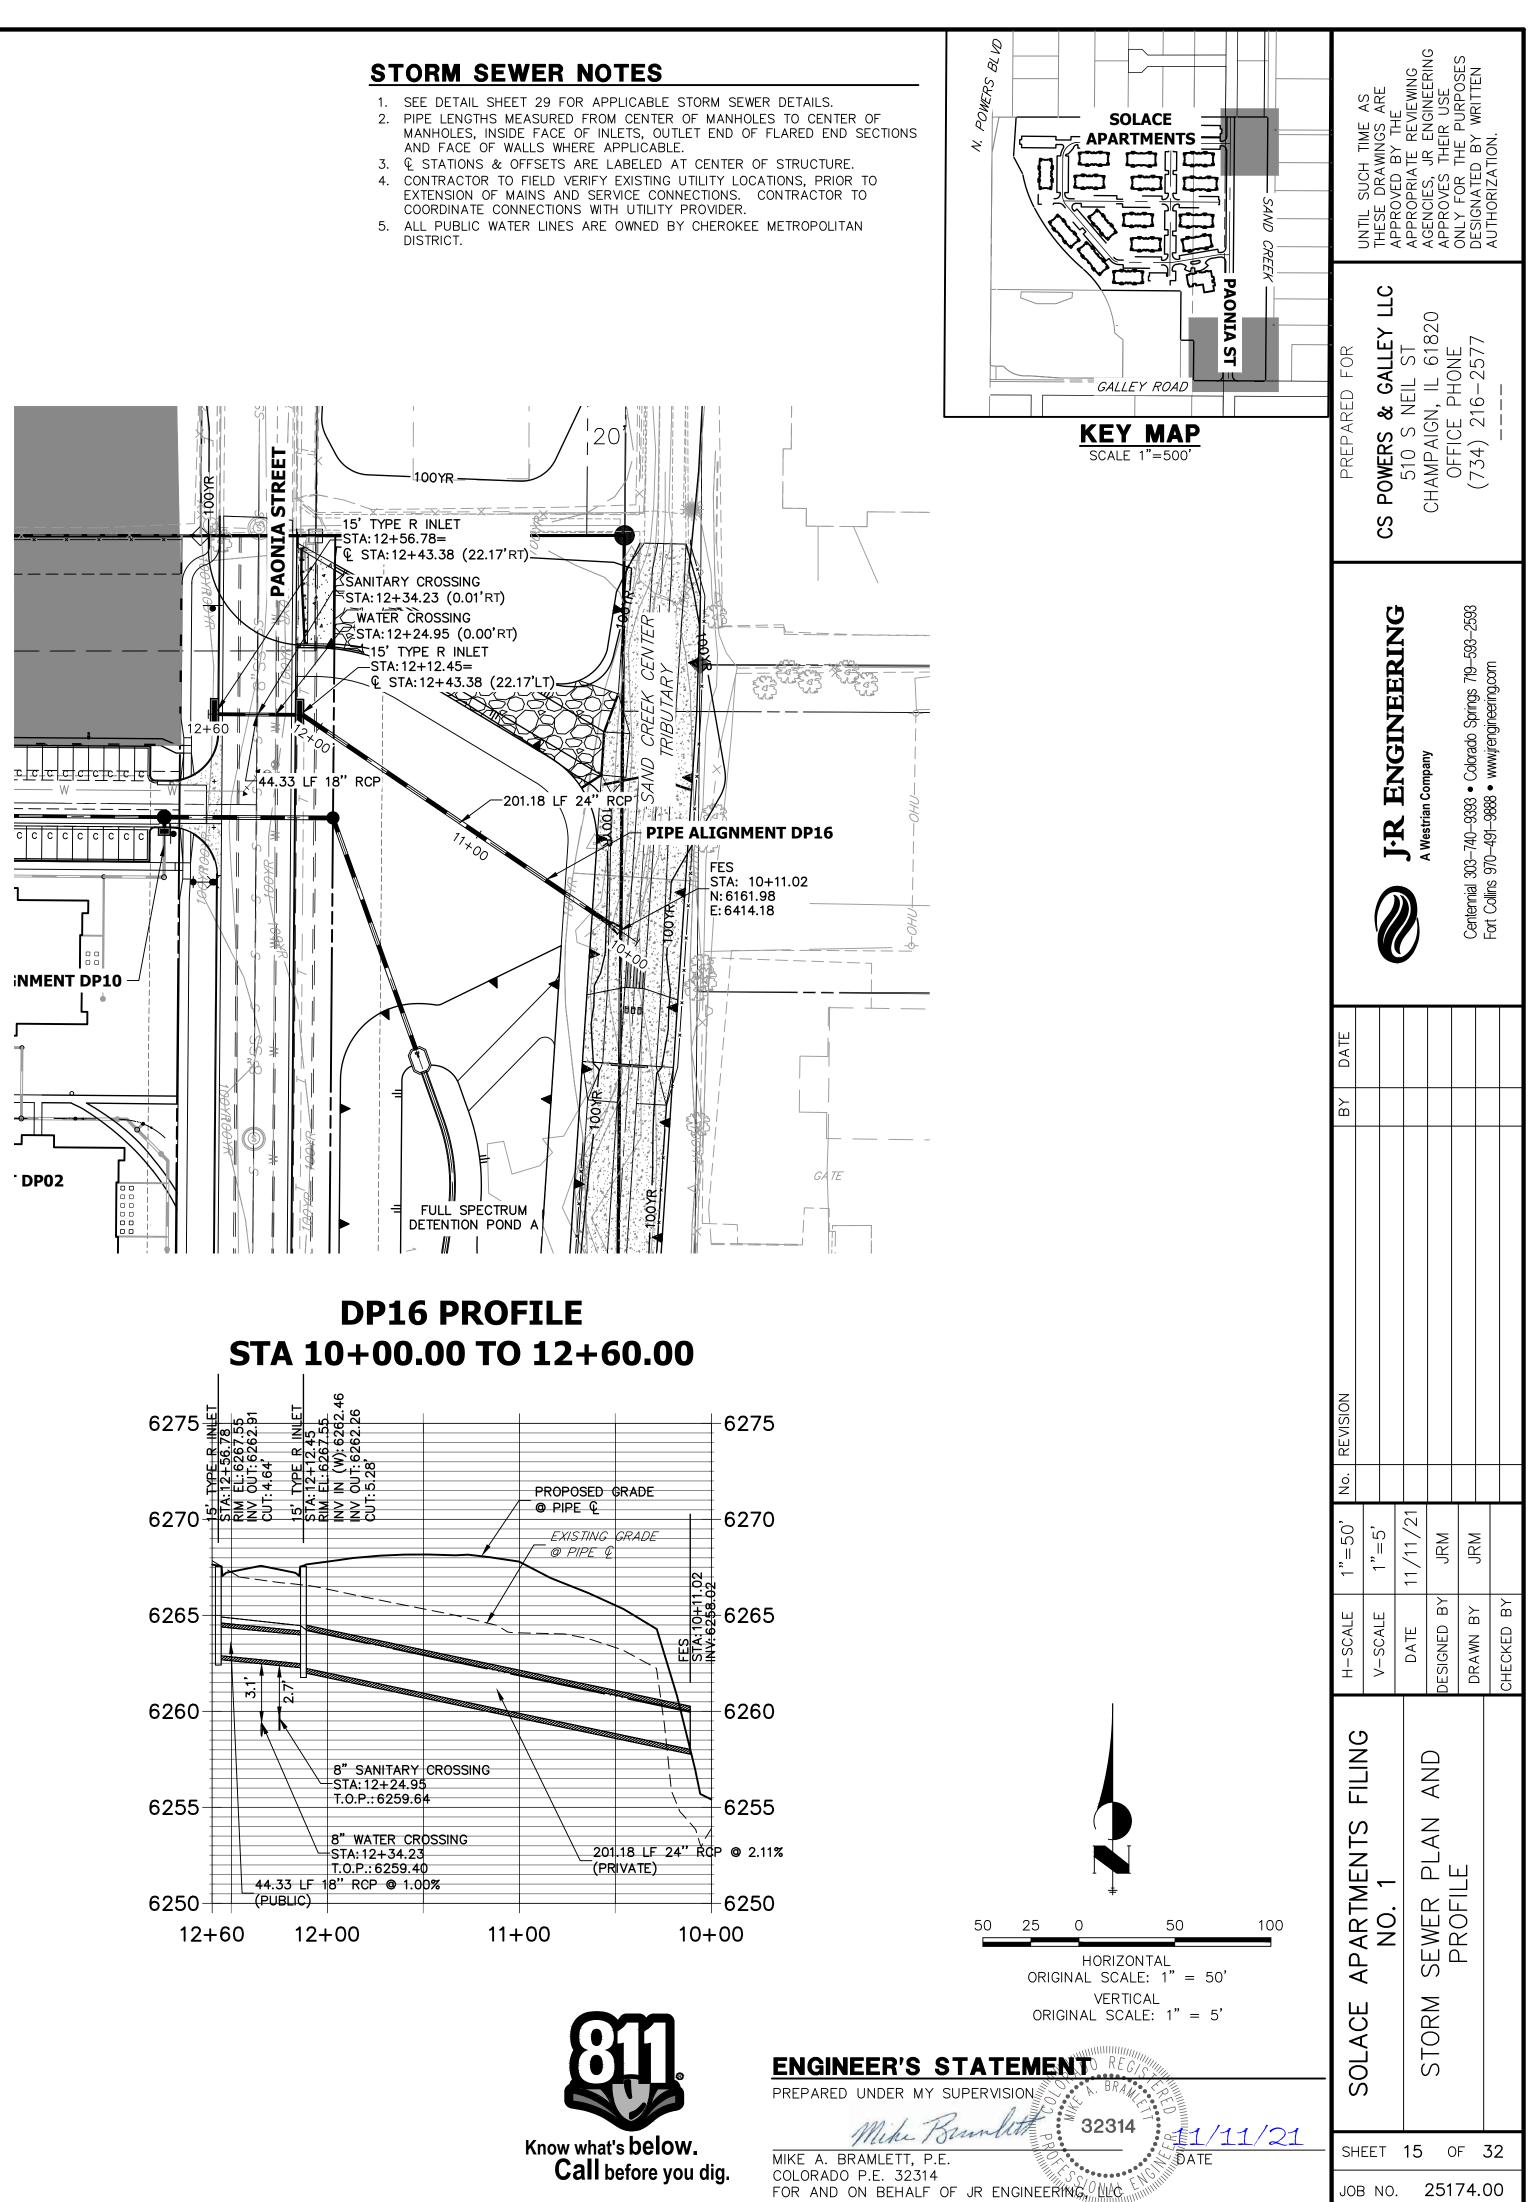


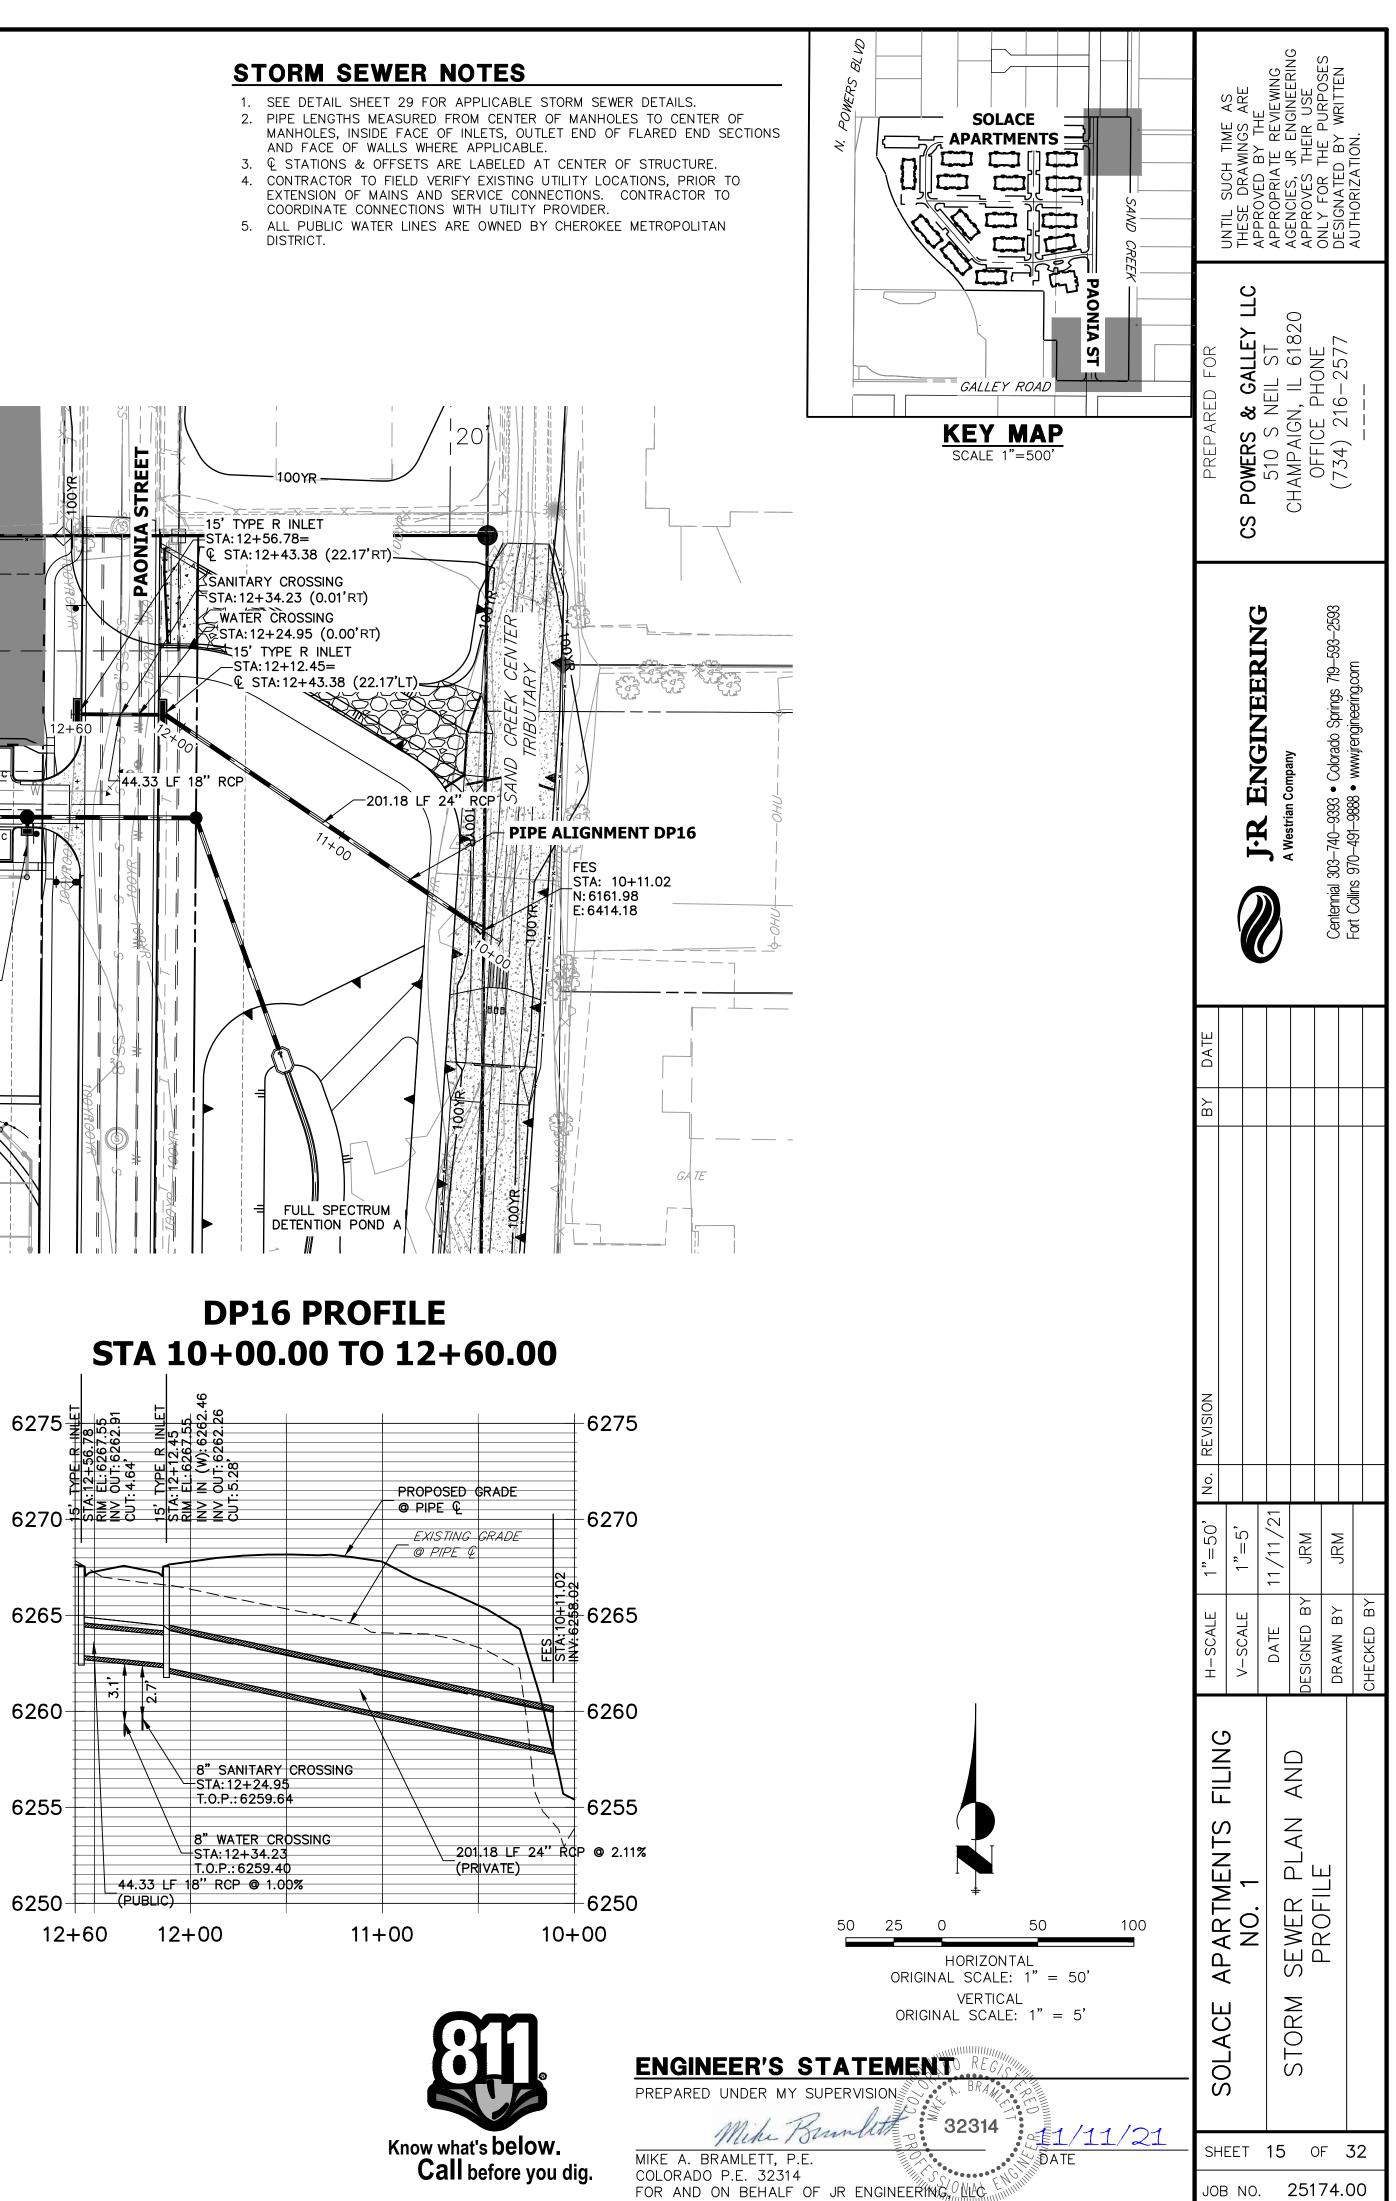


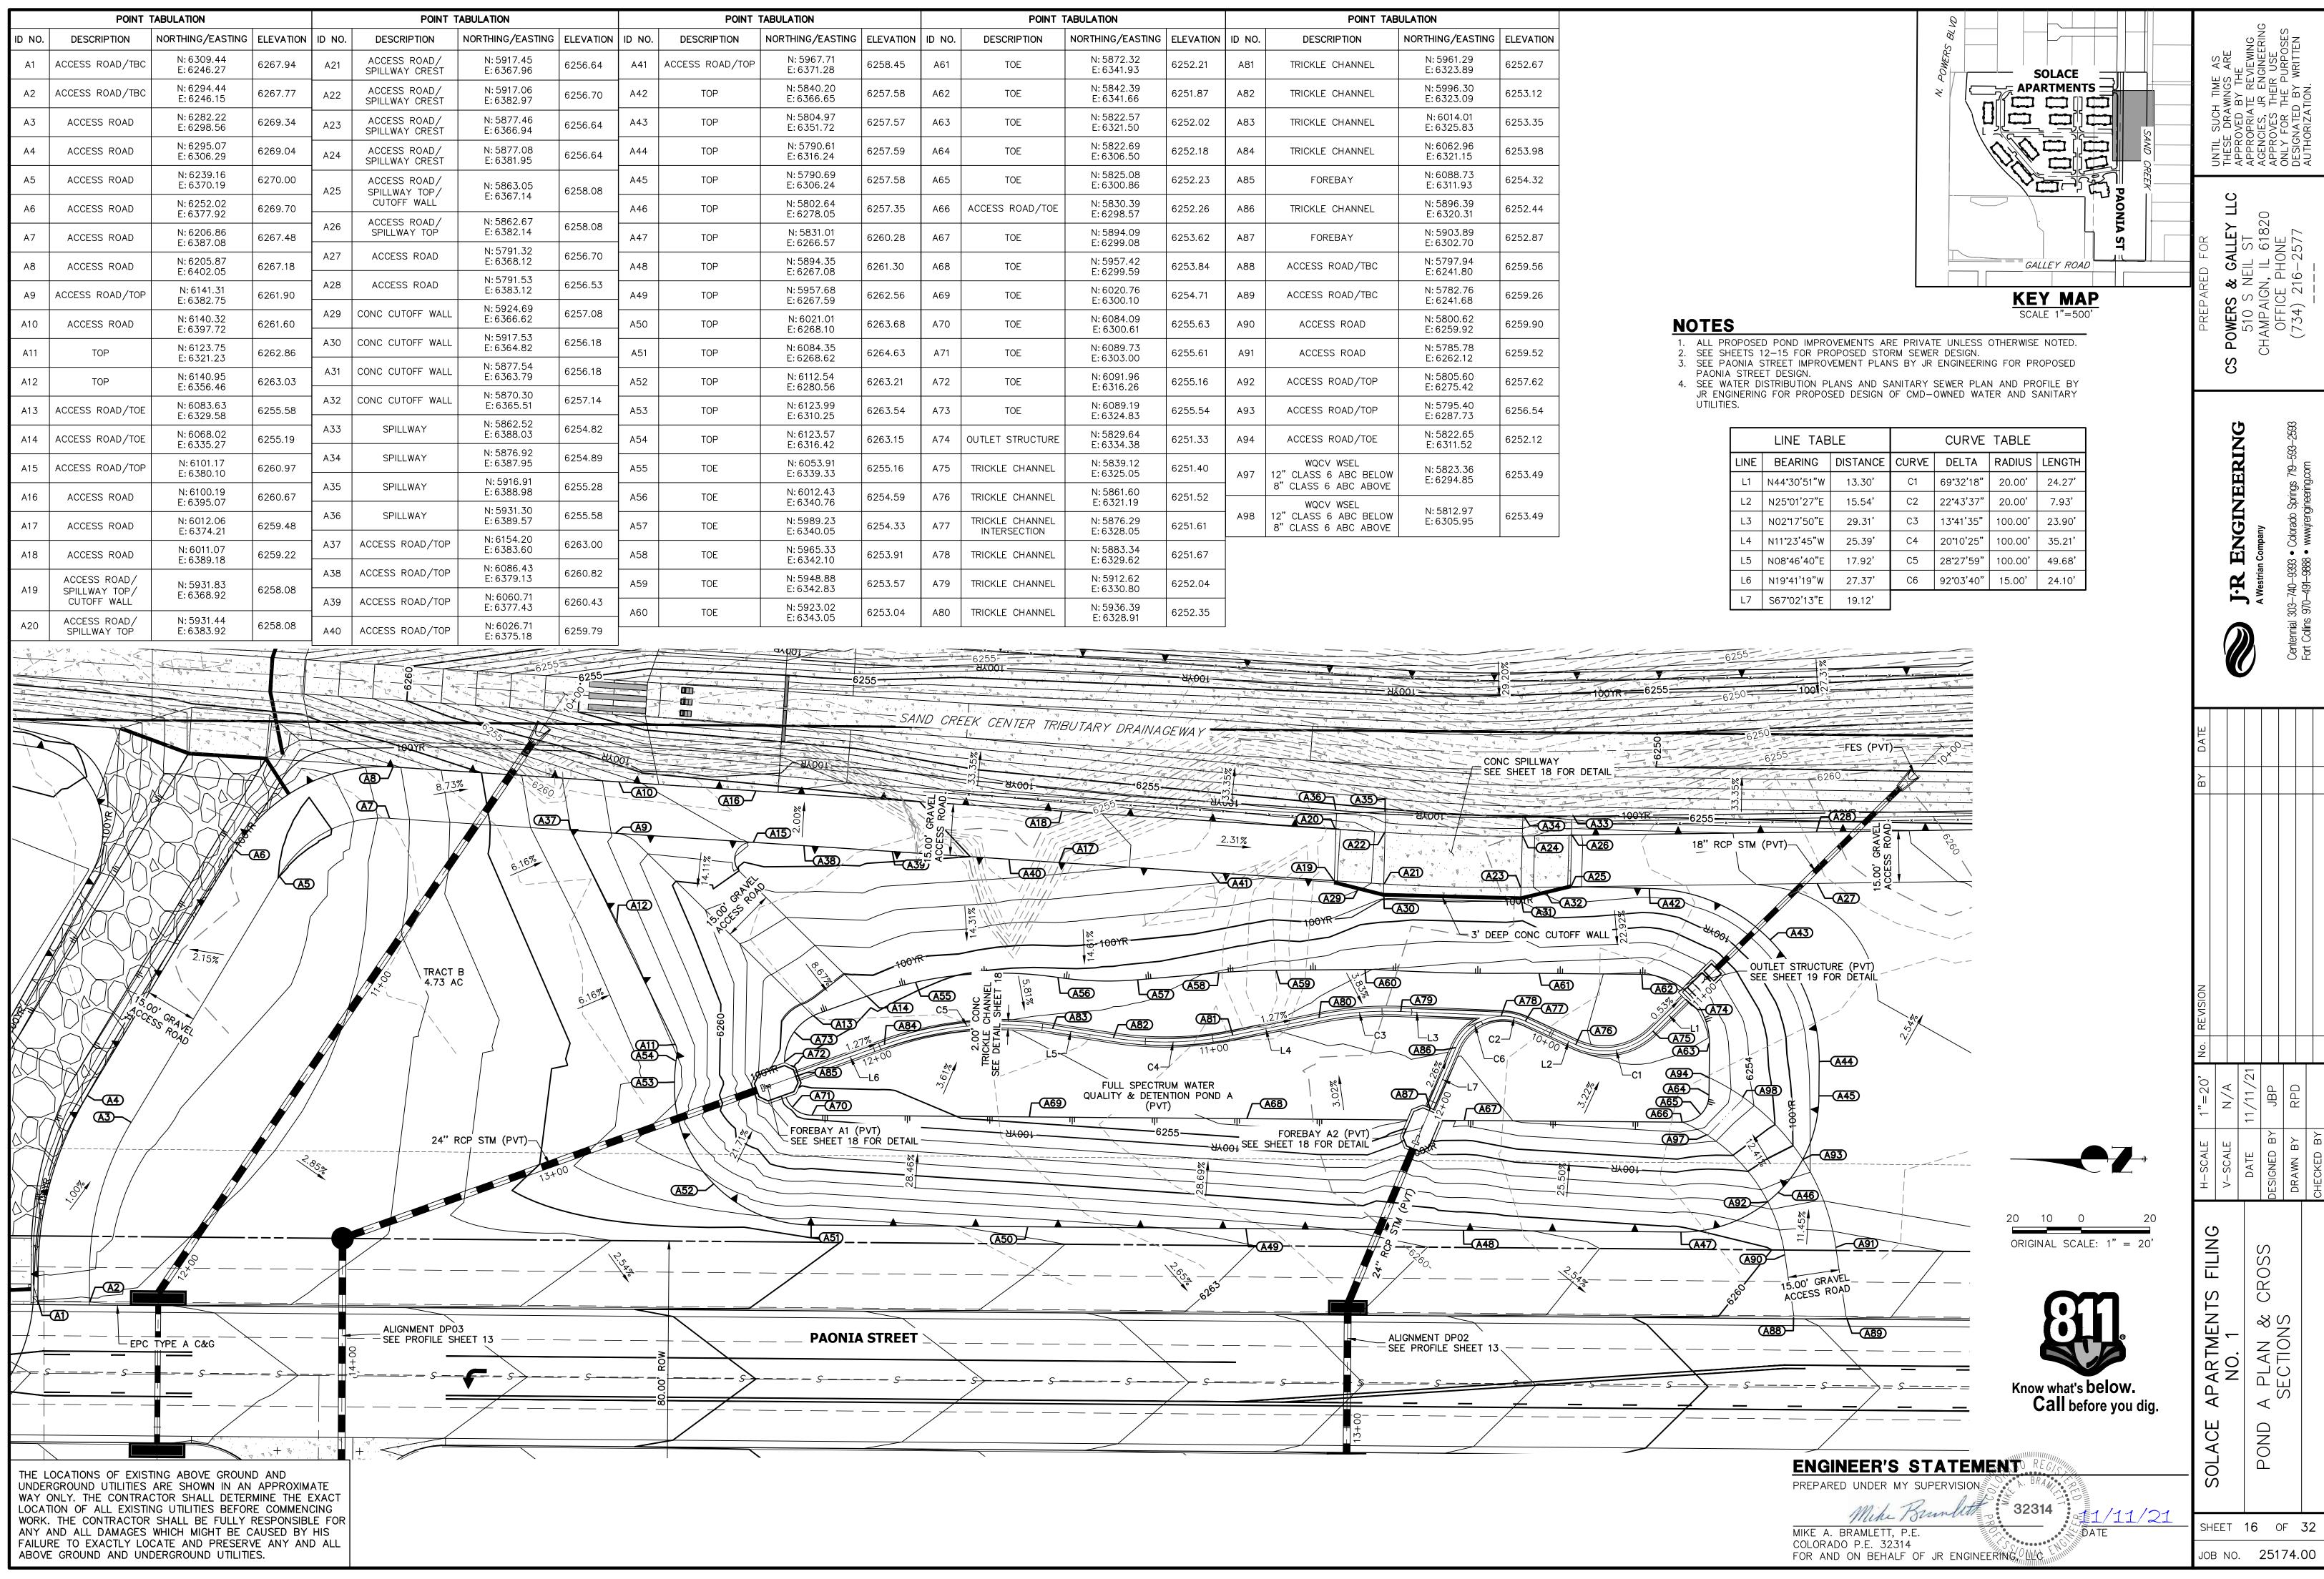


	FABULATION			POINT	TABULATION		POINT TABULATION					
	NORTHING/EASTING	ELEVATION	ID NO.	DESCRIPTION	NORTHING/EASTING	ELEVATION	ID NO.	DESCRIPTION	NORTHING/EASTING	ELEVATION		
,	N: 5967.71 E: 6371.28	6258.45	A61	TOE	N: 5872.32 E: 6341.93	6252.21	A81	TRICKLE CHANNEL	N: 5961.29 E: 6323.89	6252.67		
	N: 5840.20 E: 6366.65	6257.58	A62	TOE	N: 5842.39 E: 6341.66	6251.87	A82	TRICKLE CHANNEL	N: 5996.30 E: 6323.09	6253.12		
	N: 5804.97 E: 6351.72	6257.57	A63	TOE	N: 5822.57 E: 6321.50	6252.02	A83	TRICKLE CHANNEL	N: 6014.01 E: 6325.83	6253.35		
	N: 5790.61 E: 6316.24	6257.59	A64	TOE	N: 5822.69 E: 6306.50	6252.18	A84	TRICKLE CHANNEL	N: 6062.96 E: 6321.15	6253.98		
	N: 5790.69 E: 6306.24	6257.58	A65	TOE	N: 5825.08 E: 6300.86	6252.23	A85	FOREBAY	N: 6088.73 E: 6311.93	6254.32		
	N: 5802.64 E: 6278.05	6257.35	A66	ACCESS ROAD/TOE	N: 5830.39 E: 6298.57	6252.26	A86	TRICKLE CHANNEL	N: 5896.39 E: 6320.31	6252.44		
	N: 5831.01 E: 6266.57	6260.28	A67	TOE	N: 5894.09 E: 6299.08	6253.62	A87	FOREBAY	N: 5903.89 E: 6302.70	6252.87		
	N: 5894.35 E: 6267.08	6261.30	A68	TOE	N: 5957.42 E: 6299.59	6253.84	A88	ACCESS ROAD/TBC	N: 5797.94 E: 6241.80	6259.56		
	N: 5957.68 E: 6267.59	6262.56	A69	TOE	N: 6020.76 E: 6300.10	6254.71	A89	ACCESS ROAD/TBC	N: 5782.76 E: 6241.68	6259.26		
	N: 6021.01 E: 6268.10	6263.68	A70	TOE	N: 6084.09 E: 6300.61	6255.63	A90	ACCESS ROAD	N: 5800.62 E: 6259.92	6259.90		
	N: 6084.35 E: 6268.62	6264.63	A71	TOE	N: 6089.73 E: 6303.00	6255.61	A91	ACCESS ROAD	N: 5785.78 E: 6262.12	6259.52		
	N: 6112.54 E: 6280.56	6263.21	A72	TOE	N: 6091.96 E: 6316.26	6255.16	A92	ACCESS ROAD/TOP	N: 5805.60 E: 6275.42	6257.62		
	N: 6123.99 E: 6310.25	6263.54	A73	TOE	N: 6089.19 E: 6324.83	6255.54	A93	ACCESS ROAD/TOP	N: 5795.40 E: 6287.73	6256.54		
	N: 6123.57 E: 6316.42	6263.15	A74	OUTLET STRUCTURE	N: 5829.64 E: 6334.38	6251.33	A94	ACCESS ROAD/TOE	N: 5822.65 E: 6311.52	6252.12		
	N: 6053.91 E: 6339.33	6255.16	A75	TRICKLE CHANNEL	N: 5839.12 E: 6325.05	6251.40	A97	WQCV WSEL 12" CLASS 6 ABC BELOW	N: 5823.36 E: 6294.85	6253.49		
	N: 6012.43 E: 6340.76	6254.59	A76	TRICKLE CHANNEL	N: 5861.60 E: 6321.19	6251.52		8" CLASS 6 ABC ABOVE WQCV WSEL				
	N: 5989.23 E: 6340.05	6254.33	A77	TRICKLE CHANNEL INTERSECTION	N: 5876.29 E: 6328.05	6251.61	A98	12" CLASS 6 ABC BELOW 8" CLASS 6 ABC ABOVE	N: 5812.97 E: 6305.95	6253.49		
	N: 5965.33 E: 6342.10	6253.91	A78	TRICKLE CHANNEL	N: 5883.34 E: 6329.62	6251.67						
	N: 5948.88 E: 6342.83	6253.57	A79	TRICKLE CHANNEL	N: 5912.62 E: 6330.80	6252.04						
	N: 5923.02 F: 6343.05	6253.04	A80	TRICKLE CHANNEL	N: 5936.39 F: 6328.91	6252.35						

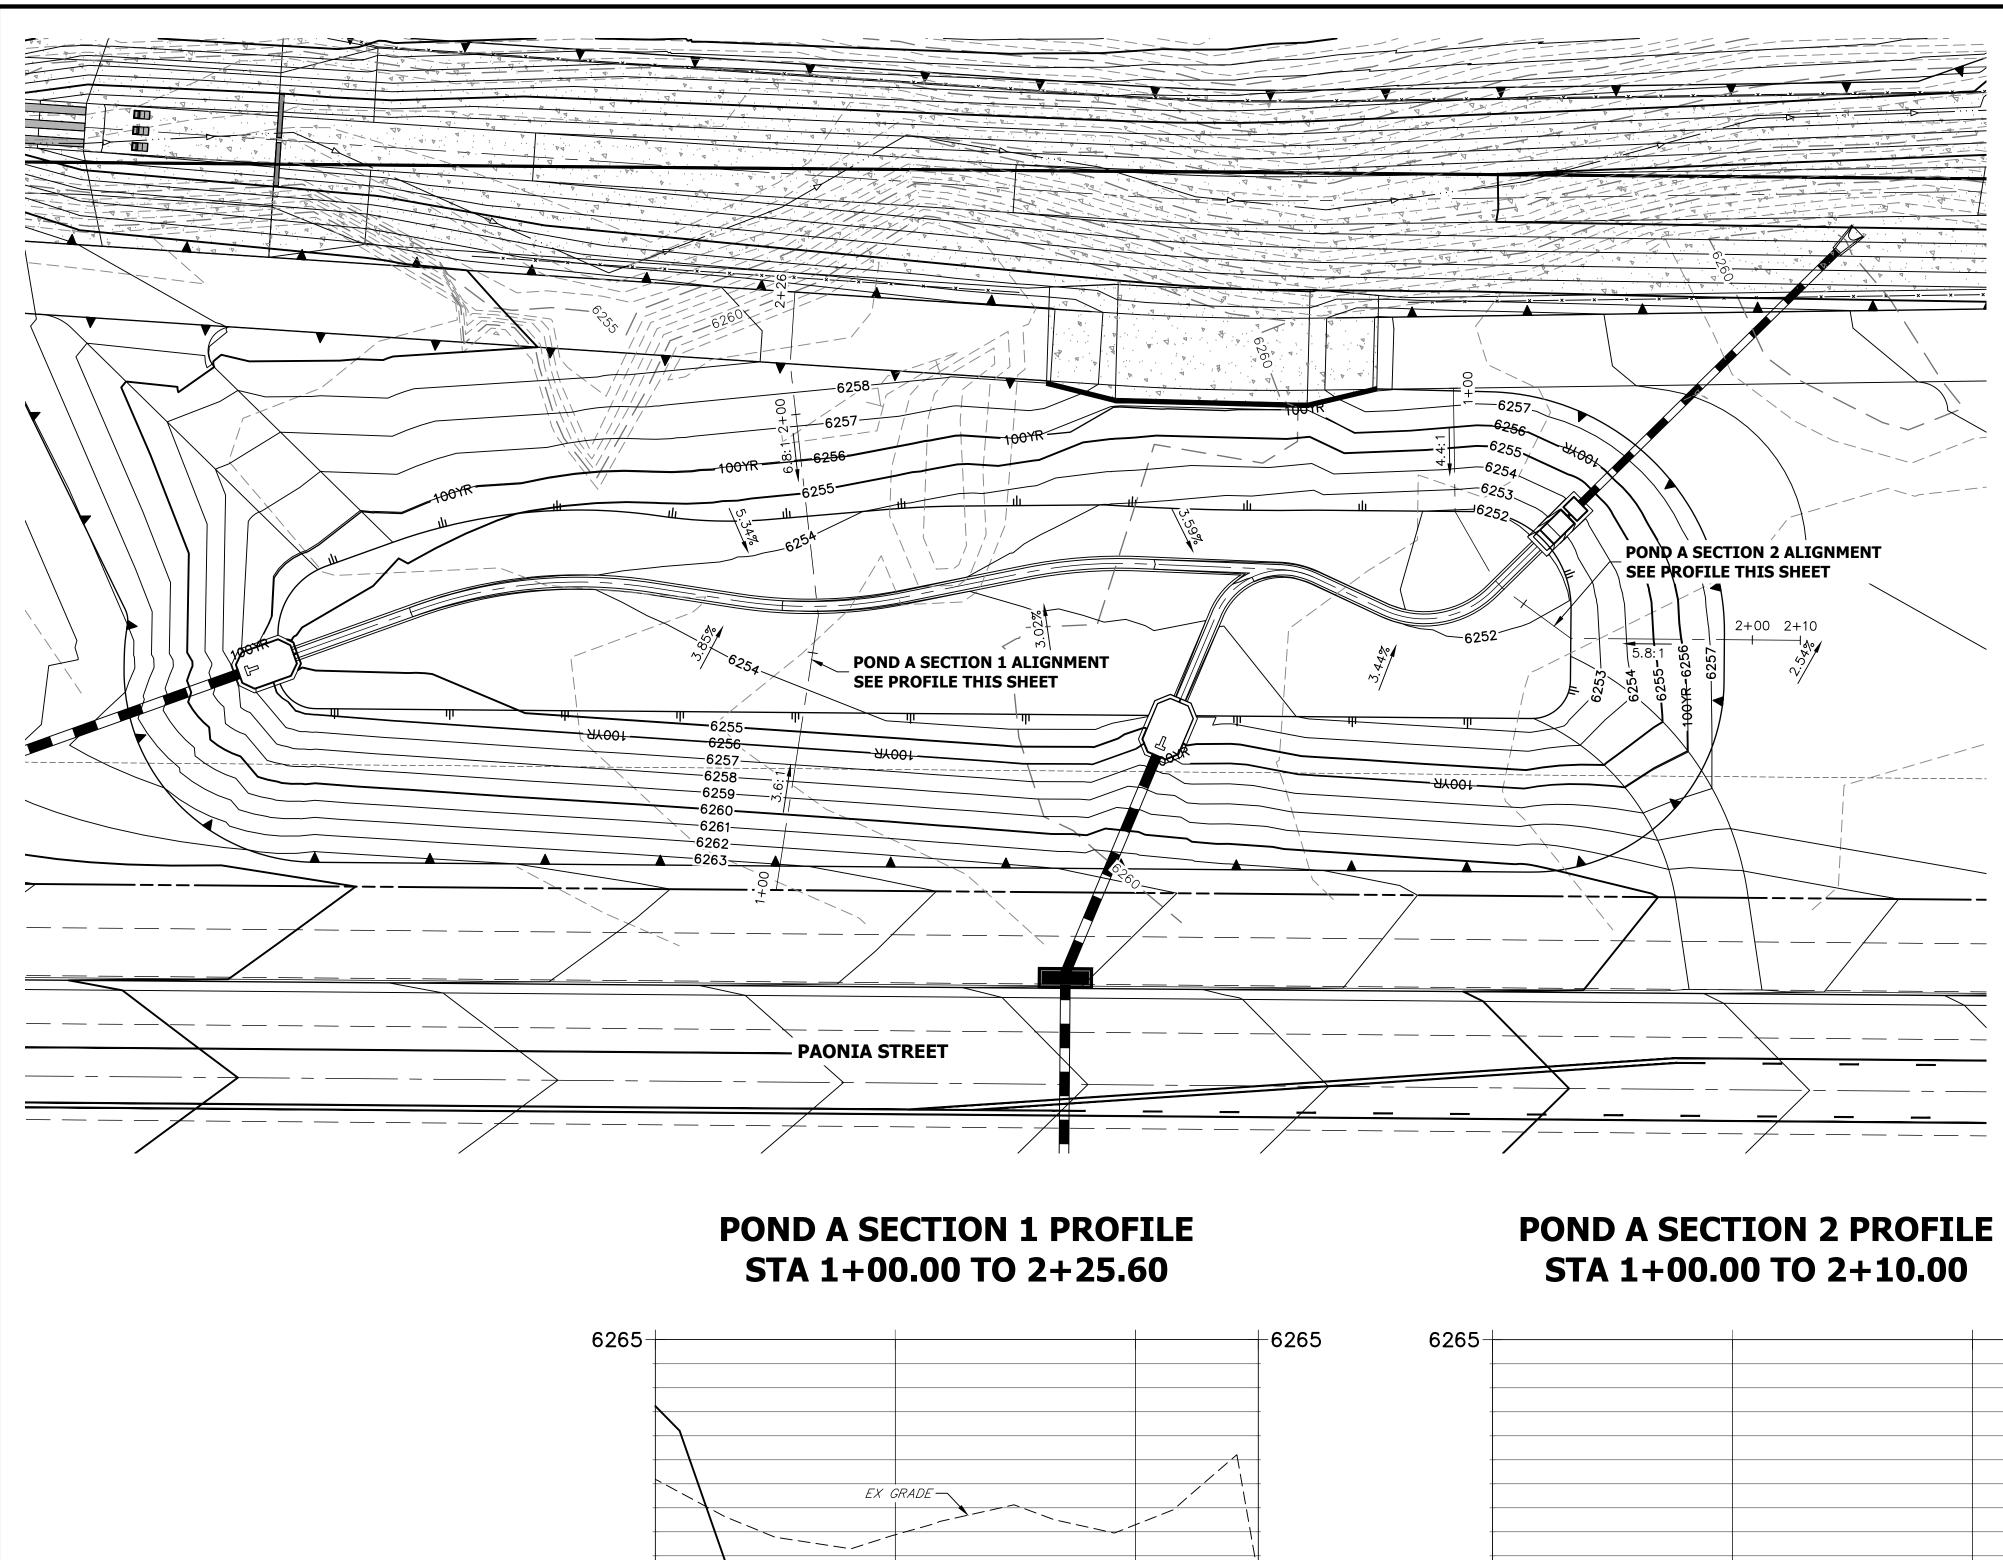

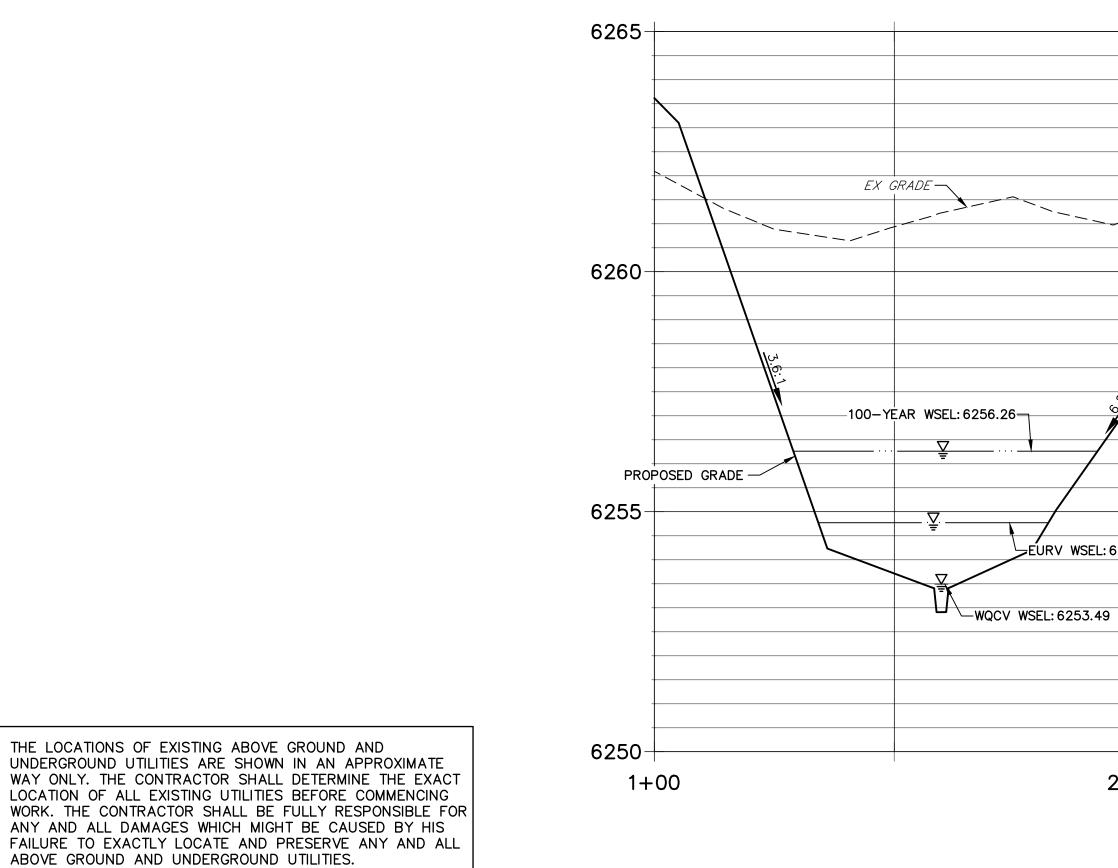

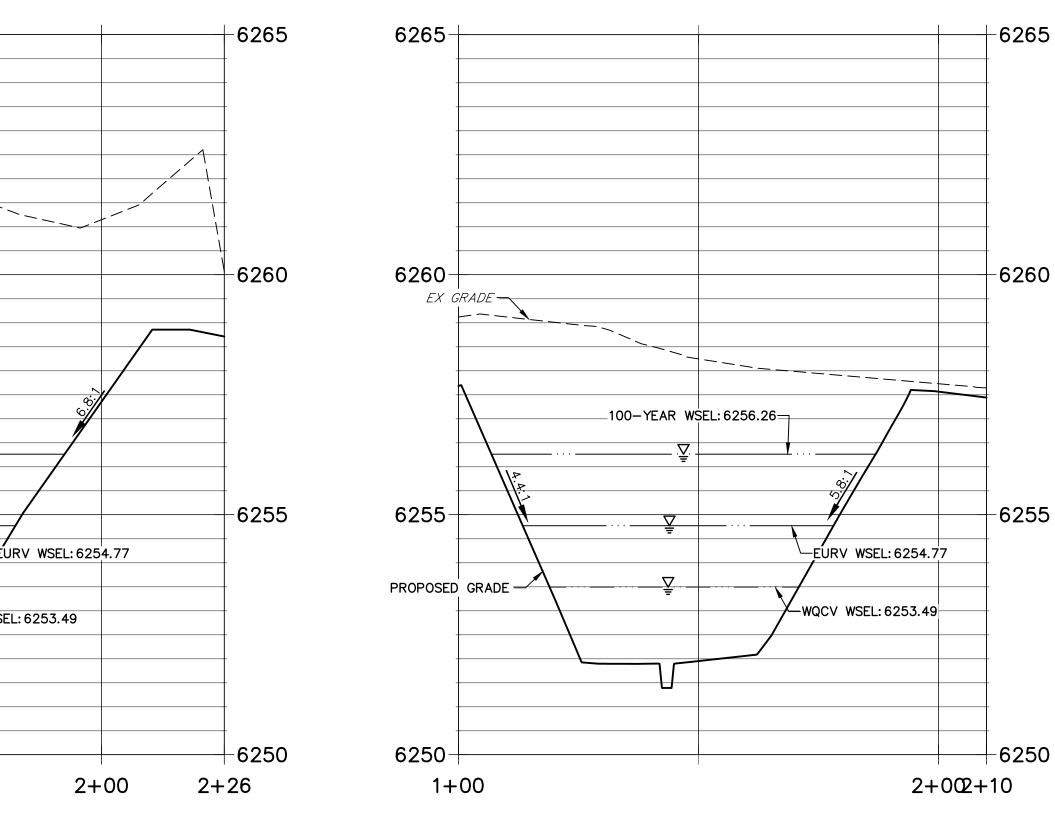

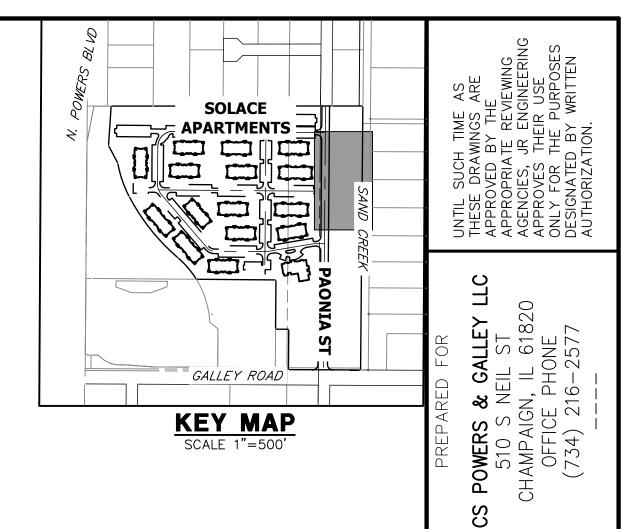

EERING

ENG


J·R

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NOTES

UTILITIES.

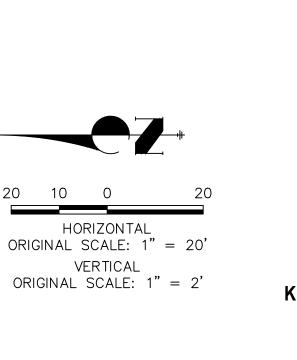- 1. ALL PROPOSED POND IMPROVEMENTS ARE PRIVATE UNLESS OTHERWISE NOTED. 2. SEE SHEETS 12-15 FOR PROPOSED STORM SEWER DESIGN.
- 3. SEE PAONIA STREET IMPROVEMENT PLANS BY JR ENGINEERING FOR PROPOSED PAONIA STREET DESIGN. 4. SEE WATER DISTRIBUTION PLANS AND SANITARY SEWER PLAN AND PROFILE BY JR ENGINERING FOR PROPOSED DESIGN OF CMD-OWNED WATER AND SANITARY





FILING

APARTMENTS NO. 1

S

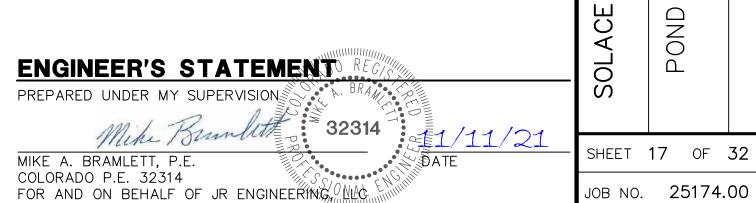
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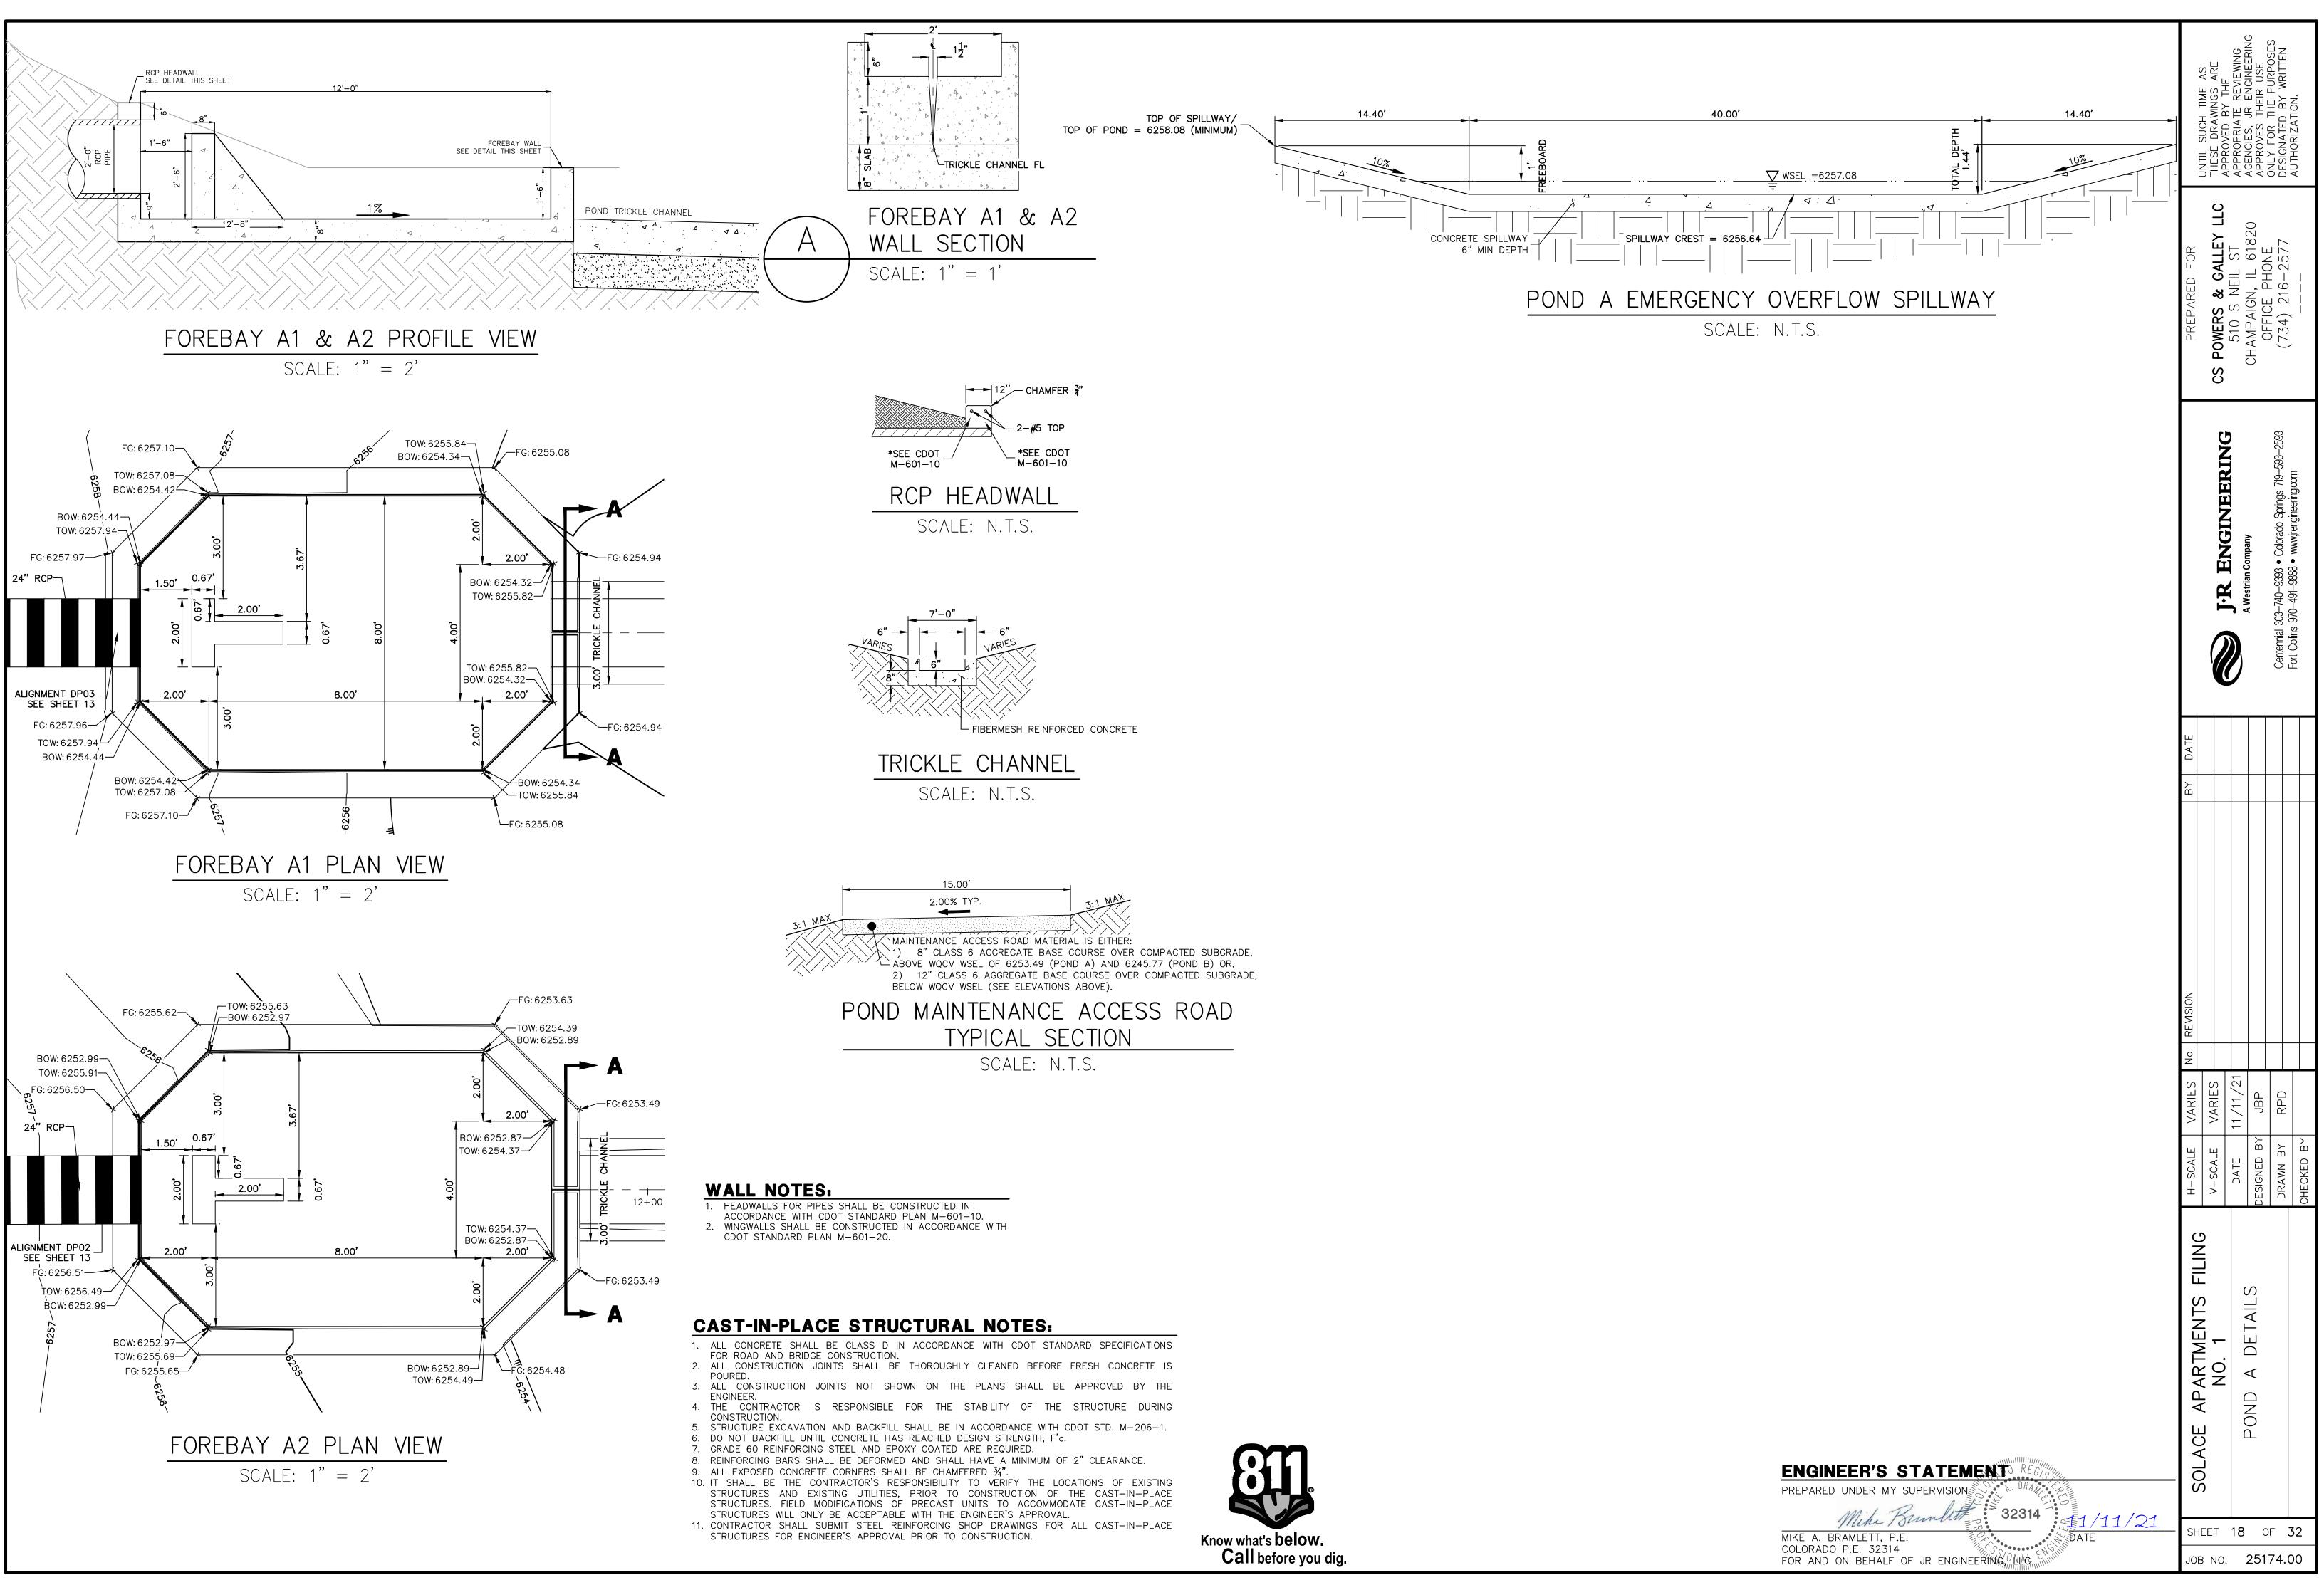
A PLAN & Sections


OND

Ω

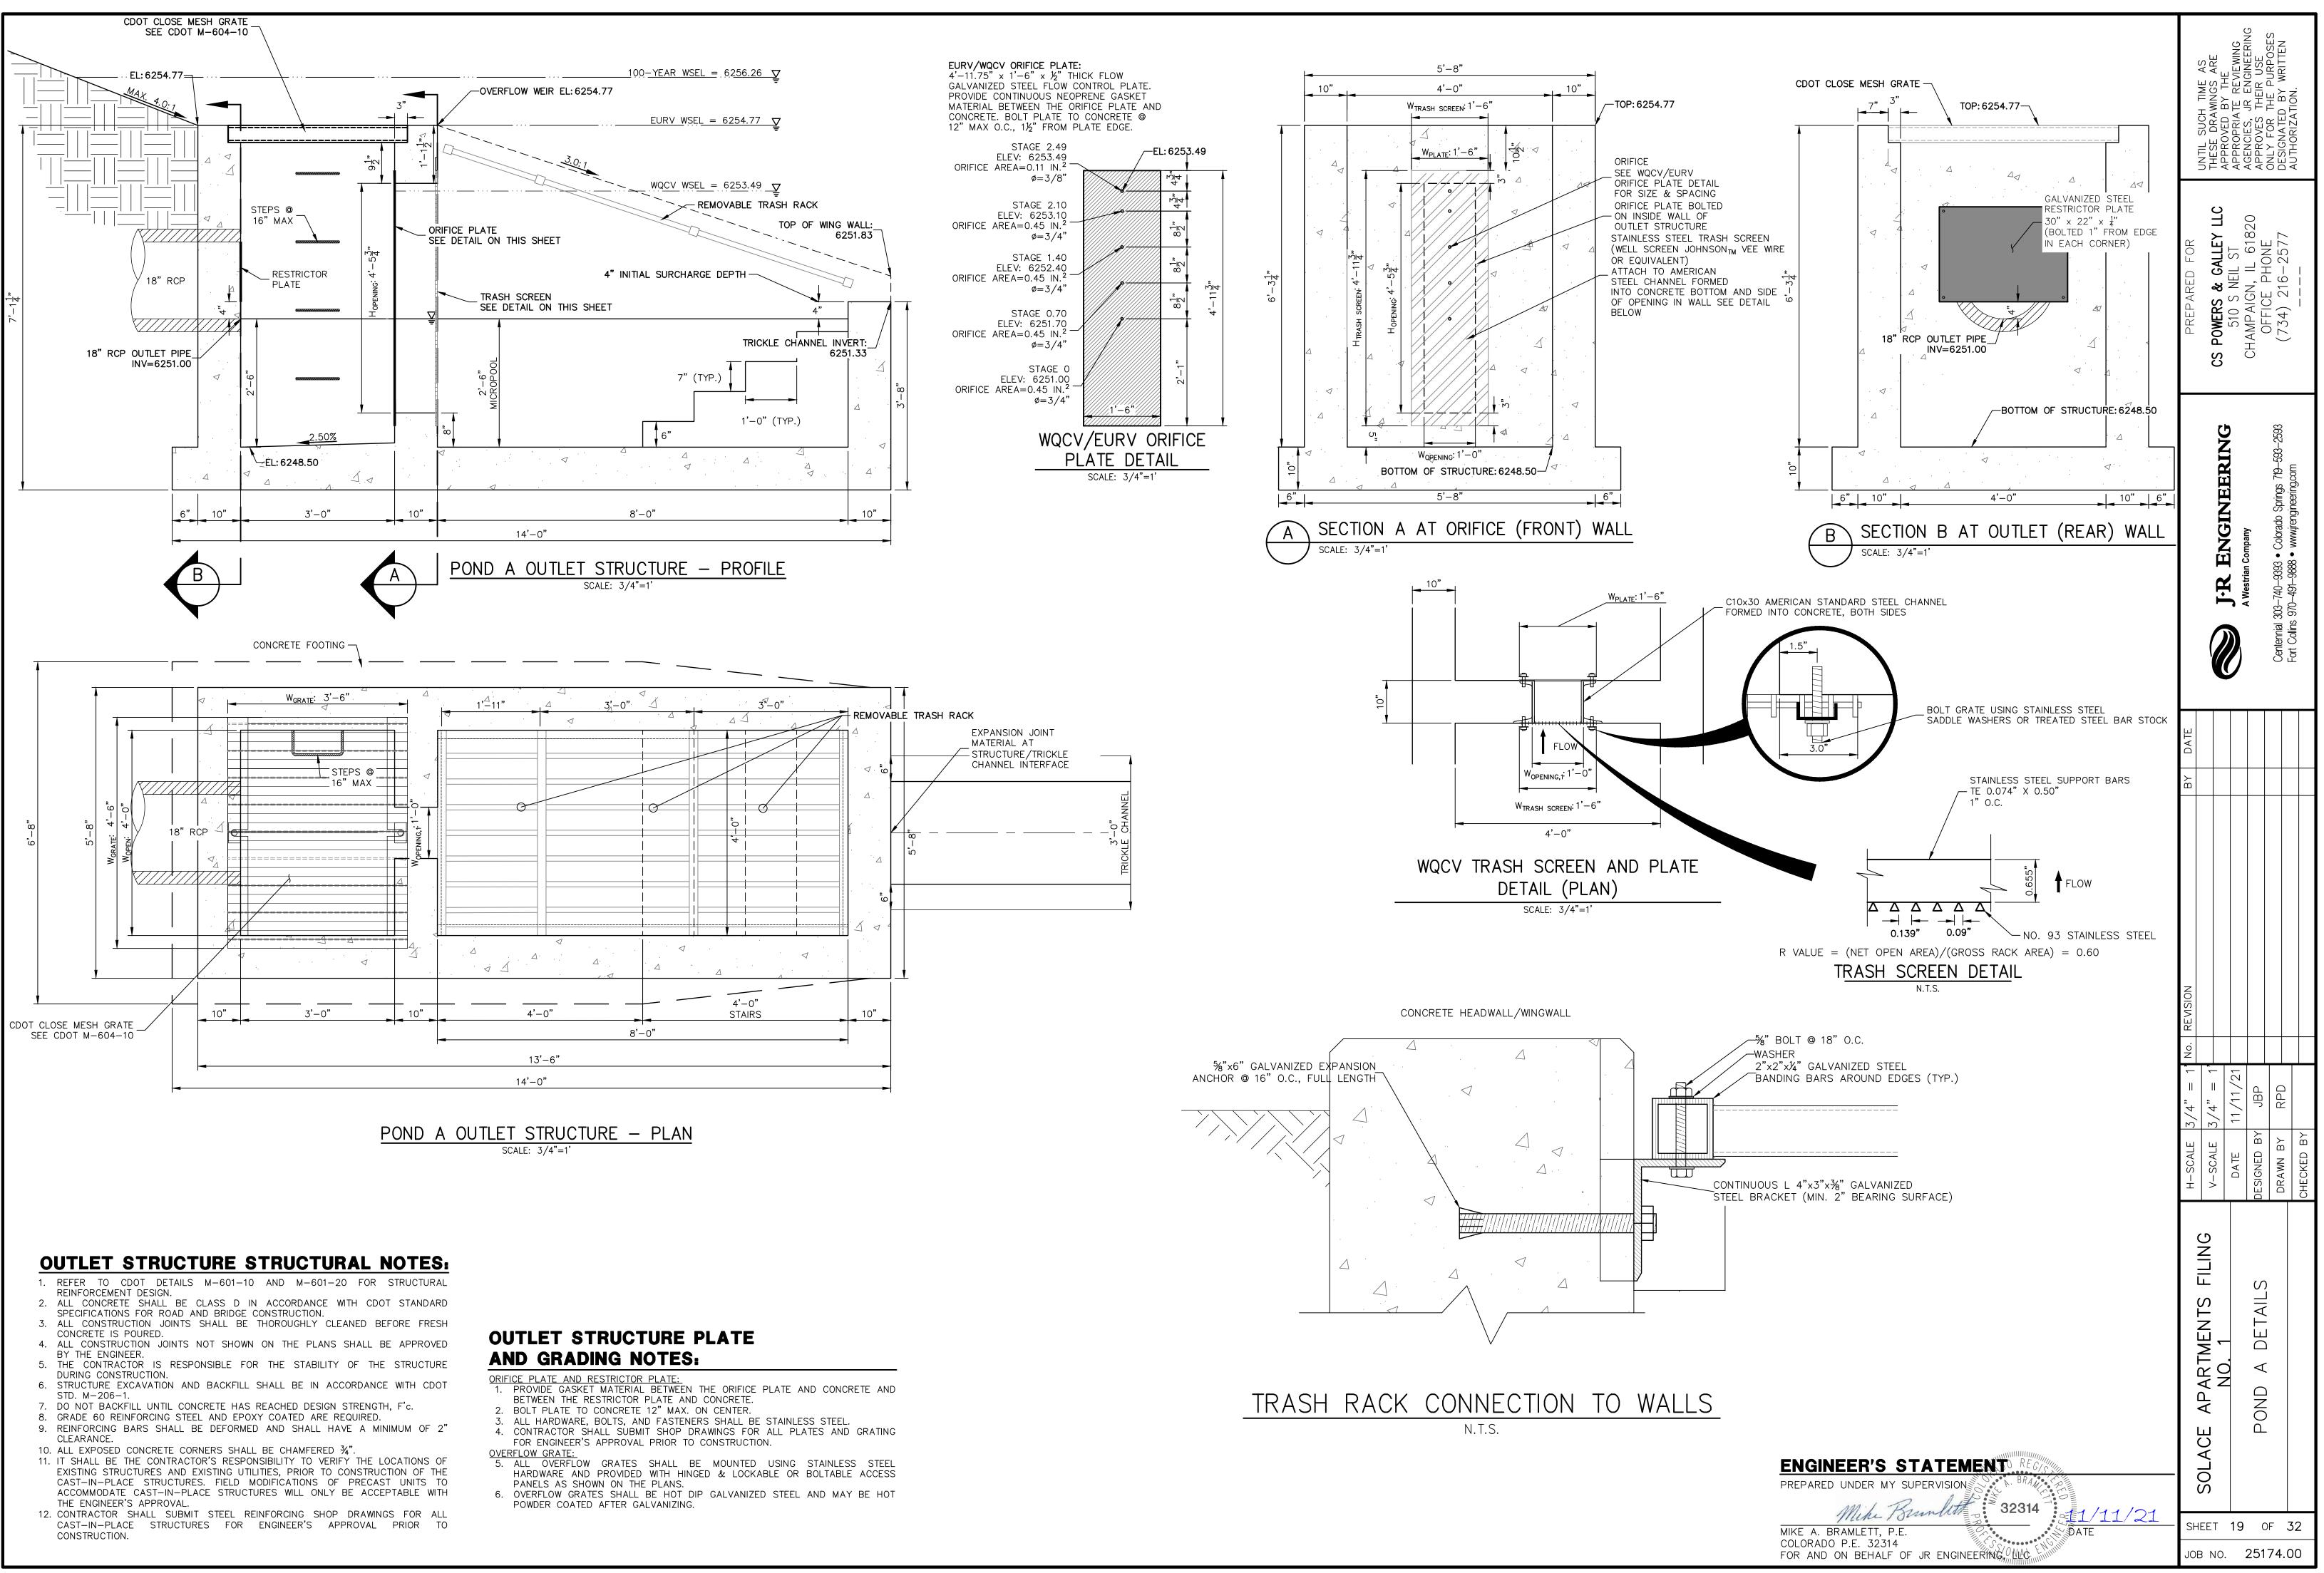
Know what's **below.** Call before you dig.











		TABULATION				TABULATION				TABULATION				TABULATION			POINT TABUL		
ID NO.	DESCRIPTION	NORTHING/EASTING	ELEVATION	ID NO.	DESCRIPTION		ELEVATION	ID NO.	DESCRIPTION		G ELEVATION	ID NO.	DESCRIPTION	NORTHING/EASTING	ELEVATION	ID NO.	DESCRIPTION	NORTHING/EASTING	ELEVATION
B1	TBC/ACCESS ROAD	N: 5025.91 E: 6235.89	6248.51	B21	ACCESS ROAD	N: 5511.78 E: 6371.95	6253.53	B41	TOP	N: 5446.78 E: 6280.21	6253.13	B61	TRICKLE CHANNEL INTERSECTION	N: 5079.32 E: 6325.67	6243.69	B81	ACCESS ROAD	N: 5282.13 E: 6247.84	6251.81
B2	TBC/ACCESS ROAD	N: 5010.91	6248.21	B22	ACCESS ROAD	N: 5511.99	6253.23	B42	TOP	N: 5458.30	6253.40	B62	TRICKLE CHANNEL	N: 5131.15 E: 6317.27	6243.95	B82	ACCESS ROAD/TOP	N: 5291.17 E: 6267.20	6251.36
В3	ACCESS ROAD/TOP	E: 6235.77 N: 5026.87	6250.00	B23	ACCESS ROAD	E: 6386.95 N: 5541.49	6253.83	B43	TOE	E: 6308.56 N: 5408.79	6247.07	B63	TRICKLE CHANNEL	N: 5158.88	6244.09	B83	ACCESS ROAD/TOP	N: 5267.23	6249.96
	· · · · · · · · · · · · · · · · · · ·	E: 6305.94 N: 5011.88	6249.72			E: 6371.54 N: 5541.69				E: 6348.36 N: 5394.18				E: 6316.67 N: 5228.73				E: 6267.01 N: 5268.21	6249.46
B4	ACCESS ROAD	E: 6306.15 N: 5027.46		B24	ACCESS ROAD	E: 6386.54 N: 5469.66	6253.53	B44	TOE	E: 6349.56 N: 5258.63	6246.69	B64	TRICKLE CHANNEL	E: 6324.92 N: 5264.87	6244.45	B84	ACCESS ROAD	E:6282.14	
B5	ACCESS ROAD/TOP	E:6348.58	6251.05	B25	ACCESS ROAD	E: 6350.16	6252.52	B45	TOE	E:6351.42	6246.12	B65	TRICKLE CHANNEL	E:6322.59	6244.63	B85	ACCESS ROAD	N: 5265.60 E: 6267.37	6249.76
B6	ACCESS ROAD	N: 5012.46 E: 6348.79	6250.75	B26	ACCESS ROAD/TOP	N: 5462.40 E: 6363.28	6252.82	B46	TOE	N: 5213.09 E: 6352.04	6245.98	B66	TRICKLE CHANNEL	N: 5297.41 E: 6321.68	6244.79	B86	ACCESS ROAD/TOE	N: 5220.07 E: 6290.63	6246.15
B7	ACCESS ROAD/TOP	N: 5036.54 E: 6369.67	6251.06	B27	ACCESS ROAD/TOP	N: 5462.64 E: 6346.27	6251.56	B47	TOE	N: 5133.09 E: 6353.14	6245.80	B67	TRICKLE CHANNEL	N: 5356.40 E: 6333.08	6245.10	B87	ACCESS ROAD/TOE	N: 5137.47 E: 6289.96	6245.52
B8	ACCESS ROAD	N: 5026.08 E: 6380.43	6250.83	B28	ACCESS ROAD/TOE	N: 5433.54 E: 6330.18	6247.58	B48	TOE	N: 5060.84 E: 6354.13	6244.32	B68	TRICKLE CHANNEL	N: 5389.88 E: 6314.94	6245.30	B88	WQCV WSEL 12" CLASS 6 ABC BELOW	N: 5159.23 E: 6286.13	6245.77
B9	ACCESS ROAD/TOP	N: 5057.87 E: 6378.17	6251.08	B29	ACCESS ROAD/TOE	N: 5424.86 E: 6342.52	6247.44	B49	TOE	N: 5051.46 E: 6344.88	6244.35	B69	FOREBAY	N: 5395.23 E: 6301.80	6245.37]	8" CLASS 6 ABC ABOVE WQCV WSEL		
B10	ACCESS ROAD	N: 5058.07 E: 6393.17	6250.78	B30	SPILLWAY	N: 5133.27 E: 6398.16	6249.73	B50	TOE	N: 5050.87 E: 6305.61	6245.32	B70	TRICKLE CHANNEL	N: 5094.53 E: 6313.73	6243.79	B89	12" CLASS 6 ABC BELOW 8" CLASS 6 ABC ABOVE/TOE	N: 5179.45 E: 6290.30	6245.77
D 11	ACCESS ROAD/	N: 5133.42	0051.44	B31	SPILLWAY	N: 5213.27	6250.52	B51	TOE	N: 5055.53	6245.50	B71	FOREBAY	N: 5103.28	6243.90	_			
B11	SPILLWAY TOP/ CUTOFF WALL	E: 6377.13	6251.11	B32	ТОР	E: 6397.06 N: 5436.74	6252.26	B52	TOE	E: 6294.11 N: 5067.00	6245.69	B72	ACCESS ROAD	E: 6293.07 N: 5426.42	6247.25	-			
B12	ACCESS ROAD/ SPILLWAY TOP	N: 5133.31 E: 6392.14	6251.11			E: 6370.45 N: 5395.32				E: 6289.39 N: 5154.86				E: 6323.03 N: 5413.47		-			
B13	ACCESS ROAD/ SPILLWAY CREST/	N: 5148.42	6249.61		ACCESS ROAD/TOP	E: 6373.55 N: 5258.96	6252.29	B53	TOE	E: 6290.10 N: 5242.72	6245.57	B73	ACCESS ROAD	E: 6330.59 N: 5423.69	6246.83	-			
	CUTOFF WALL	E: 6376.93		B34	ACCESS ROAD/TOP	E:6375.41	6251.31	B54	TOE	E: 6290.81	6246.28	B74	ACCESS ROAD	E: 6312.77	6247.05	-			
B14	ACCESS ROAD/ SPILLWAY CREST	N: 5148.31 E: 6391.93	6249.64	B35	ТОР	N: 5038.51 E: 6277.19	6250.45	B55	TOE	N: 5330.57 E: 6291.52	6246.82	B75	ACCESS ROAD	N: 5408.69 E: 6312.65	6246.47	_			
B15	ACCESS ROAD/ SPILLWAY CREST/	N: 5198.41 E: 6376.24	6249.61	B36	ТОР	N: 5067.19 E: 6265.39	6251.21	B56	TOE	N: 5418.39 E: 6292.23	6246.85	B76	ACCESS ROAD/TOE	N: 5423.85 E: 6293.26	6246.98				
P10	CUTOFF WALL	N: 5198.31	6240.00	B37	ТОР	N: 5155.05 E: 6266.10	6250.20	B57	TOE	N: 5429.67 E: 6297.05	6247.13	B77	ACCESS ROAD/TOE	N: 5408.86 E: 6292.16	6246.63				
B16	ACCESS ROAD/	E: 6391.25	6249.62	B38	ТОР	N: 5242.91 E: 6266.81	6249.42	B58	TOE	N: 5434.30 E: 6308.41	6247.40	B78	ACCESS ROAD/TBC	NI- 5007-01	6251.81	1			
B17	SPILLWAY TOP/ CUTOFF WALL	N: 5213.42 E: 6376.04	6251.11	B39	ТОР	N: 5330.77 E: 6267.52	6252.95	B59	OUTLET STRUCTURE	N: 5054 56	6243.51	B79	ACCESS ROAD/TBC	NI- 5080-01	6251.66	-			
B18	ACCESS ROAD/	N: 5213.31 E: 6391.04	6251.11	B40	ТОР	N: 5418.63	6252.85	B60	TRICKLE CHANNEL	N: 5066.08	6243.61	B80	ACCESS ROAD	N: 5297.13	6251.97	-			
B19	SPILLWAY TOP	N: 5460.05	6252.95		101	E:6268.23		800		E: 6334.01				E:6247.96	0201.07				
		E: 6372.66 N: 5460.26			x x x x x x x x x x x x x x x x x x x		x 	×	-x x x x	100YR	6250					COYR -		-100 1R	
B20 - 6250	ACCESS ROAD	E: 6387.66	6252.72			33.35	62 62				6250		A A A A A A A A A A A A A A A A A A A						-6245
		625	00-0-0-0						6250	6245		6245					TARX DRAMACEWAY 624		
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			<u>B26</u> _/	\nearrow	625	50			100YR	0. 	100	YR ——		5					
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		1.36%				-875	<u>B68</u>	04%							ы Карала Кара Кар	L1	0-12+00		
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	-~					ALIGNMENT	DP01 <u>E</u> SHEET_12							\sim			625		ALIGNMENT DP17
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UNDEF	GROUND UTILITIES	TING ABOVE GROUN ARE SHOWN IN AN CTOR SHALL DETER	I APPROXIM																
LOCAT	ON OF ALL EXISTI	NG UTILITIES BEFOR SHALL BE FULLY	RE COMMEN	CING															
ANY A FAILUF	ND ALL DAMAGES E TO EXACTLY LO	WHICH MIGHT BE C	CAUSED BY VE ANY AN	HIS															
ABOVE	GROUND AND UN	DERGROUND UTILITIE	ES.																

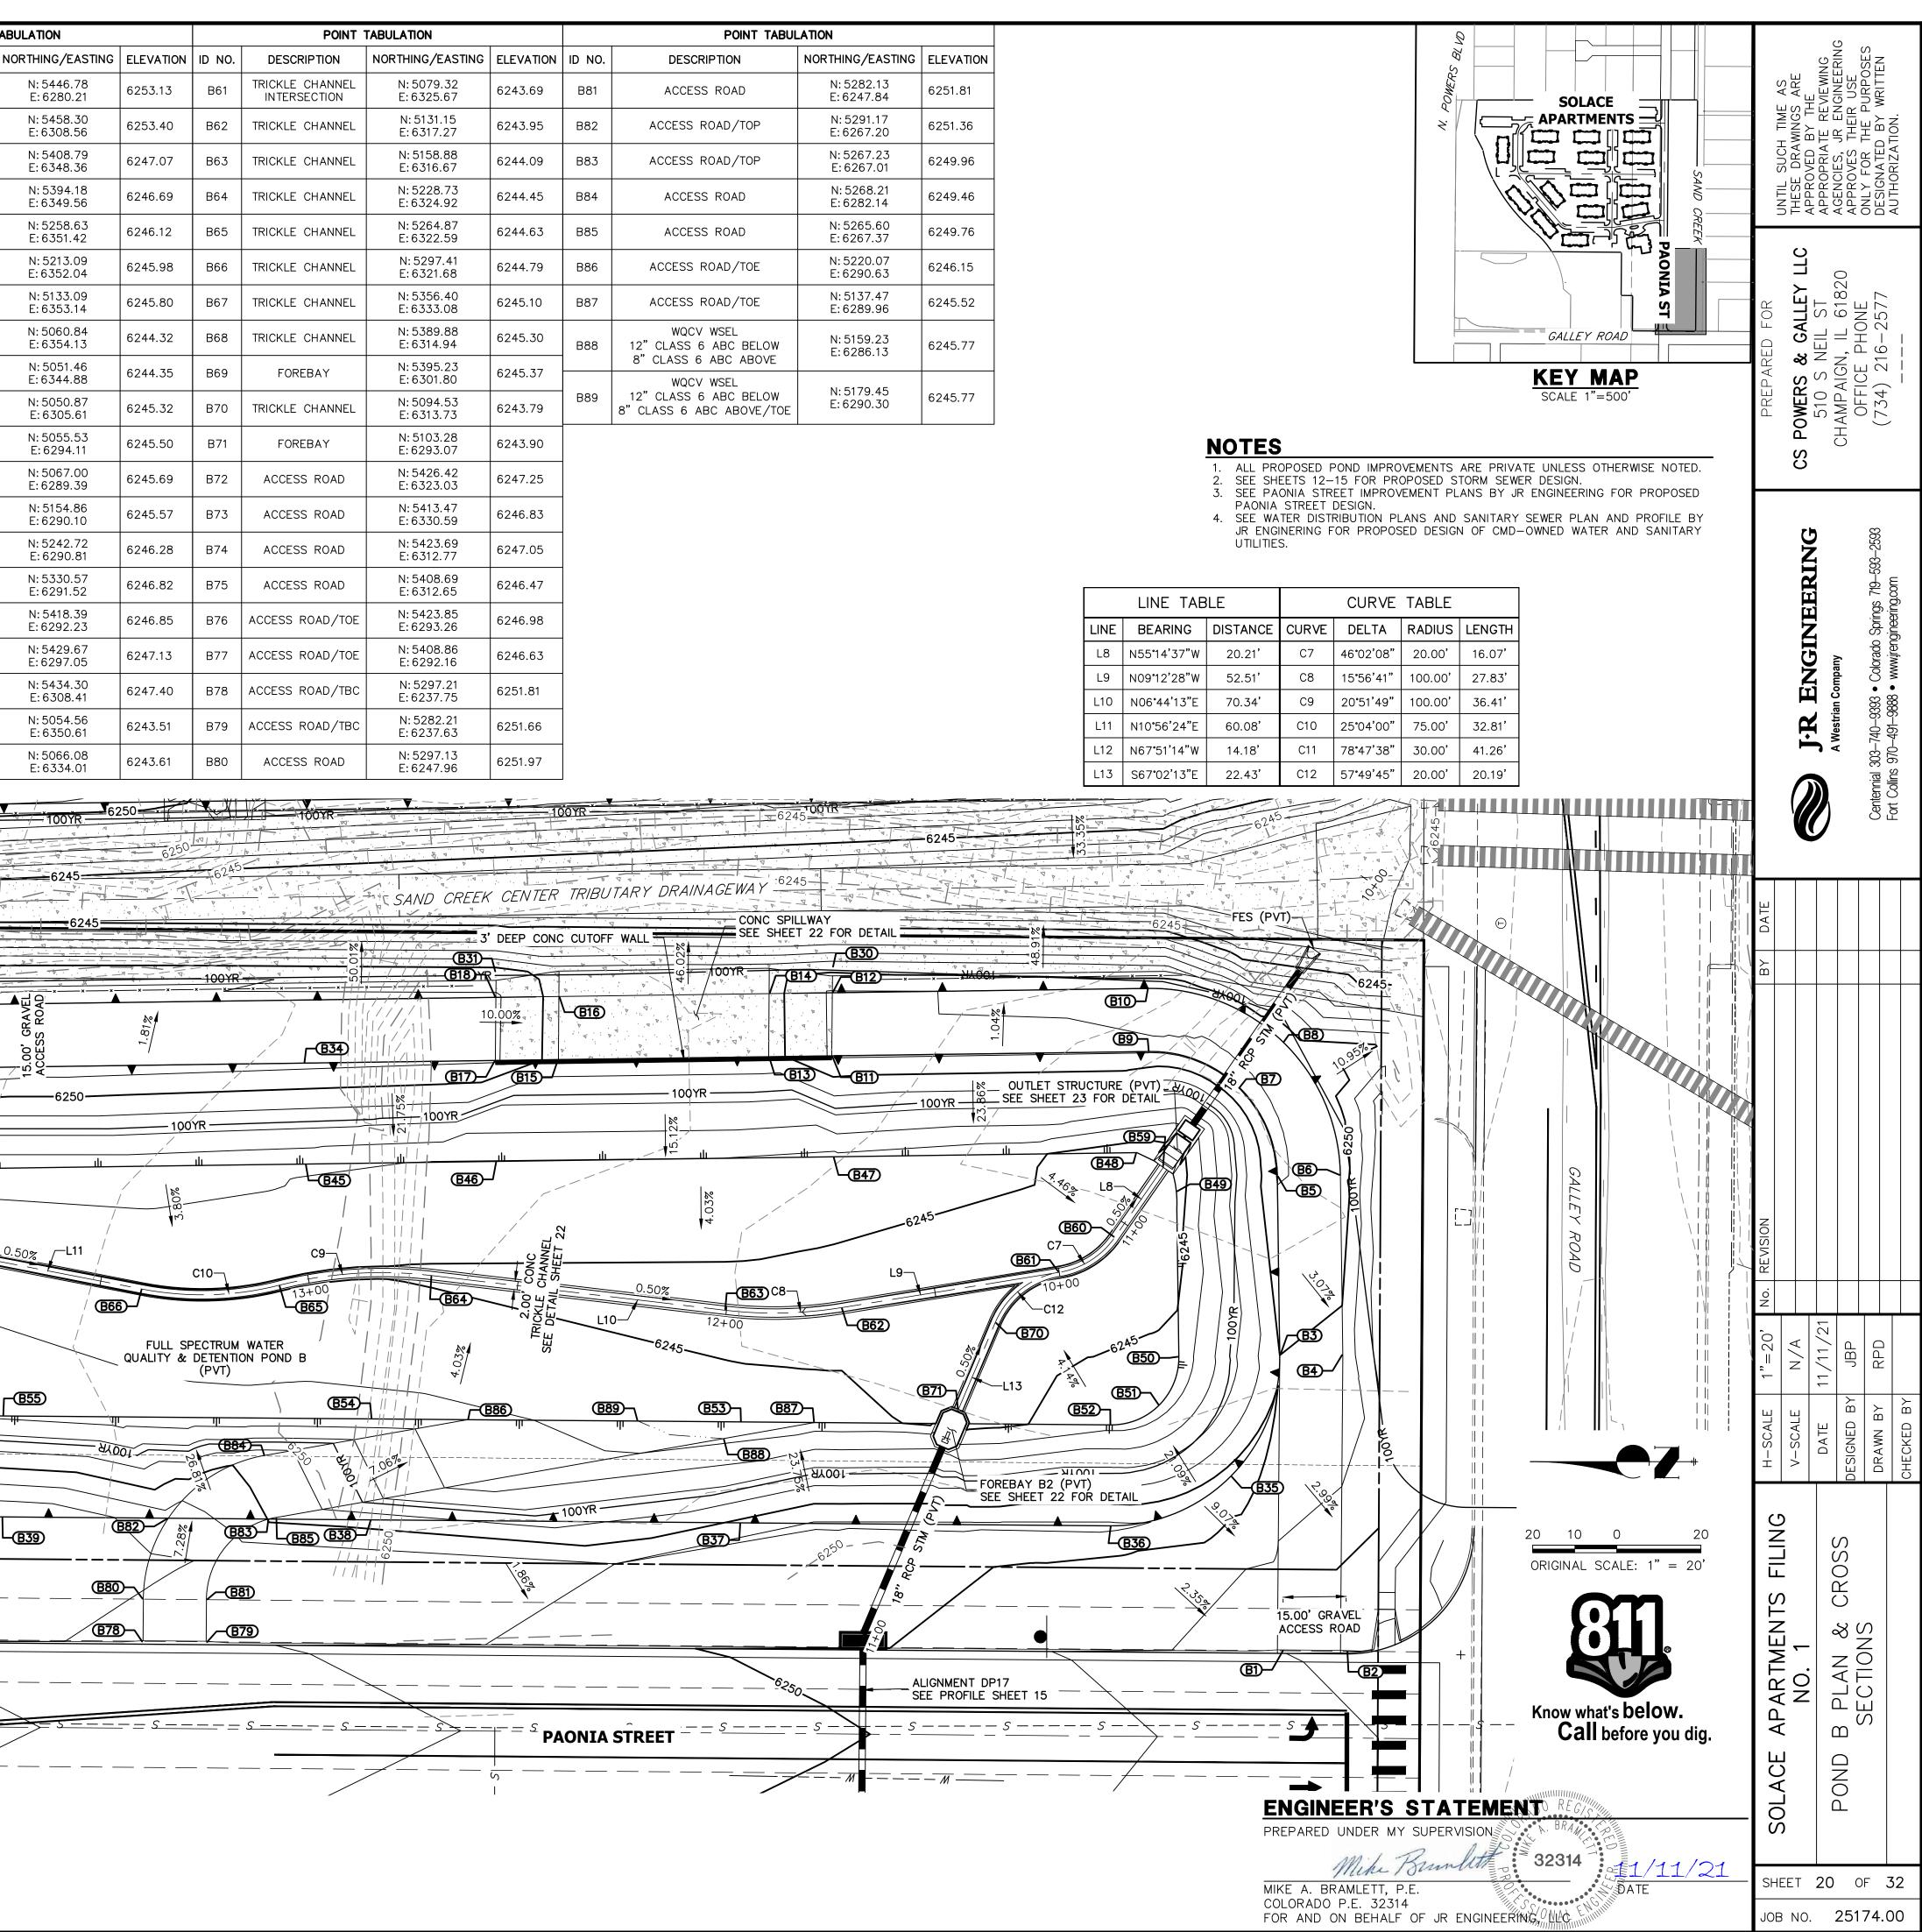


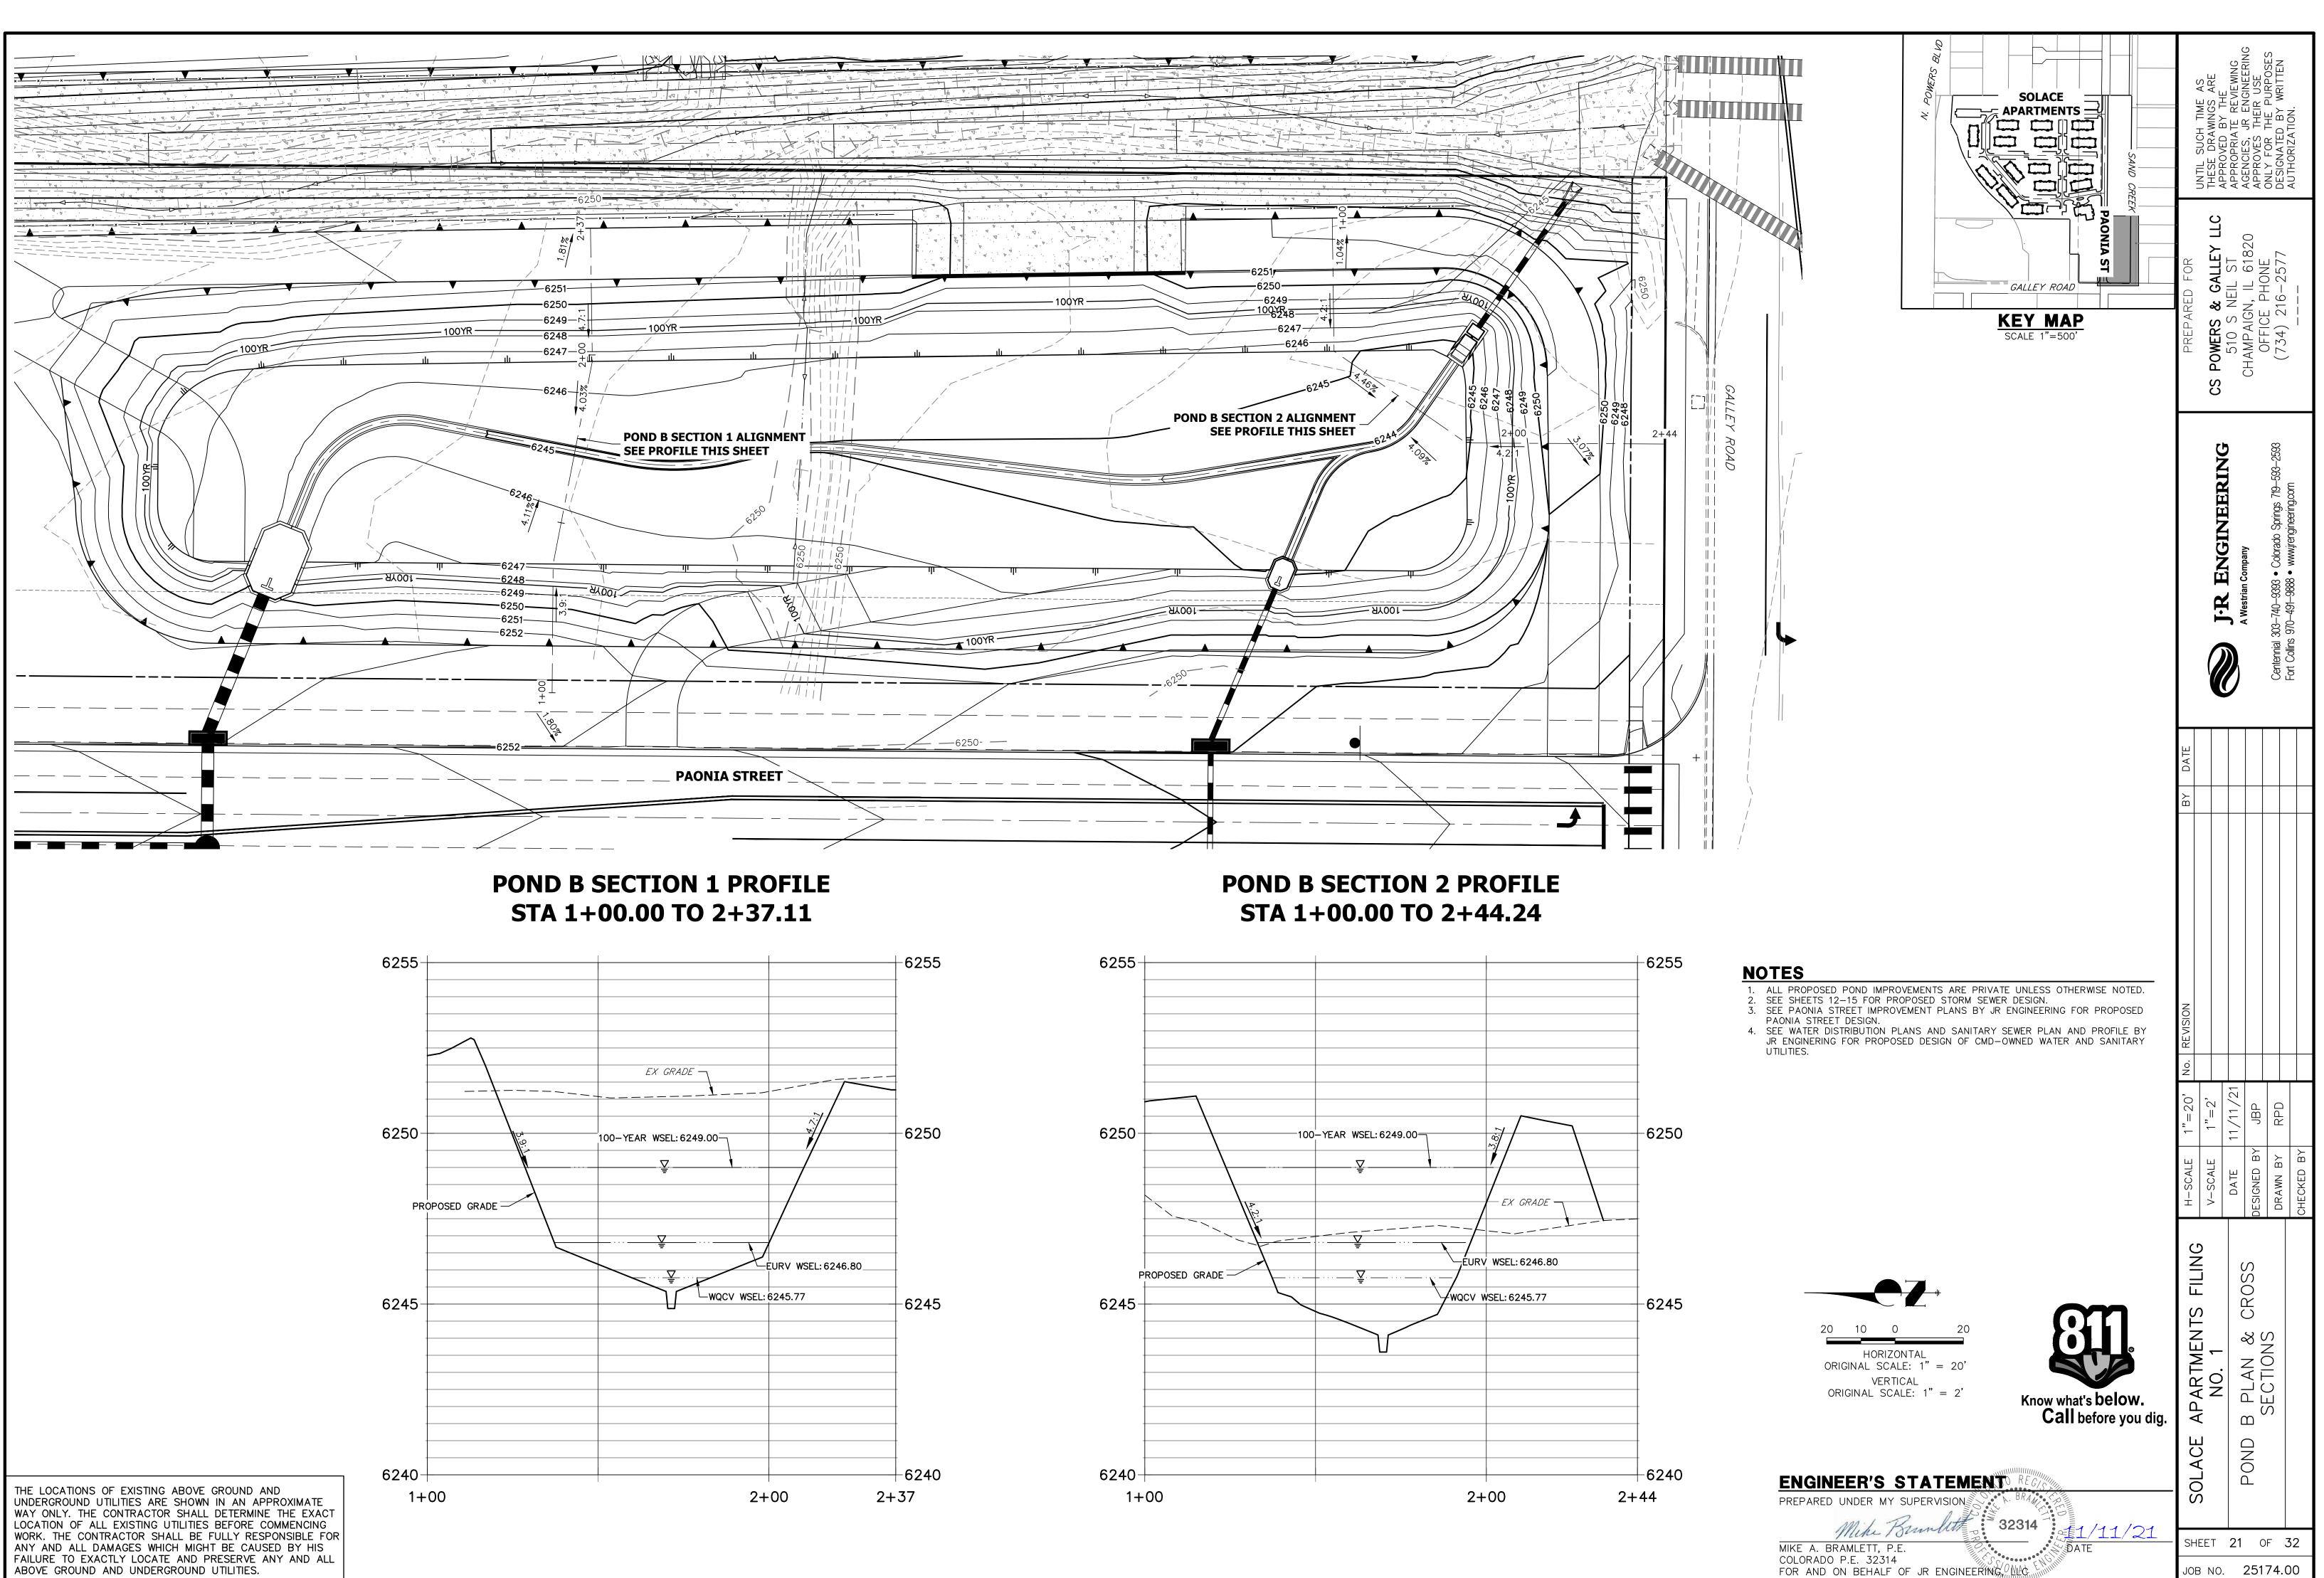


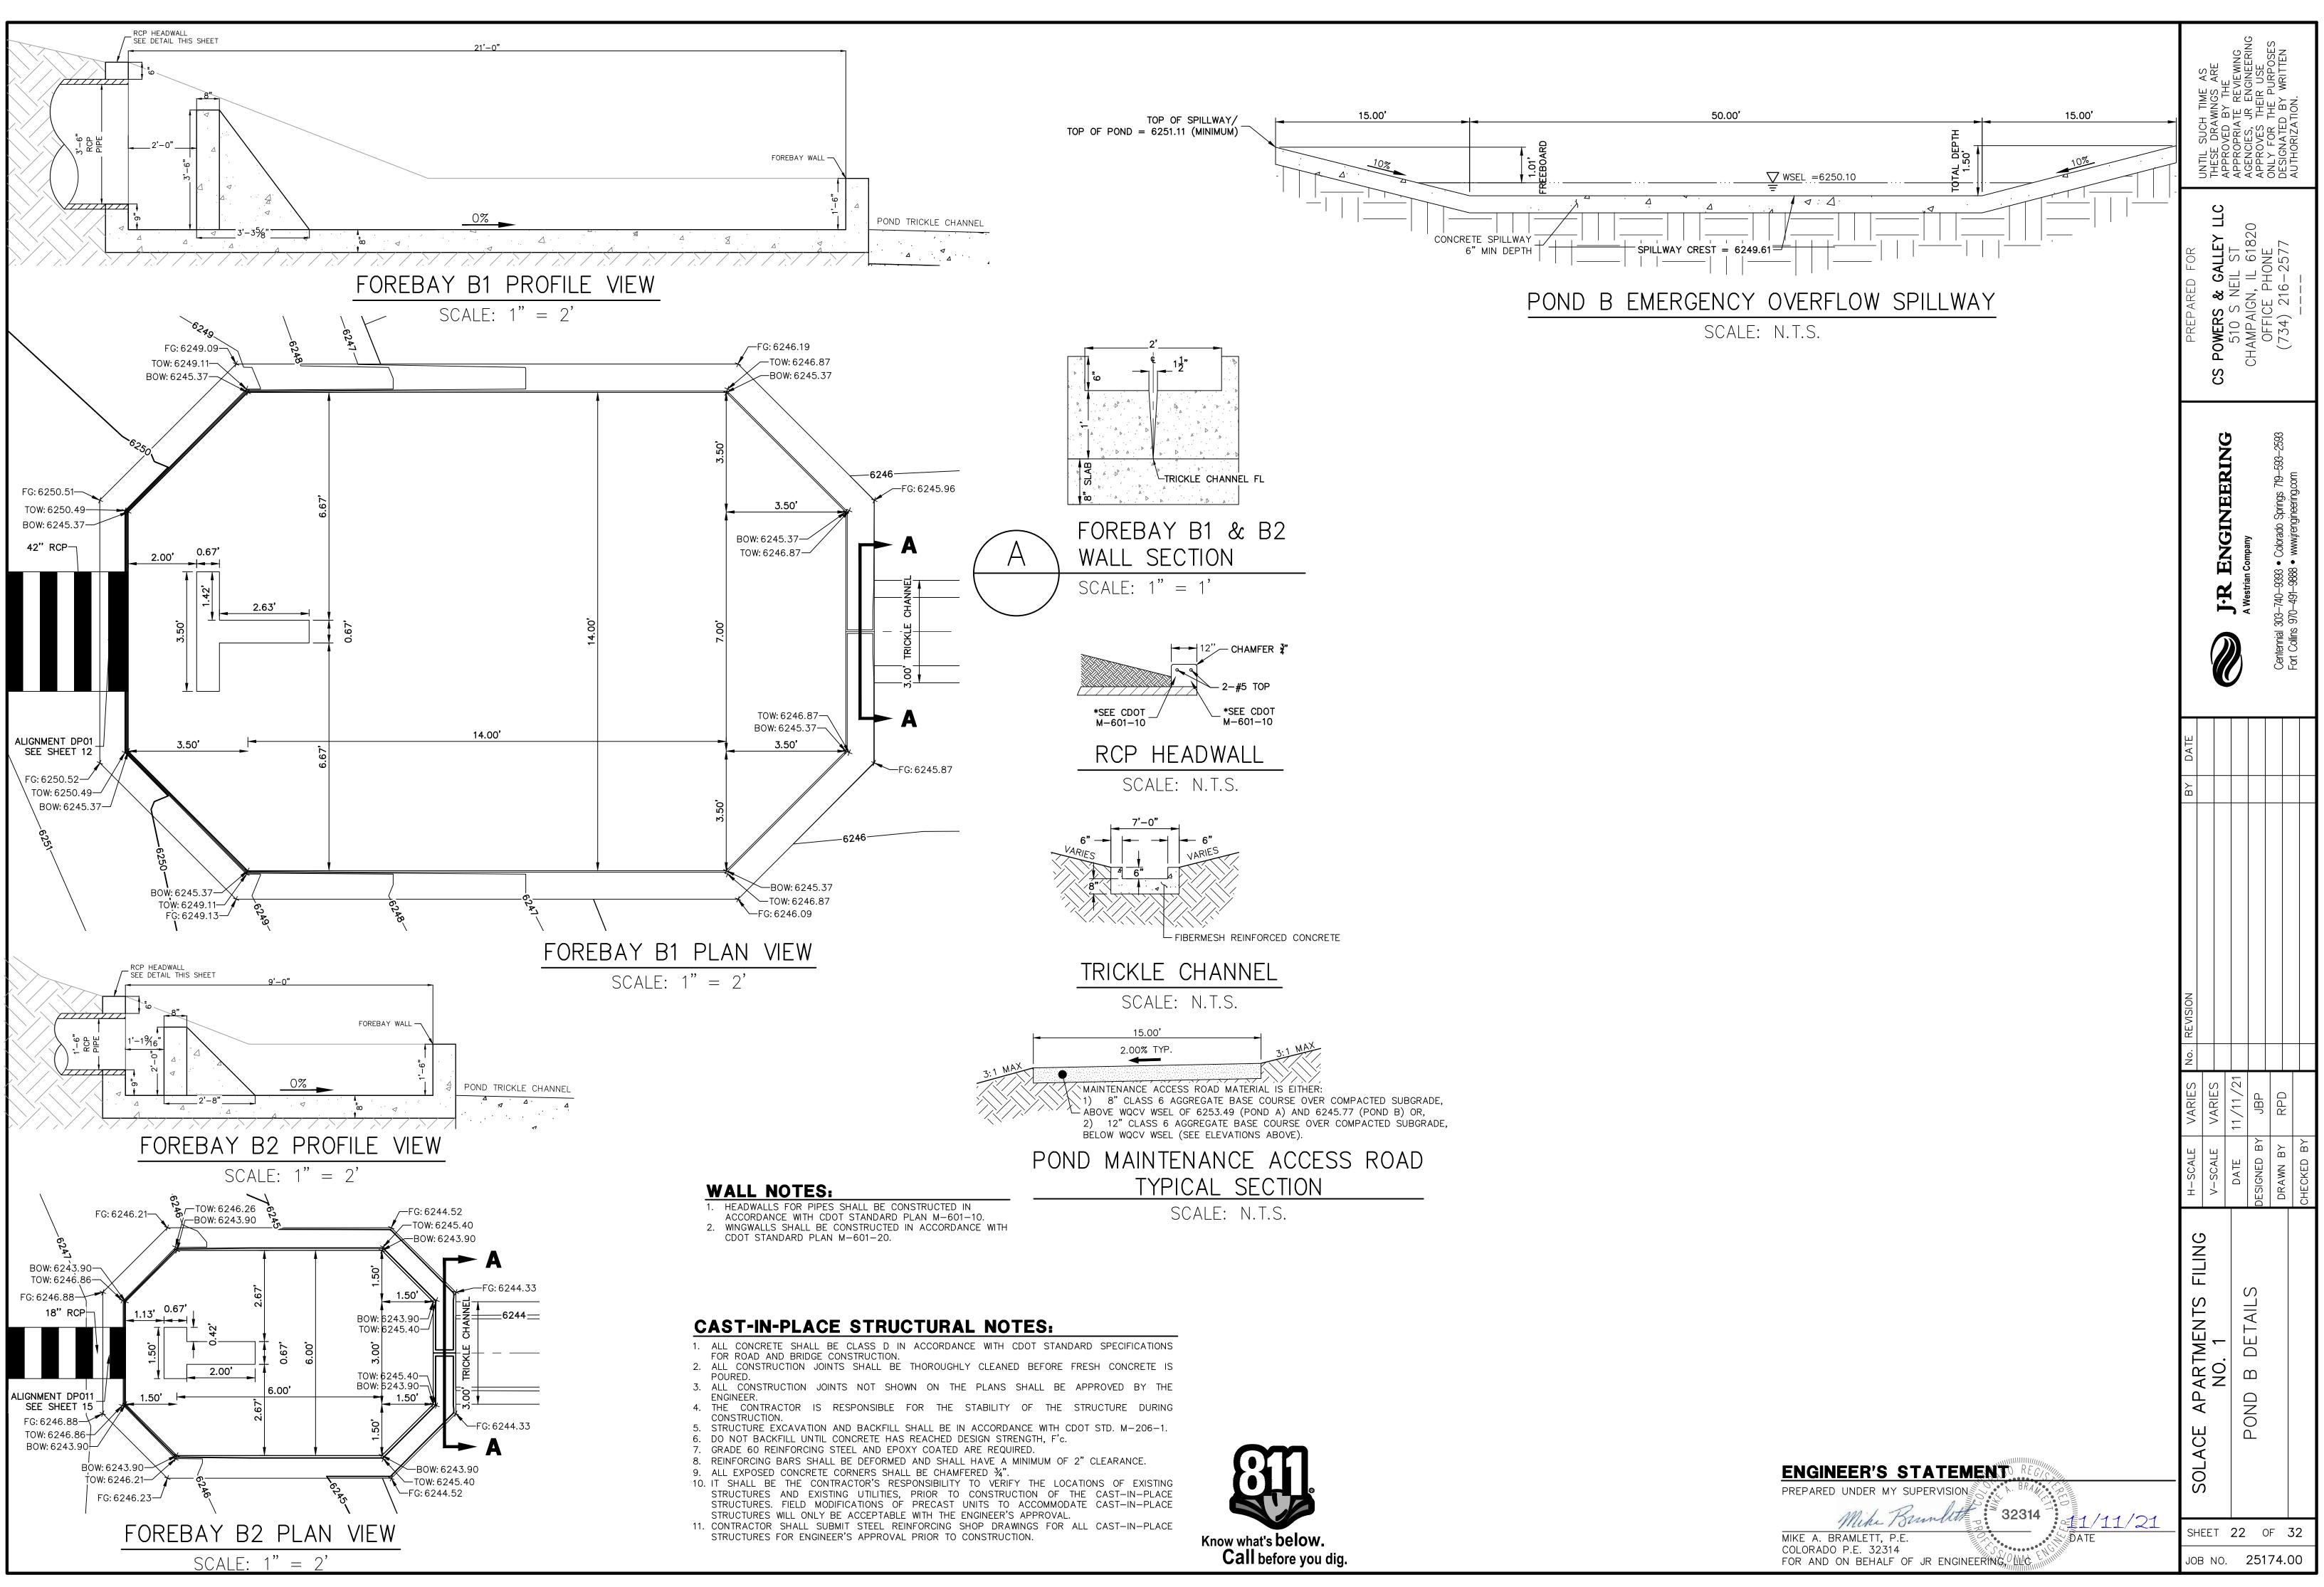


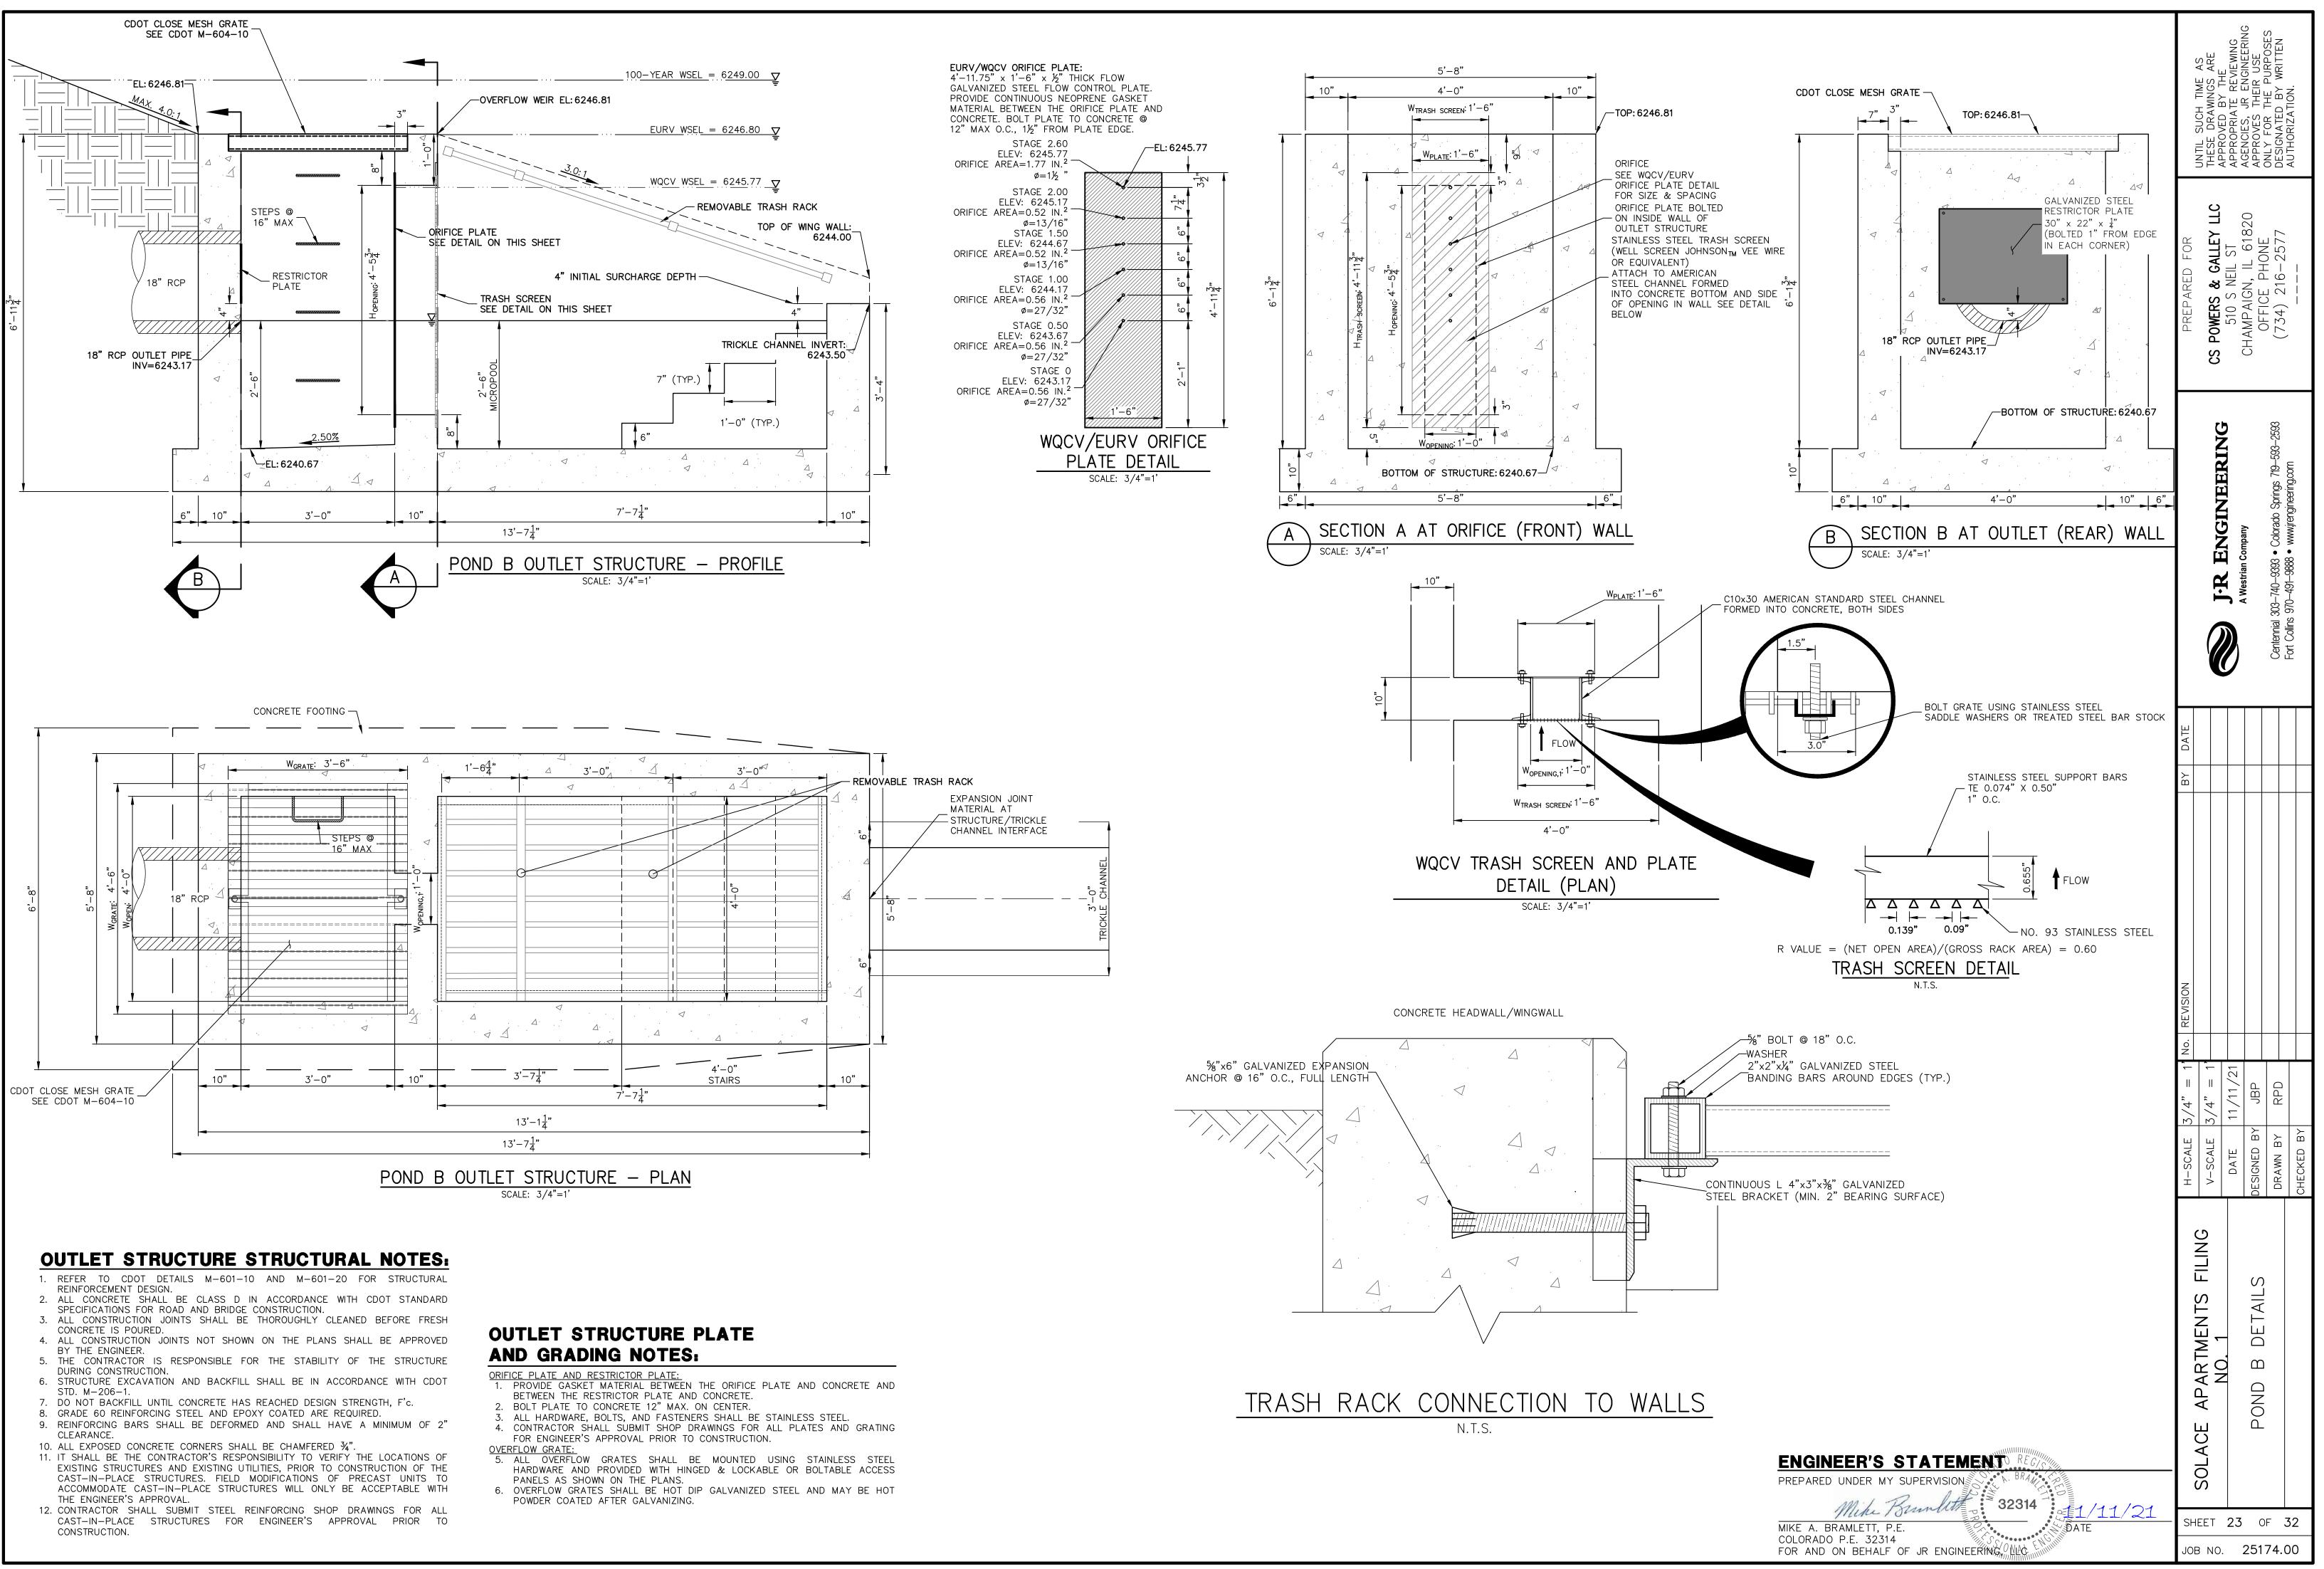


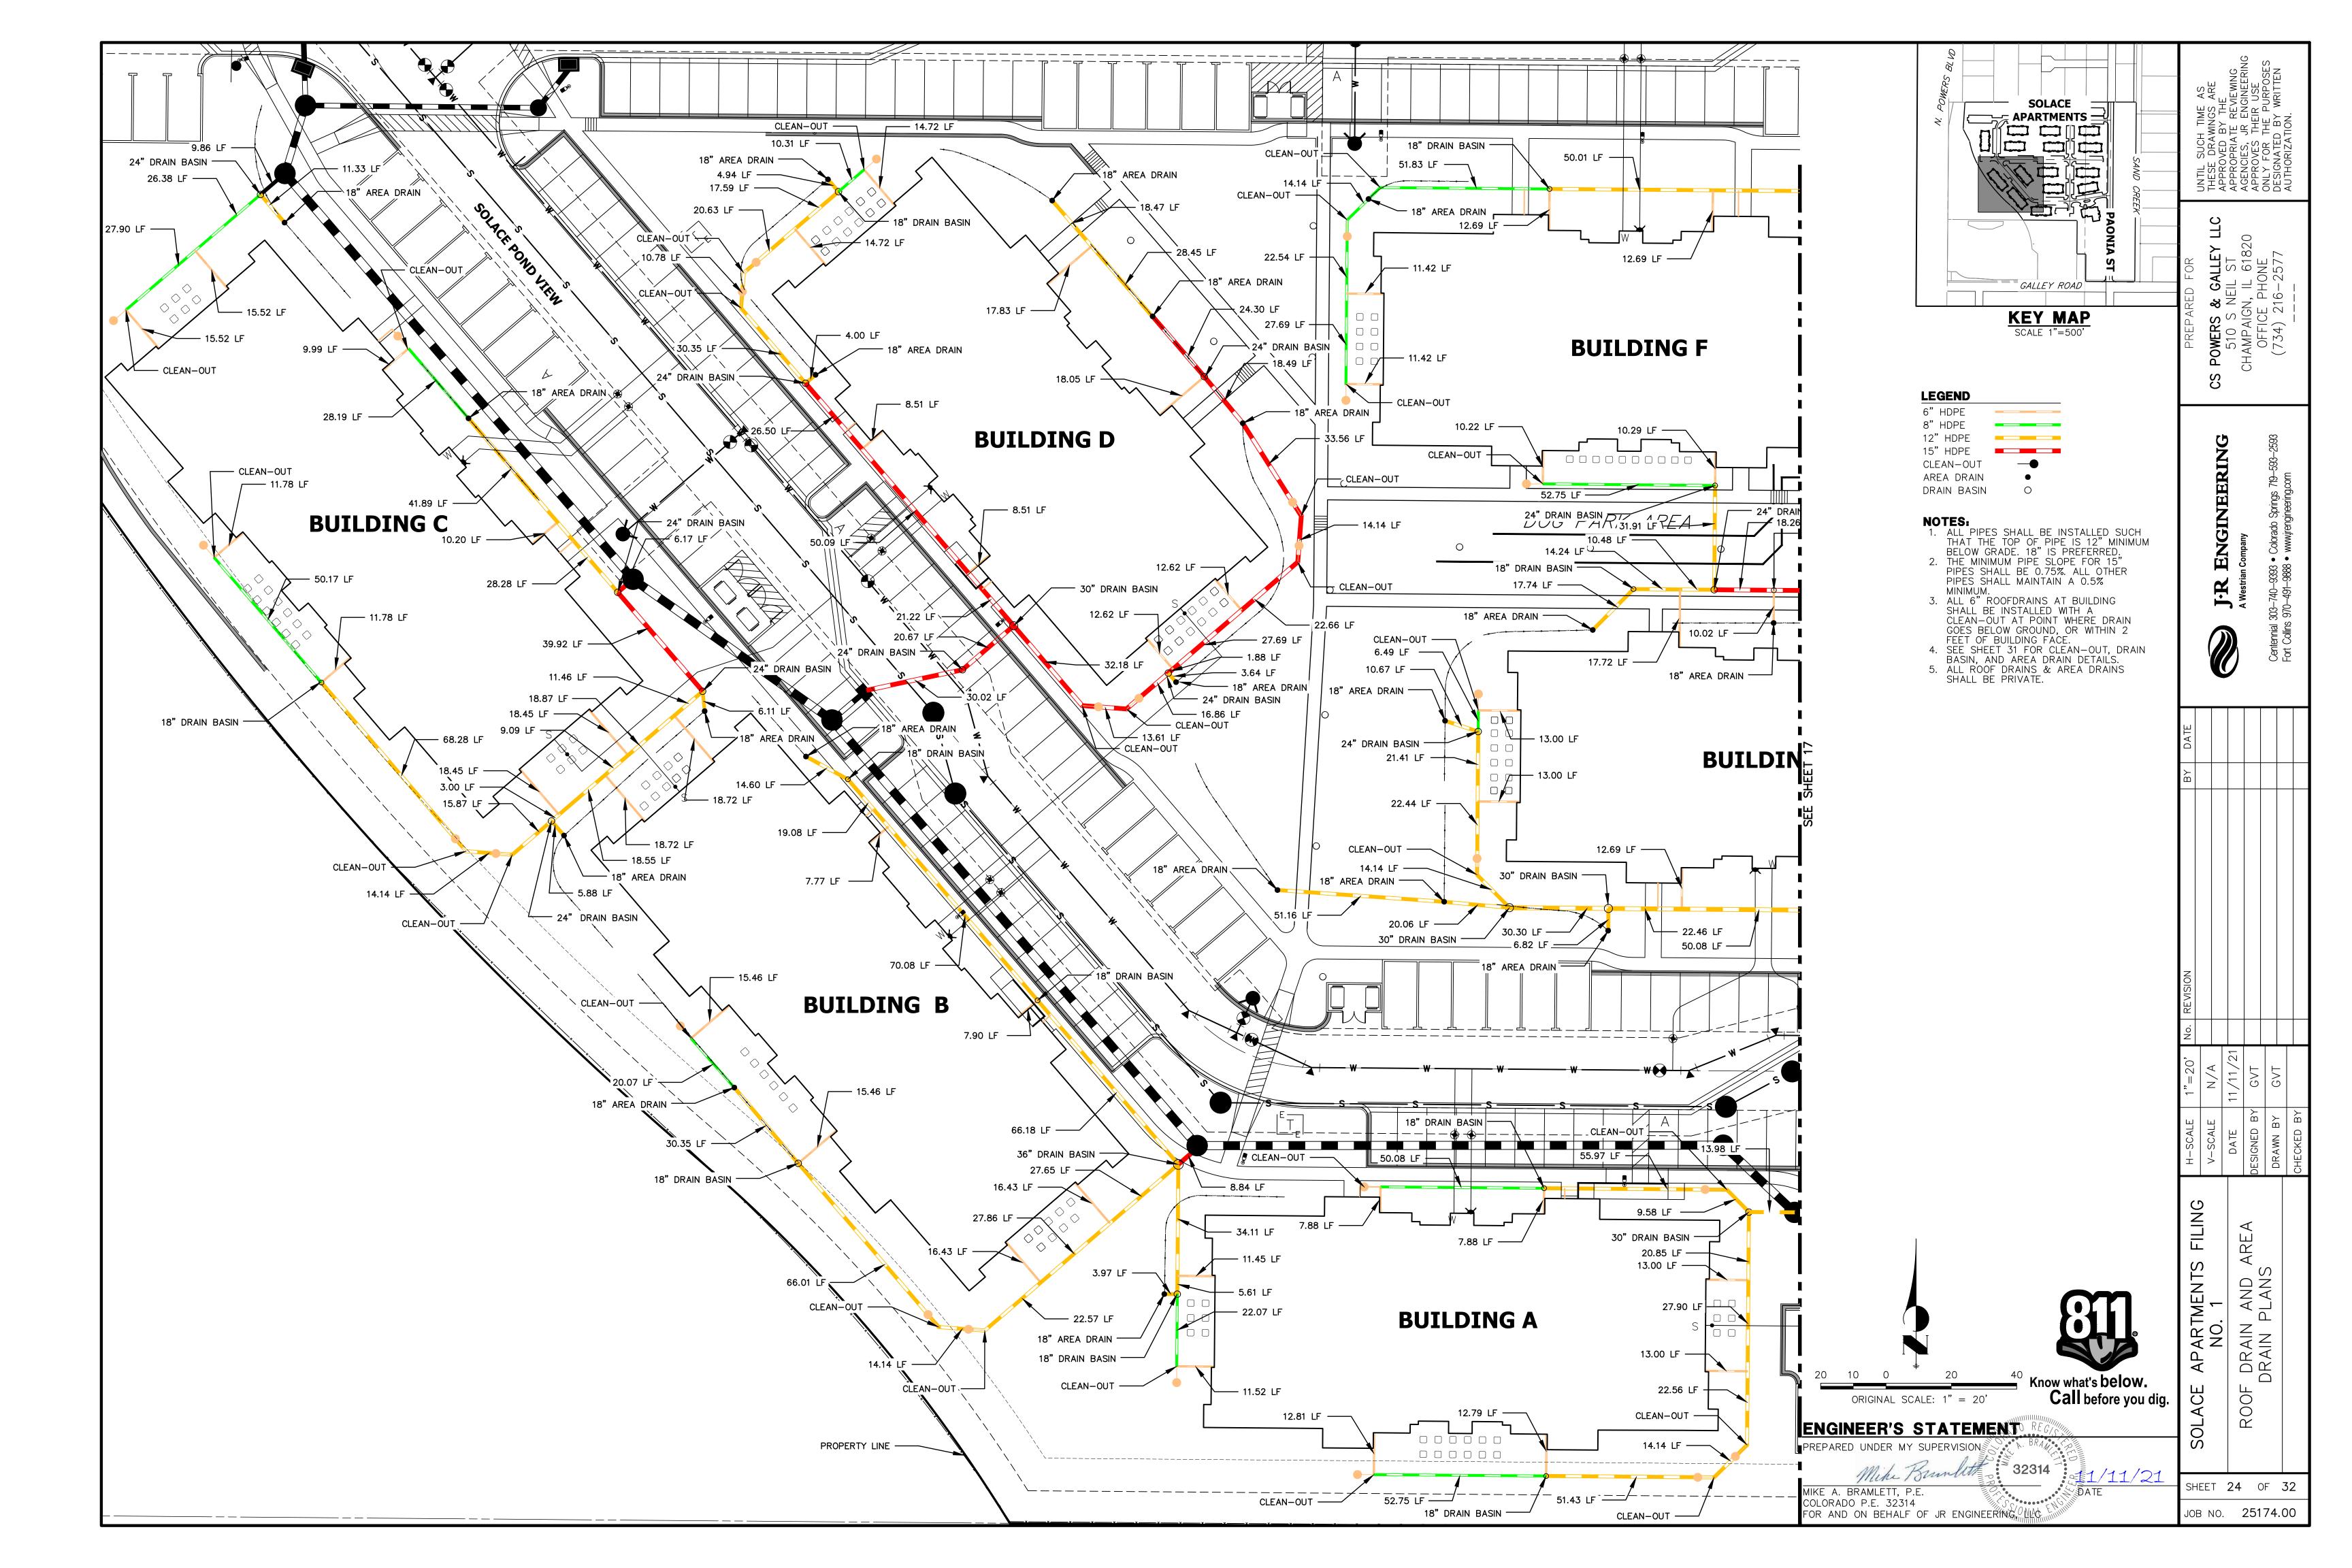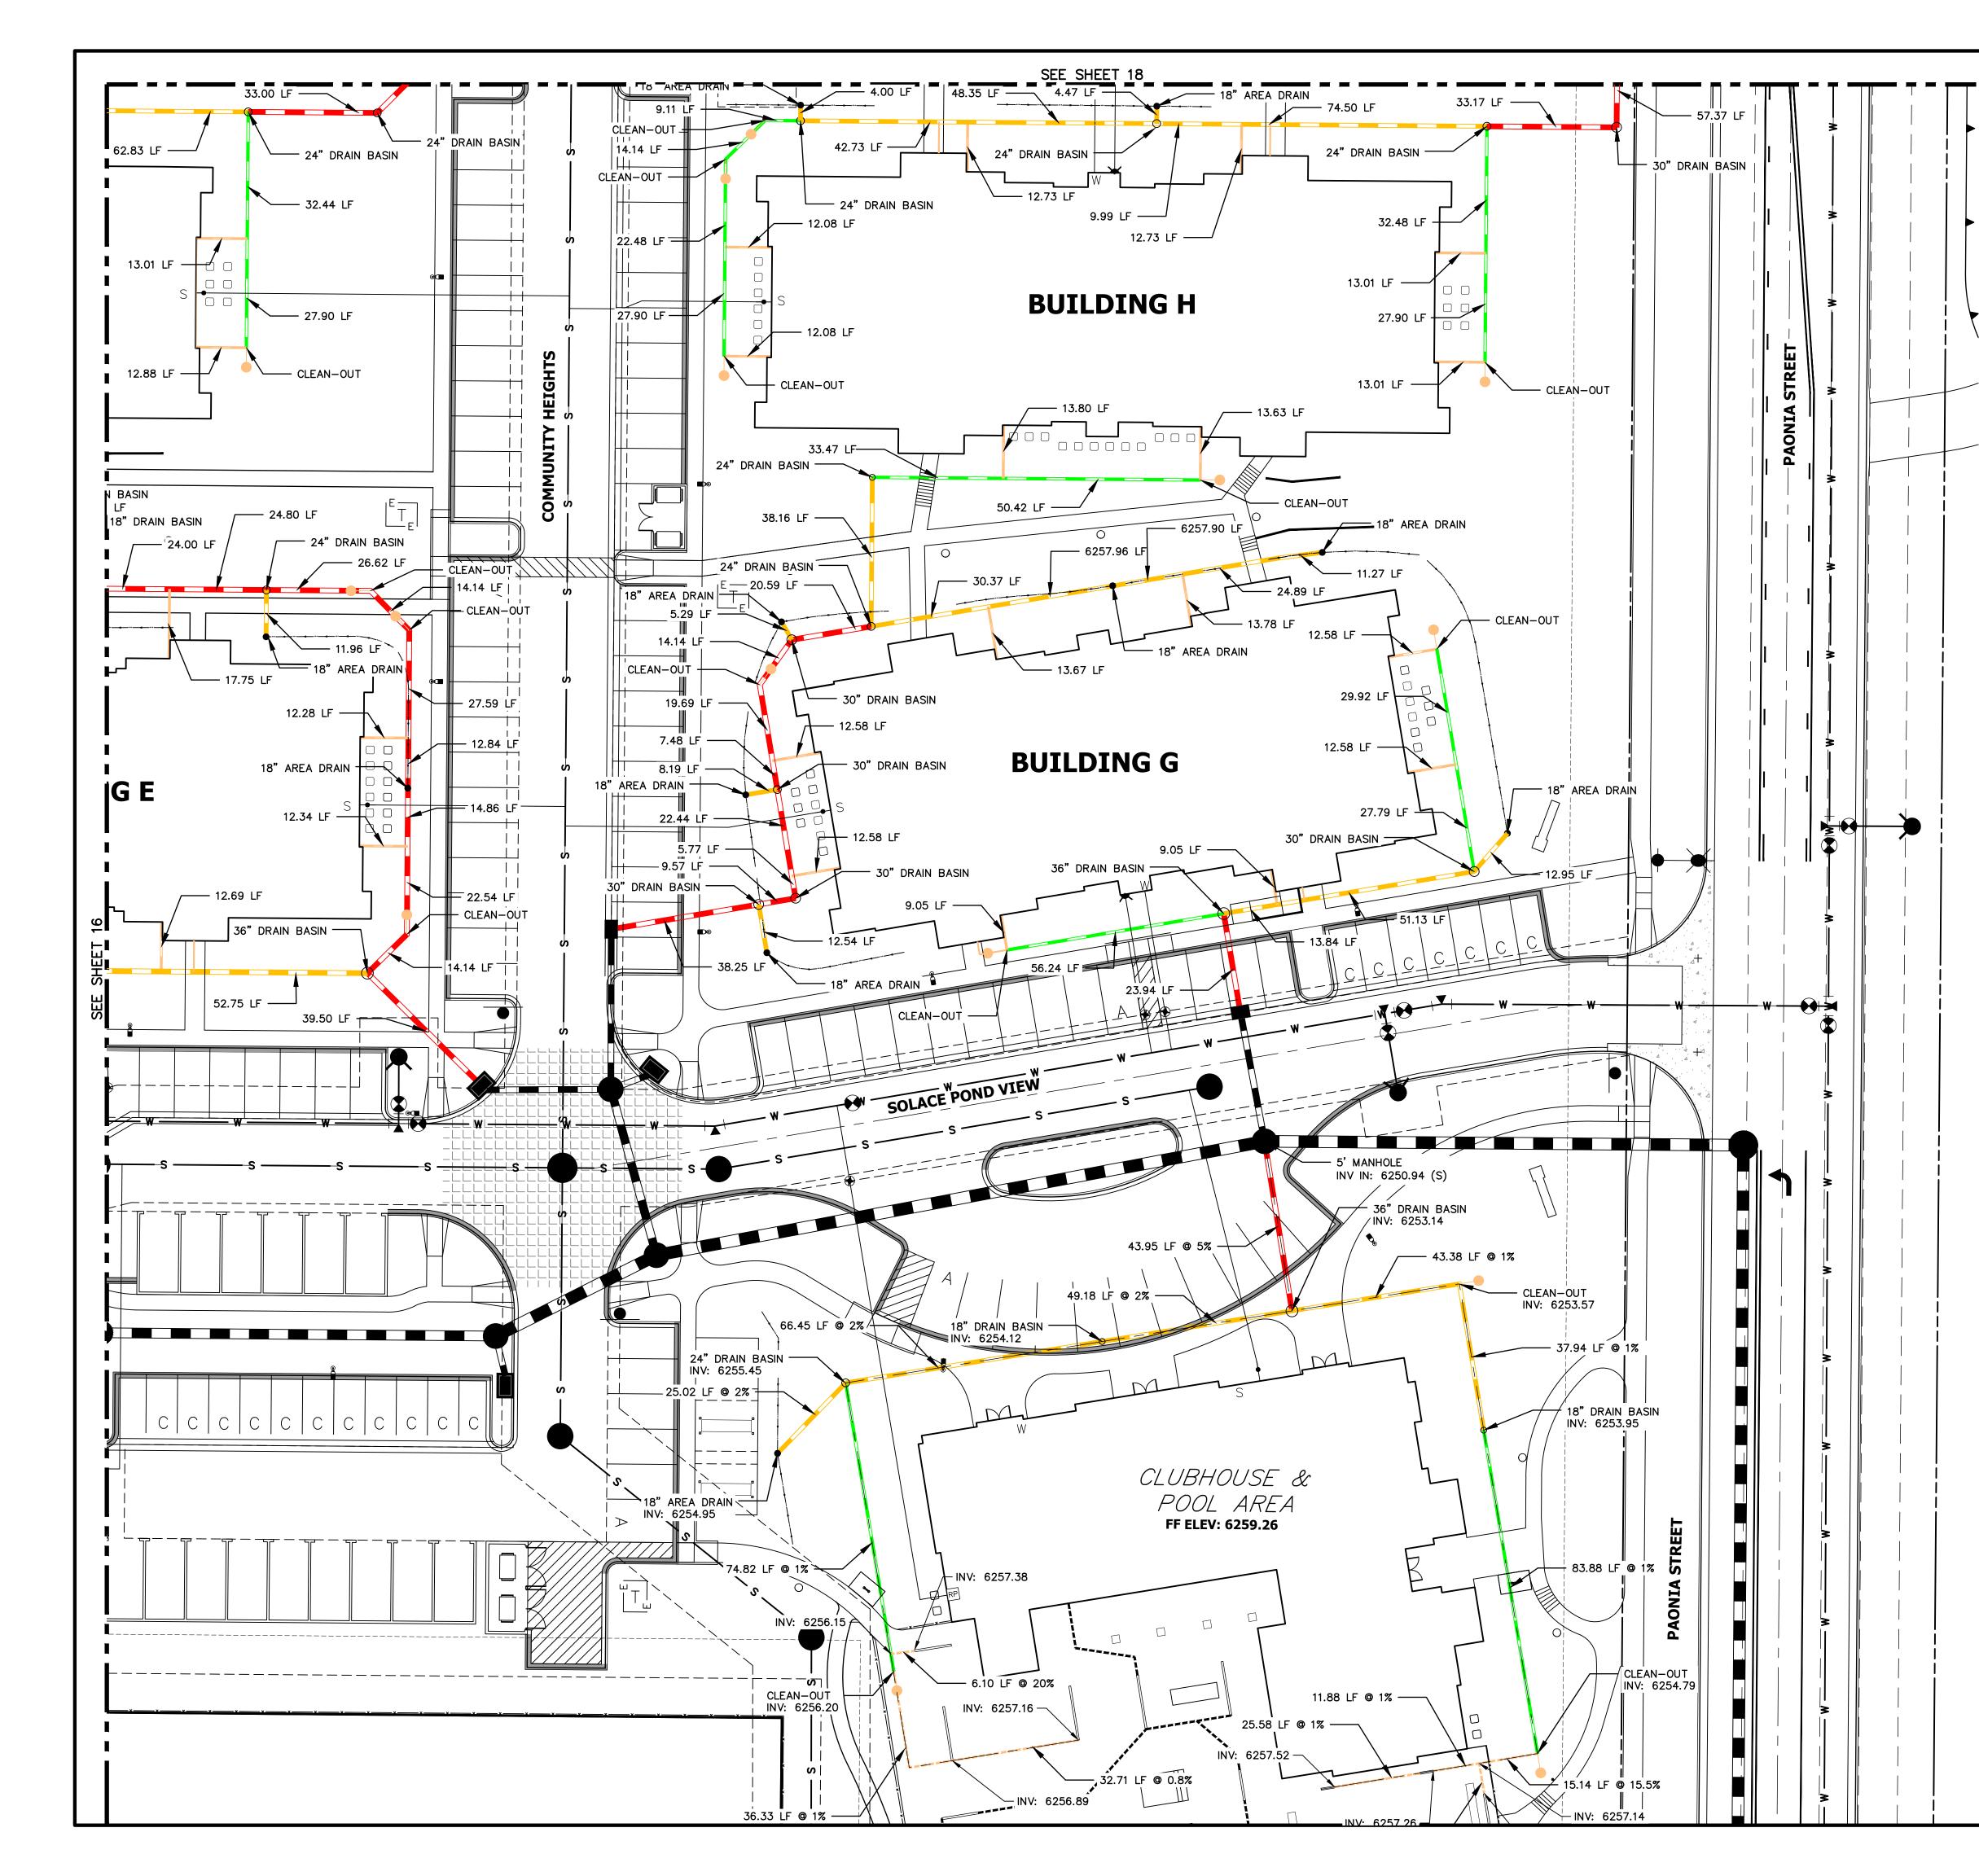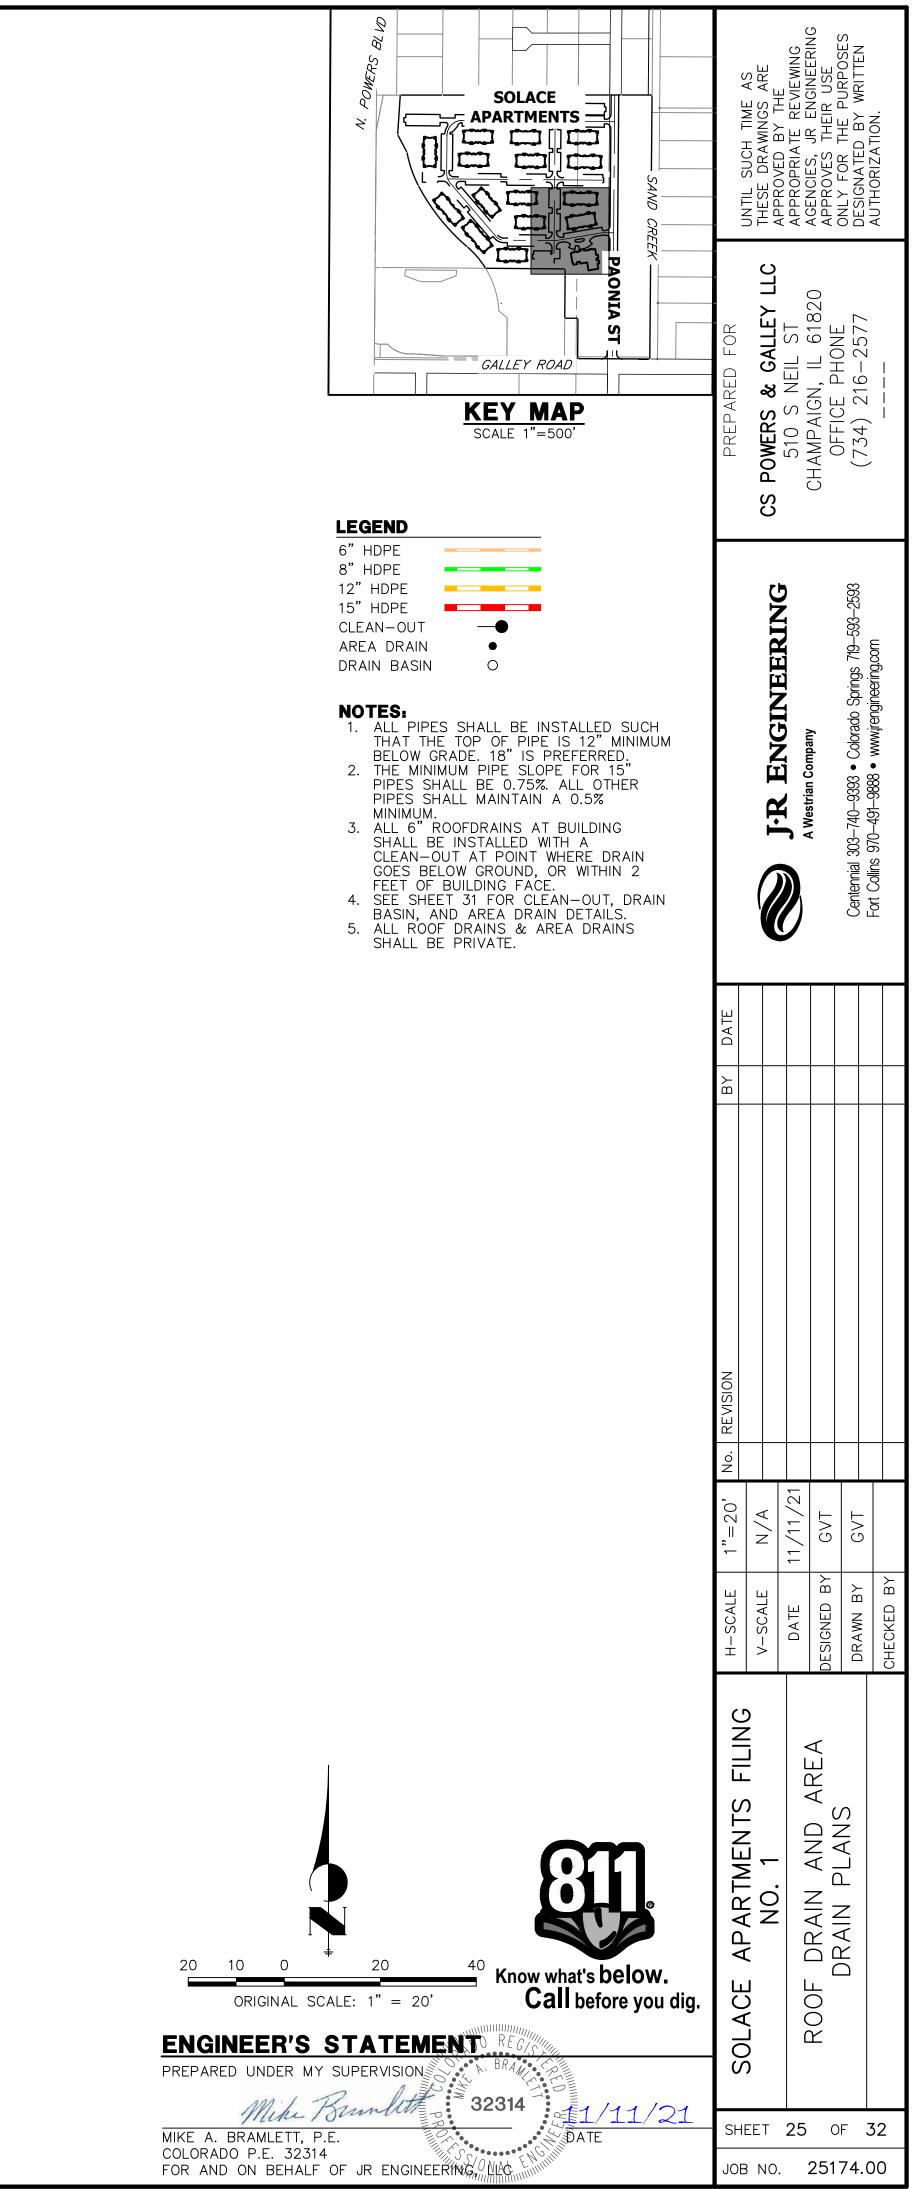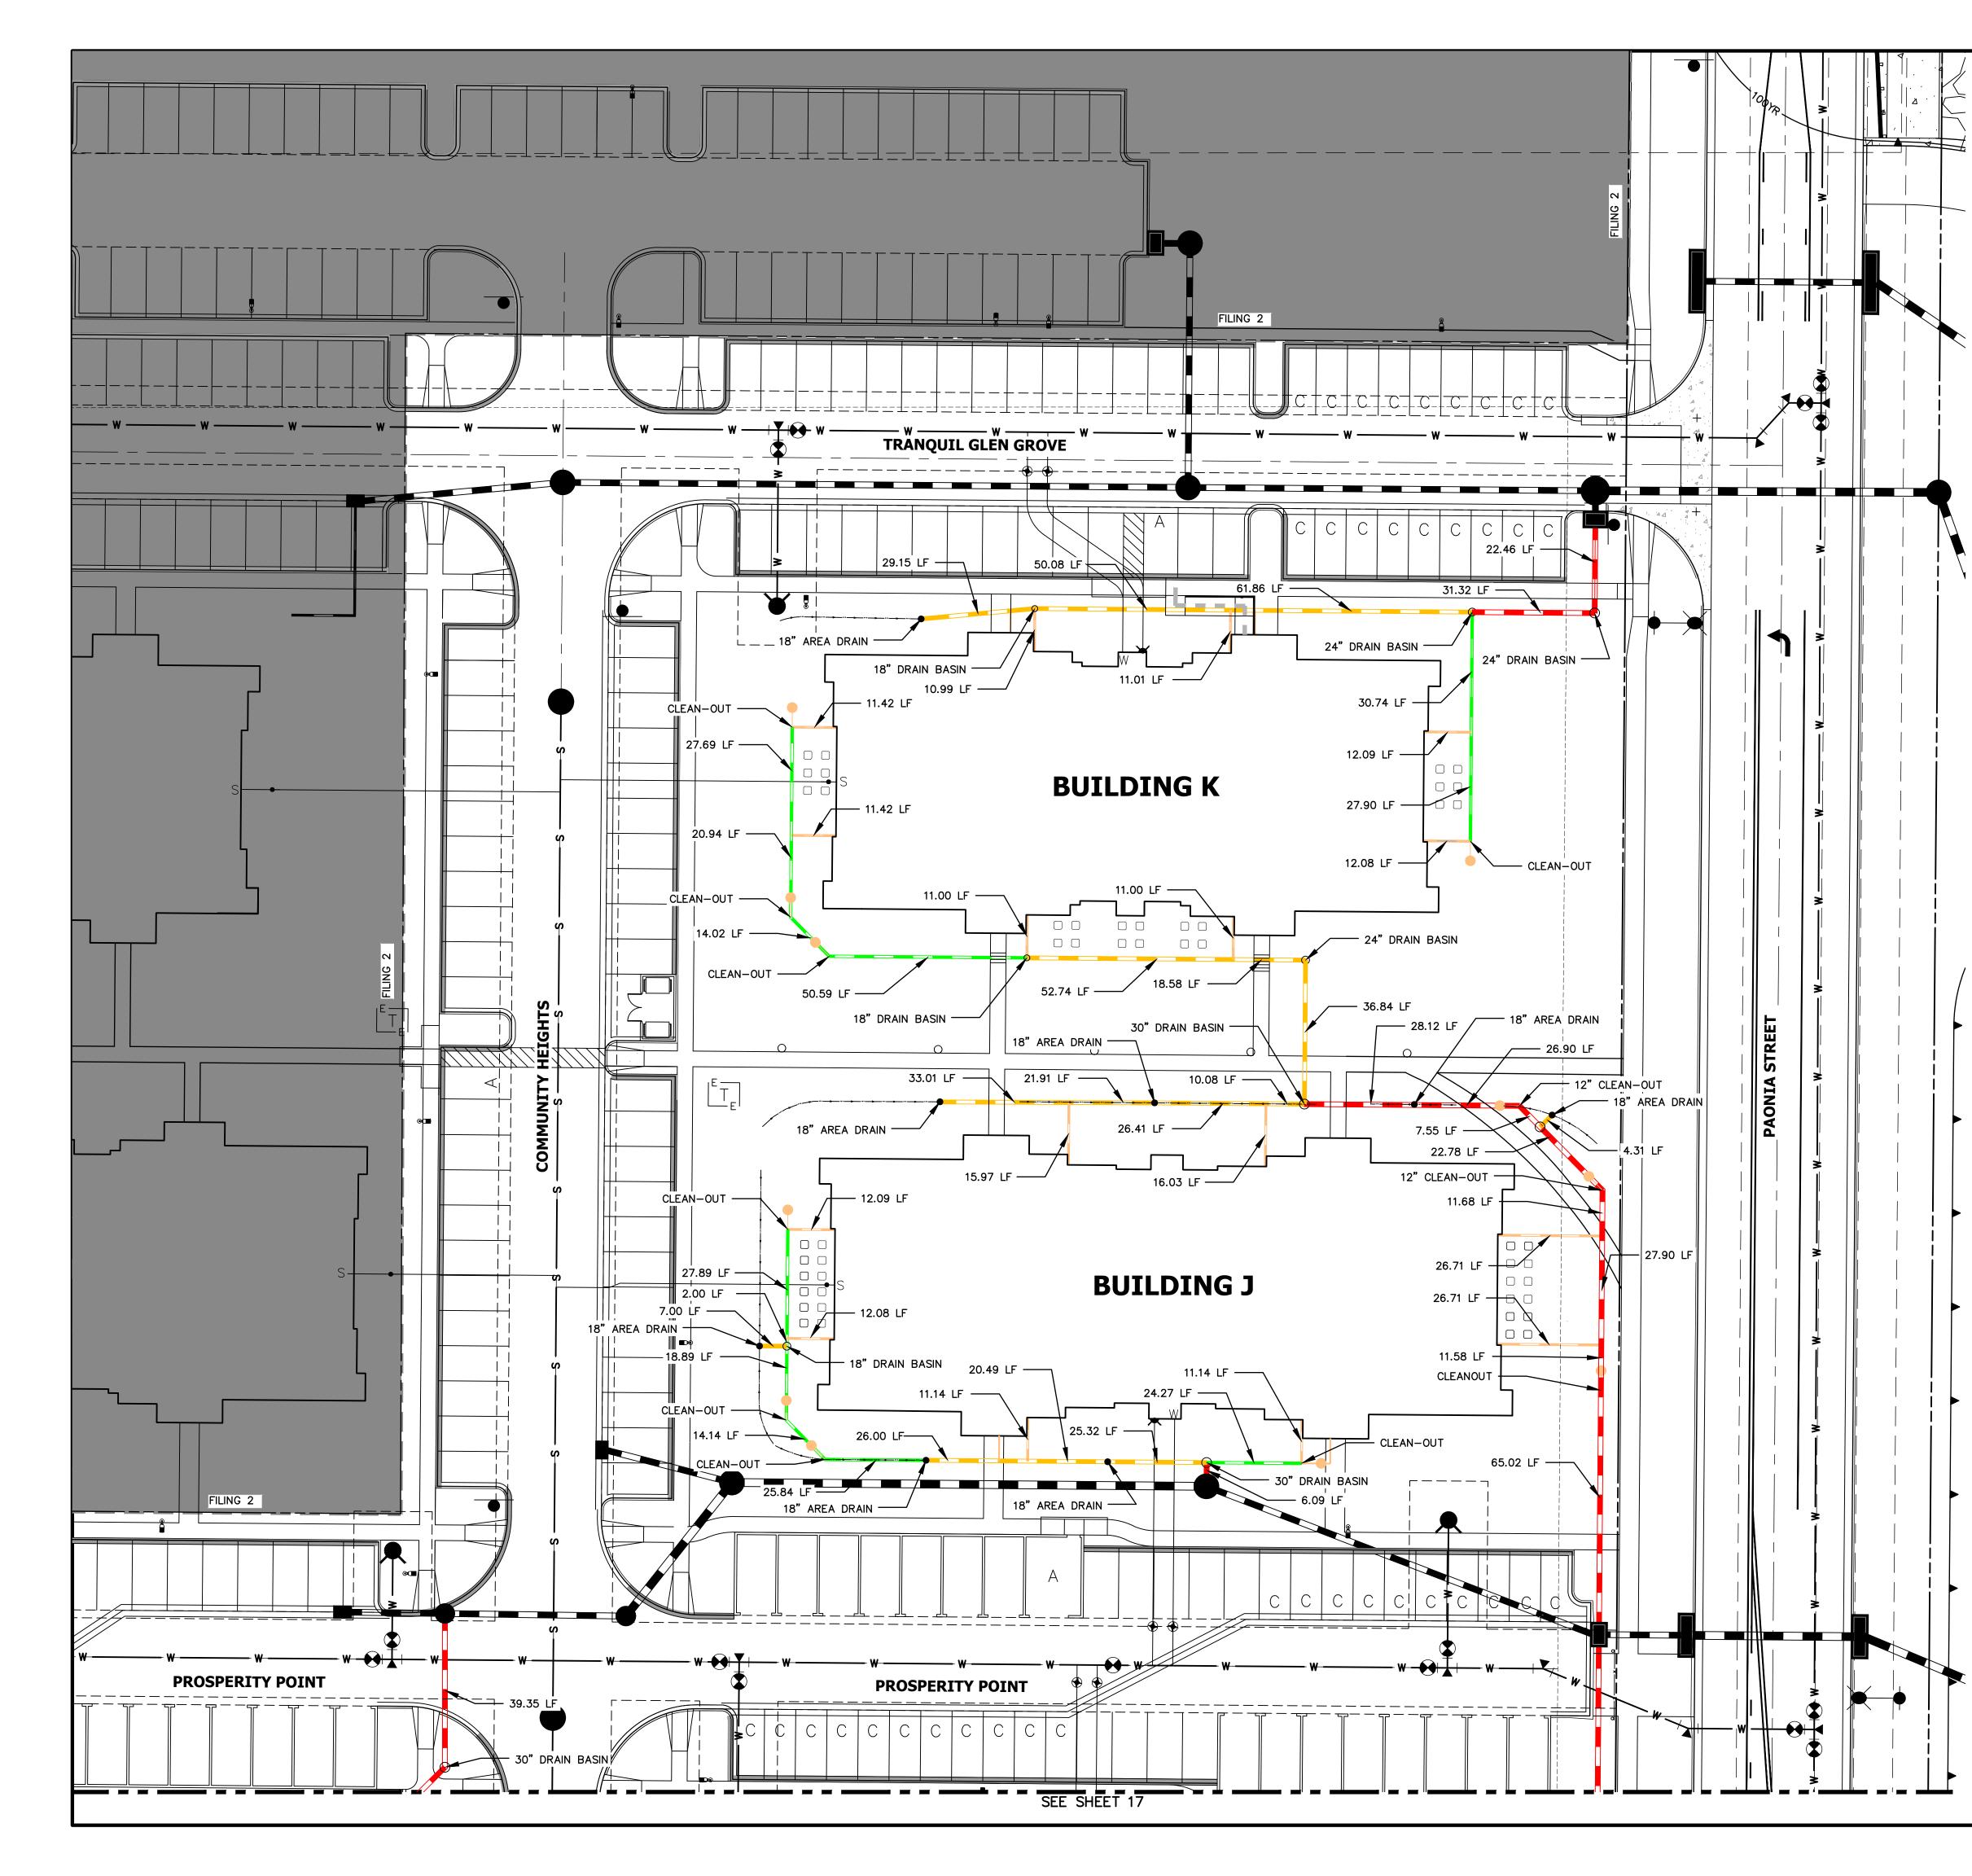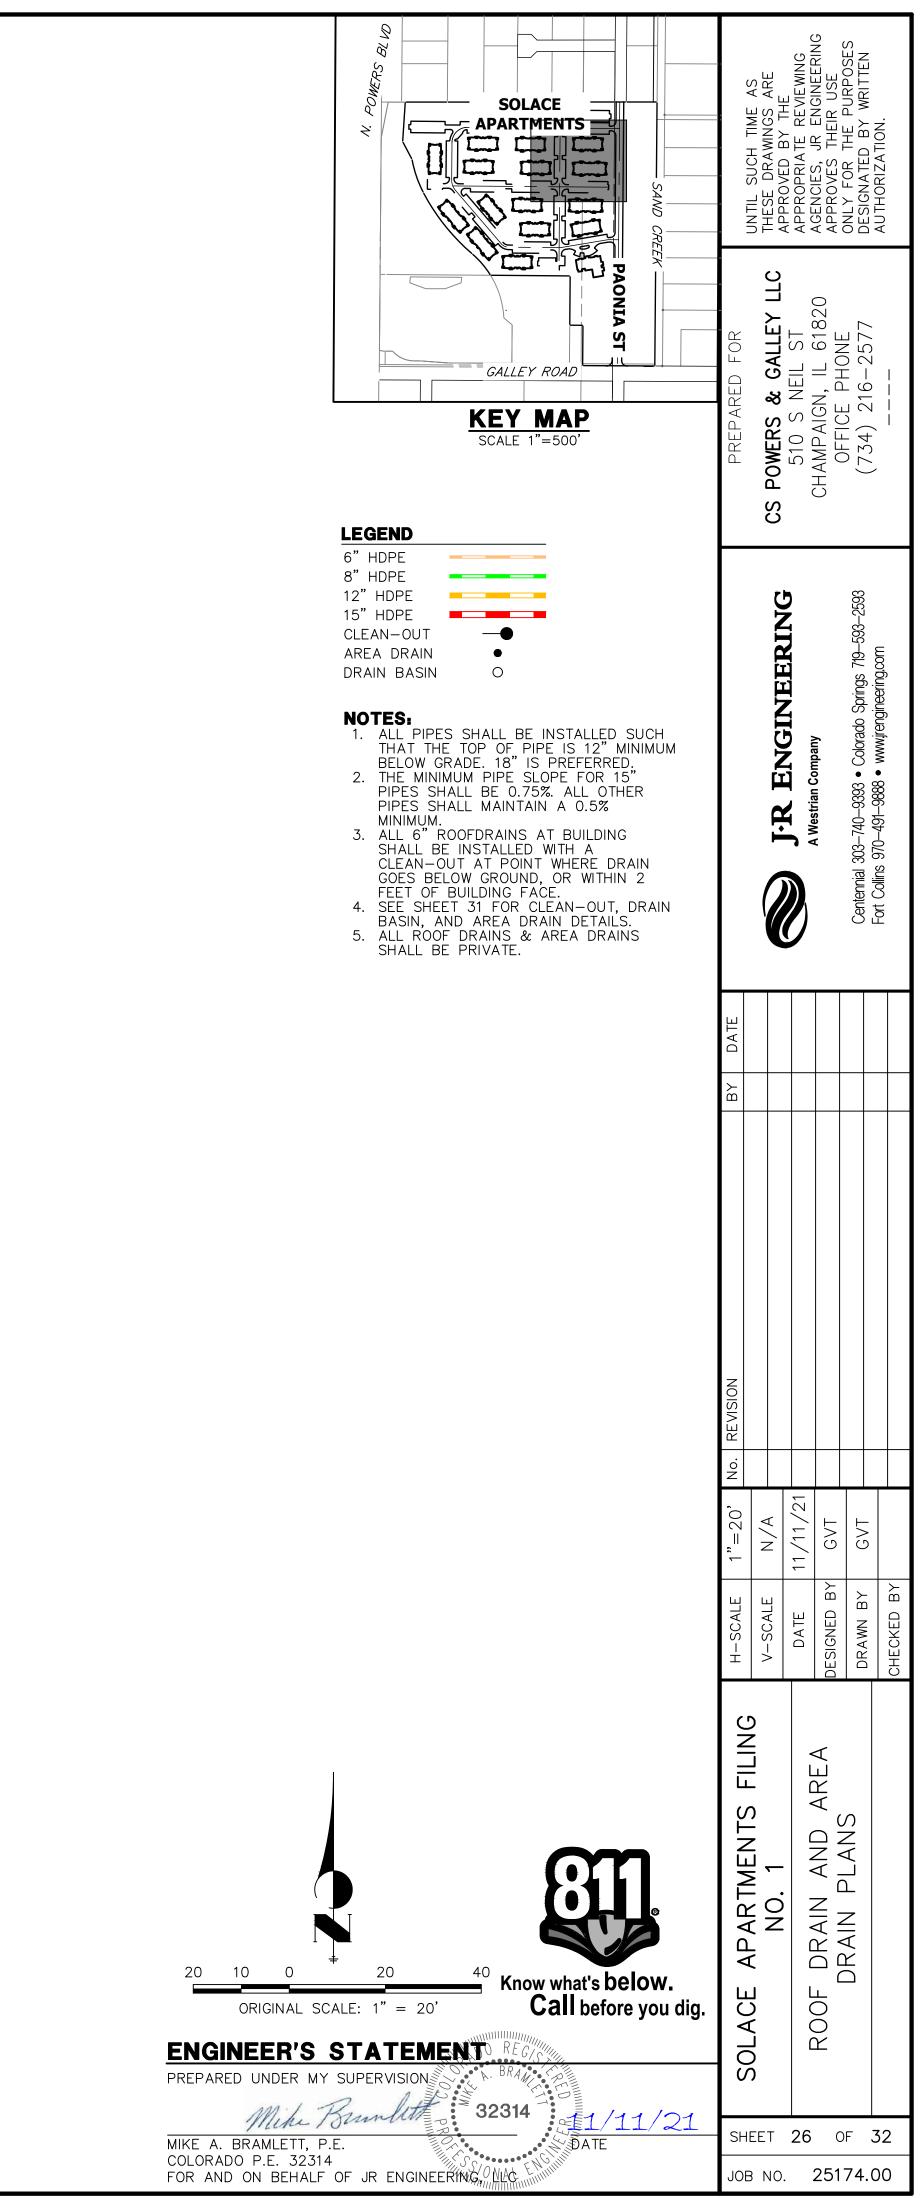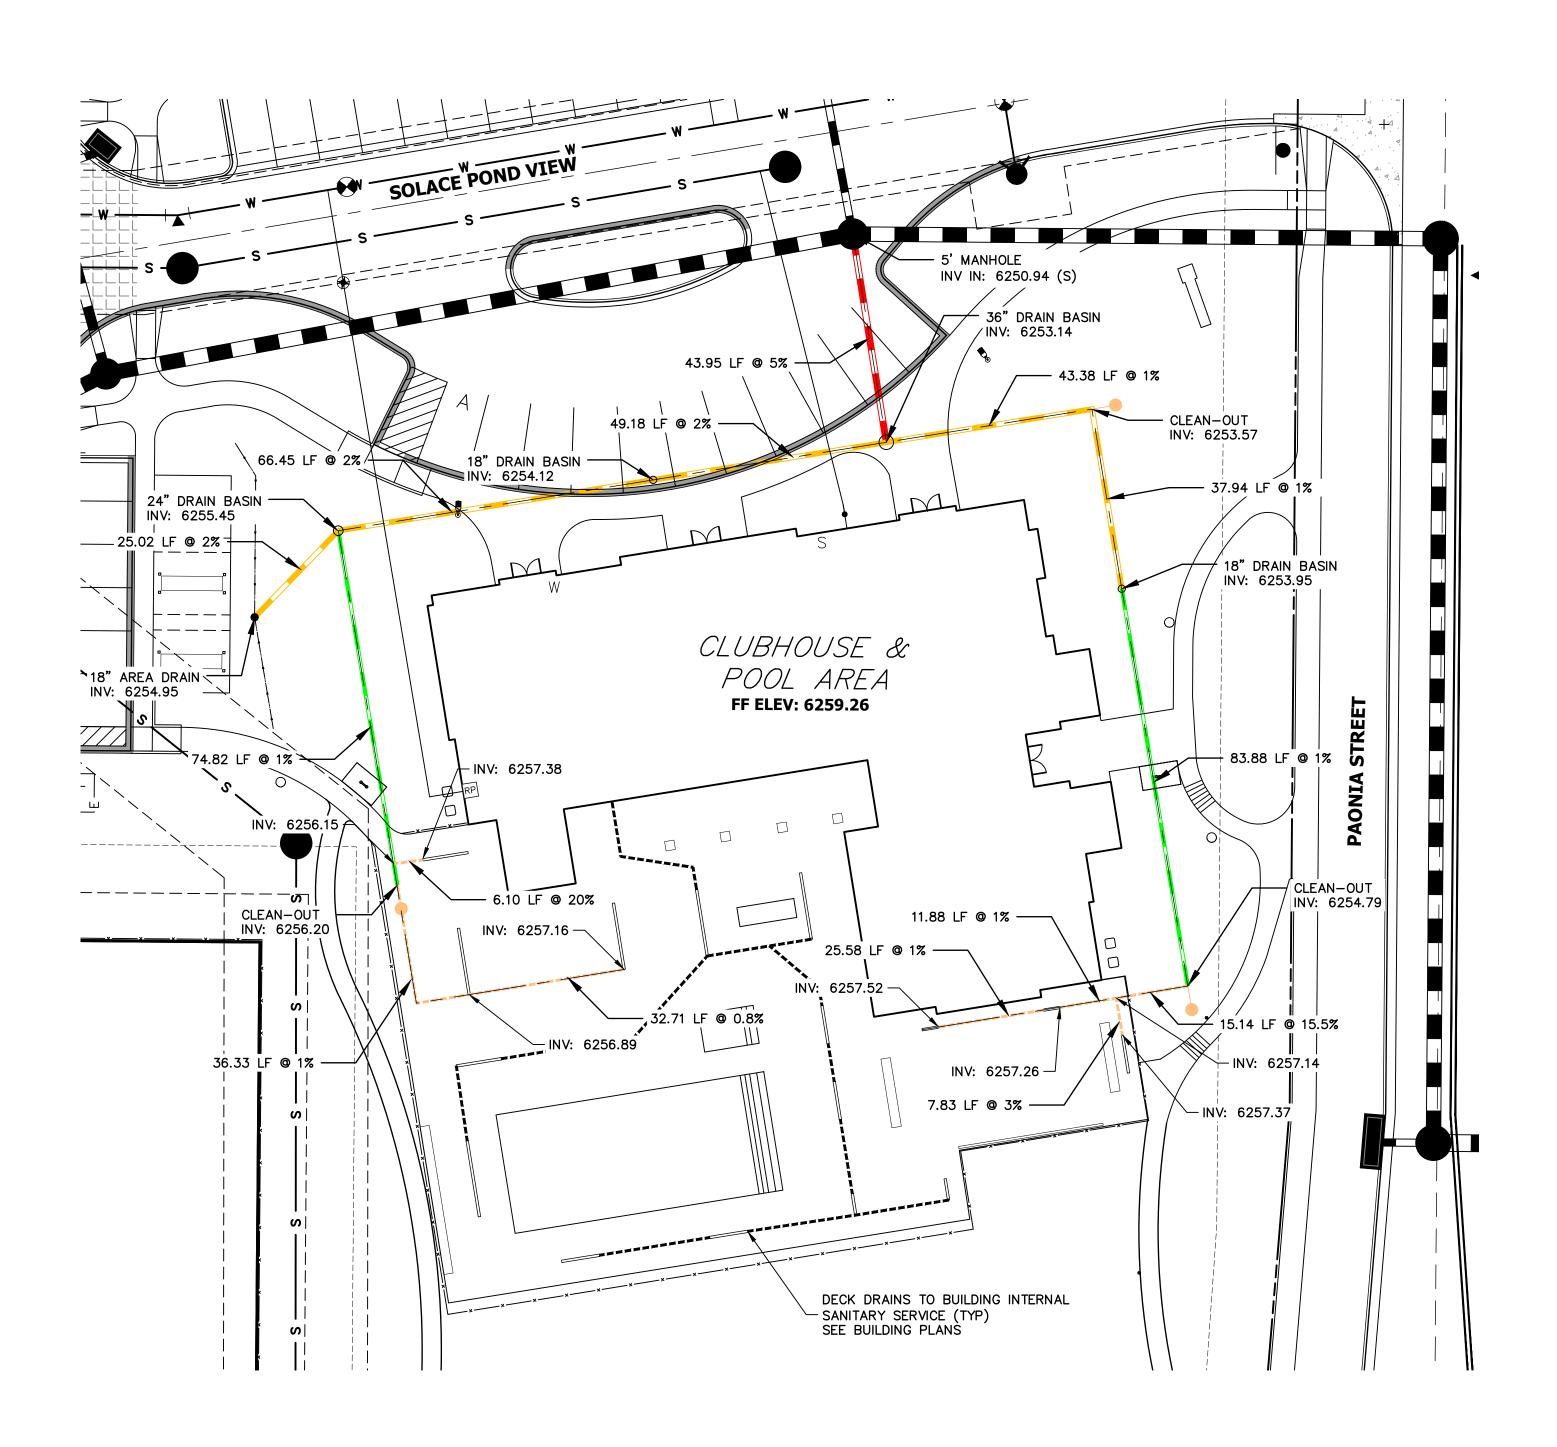














Part #: 864 (Includes #814-Grates (2qty.) , #800-Channel (1qty.), #813-End Outlet (1qty.), and #812-End Cap (1qty.) Material: Channel (Polyolefin) Grates (HDPE) Color: Light Gray

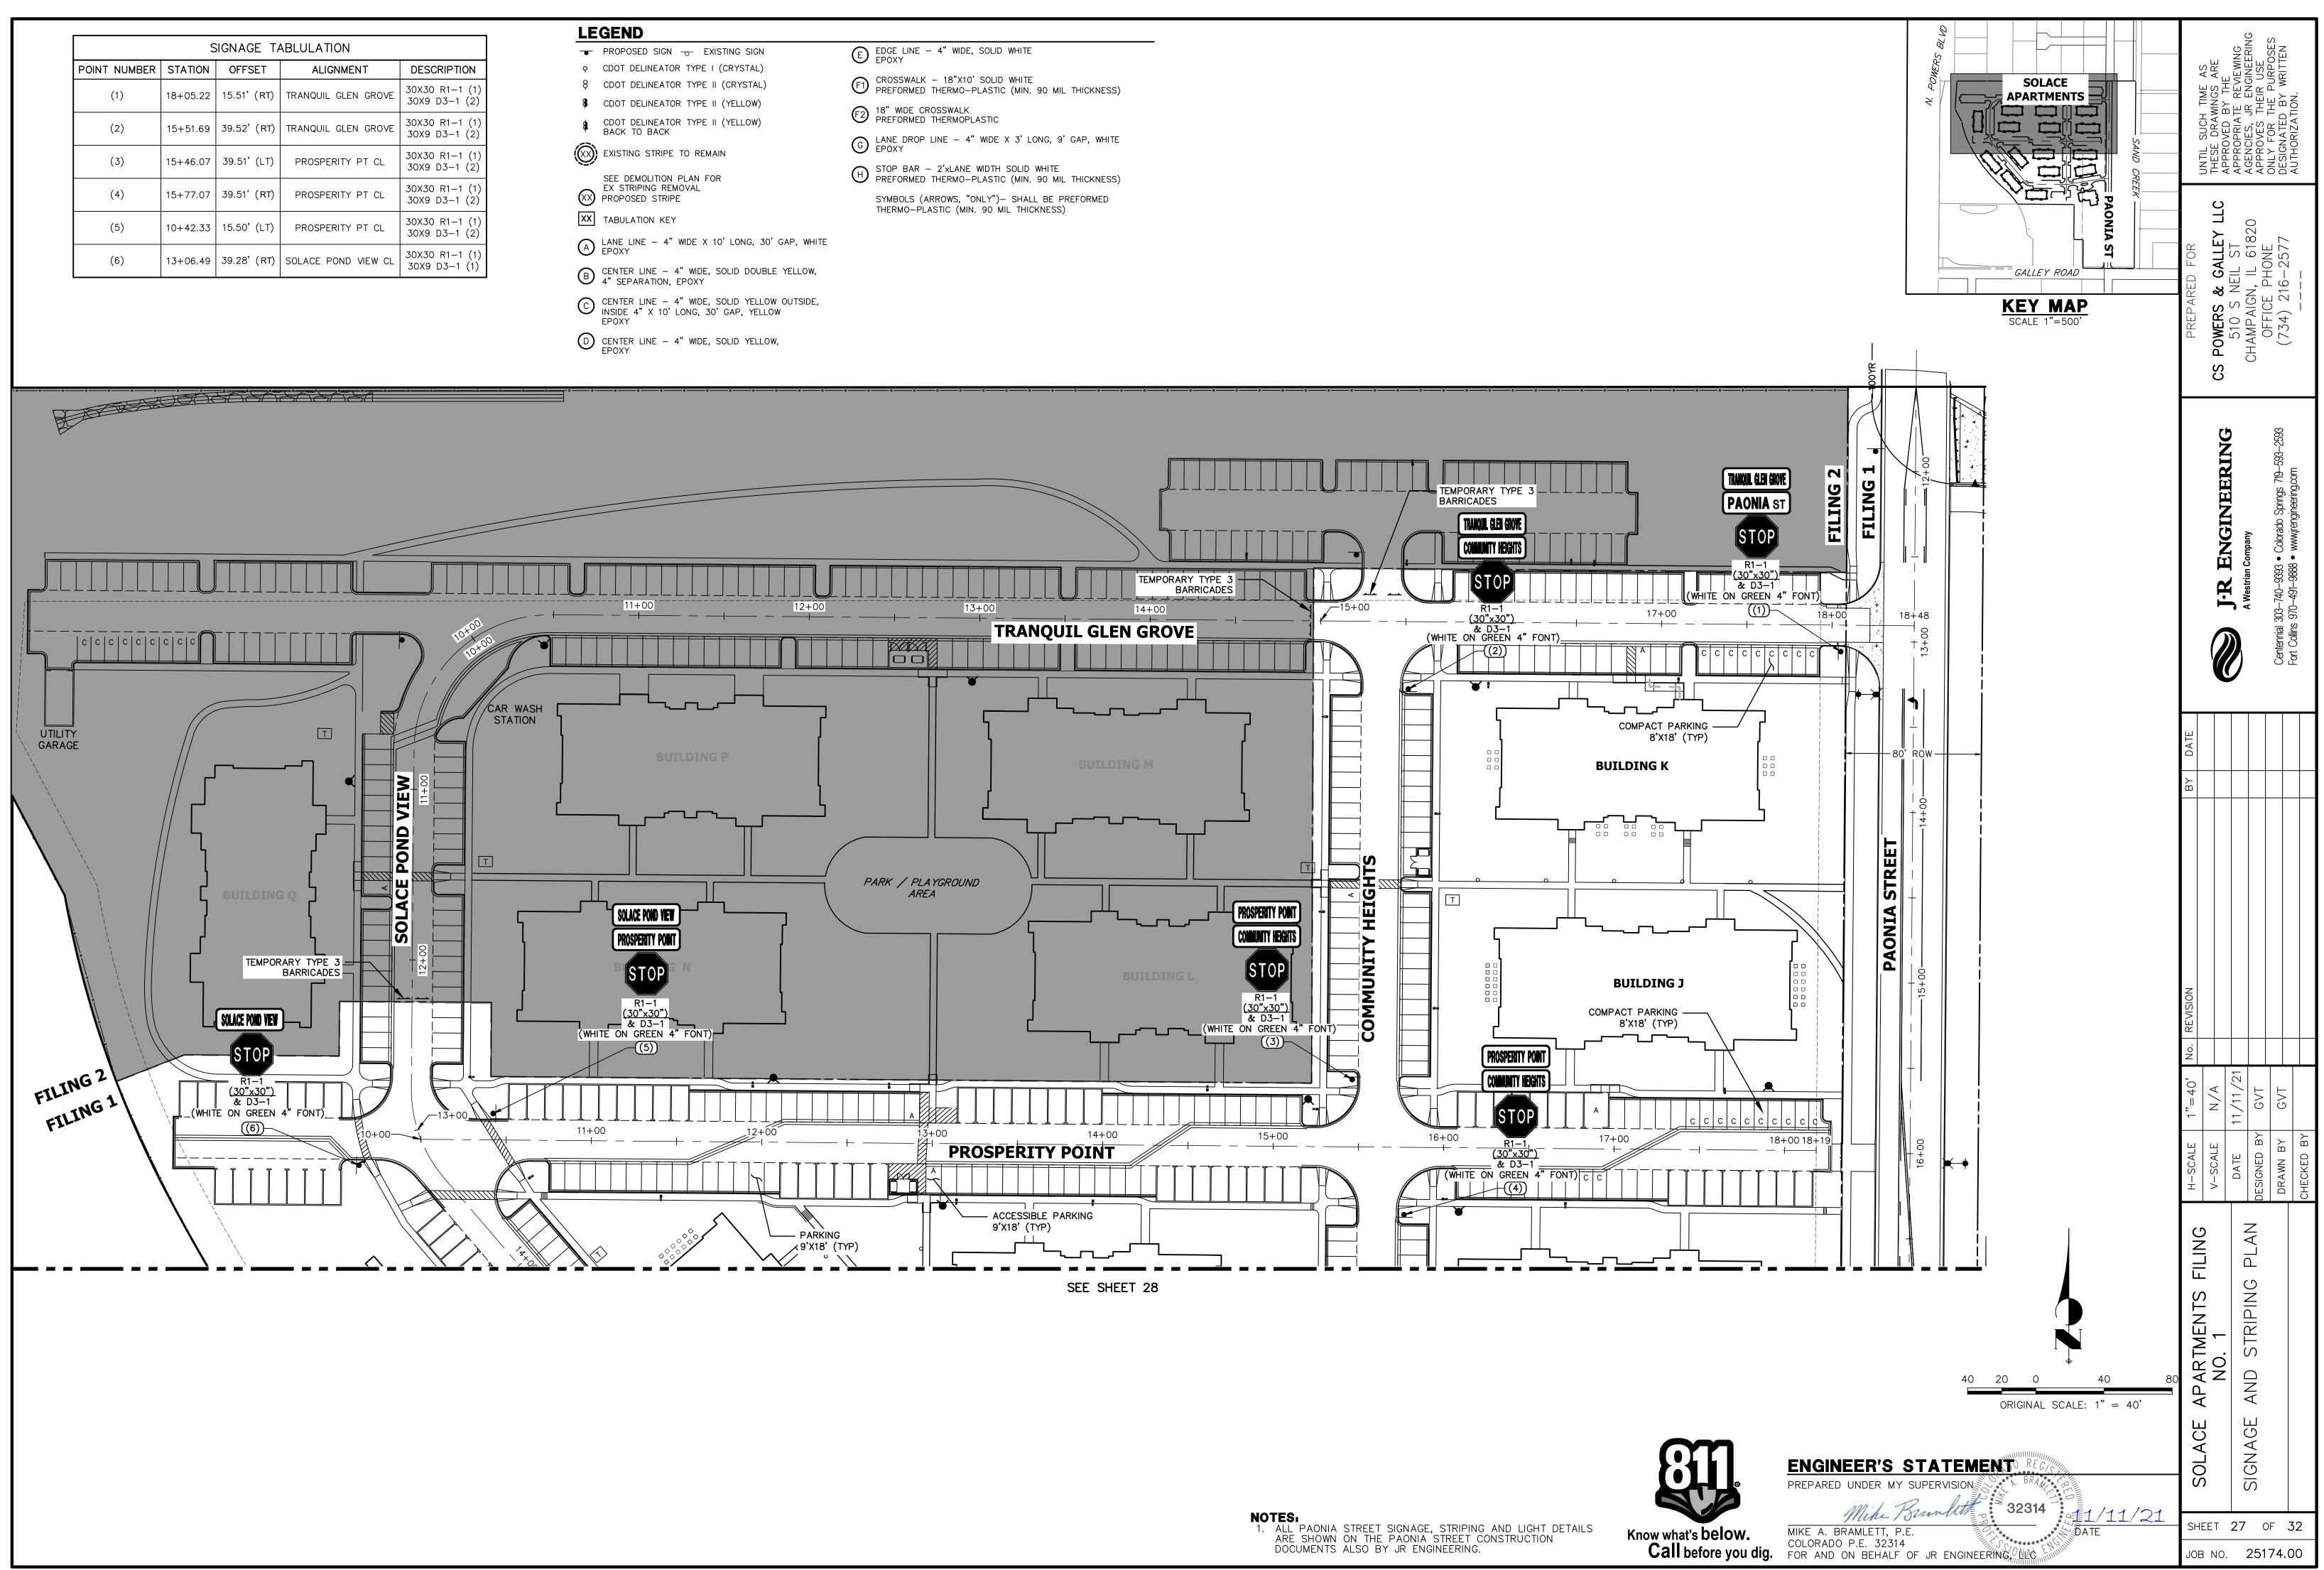
Rebar tie clips for easier installation: Fits #4 Rebar

Open Surface Area: 23.52 Sq. Inch per Ft.

Head (inches) - Max Flow 1" = 101.75 GPM


Weight per each: 5.67 lbs. UV Inhibitors





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	S	GIGNAGE TA	ABLULATION	
POINT NUMBER	STATION	OFFSET	ALIGNMENT	DESCRIPTION
(7)	19+96.97	39.50'(LT)	SOLACE POND VIEW CL	30X30 R1-1 (1) 30X9 D3-1 (2)
(8)	20+20.92	37.75' (RT)	SOLACE POND VIEW CL	30X30 R1-1 (1) 30X9 D3-1 (1)
(9)	22+85.32	17.57' (RT)	SOLACE POND VIEW CL	30X30 R1-1 (1) 30X9 D3-1 (2)

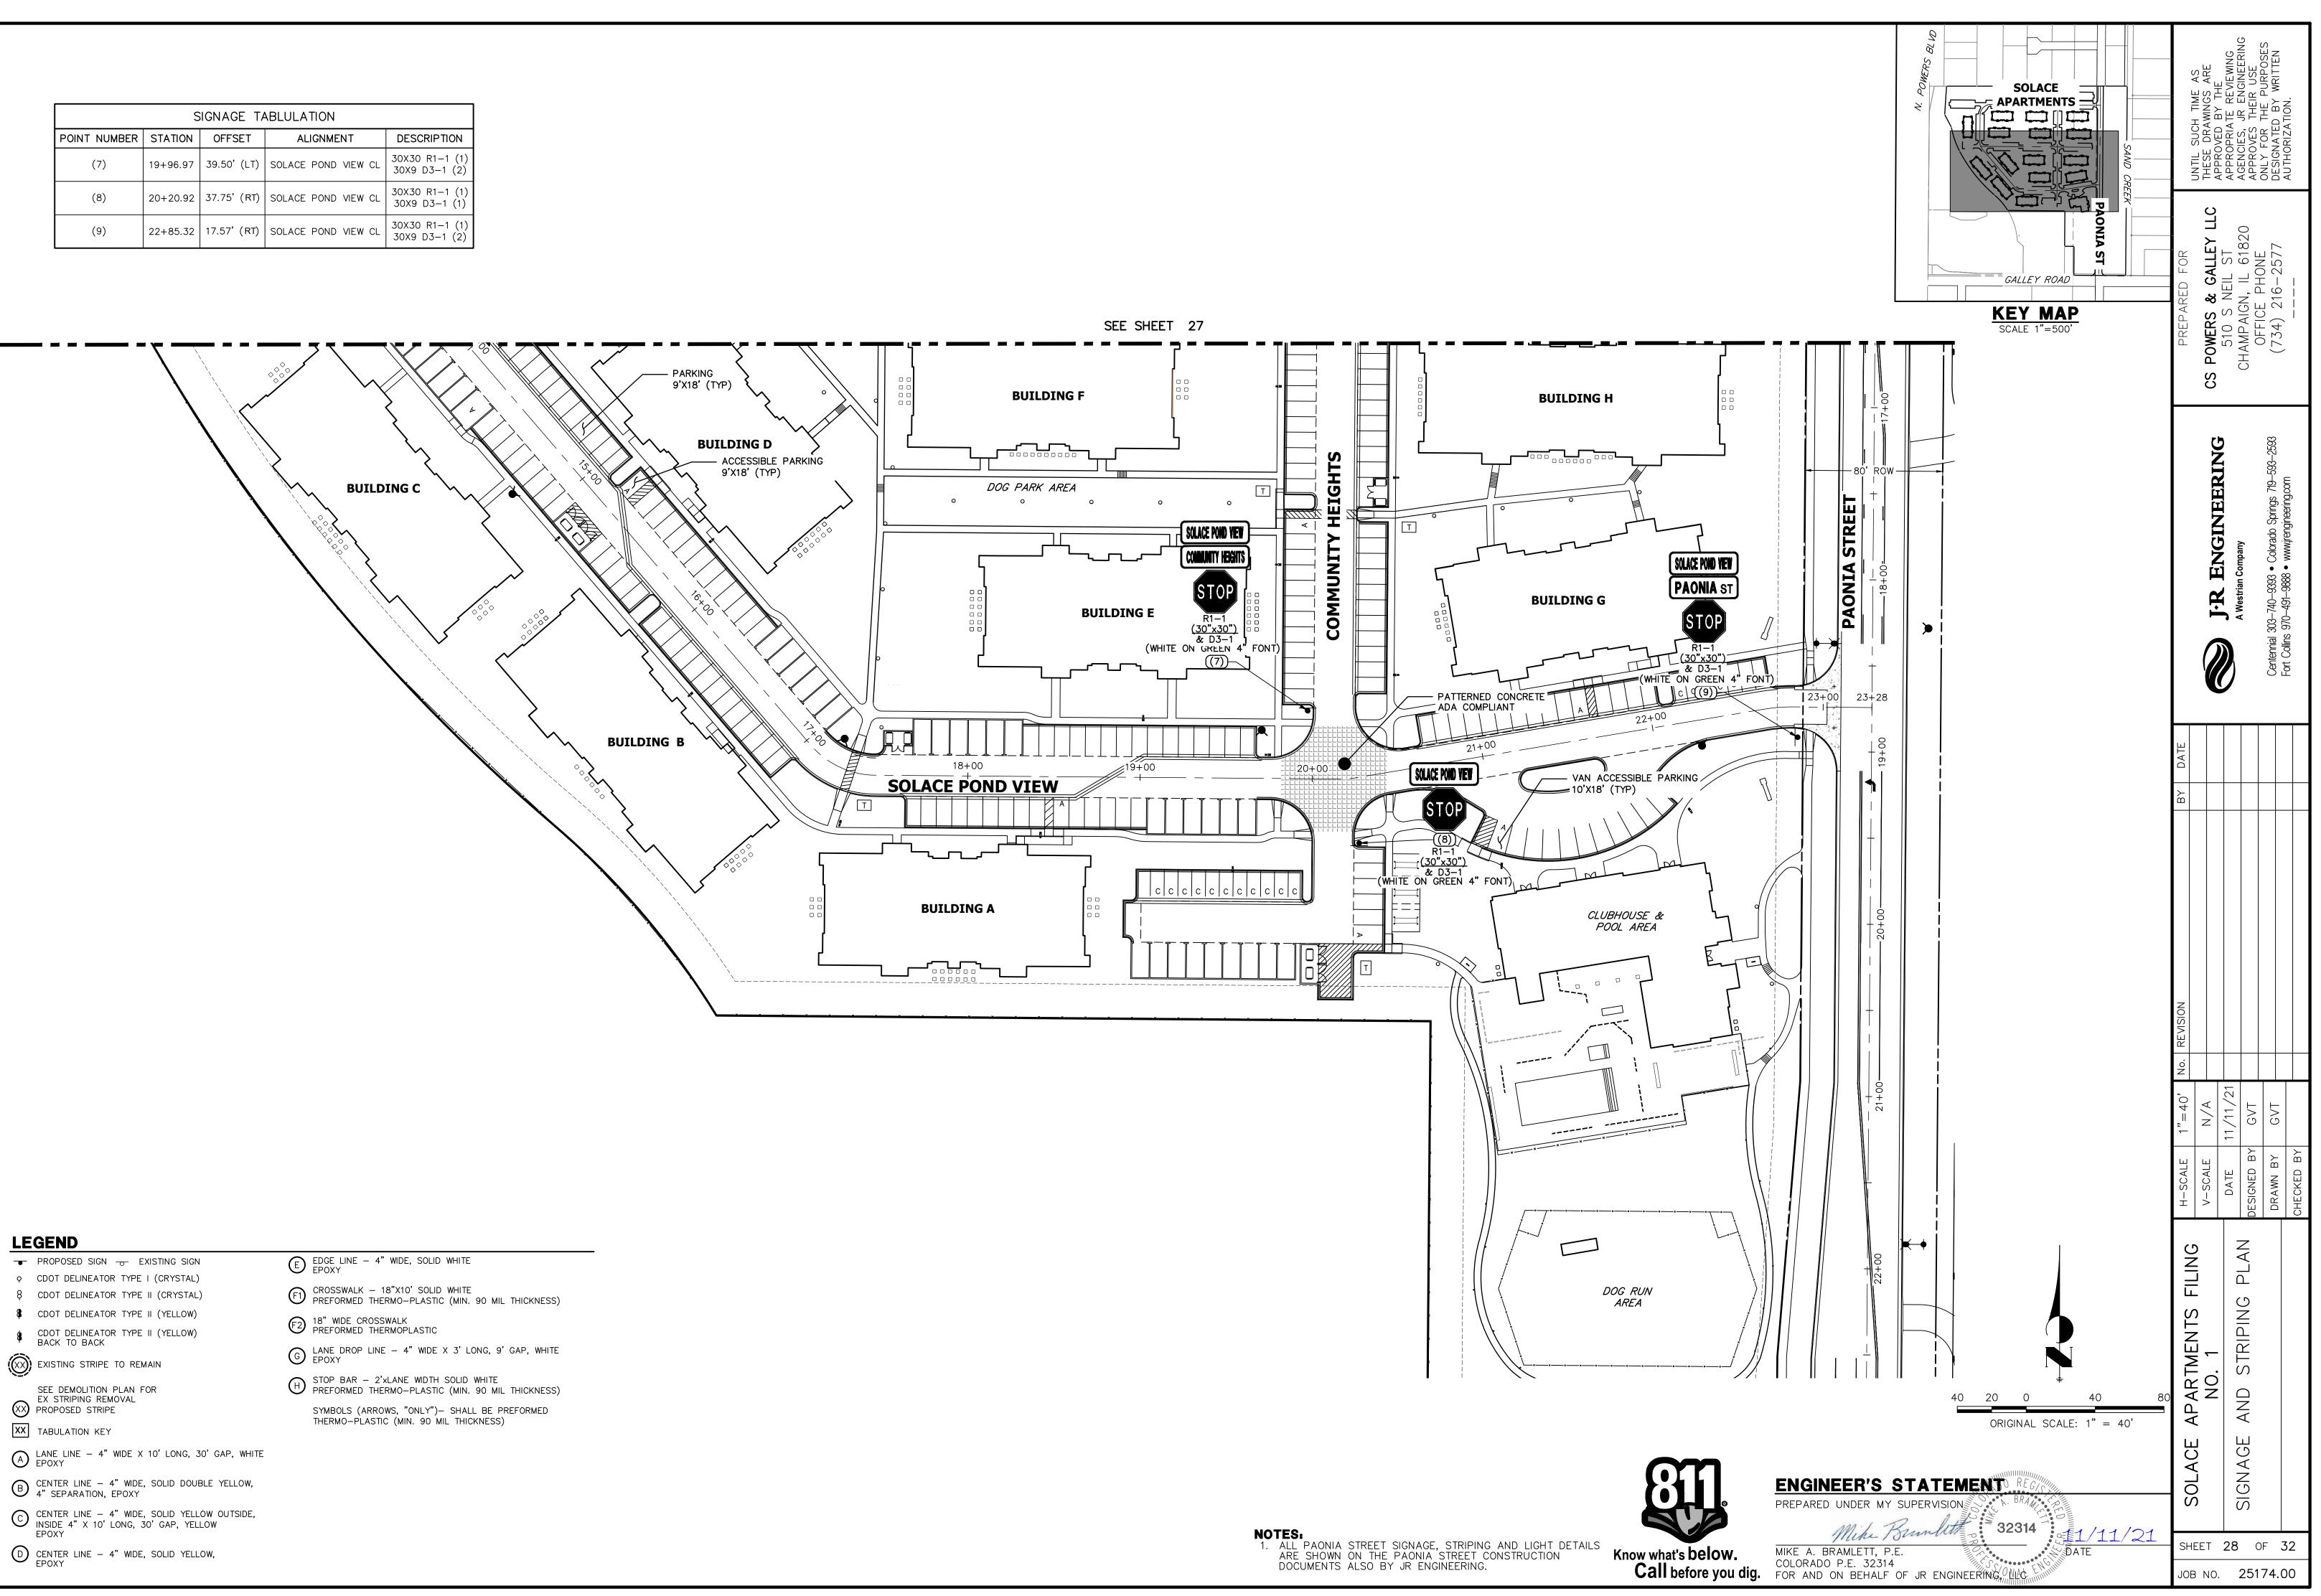


LEGEND


- PROPOSED SIGN EXISTING SIGN


- XX TABULATION KEY

EPOXY

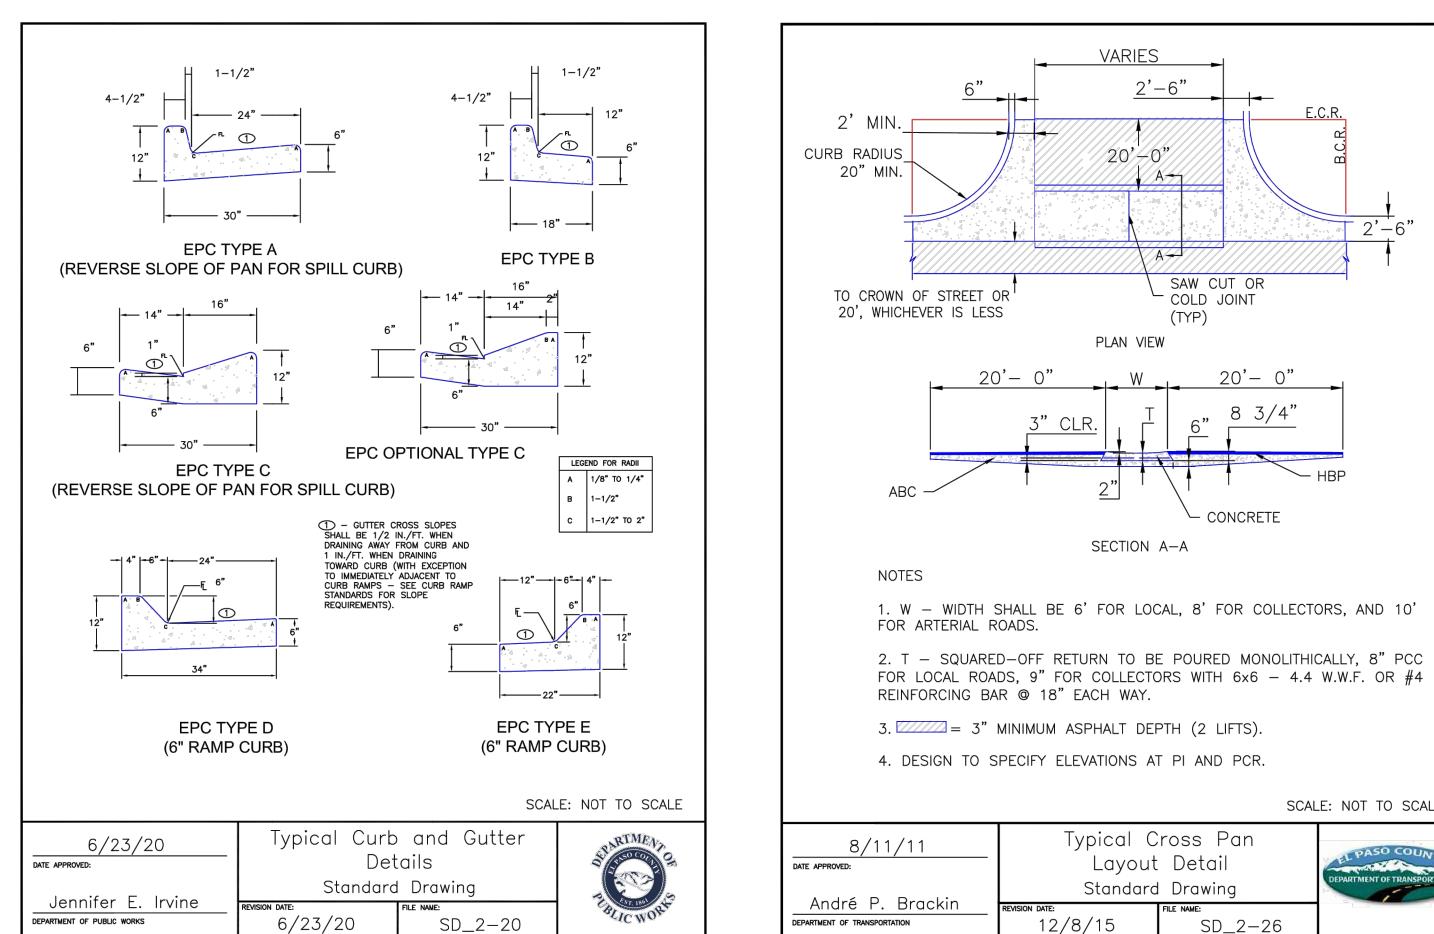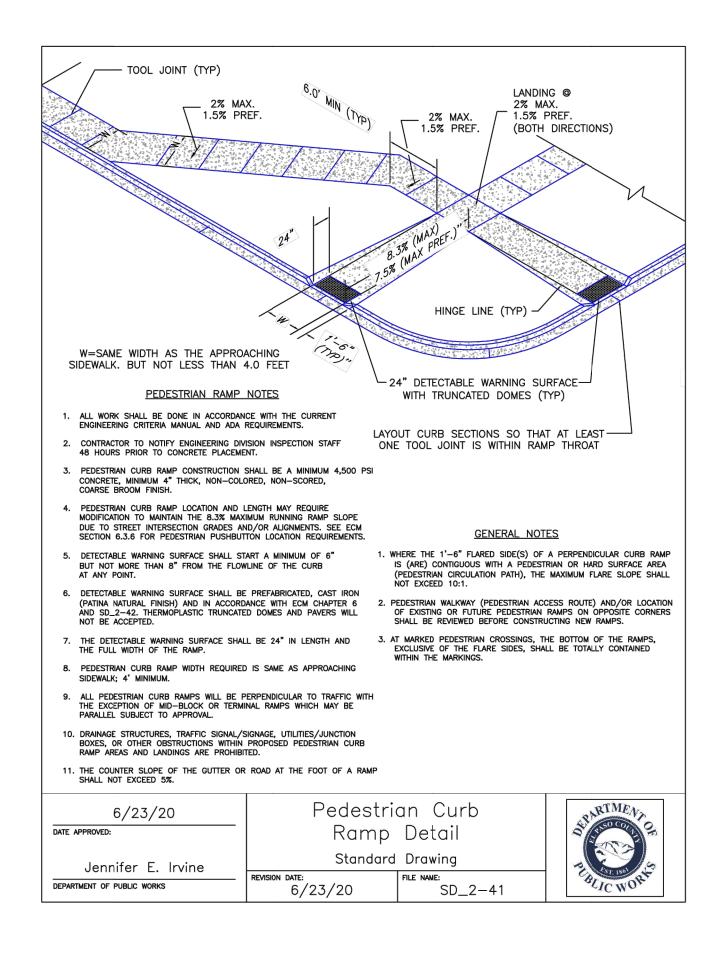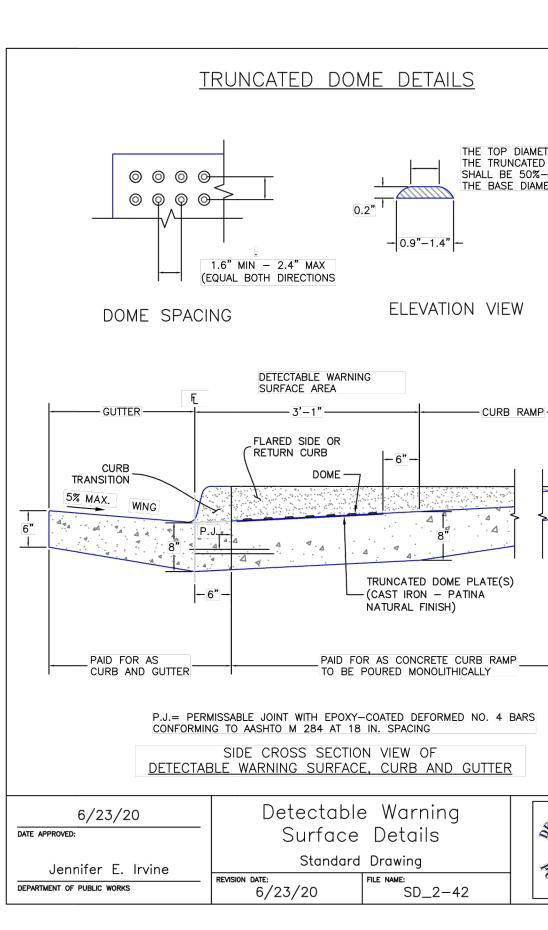- C CENTER LINE 4" WIDE, SOLID YELLOW OUTSIDE, INSIDE 4" X 10' LONG, 30' GAP, YELLOW







0.2"

DETECTABLE WARNING

DOME -

SURFACE AREA

— 3'—1"·

FLARED SIDE OR

- 0.9"-1.4" -

ELEVATION VIEW

TRUNCATED DOME PLATE(S)

— (CAST IRON – PATINA

PAID FOR AS CONCRETE CURB RAMP

TO BE POURED MONOLITHICALLY

Detectable Warning

Surface Details

Standard Drawing

FILE NAME:

SD_2-42

NATURAL FINISH)

	SCALE: NOT TO SCAL
Typical Cross Pan Layout Detail	PASO COUN

Typical C Layout Standard	Detail	DEPARTMENT OF TRANSPORTATION
N DATE:	FILE NAME:	

THE TOP DIAMETER OF THE TRUNCATED DOMES SHALL BE 50%-65% OF THE BASE DIAMETER

- CURB RAMP

4'

RTMEN


ICWC


6/23/20		ian Curb	
DATE APPROVED:	Ramp Detail Standard Drawing		
Jennifer E. Irvine DEPARTMENT OF PUBLIC WORKS	revision date: 6/23/20	FILE NAME: SD_2-40	

DETECTABLE WARNING SURFACES. SEE SD_2-42. (TYP.)

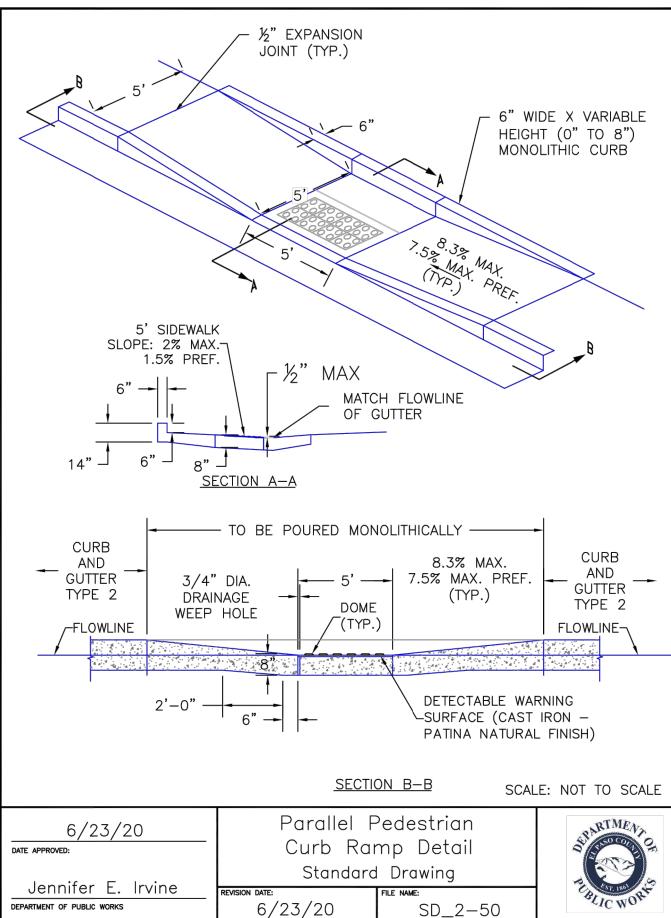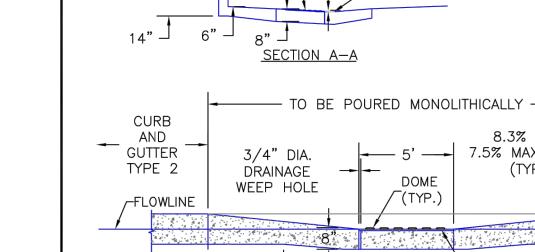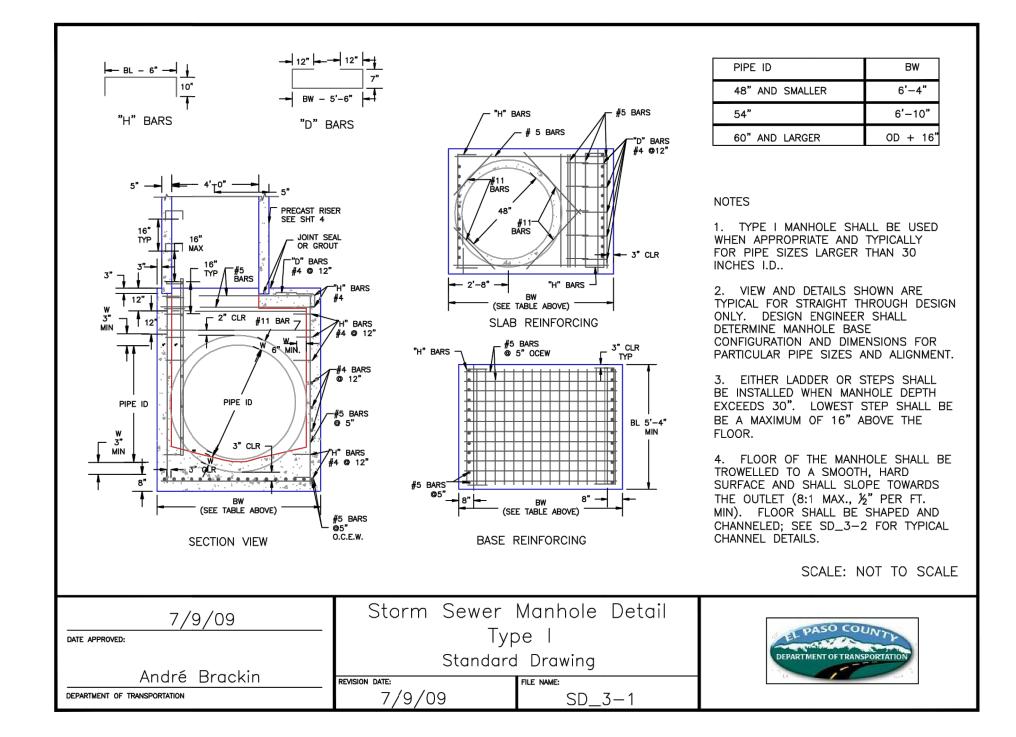
DETECTABLE WARNING SURFACES. SEE SD_2-42. (TYP.)

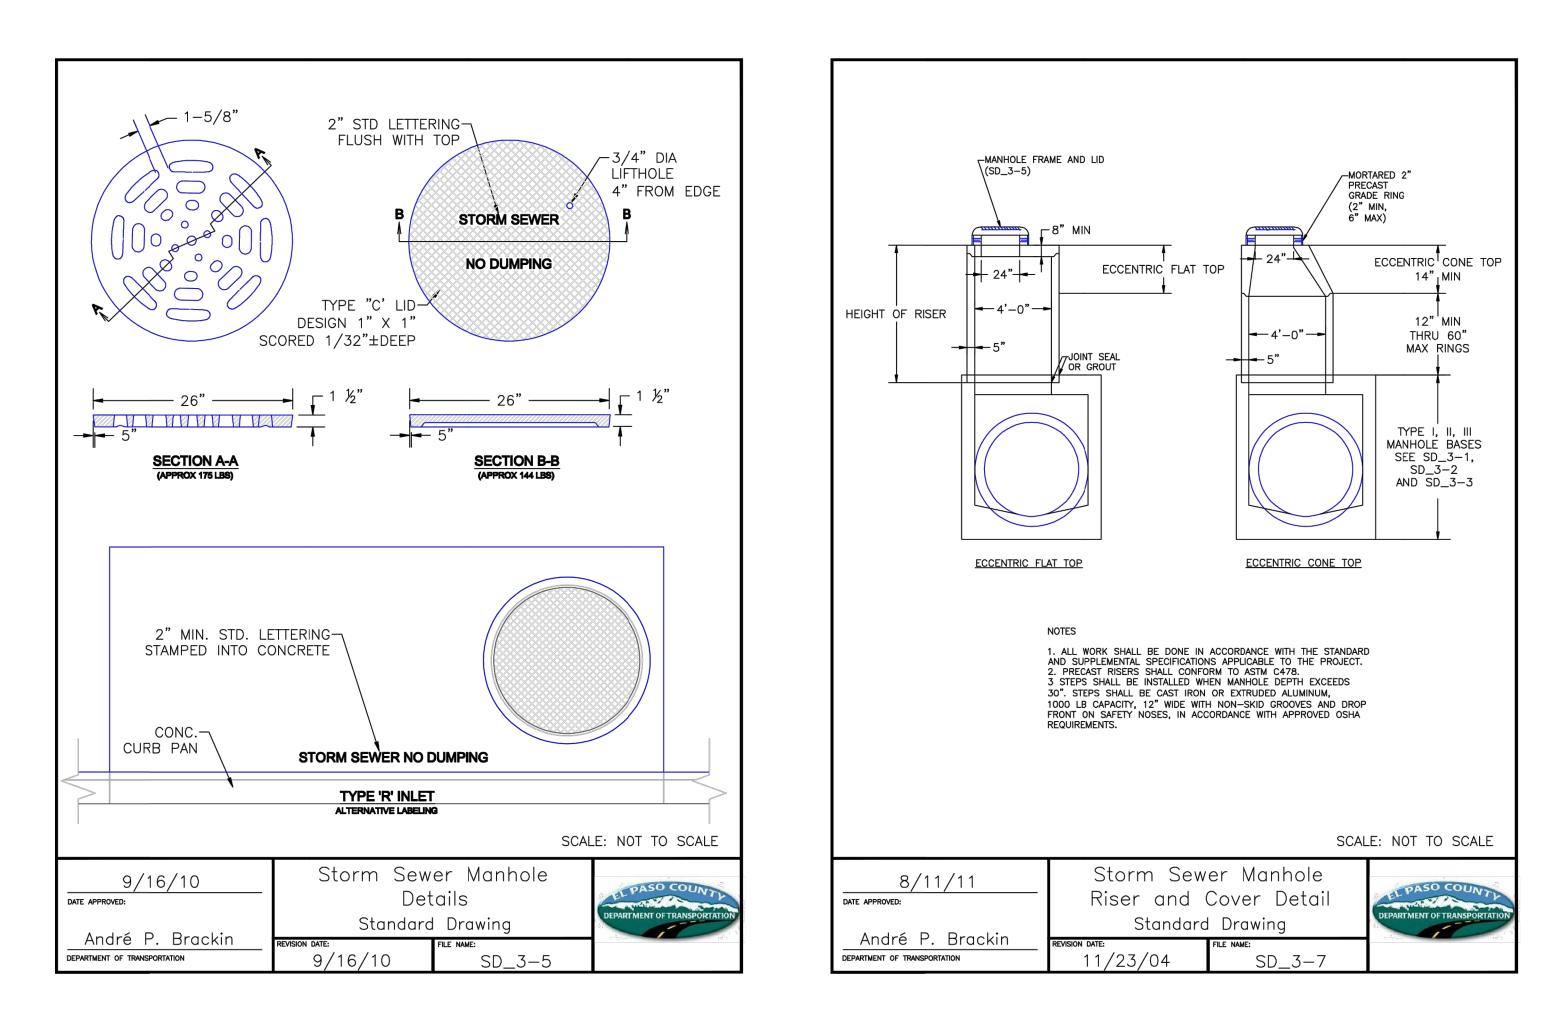
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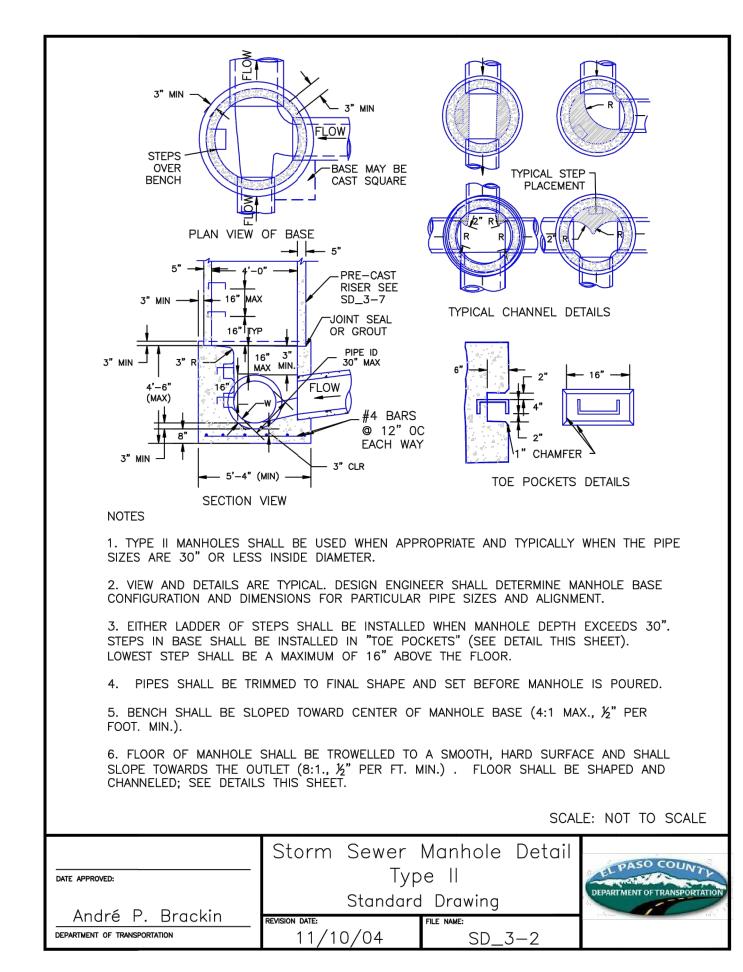





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			UNTIL SUCH TIME AS	THESE DRAWINGS ARE APPROVED BY THE	APPROPRIATE REVIEWING	APPROVES THEIR USE	DESIGNATED BY WRITTEN	
			PREPARED FOR	CS POWERS & GALLEY LLC	510 S NEIL ST	DHC PHC	(734) 216-2577	
	SCALE: NOT TO SCALE			J I-R ENGINEERING			Centennial 303-740-9393 • Colorado Springs 719-593-2593 Fort Collins 970-491-9888 • www.irenchineerinn.com	
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RIABLE D 8") URB			BY DATE					
			. REVISION					
			N/A No.	N/A	11/11/21		JRM	
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TO SCALE		ENGINEER'S STATEMENT STANDARD DETAILS SHOWN WERE REVIEWED ONLY GAS TO THEIR APPLICATION ON THIS PROJECT	SOLACE APARTMENTS FILING	NO. 1				
	Know what's below. Call before you dig.	Mike A. BRAMLETT, P.E. COLORADO P.E. 32314 FOR AND ON BEHALF OF JR ENGINEERING, 10/AL	SHE JOB		29	OF 2517		








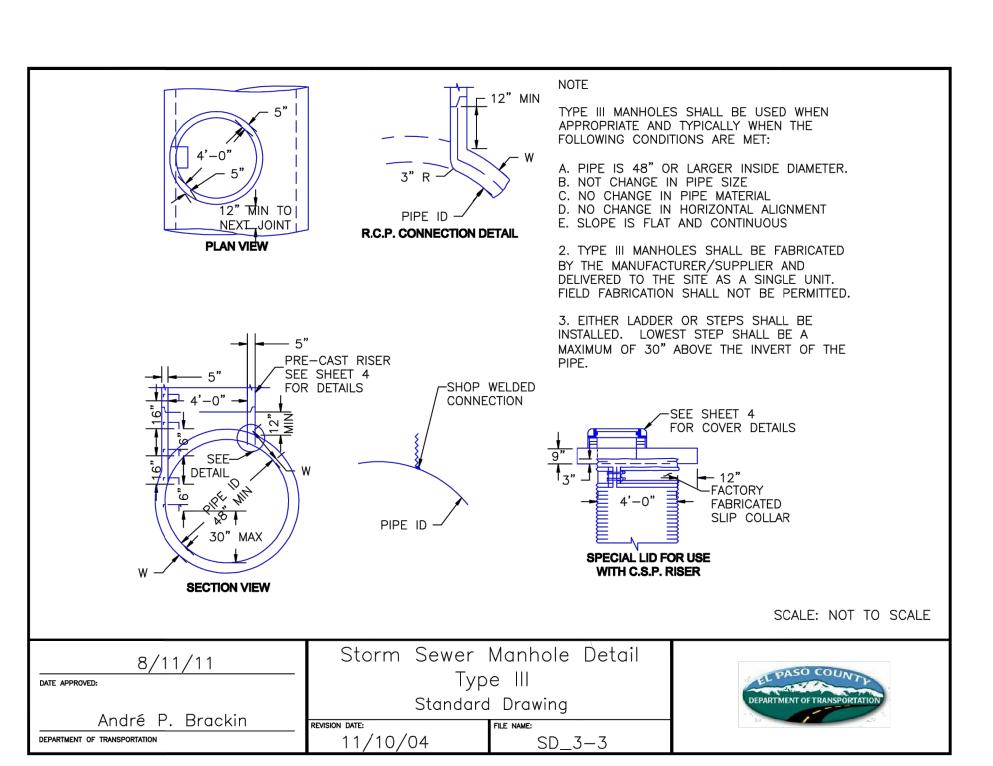


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	PREPARED FOR	CS POWERS & GALLEY LLC	510 S NEIL ST	CHAMPAIGN, IL 67820 Office phone	(734) 216-2577	
			A Westrian Commany		Centennial 303-740-9393 • Colorado Springs 719-593-2593	Fort Collins 970–491–9888 • www.jrengineering.com
	BY DATE					
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	No. REVISION					
	N/A	N/A	11/11/21	JRM	JRM	
	H-SCALE	V-SCALE	DATE	DESIGNED BY JRM	DRAWN BY	СНЕСКЕД ВҮ
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Mike Bundett 32314 11/11/21	
MIKE A. BRAMLETT, P.E.	SHEET
COLORADO P.E. 32314 FOR AND ON BEHALF OF JR ENGINEERING	JOB NO



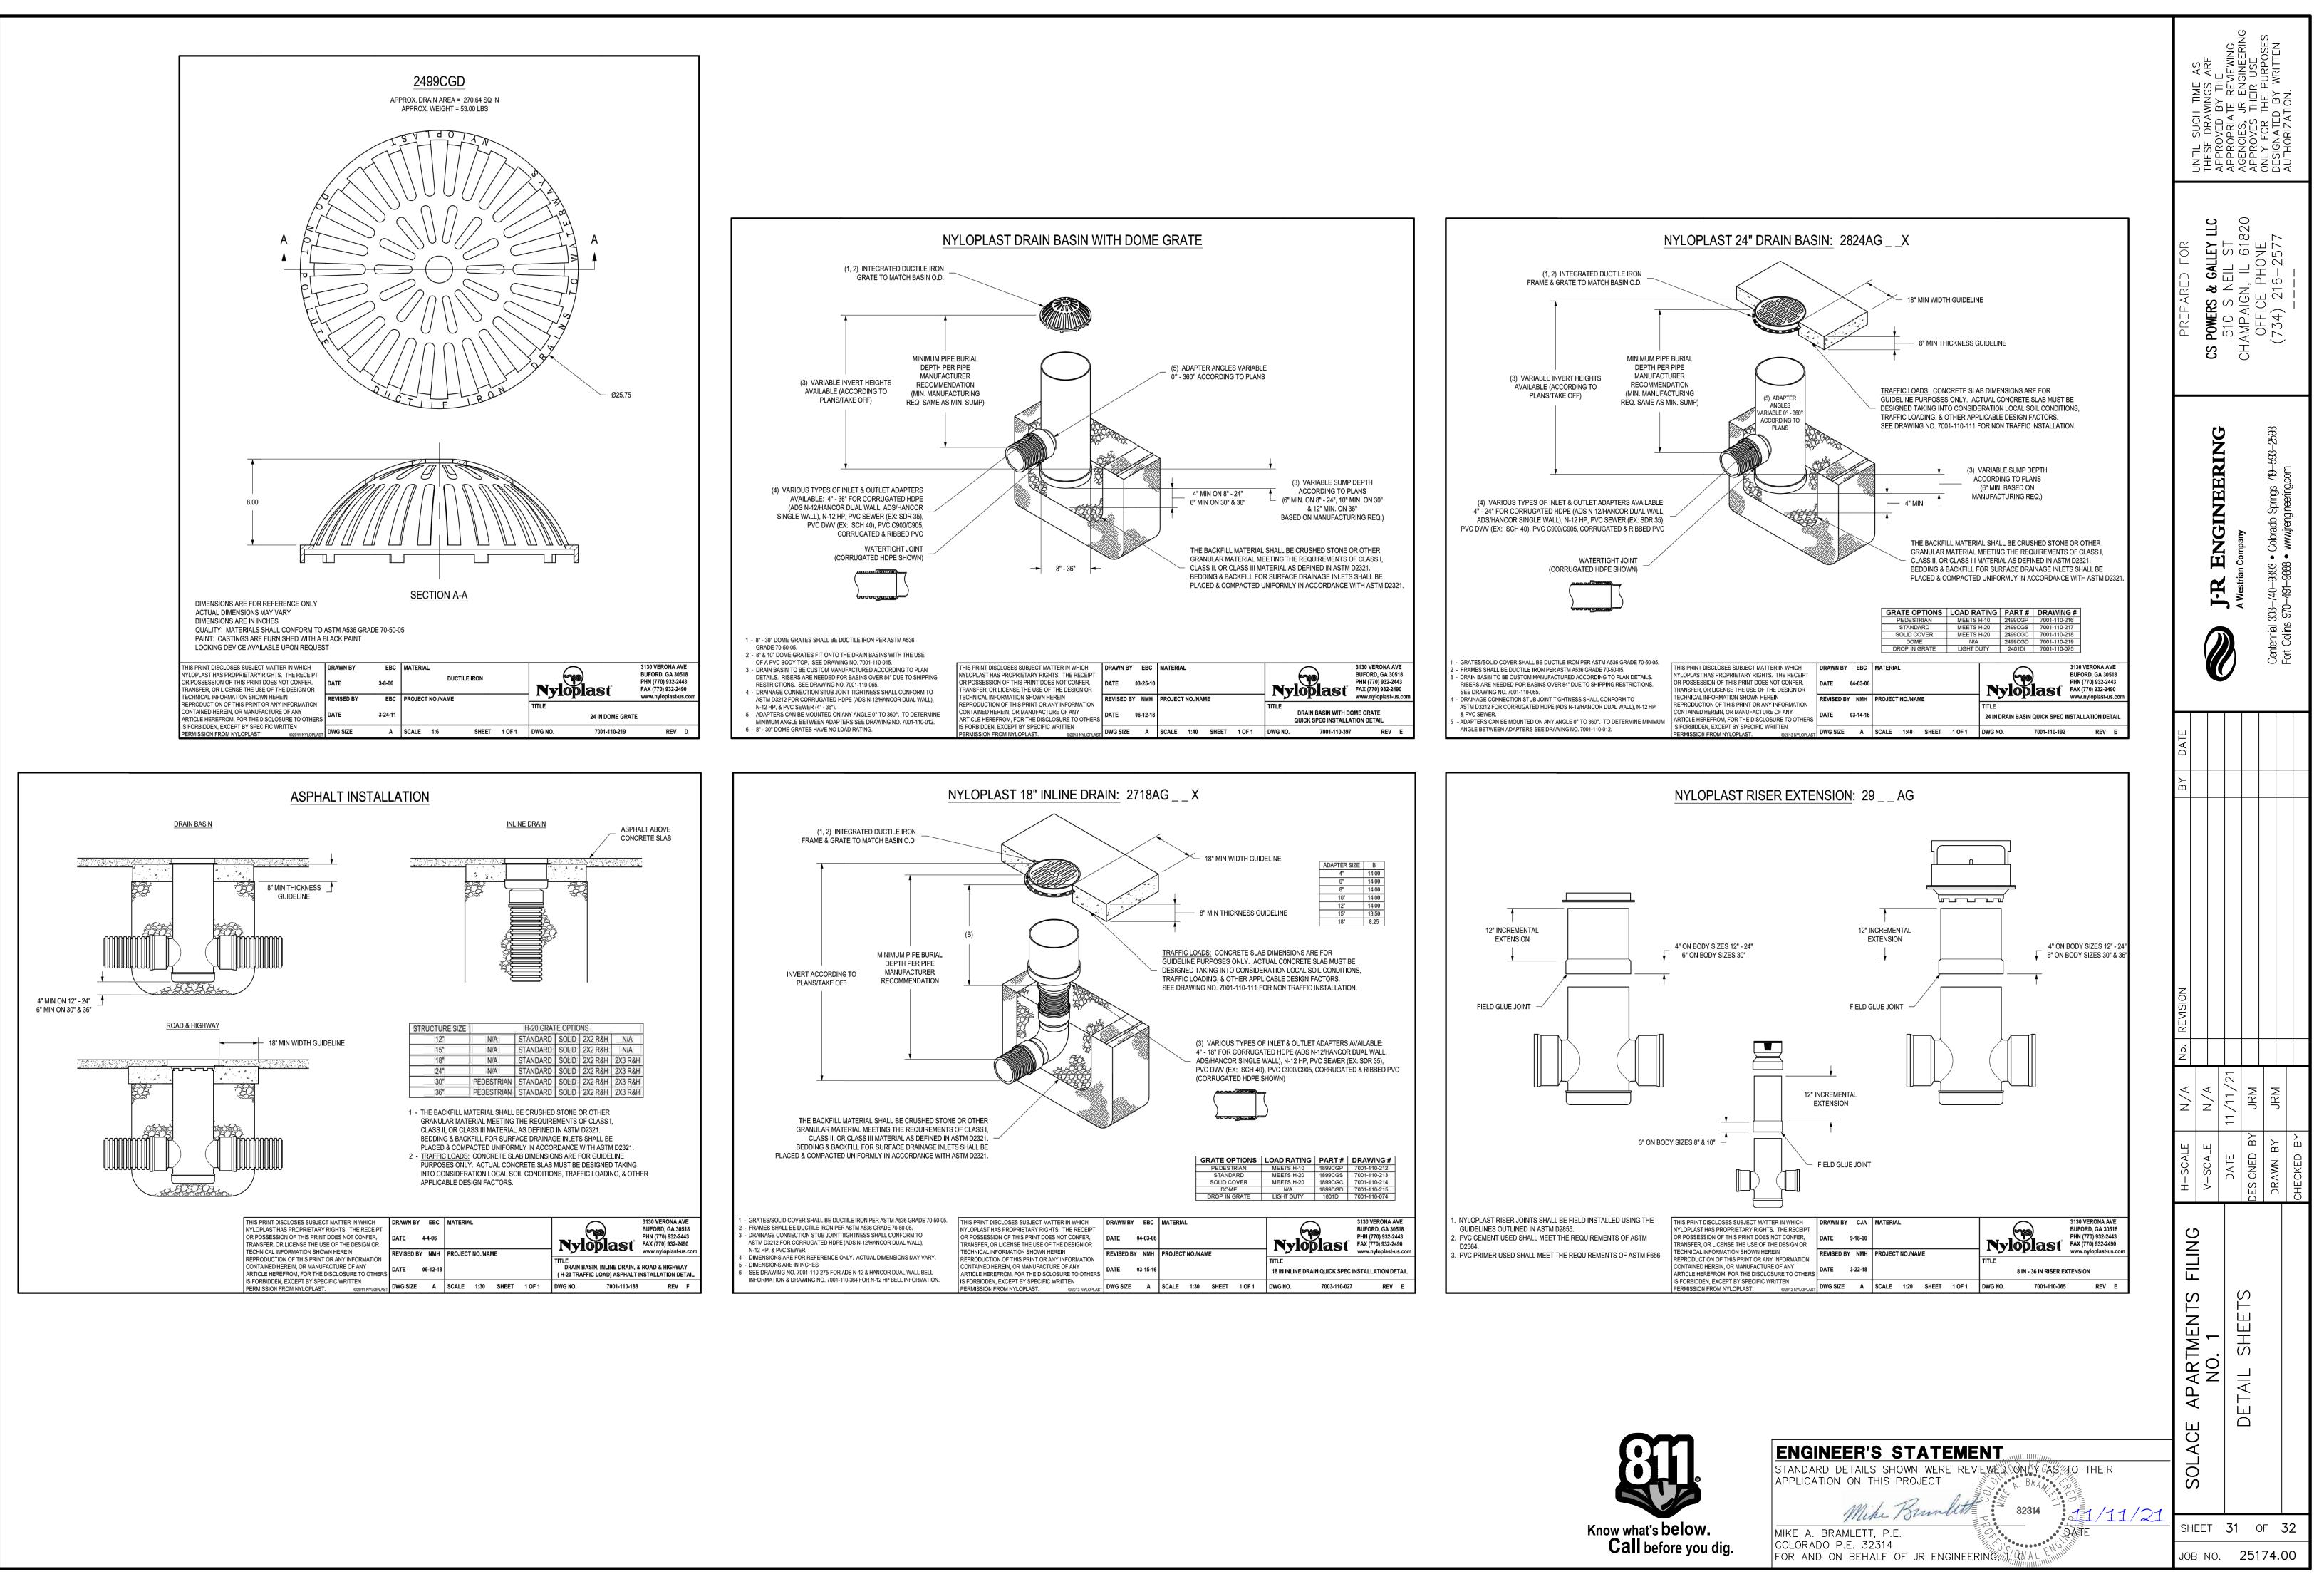
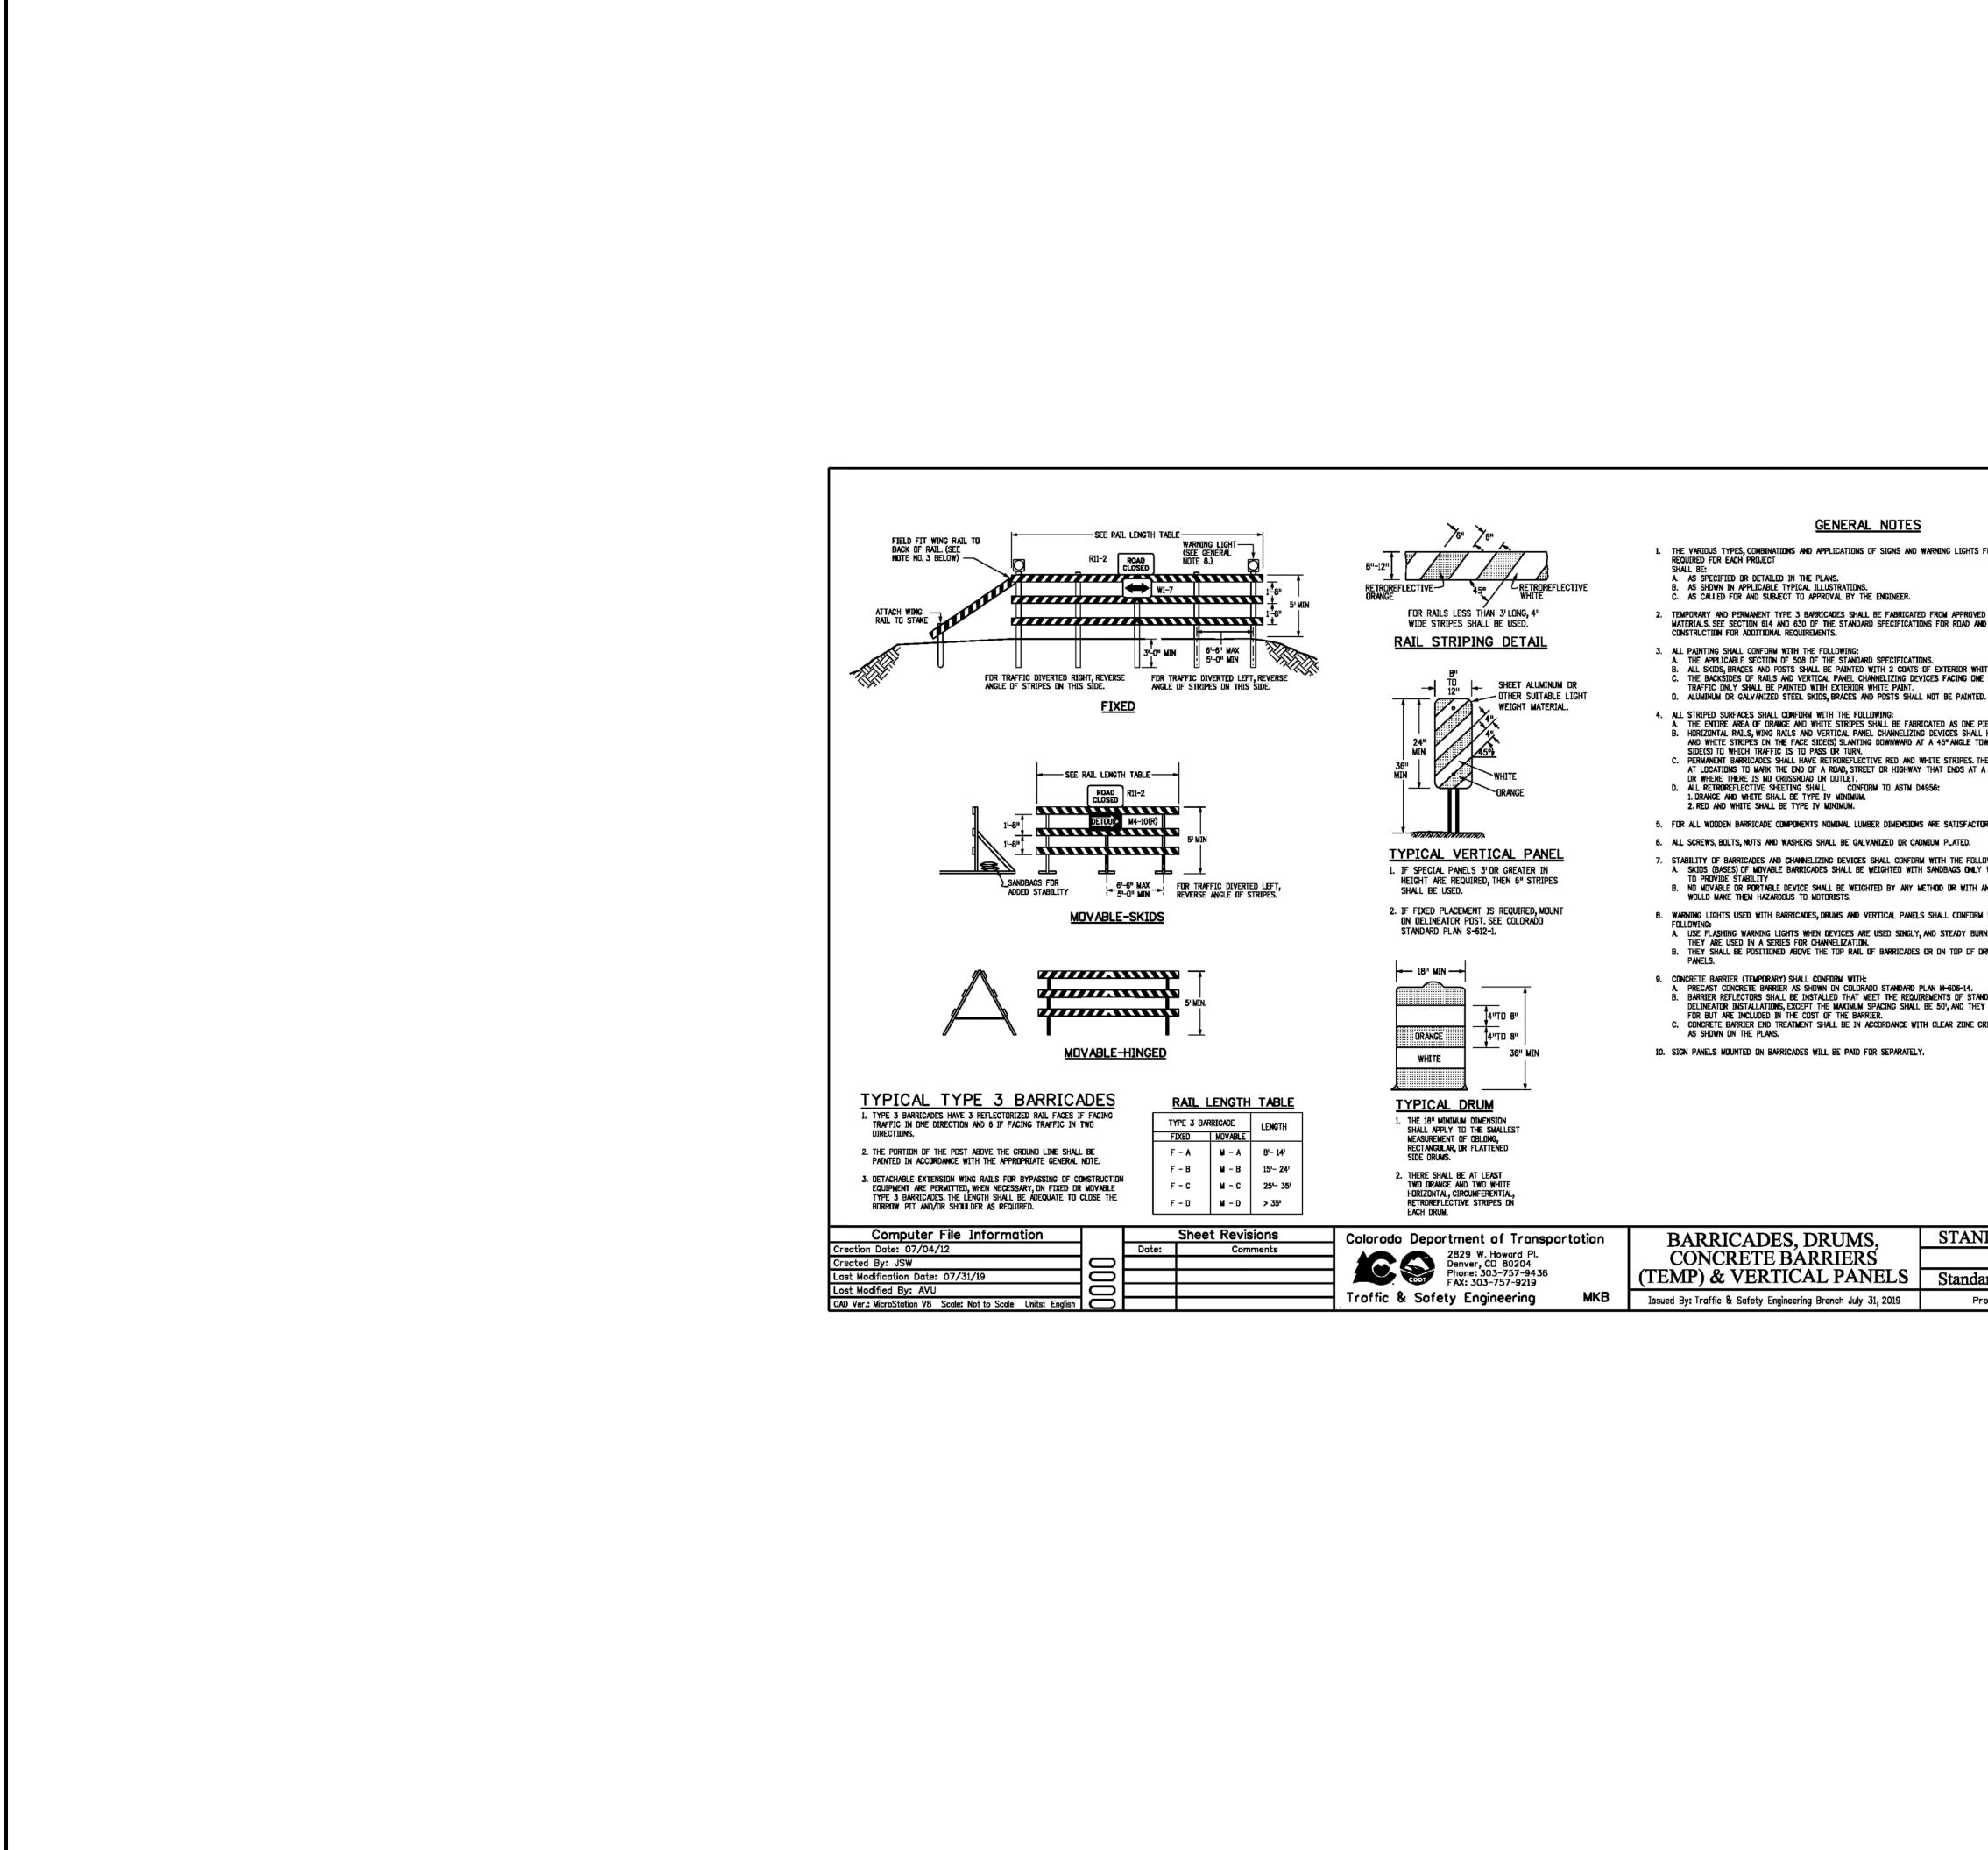
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		PREPARED FOR	s & Gal	510 S NEIL ST	CHAMPAIGN, IL 61820 Office phone	(734) 216-2577	
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NDARD PLAN NO. S-630-2 lard Sheet No. 1 of 1 Project Sheet Number:		-SCALE N/A No. REVISION	-SCALE N/A	DATE 11/11/21 DATE	DESIGNED BY JRM	DRAWN BY JRM	CHECKED BY
	ENGINEER'S STATEMENT STANDARD DETAILS SHOWN WERE REVIEWED ONLY AS TO THEIR APPLICATION ON THIS PROJECT	SOLACE ADARTMENTS FILING			UE I AIL OHEE I O	DR/	CHEC
Know what's below. Call before you dig.	Mike A. BRAMLETT, P.E. COLORADO P.E. 32314 FOR AND ON BEHALF OF JR ENGINEERING, 2001AL		EET 3 NO.	32	01 2517		52 00