



18. TRACKING OF SOILS AND CONSTRUCTION DEBRIS OFF-SITE SHALL BE MINIMIZED. MATERIALS TRACKED OFF-SITE SHALL BE CLEANED UP AND PROPERLY DISPOSED OF IMMEDIATELY.

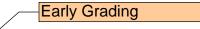

WINDERMERE FILING NO. 2 **GRADING & EROSION CONTROL PLANS**

T13S, R65W OF THE 6TH P.M.

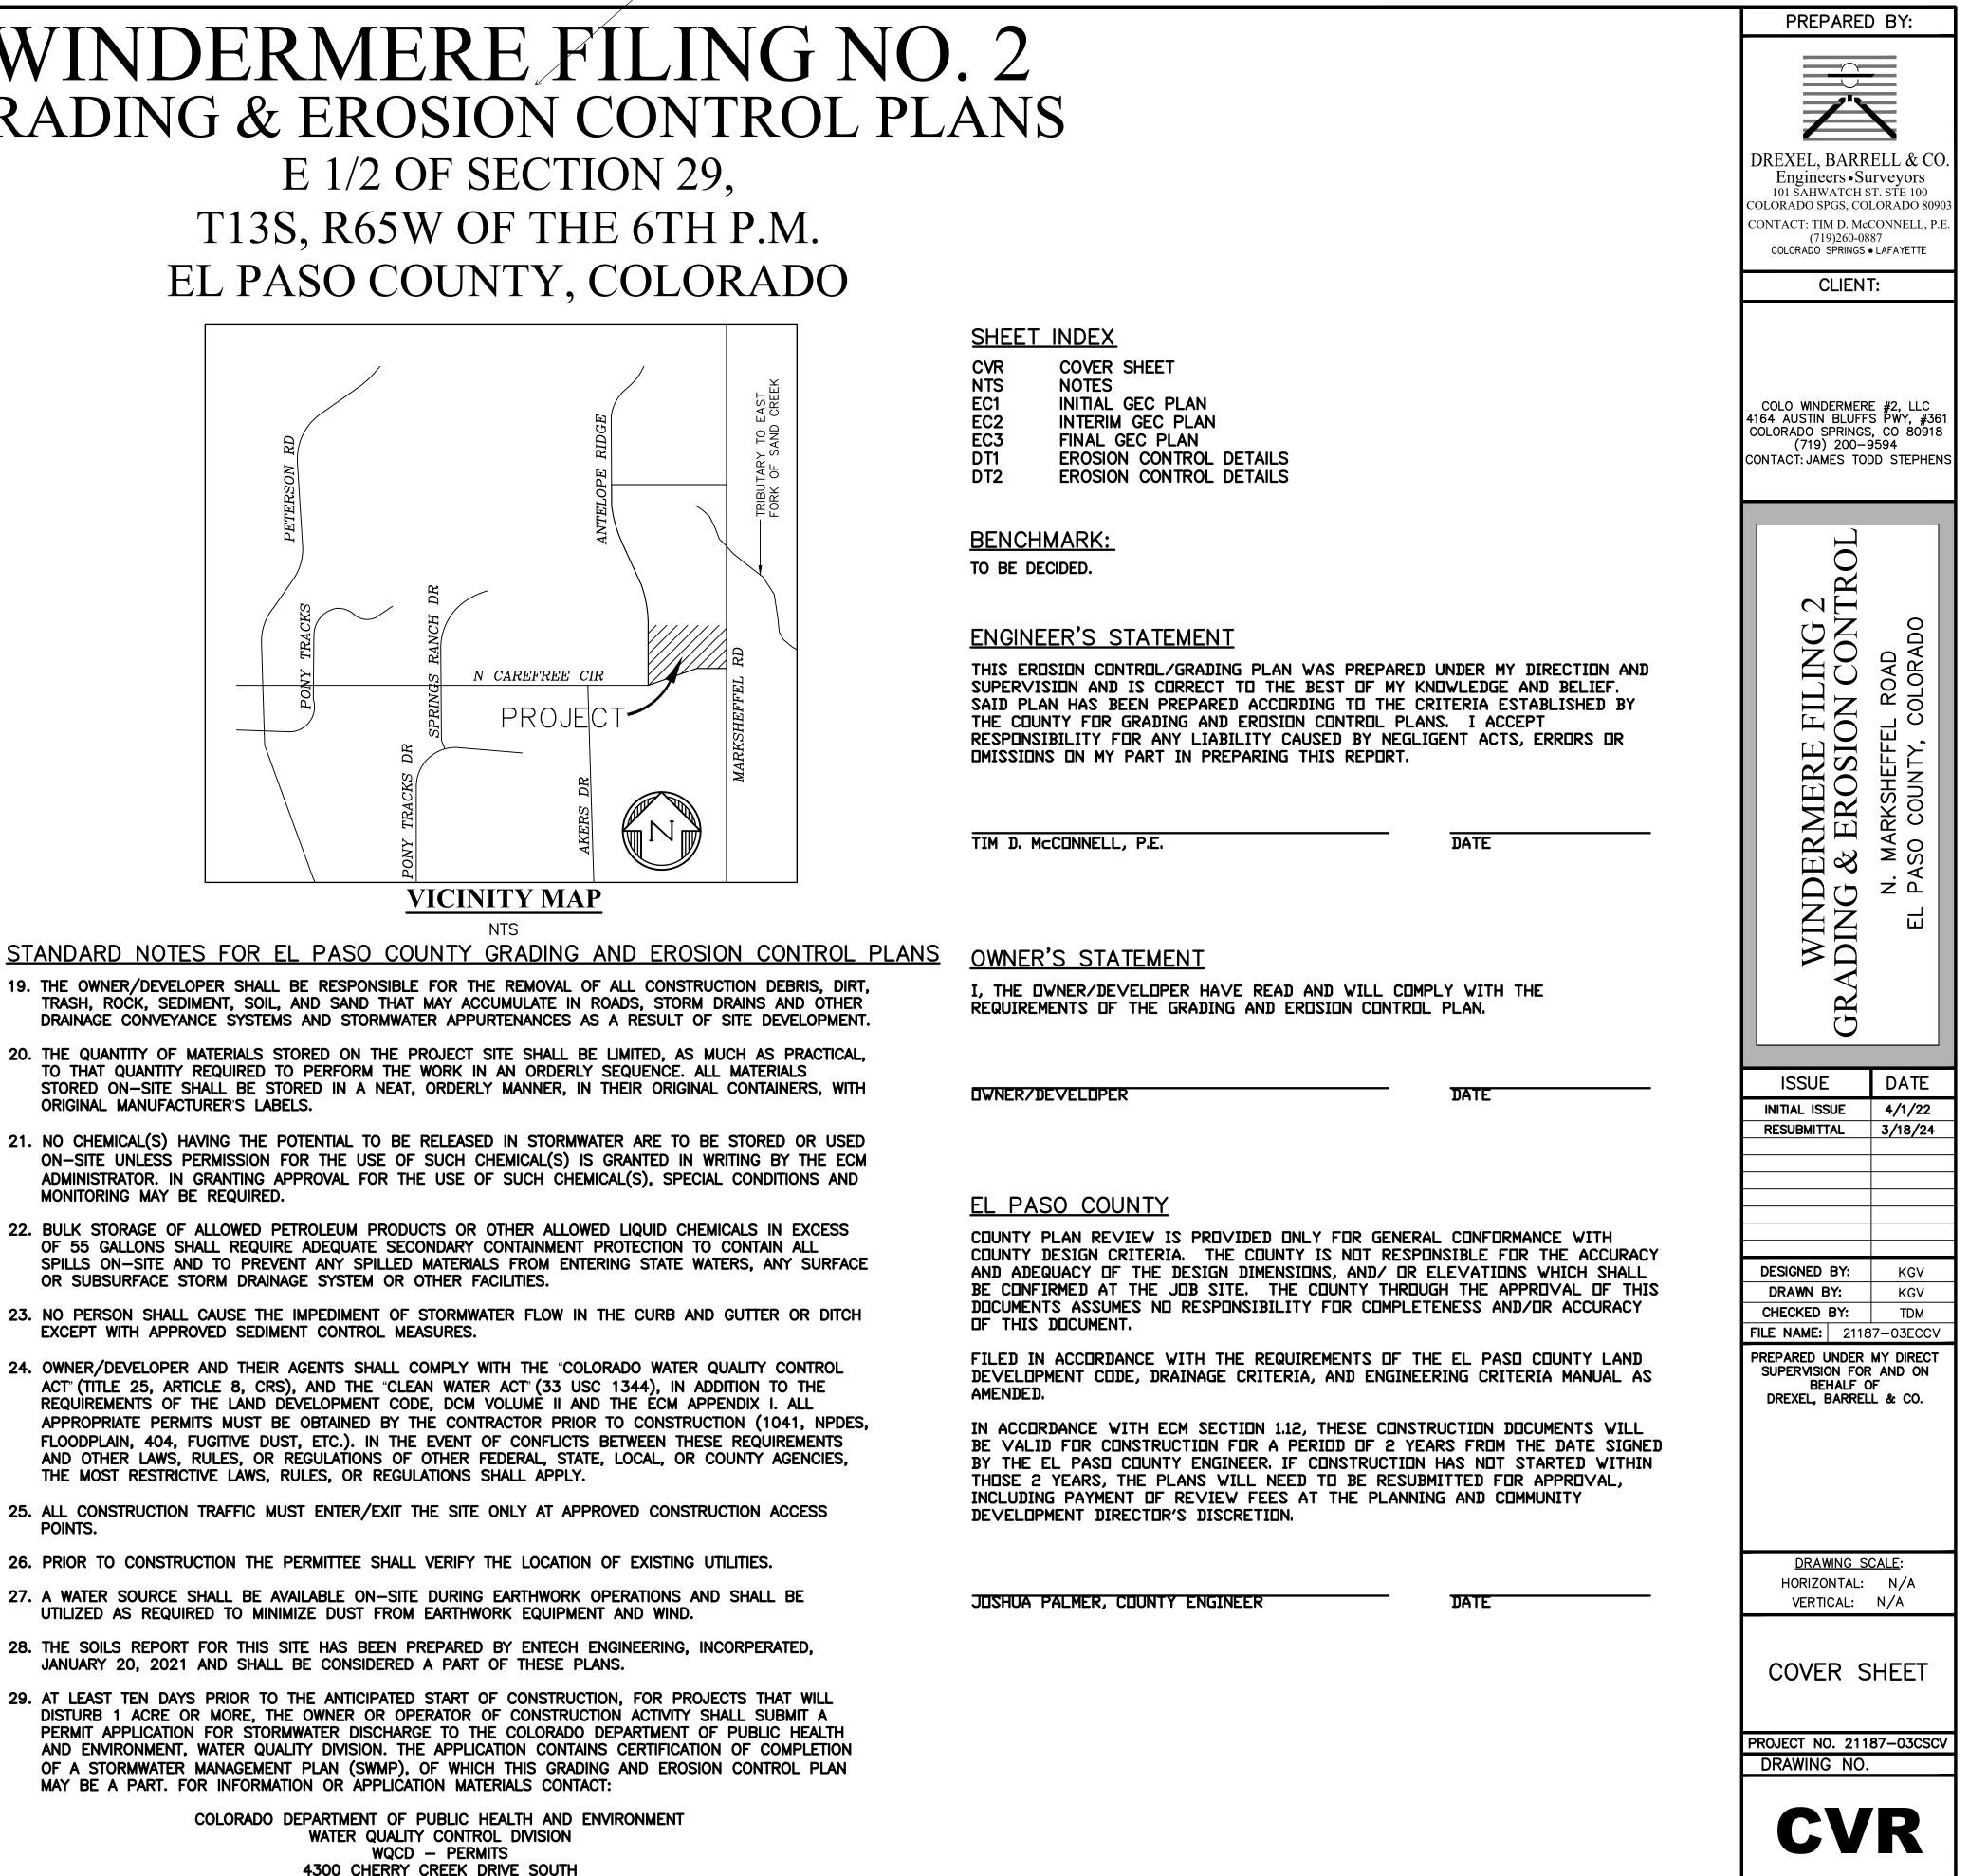

- 28. THE SOILS REPORT FOR THIS SITE HAS BEEN PREPARED BY ENTECH ENGINEERING. INCORPERATED. JANUARY 20, 2021 AND SHALL BE CONSIDERED A PART OF THESE PLANS.
- 29. AT LEAST TEN DAYS PRIOR TO THE ANTICIPATED START OF CONSTRUCTION, FOR PROJECTS THAT WILL DISTURB 1 ACRE OR MORE. THE OWNER OR OPERATOR OF CONSTRUCTION ACTIVITY SHALL SUBMIT A PERMIT APPLICATION FOR STORMWATER DISCHARGE TO THE COLORADO DEPARTMENT OF PUBLIC HEALTH AND ENVIRONMENT. WATER QUALITY DIVISION. THE APPLICATION CONTAINS CERTIFICATION OF COMPLETION OF A STORMWATER MANAGEMENT PLAN (SWMP). OF WHICH THIS GRADING AND EROSION CONTROL PLAN MAY BE A PART. FOR INFORMATION OR APPLICATION MATERIALS CONTACT:

DENVER, CO 80246-1530 ATTN: PERMITS UNIT

COUNTY FILE NO.: SP-22-003 SHEET: 1 OF 7

EPC STORMWATER REVIEW COMMENTS IN ORANGE BOXES WITH BLACK TEXT M


STANDARD NOTES FOR EL PASO COUNTY GRADING AND EROSION CONTROL PLANS

- 1. STORMWATER DISCHARGES FROM CONSTRUCTION SITES SHALL NOT CAUSE OR THREATEN TO CAUSE POLLUTION, CONTAMINATION, OR DEGRADATION OF STATE WATERS. ALL WORK AND EARTH DISTURBANCE SHALL BE DONE IN A MANNER THAT MINIMIZES POLLUTION OF ANY ON-SITE OR OFF SITE WATERS, INCLUDING WETLANDS.
- 2. NOTWITHSTANDING ANYTHING DEPICTED IN THESE PLANS IN WORDS OR GRAPHIC REPRESENTATION, ALL DESIGN AND CONSTRUCTION RELATED TO ROADS, STORM DRAINAGE AND EROSION CONTROL SHALL CONFORM TO THE STANDARDS AND REQUIREMENTS OF THE MOST RECENT VERSION OF THE RELEVANT ADOPTED EL PASO COUNTY STANDARDS, INCLUDING THE LAND DEVELOPMENT CODE, THE ENGINEERING CRITERIA MANUAL, THE DRAINAGE CRITERIA MANUAL VOLUME 2. ANY DEVIATIONS TO REGULATIONS AND STANDARDS MUST BE REQUESTED, AND APPROVED, IN WRITING.
- 3. A SEPARATE STORMWATER MANAGEMENT PLAN (SMWP) FOR THIS PROJECT SHALL BE COMPLETED AND AN EROSION AND STORMWATER QUALITY CONTROL PERMIT (ESQCP) ISSUED PRIOR TO COMMENCING CONSTRUCTION. MANAGEMENT OF THE SWMP DURING CONSTRUCTION IS THE RESPONSIBILITY OF THE DESIGNATED QUALIFIED STORMWATER MANAGER OR CERTIFIED EROSION CONTROL INSPECTOR. THE SWMP SHALL BE LOCATED ON-SITE AT ALL TIMES DURING CONSTRUCTION AND SHALL BE KEPT UP TO DATE WITH WORK PROGRESS AND CHANGES IN THE FIELD.
- 4. ONCE THE ESQCP IS APPROVED AND A "NOTICE TO PROCEED" HAS BEEN ISSUED, THE CONTRACTOR MAY INSTALL THE INITIAL STAGE EROSION AND SEDIMENT CONTROL BMPS AS INDICATED ON THE GEC. A PRECONSTRUCTION MEETING BETWEEN THE CONTRACTOR, ENGINEER, AND EL PASO COUNTY WILL BE HELD PRIOR TO ANY CONSTRUCTION. IT IS THE RESPONSIBILITY OF THE APPLICANT TO COORDINATE THE MEETING TIME AND PLACE WITH COUNTY STAFF.
- 5. CONTROL MEASURES MUST BE INSTALLED PRIOR TO COMMENCEMENT OF ACTIVITIES THAT COULD CONTRIBUTE POLLUTANTS TO STORMWATER. CONTROL MEASURES FOR ALL SLOPES, CHANNELS, DITCHES, AND DISTURBED LAND AREAS SHALL BE INSTALLED IMMEDIATELY UPON COMPLETION OF THE DISTURBANCE.
- 6. ALL TEMPORARY SEDIMENT AND EROSION CONTROL MEASURES SHALL BE MAINTAINED AND REMAIN IN EFFECTIVE OPERATING CONDITION UNTIL PERMANENT SOIL EROSION CONTROL MEASURES ARE IMPLEMENTED AND FINAL STABILIZATION IS ESTABLISHED. ALL PERSONS ENGAGED IN LAND DISTURBANCE ACTIVITIES SHALL ASSESS THE ADEQUACY OF CONTROL MEASURES AT THE SITE AND IDENTIFY IF CHANGES TO THOSE CONTROL MEASURES ARE NEEDED TO ENSURE THE CONTINUED EFFECTIVE PERFORMANCE OF THE CONTROL MEASURES. ALL CHANGES TO TEMPORARY SEDIMENT AND EROSION CONTROL MEASURES MUST BE INCORPORATED INTO THE STORMWATER MANAGEMENT PLAN.
- 7. TEMPORARY STABILIZATION SHALL BE IMPLEMENTED ON DISTURBED AREAS AND STOCKPILES WHERE GROUND DISTURBING CONSTRUCTION ACTIVITY HAS PERMANENTLY CEASED OR TEMPORARILY CEASED FOR LONGER THAN 14 DAYS.
- 8. FINAL STABILIZATION MUST BE IMPLEMENTED AT ALL APPLICABLE CONSTRUCTION SITES. FINAL STABILIZATION IS ACHIEVED WHEN ALL GROUND DISTURBING ACTIVITIES ARE COMPLETE AND ALL DISTURBED AREAS EITHER HAVE A UNIFORM VEGETATIVE COVER WITH INDIVIDUAL PLANT DENSITY OF 70 PERCENT OF PRE-DISTURBANCE LEVELS ESTABLISHED OR EQUIVALENT PERMANENT ALTERNATIVE STABILIZATION METHOD IS IMPLEMENTED. ALL TEMPORARY SEDIMENT AND EROSION CONTROL MEASURES SHALL BE REMOVED UPON FINAL STABILIZATION AND BEFORE PERMIT CLOSURE.
- 9. ALL PERMANENT STORMWATER MANAGEMENT FACILITIES SHALL BE INSTALLED AS DESIGNED IN THE APPROVED PLANS. ANY PROPOSED CHANGES THAT EFFECT THE DESIGN OR FUNCTION OF PERMANENT STORMWATER MANAGEMENT STRUCTURES MUST BE APPROVED BY THE ECM ADMINISTRATOR PRIOR TO IMPLEMENTATION.
- 10. EARTH DISTURBANCES SHALL BE CONDUCTED IN SUCH A MANNER SO AS TO EFFECTIVELY MINIMIZE ACCELERATED SOIL EROSION AND RESULTING SEDIMENTATION. ALL DISTURBANCES SHALL BE DESIGNED, CONSTRUCTED, AND COMPLETED SO THAT THE EXPOSED AREA OF ANY DISTURBED LAND SHALL BE LIMITED TO THE SHORTEST PRACTICAL PERIOD OF TIME. PRE-EXISTING VEGETATION SHALL BE PROTECTED AND MAINTAINED WITHIN 50 HORIZONTAL FEET OF A WATERS OF THE STATE UNLESS SHOWN TO BE INFEASIBLE AND SPECIFICALLY REQUESTED AND APPROVED.
- 11. COMPACTION OF SOIL MUST BE PREVENTED IN AREAS DESIGNATED FOR INFILTRATION CONTROL MEASURES OR WHERE FINAL STABILIZATION WILL BE ACHIEVED BY VEGETATIVE COVER. AREAS DESIGNATED FOR INFILTRATION CONTROL MEASURES SHALL ALSO BE PROTECTED FROM SEDIMENTATION DURING CONSTRUCTION UNTIL FINAL STABILIZATION IS ACHIEVED. IF COMPACTION PREVENTION IS NOT FEASIBLE DUE TO SITE CONSTRAINTS, ALL AREAS DESIGNATED FOR INFILTRATION AND VEGETATION CONTROL MEASURES MUST BE LOOSENED PRIOR TO INSTALLATION OF THE CONTROL MEASURE(S).
- 12. ANY TEMPORARY OR PERMANENT FACILITY DESIGNED AND CONSTRUCTED FOR THE CONVEYANCE OF STORMWATER AROUND, THROUGH, OR FROM THE EARTH DISTURBANCE AREA SHALL BE A STABILIZED CONVEYANCE DESIGNED TO MINIMIZE EROSION AND THE DISCHARGE OF SEDIMENT OFF-SITE.
- 13. CONCRETE WASH WATER SHALL BE CONTAINED AND DISPOSED OF IN ACCORDANCE WITH THE SWMP. NO WASH WATER SHALL BE DISCHARGED TO OR ALLOWED TO ENTER STATE WATERS, INCLUDING ANY SURFACE OR SUBSURFACE STORM DRAINAGE SYSTEM OR FACILITIES. CONCRETE WASHOUTS SHALL NOT BE LOCATED IN AN AREA WHERE SHALLOW GROUNDWATER MAY BE PRESENT, OR WITHIN 50 FEET OF A SURFACE WATER BODY, CREEK OR STREAM.
- 14. DURING DEWATERING OPERATIONS, UNCONTAMINATED GROUNDWATER MAY BE DISCHARGED ON-SITE, BUT SHALL NOT LEAVE THE SITE IN THE FORM OF SURFACE RUNOFF UNLESS AN APPROVED STATE DEWATERING PERMIT IS IN PLACE.
- 15. EROSION CONTROL BLANKETING OR OTHER PROTECTIVE COVERING SHALL BE USED ON SLOPES STEEPER THAN 3:1.
- 16. CONTRACTOR SHALL BE RESPONSIBLE FOR THE REMOVAL OF ALL WASTES FROM THE CONSTRUCTION SITE FOR DISPOSAL IN ACCORDANCE WITH LOCAL AND STATE REGULATORY REQUIREMENTS. NO CONSTRUCTION DEBRIS, TREE SLASH, BUILDING MATERIAL WASTES OR UNUSED BUILDING MATERIALS SHALL BE BURIED, DUMPED, OR DISCHARGED AT THE SITE.
- 17. WASTE MATERIALS SHALL NOT BE TEMPORARILY PLACED OR STORED IN THE STREET, ALLEY, OR OTHER PUBLIC WAY, UNLESS IN ACCORDANCE WITH AN APPROVED TRAFFIC CONTROL PLAN. CONTROL MEASURES MAY BE REQUIRED BY EL PASO COUNTY ENGINEERING IF DEEMED NECESSARY, BASED ON SPECIFIC CONDITIONS AND CIRCUMSTANCES.
- 18. TRACKING OF SOILS AND CONSTRUCTION DEBRIS OFF-SITE SHALL BE MINIMIZED. MATERIALS TRACKED OFF-SITE SHALL BE CLEANED UP AND PROPERLY DISPOSED OF IMMEDIATELY.
- 19. THE OWNER/DEVELOPER SHALL BE RESPONSIBLE FOR THE REMOVAL OF ALL CONSTRUCTION DEBRIS, DIRT, TRASH, ROCK, SEDIMENT, SOIL, AND SAND THAT MAY ACCUMULATE IN ROADS, STORM DRAINS AND OTHER DRAINAGE CONVEYANCE SYSTEMS AND STORMWATER APPURTENANCES AS A RESULT OF SITE DEVELOPMENT.
- 20. THE QUANTITY OF MATERIALS STORED ON THE PROJECT SITE SHALL BE LIMITED, AS MUCH AS PRACTICAL, TO THAT QUANTITY REQUIRED TO PERFORM THE WORK IN AN ORDERLY SEQUENCE. ALL MATERIALS STORED ON-SITE SHALL BE STORED IN A NEAT, ORDERLY MANNER, IN THEIR ORIGINAL CONTAINERS, WITH ORIGINAL MANUFACTURER'S LABELS.
- 21. NO CHEMICAL(S) HAVING THE POTENTIAL TO BE RELEASED IN STORMWATER ARE TO BE STORED OR USED ON-SITE UNLESS PERMISSION FOR THE USE OF SUCH CHEMICAL(S) IS GRANTED IN WRITING BY THE ECM ADMINISTRATOR. IN GRANTING APPROVAL FOR THE USE OF SUCH CHEMICAL(S), SPECIAL CONDITIONS AND MONITORING MAY BE REQUIRED.

| 22. BULK | STORAGE | OF ALLOWE | D PETROLE | UM PROD | JCTS OR | OTHER | ALLOWED | LIQUID CHE | EMICALS | IN EXCESS | 5 OF 55 |
|----------|-----------|-----------|-------------|-----------|----------|---------|------------|------------|---------|-----------|------------|
| GALLC | NS SHALL | REQUIRE / | ADEQUATE S | SECONDAR' | Y CONTAI | NMENT | PROTECTION | N TO CONT | AIN ALL | SPILLS ON | I-SITE AND |
| TO PF | REVENT AN | Y SPILLED | MATERIALS | FROM EN | TERING S | STATE W | ATERS, ANY | SURFACE | OR SUE | BSURFACE | STORM |
| DRAIN | AGE SYSTE | M OR OTH | ER FACILITI | ES. | | | | | | | |

- 23. NO PERSON SHALL CAUSE THE IMPEDIMENT OF STORMWATER FLOW IN THE CURB AND GUTTER OR DITCH EXCEPT WITH APPROVED SEDIMENT CONTROL MEASURES.
- 24. OWNER/DEVELOPER AND THEIR AGENTS SHALL COMPLY WITH THE "COLORADO WATER QUALITY CONTROL ACT" (TITLE 25, ARTICLE 8, CRS), AND THE "CLEAN WATER ACT" (33 USC 1344), IN ADDITION TO THE REQUIREMENTS OF THE LAND DEVELOPMENT CODE, DCM VOLUME II AND THE ECM APPENDIX I. ALL APPROPRIATE PERMITS MUST BE OBTAINED BY THE CONTRACTOR PRIOR TO CONSTRUCTION (1041, NPDES, FLOODPLAIN, 404, FUGITIVE DUST, ETC.). IN THE EVENT OF CONFLICTS BETWEEN THESE REQUIREMENTS AND OTHER LAWS, RULES, OR REGULATIONS OF OTHER FEDERAL, STATE, LOCAL, OR COUNTY AGENCIES, THE MOST RESTRICTIVE LAWS, RULES, OR REGULATIONS SHALL APPLY.
- 25. ALL CONSTRUCTION TRAFFIC MUST ENTER/EXIT THE SITE ONLY AT APPROVED CONSTRUCTION ACCESS POINTS.
- 26. PRIOR TO CONSTRUCTION THE PERMITTEE SHALL VERIFY THE LOCATION OF EXISTING UTILITIES.
- 27. A WATER SOURCE SHALL BE AVAILABLE ON-SITE DURING EARTHWORK OPERATIONS AND SHALL BE UTILIZED AS REQUIRED TO MINIMIZE DUST FROM EARTHWORK EQUIPMENT AND WIND.
- 28. THE SOILS REPORT FOR THIS SITE HAS BEEN PREPARED BY RMG ENGINEERS, OCTOBER 26, 2020 AND SHALL BE CONSIDERED A PART OF THESE PLANS.
- 29. AT LEAST TEN (10) DAYS PRIOR TO THE ANTICIPATED START OF CONSTRUCTION, FOR PROJECTS THAT WILL DISTURB ONE (1)ACRE OR MORE, THE OWNER OR OPERATOR OF CONSTRUCTION ACTIVITY SHALL SUBMIT A PERMIT APPLICATION FOR STORMWATER DISCHARGE TO THE COLORADO DEPARTMENT OF PUBLIC HEALTH AND ENVIRONMENT, WATER QUALITY DIVISION. THE APPLICATION CONTAINS CERTIFICATION OF COMPLETION OF A STORMWATER MANAGEMENT PLAN(SWMP), OF WHICH THIS GRADING AND EROSION CONTROL PLAN MAY BE A PART. FOR INFORMATION OR APPLICATION MATERIALS CONTACT:
- COLORADO DEPARTMENT OF PUBLIC HEALTH AND ENVIRONMENT WATER QUALITY CONTROL DIVISION WQCD – PERMITS 4300 CHERRY CREEK DRIVE SOUTH
- DENVER, CO 80246–1530 ATTN: PERMITS UNIT


| | | PREPARE | D BY: |
|--|------|--|---|
| | | DREXEL, BARR Engineers • St 101 SAHWATCH S COLORADO SPGS, CC CONTACT: TIM D. Mc (719)260-08 COLORADO SPRINGS | LITVEYORS ST. STE 100 IORADO 80903 CONNELL, P.E. 887 • LAFAYETTE |
| | | COLO WINDERMER 4164 AUSTIN BLUFF COLORADO SPRINGS (719) 200- CONTACT: JAMES TO | 6, CO 80918 9594 |
| | | WINDERMERE FILING 2 GRADING & EROSION CONTROL | N. MARKSHEFFEL ROAD EL PASO COUNTY, COLORADO |
| | | ISSUE INITIAL ISSUE | DATE 4/1/22 |
| | | RESUBMITTAL | 3/18/24 |
| | | | |
| | | DESIGNED BY: DRAWN BY: CHECKED BY: | KGV KGV TDM |
| | | FILE NAME: 2118 PREPARED UNDER SUPERVISION FOF BEHALF (DREXEL, BARREI | B7-03ECCV MY DIRECT R AND ON DF L & CO. |
| | | <u>DRAWING S</u> HORIZONTAL: VERTICAL: | |
| | | | |
| | | PROJECT NO. 211 DRAWING NO. | |
| | | ΝΤ | |
| | | SHEET: 2 | |

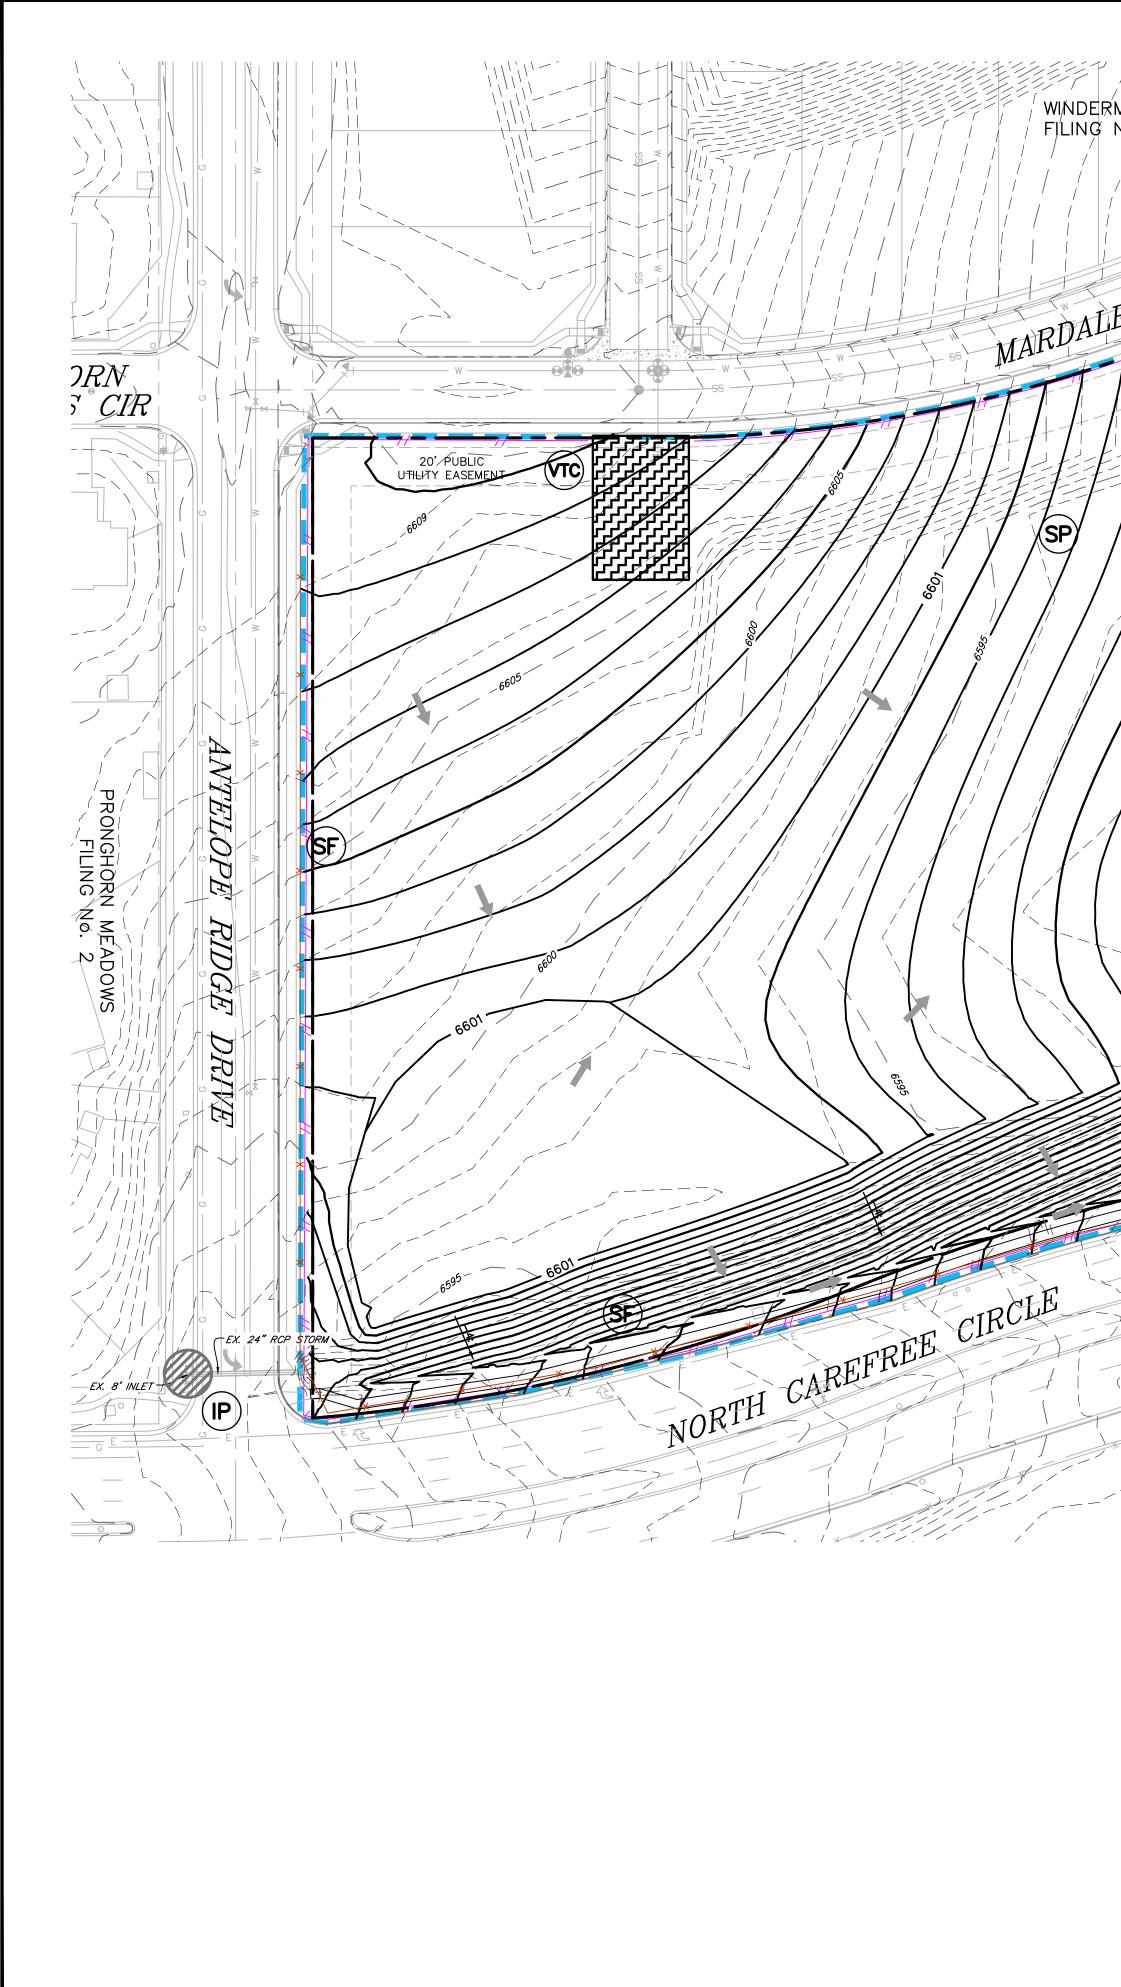

WINDERMERE FILING No, 1 -65.95 _____ MARDALE LANE - EX. 12" STORM -24" RCP STORM EX. 10' INLET — EX 5' INLET EX. 24" RCP STORM FOREBAY -(SF) (SP) TRICKLE + CHANNEL PUBLIC DRAINAGE SF DETENTION POND ORIFICE PLATE TO BE REPLACED WHEN SITE DEVELOPS WHEN SITE DEVELOPS 147 Easem NINLET EX. AREA INLET $-\!\!\!/$ EX. AREA INLET FT Paso County Easement Reception #209071399 EX. 24" RCP STORM EX. 24" RCP STORM-EX. 30" RCP STORM \sim \leq 0_____ 1/

show existing and proposed flow direction arrows



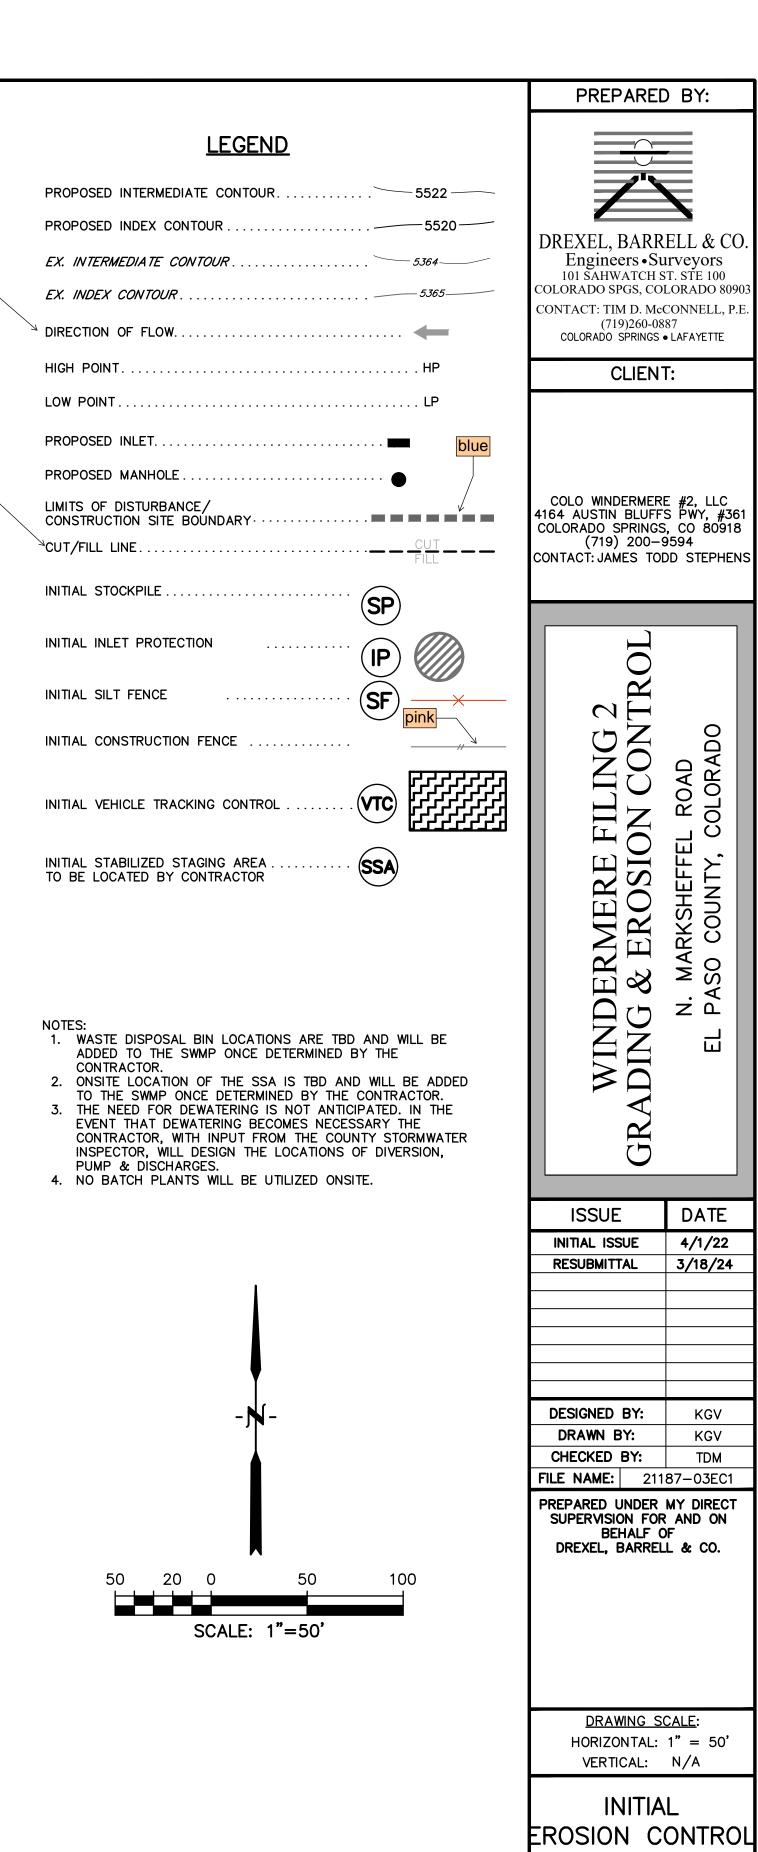

ADO

OUN


Ũ


0


KGV


KGV

TDM

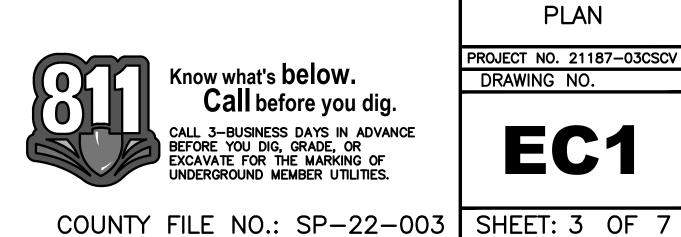


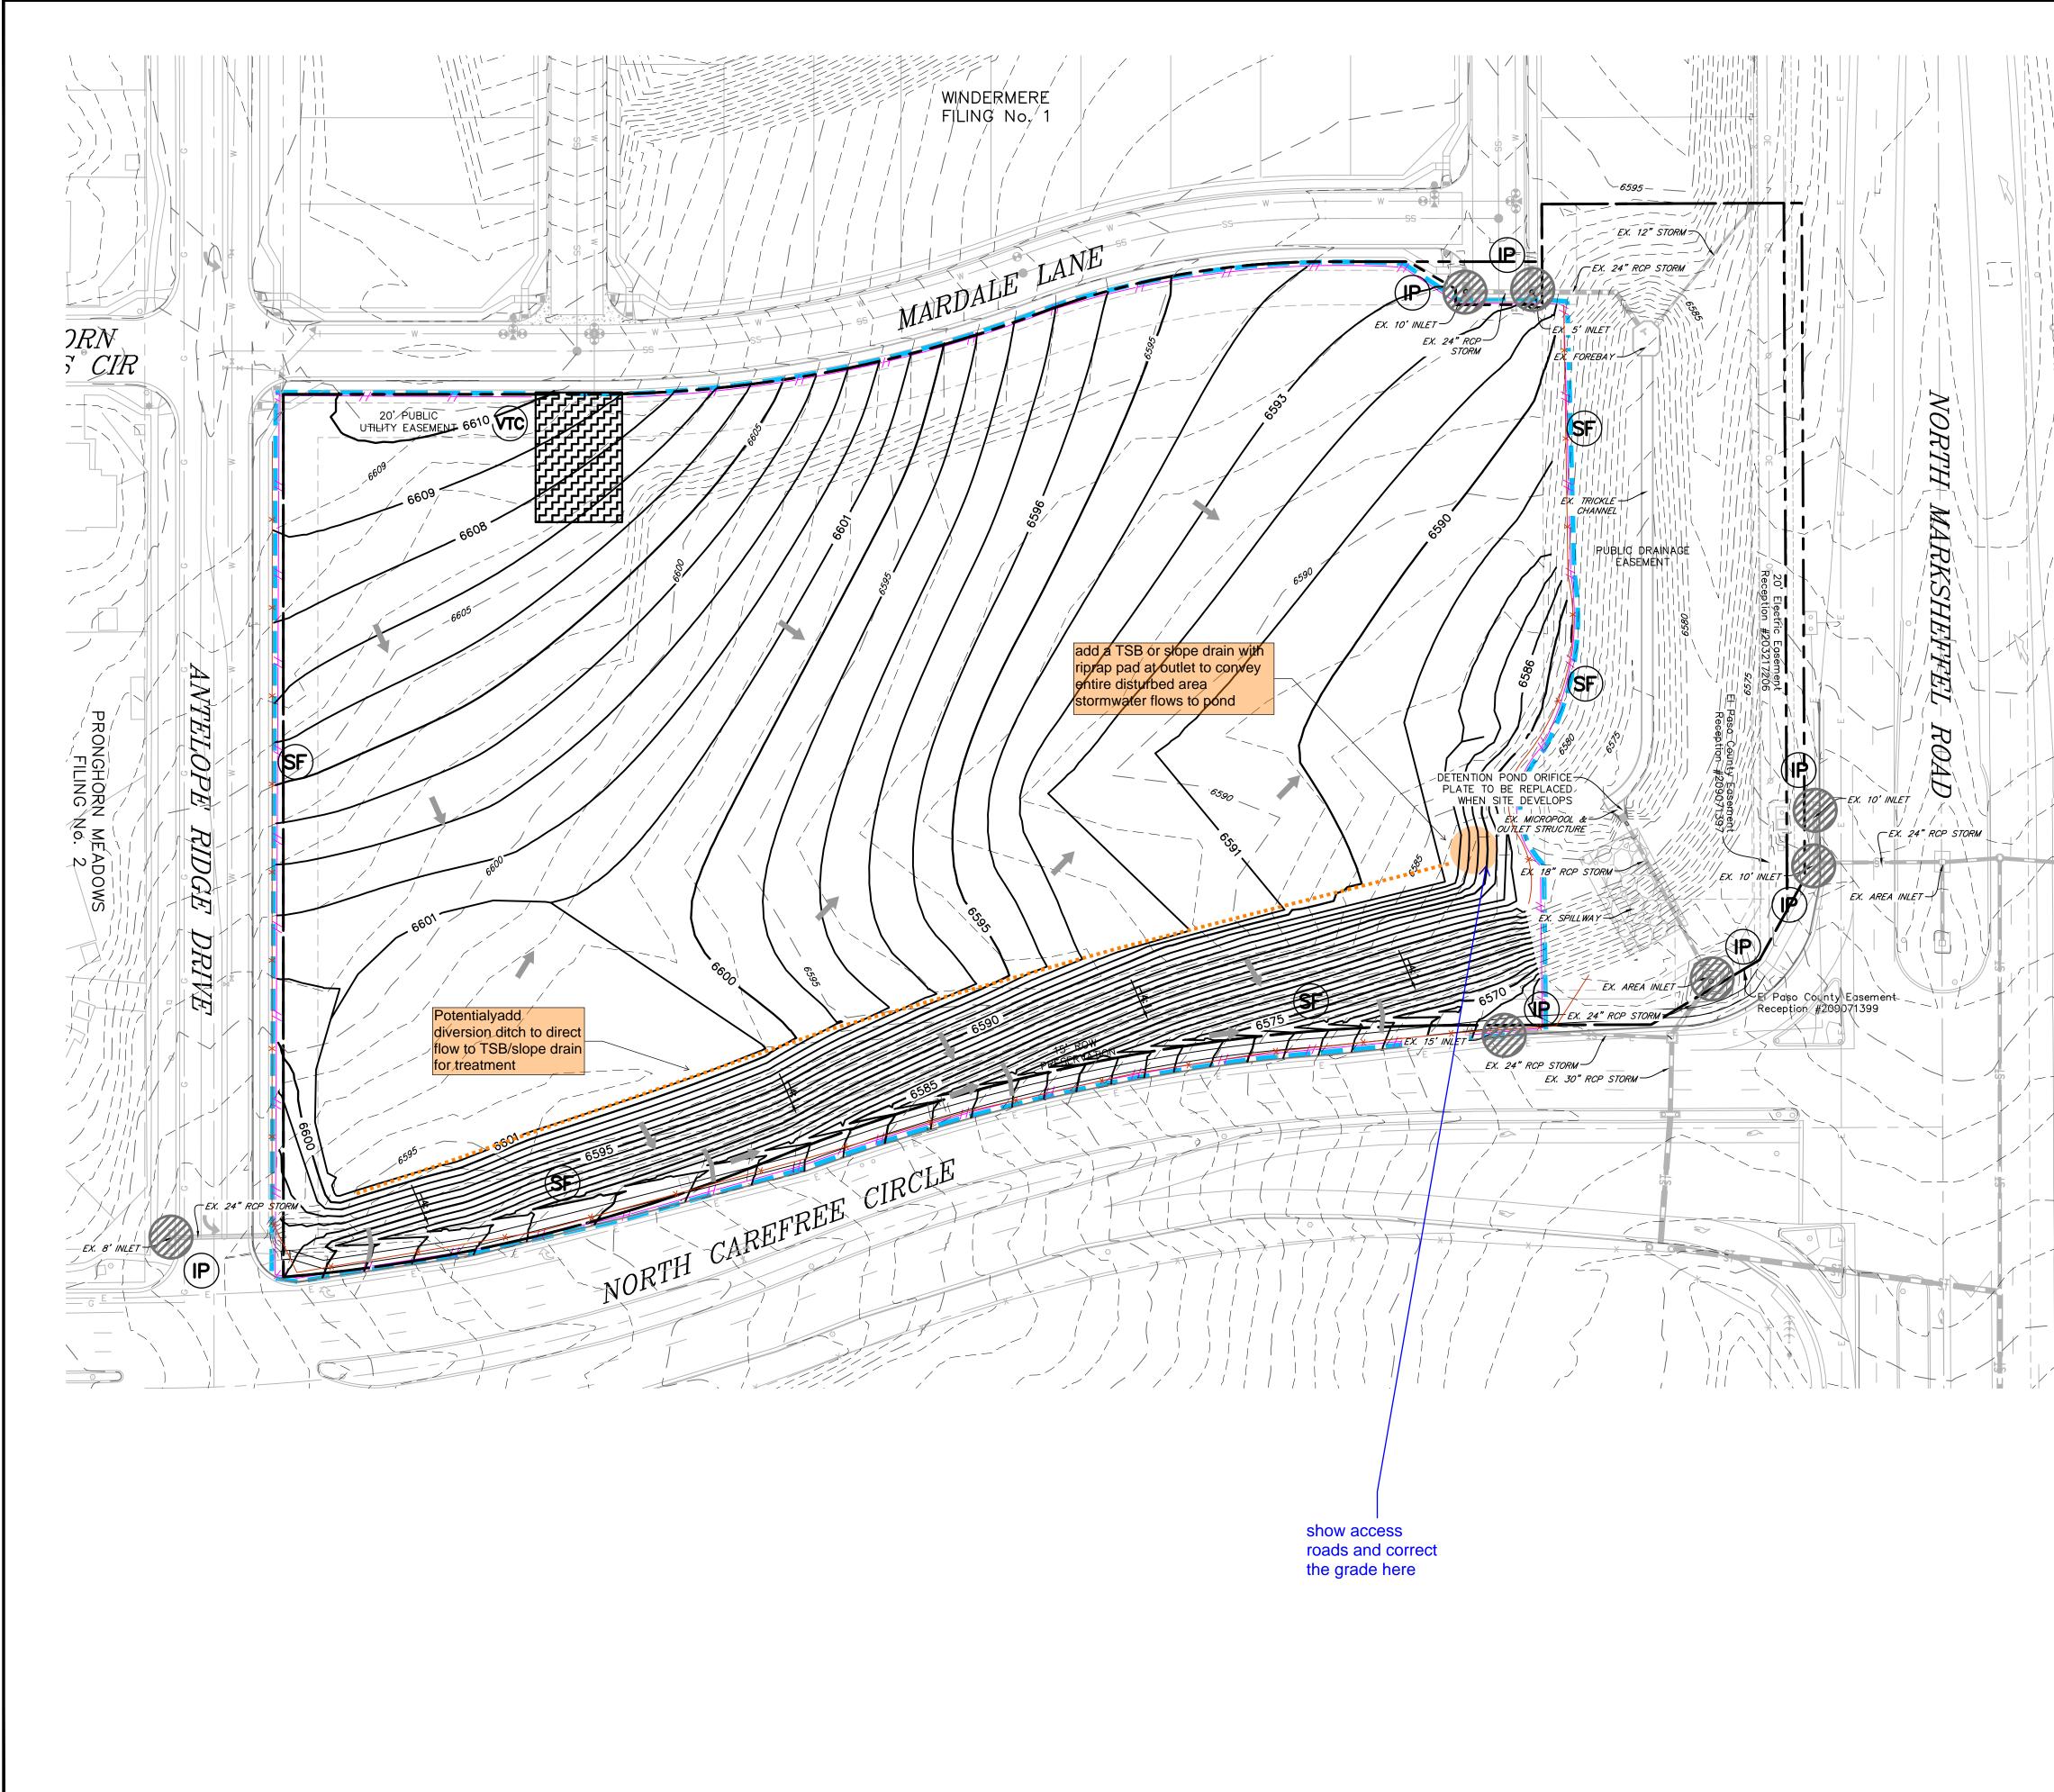


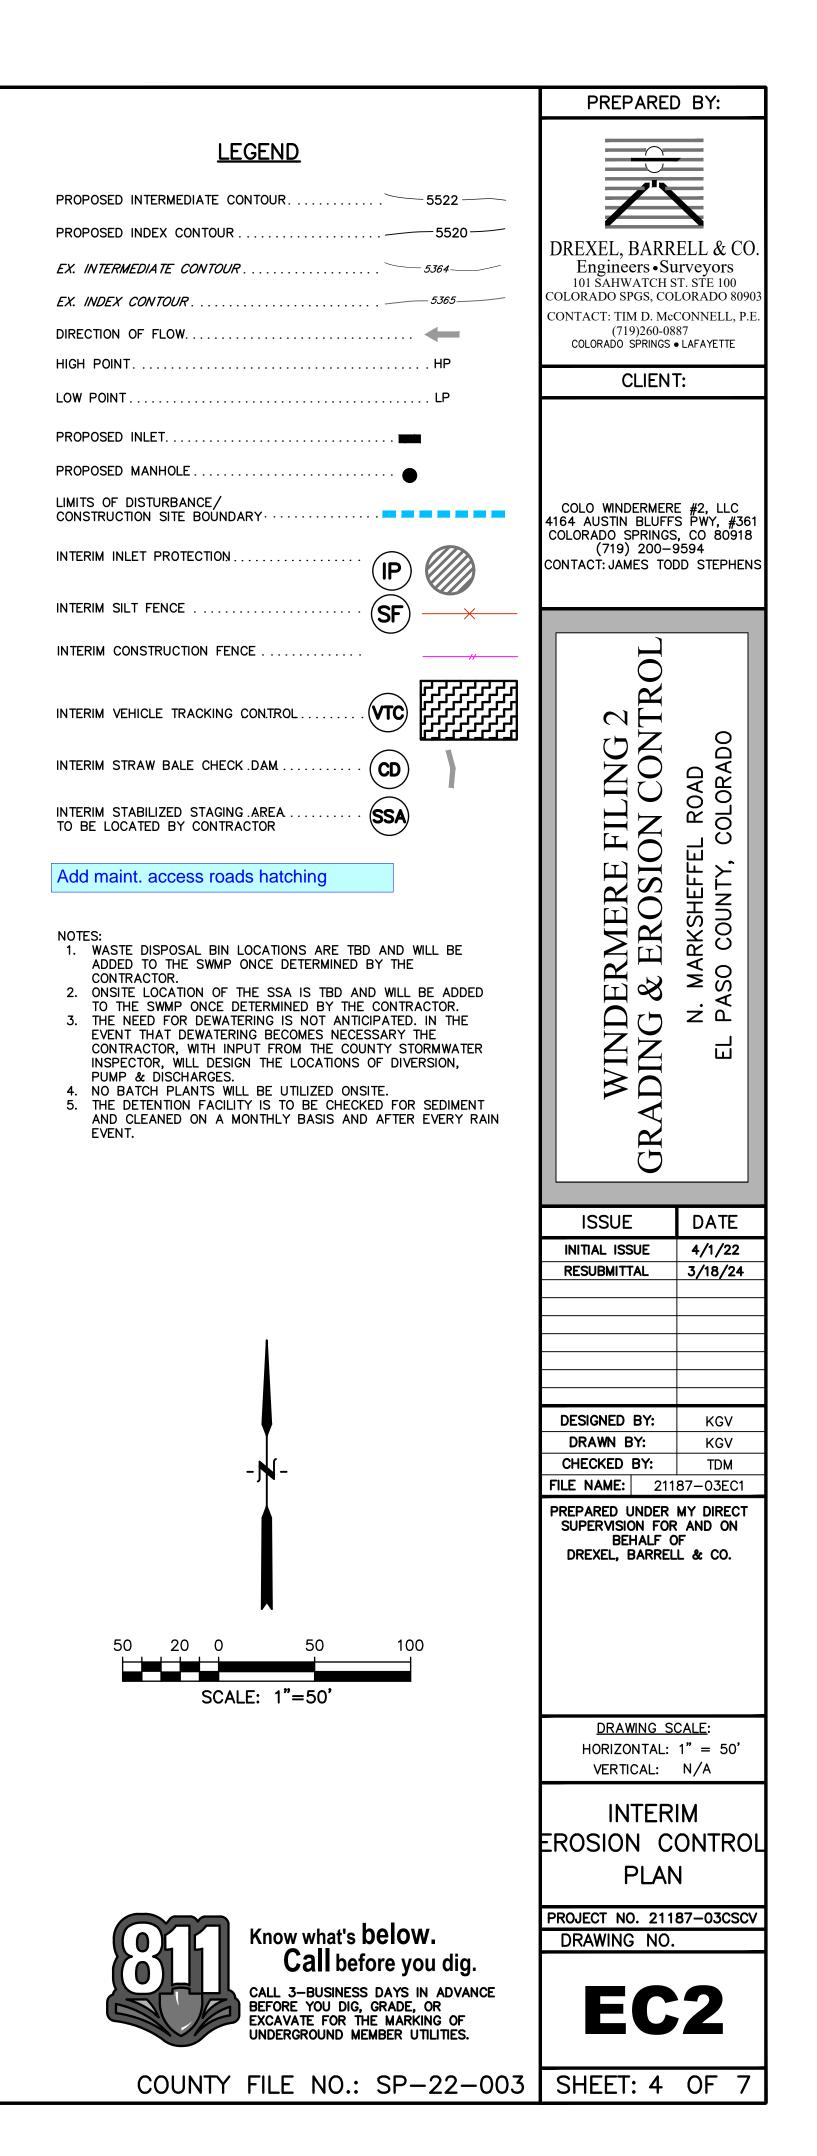


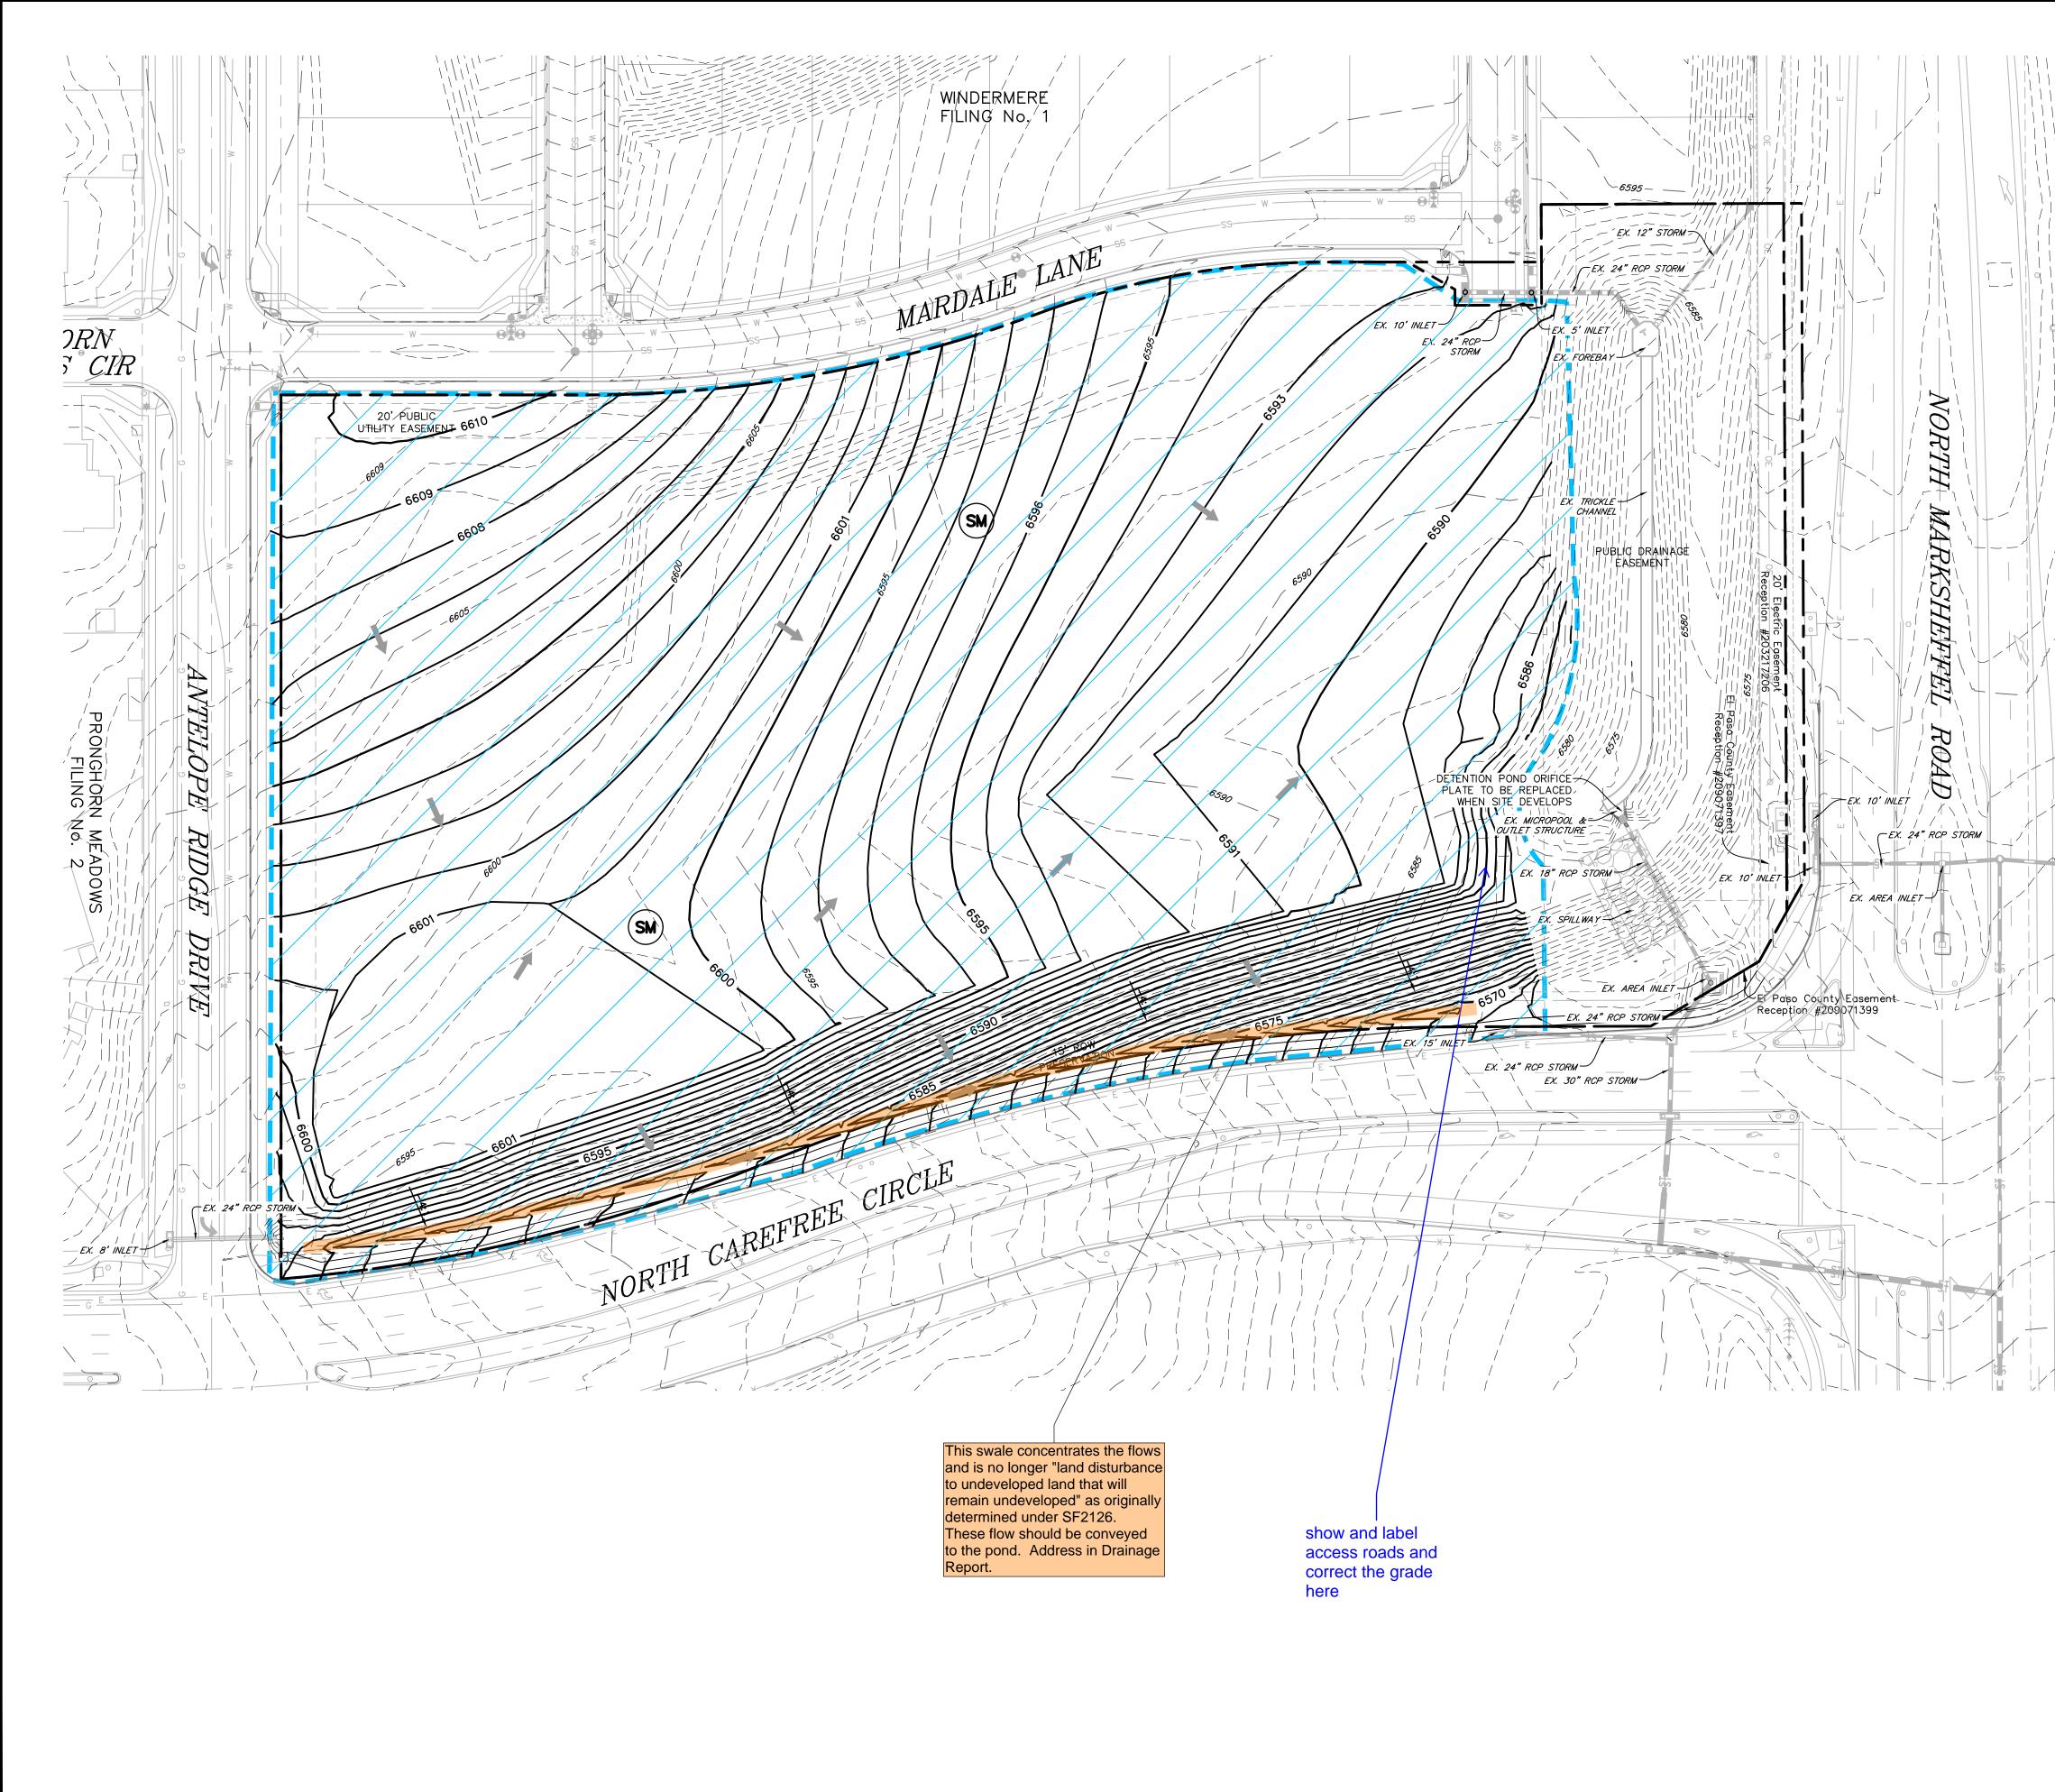


| | PREPARED BY: |
|--|--|
| LEGEND | |
| PROPOSED INTERMEDIATE CONTOUR | |
| PROPOSED INDEX CONTOUR | DREXEL, BARRELL & CO. |
| EX. INTERMEDIATE CONTOUR | Engineers • Surveyors 101 SAHWATCH ST. STE 100 COLORADO SPGS, COLORADO 80902 |
| EX. INDEX CONTOUR | CONTACT: TIM D. McCONNELL, P.E (719)260-0887 |
| DIRECTION OF FLOW | COLORADO SPRINGS • LAFAYETTE |
| LOW POINT | CLIENT: |
| PROPOSED INLET. | |
| | |
| LIMITS OF DISTURBANCE/ CONSTRUCTION SITE BOUNDARY | COLO WINDERMERE #2, LLC |
| FINAL SEEDING/MULCHING. | 4164 AUSTIN BLUFFS PWY, #361 COLORADO SPRINGS, CO 80918 (719) 200-9594 |
| Add maint. access roads hatching | CONTACT: JAMES TODD STEPHENS |
| NOTES: | |
| WASTE DISPOSAL BIN LOCATIONS ARE TBD AND WILL BE ADDED TO THE SWMP ONCE DETERMINED BY THE CONTRACTOR. | DL D |
| ONSITE LOCATION OF THE SSA IS TBD AND WILL BE ADDED TO THE SWMP ONCE DETERMINED BY THE CONTRACTOR. | L C C |
| 3. THE NEED FOR DEWATERING IS NOT ANTICIPATED. IN THE EVENT THAT DEWATERING BECOMES NECESSARY THE CONTRACTOR, WITH INPUT FROM THE COUNTY STORMWATER | |
| INSPECTOR, WILL DESIGN THE LOCATIONS OF DIVERSION, PUMP & DISCHARGES. | |
| NO BATCH PLANTS WILL BE UTILIZED ONSITE. THE DETENTION FACILITY IS TO BE CHECKED FOR SEDIMENT AND CLEANED ON A MONTHLY BASIS AND AFTER EVERY RAIN | FILING N CON - ROAD COLORADO |
| EVENT. | IL R COL |
| | SIC SIC |
| | MERE ROSI RKSHEFF |
| | ERMERE F & EROSIOI Marksheffel so county, c |
| | |
| | DH CD Z A |
| | |
| | |
| | SA 1 |
| | |
| | U U |
| | |
| | ISSUE DATE |
| | ISSUE DATE INITIAL ISSUE 4/1/22 RESUBMITTAL 3/18/24 |
| | INITIAL ISSUE 4/1/22 |
| | INITIAL ISSUE 4/1/22 |
| | INITIAL ISSUE 4/1/22 |
| | INITIAL ISSUE 4/1/22 RESUBMITTAL 3/18/24 |
| | INITIAL ISSUE 4/1/22 RESUBMITTAL 3/18/24 |
| -) - | INITIAL ISSUE 4/1/22 RESUBMITTAL 3/18/24 Image: strain of the strain |
| -) - | INITIAL ISSUE 4/1/22 RESUBMITTAL 3/18/24 |
| - N - | INITIAL ISSUE 4/1/22 RESUBMITTAL 3/18/24 |
| | INITIAL ISSUE 4/1/22 RESUBMITTAL 3/18/24 |
| | INITIAL ISSUE 4/1/22 RESUBMITTAL 3/18/24 |
| | INITIAL ISSUE 4/1/22 RESUBMITTAL 3/18/24 |
| The second secon | INITIAL ISSUE 4/1/22 RESUBMITTAL 3/18/24 |
| | INITIAL ISSUE 4/1/22 RESUBMITTAL 3/18/24 DESIGNED BY: 3/18/24 DESIGNED BY: 4/1/22 3/18/24 DESIGNED BY: 4/1/22 3/18/24 DESIGNED BY: 4/1/22 3/18/24 DESIGNED BY: 4/1/22 SUBMITTAL 3/18/24 DESIGNED BY: 4/1/22 SUBMITTAL 3/18/24 DESIGNED BY: 4/1/22 SUBMITTAL 3/18/24 SUBMITTAL 3/18/24 SUBMIT |
| | INITIAL ISSUE 4/1/22 RESUBMITTAL 3/18/24 BESIGNED BY: 3/18/24 DESIGNED BY: 4/1/22 3/18/24 DESIGNED BY: 4/1/22 3/18/24 DESIGNED BY: 4/1/22 SUBMITTAL 3/18/24 DESIGNED BY: 4/1/22 SUBMITTAL 3/18/24 HORIZONTAL: 1" = 50' VERTICAL: N/A |
| | INITIAL ISSUE 4/1/22 RESUBMITTAL 3/18/24 BESIGNED BY: 3/18/24 DESIGNED BY: 4/1/22 AUXING DESIGNED BY: 4/1/22 AUXING AUX |
| | INITIAL ISSUE 4/1/22 RESUBMITTAL 3/18/24 BESIGNED BY: 3/18/24 DESIGNED BY: 4/1/22 3/18/24 DESIGNED BY: 4/1/22 3/18/24 DESIGNED BY: 4/1/22 SUBMITTAL 3/18/24 DESIGNED BY: 4/1/22 SUBMITTAL 3/18/24 HORIZONTAL: 1" = 50' VERTICAL: N/A |
| SCALE: 1"=50' | INITIAL ISSUE 4/1/22 RESUBMITTAL 3/18/24 A 18/24 A 18/24 A 19/24 A 19/ |
| SCALE: 1"=50' | INITIAL ISSUE 4/1/22 RESUBMITTAL 3/18/24 BESIGNED BY: 3/18/24 DESIGNED BY: KGV DRAWN BY: KGV CHECKED BY: TDM FILE NAME: 21187–03EC1 PREPARED UNDER MY DIRECT SUPERVISION FOR AND ON BEHALF OF DREXEL, BARRELL & CO. DRAWING SCALE: HORIZONTAL: 1" = 50' VERTICAL: N/A FINAL FINAL FINAL FINAL FINAL FINAL FINAL FINAL PLAN |
| SCALE: 1"=50' Know what's below. Call before you dig. CALL 3-BUSINESS DAYS IN ADVANCE | INITIAL ISSUE 4/1/22 RESUBMITTAL 3/18/24 DESIGNED BY: 3/18/24 DESIGNED BY: KGV DRAWN BY: KGV CHECKED BY: TDM FILE NAME: 21187–03EC1 PREPARED UNDER MY DIRECT SUPERVISION FOR AND ON BEHALF OF DREXEL, BARRELL & CO. DREXEL, BARRELL & CO. DREXEL, BARRELL & CO. FINAL FINAL FINAL FINAL EROSION CONTROL PLAN PROJECT NO. 21187–03CSCV DRAWING NO. |
| SCALE: 1"=50' Know what's below. Call before you dig. Call before you dig. | INITIAL ISSUE 4/1/22 RESUBMITTAL 3/18/24 RESUBMITTAL 3/18/24 DESIGNED BY: 3/18/24 DESIGNED BY: CONTROL DESIGNED BY: KGV DRAWN BY: KGV CHECKED BY: TDM FILE NAME: 21187–03EC1 PREPARED UNDER MY DIRECT SUPERVISION FOR AND ON BEHALF OF DREXEL, BARRELL & CO. DREXEL, BARRELL & CO. DREXEL, BARRELL & CO. DREXEL, BARRELL & CO. FINAL FINAL FINAL FINAL FINAL PROJECT NO. 21187–03CSCV |
| SCALE: 1"=50' Know what's below. Call before you dig. CALL 3-BUSINESS DAYS IN ADVANCE | INITIAL ISSUE 4/1/22 RESUBMITTAL 3/18/24 DESIGNED BY: 3/18/24 DESIGNED BY: KGV DRAWN BY: KGV CHECKED BY: TDM FILE NAME: 21187–03EC1 PREPARED UNDER MY DIRECT SUPERVISION FOR AND ON BEHALF OF DREXEL, BARRELL & CO. DREXEL, BARRELL & CO. DREXEL, BARRELL & CO. FINAL FINAL FINAL FINAL EROSION CONTROL PLAN PROJECT NO. 21187–03CSCV DRAWING NO. |

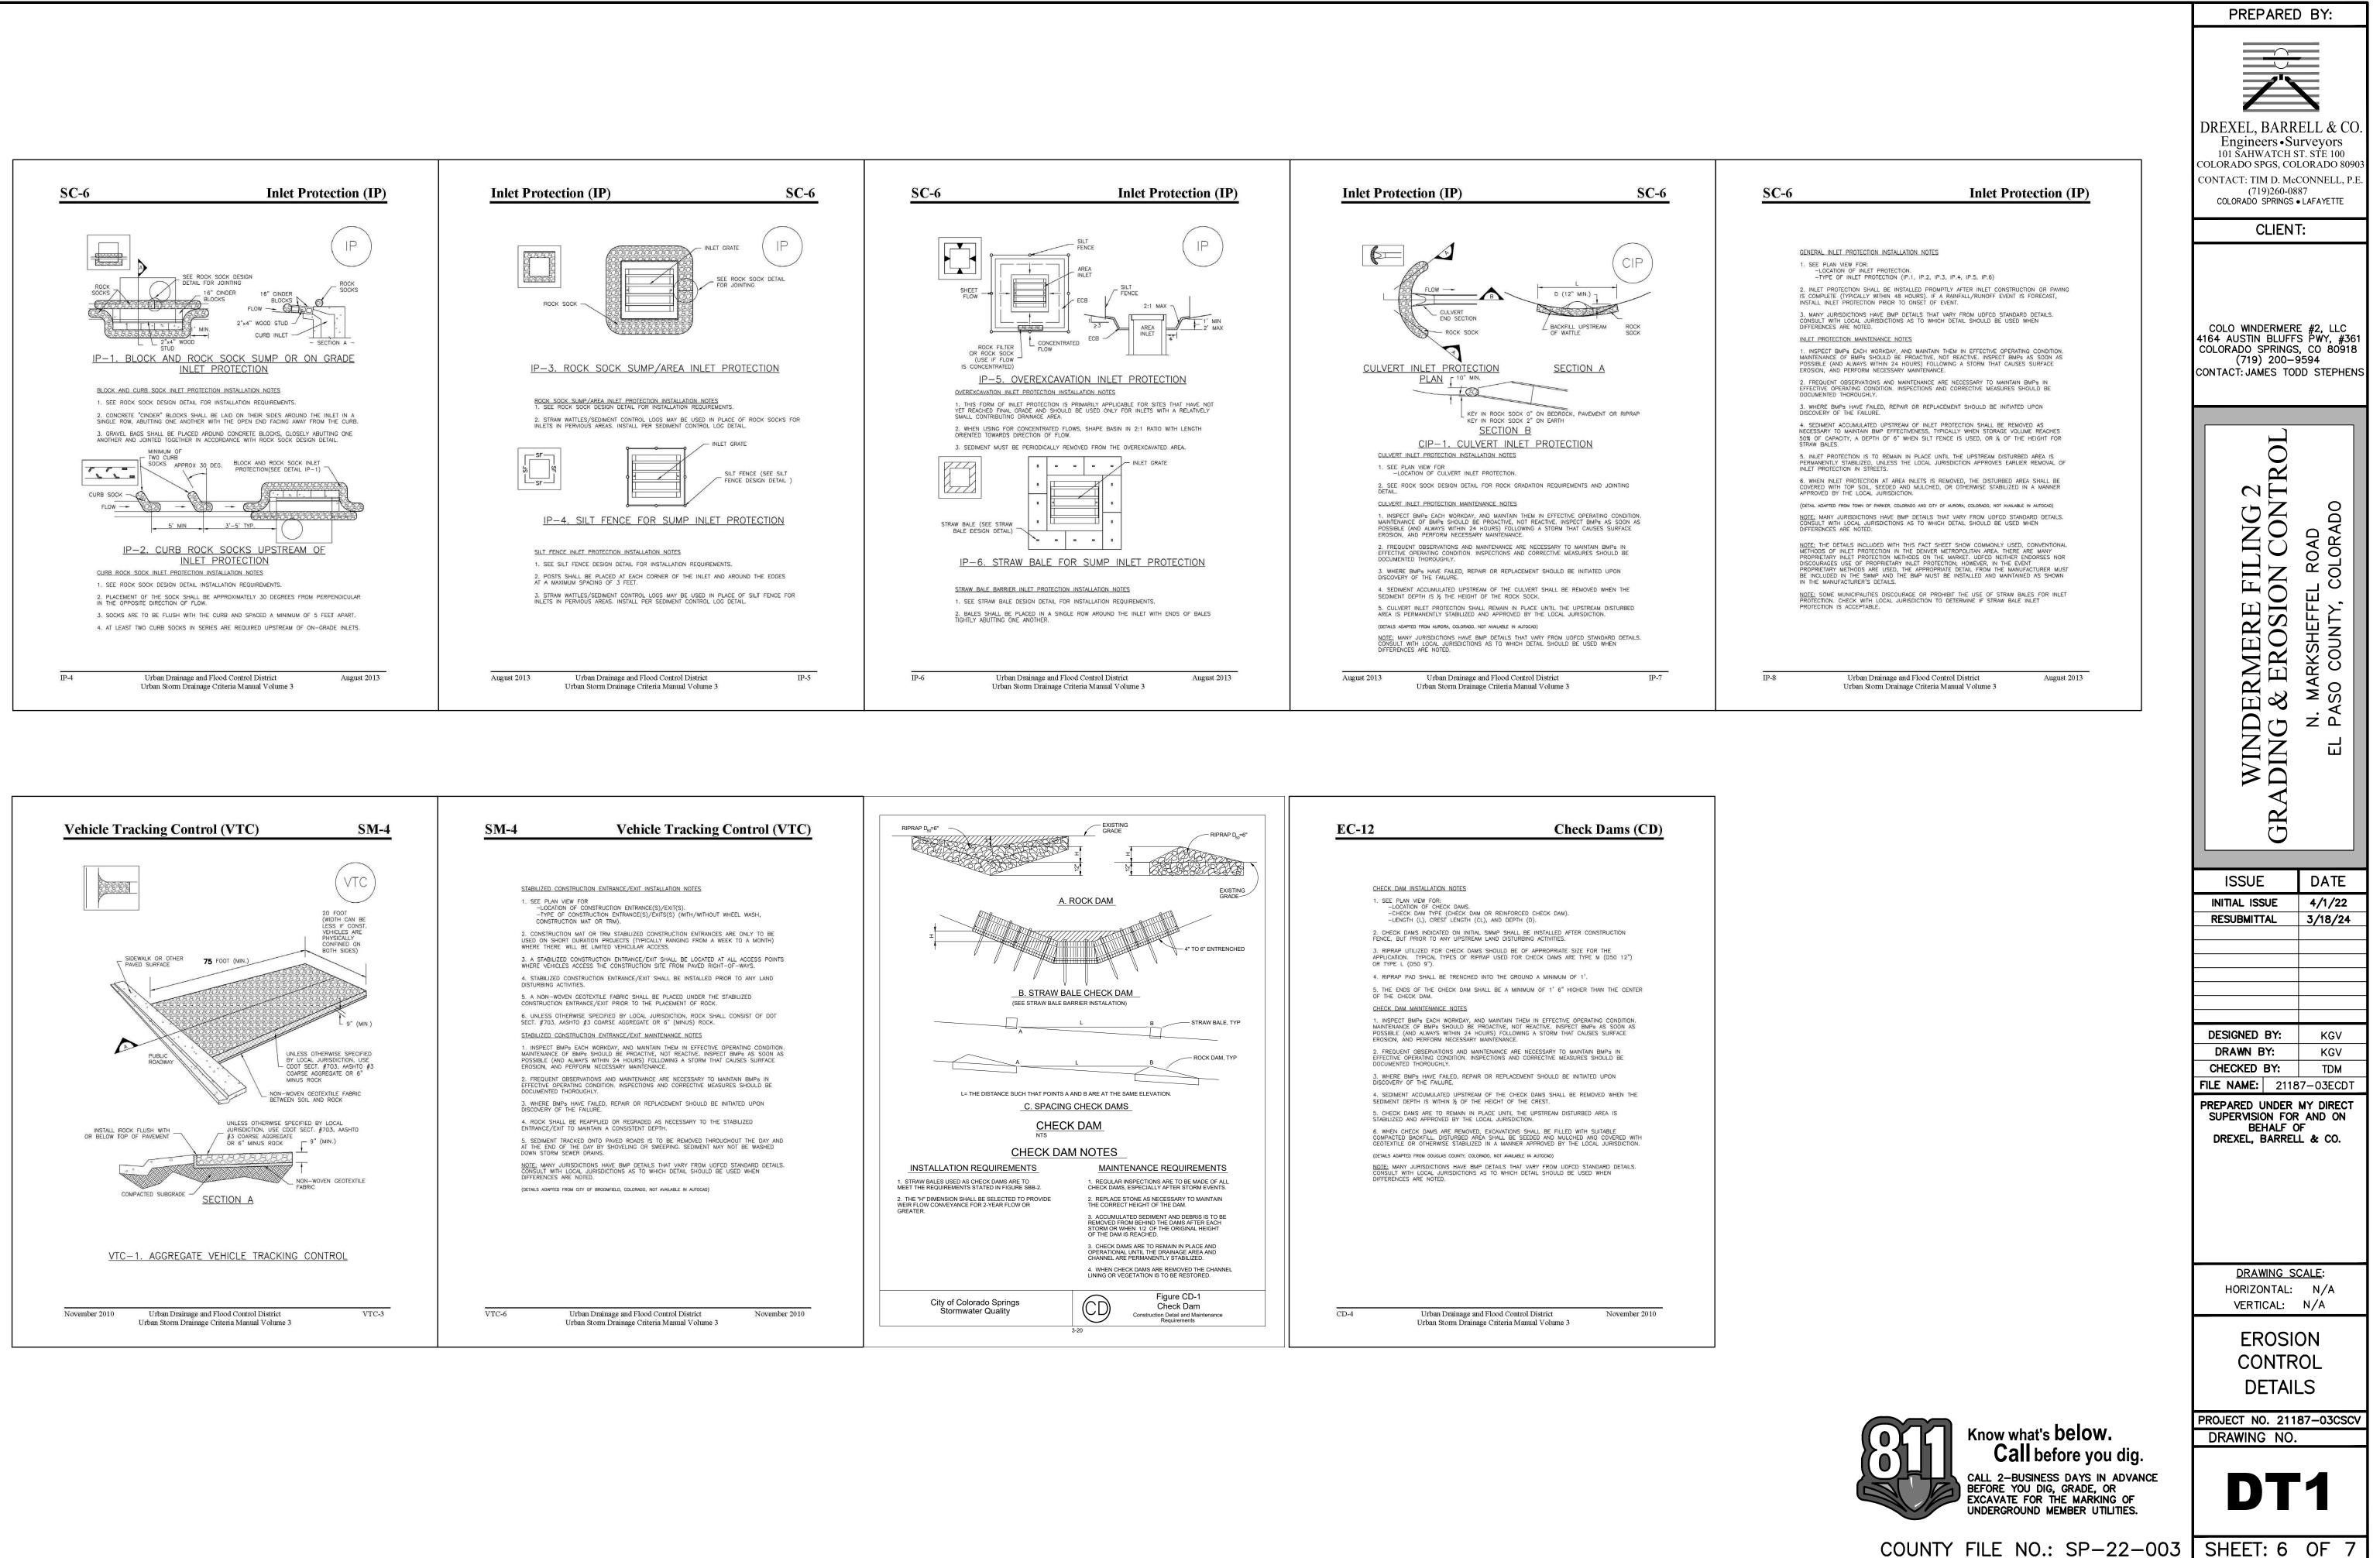

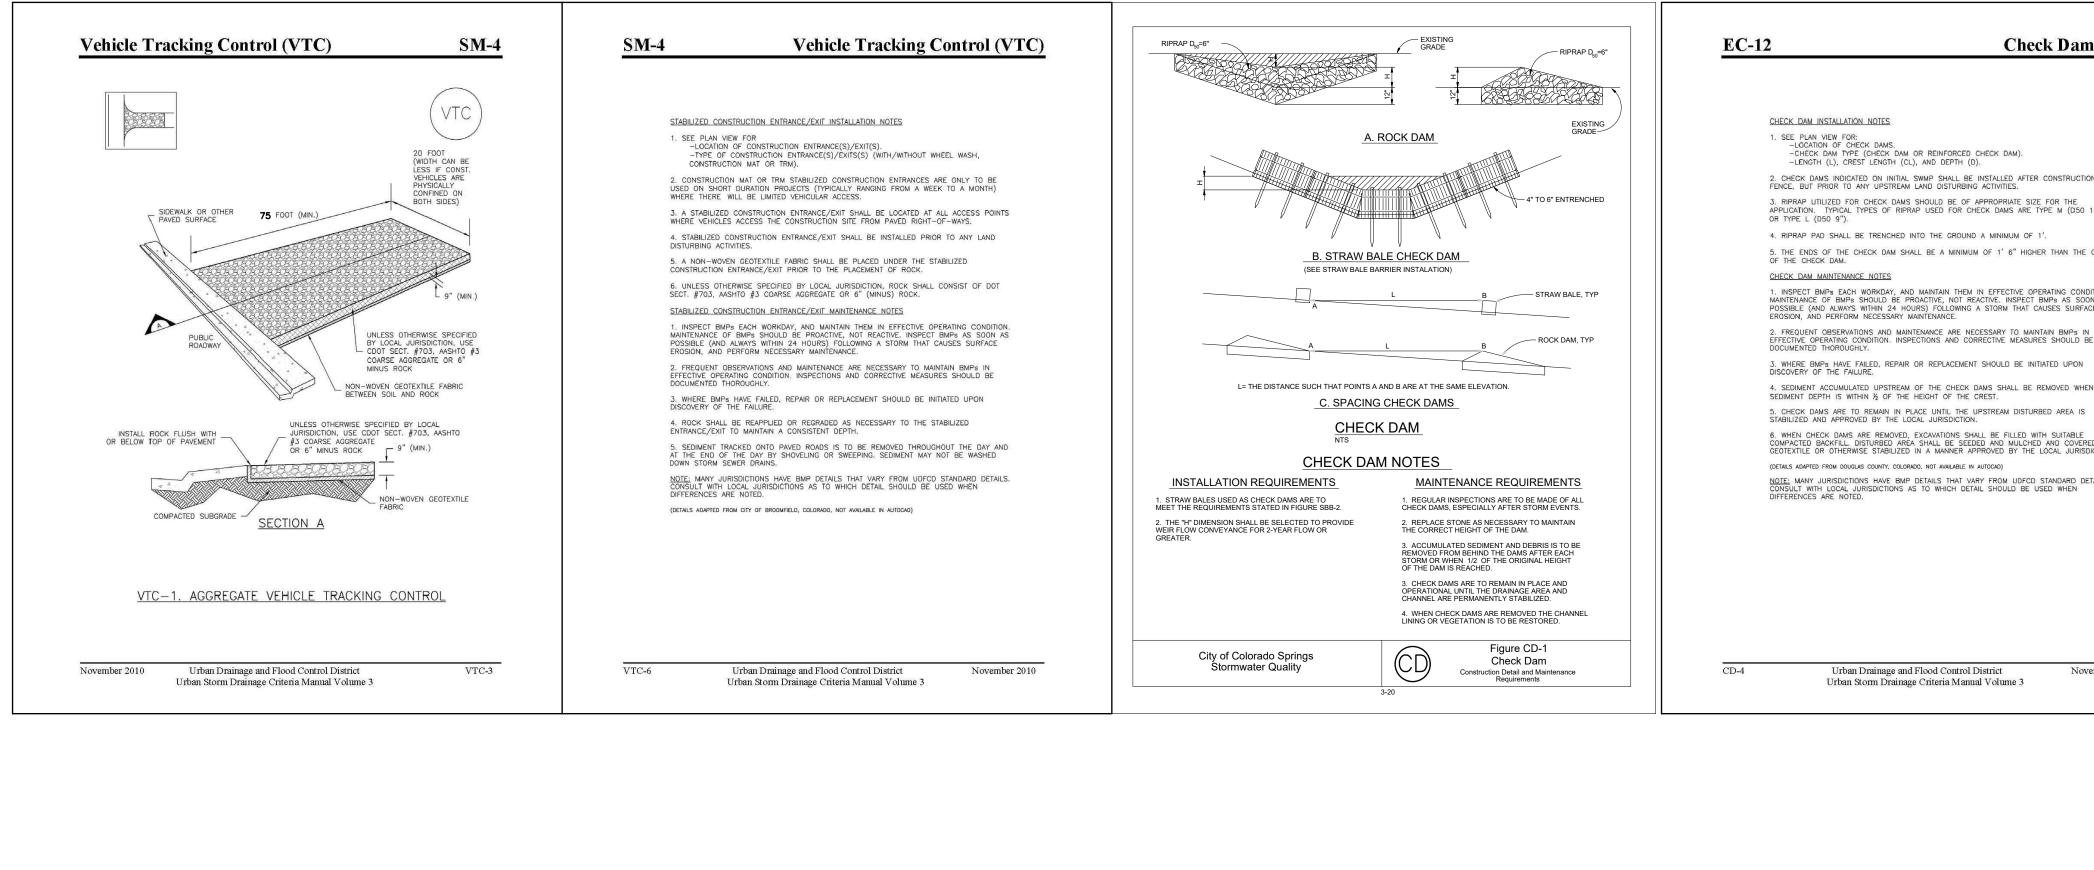

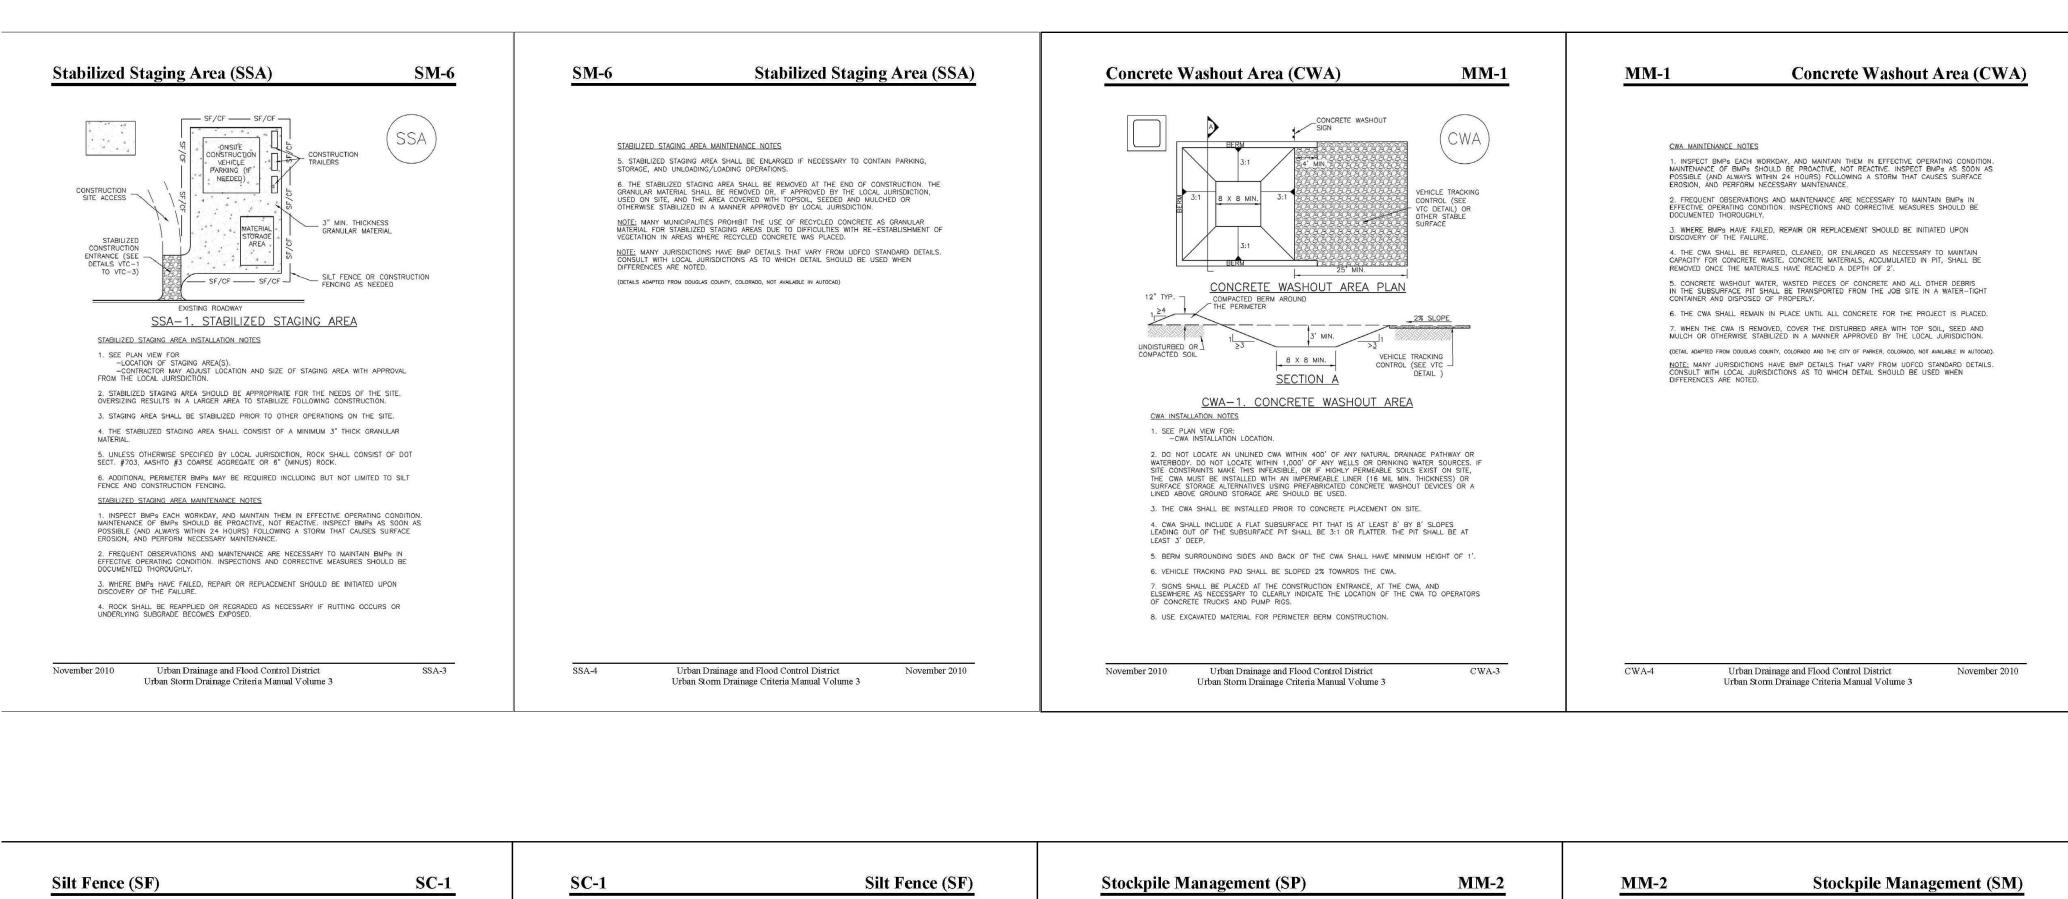


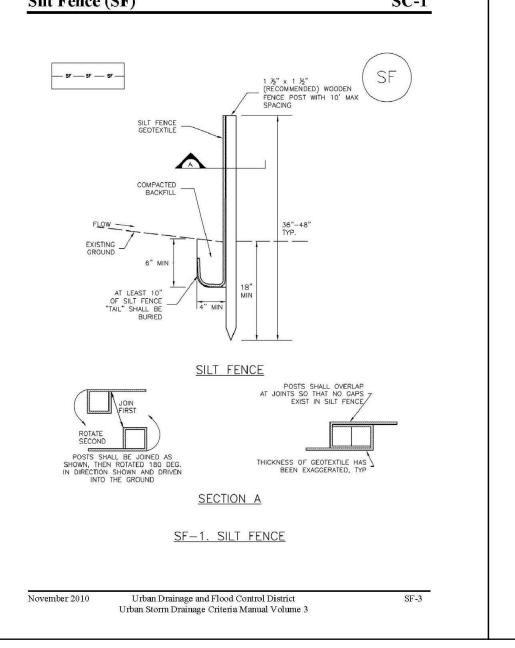

| | Silt Fe |
|-----------|---|
| | |
| SIL | T FENCE INSTALLATION NOTES |
| POI | SILT FENCE MUST BE PLACED AWAY FROM THE TOE OF THE SLOPE TO ALLOW F NDING. SILT FENCE AT THE TOE OF A SLOPE SHOULD BE INSTALLED IN A FLAT LEAST SEVERAL FEET ($2-5$ FT) FROM THE TOE OF THE SLOPE TO ALLOW ROOM NDING AND DEPOSITION. |
| FEI | A UNIFORM 6" X 4" ANCHOR TRENCH SHALL BE EXCAVATED USING TRENCHER (CCE INSTALLATION DEVICE. NO ROAD GRADERS, BACKHOES, OR SIMILAR EQUIPMEN USED. |
| CO | COMPACT ANCHOR TRENCH BY HAND WITH A "JUMPING JACK" OR BY WHEEL RO MPACTION SHALL BE SUCH THAT SILT FENCE RESISTS BEING PULLED OUT OF AN ENCH BY HAND. |
| | SILT FENCE SHALL BE PULLED TIGHT AS IT IS ANCHORED TO THE STAKES. THEF NO NOTICEABLE SAG BETWEEN STAKES AFTER IT HAS BEEN ANCHORED TO THE |
| OR | SILT FENCE FABRIC SHALL BE ANCHORED TO THE STAKES USING 1" HEAVY DUT NAILS WITH 1" HEADS. STAPLES AND NAILS SHOULD BE PLACED 3" ALONG THE WN THE STAKE. |
| 6. TUR | AT THE END OF A RUN OF SILT FENCE ALONG A CONTOUR, THE SILT FENCE SI RNED PERPENDICULAR TO THE CONTOUR TO CREATE A "J-HOOK." THE "J-HOO ENDING PERPENDICULAR TO THE CONTOUR SHOULD BE OF SUFFICIENT LENGTH 10FF FROM FLOWING ARQUND THE END OF THE SILT FENCE (TYPICALLY 10' - 2 |
| 7. | SILT FENCE SHALL BE INSTALLED PRIOR TO ANY LAND DISTURBING ACTIVITIES. |
| SIL | T FENCE MAINTENANCE NOTES |
| MA PO | INSPECT BMPs EACH WORKDAY, AND MAINTAIN THEM IN EFFECTIVE OPERATING C INTENANCE OF BMPs SHOULD BE PROACTIVE, NOT REACTIVE. INSPECT BMPs AS I SIBLE (AND ALWAYS WITHIN 24 HOURS) FOLLOWING A STORM THAT CAUSES SUJ JSION, AND PERFORM NECESSARY MAINTENANCE. |
| EFF | FREQUENT OBSERVATIONS AND MAINTENANCE ARE NECESSARY TO MAINTAIN BMPs FECTIVE OPERATING CONDITION. INSPECTIONS AND CORRECTIVE MEASURES SHOULD CUMENTED THOROUGHLY. |
| | WHERE BMPS HAVE FAILED, REPAIR OR REPLACEMENT SHOULD BE INITIATED UPC COVERY OF THE FAILURE. |
| TO | SEDIMENT ACCUMULATED UPSTREAM OF THE SILT FENCE SHALL BE REMOVED AS MAINTAIN THE FUNCTIONALITY OF THE BMP, TYPICALLY WHEN DEPTH OF ACCUMU DIMENTS IS APPROXIMATELY 6". |
| | REPAIR OR REPLACE SILT FENCE WHEN THERE ARE SIGNS OF WEAR, SUCH AS RING, OR COLLAPSE. |
| AN | SILT FENCE IS TO REMAIN IN PLACE UNTIL THE UPSTREAM DISTURBED AREA IS D APPROVED BY THE LOCAL JURISDICTION, OR IS REPLACED BY AN EQUIVALENT DIMENT CONTROL BMP. |
| 7. SEI | WHEN SILT FENCE IS REMOVED, ALL DISTURBED AREAS SHALL BE COVERED WITH EDED AND MULCHED OR OTHERWISE STABILIZED AS APPROVED BY LOCAL JURISDI |
| | TALL ADAPTED FROM TOWN OF PARKER, COLORADO AND CITY OF AURORA, NOT AVAILABLE IN AUTOCAD) |
| CO | TE: MANY JURISDICTIONS HAVE BMP DETAILS THAT VARY FROM UDFCD STANDARD NSULT WITH LOCAL JURISDICTIONS AS TO WHICH DETAIL SHOULD BE USED WHEN FERENCES ARE NOTED. |

Urban Drainage and Flood Control District Urban Storm Drainage Criteria Manual Volume 3

SF-4

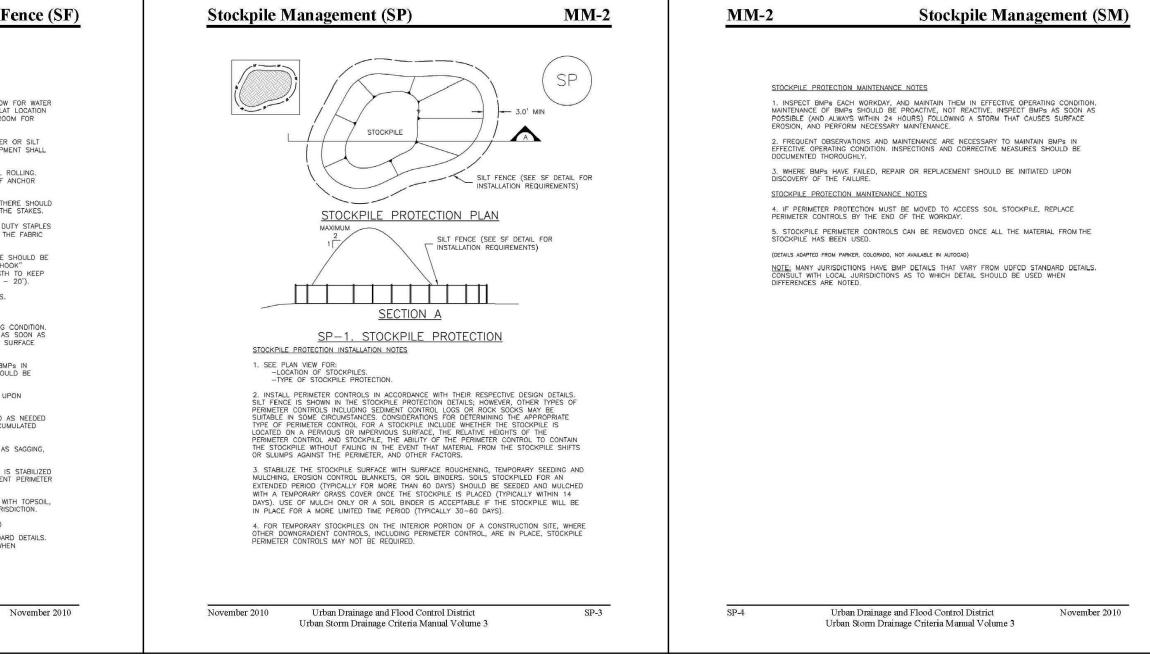

TEMPORARY SEEDING NOTES

 SOIL IS TO BE CONDITIONED FOR PLANT GROWTH BY APPLYING TOPSOIL, FERTILIZER OR LIME.
 SOIL IS TO BE TILLED IMMEDIATELY PRIOR TO APPLYING SEEDS. COMPACT SOILS ESPECIALLY NEED TO BE LOOSENED.

3. SEEDBED DEPTH IS TO BE 4 INCHES FOR SLOPES FLATTER THAN 2:1 AND 1 INCH FOR SLOPES STEEPER THAN 2:1.

4. ANNUAL GRASSES LISTED IN THE TABLE BELOW ARE TO BE USED FOR TEMPORARY SEEDING. SEED MIXES ARE NOT TO CONTAIN ANY NOXIOUS WEED SEEDS INCLUDING RUSSIAN OR CANADIAN THISTLE, KNAPWEED, PURPLE LOOSESTRIFE, EUROPEAN BINDWEED, JOHNSON GRASS, AND LEAFY SPURGE.

5. THE TABLE BELOW ALSO PROVIDES REQUIREMENTS FOR SEEDING RATES, SEEDING DATES, AND PLANTING DEPTHS FOR THE APPROVED TYPES OF ANNUAL GRASSES.

6. SEEDING IS TO BE APPLIED USING MECHANICAL TYPE DRILLS EXCEPT WHERE SLOPES ARE STEEP OR ACCESS IS LIMITED THEN HYDRAULIC SEEDING MAY BE USED.7. ALL SEEDED AREAS ARE TO BE MULCHED.

8. IF HYDRAULIC SEEDING IS USED THEN HYDRAULIC MULCHING SHALL BE DONE SEPARATELY TO AVOID SEEDS BECOMING ENCAPSULATED IN THE MULCH.

MULCHING NOTES

INSTALLATION REQUIREMENTS

1. MATERIAL USED FOR MULCH CAN BE CERTIFIED CLEAN, WEED-AND SEED-FREE LONG STEMMED FIELD OR MARSH HAY, OR STRAW OF OATS, BARLEY, WHEAT, RYE, OR TRITICALE CERTIFIED BY THE COLORADO DEPARTMENT OF AGRICULTURE WEED FREE FORAGE CERTIFICATION PROGRAM.

2. HYDRAULIC MULCHING MATERIAL SHALL CONSIST OF VIRGIN WOOD FIBER MANUFACTURED FROM CLEAN WHOLE WOOD CHIPS. WOOD CHIPS CANNOT CONTAIN ANY GROWTH OR GERMINATION INHIBITORS OR BE PRODUCED FROM RECYCLED MATERIAL.

3. MULCH IS TO BE APPLIED EVENLY AT A RATE OF 2 TONS PER ACRE.

4. MULCH IS TO BE ANCHORED EITHER BY CRIMPING (TUCKING MULCH FIBERS 4 INCHES INTO THE SOIL), USING NETTING (USED ON SMALL AREAS WITH STEEP SLOPES) OR WITH A TACKIFIER.5. HYDRAULIC MULCHING AND TACKIFIERS ARE NOT TO BE USED IN THE PRESENCE OF FREE SURFACE WATER.

MAINTENANCE REQUIREMENTS

1. REGULAR INSPECTIONS ARE TO BE MADE OF ALL MULCHED AREAS.

2. MULCH IS TO BE REPLACED IMMEDIATELY IN THOSE AREAS IT HAS BEEN REMOVED, AND IF NECESSARY THE AREA SHOULD BE RESEEDED.

SEEDING PLAN

NATIVE SEEDING MIX

SOIL PREPARATION, FERTILIZER, SEEDING, MULCHING AND MULCH TACKIFIER WILL BE REQUIRED FOR DISTURBED AREAS EXCLUDING THE RIGHT-OF-WAYS.

THE FOLLOWING TYPES AND RATES SHALL BE USED:

| COMMON NAME | SCIENTIFIC NAME | LBS PLS/ACRE |
|---|---|--|
| SAND BLUESTEM V. ELIDA WESTERN WHEATGRASS V. ARRIBA SIDEOATS GRAMA V. VAUGHN GALLETA V. VIVA (CARYOPSIS) LITTLE BLUESTEM V. PASTURA PRARIE SANDREED V. GASHEN SWITCHGRASS V. NEBR 28 BLANKETFLOWER PRARIE CONEFLOWER BLUE FLAX OATS WINTER WHEAT | ANDROPOGON HALLII PASCOPYRUM SMITHII BOUTELOUA CURTIPENDULA HILARIA JAMESII SCHIZACHYRIUM SCOPARIUM CALAMOVILFA LONGIFOLIA PANICUM VIRGATUM GAILLARDIA ARISTATA RATIBIDA COLUMINIFERA LINUM LEWISII AVENA SATIVA TRITICUM AESTIVUM | 2.0 7.0 4.0 1.0 3.0 2.0 1.0 1.0 0.5 1.0 3.0 3.0 |
| TOTAL/POUNDS/ACRE | | 28.5 |

| FERTILIZER | RATE PER ACRE |
|-------------------|---------------|
| NITROGEN | 27 |
| PHOSPHORUS (P205) | 69 |

SEEDING APPLICATION: DRILL SEED 0.25"-0.5" INTO TOPSOIL. AREA NOT ACCESSIBLE TO A DRILL SEEDER AND SLOPES STEEPER THAN 2:1 SHALL BE HAND BROADCAST AT DOUBLE THE ABOVE SEED RATE AND RAKED AT 1/4 TO 1/2 INTO THE TOPSOIL.

MULCHING APPLICATION: 1 1/2 TONS CERTIFIED WEED FREE NATIVE HAY PER ACRE MECHANICALLY CRIMED IN TOPSOIL IN COMBINATION WITH AN ORGANIC MULCH TACKIFIER.



Know what's below. Call before you dig.

CALL 2-BUSINESS DAYS IN ADVANCE BEFORE YOU DIG, GRADE, OR EXCAVATE FOR THE MARKING OF UNDERGROUND MEMBER UTILITIES.

COUNTY FILE NO.: SP-22-003 SHEET: 7 OF 7

| F | PREPARED |) BY: |
|------------------|--|---|
| C C 4 (| COLO WINDERMERE COLO WINDERMERE COLORADO SPRINGS COLORADO SPRINGS | T. STE 100 LORADO 80903 CONNELL, P.E. 87 LAFAYETTE |
| | WINDERMERE FILING 2 GRADING & EROSION CONTROL | N. MARKSHEFFEL ROAD EL PASO COUNTY, COLORADO |
| | ISSUE | DATE |
| | INITIAL ISSUE RESUBMITTAL | 4/1/22 3/18/24 |
| | | |
| E | | |
| | | |
| | DESIGNED BY: | KGV |
| | DRAWN BY: CHECKED BY: | KGV TDM |
| | DRAWN BY: | KGV TDM 7-03ECDT MY DIRECT AND ON F |
| | DRAWN BY: CHECKED BY: TILE NAME: 2118 PREPARED UNDER SUPERVISION FOR BEHALF O | KGV TDM 7-03ECDT MY DIRECT AND ON F L & CO. |
| | DRAWN BY: CHECKED BY: TILE NAME: 2118 PREPARED UNDER SUPERVISION FOR BEHALF O DREXEL, BARREL DREXEL, BARREL DREXEL, BARREL CONTAL: VERTICAL: CONTR DETAIL | KGV TDM 7-03ECDT MY DIRECT AND ON F L & CO. CALE: N/A N/A ON OL S |
| | DRAWN BY: CHECKED BY: TILE NAME: 2118 PREPARED UNDER SUPERVISION FOR BEHALF O DREXEL, BARREL DREXEL, BARREL CONTAL: VERTICAL: CONTR | KGV TDM 7-03ECDT MY DIRECT AND ON F L & CO. CALE: N/A N/A ON OL S |