EL PASO COUNTY:

COUNTY PLAN REVIEW IS PROVIDED ONLY FOR GENERAL CONFORMANCE WITH COUNTY DESIGN CRITERIA. THE COUNTY IS NOT RESPONSIBLE FOR THE ACCURACY AND ADEQUACY OF THE DESIGN

CONSTRUCTION FOR A PERIOD OF 2 YEARS FROM THE DATE SIGNED BY THE EL PASO COUNTY ENGINEER. IF CONSTRUCTION HAS NOT STARTED WITHIN THOSE 2 YEARS, THE PLANS WILL NEED TO BE RESUBMITTED FOR APPROVAL. INCLUDING PAYMENT OF REVIEW FEES AT THE PLANNING AND COMMUNITY DEVELOPMENT DIRECTORS DISCRETION.

JOSHUA PALMER. PE COUNTY ENGINEER/ECM ADMINISTRATOR

> SHEET No. DWG No. SHEET NAME TS01 TITLE SHEET **GENERAL NOTES, LEGEND & ABBREVIATIONS GN01** WASTEWATER PLAN & PROFILE 3 - 10 SANITARY SERVICE PLAN 11 - 12

DATE

OWNER/DEVELOPER COLA, LLC

555 MIDDLE CREEK PARKWAY, SUITE 380

COLORADO SPRINGS, CO 80921

CIVIL ENGINEER MATRIX DESIGN GROUP

> 2435 RESEARCH PARKWAY, SUITE 300 COLORADO SPRINGS, CO 80920

WATER & SANITARY SEWER

WIDEFIELD WATER AND SANITATION DISTRICT

8495 FONTAINE BOULEVARD COLORADO SPRINGS, CO 80925 ROBERT BANNISTER, (719) 390-7111

MOUNTAIN VIEW ELECTRIC ASSOCIATION

(719) 495-2283

GAS **COLORADO SPRINGS UTILITIES**

1521 HANCOCK EXPRESSWAY COLORADO SPRINGS, CO MARY HOAGLUND (719) 668-4083

STREET EL PASO COUNTY PUBLIC SERVICES DEPARTMENT

(719) 520-6460

DRAINAGE EL PASO COUNTY PUBLIC SERVICES DEPARTMENT

(719) 520-6460

FIRE DEPARTMENT SECURITY FIRE DEPARTMENT

400 SECURITY BOULEVARD SECURITY, CO 80911

ENGINEER'S STATEMENT:

NICOLE SCHANEL, PE #52434

THIS GRADING AND EROSION CONTROL PLAN WAS PREPARED UNDER MY DIRECTION AND SUPERVISION AND IS CORRECT TO THE BEST OF MY KNOWLEDGE AND BELIEF. SAID PLAN HAS BEEN PREPARED ACCORDING TO THE CRITERIA ESTABLISHED BY THE COUNTY FOR GRADING AND EROSION CONTROL PLANS. I ACCEPT RESPONSIBILITY FOR ANY LIABILITY CAUSED BY ANY NEGLIGENT ACTS, ERRORS OR OMISSIONS ON MY PART IN PREPARING THIS REPORT.

(719) 392-7121

TRAILS AT ASPEN RIDGE - FILING NO. 4

EL PASO COUNTY, COLORADO


8" PUBLIC SANITARY MAIN PLANS

JUNE 2021



PCD FILE No. SF-21-024

THE LOCATIONS OF EXISTING ABOVE GROUND AND UNDERGROUND UTILITIES ARE SHOWN IN AN APPROXIMATE WAY ONLY. THE CONTRACTOR SHALL DETERMINE THE EXACT LOCATION OF ALL EXISTING UTILITIES BEFORE COMMENCING WORK. THE CONTRACTOR SHALL BE FULLY RESPONSIBLE FOR ANY AND ALL DAMAGES WHICH MIGHT BE CAUSED BY HIS FAILURE TO EXACTLY LOCATE AND PRESERVE ANY AND ALL ABOVE GROUND AND UNDERGROUND UTILITIES.

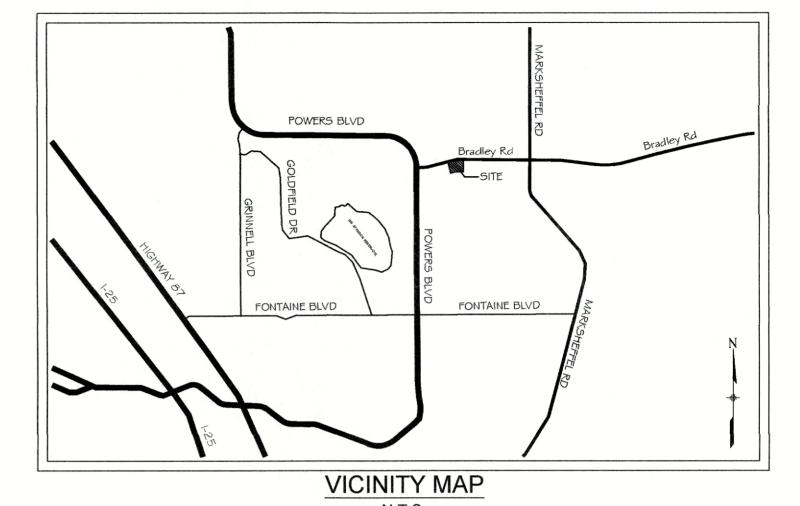

DISTRICT APPROVALS:

THE WIDEFIELD WATER AND SANITATION DISTRICT RECOGNIZES THE DESIGN ENGINEER AS HAVING RESPONSIBILITY FOR THE DESIGN AND HAS LIMITED ITS SCOPE OF REVIEW ACCORDINGLY.

> WIDEFIELD WATER AND SANITATION DISTRICT WATER DESIGN APPROVAL

PROJECT NUMBER:

IN CASE OF ERRORS OR OMISSIONS WITH THE WATER DESIGN AS SHOWN ON THIS DOCUMENT THE STANDARDS AS DEFINED IN THE "RULES AND REGULATIONS FOR INSTALLATION OF WATER MAINS AND SERVICES" SHALL RULE.

APPROVAL EXPIRES 180 DAYS FROM DESIGN APPROVAL

WATER AND SANITARY SEWER APPROVAL

ANY CHANGES OR ALTERATIONS AFFECTING THE GRADE, ALIGNMENT, ELEVATION, AND/OR DEPTH OF COVER OF ANY WATER OR SEWER MAINS OR OTHER APPURTENANCE SHOWN ON THIS DRAWING SHALL BE THE RESPONSIBILTY OF THE OWNER/DEVELOPER. THE OWNER/DEVELOPER SHALL BE RESPONSIBLE FOR ALL OPERATION DAMAGES AND DEFECTS IN INSTALLATION AND MATERIAL FOR MAINS AND SERVICES FROM THE DATE OF APPROVAL UNTIL FINAL ACCEPTANCE IS ISSUED.

SHEET No.

Call before you dig.

PRINT NAME TIM BUSCHAR

ADDRESS 555 MIDDLE CREEK PARKWAY, SUMS 500

COLORADO SPRINKS, CO 80921

SHEET KEY DRAWINGS BOULEVARD, ELEVATION - 5897.89' U.S. SURVEY FT DESCRIPTION No. DATE **REVISIONS**

COMPUTER FILE MANAGEMENT

PLOT DATE: June 22, 2021 1:40:18 PM

FILE NAME: S:\21.886.038 (Trails F6)\100 Dwg\104 Plan Sets\Construction Plans\Utility Plans\Sanitary Plan\TS01.dwg CTB FILE: Matrix(black).ctb THIS DRAWING IS CURRENT AS OF PLOT DATE AND MAY BE SUBJECT TO CHANGE.

COLORADO SPRINGS UTILITIES (FIMS) MONUMENT F206 A BERNTSEN TOP SECURITY MONUMENT SYSTEM WITH A 3.5-INCH DIAMETER ALUMINUM CAP IN A ROAD BOX, LOCATED ON THE NORTHWEST CORNER OF FONTAINE BOULEVARD AND POWERS

BEARINGS ARE BASED ON THE NORTH LINE OF THE 6TH P.M. SAID LINE BEARS S89 51 23 E FINOM TOWNSHIP 15 SOUTH, RANGE 65 WEST OF THE 6TH P.M. SAID LINE BEARS S89 51 23 E FINOM TOWNSHIP 15 SOUTH, RANGE 65 WEST OF THE 6TH P.M. SAID LINE BEARS S89 51 23 E FINOM TOWNSHIP 15 SOUTH, RANGE 65 WEST OF THE 6TH P.M. SAID LINE BEARS S89 51 23 E FINOM TOWNSHIP 15 SOUTH, RANGE 65 WEST OF THE 6TH P.M. SAID LINE BEARS S89 51 23 E FINOM TOWNSHIP 15 SOUTH, RANGE 65 WEST OF THE 6TH P.M. SAID LINE BEARS S89 51 23 E FINOM TOWNSHIP 15 SOUTH, RANGE 65 WEST OF THE 6TH P.M. SAID LINE BEARS S89 51 23 E FINOM TOWNSHIP 15 SOUTH, RANGE 65 WEST OF THE 6TH P.M. SAID LINE BEARS S89 51 23 E FINOM TOWNSHIP 15 SOUTH, RANGE 65 WEST OF THE 6TH P.M. SAID LINE BEARS S89 51 23 E FINOM TOWNSHIP 15 SOUTH, RANGE 65 WEST OF THE 6TH P.M. SAID LINE BEARS S89 51 23 E FINOM TOWNSHIP 15 SOUTH TOWNSH BEARINGS ARE BASED ON THE NORTH LINE OF THE NORTHWEST QUARTER OF SECTION 9,





TRAILS AT ASPEN RIDGE

FILING NO. 4 8" SANITARY SEWER PLANS

TITLE SHEET

FOR AND ON BEHALF OF MATRIX DESIGN GROUP, INC. DRAWN BY: PROJECT No. 21.886.038 CHECKED BY:

DRAWING No. TS01 1 OF 12

WIDEFIELD WATER AND SANITATION DISTRICT GENERAL NOTES

- 1. ALL UTILITY CONSTRUCTION TO BE CONDUCTED IN CONFORMANCE WITH THE CURRENT WIDEFIELD WATER AND SANITATION DISTRICT SPECIFICATIONS. COMPACTION REQUIREMENTS SHALL BE 95% STANDARD PROCTOR AS DETERMINED BY ASTM D698, UNLESS OTHERWISE APPROVED BY THE WIDEFIELD WATER AND SANITATION DISTRICT OR A HIGHER STANDARD IS IMPOSED BY ANOTHER AGENCY HAVING RIGHT-OF-WAY JURISDICTION.
- 2. ALL MATERIALS AND WORKMANSHIP SHALL BE SUBJECT TO INSPECTION BY THE WIDEFIELD WATER AND SANITATION DISTRICT. THE WIDEFIELD WATER AND SANITATION DISTRICT RESERVES THE RIGHT TO ACCEPT OR REJECT ANY SUCH MATERIALS AND WORKMANSHIP THAT DOES NOT CONFORM TO ITS STANDARDS AND SPECIFICATIONS.
- 3. THE DEVELOPER OR HIS ENGINEER HAS LOCATED ALL FIRE HYDRANTS AND FUTURE SERVICE STUBS. ANY REQUIRED REALIGNMENT, EITHER HORIZONTAL OR VERTICAL, SHALL BE AT THE EXPENSE OF THE DEVELOPER.
- 4. ALL DUCTILE IRON PIPE, TO INCLUDE FITTINGS, VALVES AND FIRE HYDRANTS WILL BE WRAPPED WITH POLYETHYLENE TUBING, AND ELECTRICALLY ISOLATED.
- 5. ALL DUCTILE IRON PIPE AND FITTINGS SHALL BE DOUBLE BONDED. SPECIFICATIONS FOR CATHODIC PROTECTION ON BOTH DIP MAINS AND PVC MAINS IS SPECIFIED IN THE STANDARDS AND SPECIFICATIONS.
- 6. PVC MAIN LINES SHALL BE INSTALLED WITH COATED NO. 12 TRACER WIRE.
- 7. THE CONTRACTOR IS REQUIRED TO NOTIFY THE WIDEFIELD WATER AND SANITATION DISTRICT (390-7111) A MINIMUM OF 48 HOURS AND A MAXIMUM OF 96 HOURS PRIOR TO THE START OF CONSTRUCTION. THE CONTRACTOR SHALL ALSO NOTIFY AFFECTED UTILITY COMPANIES 48 HOURS PRIOR TO CONSTRUCTION ADJACENT TO THE KNOWN UTILITY LINES.
- 8. THE LOCATION OF ALL UTILITIES AS SHOWN ON THESE DRAWINGS ARE APPROXIMATE ONLY. THE LOCATION OF ALL UTILITIES SHALL BE VERIFIED PRIOR TO CONSTRUCTION BY THE CONTRACTOR.
- 9. THE CONTRACTOR SHALL FIELD EXCAVATE AND VERIFY THE VERTICAL AND HORIZONTAL LOCATION OF ALL TIE-INS. CONTRACTOR SHALL NOTIFY THE WIDEFIELD WATER AND SANITATION DISTRICT AND THE ENGINEER OF THE FIELD VERIFIED INFORMATION PRIOR TO CONSTRUCTION.
- 10. ALL BENDS SHALL BE FIELD STAKED PRIOR TO CONSTRUCTION.

ABBREVIATIONS

BOV CPLG.

(INS.) (RED.)

(STR.)

CRA

CTRB

DEFL

GPM

GRD BRK

HYD ASSY

N,S,E,W

RCP

RSNTS

STS

TOP

ASSEMBLY

COUPLING

DEFLECT

ELEVATION

EXISTING FLANGE

MINIMUM

SLIP JOINT

STATION

TYPICAL

SANITARY SEWER

STORM SEWER

TOP OF PIPE

FIRE HYDRANT

BOTTOM OF PIPE

(INSULATING)

DUCTILE IRON PIPE

GALLONS PER MINUTE

LEFT OF CENTER LINE

POUNDS PER SQUARE INCH POLYVINYL CHLORIDE PIPE

REINFORCED CONCRETE PIPE

MJ RESTRAINT (i.e. MEGALUG)

RIGHT OF CENTER LINE

MECHANICAL JOINT NORTH,SOUTH,EAST,WEST

PROPERTY LINE

V.P.I. GRADE BREAK

(REDUCING)

(STRAIGHT)

BLOWOFF ASSEMBLY AND VALVE

CONCRETE REVERSE ANCHOR

CONCRETE THRUST REACTION BLOCK

INCLUDES FIRE HYDRANT, LATERAL, VALVE,

TIE RODS, AND REVERSE ANCHOR.

- 11. ANY WATER UTILITY MATERIAL REMOVED AND NOT REUSED SHALL BE RETURNED TO THE WIDEFIELD WATER AND SANITATION DISTRICT IF THE DISTRICT SO REQUESTS.
- 12. THE CONTRACTOR SHALL AT HIS EXPENSE SUPPORT AND PROTECT ALL UTILITY MAINS SO THAT THEY WILL FUNCTION CONTINUOUSLY DURING CONSTRUCTION. SHOULD A UTILITY MAIN FAIL AS A RESULT OF THE CONTRACTOR'S OPERATION, IT WILL BE REPLACED IMMEDIATELY BY EITHER THE CONTRACTOR OR THE WIDEFIELD WATER AND SANITATION DISTRICT AT FULL COST OF LABOR AND MATERIALS TO THE CONTRACTOR.
- 13. ANY PUMPING OR BYPASS OPERATIONS MUST BE REVIEWED AND APPROVED PRIOR TO EXECUTION BY BOTH THE WIDEFIELD WATER AND SANITATION DISTRICT AND THE ENGINEER
- 14. CONTRACTOR MUST REPLACE OR REPAIR ANY DAMAGE TO ALL SURFACE IMPROVEMENTS, INCLUDING BUT NOT LIMITED TO FENCES, CURB AND GUTTER AND/OR ASPHALT THAT MAY BE CAUSED DURING CONSTRUCTION.
- 15. ALL WATER LINES 6" AND LARGER, AND ALL SEWER LINES 8" AND LARGER, SHALL HAVE AS "AS-BUILT" PLANS PREPARED AND APPROVED PRIOR TO FINAL ACCEPTANCE BY THE WIDEFIELD WATER AND SANITATION DISTRICT.
- 16. PRIOR TO CONSTRUCTION, A PRE-CONSTRUCTION CONFERENCE IS REQUIRED A MINIMUM OF 72 HOURS IN ADVANCE OF COMMENCEMENT OF WORK. TO SET THE PRE-CONSTRUCTION CONFERENCE, CONTACT ROB BANNISTER, DISTRICT ENGINEER AT (719) 390-7111 OF THE WIDEFIELD WATER AND SANITATION DISTRICT FOR A TIME. NO PRE-CONSTRUCTION CONFERENCE TIMES WILL BE SET UNTIL 4 SETS OF SIGNED DRAWINGS ARE RECEIVED BY THE WIDEFIELD W & S DISTRICT. PRE-CONSTRUCTION DATE/INITIALS

LEGEND

VALVE (PROPOSED)

BLOWOFF (PROPOSED)

EXISTING FIRE HYDRANT

PROPOSED FIRE HYDRANT

BLOWOFF (EXISTING)

VALVE (EXISTING)

PLUG (PROPOSED)

PLUG (EXISTING)

PROPERTY LINE

EXISTING GAS MAIN

PROPOSED WATER

EXISTING STORM DRAIN

EXISTING SAN. SEWER

EXISTING MANHOLE

PROPOSED SAN. SEWER

PROPOSED STORM DRAIN

EXISTING WATER


CURB LINE

EL PASO COUNTY STANDARD CONSTRUCTION NOTES:

- 1. ALL DRAINAGE AND ROADWAY CONSTRUCTION SHALL MEET THE STANDARDS AND SPECIFICATIONS OF THE CITY OF COLORADO SPRINGS/EL PASO COUNTY DRAINAGE CRITERIA MANUAL, VOLUMES 1 AND 2, AND THE EL PASO COUNTY ENGINEERING CRITERIA MANUAL.
- CONTRACTOR SHALL BE RESPONSIBLE FOR THE NOTIFICATION AND FIELD NOTIFICATION
 OF ALL EXISTING UTILITIES, WHETHER SHOWN ON THE PLANS OR NOT, BEFORE
 BEGINNING CONSTRUCTION. LOCATION OF EXISTING UTILITIES SHALL BE VERIFIED BY
 THE CONTRACTOR PRIOR TO CONSTRUCTION. CALL 811 TO CONTACT THE UTILITY
 NOTIFICATION CENTER OF COLORADO (UNCC).
- 3. CONTRACTOR SHALL KEEP A COPY OF THESE APPROVED PLANS, THE GRADING AND EROSION CONTROL PLAN, THE STORMWATER MANAGEMENT PLAN (SWMP), THE SOILS AND GEOTECHNICAL REPORT, AND THE APPROPRIATE DESIGN AND CONSTRUCTION STANDARDS AND SPECIFICATIONS AT THE JOB SITE AT ALL TIMES, INCLUDING THE FOLLOWING:
- a. EL PASO COUNTY ENGINEERING CRITERIA MANUAL (ECM)

d. CDOT M & S STANDARDS

- b. CITY OF COLORADO SPRINGS/EL PASO COUNTY DRAINAGE CRITERIA MANUAL VOLUMES 1 AND 2
- c. COLORADO DEPARTMENT OF TRANSPORTATION (CDOT) STANDARD SPECIFICATIONS FOR ROAD AND BRIDGE CONSTRUCTION
- 4. NOTWITHSTANDING ANYTHING DEPICTED IN THESE PLANS IN WORDS OR GRAPHIC REPRESENTATION, ALL DESIGN AND CONSTRUCTION RELATED TO ROADS, STORM DRAINAGE AND EROSION CONTROL SHALL CONFORM TO THE STANDARDS AND REQUIREMENTS OF THE MOST RECENT VERSION OF THE RELEVANT ADOPTED EL PASO COUNTY STANDARDS, INCLUDING THE LAND DEVELOPMENT CODE, THE ENGINEERING CRITERIA MANUAL, THE DRAINAGE CRITERIA MANUAL, AND THE DRAINAGE CRITERIA MANUAL VOLUME 2. ANY DEVIATIONS FROM REGULATIONS AND STANDARDS MUST BE REQUESTED, AND APPROVED, IN WRITING. ANY MODIFICATIONS NECESSARY TO MEET CRITERIA AFTER-THE-FACT WILL BE ENTIRELY THE DEVELOPER'S RESPONSIBILITY TO RECTIFY.
- 5. IT IS THE DESIGN ENGINEER'S RESPONSIBILITY TO ACCURATELY SHOW EXISTING CONDITIONS, BOTH ONSITE AND OFFSITE, ON THE CONSTRUCTION PLANS. ANY MODIFICATIONS NECESSARY DUE TO CONFLICTS, OMISSIONS, OR CHANGED CONDITIONS WILL BE ENTIRELY THE DEVELOPER'S RESPONSIBILITY TO RECTIFY.
- CONTRACTOR SHALL SCHEDULE A PRE-CONSTRUCTION MEETING WITH EL PASO COUNTY PLANNING AND COMMUNITY DEVELOPMENT (PCD) - INSPECTIONS, PRIOR TO STARTING CONSTRUCTION.
- 7. IT IS THE CONTRACTOR'S RESPONSIBILITY TO UNDERSTAND THE REQUIREMENTS OF ALL JURISDICTIONAL AGENCIES AND TO OBTAIN ALL REQUIRED PERMITS, INCLUDING BUT NOT LIMITED TO EL PASO COUNTY EROSION AND STORMWATER QUALITY CONTROL PERMIT (ESQCP), REGIONAL BUILDING FLOODPLAIN DEVELOPMENT PERMIT, U.S. ARMY CORPS OF ENGINEERS-ISSUED 401 AND/OR 404 PERMITS, AND COUNTY AND STATE FUGITIVE DUST DEPMITS
- S. CONTRACTOR SHALL NOT DEVIATE FROM THE PLANS WITHOUT FIRST OBTAINING WRITTEN APPROVAL FROM THE DESIGN ENGINEER AND PCD. CONTRACTOR SHALL NOTIFY THE DESIGN ENGINEER IMMEDIATELY UPON DISCOVERY OF ANY ERRORS OR INCONSISTENCIES.
- ALL STORM DRAIN PIPE SHALL BE CLASS III RCP UNLESS OTHERWISE NOTED AND APPROVED BY PCD.
- 10. CONTRACTOR SHALL COORDINATE GEOTECHNICAL TESTING PER ECM STANDARDS. PAVEMENT DESIGN SHALL BE APPROVED BY EL PASO COUNTY PCD PRIOR TO PLACEMENT OF CURB AND GUTTER AND PAVEMENT.
- 11. ALL CONSTRUCTION TRAFFIC MUST ENTER/EXIT THE SITE AT APPROVED CONSTRUCTION ACCESS POINTS.
- 12. SIGHT VISIBILITY TRIANGLES AS IDENTIFIED IN THE PLANS SHALL BE PROVIDED AT ALL INTERSECTIONS. OBSTRUCTIONS GREATER THAN 18 INCHES ABOVE FLOWLINE ARE NOT ALLOWED WITHIN SIGHT TRIANGLES.
- 13. SIGNING AND STRIPING SHALL COMPLY WITH EL PASO COUNTY DOT AND MUTCD CRITERIA. [IF APPLICABLE, ADDITIONAL SIGNING AND STRIPING NOTES WILL BE PROVIDED.]
- 14. CONTRACTOR SHALL OBTAIN ANY PERMITS REQUIRED BY EL PASO COUNTY DOT, INCLUDING WORK WITHIN THE RIGHT-OF-WAY AND SPECIAL TRANSPORT PERMITS.
- 15. THE LIMITS OF CONSTRUCTION SHALL REMAIN WITHIN THE PROPERTY LINE UNLESS OTHERWISE NOTED. THE OWNER/DEVELOPER SHALL OBTAIN WRITTEN PERMISSION AND EASEMENTS, WHERE REQUIRED, FROM ADJOINING PROPERTY OWNER(S) PRIOR TO ANY OFF-SITE DISTURBANCE, GRADING, OR CONSTRUCTION.

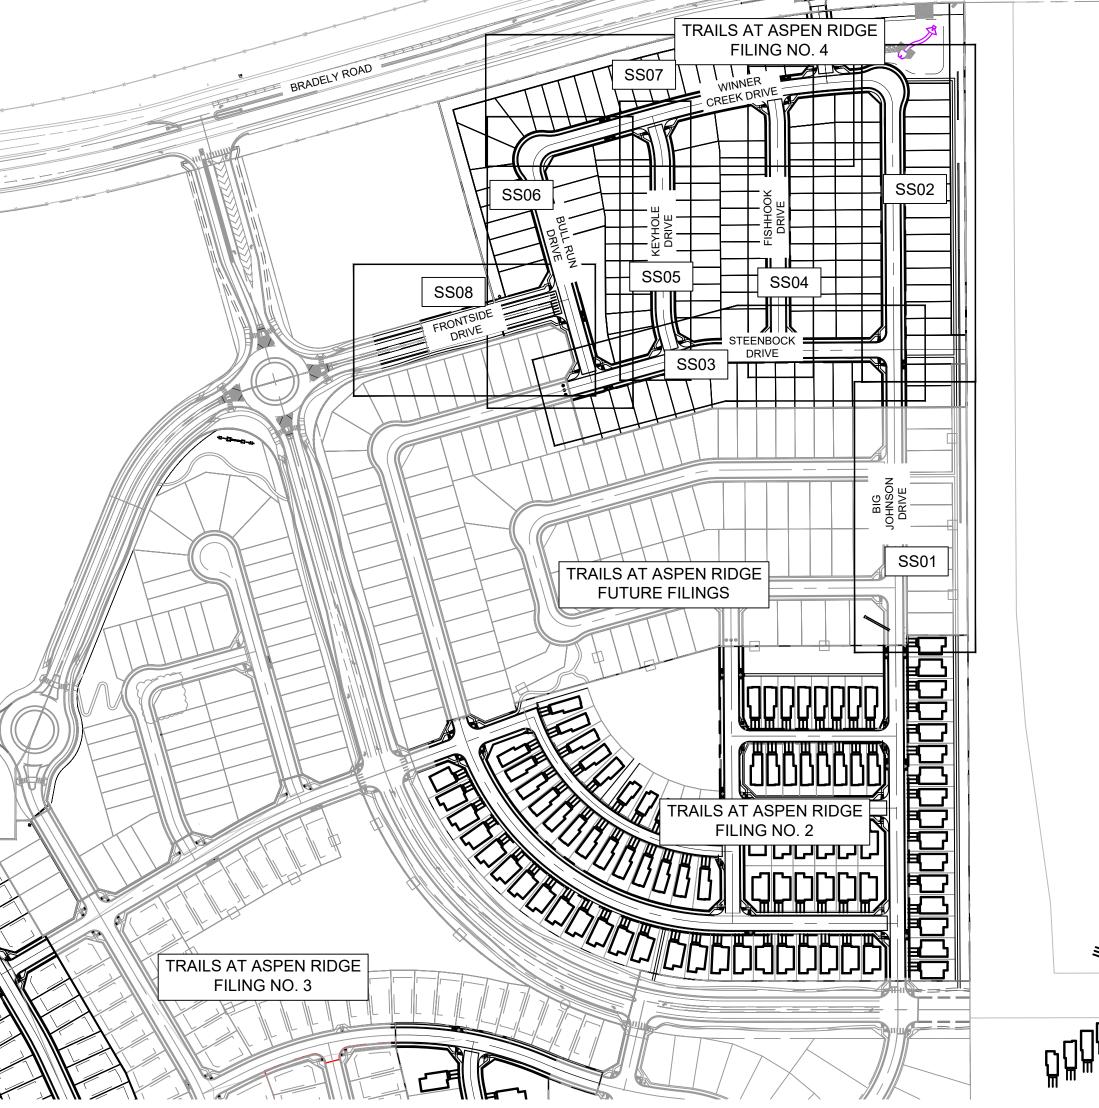





OVERALL LAYOUT

SCALE: 1" = 200'

THE WIDEFIELD WATER AND SANITATION DISTRICT RECOGNIZES THE DESIGN ENGINEER AS HAVING RESPONSIBILITY FOR THE DESIGN AND HAS LIMITED ITS SCOPE OF REVIEW ACCORDINGLY.

WIDEFIELD WATER AND SANITATION DISTRICT WATER DESIGN APPROVAL

DATE: _

DRAWN BY:

CHECKED BY:

PROJECT NUMBER:

IN CASE OF ERRORS OR OMISSIONS WITH THE WATER DESIGN AS SHOWN ON THIS DOCUMENT THE STANDARDS AS DEFINED IN THE "RULES AND REGULATIONS FOR INSTALLATION OF WATER MAINS AND SERVICES" SHALL RULE.

APPROVAL EXPIRES 180 DAYS FROM DESIGN APPROVAL

REFERENCE DRAWINGS

1 10/14/2022 SHORTENED WATER SERVICES TO PROPERTY LINE

NO. DATE

REVISIONS


COMPUTER FILE MANAGEMENT

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CTB FILE: Matrix(black).ctb
PLOT DATE: January 4, 2023 1:30:26 PM

THIS DRAWING IS CURRENT AS OF PLOT DATE AND MAY BE SUBJECT TO CHANGE.

----- E-W 8 -----

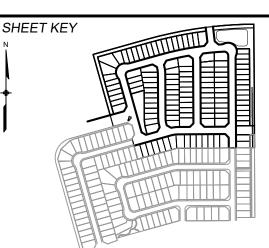

BENCHMARK

COLORADO SPRINGS UTILITIES (FIMS) MONUMENT F206
A BERNTSEN TOP SECURITY MONUMENT SYSTEM WITH A 3.5-INCH DIAMETER ALUMINUM CAP IN A ROAD BOX, LOCATED ON THE NORTHWEST CORNER OF FONTAINE BOULEVARD AND POWERS BOULEVARD.

ELEVATION - 5897.89' U.S. SURVEY FT

BASIS OF BEARING

BEARINGS ARE BASED ON THE NORTH LINE OF THE NORTHWEST QUARTER OF SECTION 9, TOWNSHIP 15 SOUTH, RANGE 65 WEST OF THE 6TH P.M. SAID LINE BEARS S89°51'23"E FROM THE NORTHWEST CORNER OF SAID SECTION 9 (2 ½" AULM. CAP PLS 17664) TO THE N ¼ CORNER OF SAID SECTION 9 (3 ½" AULM. CAP PLS 10377)



TRAILS AT ASPEN RIDGE

NMS VFRT

FILING NO. 4 8" SANITARY SEWER PLANS

GENERAL NOTES, LEGEND & ABBREVIATIONS

SF-21-02

GN01

2 OF 12

ABBREVIATIONS


DESIGNED BY: BAS SCALE DATE ISSUED: JUNE 2022 DRAWING No.


PREPARED BY:

SAID

A Trix

FOR AND ON BEHALF OF MATRIX DESIGN GROUP, INC.

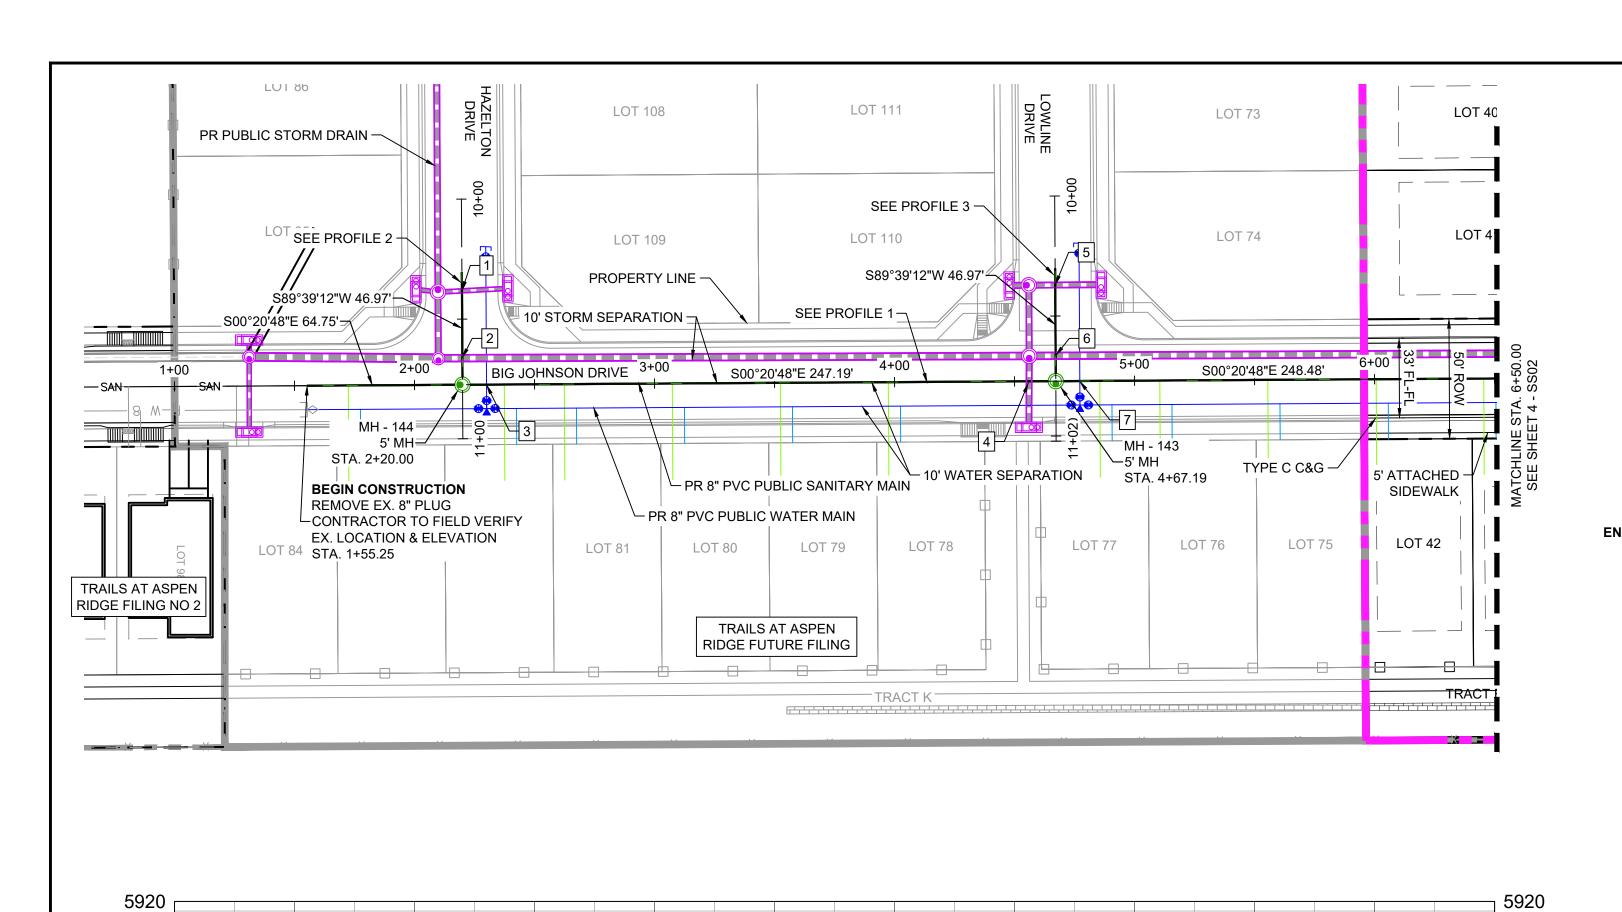


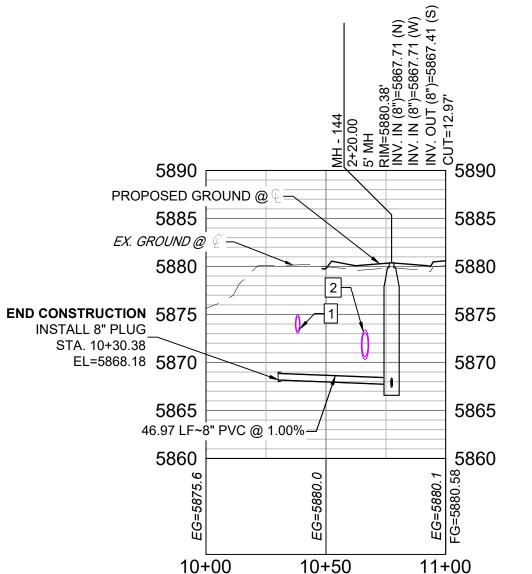

Hazelton-SAN PROFILE SCALE: (H) 1" = 40' (V) 1" = 10' START STA: 10+00.00, END STA: 10+99.84

PROFILE 2

5895

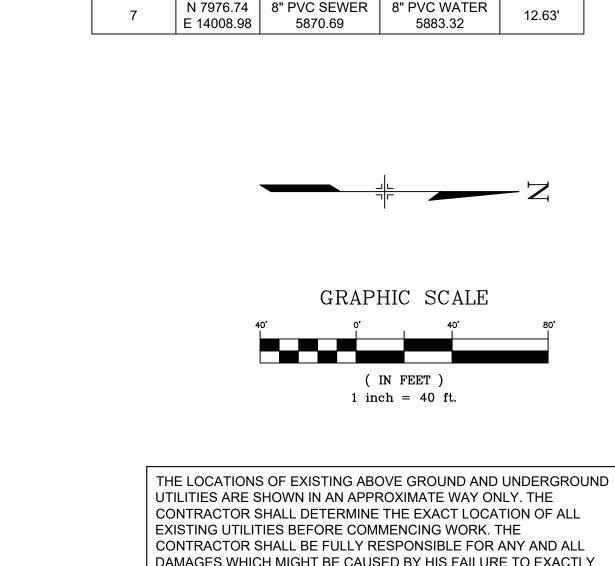

CROSSING

N 7719.33

E 13971.45

N 7719.50

E 13999.37

N 7729.56

E 14010.51

N 7955.64

N 7966.50

E 13968.99

N 7966.69

E 13998.38

E 14009.1⁻

UTILITIES ARE SHOWN IN AN APPROXIMATE WAY ONLY. THE CONTRACTOR SHALL DETERMINE THE EXACT LOCATION OF ALL EXISTING UTILITIES BEFORE COMMENCING WORK. THE CONTRACTOR SHALL BE FULLY RESPONSIBLE FOR ANY AND ALL DAMAGES WHICH MIGHT BE CAUSED BY HIS FAILURE TO EXACTLY LOCATE AND PRESERVE ANY AND ALL ABOVE GROUND AND UNDERGROUND UTILITIES.

UTILITY CROSSING DETAILS

BTM OF PIPE VERT. SEP.

4.27'

4.52'

10.00'

10.11'

12.63'

18" RCP STORM

5873.06

30" RCP STORM

5870.32

8" PVC WATER

5873.00

24" RCP STORM

5880.25

24" RCP STORM

5881.02

30" RCP STORM

5880.86

TOP OF PIPE

8" PVC SEWER

5868.79

8" PVC SEWER

5868.51

8" PVC SEWER

5868.48

8" PVC SEWER

5870.25

8" PVC SEWER

5871.04

8" PVC SEWER

5870.75

THE WIDEFIELD WATER AND SANITATION DISTRICT RECOGNIZES THE DESIGN ENGINEER AS HAVING RESPONSIBILITY FOR THE DESIGN AND HAS LIMITED ITS SCOPE OF REVIEW ACCORDINGLY.

SHEET No.

Know what's below.

Call before you dig.

WIDEFIELD WATER AND SANITATION DISTRICT WASTEWATER DESIGN APPROVAL

PROJECT NUMBER:

IN CASE OF ERRORS OR OMISSIONS WITH THE WATER DESIGN AS SHOWN ON THIS DOCUMENT THE STANDARDS AS DEFINED IN THE "RULES AND REGULATIONS FOR INSTALLATION OF WASTEWATER MAINS AND SERVICES" SHALL RULE.

APPROVAL EXPIRES 180 DAYS FROM DESIGN APPROVAL

PROPOSED GROUND @ 5900 5900 - EX. GROUND @ 5885 5880 64.75 LF~8" PVC @ 4.00%= 248.48 LF~8" PVC @ 0.50% _247.19 LF~8" PVC @ 0.78% <u>-</u> 5870 248.4 LF~8" PVC @ 4.00% = 5865 **BEGIN CONSTRUCTION** 5860 5860 REMOVE EX 8" PLUG CONTRACTOR TO FIELD VERIFY EX LOCATION & ELEVATION 5855 5855 STA. 1+55.25 EL=5864.82 5850 5850 1+50 2+00 2+50 3+00 3+50 4+00 4+50 5+00 5+50 6+00 BigJohnson-SAN PROFILE SCALE: (H) 1" = 40' (V) 1" = 10' START STA: 1+00.00, END STA: 6+50.00 PROFILE 1

EX. GROUND @ 5890 5890 5885 5885 5880 5880 **END CONSTRUCTION** INSTALL 8" PLUG_5875 5875 STA. 10+30.17 EL=5870.42 5870 5870 5865 46.97 LF~8" PVC @ 1.00%= 10+50 11+00 Lowline-SAN PROFILE SCALE: (H) 1" = 40' (V) 1" = 10' START STA: 10+00.00, END STA: 11+02.13

PROPOSED GROUND @

PROFILE 3

REFERENCE DRAWINGS				<u> </u>	SHEET KEY
DRAWINGS	-				- "
					<u> </u>
	1	10/14/2022	SHORTENED WATER SERVICES TO PROPERTY LINE	CV	
	No.	DATE	DESCRIPTION	BY]
			REVISIONS		
	COM	IPUTER FIL	E MANAGEMENT		
	CTB F	<i>II F</i> · Matrix(b	6.038 (Trails F6)\100 Dwg\104 Plan Sets\Construction Plans\Utility Plans\Sanitary Plan\SS01.dwg ack).ctb 4, 2023 1:31:09 PM		

THIS DRAWING IS CURRENT AS OF PLOT DATE AND MAY BE SUBJECT TO CHANGE.

5915

5910

5905

5915


5910

5905

COLORADO SPRINGS UTILITIES (FIMS) MONUMENT F206 A BERNTSEN TOP SECURITY MONUMENT SYSTEM WITH A 3.5-INCH DIAMETER ALUMINUM CAP IN A ROAD BOX, LOCATED ON THE NORTHWEST CORNER OF FONTAINE BOULEVARD AND POWERS

BOULEVARD, ELEVATION - 5897.89' U.S. SURVEY FT

BASIS OF BEARING

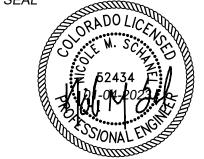


TRAILS AT ASPEN RIDGE


FILING NO. 4 8" SANITARY SEWER PLANS

WASTEWATER PLAN & PROFILE


FOR AND ON BEHALF OF MATRIX DESIGN GROUP, INC. PROJECT No. 21.886.038 BAS SCALE DATE ISSUED:
JLW HORIZ. 1" = 40' DESIGNED BY: JUNE 2022 DRAWING No. DRAWN BY: SS01 CHECKED BY: NMS VERT. 1" = 10' SHEET 3 OF 12

PREPARED BY:

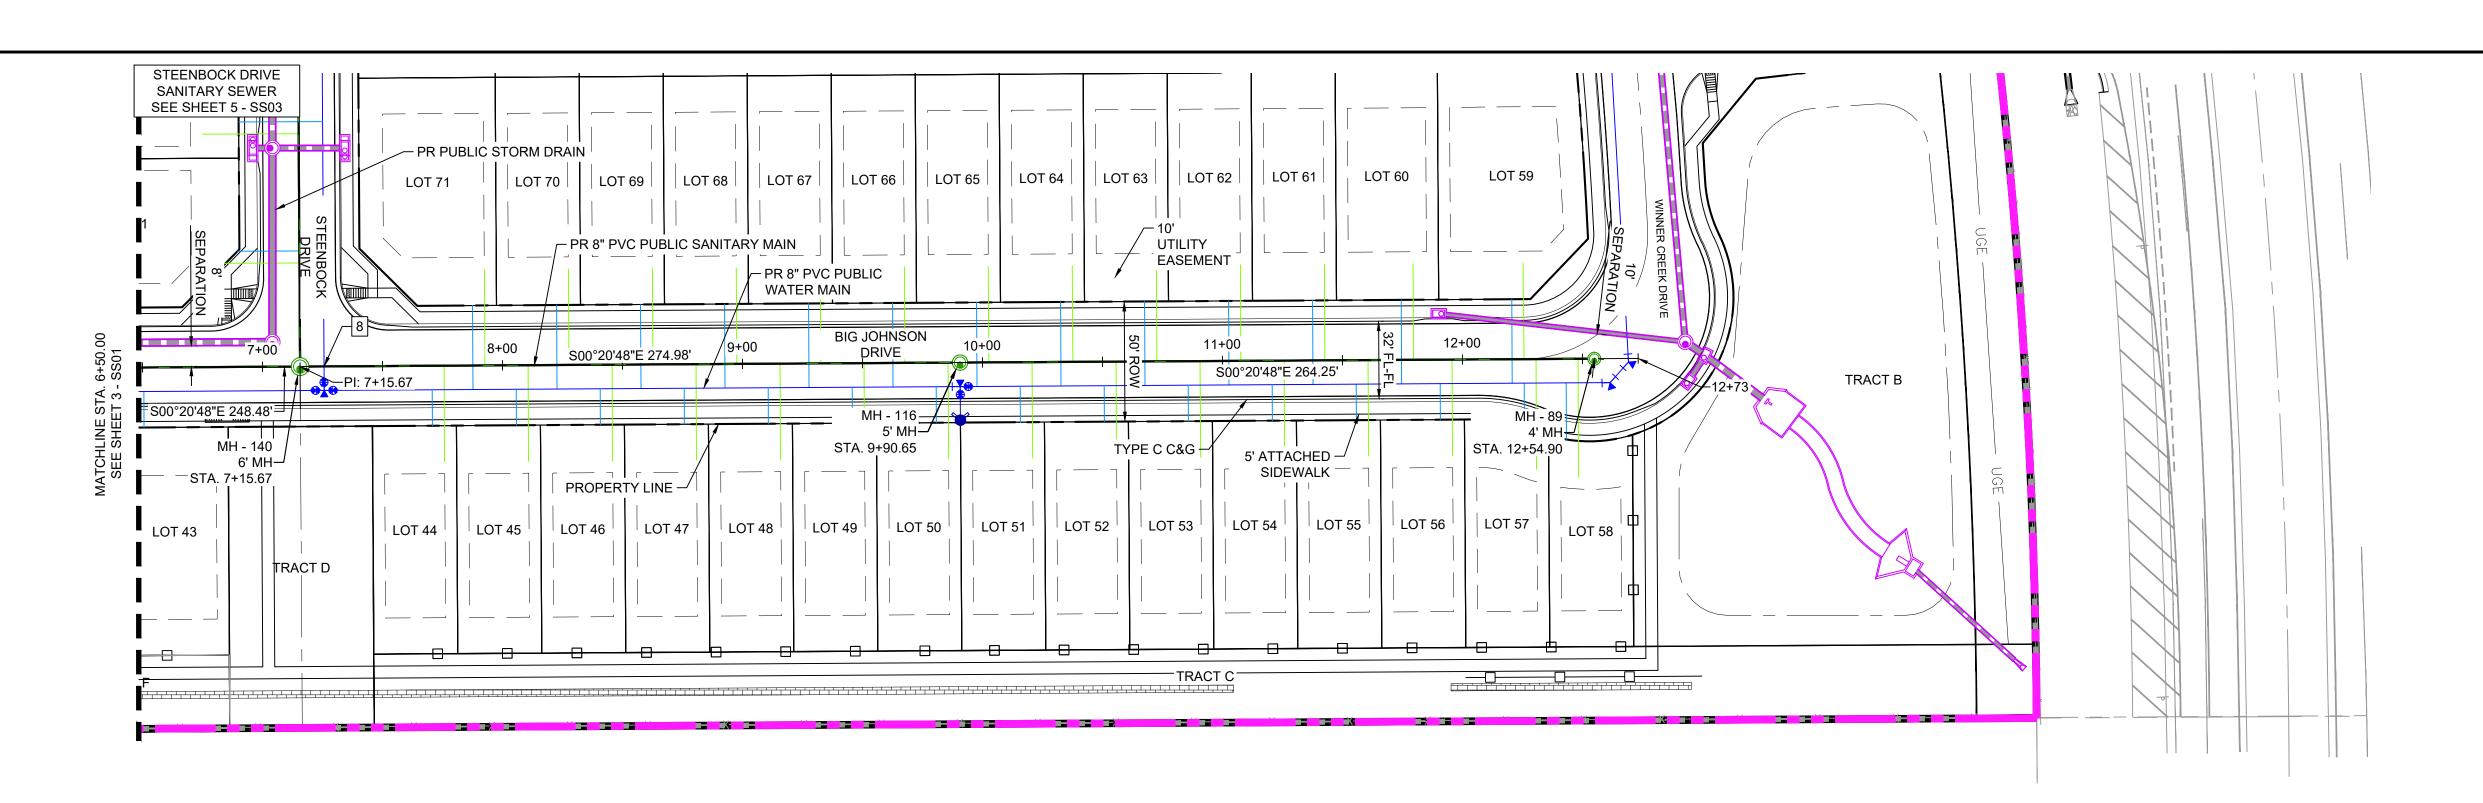

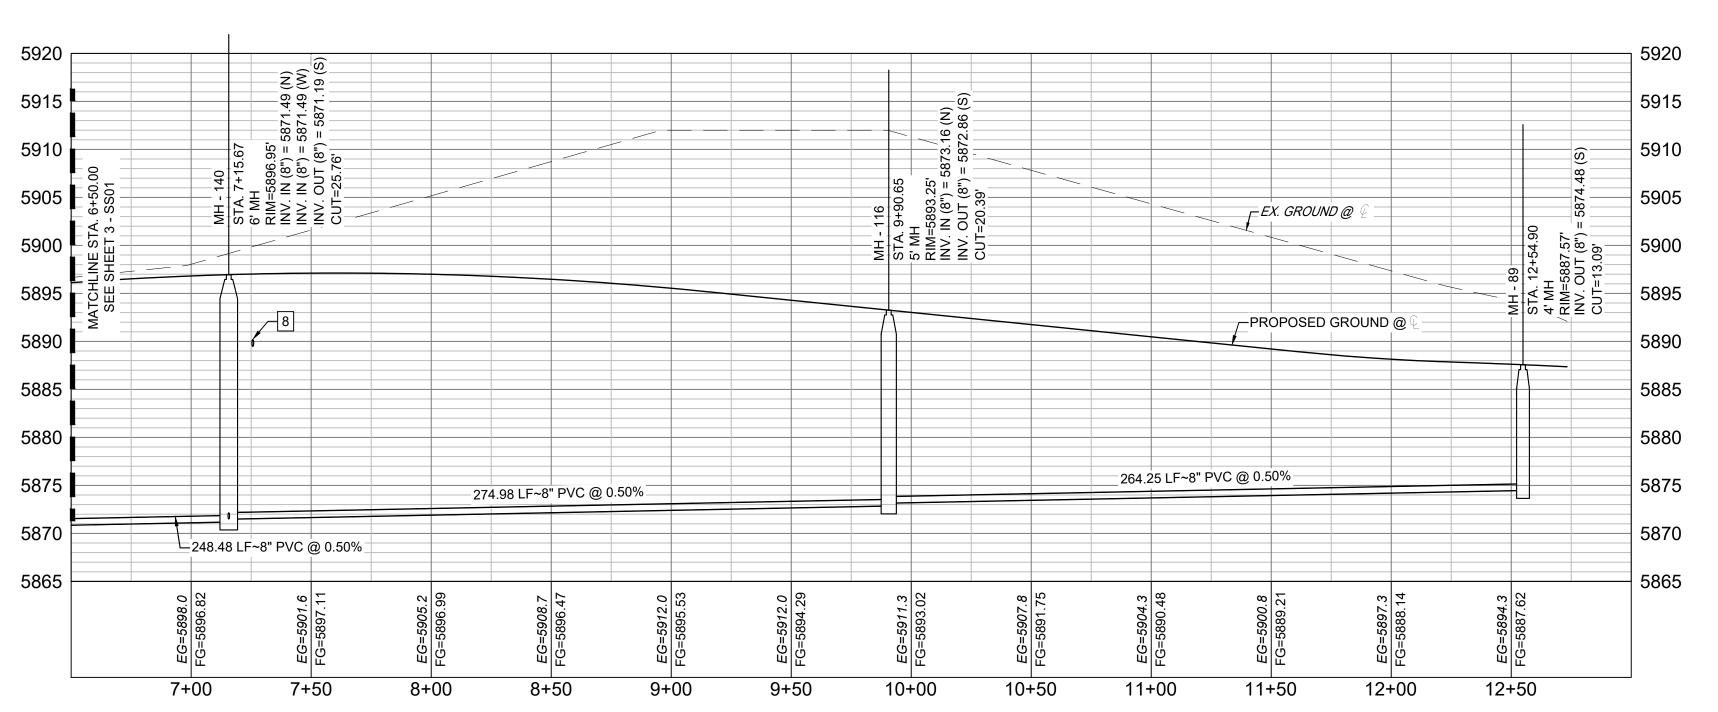

BigJohnson-SAN PROFILE SCALE: (H) 1" = 40' (V) 1" = 10' START STA: 6+50.00, END STA: 13+00.00

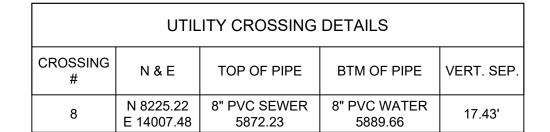


SHEET No.

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Call before you dig.



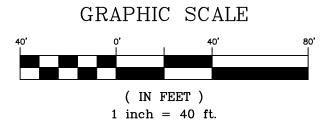

THE LOCATIONS OF EXISTING ABOVE GROUND AND UNDERGROUND UTILITIES ARE SHOWN IN AN APPROXIMATE WAY ONLY. THE CONTRACTOR SHALL DETERMINE THE EXACT LOCATION OF ALL EXISTING UTILITIES BEFORE COMMENCING WORK. THE CONTRACTOR SHALL BE FULLY RESPONSIBLE FOR ANY AND ALL DAMAGES WHICH MIGHT BE CAUSED BY HIS FAILURE TO EXACTLY LOCATE AND PRESERVE ANY AND ALL ABOVE GROUND AND UNDERGROUND UTILITIES.

THE WIDEFIELD WATER AND SANITATION DISTRICT RECOGNIZES THE DESIGN ENGINEER AS HAVING RESPONSIBILITY FOR THE DESIGN AND HAS LIMITED ITS SCOPE OF REVIEW ACCORDINGLY.

> WIDEFIELD WATER AND SANITATION DISTRICT WASTEWATER DESIGN APPROVAL

PROJECT NUMBER:

IN CASE OF ERRORS OR OMISSIONS WITH THE WATER DESIGN AS SHOWN ON THIS DOCUMENT THE STANDARDS AS DEFINED IN THE "RULES AND REGULATIONS FOR INSTALLATION OF WASTEWATER MAINS AND SERVICES" SHALL RULE.

APPROVAL EXPIRES 180 DAYS FROM DESIGN APPROVAL


REFERENCE SHEET KEY DRAWINGS 10/14/2022 SHORTENED WATER SERVICES TO PROPERTY LINE No. DATE BY DESCRIPTION REVISIONS COMPUTER FILE MANAGEMENT FILE NAME: S:\21.886.038 (Trails F6)\100 Dwg\104 Plan Sets\Construction Plans\Utility Plans\Sanitary Plan\SS01.dwg CTB FILE: Matrix(black).ctb PLOT DATE: January 4, 2023 1:31:16 PM

THIS DRAWING IS CURRENT AS OF PLOT DATE AND MAY BE SUBJECT TO CHANGE.

COLORADO SPRINGS UTILITIES (FIMS) MONUMENT F206 A BERNTSEN TOP SECURITY MONUMENT SYSTEM WITH A 3.5-INCH DIAMETER ALUMINUM CAP IN A ROAD BOX, LOCATED ON THE NORTHWEST CORNER OF FONTAINE BOULEVARD AND POWERS BOULEVARD, ELEVATION - 5897.89' U.S. SURVEY FT

BASIS OF BEARING

PREPARED BY:

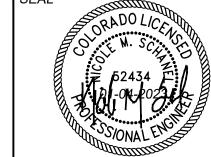


FOR AND ON BEHALF OF MATRIX DESIGN GROUP, INC. PROJECT No. 21.886.038


TRAILS AT ASPEN RIDGE


FILING NO. 4 8" SANITARY SEWER PLANS


WASTEWATER PLAN & PROFILE

-	DESIGNED BY:	BAS	SC	ALE	DATE 1001 IED	JUNE 2022	DDAWNO N
	DRAWN BY:	JLW	HORIZ.	1" = 40'	DATE ISSUED:	JUINE 2022	DRAWING No.
	CHECKED BY:	NMS	VERT.	1" = 10'	SHEET	4 OF 12	5502

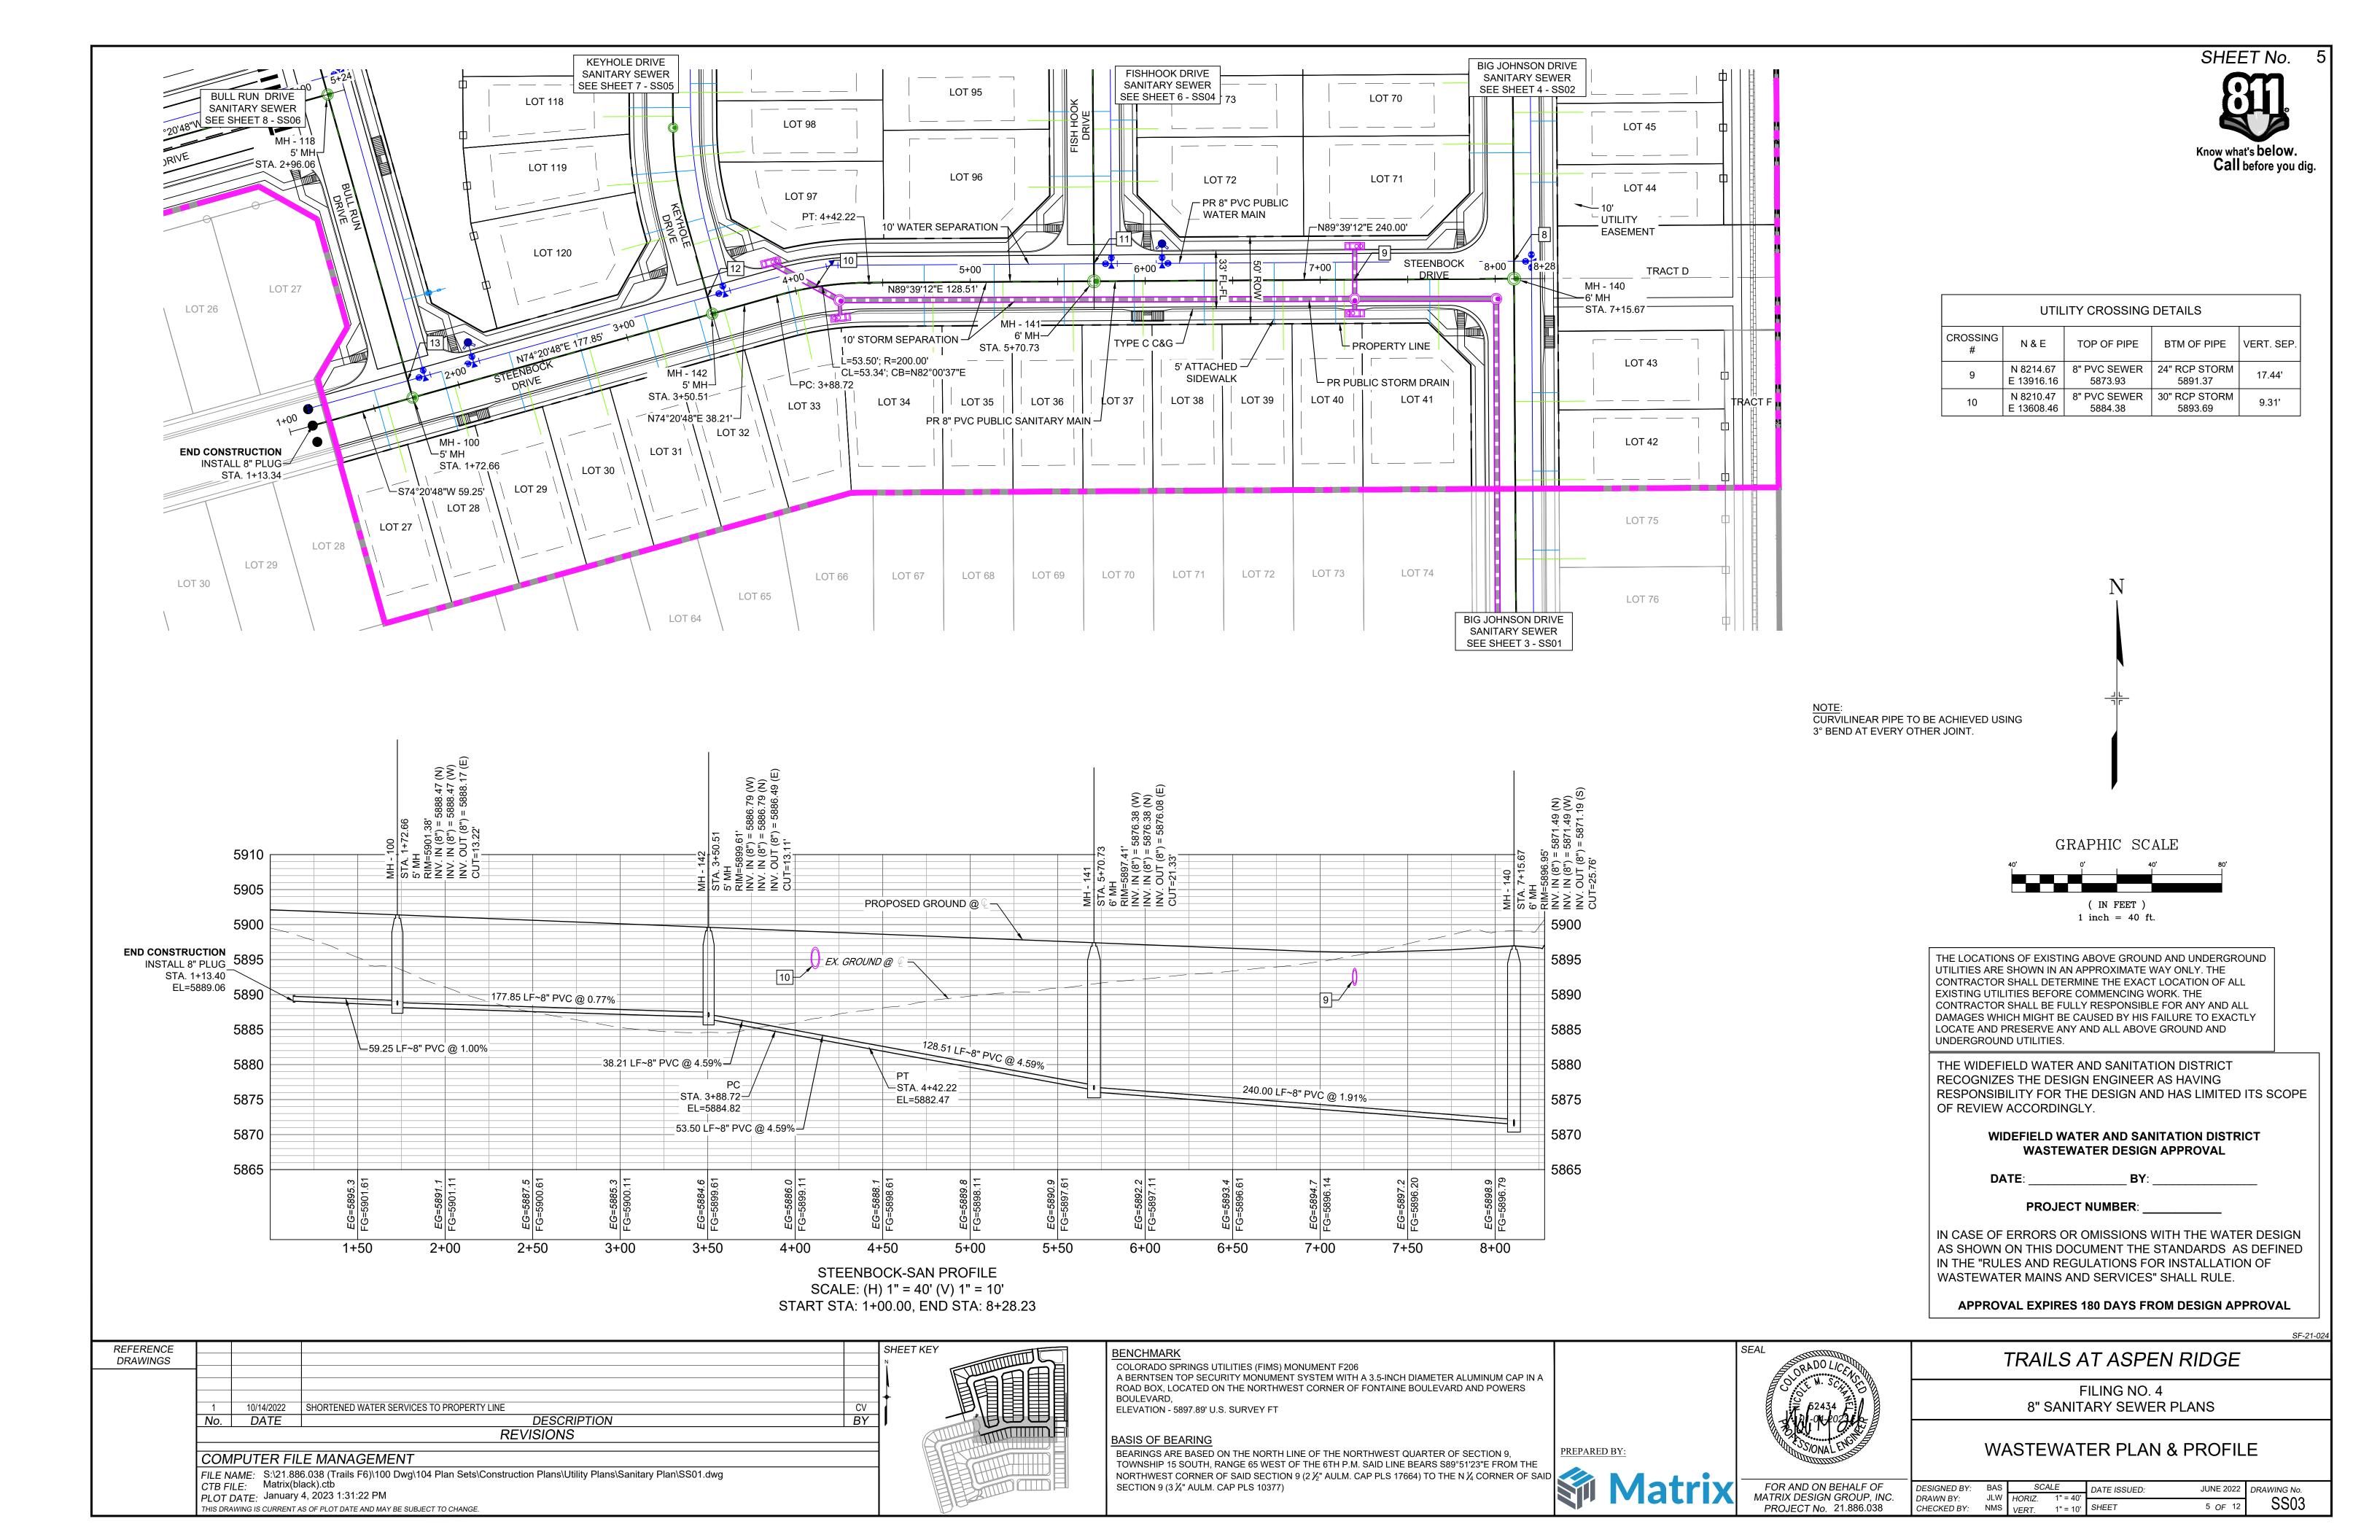

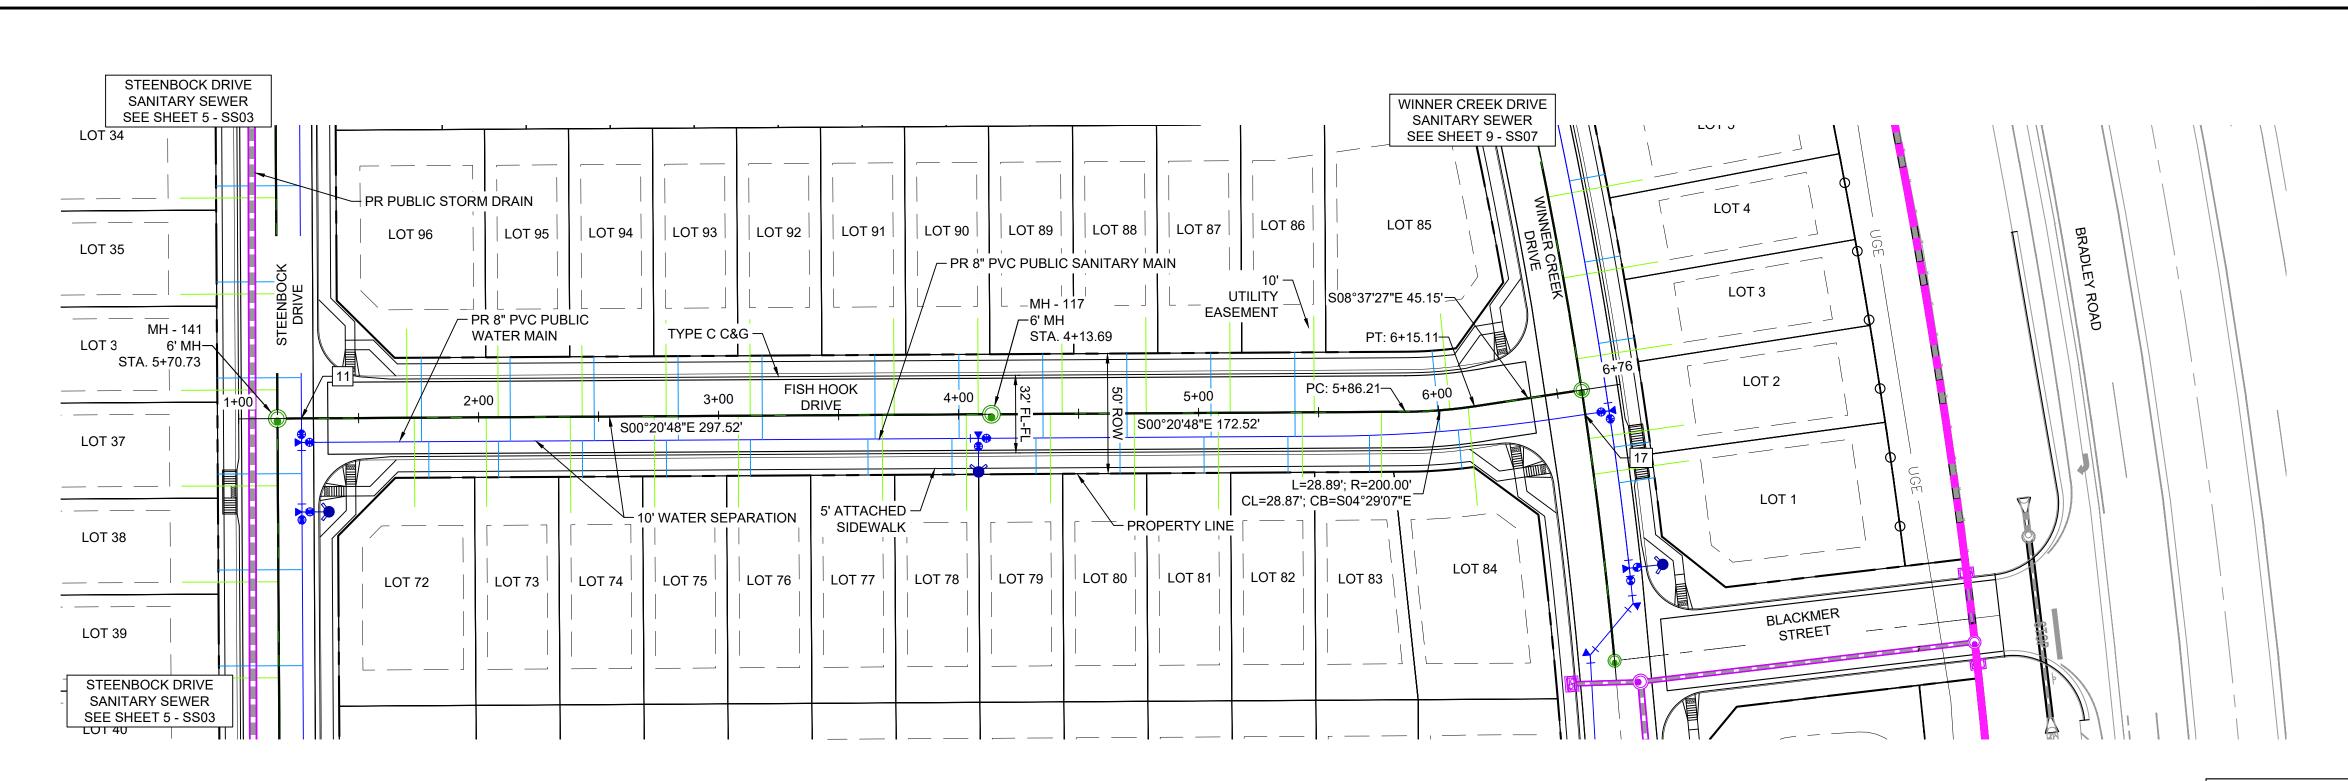

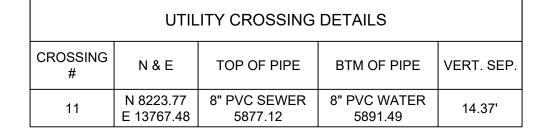

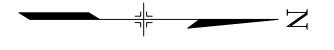


SHEET No.

Know what's below.

Call before you dig.

CURVILINEAR PIPE TO BE ACHIEVED USING 3° BEND AT EVERY OTHER JOINT.

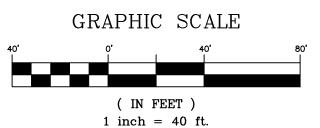

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APPROVAL EXPIRES 180 DAYS FROM DESIGN APPROVAL

Fishhook-SAN PROFILE SCALE: (H) 1" = 40' (V) 1" = 10' START STA: 1+00.00, END STA: 7+00.00 REFERENCE SHEET KEY DRAWINGS 10/14/2022 SHORTENED WATER SERVICES TO PROPERTY LINE No. DATE BY DESCRIPTION REVISIONS COMPUTER FILE MANAGEMENT FILE NAME: S:\21.886.038 (Trails F6)\100 Dwg\104 Plan Sets\Construction Plans\Utility Plans\Sanitary Plan\SS01.dwg CTB FILE: Matrix(black).ctb PLOT DATE: January 4, 2023 1:31:27 PM THIS DRAWING IS CURRENT AS OF PLOT DATE AND MAY BE SUBJECT TO CHANGE.

1+50

2+00

EX. GROUND @

-297.52 LF~8" PVC @ 0.50%

2+50

3+00

3+50

PROPOSED GROUND @

5920

5905

5900

5895

5890

5885

5880

5875

5870

-172.52 LF∼8" PVC @ 0.50% —

4+50

4+00

COLORADO SPRINGS UTILITIES (FIMS) MONUMENT F206 A BERNTSEN TOP SECURITY MONUMENT SYSTEM WITH A 3.5-INCH DIAMETER ALUMINUM CAP IN A ROAD BOX, LOCATED ON THE NORTHWEST CORNER OF FONTAINE BOULEVARD AND POWERS BOULEVARD,

6+00

45.15 LF~8" PVC @ 0.50%—

STA. 5+86.21 EL=5878.93

28.89 LF~8" PVC @ 0.50%=

5+50

1.50' |")=5879.60 (W) |")=5879.60 (E) (8")=5879.30 (8")

STA. 6+15.11−

EL=5879.07

6+50

5915

5900

5895

5890

5885

5880

5875

5870

PREPARED BY:

ELEVATION - 5897.89' U.S. SURVEY FT

5+00

BASIS OF BEARING BEARINGS ARE BASED ON THE NUKTH LINE OF THE 6TH P.M. SAID LINE BEARS S89°51'23"E PROWNER TOWNSHIP 15 SOUTH, RANGE 65 WEST OF THE 6TH P.M. SAID LINE BEARS S89°51'23"E PROWNER OF SAID NORTHWEST CORNER OF SAID SECTION 9 (2½" AULM. CAP PLS 17664) TO THE N¼ CORNER OF SAID SECTION 9 (3½" AULM. CAP PLS 10377)





TRAILS AT ASPEN RIDGE

FILING NO. 4 8" SANITARY SEWER PLANS

WASTEWATER PLAN & PROFILE

FOR AND ON BEHALF OF	DESIGNED BY:	BAS	SCALE		DATE ISSUED:	JUNE 2022	DRAWING No.
MATRIX DESIGN GROUP, INC.	DRAWN BY:	JLW	HORIZ.	1" = 40'	_		0004
				-	CUEET	6 OF 12	SS04
PROJECT No. 21.886.038	CHECKED BY:	NMS	VERT.	1" = 10'	SHEET	0 OF 12	0007

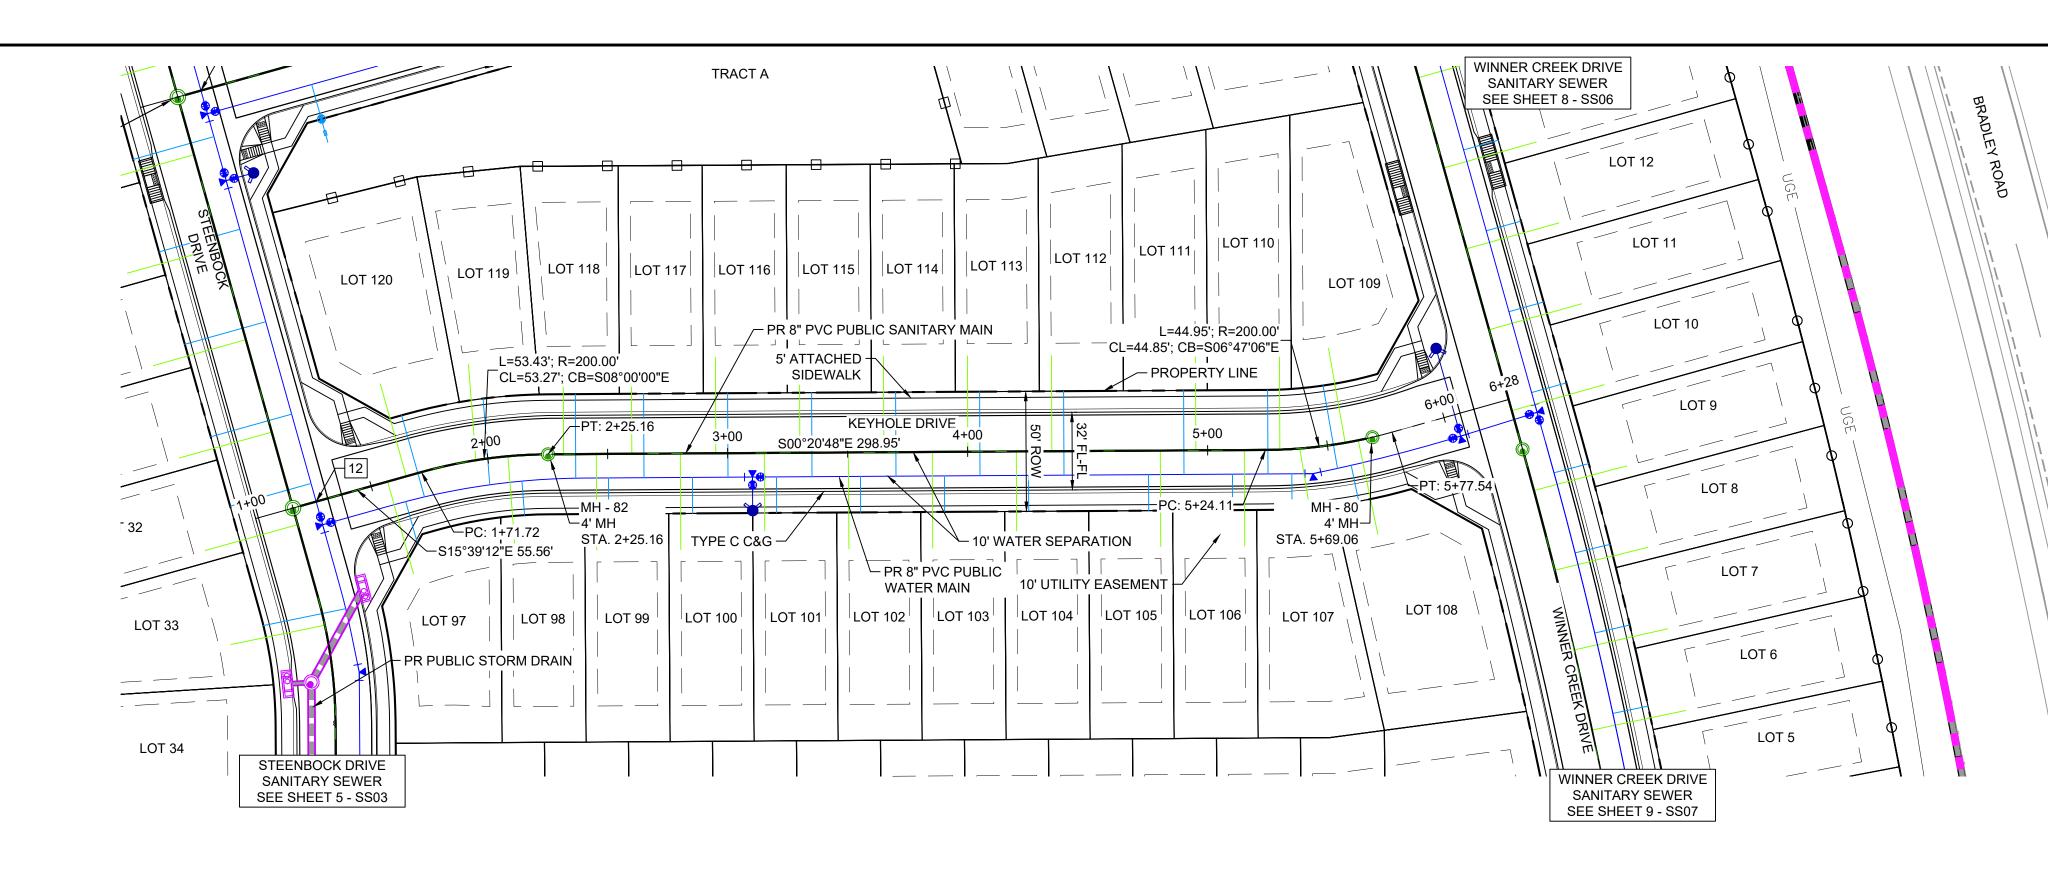

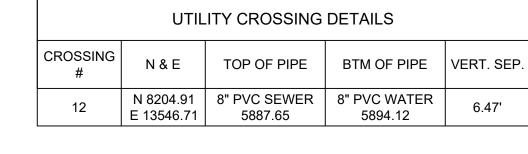



SHEET No.

Know what's **below**.

Call before you dig.

NOTE:
CURVILINEAR PIPE TO BE ACHIEVED USING 3° BEND AT EVERY OTHER JOINT.

GRAPHIC SCALE (IN FEET)

1 inch = 40 ft.

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PROJECT NUMBER:

APPROVAL EXPIRES 180 DAYS FROM DESIGN APPROVAL

12 5890 44.95 LF~8" PVC @ 0.97%<u></u> 5885 ├-53.43 LF~8" PVC @ 1.65%-5880 55.56 LF~8" PVC @ 1.65% 2+00 2+50 3+50 6+00 1+50 3+00 4+50 5+00 5+50 Keyhole-SAN PROFILE SCALE: (H) 1" = 40' (V) 1" = 10' START STA: 1+00.00, END STA: 6+27.97 SHEET KEY COLORADO SPRINGS UTILITIES (FIMS) MONUMENT F206 BOULEVARD, 10/14/2022 SHORTENED WATER SERVICES TO PROPERTY LINE

STA NV. INV.

⊤−STA. 1+71.72−

EL=5887.73

PROPOSED GROUND @ $\mathop{f @}$

-EX. GROUND @

-298.95 LF~8" PVC @ 0.97%

5920

5910

5900

5895

REFERENCE

DRAWINGS

No. DATE

CTB FILE: Matrix(black).ctb

COMPUTER FILE MANAGEMENT

THIS DRAWING IS CURRENT AS OF PLOT DATE AND MAY BE SUBJECT TO CHANGE.


PLOT DATE: January 4, 2023 1:31:32 PM

MH - 14 STA. 3+ STA. 3+ STA. 3+ INV. IN INV. OU CUT=13

DESCRIPTION

REVISIONS

FILE NAME: S:\21.886.038 (Trails F6)\100 Dwg\104 Plan Sets\Construction Plans\Utility Plans\Sanitary Plan\SS01.dwg

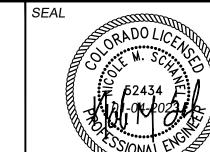

PREPARED BY:

TRAILS AT ASPEN RIDGE

FILING NO. 4 8" SANITARY SEWER PLANS

WASTEWATER PLAN & PROFILE

SS05

FOR AND ON BEHALF OF MATRIX DESIGN GROUP, INC. PROJECT No. 21.886.038

 DESIGNED BY:
 BAS
 SCALE
 DATE ISSUED:

 DRAWN BY:
 JLW
 HORIZ.
 1" = 40'

 CHECKED BY:
 NMS
 VERT.
 1" = 10'
 SHEET
 JUNE 2022 DRAWING No. 7 OF 12

A BERNTSEN TOP SECURITY MONUMENT SYSTEM WITH A 3.5-INCH DIAMETER ALUMINUM CAP IN A ROAD BOX, LOCATED ON THE NORTHWEST CORNER OF FONTAINE BOULEVARD AND POWERS

5920

5905

5900

5895

5890

5885


5880


ELEVATION - 5897.89' U.S. SURVEY FT

BASIS OF BEARING

STA. 5+24.11− EL=5891.80

BEARINGS ARE BASED ON THE NUKTH LINE OF THE 11 TOWNSHIP 15 SOUTH, RANGE 65 WEST OF THE 6TH P.M. SAID LINE BEARS \$89°51'23" E FROW THE NORTHWEST CORNER OF SAID SECTION 9 (2 ½" AULM. CAP PLS 17664) TO THE N ¼ CORNER OF SAID SECTION 9 (3 ½" AULM. CAP PLS 10377)

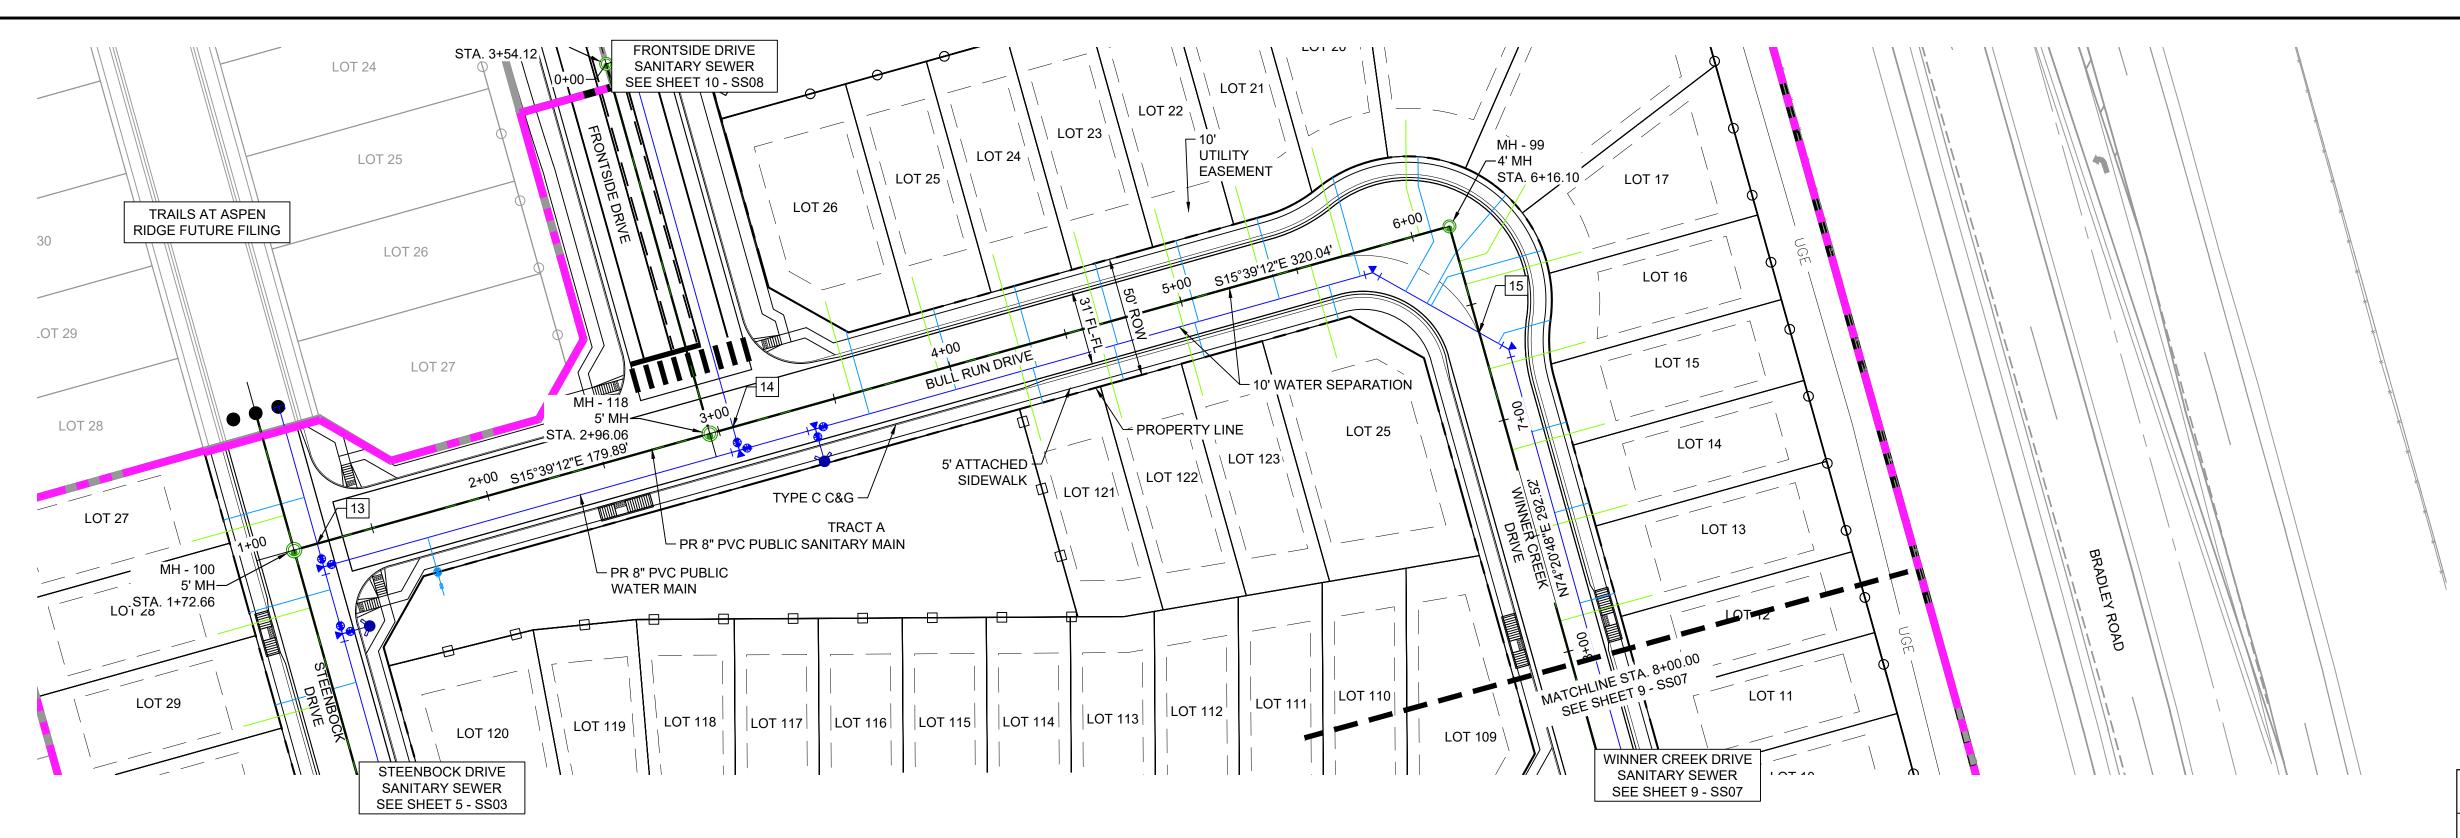

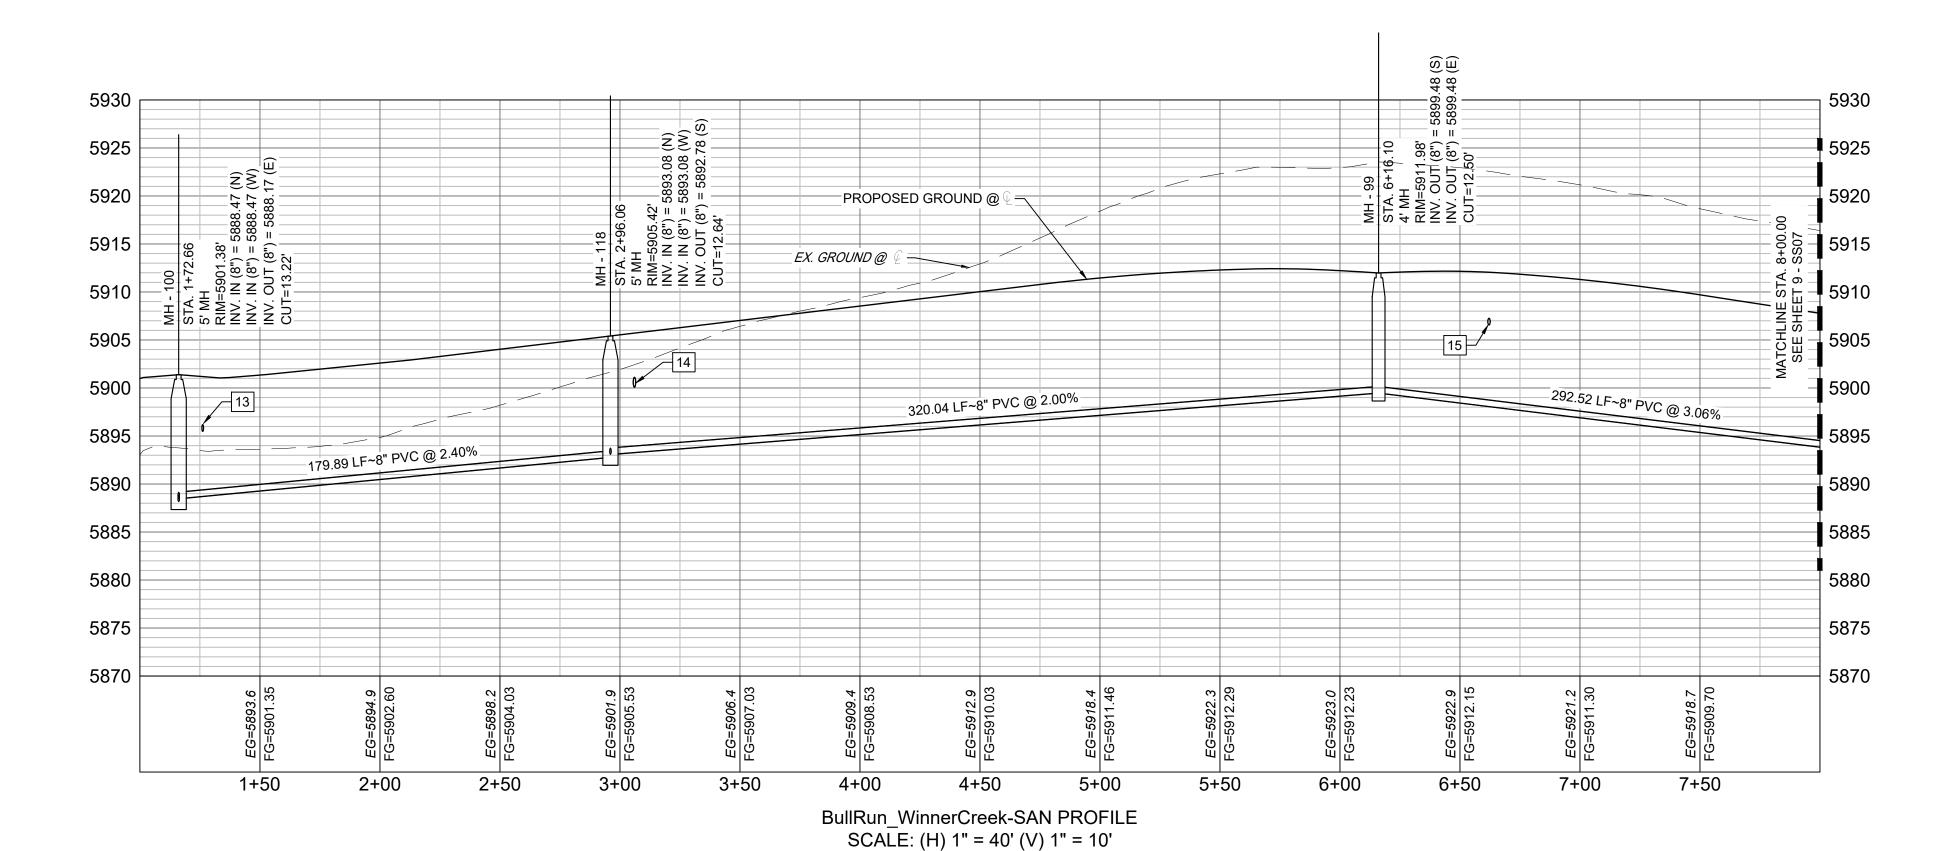

START STA: 1+00.00, END STA: 8+00.00

CROSSING TOP OF PIPE BTM OF PIPE VERT. SEP. N 8156.91 | 8" PVC SEWER 8" PVC WATER 6.50' E 13375.46 5895.90 5889.40 N 8330.13 | 8" PVC SEWER 12" PVC WATER 6.11' E 13326.92 5893.97 5900.08 N 8641.09 | 8" PVC SEWER 8" PVC WATER 7.80' 5906.56

UTILITY CROSSING DETAILS

SHEET No.

Know what's below.

Call before you dig.



GRAPHIC SCALE

1 inch = 40 ft.

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> WIDEFIELD WATER AND SANITATION DISTRICT WASTEWATER DESIGN APPROVAL

PROJECT NUMBER:

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APPROVAL EXPIRES 180 DAYS FROM DESIGN APPROVAL

TRAILS AT ASPEN RIDGE

REFERENCE SHEET KEY DRAWINGS 10/14/2022 SHORTENED WATER SERVICES TO PROPERTY LINE No. DATE BY DESCRIPTION REVISIONS COMPUTER FILE MANAGEMENT

FILE NAME: S:\21.886.038 (Trails F6)\100 Dwg\104 Plan Sets\Construction Plans\Utility Plans\Sanitary Plan\SS01.dwg

CTB FILE: Matrix(black).ctb

PLOT DATE: January 4, 2023 1:31:37 PM

THIS DRAWING IS CURRENT AS OF PLOT DATE AND MAY BE SUBJECT TO CHANGE.

COLORADO SPRINGS UTILITIES (FIMS) MONUMENT F206 A BERNTSEN TOP SECURITY MONUMENT SYSTEM WITH A 3.5-INCH DIAMETER ALUMINUM CAP IN A ROAD BOX, LOCATED ON THE NORTHWEST CORNER OF FONTAINE BOULEVARD AND POWERS

BOULEVARD, ELEVATION - 5897.89' U.S. SURVEY FT

BASIS OF BEARING

BEARINGS ARE BASED ON THE NORTH LINE OF THE NORTHWEST QUARTER OF SECTION 9, BEARINGS ARE BASED ON THE NORTH ENGLAND TOWNSHIP 15 SOUTH, RANGE 65 WEST OF THE 6TH P.M. SAID LINE BEARS 589 51 23 E FINOR THE NORTHWEST CORNER OF SAID SECTION 9 (2 ½" AULM. CAP PLS 17664) TO THE N ½ CORNER OF SAID SECTION 9 (3 ½" AULM. CAP PLS 10377)




FILING NO. 4 8" SANITARY SEWER PLANS

WASTEWATER PLAN & PROFILE

BAS SCALE DATE ISSUED:

JLW HORIZ. 1" = 40' DESIGNED BY: JUNE 2022 DRAWING No. DRAWN BY: SS06 CHECKED BY: NMS VERT. 1" = 10' SHEET 8 OF 12

PREPARED BY: FOR AND ON BEHALF OF MATRIX DESIGN GROUP, INC. PROJECT No. 21.886.038

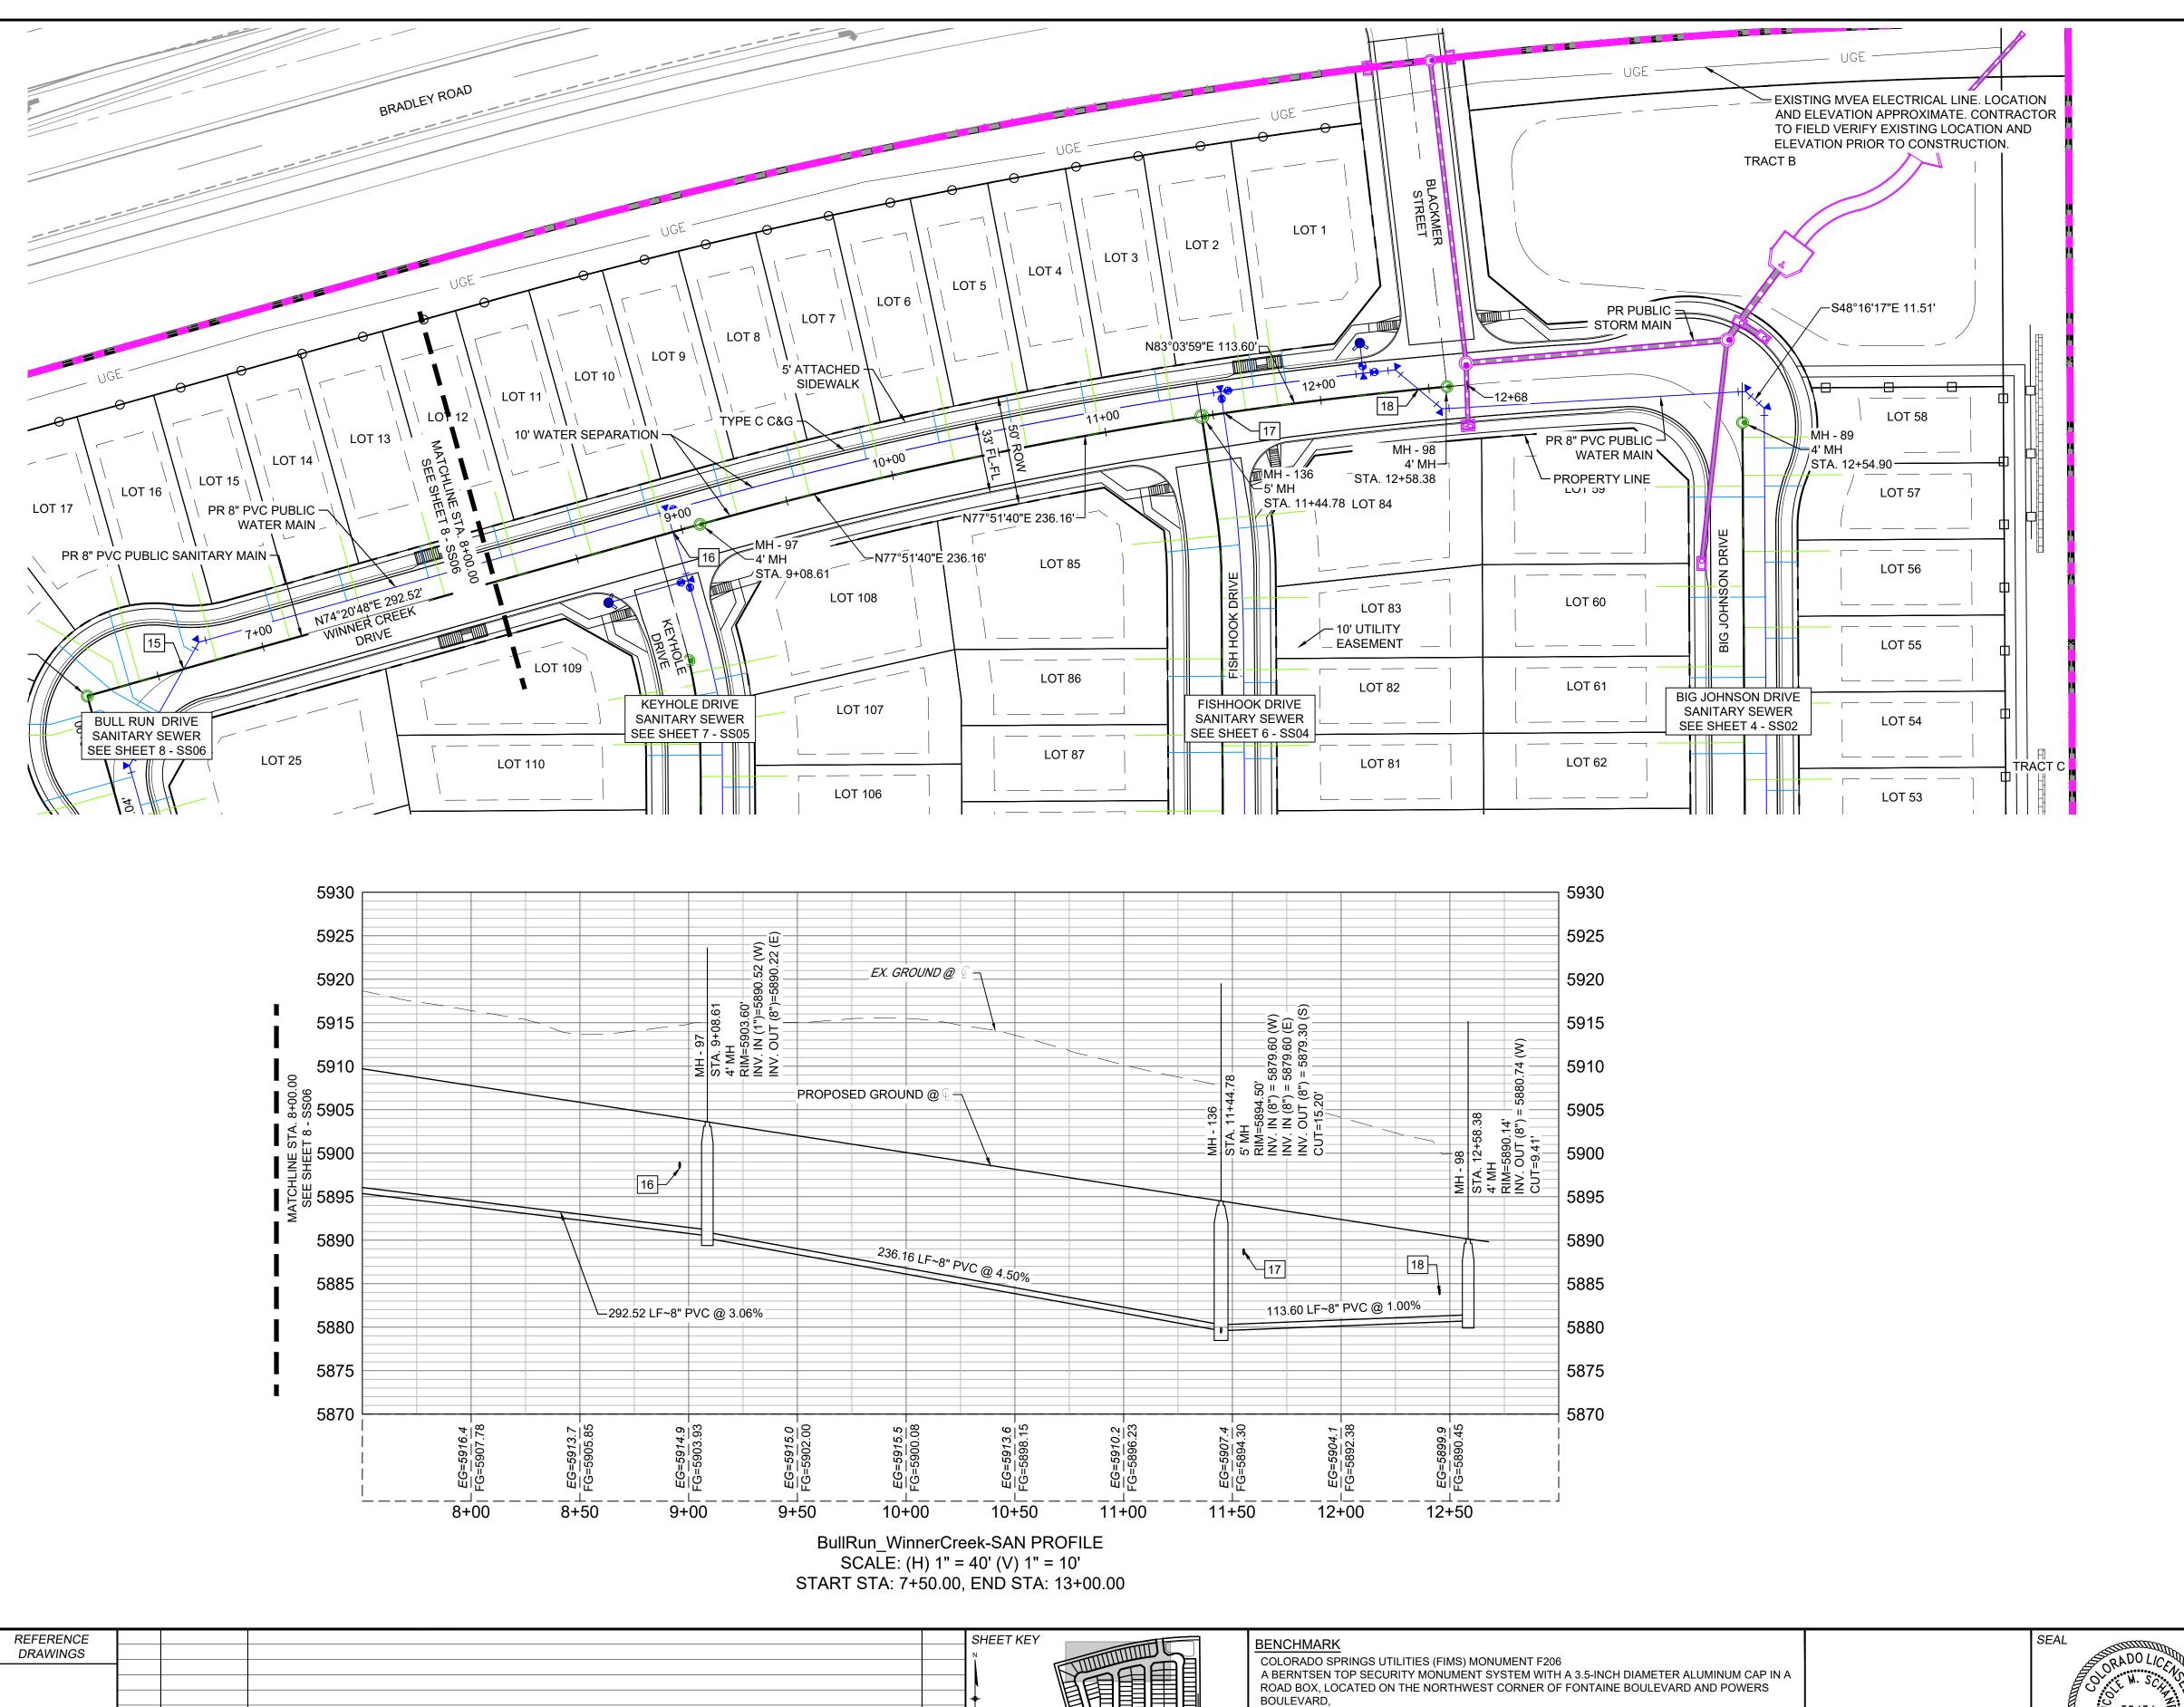

BY

ELEVATION - 5897.89' U.S. SURVEY FT

BEARINGS ARE BASED ON THE NORTH LINE OF THE NORTHWEST QUARTER OF SECTION 9,

BEARINGS ARE BASED ON THE TOWNS TOWNSHIP 15 SOUTH, RANGE 65 WEST OF THE 6TH P.M. SAID LINE BEARS S89 31 23 E 1 130 M NORTHWEST CORNER OF SAID SECTION 9 (2 ½" AULM. CAP PLS 17664) TO THE N ¼ CORNER OF SAID SECTION 9 (3 ¼" AULM. CAP PLS 10377)

BASIS OF BEARING

10/14/2022 SHORTENED WATER SERVICES TO PROPERTY LINE

DESCRIPTION

REVISIONS

FILE NAME: S:\21.886.038 (Trails F6)\100 Dwg\104 Plan Sets\Construction Plans\Utility Plans\Sanitary Plan\SS01.dwg

No. DATE

CTB FILE: Matrix(black).ctb

COMPUTER FILE MANAGEMENT


THIS DRAWING IS CURRENT AS OF PLOT DATE AND MAY BE SUBJECT TO CHANGE.


PLOT DATE: January 4, 2023 1:31:42 PM

CURVILINEAR PIPE TO BE ACHIEVED USING 3° BEND AT EVERY OTHER JOINT.

SHEET No. Know what's below. Call before you dig.

UTILITY CROSSING DETAILS						
CROSSING #	N&E	TOP OF PIPE	BTM OF PIPE	VERT. SEP.		
16	N 8704.16 E 13512.68	8" PVC SEWER 5891.60	8" PVC WATER 5898.29	6.69'		
17	N 8758.76 E 13765.98	8" PVC SEWER 5880.39	8" PVC WATER 5888.30	7.91'		
18	N 8770.00 E 13858.47	8" PVC SEWER 5881.30	8" PVC WATER 5883.72	2.42'		

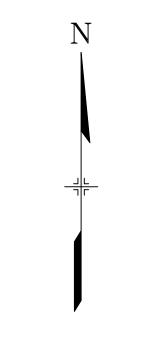

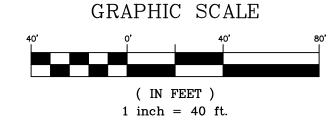

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APPROVAL EXPIRES 180 DAYS FROM DESIGN APPROVAL

TRAILS AT ASPEN RIDGE

PREPARED BY:

FILING NO. 4					
8" SANITARY SEWER PLANS					


WASTEWATER PLAN & PROFILE


9 OF 12


BAS SCALE DATE ISSUED:

JLW HORIZ. 1" = 40' DESIGNED BY: JUNE 2022 DRAWING No. SS07

FOR AND ON BEHALF OF MATRIX DESIGN GROUP, INC. PROJECT No. 21.886.038 DRAWN BY: CHECKED BY: NMS VERT. 1" = 10' SHEET

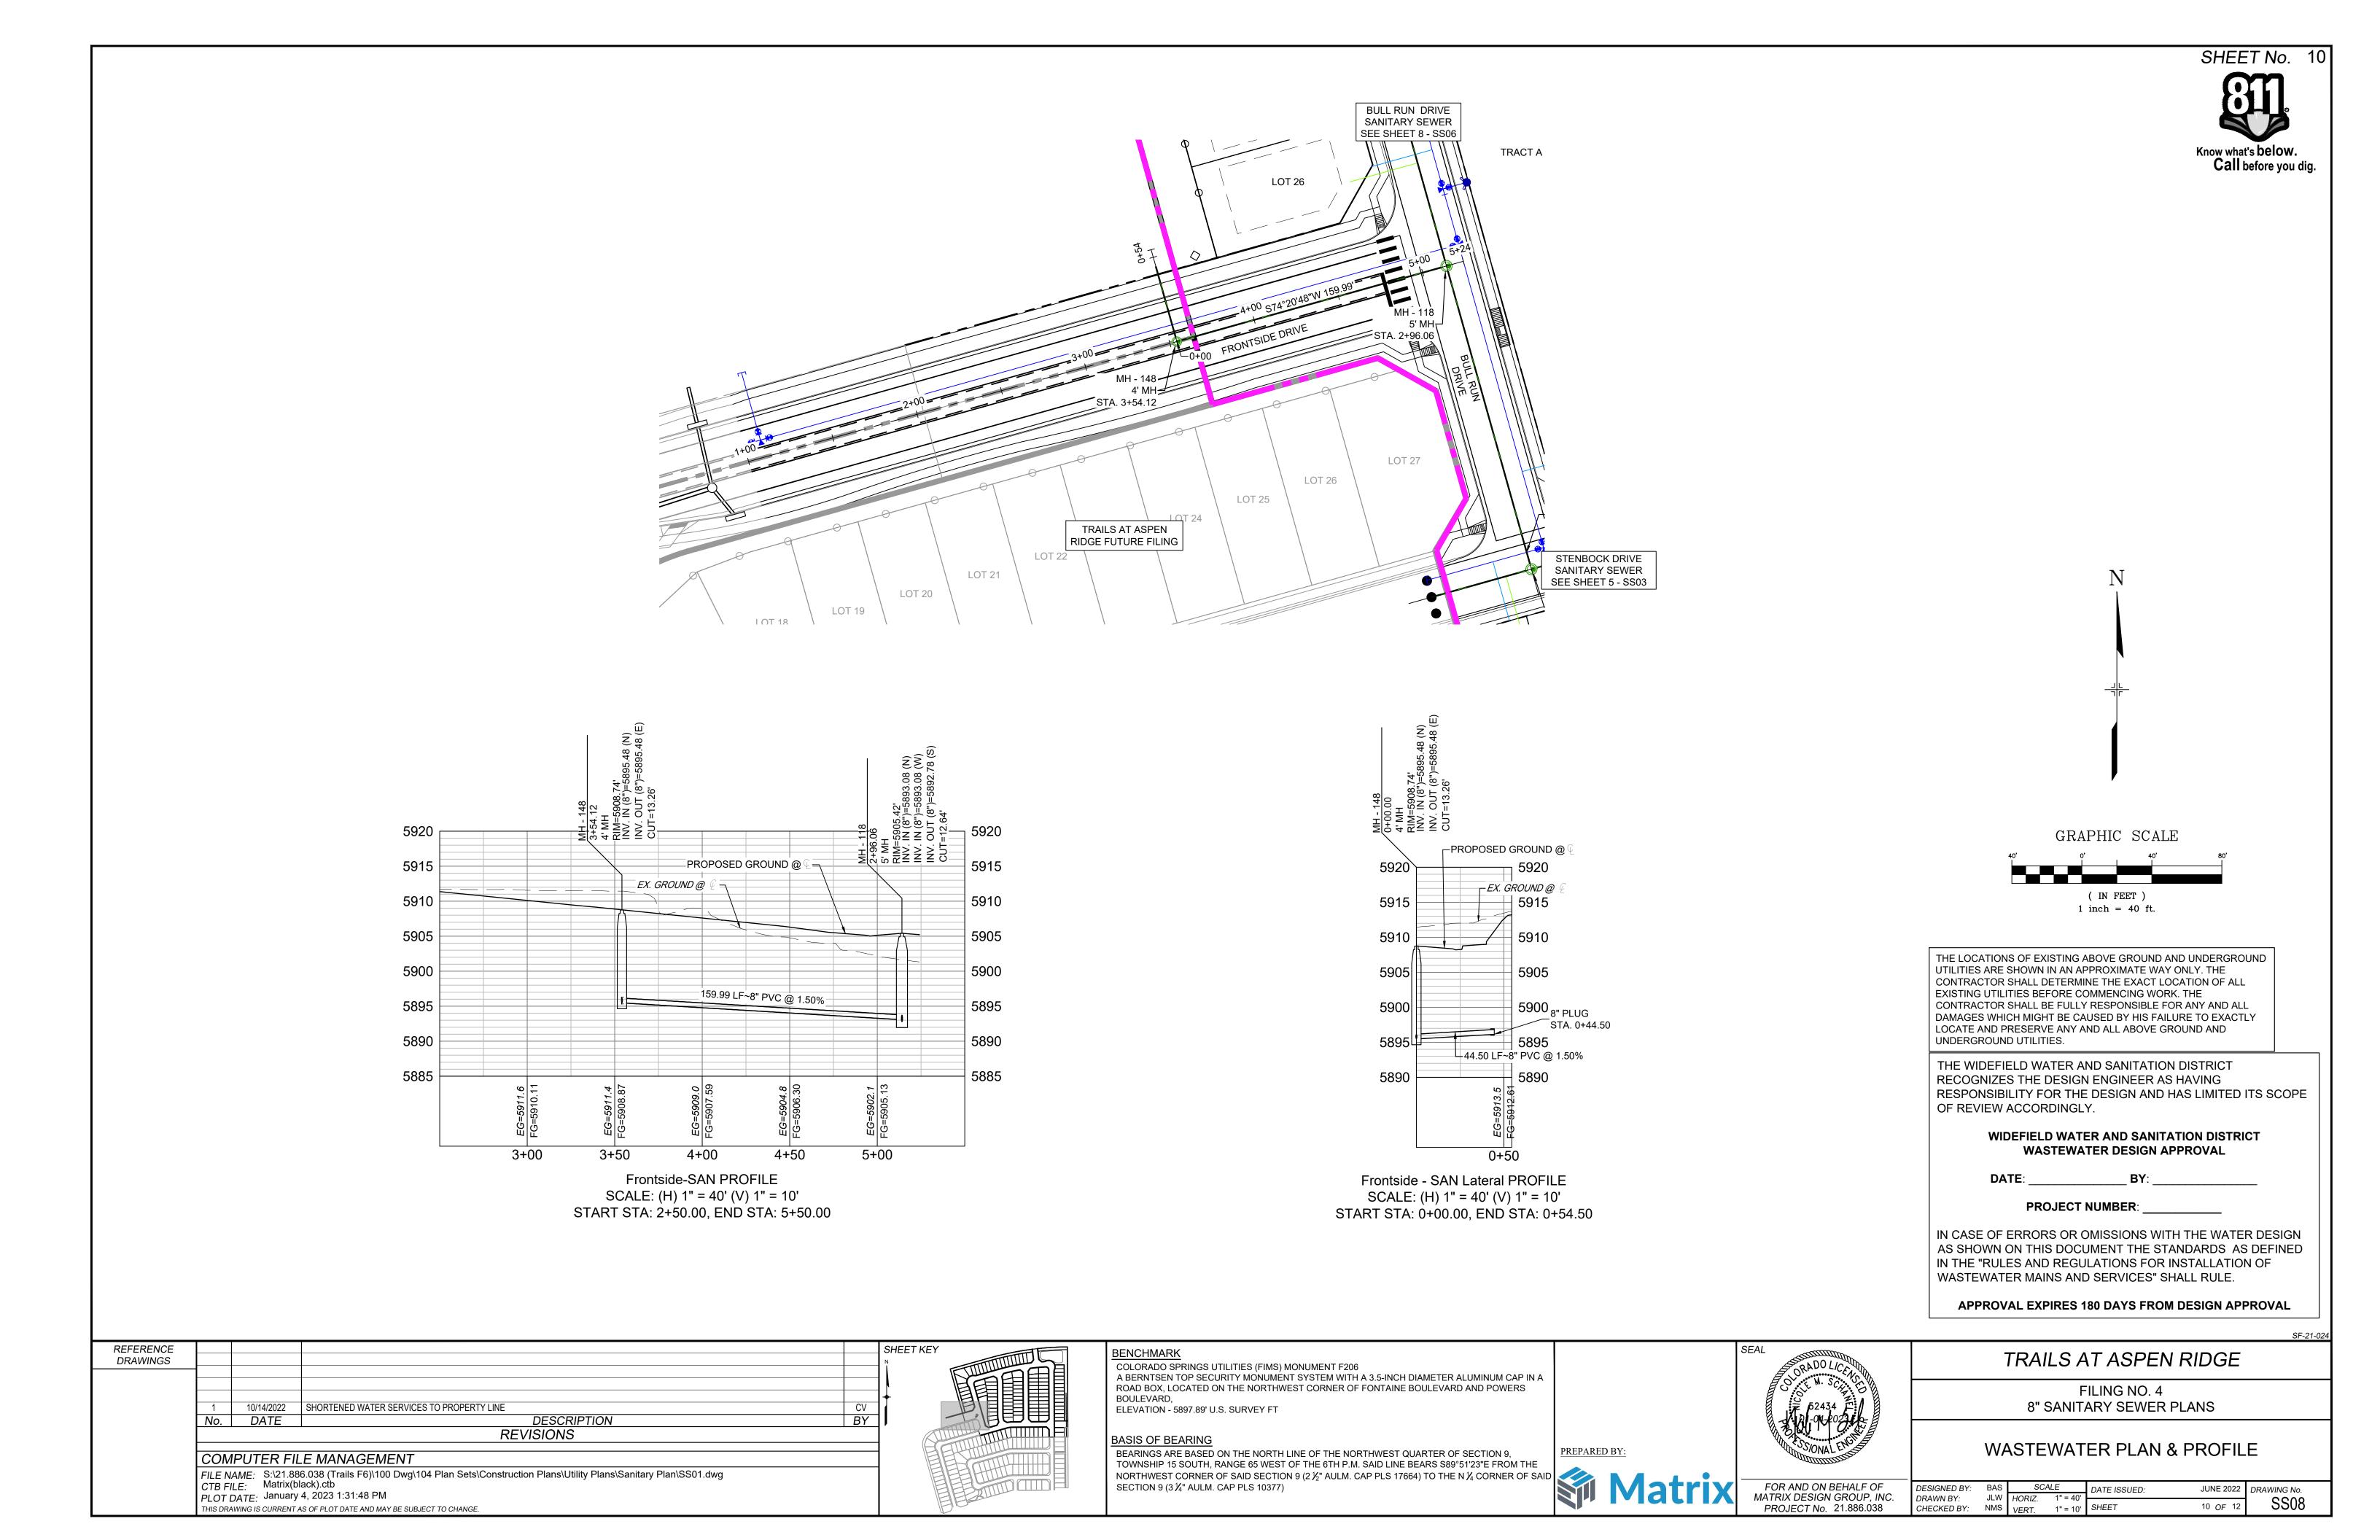

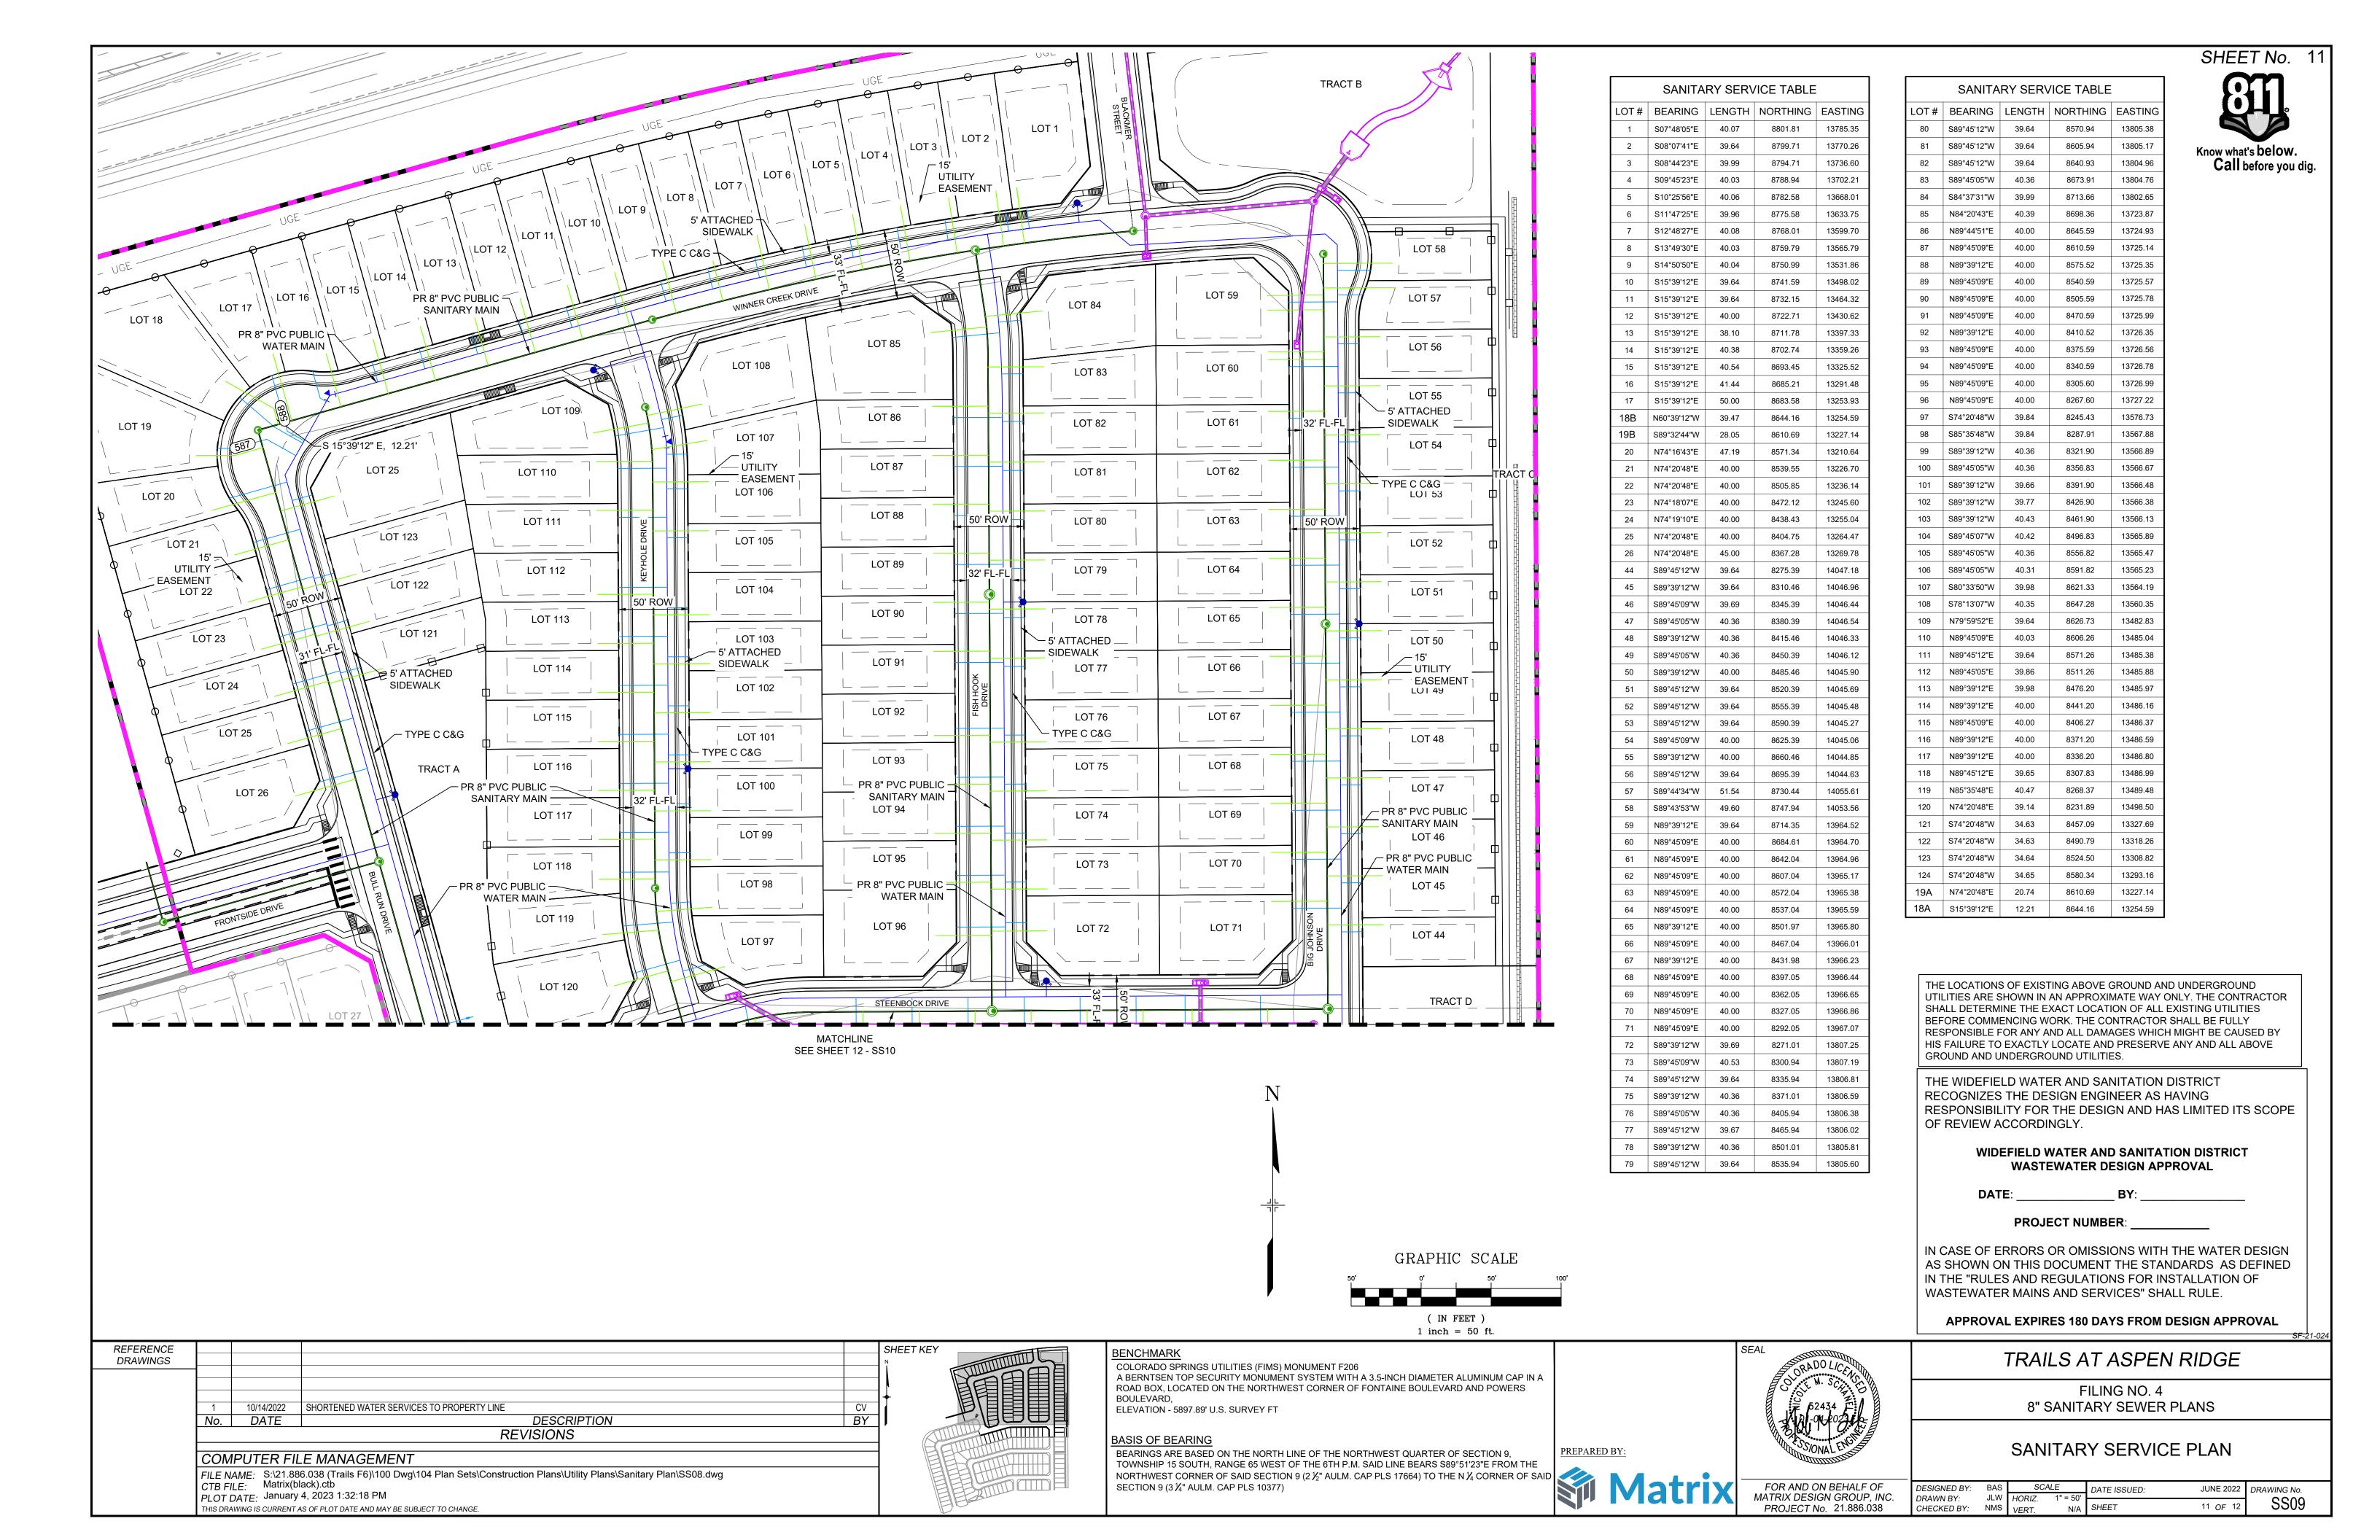

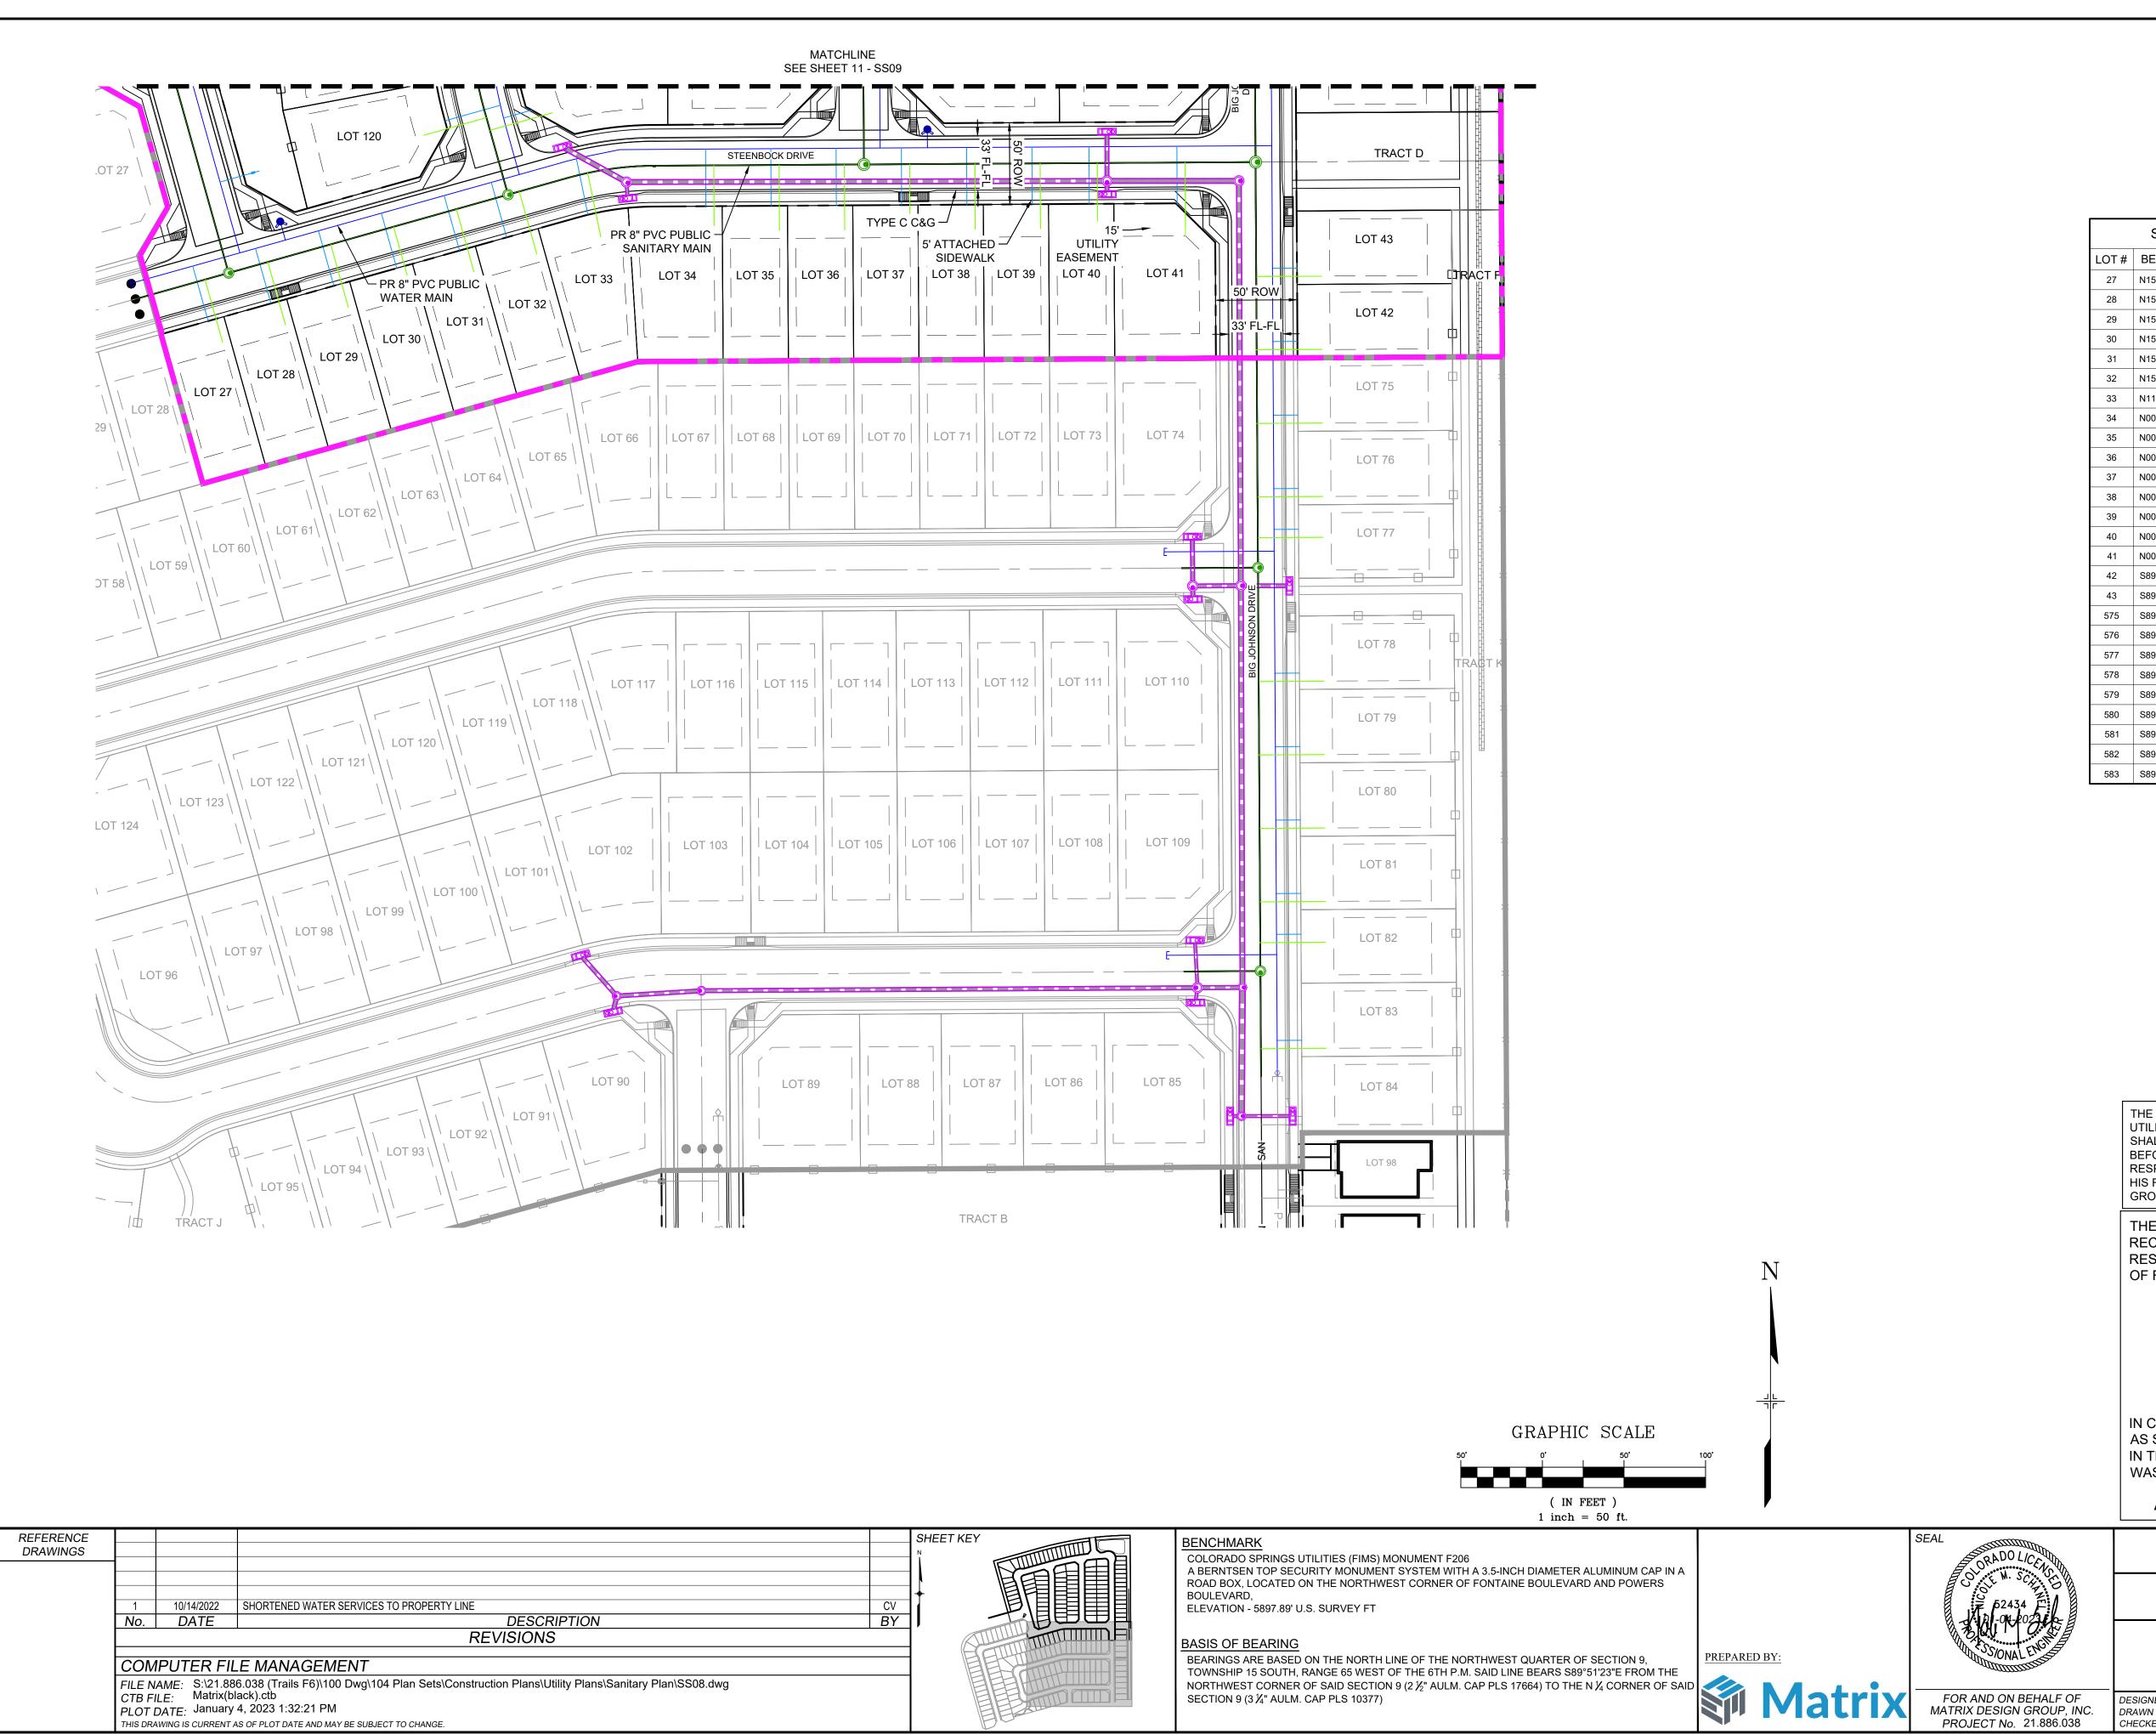

FILE NAME: S:\21.886.038 (Trails F6)\100 Dwg\104 Plan Sets\Construction Plans\Utility Plans\Sanitary Plan\SS08.dwg

CTB FILE: Matrix(black).ctb

PLOT DATE: January 4, 2023 1:32:21 PM

THIS DRAWING IS CURRENT AS OF PLOT DATE AND MAY BE SUBJECT TO CHANGE.

SHEET No. 12 Know what's **below**. Call before you dig.

SANITARY SERVICE TABLE						
LOT#	BEARING	LENGTH	NORTHING	EASTING		
27	N15°39'12"W	40.00	8104.72	13374.51		
28	N15°39'12"W	40.00	8115.50	13412.98		
29	N15°38'07"W	40.00	8126.30	13451.54		
30	N15°38'07"W	40.00	8137.09	13490.05		
31	N15°38'07"W	40.00	8147.89	13528.57		
32	N15°39'12"W	40.00	8158.68	13567.09		
33	N11°35'48"W	40.00	8169.36	13606.26		
34	N00°14'51"W	40.00	8173.21	13675.72		
35	N00°14'51"W	40.00	8173.46	13715.72		
36	N00°14'51"W	40.00	8173.70	13755.72		
37	N00°14'51"W	38.25	8175.69	13795.71		
38	N00°20'48"W	40.00	8174.18	13835.78		
39	N00°14'51"W	40.00	8174.42	13875.71		
40	N00°14'51"W	40.00	8174.64	13910.71		
41	N00°14'16"W	45.00	8169.96	13964.58		
42	S89°45'05"W	40.36	8100.40	14048.23		
43	S89°45'12"W	39.62	8145.26	14047.94		
575	S89°39'12"W	40.36	8055.33	14048.51		
576	S89°39'12"W	39.64	8010.33	14048.78		
577	S89°39'12"W	39.64	7985.33	14048.93		
578	S89°39'12"W	39.64	7897.20	14049.46		
579	S89°39'12"W	40.36	7852.20	14049.74		
580	S89°39'12"W	39.64	7807.20	14050.01		
581	S89°39'12"W	40.00	7762.20	14050.28		
582	S89°39'12"W	40.36	7737.20	14050.43		
583	S89°39'12"W	40.00	7672.21	14050.82		

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APPROVAL EXPIRES 180 DAYS FROM DESIGN APPROVAL

TRAILS AT ASPEN RIDGE

FILING NO. 4 8" SANITARY SEWER PLANS

SANITARY SERVICE PLAN

DESIGNED BY: BAS SCALE DATE ISSUED:
DRAWN BY: JLW HORIZ. 1" = 50'
CHECKED BY: NMS VERT. N/A SHEET JUNE 2022 DRAWING No. SS10 12 OF 12

FOR AND ON BEHALF OF MATRIX DESIGN GROUP, INC. PROJECT No. 21.886.038