TRAILS AT ASPEN RIDGE - FILING NO. 4



EL PASO COUNTY, COLORADO

PUBLIC WATERLINE PLANS SHEET NAME SHEET No. DWG No. TITLE SHEET **GN01** GENERAL NOTES, LEGEND, ABBREVIATIONS, & SHEET INDEX WATERLINE PLAN AND PROFILE 3 - 10 WATERLINE SERVICE PLAN 11 - 12

JUNE 2021

COUNTY PLAN REVIEW IS PROVIDED ONLY FOR GENERAL CONFORMANCE WITH COUNTY DESIGN CRITERIA. THE COUNTY IS NOT RESPONSIBLE FOR THE ACCURACY AND ADEQUACY OF THE DESIGN DIMENSIONS, AND/ OR ELEVATIONS WHICH SHALL BE CONFIRMED AT THE JOB SITE. THE COUNTY THROUGH THE APPROVAL OF THIS DOCUMENT ASSUMES NO RESPONSIBILITY FOR COMPLETENESS AND/ OR ACCURACY OF THIS DOCUMENT.

FILED IN ACCORDANCE WITH THE REQUIREMENTS OF THE EL PASO COUNTY LAND DEVELOPMENT CODE, DRAINAGE CRITERIA MANUAL, VOLUMES 1 AND 2, AND ENGINEERING CRITERIA MANUAL AS

MATRIX DESIGN GROUP 2435 RESEARCH PARKWAY, SUITE 300

555 MIDDLE CREEK PARKWAY, SUITE 380

COLORADO SPRINGS, CO 80921

COLORADO SPRINGS, CO 80920

WIDEFIELD WATER AND SANITATION DISTRICT

8495 FONTAINE BOULEVARD COLORADO SPRINGS, CO 80925 ROBERT BANNISTER, (719) 390-7111

ELECTRIC MOUNTAIN VIEW ELECTRIC ASSOCIATION

COLA, LLC

(719) 495-2283

GAS **COLORADO SPRINGS UTILITIES**

OWNER/DEVELOPER

WATER & SANITARY SEWER

CIVIL ENGINEER

1521 HANCOCK EXPRESSWAY COLORADO SPRINGS, CO MARY HOAGLUND (719) 668-4083

STREET EL PASO COUNTY PUBLIC SERVICES DEPARTMENT


(719) 520-6460

DRAINAGE EL PASO COUNTY PUBLIC SERVICES DEPARTMENT

(719) 520-6460

FIRE DEPARTMENT SECURITY FIRE DEPARTMENT

400 SECURITY BOULEVARD SECURITY, CO 80911 (719) 392-7121

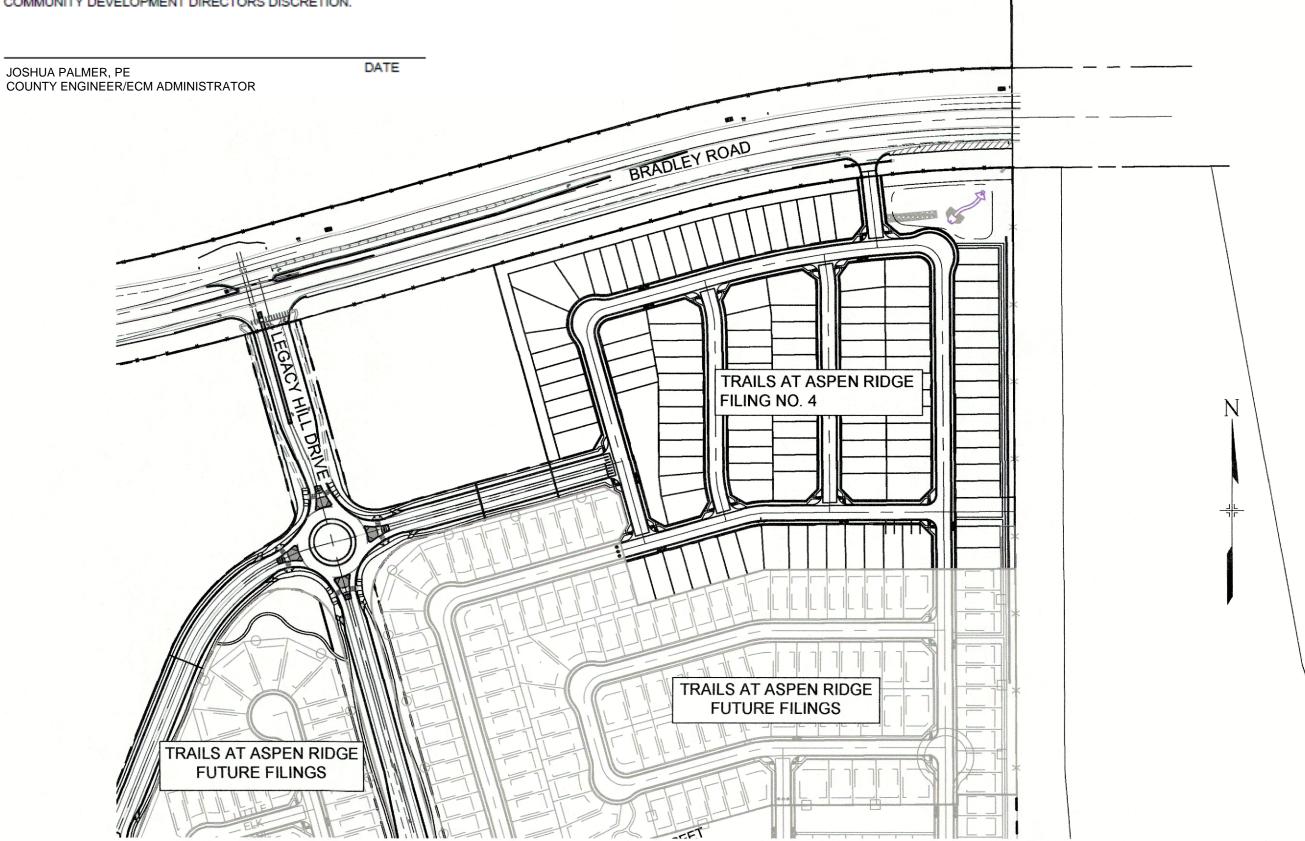

SITE MAP

NODE	FIRE FLOW (GPM)	PSI @ MDD
Α	2219.65	26.5
В	2218.71	26.8
С	2216.06	25.3
D	2217.82	24.6
E	2217.00	23.1
F	2215.31	24.5
G	2216.26	24.5
Н	2217.93	29.0

THIS GRADING AND EROSION CONTROL PLAN WAS PREPARED UNDER MY DIRECTION AND SUPERVISION AND IS CORRECT TO THE BEST OF MY KNOWLEDGE AND BELIEF. SAID PLAN HAS BEEN PREPARED ACCORDING TO THE CRITERIA ESTABLISHED BY THE COUNTY FOR GRADING AND EROSION CONTROL PLANS. I ACCEPT RESPONSIBILITY FOR ANY LIABILITY CAUSED BY ANY NEGLIGENT ACTS, ERRORS OR OMISSIONS ON MY PART IN PREPARING THIS REPORT.

NICOLE SCHANEL, PE #52434 NOTE: FIRE FLOW AND PRESSURE VALUES ARE


PROVIDED BY WIDEFIELD DISTRICT ENGINEERING

CONSULTANT BASED ON LATEST WATER MODELING.

ENGINEER'S STATEMENT:

PCD FILE No. SF-21-024

THE LOCATIONS OF EXISTING ABOVE GROUND AND UNDERGROUND UTILITIES ARE SHOWN IN AN APPROXIMATE WAY ONLY. THE CONTRACTOR SHALL DETERMINE THE EXACT LOCATION OF ALL EXISTING UTILITIES BEFORE COMMENCING WORK. THE CONTRACTOR SHALL BE FULLY RESPONSIBLE FOR ANY AND ALL DAMAGES WHICH MIGHT BE CAUSED BY HIS FAILURE TO EXACTLY LOCATE AND PRESERVE ANY AND ALL ABOVE GROUND AND UNDERGROUND UTILITIES.

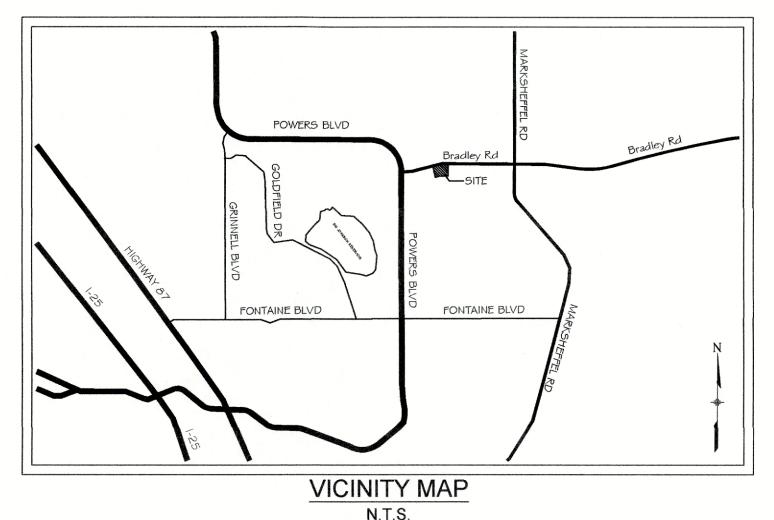

FIRE AUTHORITY APPROVAL

THE NUMBER OF FIRE HYDRANTS AND HYDRANT LOCATIONS SHOWN ON THIS WATER INSTALLATION PLAN ARE CORRECT AND ADEQUATE TO SATISFY THE FIRE PROTECTION REQUIREMENTS AS SPECIFIED BY THE FIRE DISTRICT SERVING THE PROPERTY NOTED ON THE PLANS.

SECURITY FIRE PROTECTION DIST FIRE PROTECTION DISTRICT SIGNED BI FR FIRE PROTECTION DISTRIC

DISTRICT APPROVALS:

THE WIDEFIELD WATER AND SANITATION DISTRICT RECOGNIZES THE DESIGN ENGINEER AS HAVING RESPONSIBILITY FOR THE DESIGN AND HAS LIMITED ITS SCOPE OF REVIEW ACCORDINGLY.

> WIDEFIELD WATER AND SANITATION DISTRICT WATER DESIGN APPROVAL

PROJECT NUMBER:

IN CASE OF ERRORS OR OMISSIONS WITH THE WATER DESIGN AS SHOWN ON THIS DOCUMENT THE STANDARDS AS DEFINED IN THE "RULES AND REGULATIONS FOR INSTALLATION OF WATER MAINS AND SERVICES" SHALL RULE

APPROVAL EXPIRES 180 DAYS FROM DESIGN APPROVAL

WATER AND SANITARY SEWER APPROVAL

ANY CHANGES OR ALTERATIONS AFFECTING THE GRADE, ALIGNMENT, ELEVATION, AND/OR DEPTH OF COVER OF ANY WATER OR SEWER MAINS OR OTHER APPURTENANCE SHOWN ON THIS DRAWING SHALL BE THE RESPONSIBILTY OF THE OWNER/DEVELOPER. THE OWNER/DEVELOPER SHALL BE RESPONSIBLE FOR ALL OPERATION DAMAGES AND DEFECTS IN INSTALLATION AND MATERIAL FOR MAINS AND SERVICES FROM THE DATE OF APPROVAL UNTIL FINAL ACCEPTANCE IS ISSUED.

PRINT NAME TIM BUSCHAR ADDRESS 555 MIDDLE CREEK PARKWAY, SUITE 500

COLORADO SPRINGS, CO 80921

REFERENCE DRAWINGS			S
	No. DATE	DESCRIPTION	BY
		REVISIONS	
	COMPUTER FILE MANAG	EMENT	
		6)\100 Dwg\104 Plan Sets\Construction Plans\Utility Plans\Water Plan\TS01.dwg	



COLORADO SPRINGS UTILITIES (FIMS) MONUMENT F206 A BERNTSEN TOP SECURITY MONUMENT SYSTEM WITH A 3.5-INCH DIAMETER ALUMINUM CAP IN A ROAD BOX, LOCATED ON THE NORTHWEST CORNER OF FONTAINE BOULEVARD AND POWERS BOULEVARD,

ELEVATION - 5897.89' U.S. SURVEY FT

BASIS OF BEARING

BEARINGS ARE BASED ON THE NORTH LINE OF THE NORTHWEST QUARTER OF SECTION 9, TOWNSHIP 15 SOUTH, RANGE 65 WEST OF THE 6TH P.M. SAID LINE BEARS S89°51'23"E FROM THE NORTHWEST CORNER OF SAID SECTION 9 (2 ½" AULM. CAP PLS 17664) TO THE N ¼ CORNER OF SAID SECTION 9 (3 1/2" AULM. CAP PLS 10377)



FILING NO. 4 PUBLIC WATERLINE PLANS

TITLE SHEET

TRAILS AT ASPEN RIDGE

JUNE 2021 DRAWING No. MATRIX DESIGN GROUP, INC. DRAWN BY: 1 OF 12 PROJECT No. 21.886.038 CHECKED BY: NMS

WIDEFIELD WATER AND SANITATION DISTRICT GENERAL NOTES

- 1. ALL UTILITY CONSTRUCTION TO BE CONDUCTED IN CONFORMANCE WITH THE CURRENT WIDEFIELD WATER AND SANITATION DISTRICT SPECIFICATIONS. COMPACTION REQUIREMENTS SHALL BE 95% STANDARD PROCTOR AS DETERMINED BY ASTM D698, UNLESS OTHERWISE APPROVED BY THE WIDEFIELD WATER AND SANITATION DISTRICT OR A HIGHER STANDARD IS IMPOSED BY ANOTHER AGENCY HAVING RIGHT-OF-WAY JURISDICTION.
- 2. ALL MATERIALS AND WORKMANSHIP SHALL BE SUBJECT TO INSPECTION BY THE WIDEFIELD WATER AND SANITATION DISTRICT. THE WIDEFIELD WATER AND SANITATION DISTRICT RESERVES THE RIGHT TO ACCEPT OR REJECT ANY SUCH MATERIALS AND WORKMANSHIP THAT DOES NOT CONFORM TO ITS STANDARDS AND SPECIFICATIONS.
- 3. THE DEVELOPER OR HIS ENGINEER HAS LOCATED ALL FIRE HYDRANTS AND FUTURE SERVICE STUBS. ANY REQUIRED REALIGNMENT, EITHER HORIZONTAL OR VERTICAL, SHALL BE AT THE EXPENSE OF THE DEVELOPER.
- 4. ALL DUCTILE IRON PIPE, TO INCLUDE FITTINGS, VALVES AND FIRE HYDRANTS WILL BE WRAPPED WITH POLYETHYLENE TUBING, AND ELECTRICALLY ISOLATED.
- 5. ALL DUCTILE IRON PIPE AND FITTINGS SHALL BE DOUBLE BONDED. SPECIFICATIONS FOR CATHODIC PROTECTION ON BOTH DIP MAINS AND PVC MAINS IS SPECIFIED IN THE STANDARDS AND SPECIFICATIONS.
- 6. PVC MAIN LINES SHALL BE INSTALLED WITH COATED NO. 12 TRACER WIRE.
- 7. THE CONTRACTOR IS REQUIRED TO NOTIFY THE WIDEFIELD WATER AND SANITATION DISTRICT (390-7111) A MINIMUM OF 48 HOURS AND A MAXIMUM OF 96 HOURS PRIOR TO THE START OF CONSTRUCTION. THE CONTRACTOR SHALL ALSO NOTIFY AFFECTED UTILITY COMPANIES 48 HOURS PRIOR TO CONSTRUCTION ADJACENT TO THE KNOWN UTILITY LINES.
- 8. THE LOCATION OF ALL UTILITIES AS SHOWN ON THESE DRAWINGS ARE APPROXIMATE ONLY. THE LOCATION OF ALL UTILITIES SHALL BE VERIFIED PRIOR TO CONSTRUCTION BY THE CONTRACTOR.
- 9. THE CONTRACTOR SHALL FIELD EXCAVATE AND VERIFY THE VERTICAL AND HORIZONTAL LOCATION OF ALL TIE-INS. CONTRACTOR SHALL NOTIFY THE WIDEFIELD WATER AND SANITATION DISTRICT AND THE ENGINEER OF THE FIELD VERIFIED INFORMATION PRIOR TO CONSTRUCTION.
- 10. ALL BENDS SHALL BE FIELD STAKED PRIOR TO CONSTRUCTION.

ABBREVIATIONS

BOP

BOV

CPLG.

(INS.) (RED.)

(STR.)

CTRB

DEFL

FLG

GPM

GRD BRK

N,S,E,W

PVC

RCP

RED

STA

STS

RSNTS

HYD ASSY

ASSEMBLY

COUPLING

DEFLECT

ELEVATION EXISTING

FLANGE FIRE HYDRANT

MINIMUM

REDUCER

SLIP JOINT

STATION

SANITARY SEWER

STORM SEWER

BOTTOM OF PIPE

(INSULATING)

DUCTILE IRON PIPE

GALLONS PER MINUTE

V.P.I. GRADE BREAK

LEFT OF CENTER LINE

MECHANICAL JOINT

PROPERTY LINE

NORTH, SOUTH, EAST, WEST

POUNDS PER SQUARE INCH

POLYVINYL CHLORIDE PIPE

REINFORCED CONCRETE PIPE

MJ RESTRAINT (i.e. MEGALUG)

RIGHT OF CENTER LINE

(REDUCING)

(STRAIGHT)

BLOWOFF ASSEMBLY AND VALVE

CONCRETE REVERSE ANCHOR

CONCRETE THRUST REACTION BLOCK

INCLUDES FIRE HYDRANT, LATERAL, VALVE,

TIE RODS, AND REVERSE ANCHOR.

- 11. ANY WATER UTILITY MATERIAL REMOVED AND NOT REUSED SHALL BE RETURNED TO THE WIDEFIELD WATER AND SANITATION DISTRICT IF THE DISTRICT SO REQUESTS.
- 12. THE CONTRACTOR SHALL AT HIS EXPENSE SUPPORT AND PROTECT ALL UTILITY MAINS SO THAT THEY WILL FUNCTION CONTINUOUSLY DURING CONSTRUCTION. SHOULD A UTILITY MAIN FAIL AS A RESULT OF THE CONTRACTOR'S OPERATION, IT WILL BE REPLACED IMMEDIATELY BY EITHER THE CONTRACTOR OR THE WIDEFIELD WATER AND SANITATION DISTRICT AT FULL COST OF LABOR AND MATERIALS TO THE CONTRACTOR.
- 13. ANY PUMPING OR BYPASS OPERATIONS MUST BE REVIEWED AND APPROVED PRIOR TO EXECUTION BY BOTH THE WIDEFIELD WATER AND SANITATION DISTRICT AND THE ENGINEER.
- 14. CONTRACTOR MUST REPLACE OR REPAIR ANY DAMAGE TO ALL SURFACE IMPROVEMENTS, INCLUDING BUT NOT LIMITED TO FENCES, CURB AND GUTTER AND/OR ASPHALT THAT MAY BE CAUSED DURING CONSTRUCTION.
- 15. ALL WATER LINES 6" AND LARGER, AND ALL SEWER LINES 8" AND LARGER, SHALL HAVE AS "AS-BUILT" PLANS PREPARED AND APPROVED PRIOR TO FINAL ACCEPTANCE BY THE WIDEFIELD WATER AND SANITATION DISTRICT.
- 16. PRIOR TO CONSTRUCTION, A PRE-CONSTRUCTION CONFERENCE IS REQUIRED A MINIMUM OF 72 HOURS IN ADVANCE OF COMMENCEMENT OF WORK. TO SET THE PRE-CONSTRUCTION CONFERENCE, CONTACT ROB BANNISTER, DISTRICT ENGINEER AT (719) 390-7111 OF THE WIDEFIELD WATER AND SANITATION DISTRICT FOR A TIME. NO PRE-CONSTRUCTION CONFERENCE TIMES WILL BE SET UNTIL 4 SETS OF SIGNED DRAWINGS ARE RECEIVED BY THE WIDEFIELD W & S DISTRICT. PRE-CONSTRUCTION DATE/INITIALS
- 17. DEVELOPER IS RESPONSIBLE FOR INSTALLING WATERLINE THROUGH FRONTSIDE DRIVE NO MORE THAN 18 MONTHS AFTER CONSTRUCTION OF TRAILS AT ASPEN RIDGE FILING 4 TO PROVIDE WATER LOOPING.

LEGEND

VALVE (PROPOSED)

BLOWOFF (PROPOSED)

EXISTING FIRE HYDRANT

PROPOSED FIRE HYDRANT

BLOWOFF (EXISTING)

VALVE (EXISTING)

PLUG (PROPOSED)

PLUG (EXISTING)

PROPERTY LINE

EXISTING WATER

EXISTING GAS MAIN

PROPOSED WATER (8")

PROPOSED WATER (12")

PROPOSED WATER (16")

EXISTING STORM DRAIN

EXISTING SAN. SEWER

PROPOSED SAN. SEWER

EXISTING MANHOLE

PROPOSED STORM DRAIN

CURB LINE


EL PASO COUNTY STANDARD CONSTRUCTION NOTES:

- 1. ALL DRAINAGE AND ROADWAY CONSTRUCTION SHALL MEET THE STANDARDS AND SPECIFICATIONS OF THE CITY OF COLORADO SPRINGS/EL PASO COUNTY DRAINAGE CRITERIA MANUAL, VOLUMES 1 AND 2, AND THE EL PASO COUNTY ENGINEERING CRITERIA MANUAL.
- CONTRACTOR SHALL BE RESPONSIBLE FOR THE NOTIFICATION AND FIELD NOTIFICATION
 OF ALL EXISTING UTILITIES, WHETHER SHOWN ON THE PLANS OR NOT, BEFORE
 BEGINNING CONSTRUCTION. LOCATION OF EXISTING UTILITIES SHALL BE VERIFIED BY
 THE CONTRACTOR PRIOR TO CONSTRUCTION. CALL 811 TO CONTACT THE UTILITY
 NOTIFICATION CENTER OF COLORADO (UNCC).
- CONTRACTOR SHALL KEEP A COPY OF THESE APPROVED PLANS, THE GRADING AND EROSION CONTROL PLAN, THE STORMWATER MANAGEMENT PLAN (SWMP), THE SOILS AND GEOTECHNICAL REPORT, AND THE APPROPRIATE DESIGN AND CONSTRUCTION STANDARDS AND SPECIFICATIONS AT THE JOB SITE AT ALL TIMES, INCLUDING THE FOLLOWING:
- a. EL PASO COUNTY ENGINEERING CRITERIA MANUAL (ECM)
- b. CITY OF COLORADO SPRINGS/EL PASO COUNTY DRAINAGE CRITERIA MANUAL, VOLUMES 1 AND 2
- c. COLORADO DEPARTMENT OF TRANSPORTATION (CDOT) STANDARD SPECIFICATIONS FOR ROAD AND BRIDGE CONSTRUCTION
- d. CDOT M & S STANDARDS
- 4. NOTWITHSTANDING ANYTHING DEPICTED IN THESE PLANS IN WORDS OR GRAPHIC REPRESENTATION, ALL DESIGN AND CONSTRUCTION RELATED TO ROADS, STORM DRAINAGE AND EROSION CONTROL SHALL CONFORM TO THE STANDARDS AND REQUIREMENTS OF THE MOST RECENT VERSION OF THE RELEVANT ADOPTED EL PASO COUNTY STANDARDS, INCLUDING THE LAND DEVELOPMENT CODE, THE ENGINEERING CRITERIA MANUAL, THE DRAINAGE CRITERIA MANUAL, AND THE DRAINAGE CRITERIA MANUAL VOLUME 2. ANY DEVIATIONS FROM REGULATIONS AND STANDARDS MUST BE REQUESTED, AND APPROVED, IN WRITING. ANY MODIFICATIONS NECESSARY TO MEET CRITERIA AFTER-THE-FACT WILL BE ENTIRELY THE DEVELOPER'S RESPONSIBILITY TO
- 5. IT IS THE DESIGN ENGINEER'S RESPONSIBILITY TO ACCURATELY SHOW EXISTING CONDITIONS, BOTH ONSITE AND OFFSITE, ON THE CONSTRUCTION PLANS. ANY MODIFICATIONS NECESSARY DUE TO CONFLICTS, OMISSIONS, OR CHANGED CONDITIONS WILL BE ENTIRELY THE DEVELOPER'S RESPONSIBILITY TO RECTIFY.
- 6. CONTRACTOR SHALL SCHEDULE A PRE-CONSTRUCTION MEETING WITH EL PASO COUNTY PLANNING AND COMMUNITY DEVELOPMENT (PCD) INSPECTIONS, PRIOR TO STARTING CONSTRUCTION.
- 7. IT IS THE CONTRACTOR'S RESPONSIBILITY TO UNDERSTAND THE REQUIREMENTS OF ALL JURISDICTIONAL AGENCIES AND TO OBTAIN ALL REQUIRED PERMITS, INCLUDING BUT NOT LIMITED TO EL PASO COUNTY EROSION AND STORMWATER QUALITY CONTROL PERMIT (ESQCP), REGIONAL BUILDING FLOODPLAIN DEVELOPMENT PERMIT, U.S. ARMY CORPS OF ENGINEERS-ISSUED 401 AND/OR 404 PERMITS, AND COUNTY AND STATE FUGITIVE DUST PERMITS.
- CONTRACTOR SHALL NOT DEVIATE FROM THE PLANS WITHOUT FIRST OBTAINING WRITTEN APPROVAL FROM THE DESIGN ENGINEER AND PCD. CONTRACTOR SHALL NOTIFY THE DESIGN ENGINEER IMMEDIATELY UPON DISCOVERY OF ANY ERRORS OR INCONSISTENCIES.
- 9. ALL STORM DRAIN PIPE SHALL BE CLASS III RCP UNLESS OTHERWISE NOTED AND APPROVED BY PCD.
- 10. CONTRACTOR SHALL COORDINATE GEOTECHNICAL TESTING PER ECM STANDARDS. PAVEMENT DESIGN SHALL BE APPROVED BY EL PASO COUNTY PCD PRIOR TO PLACEMENT OF CURB AND GUTTER AND PAVEMENT.
- 11. ALL CONSTRUCTION TRAFFIC MUST ENTER/EXIT THE SITE AT APPROVED CONSTRUCTION ACCESS POINTS.
- 12. SIGHT VISIBILITY TRIANGLES AS IDENTIFIED IN THE PLANS SHALL BE PROVIDED AT ALL INTERSECTIONS. OBSTRUCTIONS GREATER THAN 18 INCHES ABOVE FLOWLINE ARE NOT ALLOWED WITHIN SIGHT TRIANGLES.
- 13. SIGNING AND STRIPING SHALL COMPLY WITH EL PASO COUNTY DOT AND MUTCD CRITERIA. [IF APPLICABLE, ADDITIONAL SIGNING AND STRIPING NOTES WILL BE PROVIDED.]
- 14. CONTRACTOR SHALL OBTAIN ANY PERMITS REQUIRED BY EL PASO COUNTY DOT, INCLUDING WORK WITHIN THE RIGHT-OF-WAY AND SPECIAL TRANSPORT PERMITS.
- 15. THE LIMITS OF CONSTRUCTION SHALL REMAIN WITHIN THE PROPERTY LINE UNLESS OTHERWISE NOTED. THE OWNER/DEVELOPER SHALL OBTAIN WRITTEN PERMISSION AND EASEMENTS, WHERE REQUIRED, FROM ADJOINING PROPERTY OWNER(S) PRIOR TO ANY OFF-SITE DISTURBANCE, GRADING, OR CONSTRUCTION.

TRAILS AT ASPEN RIDGE WT01 TRAILS AT ASPEN RIDGE FUTURE FILINGS TRAILS AT ASPEN RIDGE FILING NO. 2 TRAILS AT ASPEN RIDGE FILING NO. 3

SHEET No.

Know what's below.
Call before you dig.

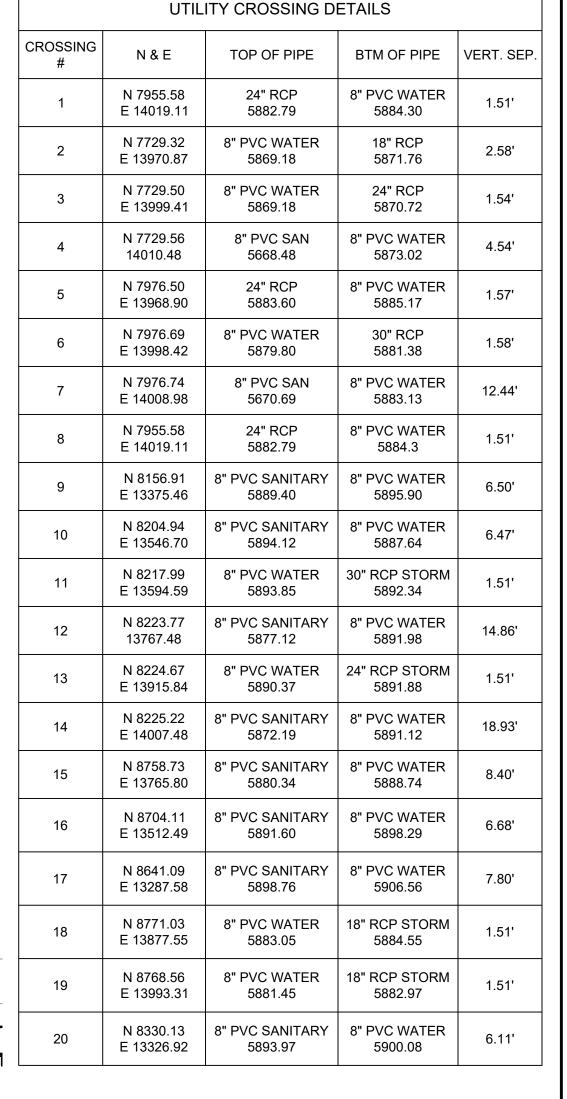

OVERALL LAYOUT AND SHEET INDEX

SCALE: 1" = 100'

THE WIDEFIELD WATER AND SANITATION DISTRICT RECOGNIZES THE DESIGN ENGINEER AS HAVING RESPONSIBILITY FOR THE DESIGN AND HAS LIMITED ITS SCOPE OF REVIEW ACCORDINGLY.

WIDEFIELD WATER AND SANITATION DISTRICT
WATER DESIGN APPROVAL

DATE: ___


PROJECT NUMBER:

IN CASE OF ERRORS OR OMISSIONS WITH THE WATER DESIGN AS SHOWN ON THIS DOCUMENT THE STANDARDS AS DEFINED IN THE "RULES AND REGULATIONS FOR INSTALLATION OF WATER MAINS AND SERVICES" SHALL RULE.

APPROVAL EXPIRES 180 DAYS FROM DESIGN APPROVAL

TYP TYP	P OF PIPE PICAL ATER LINE		PROPOSED MANHOLE MATCHLINE		
REFERENCE DRAWINGS				S	SHEET
DRAWINGS				N	
					\ } -
	1	10/14/2022	SHORTENED WATER SERVICES TO PROPERTY LINE	CVW	
	No.	DATE	DESCRIPTION	BY	i
			REVISIONS		
	COM	PUTER FIL	LE MANAGEMENT		
	CTB FI	<pre>/ F· Matrix(b</pre>	6.038 (trails f6)\100 Dwg\104 plan sets\construction plans\utility plans\water plan\GN01.dwg lack).ctb 4, 2023 1:24:44 PM		
	THIS DRA	WING IS CURRENT	AS OF PLOT DATE AND MAY BE SUBJECT TO CHANGE.		

E-W 8

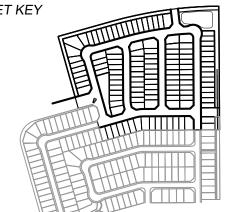

BENCHMARK

COLORADO SPRINGS UTILITIES (FIMS) MONUMENT F206
A BERNTSEN TOP SECURITY MONUMENT SYSTEM WITH A 3.5-INCH DIAMETER ALUMINUM CAP IN A ROAD BOX, LOCATED ON THE NORTHWEST CORNER OF FONTAINE BOULEVARD AND POWERS BOULEVARD.

ELEVATION - 5897.89' U.S. SURVEY FT

BASIS OF BEARING

BEARINGS ARE BASED ON THE NORTH LINE OF THE NORTHWEST QUARTER OF SECTION 9, TOWNSHIP 15 SOUTH, RANGE 65 WEST OF THE 6TH P.M. SAID LINE BEARS S89°51'23"E FROM THE NORTHWEST CORNER OF SAID SECTION 9 (2 ½" AULM. CAP PLS 17664) TO THE N ¼ CORNER OF SAID SECTION 9 (3 ¼" AULM. CAP PLS 10377)





TRAILS AT ASPEN RIDGE

FILING NO. 4
PUBLIC WATERLINE PLANS


SF-21-02


GENERAL NOTES, LEGEND, ABBREVIATIONS, & SHEET INDEX

FOR AND ON BEHALF OF MATRIX DESIGN GROUP, INC. PROJECT No. 21.886.038


DESIGNED BY: JSE SCALE DATE ISSUED: JUNE 2022 DRAWING No. HORIZ. N/A SHEET 2 OF 12

CHECKED BY: NMS VERT N/A SHEET 2 OF 12

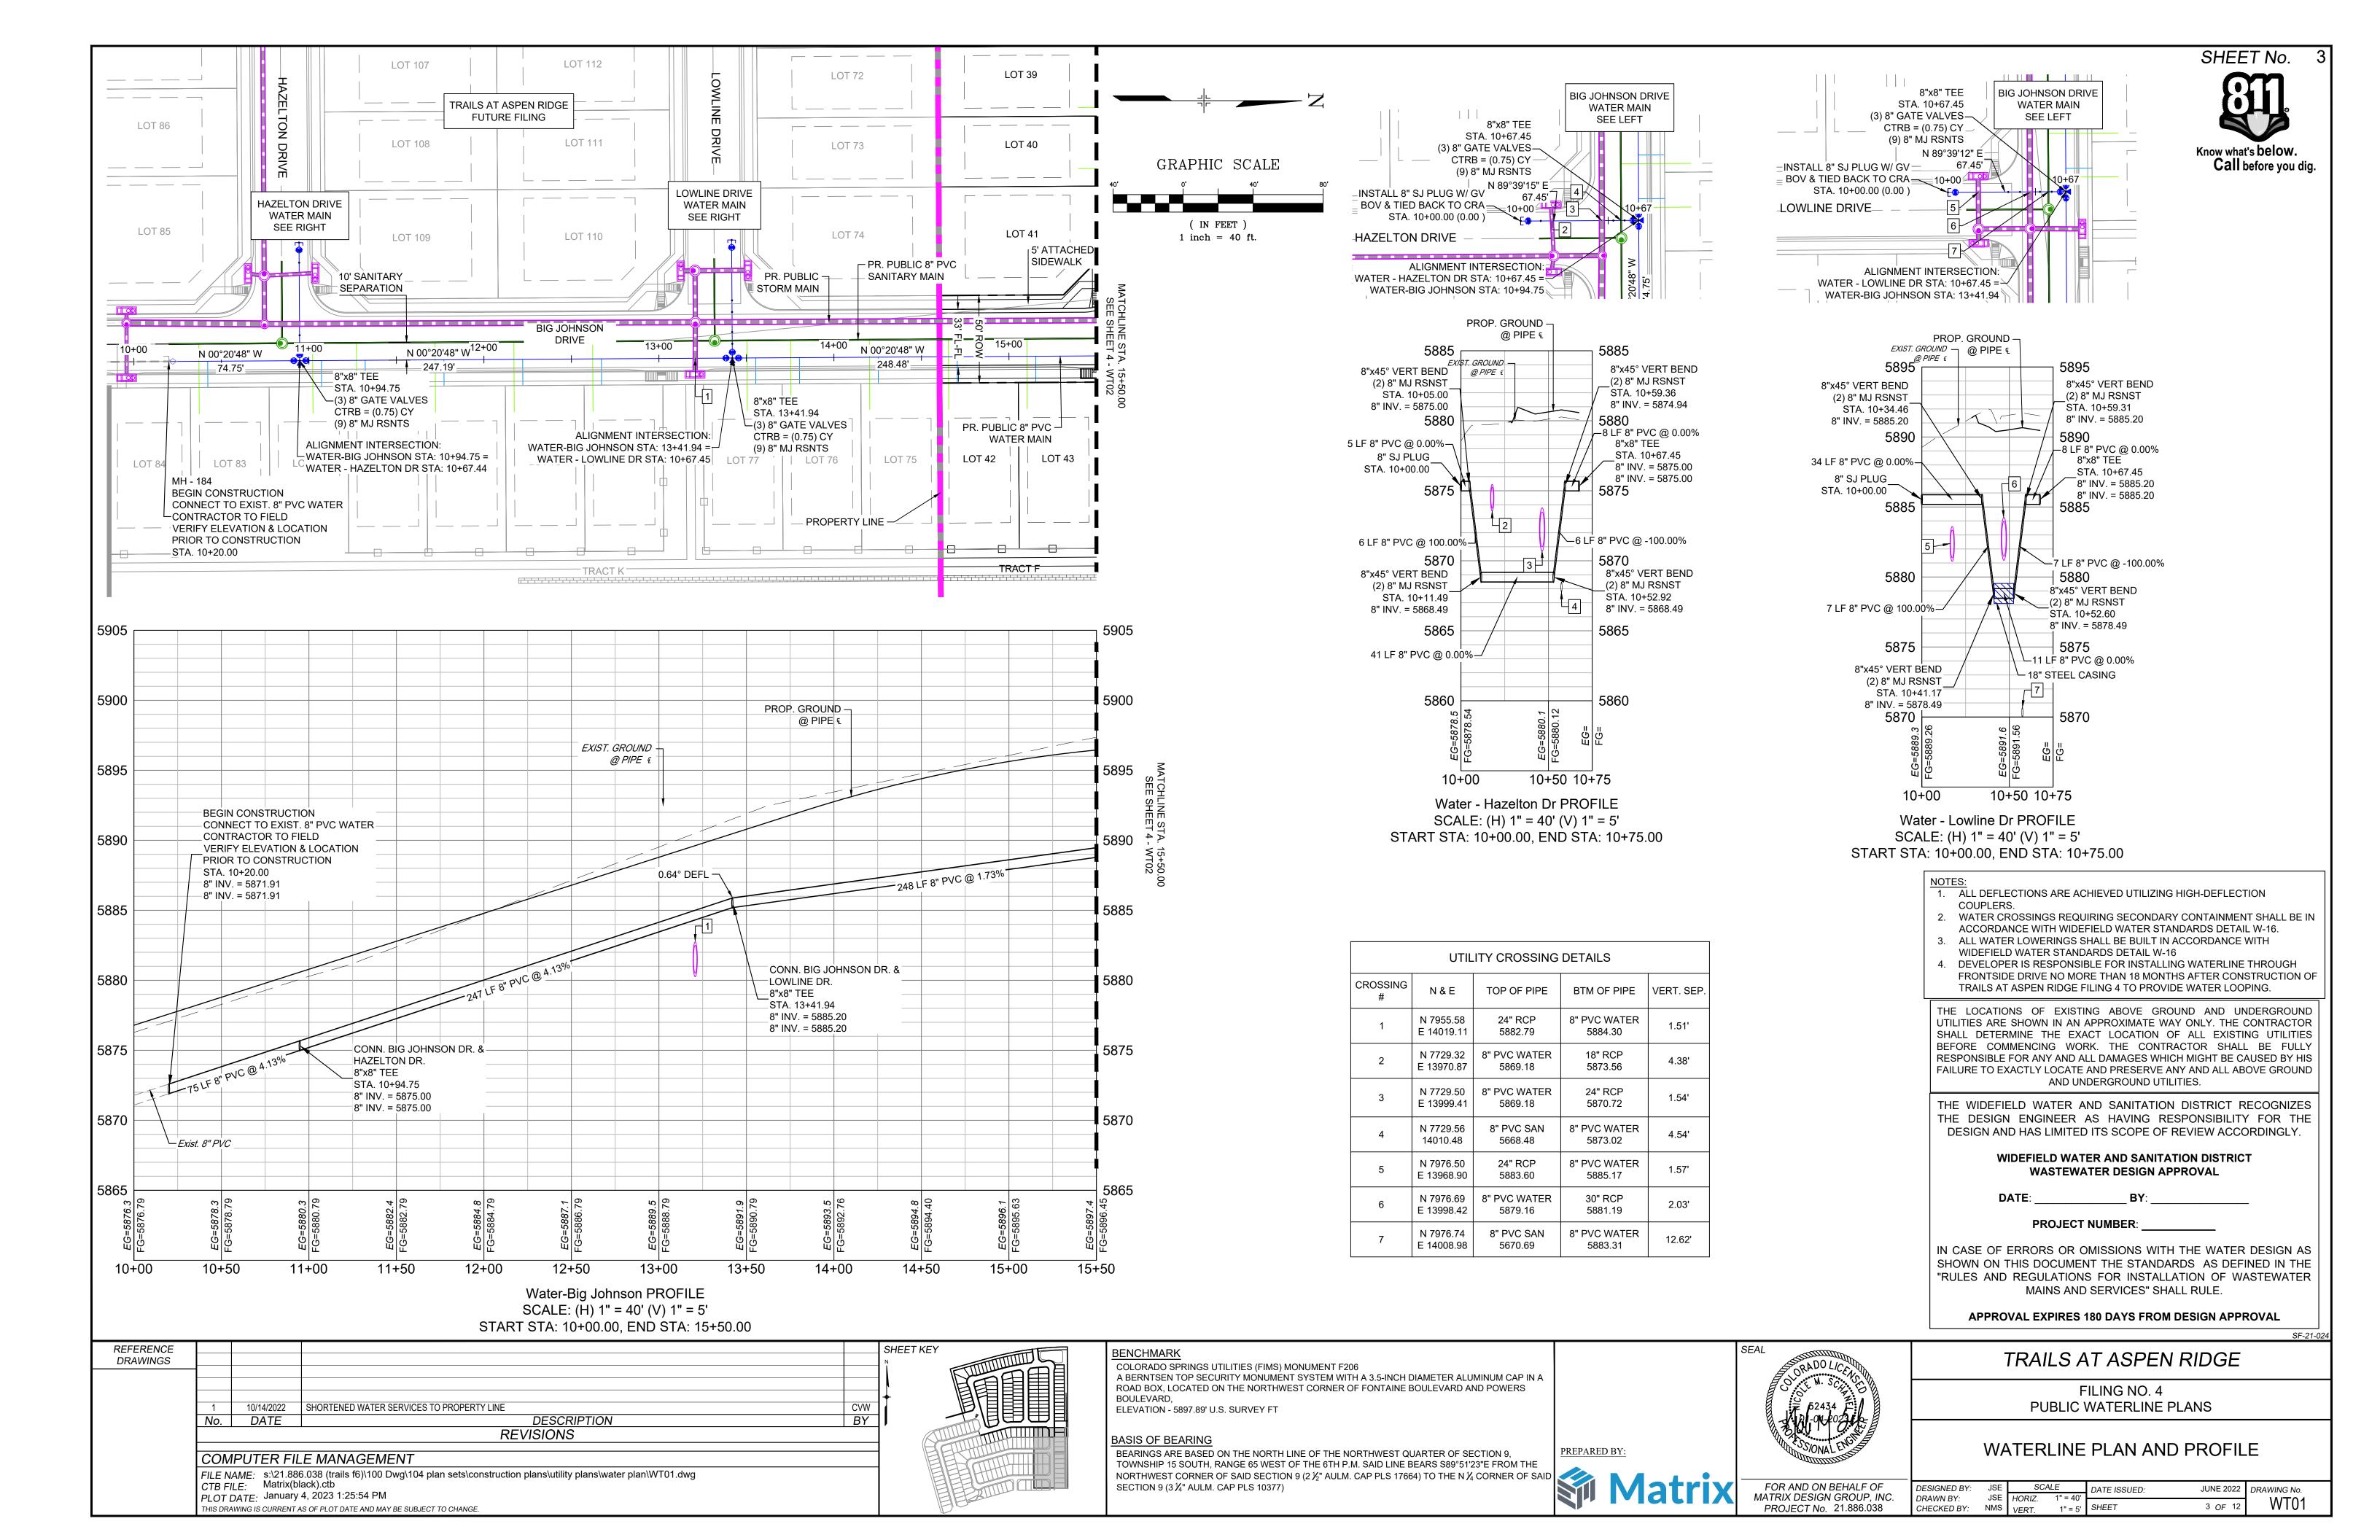

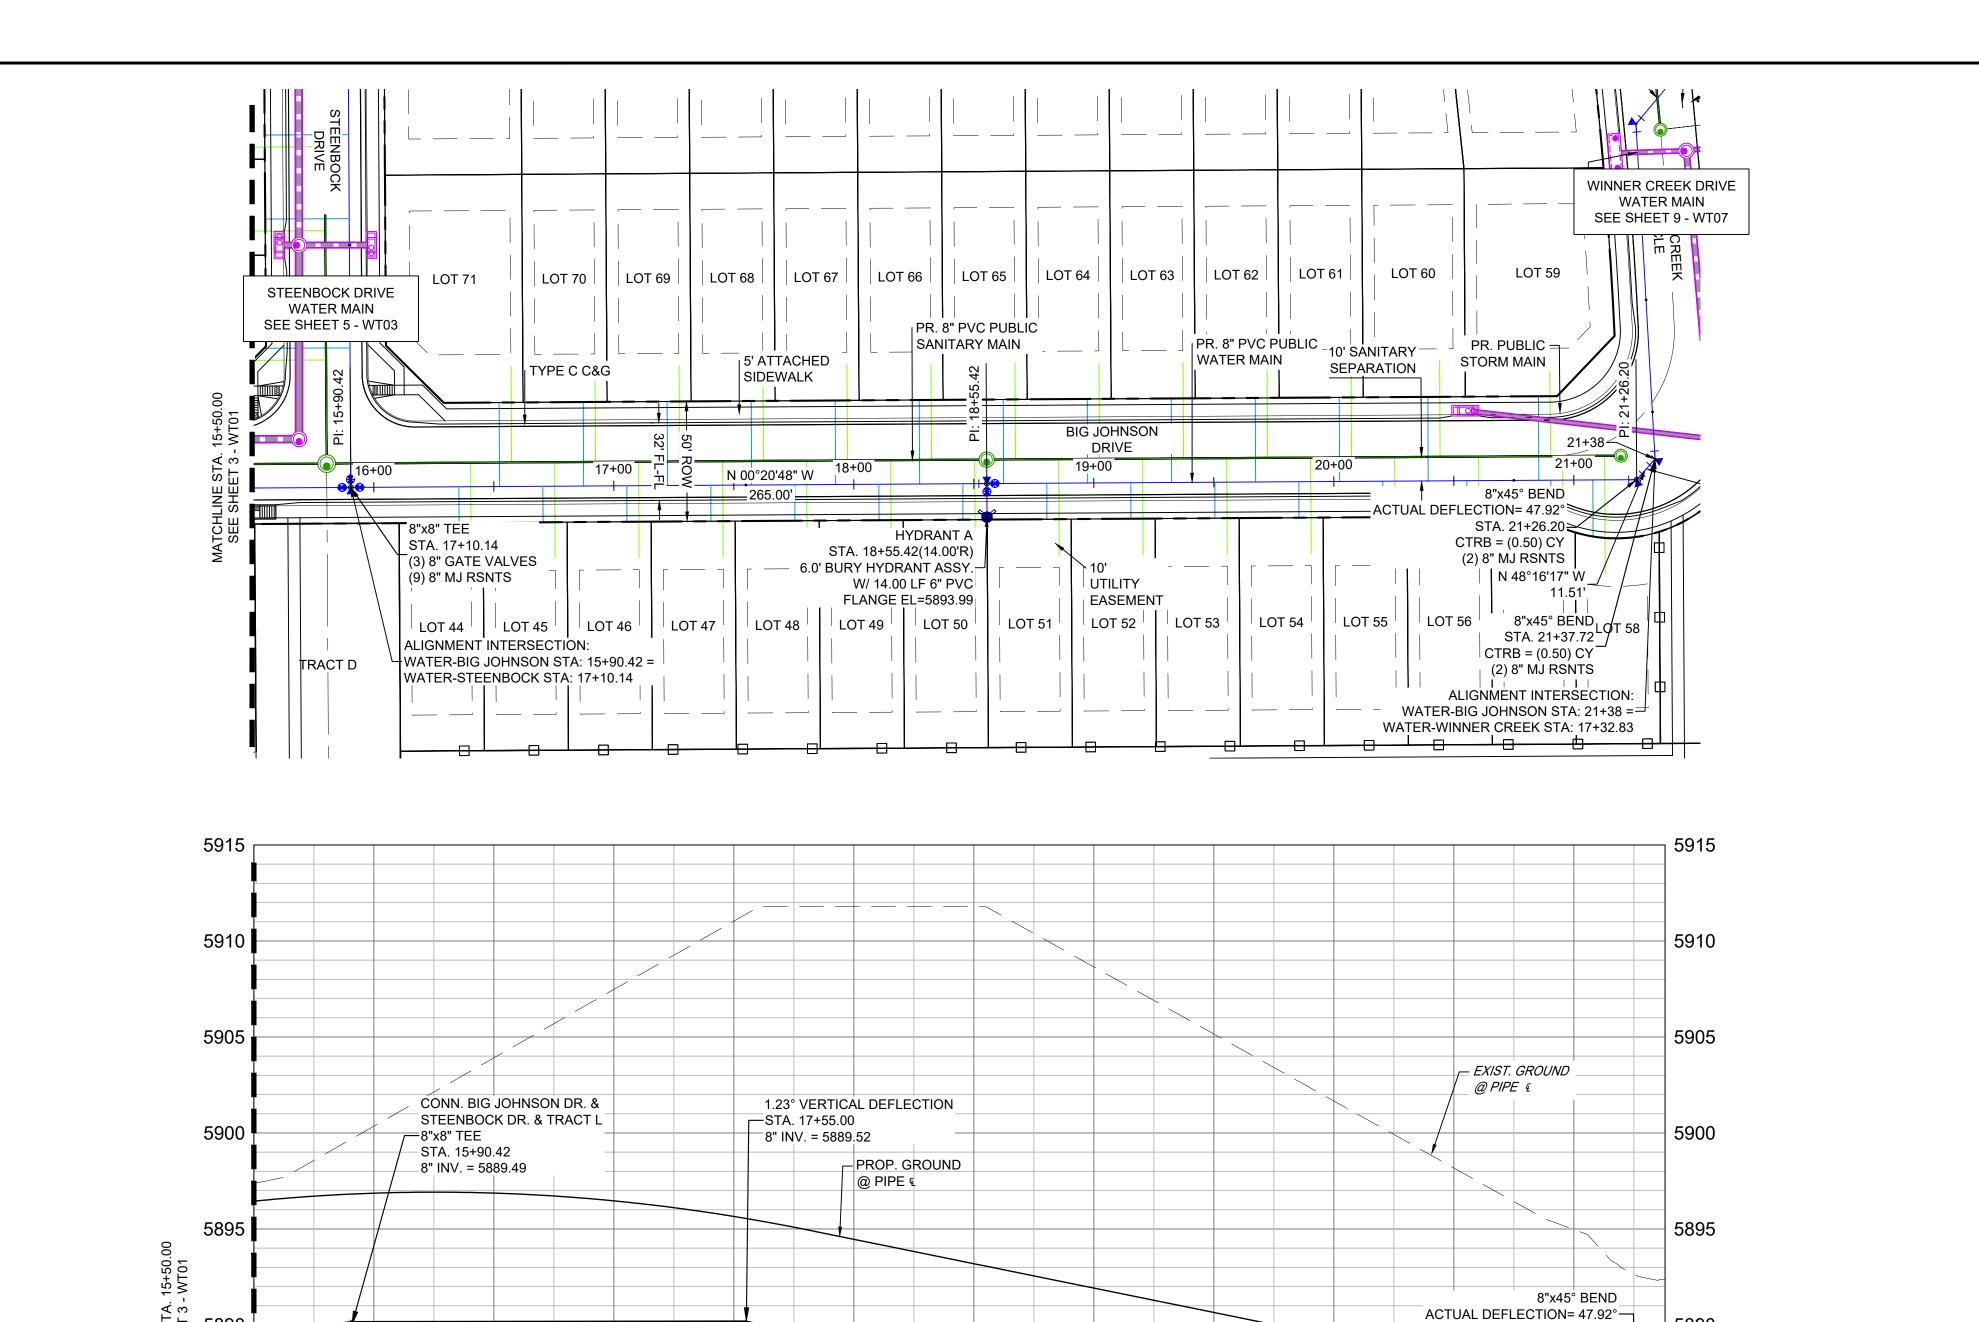



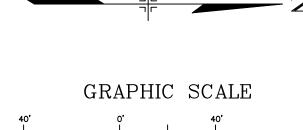

(IN FEET)

1 inch = 40 ft.

1. ALL DEFLECTIONS ARE ACHIEVED UTILIZING HIGH-DEFLECTION

COUPLERS.

- 2. WATER CROSSINGS REQUIRING SECONDARY CONTAINMENT SHALL BE IN ACCORDANCE WITH WIDEFIELD WATER STANDARDS DETAIL W-16.
- 3. ALL WATER LOWERINGS SHALL BE BUILT IN ACCORDANCE WITH
- WIDEFIELD WATER STANDARDS DETAIL W-16 4. DEVELOPER IS RESPONSIBLE FOR INSTALLING WATERLINE THROUGH

FRONTSIDE DRIVE NO MORE THAN 18 MONTHS AFTER CONSTRUCTION OF TRAILS AT ASPEN RIDGE FILING 4 TO PROVIDE WATER LOOPING. THE LOCATIONS OF EXISTING ABOVE GROUND AND UNDERGROUND

UTILITIES ARE SHOWN IN AN APPROXIMATE WAY ONLY. THE CONTRACTOR SHALL DETERMINE THE EXACT LOCATION OF ALL EXISTING UTILITIES BEFORE COMMENCING WORK. THE CONTRACTOR SHALL BE FULLY RESPONSIBLE FOR ANY AND ALL DAMAGES WHICH MIGHT BE CAUSED BY HIS FAILURE TO EXACTLY LOCATE AND PRESERVE ANY AND ALL ABOVE GROUND AND UNDERGROUND UTILITIES.

THE WIDEFIELD WATER AND SANITATION DISTRICT RECOGNIZES THE DESIGN ENGINEER AS HAVING RESPONSIBILITY FOR THE DESIGN AND HAS LIMITED ITS SCOPE OF REVIEW ACCORDINGLY.

> WIDEFIELD WATER AND SANITATION DISTRICT WASTEWATER DESIGN APPROVAL

PROJECT NUMBER:

IN CASE OF ERRORS OR OMISSIONS WITH THE WATER DESIGN AS SHOWN ON THIS DOCUMENT THE STANDARDS AS DEFINED IN THE "RULES AND REGULATIONS FOR INSTALLATION OF WASTEWATER MAINS AND SERVICES" SHALL RULE.

APPROVAL EXPIRES 180 DAYS FROM DESIGN APPROVAL

REFERENCE SHEET KEY DRAWINGS 10/14/2022 SHORTENED WATER SERVICES TO PROPERTY LINE CVW No. DATE BY DESCRIPTION REVISIONS COMPUTER FILE MANAGEMENT FILE NAME: s:\21.886.038 (trails f6)\100 Dwg\104 plan sets\construction plans\utility plans\water plan\WT01.dwg CTB FILE: Matrix(black).ctb PLOT DATE: January 4, 2023 1:26:02 PM THIS DRAWING IS CURRENT AS OF PLOT DATE AND MAY BE SUBJECT TO CHANGE.

17+00

17+50

18+00

18+50

Water-Big Johnson PROFILE

SCALE: (H) 1" = 40' (V) 1" = 5' START STA: 15+50.00, END STA: 21+38.00

19+00

165 LF 8" PVC @ 0.02%

─ 1.04° DEFL

16+00

5880

15+50

-248 LF 8" PVC @ 1.73%

16+50

20+00

VERTICAL DEFLECTION

-220 LF 8" PVC @ -2.74%

19+50

STA. 20+75.00—

8" INV. = 5880.75

COLORADO SPRINGS UTILITIES (FIMS) MONUMENT F206 A BERNTSEN TOP SECURITY MONUMENT SYSTEM WITH A 3.5-INCH DIAMETER ALUMINUM CAP IN A ROAD BOX, LOCATED ON THE NORTHWEST CORNER OF FONTAINE BOULEVARD AND POWERS

21+38

5890

5885

5880

STA. 21+26.20

51 LF 8" PVC @ 0.00%

21+00

BASIS OF BEARING

20+50

PREPARED BY:



FOR AND ON BEHALF OF MATRIX DESIGN GROUP, INC. PROJECT No. 21.886.038


TRAILS AT ASPEN RIDGE

FILING NO. 4 PUBLIC WATERLINE PLANS


WATERLINE PLAN AND PROFILE


SCALE DATE ISSUED: DESIGNED BY: JUNE 2022 DRAWING No.
 DRAWN BY:
 JSE
 HORIZ.
 1" = 40'


 CHECKED BY:
 NMS
 VERT.
 1" = 5'
 SHEET
 4 OF 12

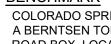

BOULEVARD, ELEVATION - 5897.89' U.S. SURVEY FT

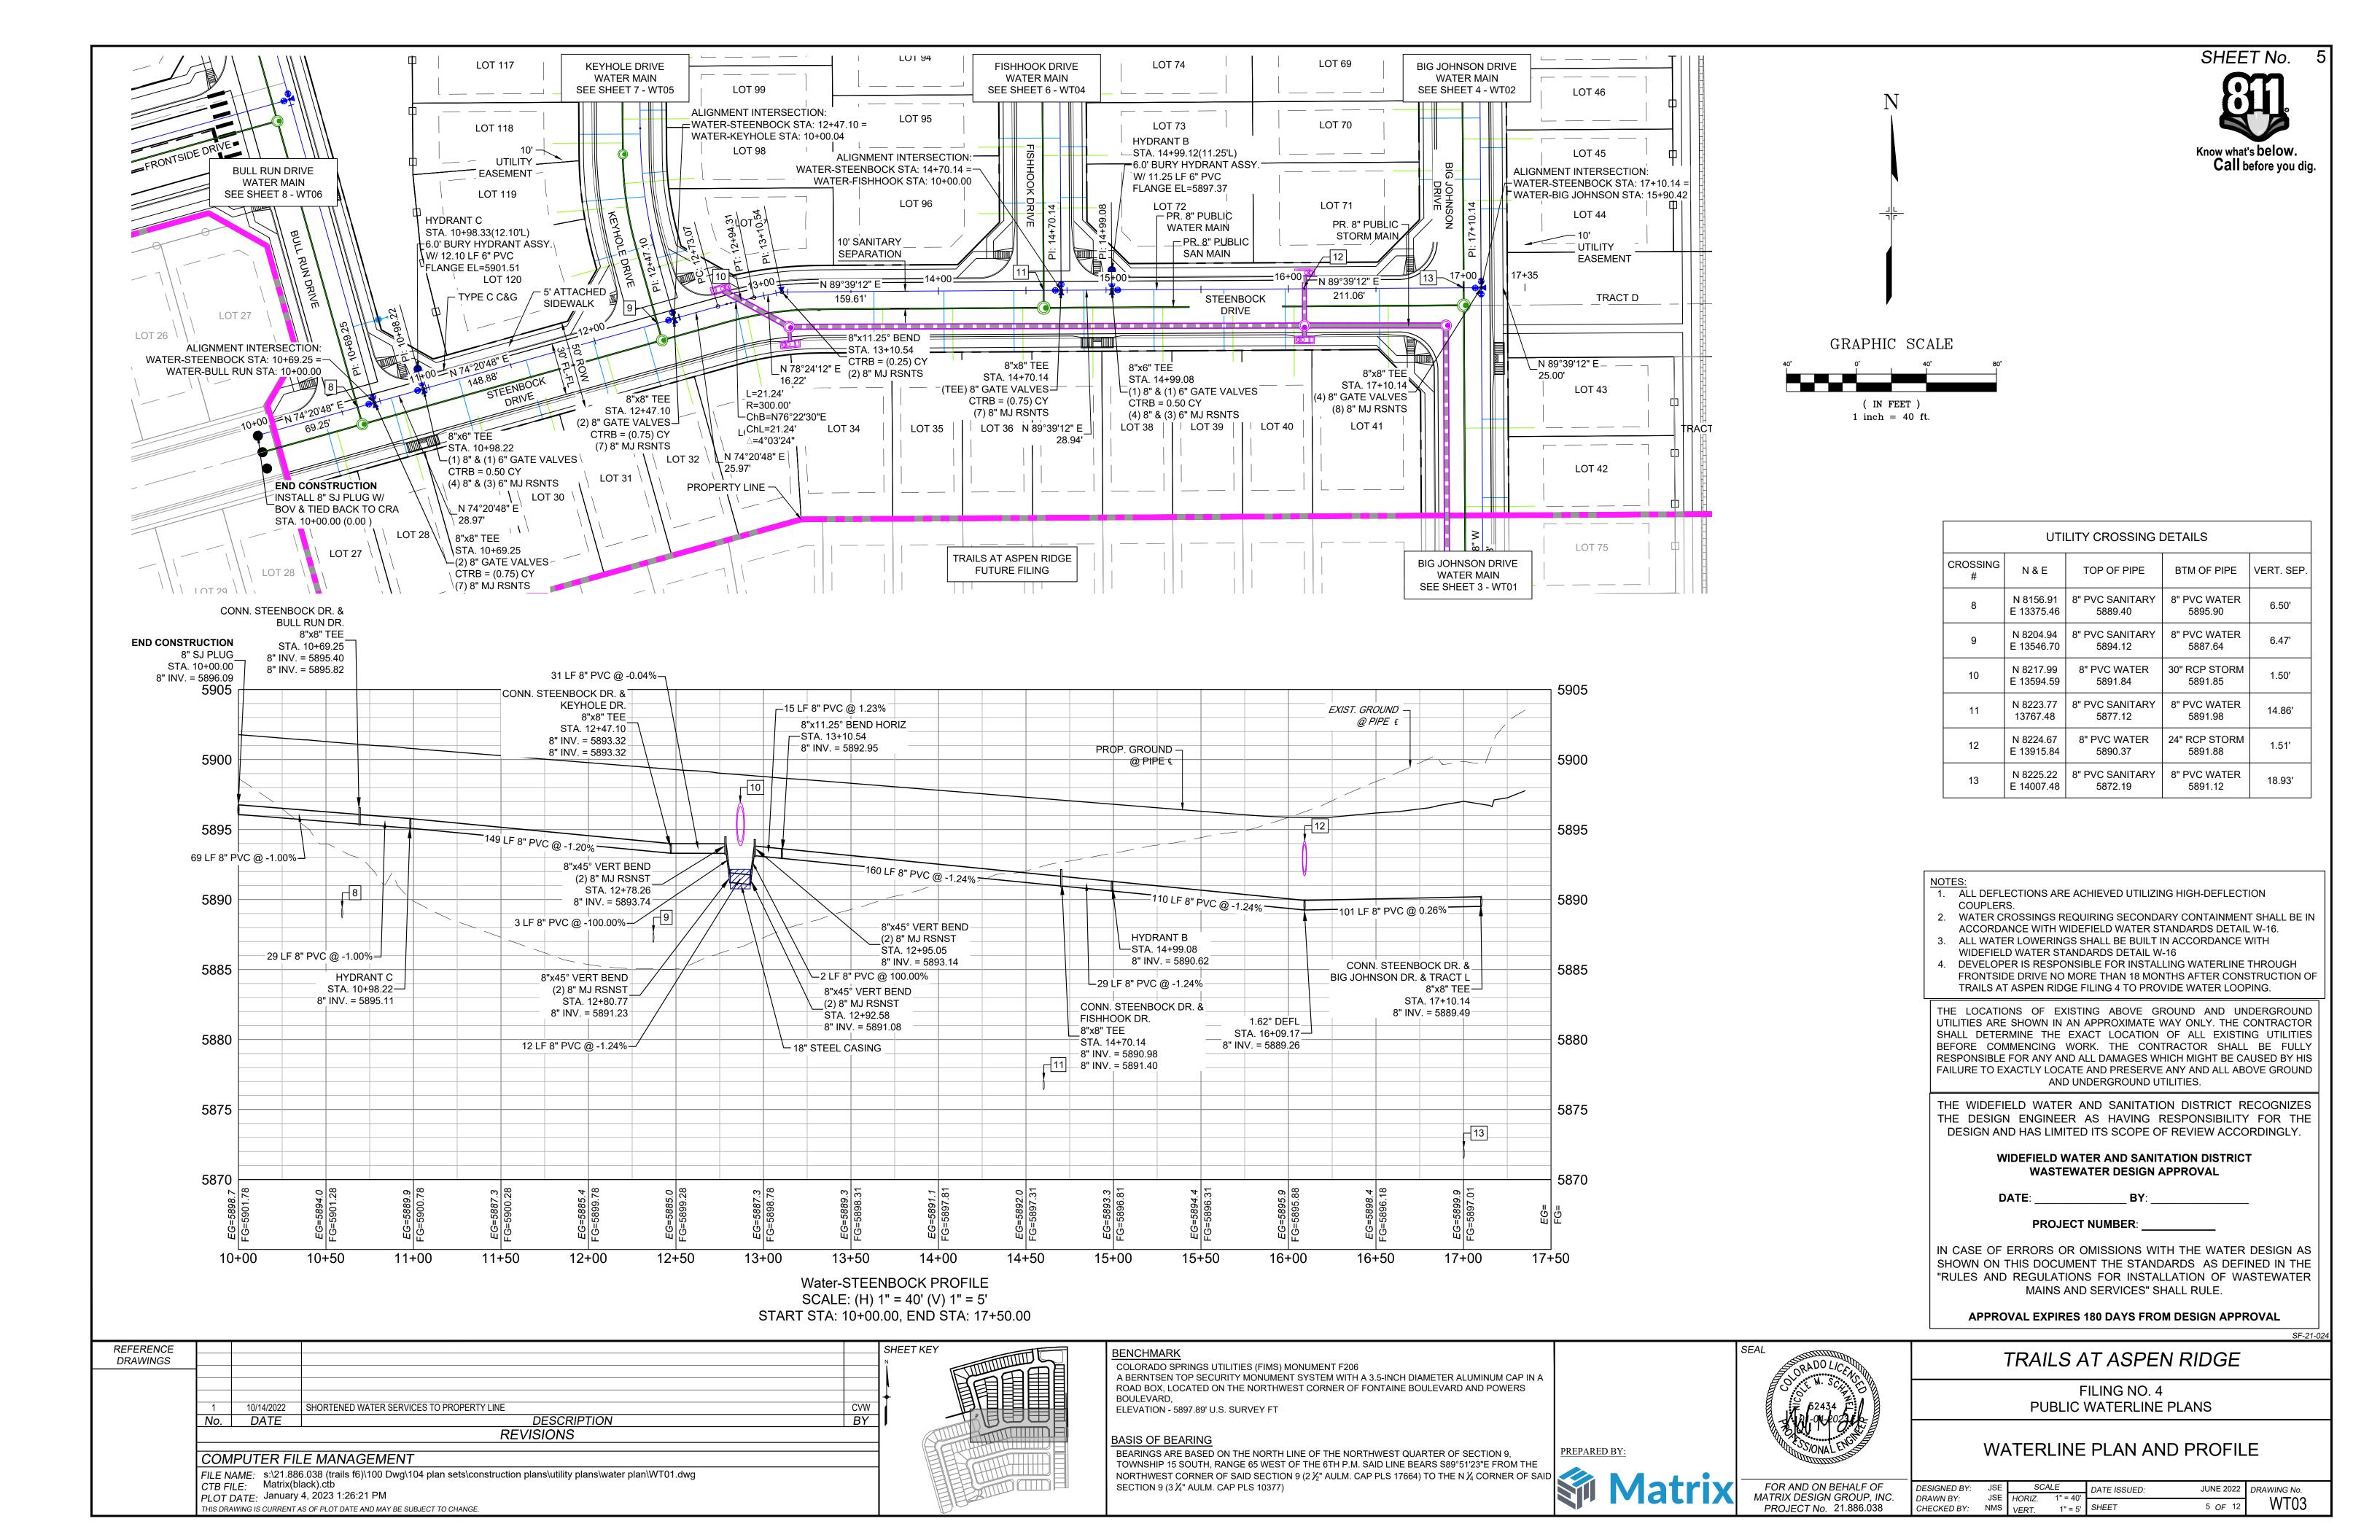

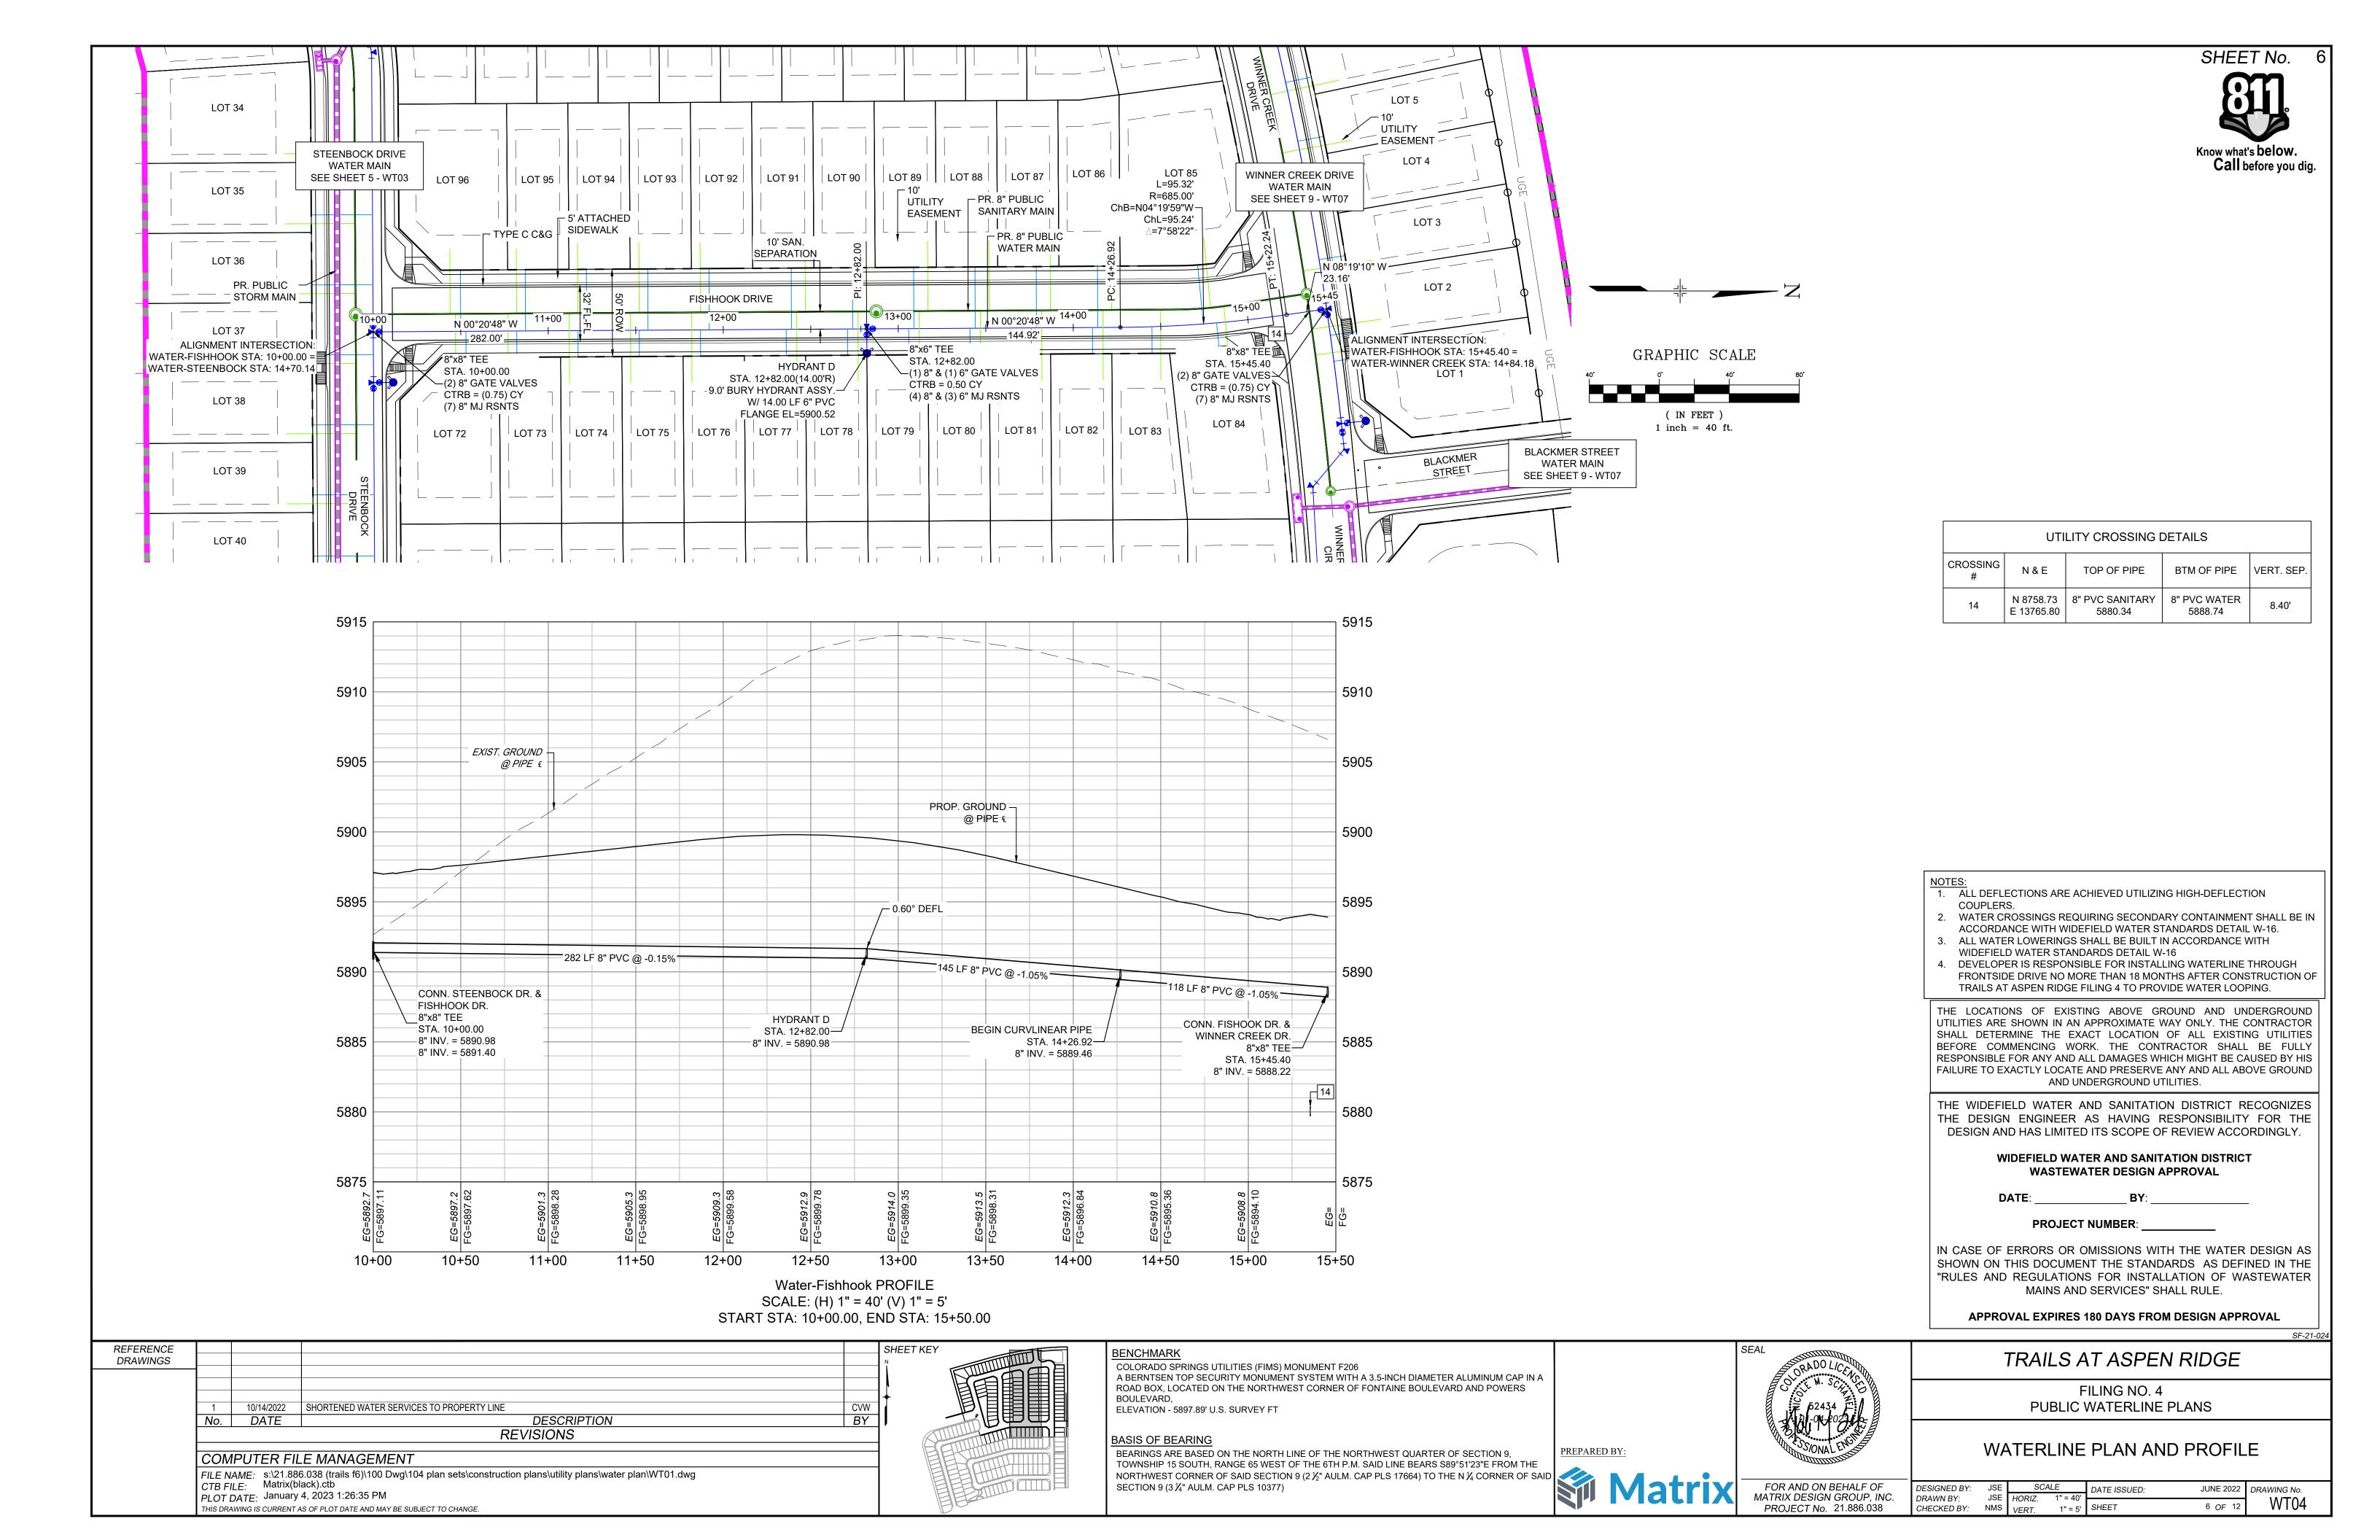

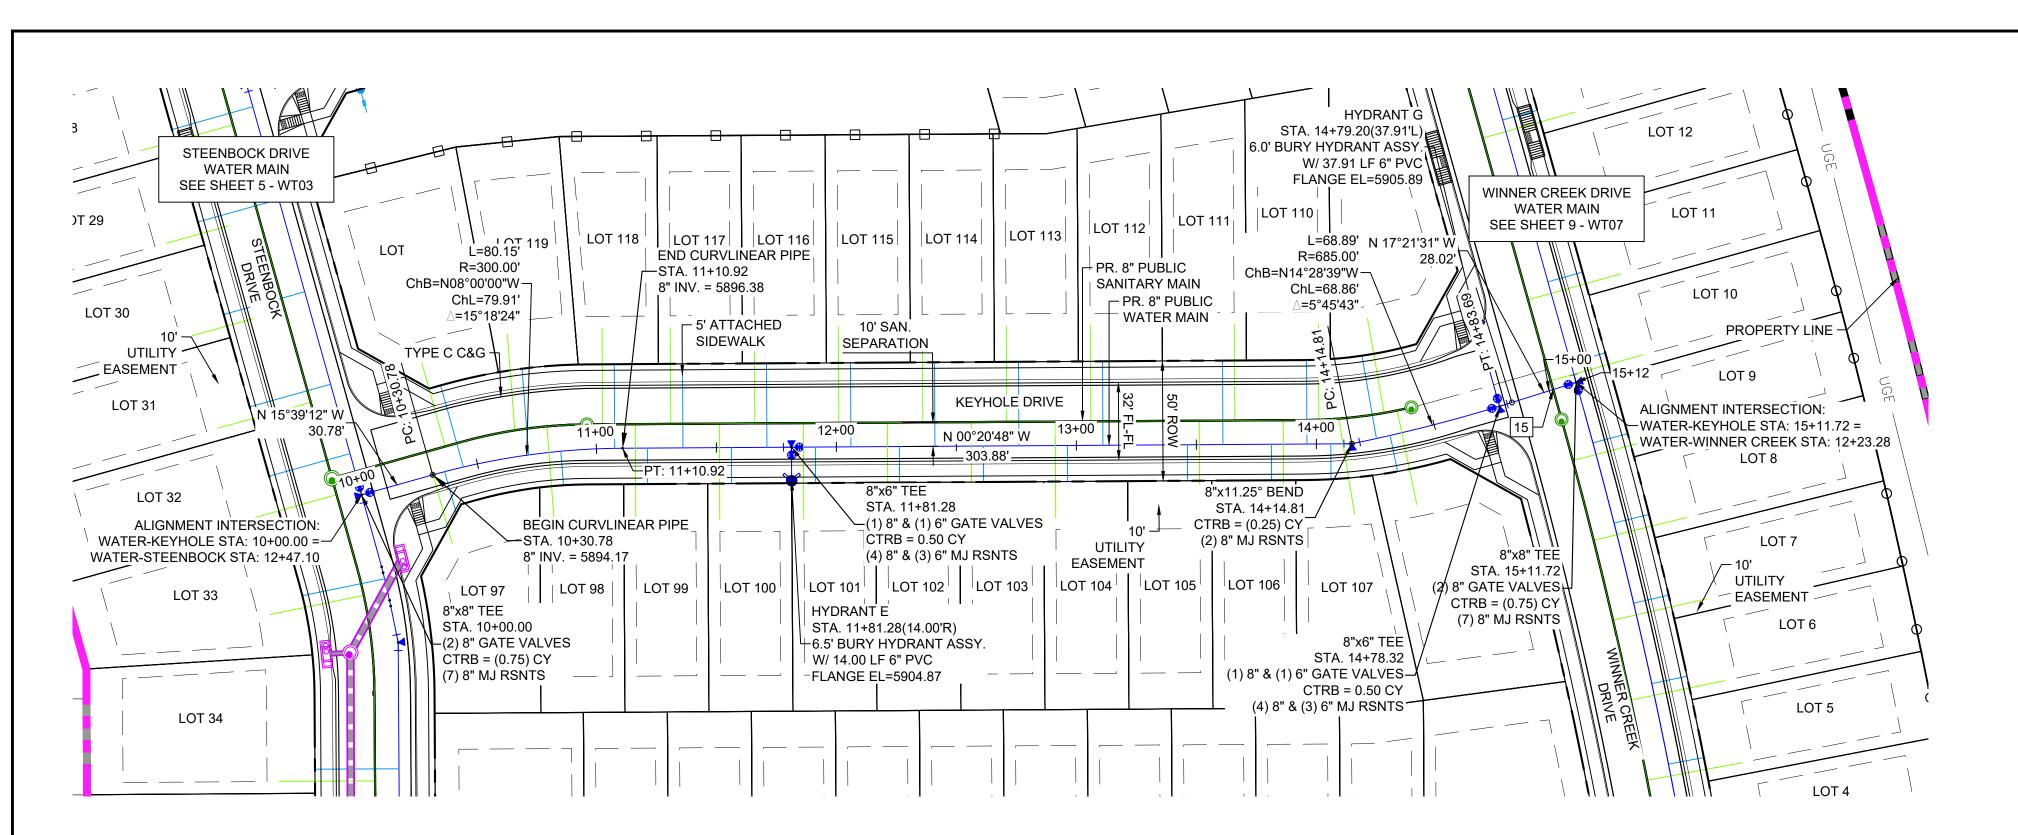

PROP. GROUND -

12+50

Water-Keyhole PROFILE

SCALE: (H) 1" = 40' (V) 1" = 5' START STA: 10+00.00, END STA: 15+25.00

@ PIPE &

=234 LF 8" PVC @ 0.00%=

13+00

8"x11.25° BEND -

8" INV. = 5898.31

13+50

STA. 14+14.81—

-HYDRANT E

STA. 11+81.28

END CURVLINEAR PIPE

STA. 11+10.92

└-80 LF 8" PVC @ 2.75% >


11+00


8" INV. = 5896.38

8" INV. = 5898.31

12+00

└─70 LF 8" PVC @ 2.75% ¯

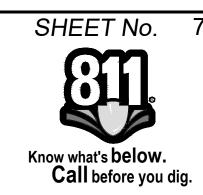

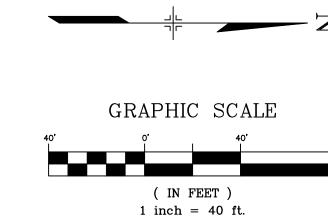

UTILITY CROSSING DETAILS					
CROSSING #	N & E	TOP OF PIPE	BTM OF PIPE	VERT. SEP.	
15	N 8704.11 E 13512.49	8" PVC SANITARY 5891.60	8" PVC WATER 5898.29	6.68'	

1. ALL DEFLECTIONS ARE ACHIEVED UTILIZING HIGH-DEFLECTION COUPLERS.

- 2. WATER CROSSINGS REQUIRING SECONDARY CONTAINMENT SHALL BE IN
- ACCORDANCE WITH WIDEFIELD WATER STANDARDS DETAIL W-16. 3. ALL WATER LOWERINGS SHALL BE BUILT IN ACCORDANCE WITH
- WIDEFIELD WATER STANDARDS DETAIL W-16
- 4. DEVELOPER IS RESPONSIBLE FOR INSTALLING WATERLINE THROUGH FRONTSIDE DRIVE NO MORE THAN 18 MONTHS AFTER CONSTRUCTION OF TRAILS AT ASPEN RIDGE FILING 4 TO PROVIDE WATER LOOPING.

THE LOCATIONS OF EXISTING ABOVE GROUND AND UNDERGROUND

UTILITIES ARE SHOWN IN AN APPROXIMATE WAY ONLY. THE CONTRACTOR SHALL DETERMINE THE EXACT LOCATION OF ALL EXISTING UTILITIES BEFORE COMMENCING WORK. THE CONTRACTOR SHALL BE FULLY RESPONSIBLE FOR ANY AND ALL DAMAGES WHICH MIGHT BE CAUSED BY HIS FAILURE TO EXACTLY LOCATE AND PRESERVE ANY AND ALL ABOVE GROUND AND UNDERGROUND UTILITIES.

THE WIDEFIELD WATER AND SANITATION DISTRICT RECOGNIZES THE DESIGN ENGINEER AS HAVING RESPONSIBILITY FOR THE DESIGN AND HAS LIMITED ITS SCOPE OF REVIEW ACCORDINGLY.

WIDEFIELD WATER AND SANITATION DISTRICT WASTEWATER DESIGN APPROVAL

PROJECT NUMBER:

IN CASE OF ERRORS OR OMISSIONS WITH THE WATER DESIGN AS SHOWN ON THIS DOCUMENT THE STANDARDS AS DEFINED IN THE "RULES AND REGULATIONS FOR INSTALLATION OF WASTEWATER MAINS AND SERVICES" SHALL RULE.

APPROVAL EXPIRES 180 DAYS FROM DESIGN APPROVAL

TRAILS AT ASPEN RIDGE

FILING NO. 4

PUBLIC WATERLINE PLANS

REFERENCE					SHEET KEY
DRAWINGS					N TOTAL TOTA
	1				
	4	10/11/10000	CHORTENED WATER CERVICES TO PROPERTY LINE	C) ////	
	1	10/14/2022		CVW	
	No.	DATE	DESCRIPTION	BY	
	COM				
	FILE NA				
	CTB FI				
	PLOT D	DATE: January	4, 2023 1:26:49 PM		
			AS OF PLOT DATE AND MAY BE SUBJECT TO CHANGE.		E E

11+50

BEGIN CURVLINEAR PIPE

─STA. 10+30.78

──31 LF 8" PVC @ 2.75%

10+50

10+00

CONN. KEYHOLE DR. & 5900

STEENBOCK DR.

8" INV. = 5893.32

8" INV. = 5893.32

8"x8" TEE

STA. 15+75.52

8" INV. = 5894.17

BEARINGS ARE BASED ON THE NORTH LINE OF THE NORTHWEST QUARTER OF SECTION 9, BEARINGS ARE BASED ON THE NORTH LINE TOWNSHIP 15 SOUTH, RANGE 65 WEST OF THE 6TH P.M. SAID LINE BEARS S89 51 23 E FIXOM THE NORTHWEST CORNER OF SAID SECTION 9 (2 ½" AULM. CAP PLS 17664) TO THE N ¼ CORNER OF SAID SECTION 9 (3 ¼" AULM. CAP PLS 10377)

5920

5915

5910

5905

5900

5895

5890

15+00 15+25

EXIST. GROUND -@ PIPE &

64 LF 8" PVC @ 0.00%—

14+00

HYDRANT G_

STA. 14+78.32—

─33 LF 8" PVC @ 0.00% ☐

14+50

8" INV. = 5898.31

CONN. KEYHOLE DR &

WINNER CREEK DR.

8"x8" TEE-

STA. 12+23.28-

8" INV. = 5898.31_




FOR AND ON BEHALF OF


PROJECT No. 21.886.038


WATERLINE PLAN AND PROFILE


DESIGNED BY: SCALE DATE ISSUED: JUNE 2022 DRAWING No.
 DRAWN BY:
 JSE
 HORIZ.
 1" = 40'


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 1" = 5'
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 MATRIX DESIGN GROUP, INC. WT05 7 OF 12

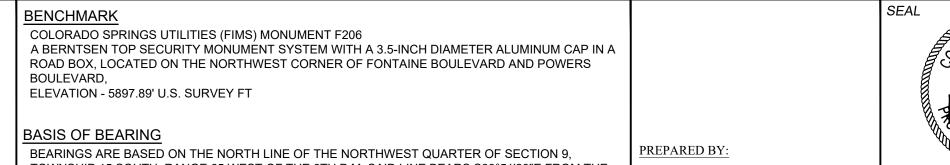

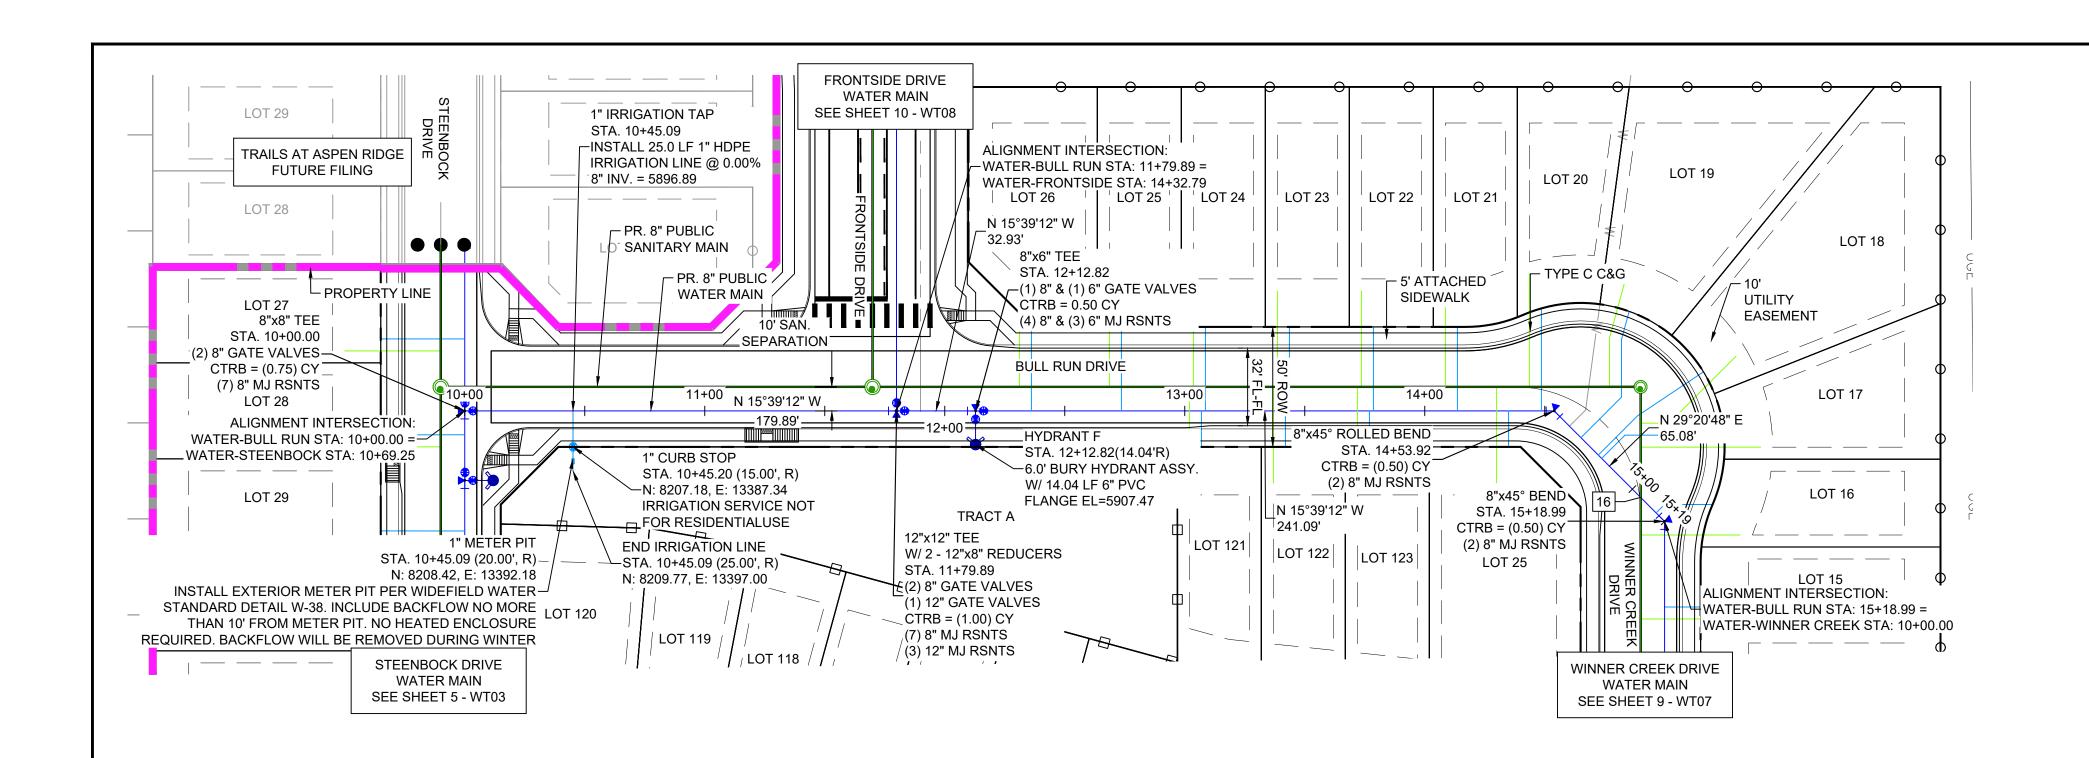


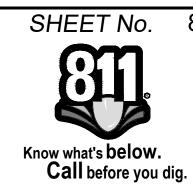

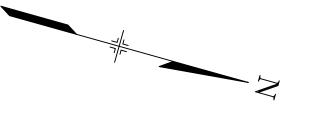

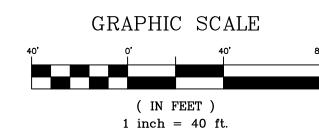

UTILITY CROSSING DETAILS				
CROSSING #	N & E	TOP OF PIPE	BTM OF PIPE	VERT. SEP.
16	N 8641.09 E 13287.58	8" PVC SANITARY 5898.76	8" PVC WATER 5906.56	7.80'

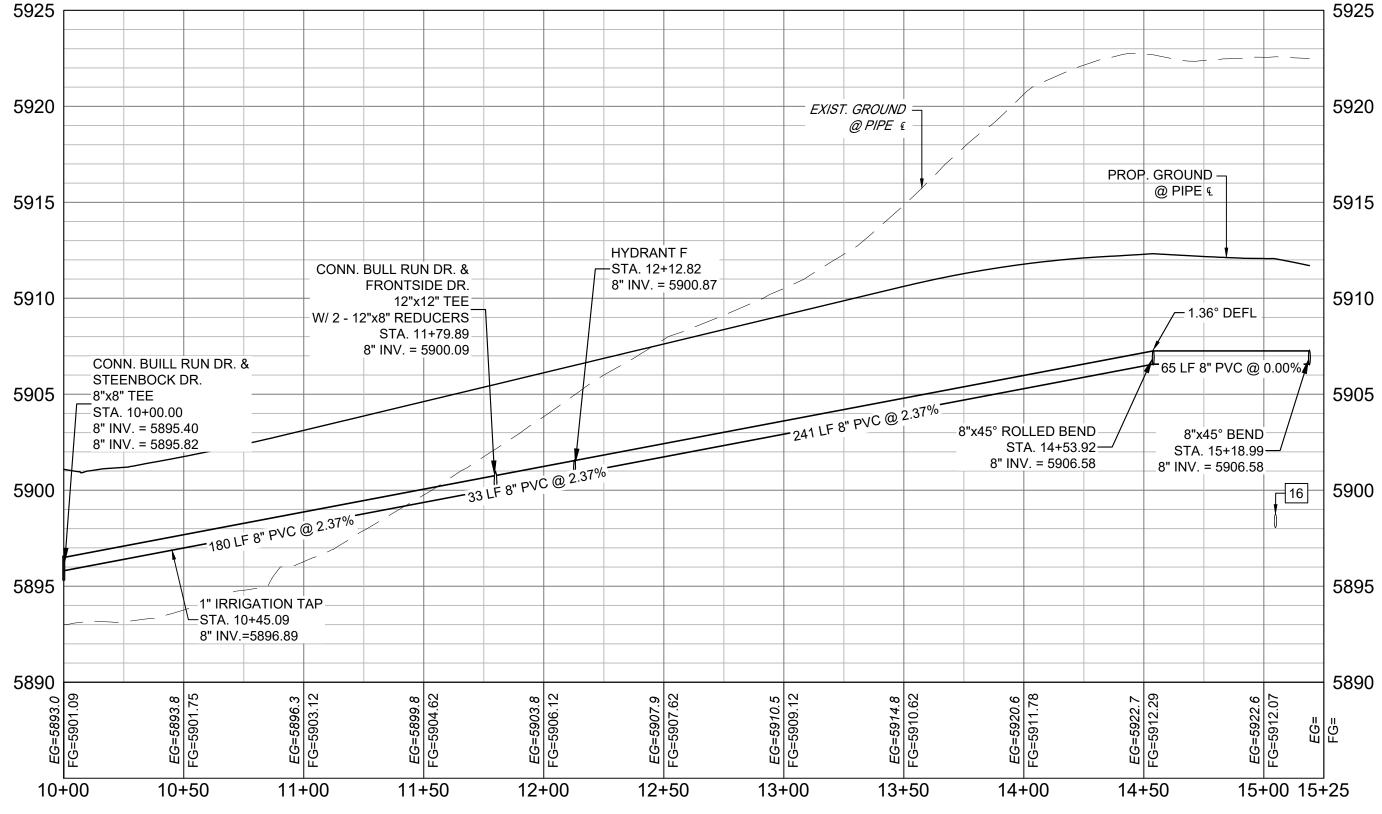

Water-Bull Run PROFILE SCALE: (H) 1" = 40' (V) 1" = 5' START STA: 10+00.00, END STA: 15+25.00

1. ALL DEFLECTIONS ARE ACHIEVED UTILIZING HIGH-DEFLECTION

COUPLERS.

2. WATER CROSSINGS REQUIRING SECONDARY CONTAINMENT SHALL BE IN ACCORDANCE WITH WIDEFIELD WATER STANDARDS DETAIL W-16.

3. ALL WATER LOWERINGS SHALL BE BUILT IN ACCORDANCE WITH WIDEFIELD WATER STANDARDS DETAIL W-16

4. DEVELOPER IS RESPONSIBLE FOR INSTALLING WATERLINE THROUGH

FRONTSIDE DRIVE NO MORE THAN 18 MONTHS AFTER CONSTRUCTION OF TRAILS AT ASPEN RIDGE FILING 4 TO PROVIDE WATER LOOPING.

THE LOCATIONS OF EXISTING ABOVE GROUND AND UNDERGROUND UTILITIES ARE SHOWN IN AN APPROXIMATE WAY ONLY. THE CONTRACTOR SHALL DETERMINE THE EXACT LOCATION OF ALL EXISTING UTILITIES BEFORE COMMENCING WORK. THE CONTRACTOR SHALL BE FULLY RESPONSIBLE FOR ANY AND ALL DAMAGES WHICH MIGHT BE CAUSED BY HIS FAILURE TO EXACTLY LOCATE AND PRESERVE ANY AND ALL ABOVE GROUND AND UNDERGROUND UTILITIES.

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> **WIDEFIELD WATER AND SANITATION DISTRICT** WASTEWATER DESIGN APPROVAL

PROJECT NUMBER:

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APPROVAL EXPIRES 180 DAYS FROM DESIGN APPROVAL

TRAILS AT ASPEN RIDGE

FILING NO. 4

PUBLIC WATERLINE PLANS

REFERENCE					SHEET KEY		$\overline{\exists}$
DRAWINGS	_				l N		≓l
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	1	10/14/2022	SHORTENED WATER SERVICES TO PROPERTY LINE	CVW	11		∄
	No.	DATE	DESCRIPTION	BY] J		ᆀ
			REVISIONS				4
	COMPUTER FILE MANAGEMENT						3
	FILE NAME: s:\21.886.038 (trails f6)\100 Dwg\104 plan sets\construction plans\utility plans\water plan\WT01.dwg CTB FILE: Matrix(black).ctb						
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			AS OF PLOT DATE AND MAY BE SUBJECT TO CHANGE.		1	de	

COLORADO SPRINGS UTILITIES (FIMS) MONUMENT F206 A BERNTSEN TOP SECURITY MONUMENT SYSTEM WITH A 3.5-INCH DIAMETER ALUMINUM CAP IN A ROAD BOX, LOCATED ON THE NORTHWEST CORNER OF FONTAINE BOULEVARD AND POWERS BOULEVARD,

ELEVATION - 5897.89' U.S. SURVEY FT

BASIS OF BEARING

PREPARED BY: BEARINGS ARE BASED ON THE NORTH LINE OF THE NORTHWEST QUARTER OF SECTION 9, BEARINGS ARE BASED ON THE NORTH LINE TOWNSHIP 15 SOUTH, RANGE 65 WEST OF THE 6TH P.M. SAID LINE BEARS S89 51 23 E FIXOM THE NORTHWEST CORNER OF SAID SECTION 9 (2 ½" AULM. CAP PLS 17664) TO THE N ¼ CORNER OF SAID SECTION 9 (3 ¼" AULM. CAP PLS 10377)



FOR AND ON BEHALF OF

PROJECT No. 21.886.038

WATERLINE PLAN AND PROFILE

JSE SCALE DATE ISSUED: DESIGNED BY: JUNE 2022 DRAWING No. MATRIX DESIGN GROUP, INC. JSE HORIZ. 1" = 40' DRAWN BY: WT06 CHECKED BY: NMS VFRT 1" = 5' SHEET 8 OF 12

