# TRAILS AT ASPEN RIDGE - FILING NO. 4

SHEET No.

DWG No. SHEET NAME SHEET No. TITLE SHEET GENERAL NOTES, LEGEND, ABBREVIATIONS, & SHEET INDEX GN01 WATERLINE PLAN AND PROFILE 3 - 10 11 - 12 WATERLINE SERVICE PLAN

OWNER/DEVELOPER COLA, LLC

555 MIDDLE CREEK PARKWAY, SUITE 380

COLORADO SPRINGS, CO 80921

CIVIL ENGINEER MATRIX DESIGN GROUP

2435 RESEARCH PARKWAY, SUITE 300

COLORADO SPRINGS, CO 80920

WATER & SANITARY SEWER WIDEFIELD WATER AND SANITATION DISTRICT

> 8495 FONTAINE BOULEVARD COLORADO SPRINGS, CO 80925 ROBERT BANNISTER, (719) 390-7111

**ELECTRIC** MOUNTAIN VIEW ELECTRIC ASSOCIATION

(719) 495-2283

**COLORADO SPRINGS UTILITIES** 

1521 HANCOCK EXPRESSWAY COLORADO SPRINGS, CO MARY HOAGLUND (719) 668-4083

STREET EL PASO COUNTY PUBLIC SERVICES DEPARTMENT

(719) 520-6460

**DRAINAGE** EL PASO COUNTY PUBLIC SERVICES DEPARTMENT

(719) 520-6460

FIRE DEPARTMENT SECURITY FIRE DEPARTMENT

> 400 SECURITY BOULEVARD SECURITY, CO 80911 (719) 392-7121

#### **ENGINEER'S STATEMENT:**

THIS GRADING AND EROSION CONTROL PLAN WAS PREPARED UNDER MY DIRECTION AND SUPERVISION AND IS CORRECT TO THE BEST OF MY KNOWLEDGE AND BELIEF. SAID PLAN HAS BEEN PREPARED ACCORDING TO THE CRITERIA ESTABLISHED BY THE COUNTY FOR GRADING AND EROSION CONTROL PLANS. I ACCEPT RESPONSIBILITY FOR ANY LIABILITY CAUSED BY ANY NEGLIGENT ACTS, ERRORS OR OMISSIONS ON MY PART IN PREPARING THIS REPORT

NICOLE SCHANEL, PE #52434

DATE

#### EL PASO COUNTY:

COUNTY PLAN REVIEW IS PROVIDED ONLY FOR GENERAL CONFORMANCE WITH COUNTY DESIGN CRITERIA. THE COUNTY IS NOT RESPONSIBLE FOR THE ACCURACY AND ADEQUACY OF THE DESIGN, DIMENSIONS, AND/ OR ELEVATIONS WHICH SHALL BE CONFIRMED AT THE JOB SITE. THE COUNTY THROUGH THE APPROVAL OF THIS DOCUMENT ASSUMES NO RESPONSIBILITY FOR COMPLETENESS AND/ OR ACCURACY OF THIS DOCUMENT.

FILED IN ACCORDANCE WITH THE REQUIREMENTS OF THE EL PASO COUNTY LAND DEVELOPMENT CODE, DRAINAGE CRITERIA MANUAL, VOLUMES 1 AND 2, AND ENGINEERING CRITERIA MANUAL AS AMENDED.

IN ACCORDANCE WITH ECM SECTION 1.12, THESE CONSTRUCTION DOCUMENTS WILL BE VALID FOR CONSTRUCTION FOR A PERIOD OF 2 YEARS FROM THE DATE SIGNED BY THE EL PASO COUNTY ENGINEER. IF CONSTRUCTION HAS NOT STARTED WITHIN THOSE 2 YEARS, THE PLANS WILL NEED TO BE RESUBMITTED FOR APPROVAL, INCLUDING PAYMENT OF REVIEW FEES AT THE PLANNING AND COMMUNITY DEVELOPMENT DIRECTORS DISCRETION.

JENNIFER IRVINE, P.E. DATE COUNTY ENGINEER / ECM ADMINISTRATOR

# EL PASO COUNTY, COLORADO

# **PUBLIC WATERLINE PLANS**

DECEMBER 2021



# SITE MAP 1" = 200'

NODE	(GPM)	PSI @ MDD
Α	2219.65	26.5
В	2218.71	26.8
С	2216.06	25.3
D	2217.82	24.6
E	2217.00	23.1
F	2215.31	24.5
G	2216.26	24.5
Н	2217.93	29.0

FIRE FLOW | DOLO MADE


NOTE: FIRE FLOW AND PRESSURE VALUES ARE PROVIDED BY WIDEFIELD DISTRICT ENGINEERING CONSULTANT BASED ON LATEST WATER MODELING.

#### **OWNER'S STATEMENT:**

I, THE OWNER/DEVELOPER HAVE READ AND COMPLY WITH THE REQUIREMENTS OF THE GRADING AND EROSION CONTROL PLAN.

TIM BUSCHAR DATE DIRECTOR OF LAND ACQUISITION AND DEVELOPMENT

> THE LOCATIONS OF EXISTING ABOVE GROUND AND UNDERGROUND UTILITIES ARE SHOWN IN AN APPROXIMATE WAY ONLY. THE CONTRACTOR SHALL DETERMINE THE EXACT LOCATION OF ALL EXISTING UTILITIES BEFORE COMMENCING WORK. THE CONTRACTOR SHALL BE FULLY RESPONSIBLE FOR ANY AND ALL DAMAGES WHICH MIGHT BE CAUSED BY HIS FAILURE TO EXACTLY LOCATE AND PRESERVE ANY AND ALL ABOVE GROUND AND UNDERGROUND UTILITIES.

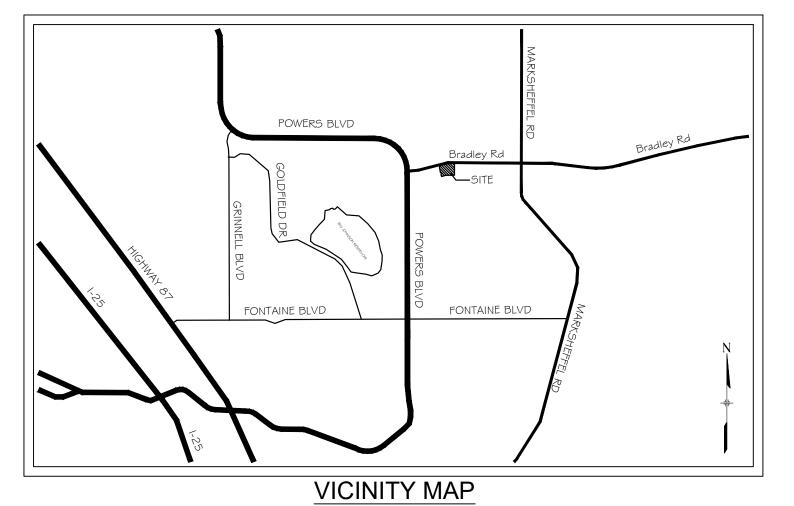

#### FIRE AUTHORITY APPROVAL

THE NUMBER OF FIRE HYDRANTS AND HYDRANT LOCATIONS SHOWN ON THIS WATER INSTALLATION PLAN ARE CORRECT AND ADEQUATE TO SATISFY THE FIRE PROTECTION REQUIREMENTS AS SPECIFIED BY THE FIRE DISTRICT SERVING THE PROPERTY NOTED ON THE PLANS.

FIRE PROTECTION DISTRICT	SECURITY	Free	PROTECTSON	Tesa
SIGNED SIGNED FIRE PROTECT	ION DISTRICT	-	DATE	6-11-21

#### **DISTRICT APPROVALS:**

DATE:

THE WIDEFIELD WATER AND SANITATION DISTRICT RECOGNIZES THE DESIGN ENGINEER AS HAVING RESPONSIBILITY FOR THE DESIGN AND HAS LIMITED ITS SCOPE OF REVIEW ACCORDINGLY

> WIDEFIELD WATER AND SANITATION DISTRICT WATER DESIGN APPROVAL

$D_{\Gamma}$	<b>`</b> 'L.			. וט	 	 
	PR	JJECT	NUMB	=R:		

IN CASE OF ERRORS OR OMISSIONS WITH THE WATER DESIGN AS SHOWN ON THIS DOCUMENT THE STANDARDS AS DEFINED IN THE "RULES AND REGULATIONS FOR INSTALLATION OF WATER MAINS AND SERVICES" SHALL RULE.

APPROVAL EXPIRES 180 DAYS FROM DESIGN APPROVAL

#### WATER AND SANITARY SEWER APPROVAL

ANY CHANGES OR ALTERATIONS AFFECTING THE GRADE. ALIGNMENT. ELEVATION. AND/OR DEPTH OF COVER OF ANY WATER OR SEWER MAINS OR OTHER APPURTENANCE SHOWN ON THIS DRAWING SHALL BE THE RESPONSIBILTY OF THE OWNER/DEVELOPER. THE OWNER/DEVELOPER SHALL BE RESPONSIBLE FOR ALL OPERATION DAMAGES AND DEFECTS IN INSTALLATION AND MATERIAL FOR MAINS AND SERVICES FROM THE DATE OF APPROVAL UNTIL FINAL ACCEPTANCE IS ISSUED.

IGNED		DATE
	OWNER/DEVELOPER	
RINT NAME		
BA		
DDRESS		

REFERENCE DRAWINGS				SHEET KEY
	No. DATE	DESCRIPTION	BY	
		REVISIONS		
	COMPUTER FILE MANAGEME	NT		
	FILE NAME: S:\21.886.038 (Trails F6)\100 E CTB FILE: Matrix(black).ctb PLOT DATE: December 23, 2021 9:48:15 AM	Owg\104 Plan Sets\Construction Plans\Utility Plans\Water Plan\TS01.dwg		
	THIS DRAWING IS CURRENT AS OF PLOT DATE AND MAY B	E SUBJECT TO CHANGE.		HILL

COLORADO SPRINGS UTILITIES (FIMS) MONUMENT F206 A BERNTSEN TOP SECURITY MONUMENT SYSTEM WITH A 3.5-INCH DIAMETER ALUMINUM CA SF-21-024 ROAD BOX, LOCATED ON THE NORTHWEST CORNER OF FONTAINE BOULEVARD AND POWER

ELEVATION - 5897.89' U.S. SURVEY FT

PREPARED BY: BEARINGS ARE BASED ON THE NORTH LINE OF THE NORTHWEST QUARTER OF SECTION 9, TOWNSHIP 15 SOUTH, RANGE 65 WEST OF THE 6TH P.M. SAID LINE BEARS S89°51'23"E FROM THE NORTHWEST CORNER OF SAID SECTION 9 (2 1/2" AULM. CAP PLS 17664) TO THE N 1/4 CORNER OF SAID SECTION 9 (3 1/4" AULM. CAP PLS 10377)





MATRIX DESIGN GROUP, INC.

PROJECT No. 21.886.038

# TRAILS AT ASPEN RIDGE

FILING NO. 4 PUBLIC WATERLINE PLANS

TITLE SHEET

DRAWING No. DRAWN BY: 1 OF 12 CHECKED BY:

ALL MATERIALS AND WORKMANSHIP SHALL BE SUBJECT TO INSPECTION BY THE WIDEFIELD WATER AND SANITATION DISTRICT. THE WIDEFIELD WATER AND SANITATION DISTRICT RESERVES THE RIGHT TO ACCEPT OR REJECT ANY SUCH MATERIALS AND WORKMANSHIP THAT DOES NOT CONFORM TO ITS STANDARDS AND SPECIFICATIONS.

THE DEVELOPER OR HIS ENGINEER HAS LOCATED ALL FIRE HYDRANTS AND FUTURE SERVICE STUBS. ANY REQUIRED REALIGNMENT, EITHER HORIZONTAL OR VERTICAL, SHALL BE AT THE EXPENSE OF THE DEVELOPER.

ALL DUCTILE IRON PIPE, TO INCLUDE FITTINGS, VALVES AND FIRE HYDRANTS WILL BE WRAPPED WITH POLYETHYLENE TUBING, AND ELECTRICALLY ISOLATED.

ALL DUCTILE IRON PIPE AND FITTINGS SHALL BE DOUBLE BONDED. SPECIFICATIONS FOR CATHODIC PROTECTION ON BOTH DIP MAINS AND PVC MAINS IS SPECIFIED IN THE STANDARDS AND SPECIFICATIONS.

6. PVC MAIN LINES SHALL BE INSTALLED WITH COATED NO. 12 TRACER WIRE.

THE CONTRACTOR IS REQUIRED TO NOTIFY THE WIDEFIELD WATER AND SANITATION DISTRICT (390-7111) A MINIMUM OF 48 HOURS AND A MAXIMUM OF 96 HOURS PRIOR TO THE START OF CONSTRUCTION. THE CONTRACTOR SHALL ALSO NOTIFY AFFECTED UTILITY COMPANIES 48 HOURS PRIOR TO CONSTRUCTION ADJACENT TO THE KNOWN UTILITY LINES.

THE LOCATION OF ALL UTILITIES AS SHOWN ON THESE DRAWINGS ARE APPROXIMATE ONLY. THE LOCATION OF ALL UTILITIES SHALL BE VERIFIED PRIOR TO CONSTRUCTION BY THE CONTRACTOR.

THE CONTRACTOR SHALL FIELD EXCAVATE AND VERIFY THE VERTICAL AND HORIZONTAL LOCATION OF ALL TIE-INS. CONTRACTOR SHALL NOTIFY THE WIDEFIELD WATER AND SANITATION DISTRICT AND THE ENGINEER OF THE FIELD VERIFIED INFORMATION PRIOR TO CONSTRUCTION.

10. ALL BENDS SHALL BE FIELD STAKED PRIOR TO CONSTRUCTION.

11. ANY WATER UTILITY MATERIAL REMOVED AND NOT REUSED SHALL BE RETURNED TO THE WIDEFIELD WATER AND SANITATION DISTRICT IF THE DISTRICT SO REQUESTS.

12. THE CONTRACTOR SHALL AT HIS EXPENSE SUPPORT AND PROTECT ALL UTILITY MAINS SO THAT THEY WILL FUNCTION CONTINUOUSLY DURING CONSTRUCTION. SHOULD A UTILITY MAIN FAIL AS A RESULT OF THE CONTRACTOR'S OPERATION, IT WILL BE REPLACED IMMEDIATELY BY EITHER THE CONTRACTOR OR THE WIDEFIELD WATER AND SANITATION DISTRICT AT FULL COST OF LABOR AND MATERIALS TO THE CONTRACTOR.

13. ANY PUMPING OR BYPASS OPERATIONS MUST BE REVIEWED AND APPROVED PRIOR TO EXECUTION BY BOTH THE WIDEFIELD WATER AND SANITATION DISTRICT AND THE ENGINEER.

14. CONTRACTOR MUST REPLACE OR REPAIR ANY DAMAGE TO ALL SURFACE IMPROVEMENTS. INCLUDING BUT NOT LIMITED TO FENCES, CURB AND GUTTER AND/OR ASPHALT THAT MAY BE CAUSED DURING CONSTRUCTION.

15. ALL WATER LINES 6" AND LARGER, AND ALL SEWER LINES 8" AND LARGER, SHALL HAVE AS "AS-BUILT" PLANS PREPARED AND APPROVED PRIOR TO FINAL ACCEPTANCE BY THE WIDEFIELD WATER AND SANITATION DISTRICT.

16. PRIOR TO CONSTRUCTION, A PRE-CONSTRUCTION CONFERENCE IS REQUIRED A MINIMUM OF 72 HOURS IN ADVANCE OF COMMENCEMENT OF WORK. TO SET THE PRE-CONSTRUCTION CONFERENCE, CONTACT BRANDON BERNARD-WATER DIVISION MANAGER AND/OR JASON DREESSEN, WASTEWATER DIVISION MANAGER AT (719)955-0548 OF THE WIDEFIELD WATER AND SANITATION DISTRICT FOR A TIME. NO PRE-CONSTRUCTION CONFERENCE TIMES WILL BE SET UNTIL 4 SETS OF SIGNED DRAWINGS ARE RECEIVED BY THE WIDEFIELD W & S DISTRICT. PRE-CONSTRUCTION DATE/INITIALS\_

17. DEVELOPER IS RESPONSIBLE FOR INSTALLING WATERLINE THROUGH FRONTSIDE DRIVE NO MORE THAN 18 MONTHS AFTER CONSTRUCTION OF TRAILS AT ASPEN RIDGE FILING 4 TO PROVIDE WATER LOOPING.

**LEGEND** 

VALVE (PROPOSED)

VALVE (EXISTING)

BLOWOFF (PROPOSED)

**EXISTING FIRE HYDRANT** 

PROPOSED FIRE HYDRANT

**BLOWOFF (EXISTING)** 

PLUG (PROPOSED)

PLUG (EXISTING)

PROPERTY LINE

EXISTING GAS MAIN

PROPOSED WATER (8")

PROPOSED WATER (12")

PROPOSED WATER (16")

**EXISTING STORM DRAIN** 

**EXISTING SAN. SEWER** 

**EXISTING MANHOLE** 

PROPOSED MANHOLE

PROPOSED STORM DRAIN

PROPOSED SAN. SEWER

EXISTING WATER

**CURB LINE** 

ABBREVIATIONS

BOV

CPLG.

(INS.)

(RED.)

(STR.) CRA

CTRB

DEFL

DIP

FLG

GPM

MIN

PVC

RCP

RED

STA

STS TOP

TYP

RSNTS

N,S,E,W

GRD BRK

HYD ASSY

ASSEMBLY

COUPLING

DEFLECT

**EXISTING** 

FIRE HYDRANT

FLANGE

INVFRT

MINIMUM

REDUCER

SLIP JOINT

STATION

**TYPICAL** 

**BOTTOM OF PIPE** 

(INSULATING)

(REDUCING)

(STRAIGHT)

DUCTILE IRON PIPE **ELEVATION** 

**GALLONS PER MINUTE** 

LEFT OF CENTER LINE

NORTH, SOUTH, EAST, WEST

POUNDS PER SQUARE INCH

POLYVINYL CHLORIDE PIPE

REINFORCED CONCRETE PIPE

MJ RESTRAINT (i.e. MEGALUG)

RIGHT OF CENTER LINE

SANITARY SEWER

STORM SEWER

TOP OF PIPE

MECHANICAL JOINT

PROPERTY LINE

V.P.I. GRADE BREAK

BLOWOFF ASSEMBLY AND VALVE

CONCRETE REVERSE ANCHOR

CONCRETE THRUST REACTION BLOCK

INCLUDES FIRE HYDRANT, LATERAL, VALVE,

TIE RODS, AND REVERSE ANCHOR.

#### **EL PASO COUNTY STANDARD CONSTRUCTION NOTES:**

1. ALL DRAINAGE AND ROADWAY CONSTRUCTION SHALL MEET THE STANDARDS AND SPECIFICATIONS OF THE CITY OF COLORADO SPRINGS/EL PASO COUNTY DRAINAGE CRITERIA MANUAL, VOLUMES 1 AND 2, AND THE EL PASO COUNTY ENGINEERING CRITERIA MANUAL

2. CONTRACTOR SHALL BE RESPONSIBLE FOR THE NOTIFICATION AND FIELD NOTIFICATION OF ALL EXISTING UTILITIES, WHETHER SHOWN ON THE PLANS OR NOT, BEFORE BEGINNING CONSTRUCTION. LOCATION OF EXISTING UTILITIES SHALL BE VERIFIED BY THE CONTRACTOR PRIOR TO CONSTRUCTION. CALL 811 TO CONTACT THE UTILITY NOTIFICATION CENTER OF COLORADO (UNCC).

3. CONTRACTOR SHALL KEEP A COPY OF THESE APPROVED PLANS, THE GRADING AND EROSION CONTROL PLAN, THE STORMWATER MANAGEMENT PLAN (SWMP), THE SOILS AND GEOTECHNICAL REPORT, AND THE APPROPRIATE DESIGN AND CONSTRUCTION STANDARDS AND SPECIFICATIONS AT THE JOB SITE AT ALL TIMES, INCLUDING THE FOLLOWING:

a. EL PASO COUNTY ENGINEERING CRITERIA MANUAL (ECM)

b. CITY OF COLORADO SPRINGS/EL PASO COUNTY DRAINAGE CRITERIA MANUAL VOLUMES 1 AND 2

c. COLORADO DEPARTMENT OF TRANSPORTATION (CDOT) STANDARD SPECIFICATIONS FOR ROAD AND BRIDGE CONSTRUCTION

d. CDOT M & S STANDARDS 4. NOTWITHSTANDING ANYTHING DEPICTED IN THESE PLANS IN WORDS OR GRAPHIC REPRESENTATION, ALL DESIGN AND CONSTRUCTION RELATED TO ROADS, STORM DRAINAGE AND EROSION CONTROL SHALL CONFORM TO THE STANDARDS AND REQUIREMENTS OF THE MOST RECENT VERSION OF THE RELEVANT ADOPTED EL PASO COUNTY STANDARDS, INCLUDING THE LAND DEVELOPMENT CODE, THE ENGINEERING CRITERIA MANUAL. THE DRAINAGE CRITERIA MANUAL. AND THE DRAINAGE CRITERIA MANUAL VOLUME 2. ANY DEVIATIONS FROM REGULATIONS AND STANDARDS MUST BE REQUESTED, AND APPROVED, IN WRITING. ANY MODIFICATIONS NECESSARY TO MEET CRITERIA AFTER-THE-FACT WILL BE ENTIRELY THE DEVELOPER'S RESPONSIBILITY TO

5. IT IS THE DESIGN ENGINEER'S RESPONSIBILITY TO ACCURATELY SHOW EXISTING CONDITIONS, BOTH ONSITE AND OFFSITE, ON THE CONSTRUCTION PLANS. ANY MODIFICATIONS NECESSARY DUE TO CONFLICTS, OMISSIONS, OR CHANGED CONDITIONS WILL BE ENTIRELY THE DEVELOPER'S RESPONSIBILITY TO RECTIFY.

6. CONTRACTOR SHALL SCHEDULE A PRE-CONSTRUCTION MEETING WITH EL PASO COUNTY PLANNING AND COMMUNITY DEVELOPMENT (PCD) - INSPECTIONS, PRIOR TO STARTING

7. IT IS THE CONTRACTOR'S RESPONSIBILITY TO UNDERSTAND THE REQUIREMENTS OF ALL JURISDICTIONAL AGENCIES AND TO OBTAIN ALL REQUIRED PERMITS, INCLUDING BUT NOT LIMITED TO EL PASO COUNTY EROSION AND STORMWATER QUALITY CONTROL PERMIT (ESQCP), REGIONAL BUILDING FLOODPLAIN DEVELOPMENT PERMIT, U.S. ARMY CORPS OF ENGINEERS-ISSUED 401 AND/OR 404 PERMITS, AND COUNTY AND STATE FUGITIVE DUST PERMITS.

8. CONTRACTOR SHALL NOT DEVIATE FROM THE PLANS WITHOUT FIRST OBTAINING WRITTEN APPROVAL FROM THE DESIGN ENGINEER AND PCD. CONTRACTOR SHALL NOTIFY THE DESIGN ENGINEER IMMEDIATELY UPON DISCOVERY OF ANY ERRORS OR INCONSISTENCIES.

9. ALL STORM DRAIN PIPE SHALL BE CLASS III RCP UNLESS OTHERWISE NOTED AND APPROVED BY PCD.

10. CONTRACTOR SHALL COORDINATE GEOTECHNICAL TESTING PER ECM STANDARDS. PAVEMENT DESIGN SHALL BE APPROVED BY EL PASO COUNTY PCD PRIOR TO PLACEMENT OF CURB AND GUTTER AND PAVEMENT.

11. ALL CONSTRUCTION TRAFFIC MUST ENTER/EXIT THE SITE AT APPROVED CONSTRUCTION ACCESS POINTS.

12. SIGHT VISIBILITY TRIANGLES AS IDENTIFIED IN THE PLANS SHALL BE PROVIDED AT ALL INTERSECTIONS. OBSTRUCTIONS GREATER THAN 18 INCHES ABOVE FLOWLINE ARE NOT ALLOWED WITHIN SIGHT TRIANGLES.

13. SIGNING AND STRIPING SHALL COMPLY WITH EL PASO COUNTY DOT AND MUTCD CRITERIA. [IF APPLICABLE, ADDITIONAL SIGNING AND STRIPING NOTES WILL BE

14. CONTRACTOR SHALL OBTAIN ANY PERMITS REQUIRED BY EL PASO COUNTY DOT INCLUDING WORK WITHIN THE RIGHT-OF-WAY AND SPECIAL TRANSPORT PERMITS.

15. THE LIMITS OF CONSTRUCTION SHALL REMAIN WITHIN THE PROPERTY LINE UNLESS OTHERWISE NOTED. THE OWNER/DEVELOPER SHALL OBTAIN WRITTEN PERMISSION AND EASEMENTS, WHERE REQUIRED, FROM ADJOINING PROPERTY OWNER(S) PRIOR TO ANY OFF-SITE DISTURBANCE, GRADING, OR CONSTRUCTION.

# TRAILS AT ASPEN RIDGE FILING NO. 4 WT01 TRAILS AT ASPEN RIDGE **FUTURE FILINGS** TRAILS AT ASPEN RIDGE FILING NO. 2 TRAILS AT ASPEN RIDGE FILING NO. 3

Call before you dig

SHEET No.



# OVERALL LAYOUT AND SHEET INDEX

SCALE: 1" = 100'


THE WIDEFIELD WATER AND SANITATION DISTRICT RECOGNIZES THE DESIGN ENGINEER AS HAVING RESPONSIBILITY FOR THE DESIGN AND HAS LIMITED ITS SCOPE OF REVIEW ACCORDINGLY.

> **WIDEFIELD WATER AND SANITATION DISTRICT WATER DESIGN APPROVAL**

PROJECT NUMBER:

IN CASE OF ERRORS OR OMISSIONS WITH THE WATER DESIGN AS SHOWN ON THIS DOCUMENT THE STANDARDS AS DEFINED IN THE "RULES AND REGULATIONS FOR INSTALLATION OF WATER MAINS AND SERVICES" SHALL RULE.

APPROVAL EXPIRES 180 DAYS FROM DESIGN APPROVAL

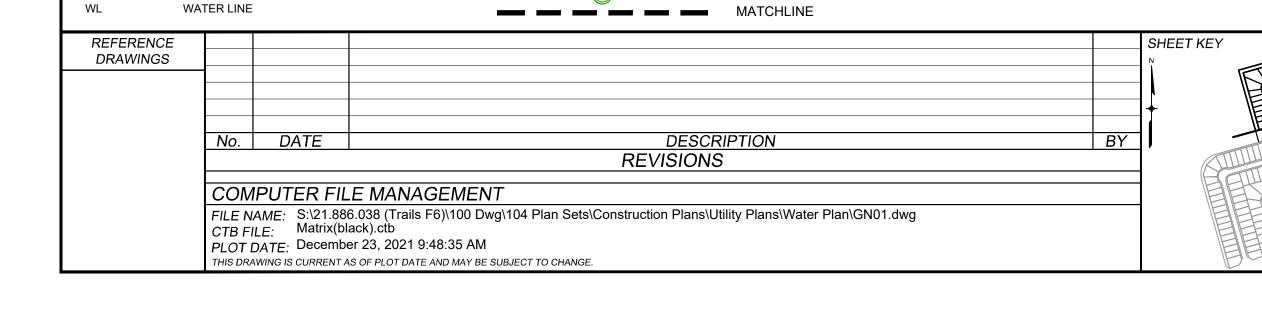


# ENCHMARK

COLORADO SPRINGS UTILITIES (FIMS) MONUMENT F206 A BERNTSEN TOP SECURITY MONUMENT SYSTEM WITH A 3.5-INCH DIAMETER ALUMINUM CAP IN A ROAD BOX, LOCATED ON THE NORTHWEST CORNER OF FONTAINE BOULEVARD AND POWERS BOULEVARD. ELEVATION - 5897.89' U.S. SURVEY FT

#### BASIS OF BEARING

BEARINGS ARE BASED ON THE NORTH LINE OF THE NORTHWEST QUARTER OF SECTION 9, TOWNSHIP 15 SOUTH, RANGE 65 WEST OF THE 6TH P.M. SAID LINE BEARS S89°51'23"E FROM THE NORTHWEST CORNER OF SAID SECTION 9 (2 ½" AULM. CAP PLS 17664) TO THE N ½ CORNER OF SAID SECTION 9 (3 ¼" AULM. CAP PLS 10377)



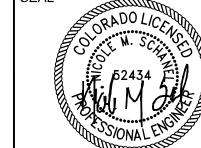

FOR AND ON BEHALF OF

MATRIX DESIGN GROUP, INC.

PROJECT No. 21.886.038


PUBLIC WATERLINE PLANS


TRAILS AT ASPEN RIDGE

FILING NO. 4

GENERAL NOTES, LEGEND, ABBREVIATIONS, & SHEET INDEX

SCALE DATE ISSUED: DRAWING No. DRAWN BY: **GN01** 2 OF 12 CHECKED BY: NMS

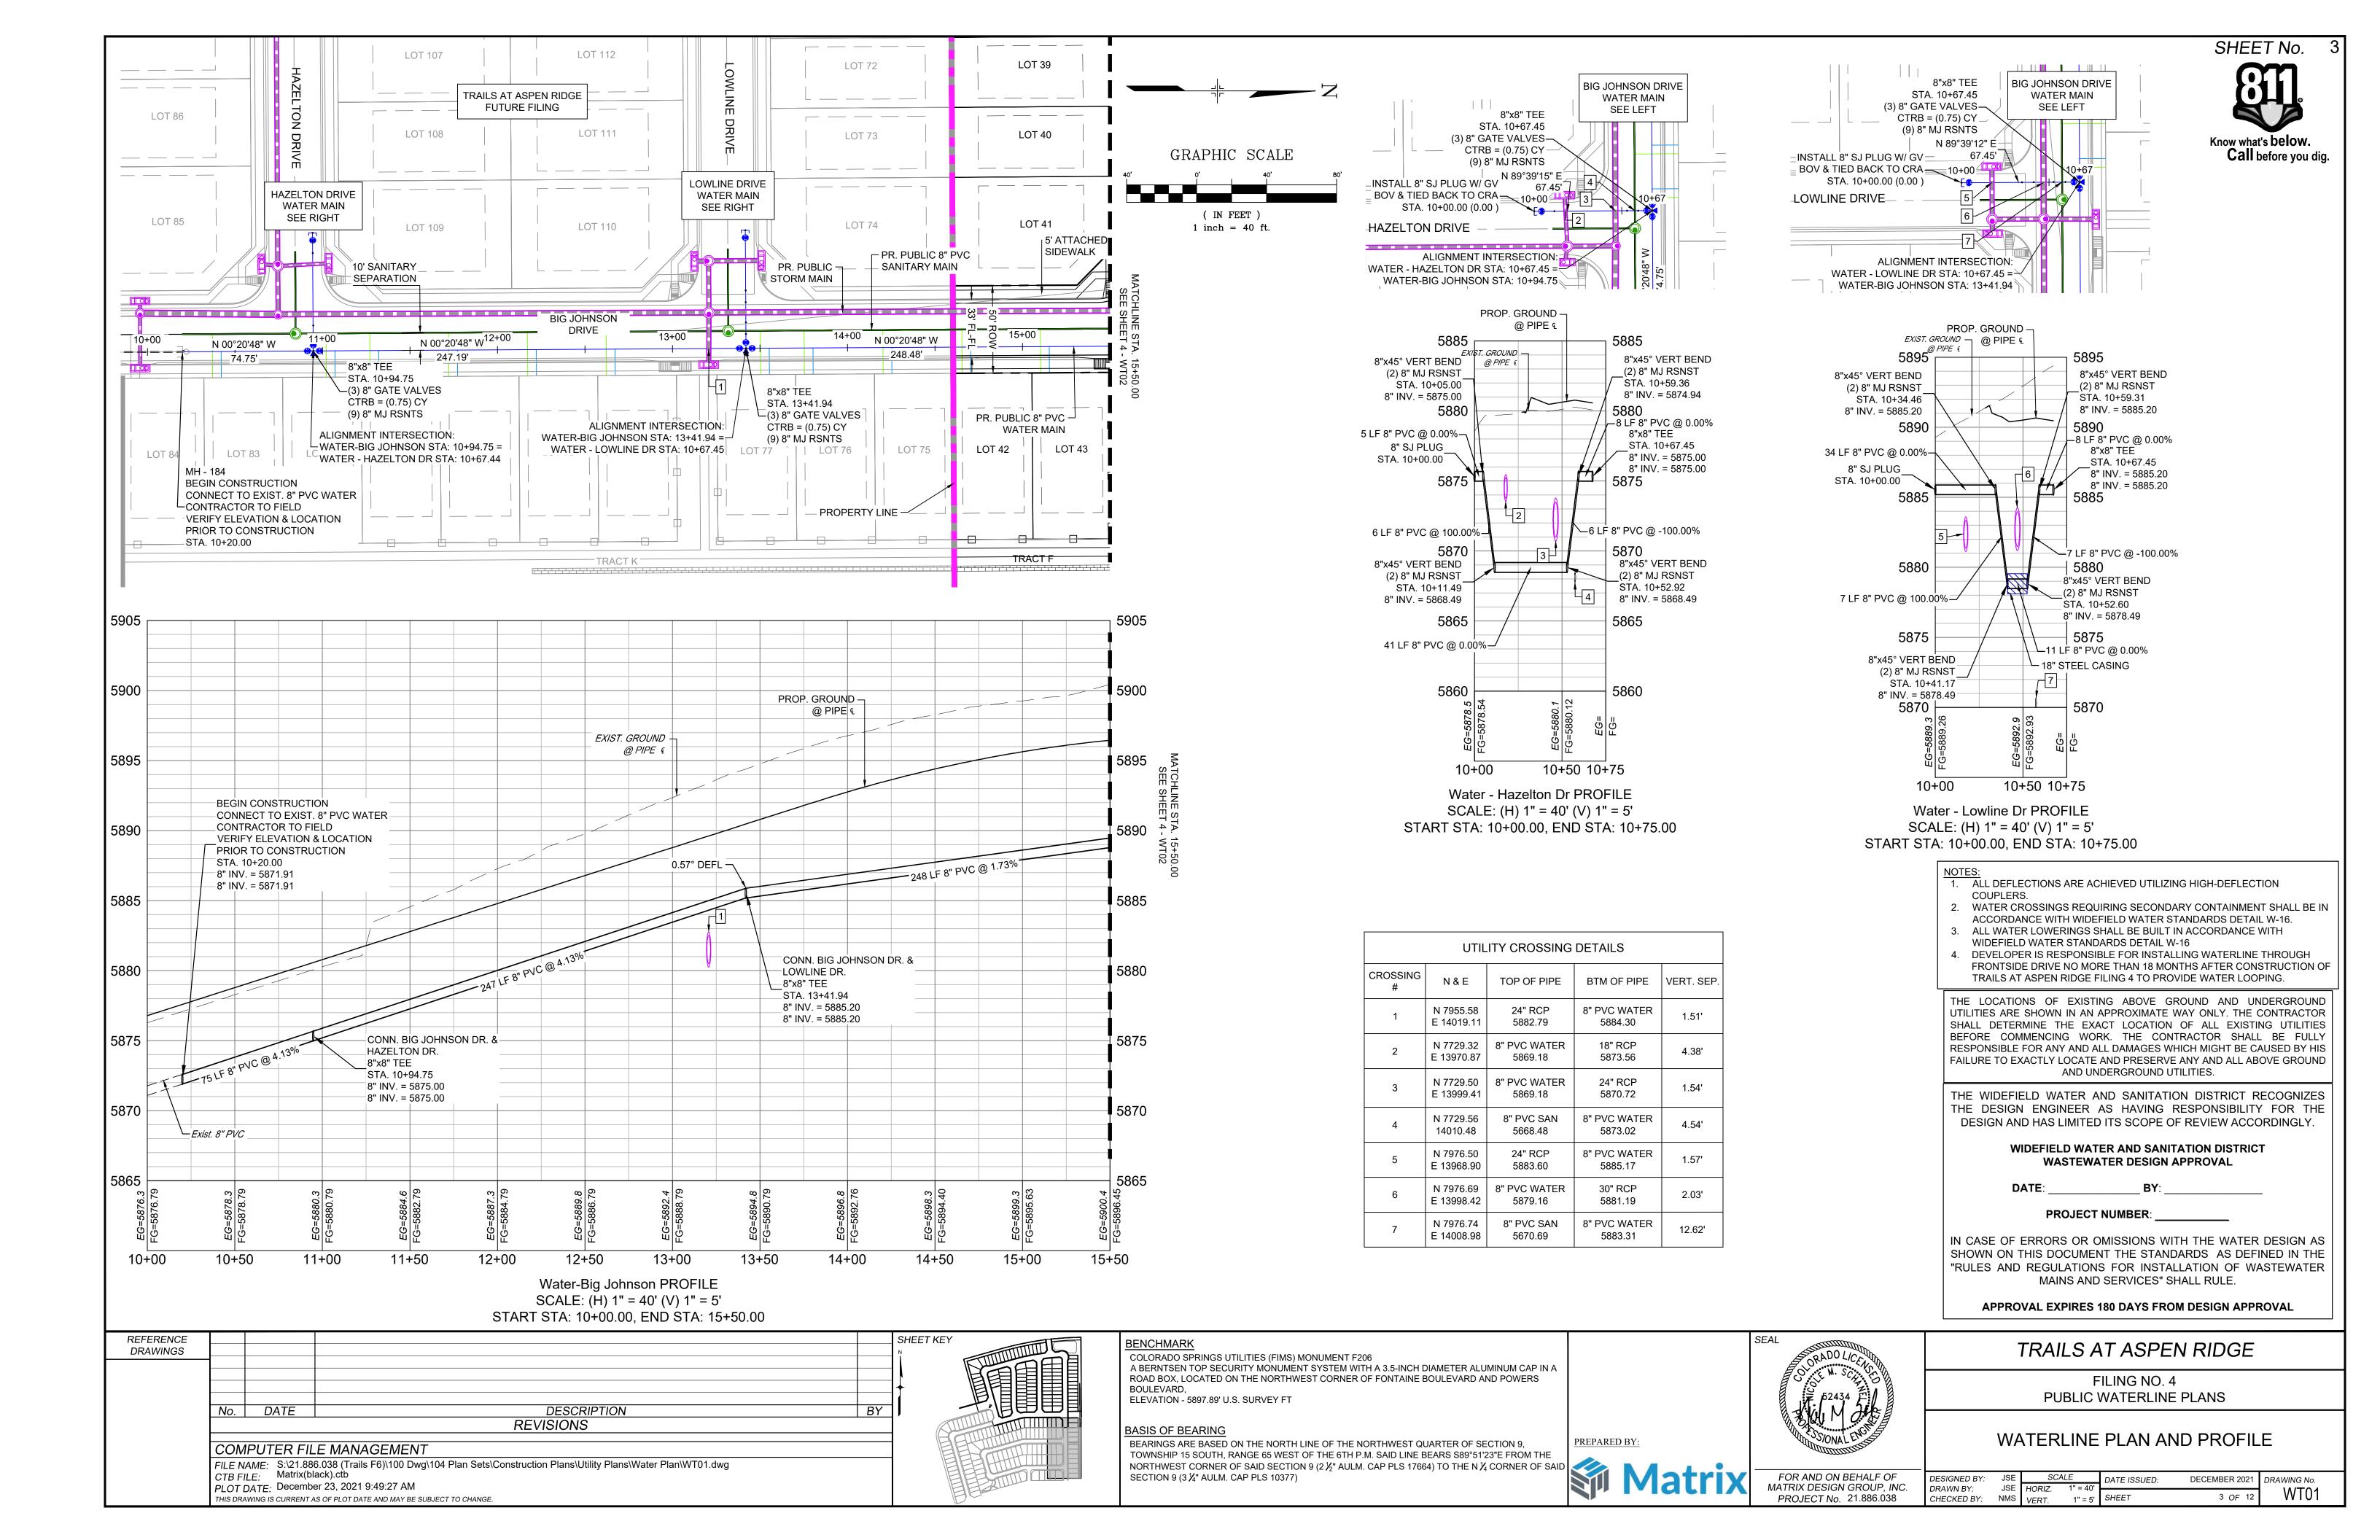

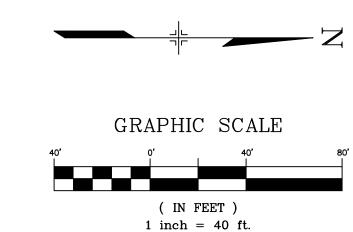

## NOTES:

- 1. ALL DEFLECTIONS ARE ACHIEVED UTILIZING HIGH-DEFLECTION
- 2. WATER CROSSINGS REQUIRING SECONDARY CONTAINMENT SHALL BE IN ACCORDANCE WITH WIDEFIELD WATER STANDARDS DETAIL W-16.
- 3. ALL WATER LOWERINGS SHALL BE BUILT IN ACCORDANCE WITH WIDEFIELD WATER STANDARDS DETAIL W-16
- 4. DEVELOPER IS RESPONSIBLE FOR INSTALLING WATERLINE THROUGH FRONTSIDE DRIVE NO MORE THAN 18 MONTHS AFTER CONSTRUCTION OF

TRAILS AT ASPEN RIDGE FILING 4 TO PROVIDE WATER LOOPING.

THE LOCATIONS OF EXISTING ABOVE GROUND AND UNDERGROUND UTILITIES ARE SHOWN IN AN APPROXIMATE WAY ONLY. THE CONTRACTOR SHALL DETERMINE THE EXACT LOCATION OF ALL EXISTING UTILITIES BEFORE COMMENCING WORK. THE CONTRACTOR SHALL BE FULLY RESPONSIBLE FOR ANY AND ALL DAMAGES WHICH MIGHT BE CAUSED BY HIS FAILURE TO EXACTLY LOCATE AND PRESERVE ANY AND ALL ABOVE GROUND AND UNDERGROUND UTILITIES.


THE WIDEFIELD WATER AND SANITATION DISTRICT RECOGNIZES THE DESIGN ENGINEER AS HAVING RESPONSIBILITY FOR THE DESIGN AND HAS LIMITED ITS SCOPE OF REVIEW ACCORDINGLY.

> WIDEFIELD WATER AND SANITATION DISTRICT **WASTEWATER DESIGN APPROVAL**

**PROJECT NUMBER:** 

IN CASE OF ERRORS OR OMISSIONS WITH THE WATER DESIGN AS SHOWN ON THIS DOCUMENT THE STANDARDS AS DEFINED IN THE "RULES AND REGULATIONS FOR INSTALLATION OF WASTEWATER MAINS AND SERVICES" SHALL RULE.

APPROVAL EXPIRES 180 DAYS FROM DESIGN APPROVAL

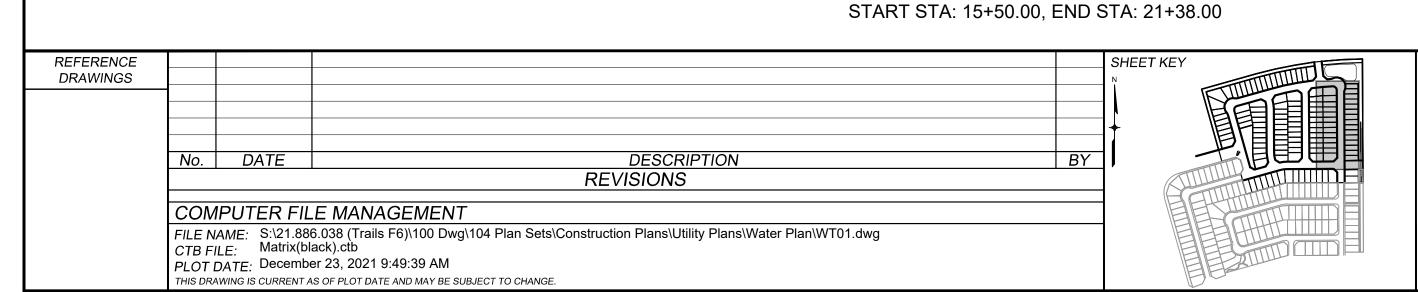

17+00

17+50

18+00

18+50

Water-Big Johnson PROFILE

SCALE: (H) 1" = 40' (V) 1" = 5'

19+00

20+00

COLORADO SPRINGS UTILITIES (FIMS) MONUMENT F206 A BERNTSEN TOP SECURITY MONUMENT SYSTEM WITH A 3.5-INCH DIAMETER ALUMINUM CAP IN A ROAD BOX, LOCATED ON THE NORTHWEST CORNER OF FONTAINE BOULEVARD AND POWERS BOULEVARD,

21+38

WINNER CREEK DRIVE WATER MAIN SEE SHEET 9 - WT07

5915

5910

5905

5900

5895

5885

PR. PUBLIC =

8"x45° BEND

CTRB = (0.50) CY

(2) 8" MJ RSNTS

STA. 21+26.20

N 48°16'17" W

11.51'

STA. 21+37.72 T 58

8"x45° BEND,

 $CTRB = (0.50) CY^{-}$ 

(2) 8" MJ RSNTS

ALIGNMENT INTERSECTION: WATER-BIG JOHNSON STA: 21+38 = WATER-WINNER CREEK STA: 17+41.39

> EXIST. GROUND @ PIPE &

> > 8"x45° BEND

STA. 21+26.20

51 LF 8" PVC @ 0.00%

21+00

ACTUAL DEFLECTION= 47.92°

VERTICAL DEFLECTION

-220 LF 8" PVC @ -2.74%

19+50

STA. 20+75.00

8" INV. = 5880.75 -

ACTUAL DEFLECTION= 47.92°

21+38~

21+00

STORM MAIN

LOT 64

LOT 65

PR. 8" PVC PUBLIC

SANITARY MAIN

HYDRANT A

LOT 50

LOT 51

STA. 18+55.42(14.00'R)

W/ 14.00 LF 6" PVC

FLANGE EL=5893.99

6.0' BURY HYDRANT ASSY.

LOT 49

1.23° VERTICAL DEFLECTION

PROP. GROUND

@ PIPE €

STA. 17+55.00

<sup>-</sup>8" INV. = 5889.52

LOT 66

LOT 69

TYPE C C&G

8" CROSS

STA. 17+10.14

(8) 8" MJ RSNTS

LOT 44

(4) 8" GATE VALVES

LOT 45

WATER-BIG JOHNSON STA: 15+90.42 =

WATER-SCHOONOVER STA: 17+10.14

ALIGNMENT INTERSECTION:

CONN. BIG JOHNSON DR. &

\_8" CROSS

= 1.04° DEFL

16+00

-248 LF 8" PVC @ 1.73%

16+50

STA. 15+90.42 8" INV. = 5889.52

8" INV. = 5889.49

SCHOONOVER DR. & TRACT L

165 LF 8" PVC @ 0.02% T

LOT 46

LOT 47

SCHOONOVER DRIVE WATER MAIN SEE SHEET 5 - WT03

TRACT D

5915

5910

5905

5900

5895

5880

15+50

15+50 WT01

LOT 68

LOT 67

5' ATTACHED

SIDEWALK

N 00°20'48" W

LOT 48

LOT 63

**BIG JOHNSON** 

LOT 52

LOT 53

DRIVE

LOT 62

WATER MAIN

LOT 61

PR. 8" PVC PUBLIC -10' SANITARY

LOT 54

SEPARATION

LOT 55

ELEVATION - 5897.89' U.S. SURVEY FT

20+50

# BASIS OF BEARING

BEARINGS ARE BASED ON THE NORTH LINE OF THE NORTHWEST QUARTER OF SECTION 9,





PROJECT No. 21.886.038


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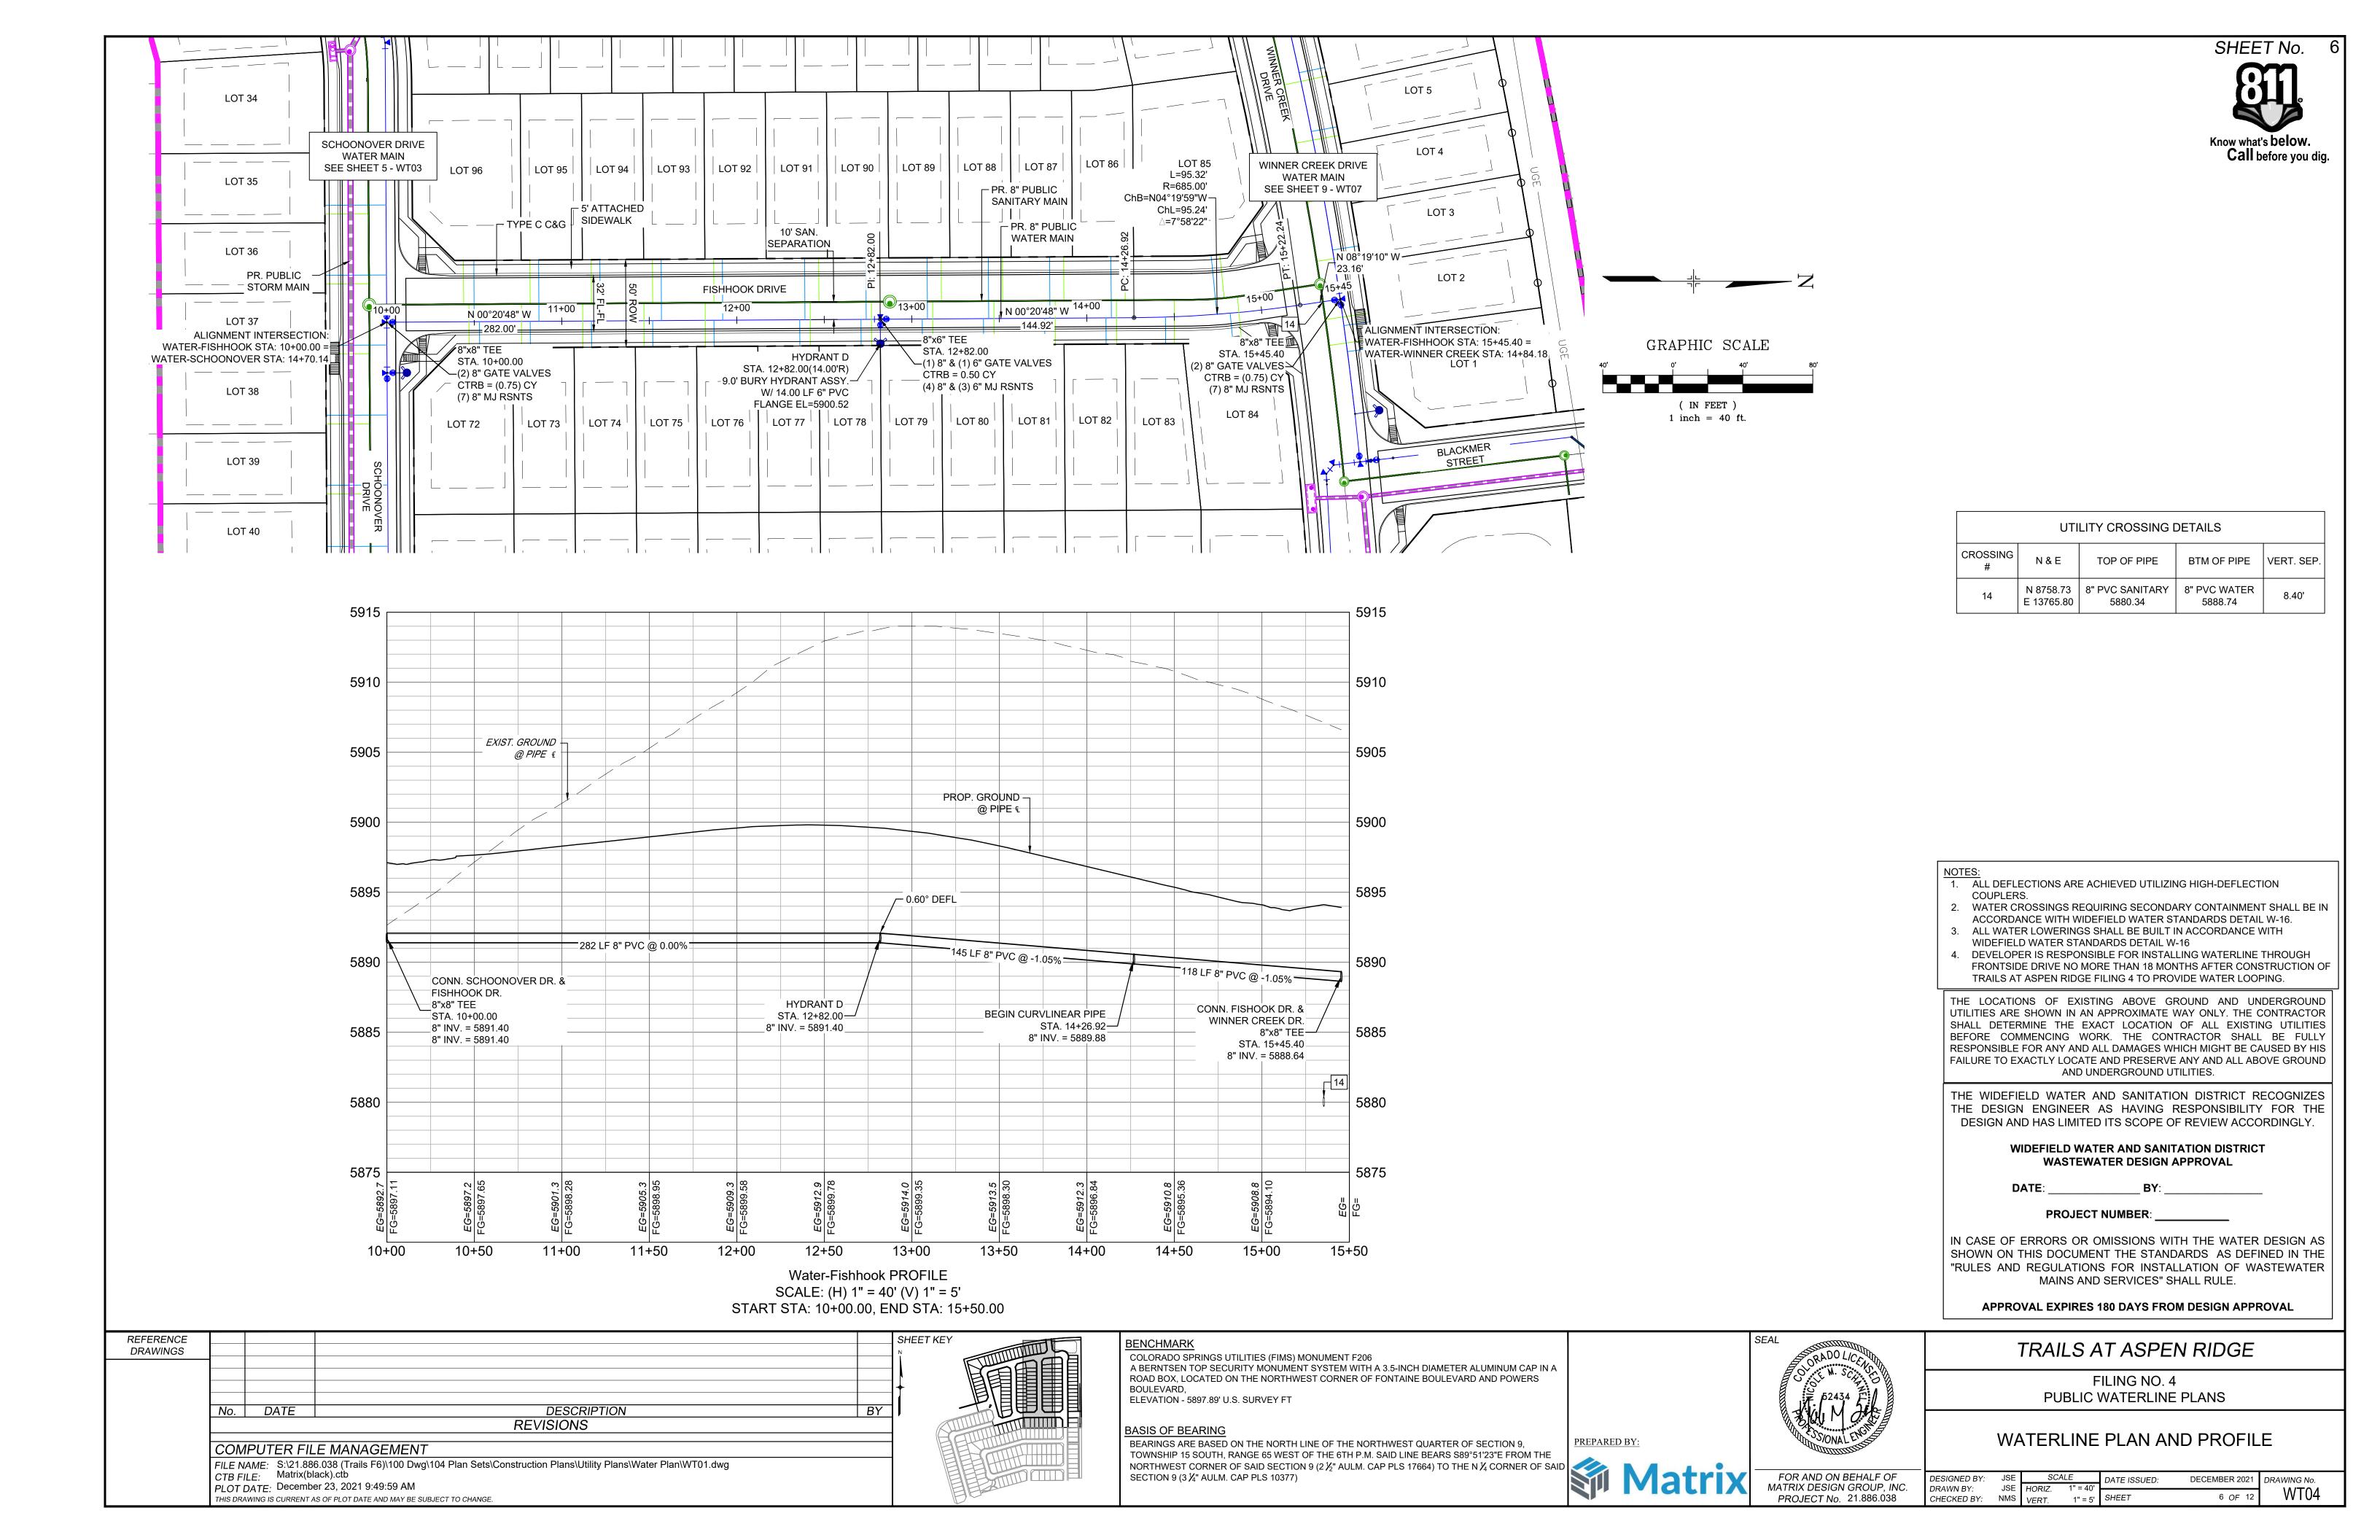
FILING NO. 4 PUBLIC WATERLINE PLANS


WATERLINE PLAN AND PROFILE

DECEMBER 2021 DRAWING No. DRAWN BY: WT02 4 OF 12 CHECKED BY: NMS





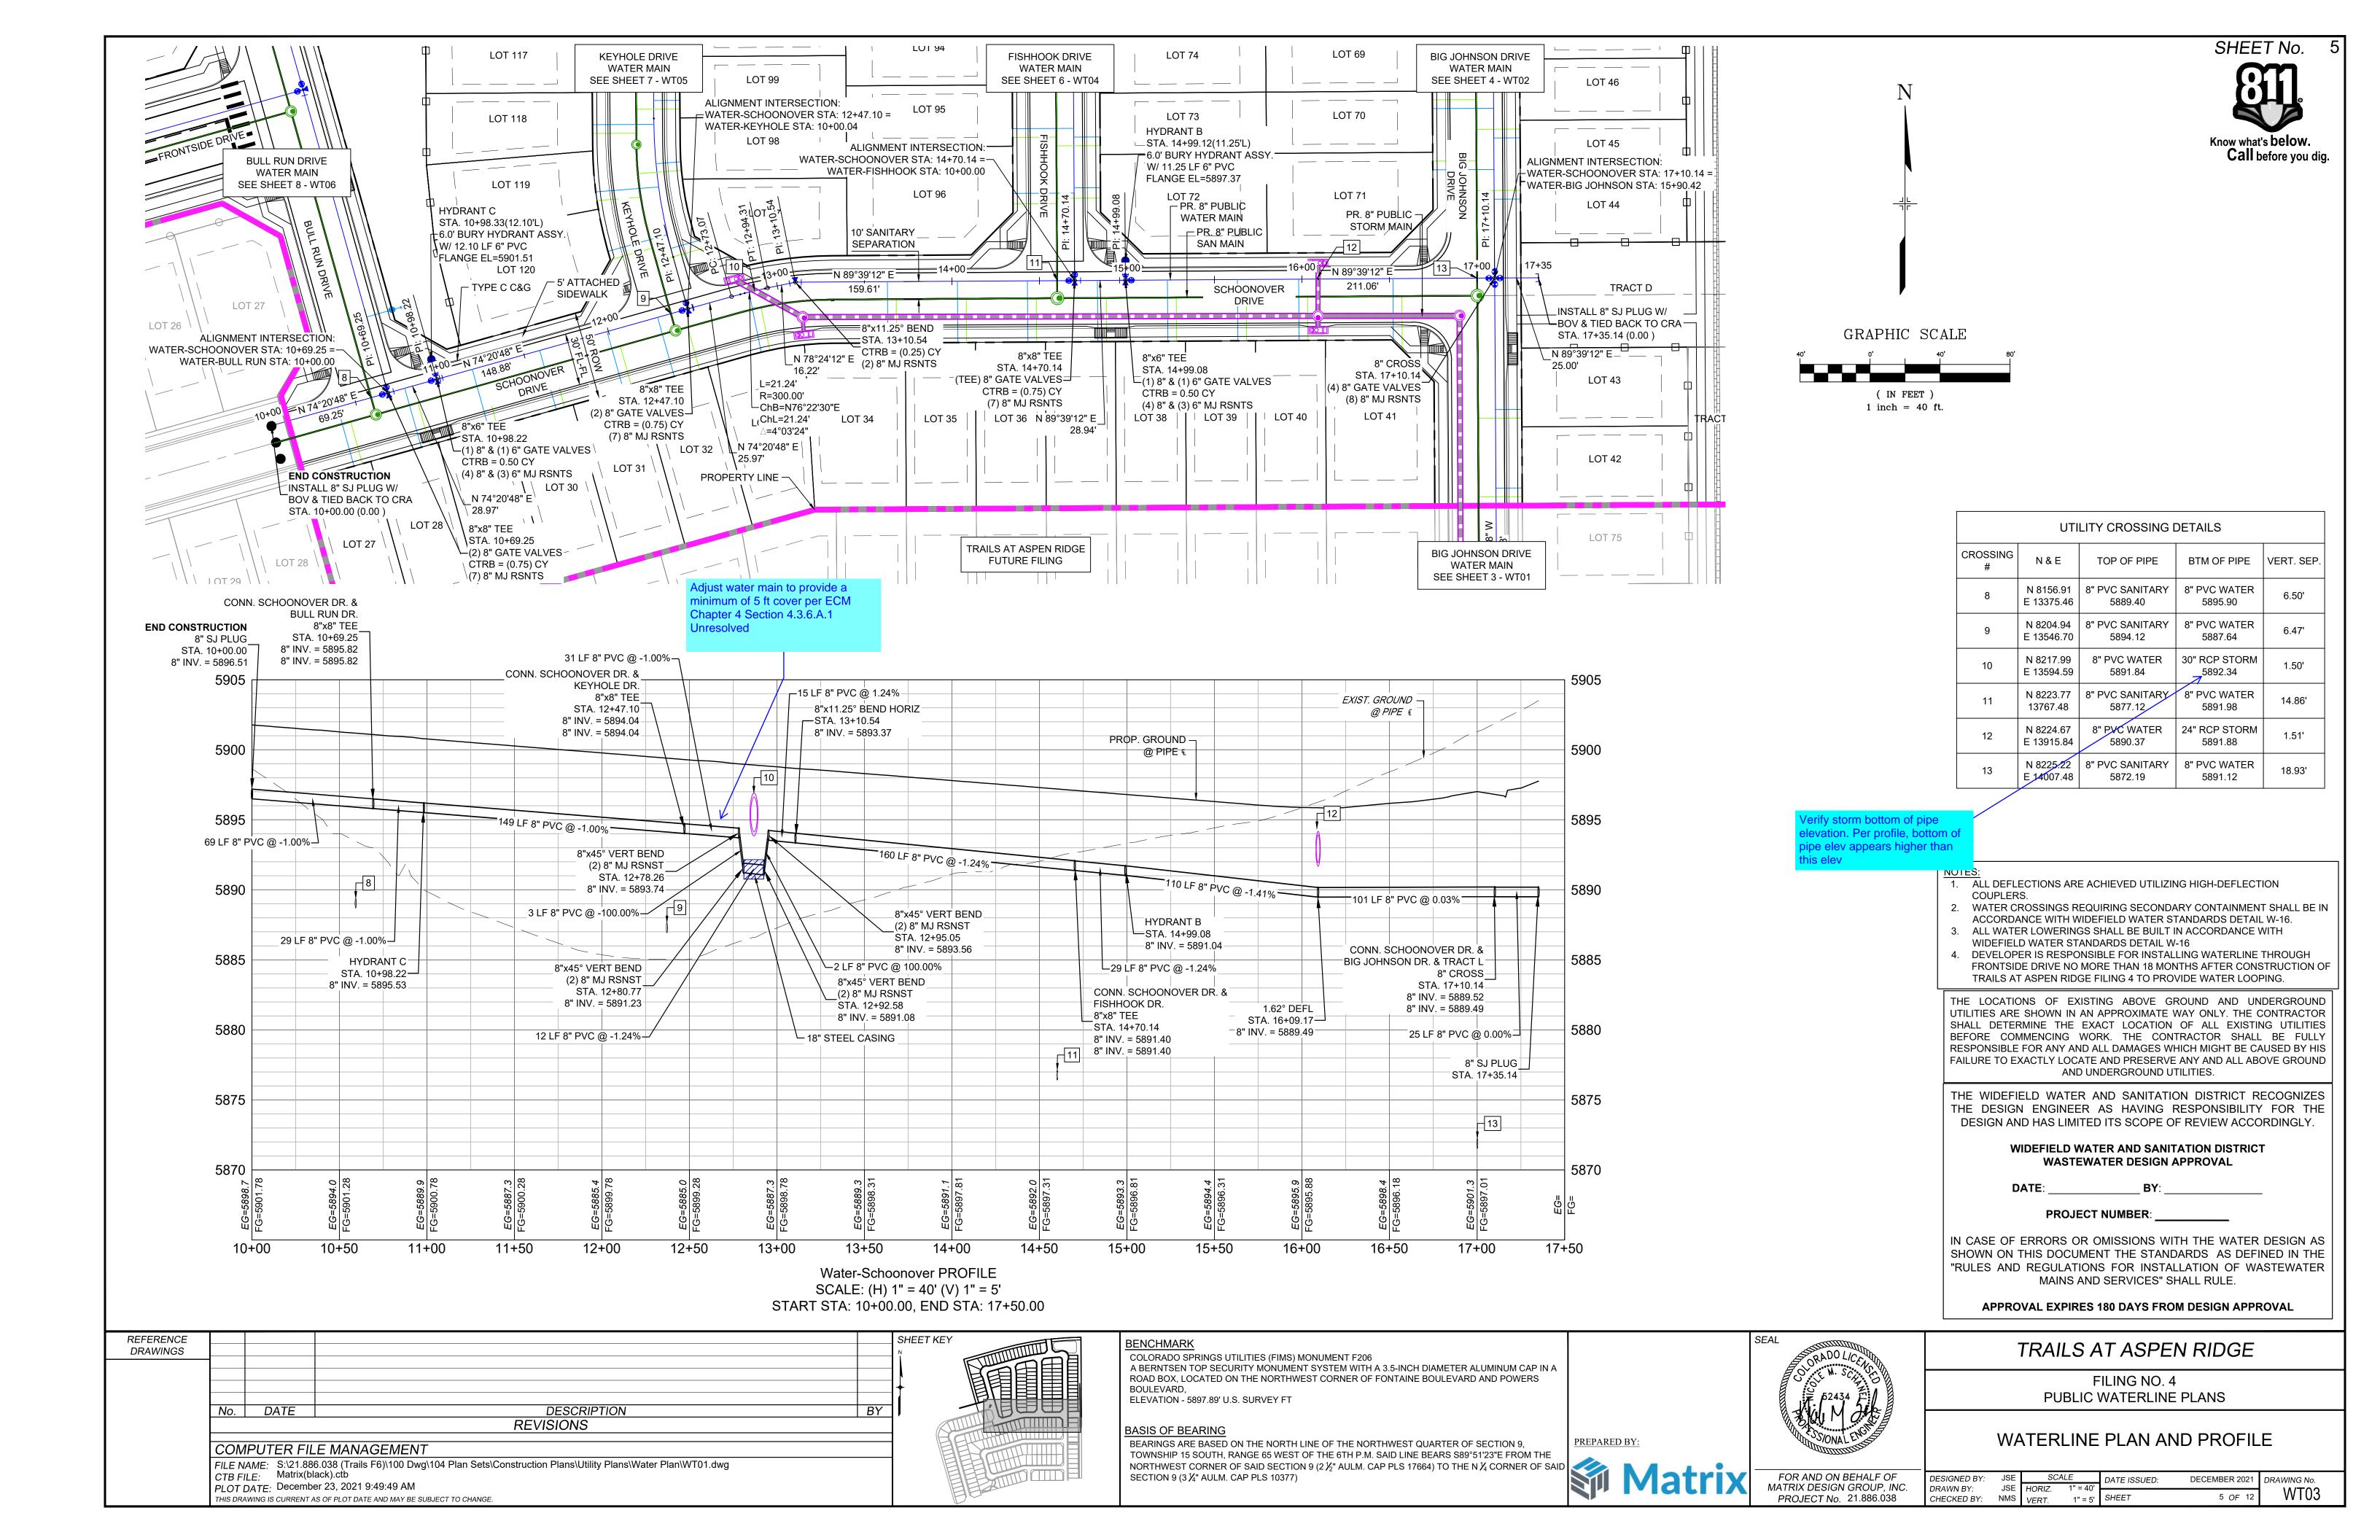

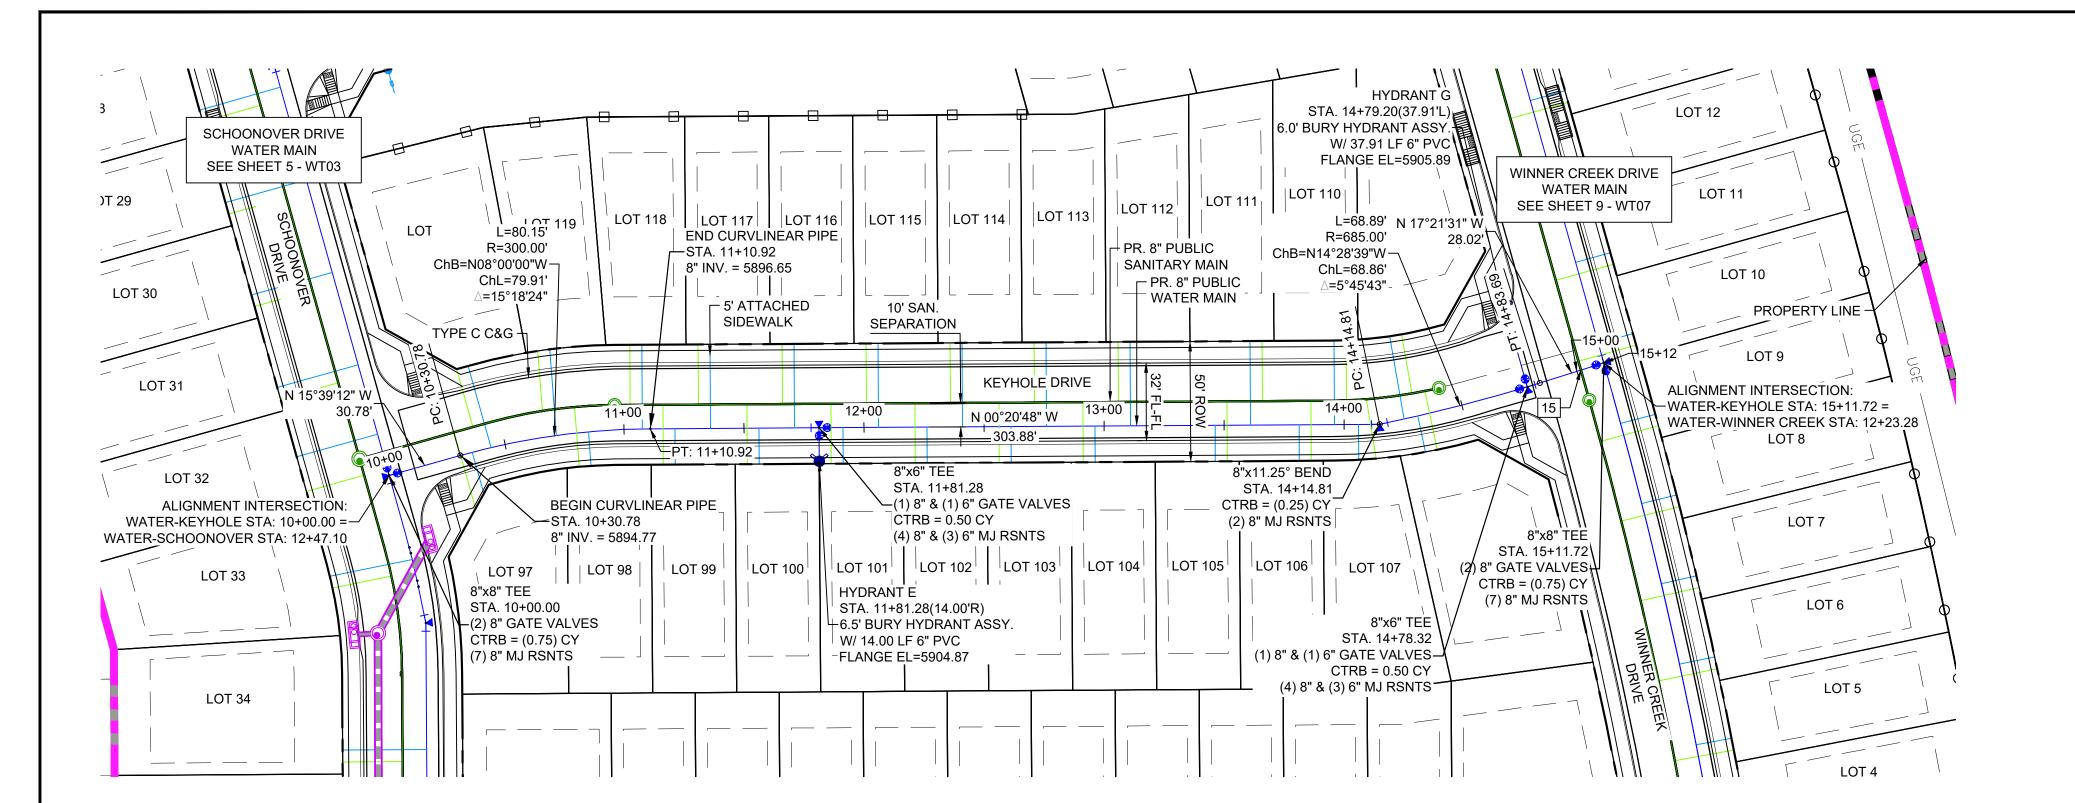

PROP. GROUND -

@ PIPE &

234 LF 8" PVC @ 0.00%=

13+00

HYDRANT E

STA. 11+81.28

\_\_\_ 1.58° DEFL

12+00

12+50

Water-Keyhole PROFILE

SCALE: (H) 1" = 40' (V) 1" = 5'

-70 LF 8" PVC @ 2.36% -

END CURVLINEAR PIPE

11+50


—STA. 11+10.92

└─80 LF 8" PVC @ 2.35%

8" INV. = 5896.65

8" INV. = 5898.31



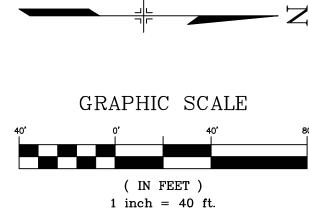

UTILITY CROSSING DETAILS						
CROSSING #	N & E	TOP OF PIPE	BTM OF PIPE	VERT. SEP.		
15	N 8704.11 E 13512.49	8" PVC SANITARY 5891.60	8" PVC WATER 5898.29	6.68'		

#### NOTES:

- 1. ALL DEFLECTIONS ARE ACHIEVED UTILIZING HIGH-DEFLECTION
- 2. WATER CROSSINGS REQUIRING SECONDARY CONTAINMENT SHALL BE IN ACCORDANCE WITH WIDEFIELD WATER STANDARDS DETAIL W-16.
- 3. ALL WATER LOWERINGS SHALL BE BUILT IN ACCORDANCE WITH
- WIDEFIELD WATER STANDARDS DETAIL W-16 4. DEVELOPER IS RESPONSIBLE FOR INSTALLING WATERLINE THROUGH
- FRONTSIDE DRIVE NO MORE THAN 18 MONTHS AFTER CONSTRUCTION OF TRAILS AT ASPEN RIDGE FILING 4 TO PROVIDE WATER LOOPING.

THE LOCATIONS OF EXISTING ABOVE GROUND AND UNDERGROUND UTILITIES ARE SHOWN IN AN APPROXIMATE WAY ONLY. THE CONTRACTOR SHALL DETERMINE THE EXACT LOCATION OF ALL EXISTING UTILITIES BEFORE COMMENCING WORK. THE CONTRACTOR SHALL BE FULLY RESPONSIBLE FOR ANY AND ALL DAMAGES WHICH MIGHT BE CAUSED BY HIS FAILURE TO EXACTLY LOCATE AND PRESERVE ANY AND ALL ABOVE GROUND AND UNDERGROUND UTILITIES.

THE WIDEFIELD WATER AND SANITATION DISTRICT RECOGNIZES THE DESIGN ENGINEER AS HAVING RESPONSIBILITY FOR THE DESIGN AND HAS LIMITED ITS SCOPE OF REVIEW ACCORDINGLY.


#### WIDEFIELD WATER AND SANITATION DISTRICT **WASTEWATER DESIGN APPROVAL**

**PROJECT NUMBER:** 

IN CASE OF ERRORS OR OMISSIONS WITH THE WATER DESIGN AS SHOWN ON THIS DOCUMENT THE STANDARDS AS DEFINED IN THE "RULES AND REGULATIONS FOR INSTALLATION OF WASTEWATER MAINS AND SERVICES" SHALL RULE.

APPROVAL EXPIRES 180 DAYS FROM DESIGN APPROVAL

TRAILS AT ASPEN RIDGE

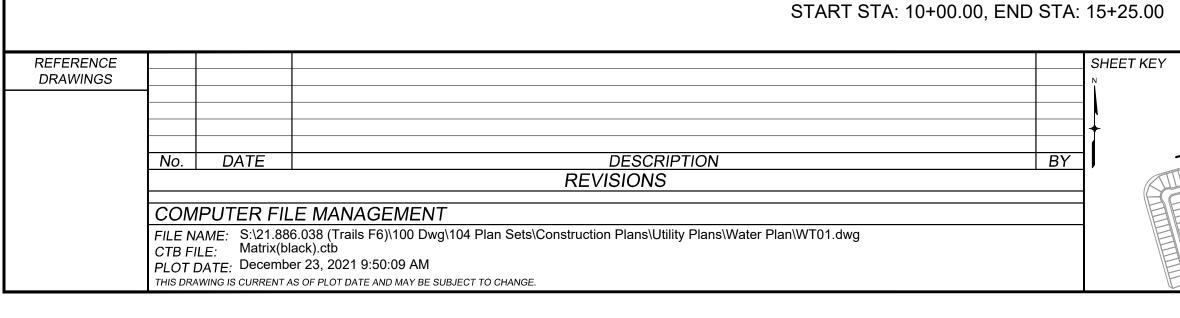

11+00

5920

5915

5905

5890

5885

10+00

CONN. KEYHOLE DR. &

SCHOONOVER DR. 5900

STA. 15+75.52

8" INV. = 5894.04

8" INV. = 5894.04

8"x8" TEE


BEGIN CURVLINEAR PIPE

←STA. 10+30.78

L31 LF 8" PVC @ 2.36%

10+50

\_\_8" INV. = 5894.77

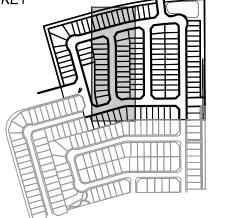

8"x11.25° BEND -

8" INV. = 5898.31

13+50

STA. 14+14.81—

EXIST. GROUND @ PIPE &

64 LF 8" PVC @ 0.00%—

14+00

HYDRANT G\_

STA. 14+78.32

¯33 LF 8" PVC @ 0.00% 🖵

8" INV. = 5898.31

CONN. KEYHOLE DR &

WINNER CREEK DR.

8"x8" TEE-

STA. 12+23.28 —

8" INV. = 5898.31\_

## ENCHMARK

14+50

COLORADO SPRINGS UTILITIES (FIMS) MONUMENT F206 A BERNTSEN TOP SECURITY MONUMENT SYSTEM WITH A 3.5-INCH DIAMETER ALUMINUM CAP IN A ROAD BOX, LOCATED ON THE NORTHWEST CORNER OF FONTAINE BOULEVARD AND POWERS

5920

5915

5910

5905

5900

5895

5890

5885

15

15+00 15+25

BOULEVARD. ELEVATION - 5897.89' U.S. SURVEY FT

# BASIS OF BEARING

BEARINGS ARE BASED ON THE NORTH LINE OF THE NORTHWEST QUARTER OF SECTION 9,



PREPARED BY:




FILING NO. 4 PUBLIC WATERLINE PLANS


## WATERLINE PLAN AND PROFILE


DATE ISSUED: DECEMBER 2021 DRAWING No. DRAWN BY: HORIZ. WT05 7 OF 12 CHECKED BY: NMS

FOR AND ON BEHALF OF MATRIX DESIGN GROUP, INC. PROJECT No. 21.886.038

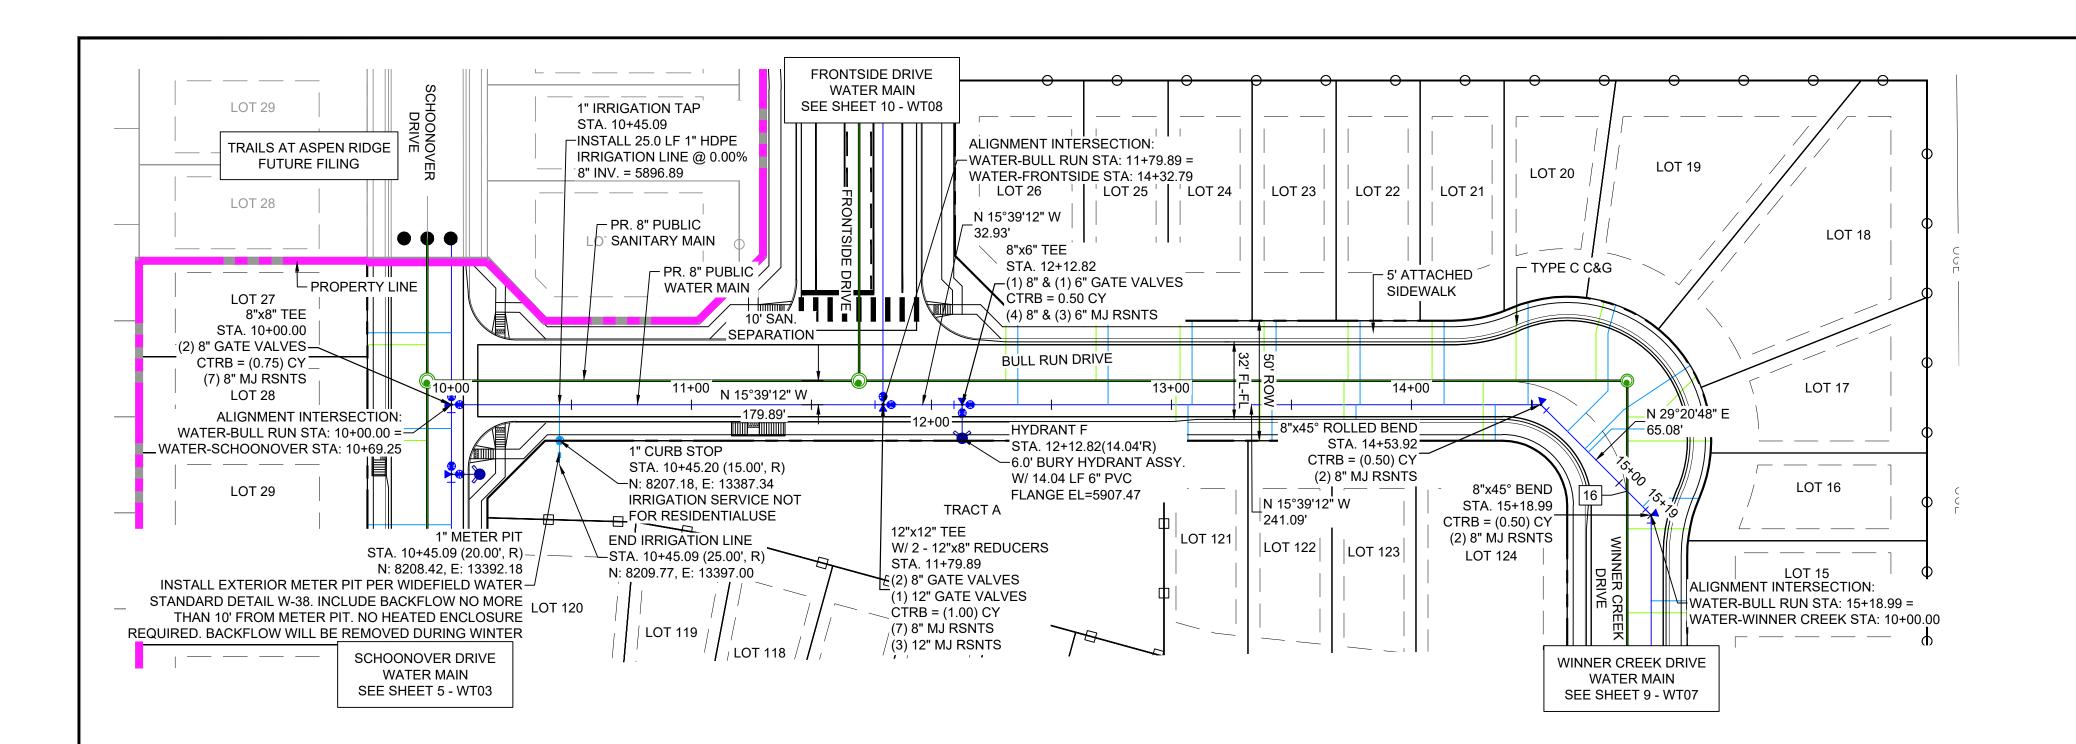




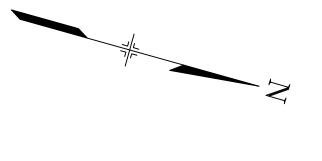

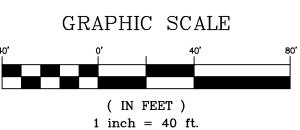

UTILITY CROSSING DETAILS							
CROSSING #	N & E	TOP OF PIPE	BTM OF PIPE	VERT. SEF			
16	N 8641.09 E 13287.58	8" PVC SANITARY 5898.76	8" PVC WATER 5906.56	7.80'			

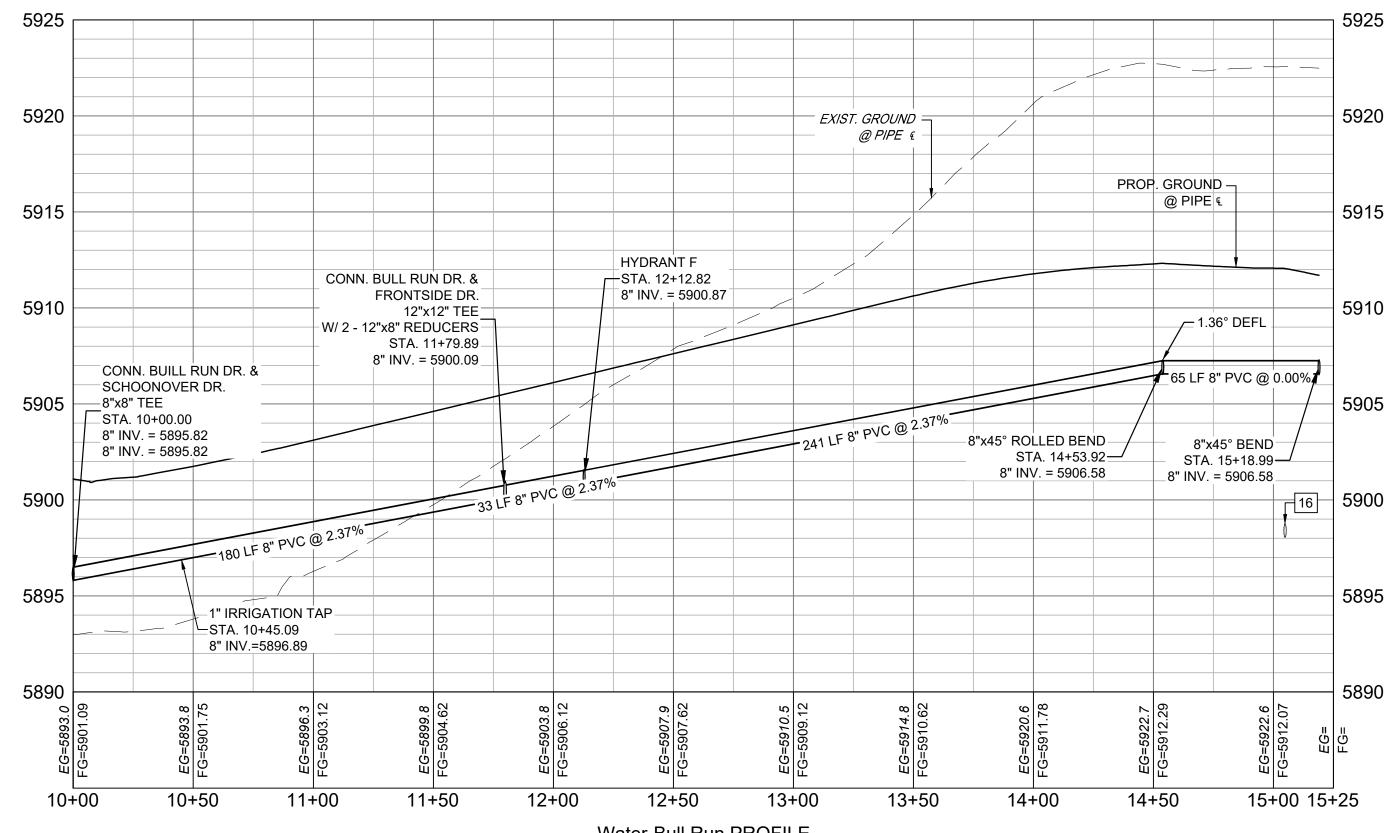

Water-Bull Run PROFILE SCALE: (H) 1" = 40' (V) 1" = 5' START STA: 10+00.00, END STA: 15+25.00

NOTES:

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TRAILS AT ASPEN RIDGE FILING 4 TO PROVIDE WATER LOOPING.

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APPROVAL EXPIRES 180 DAYS FROM DESIGN APPROVAL

TRAILS AT ASPEN RIDGE

FILING NO. 4

DRAWINGS DESCRIPTION No. DATE REVISIONS COMPUTER FILE MANAGEMENT FILE NAME: S:\21.886.038 (Trails F6)\100 Dwg\104 Plan Sets\Construction Plans\Utility Plans\Water Plan\WT01.dwg CTB FILE: Matrix(black).ctb PLOT DATE: December 23, 2021 9:50:19 AM THIS DRAWING IS CURRENT AS OF PLOT DATE AND MAY BE SUBJECT TO CHANGE.

## ENCHMARK

COLORADO SPRINGS UTILITIES (FIMS) MONUMENT F206 A BERNTSEN TOP SECURITY MONUMENT SYSTEM WITH A 3.5-INCH DIAMETER ALUMINUM CAP IN A

ROAD BOX, LOCATED ON THE NORTHWEST CORNER OF FONTAINE BOULEVARD AND POWERS

BOULEVARD. ELEVATION - 5897.89' U.S. SURVEY FT

BASIS OF BEARING BEARINGS ARE BASED ON THE NORTH EINE S.

TOWNSHIP 15 SOUTH, RANGE 65 WEST OF THE 6TH P.M. SAID LINE BEARS S89°51'23"E PROWLINE
NORTHWEST CORNER OF SAID SECTION 9 (2½" AULM. CAP PLS 17664) TO THE N¼ CORNER OF SAID

Office of the second secon BEARINGS ARE BASED ON THE NORTH LINE OF THE NORTHWEST QUARTER OF SECTION 9,




PROJECT No. 21.886.038


PUBLIC WATERLINE PLANS


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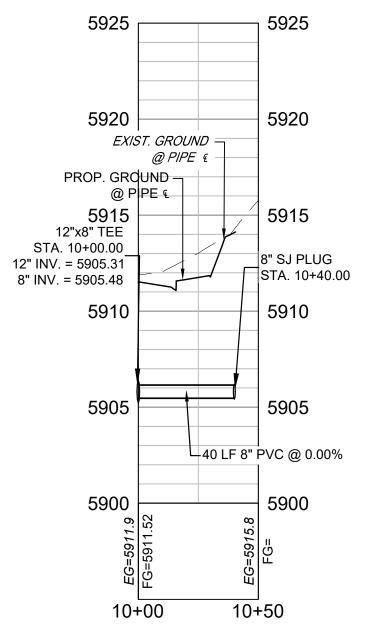
DESIGNED BY:	JSE	SC	ALE	DATE ISSUED:	DECEMBER 2021	DRAWING No.
DRAWN BY:	JSE	HORIZ.	1" = 40'			M/TOG
CHECKED BY:	NMS	VERT.	1" = 5'	SHEET	8 OF 12	WT06






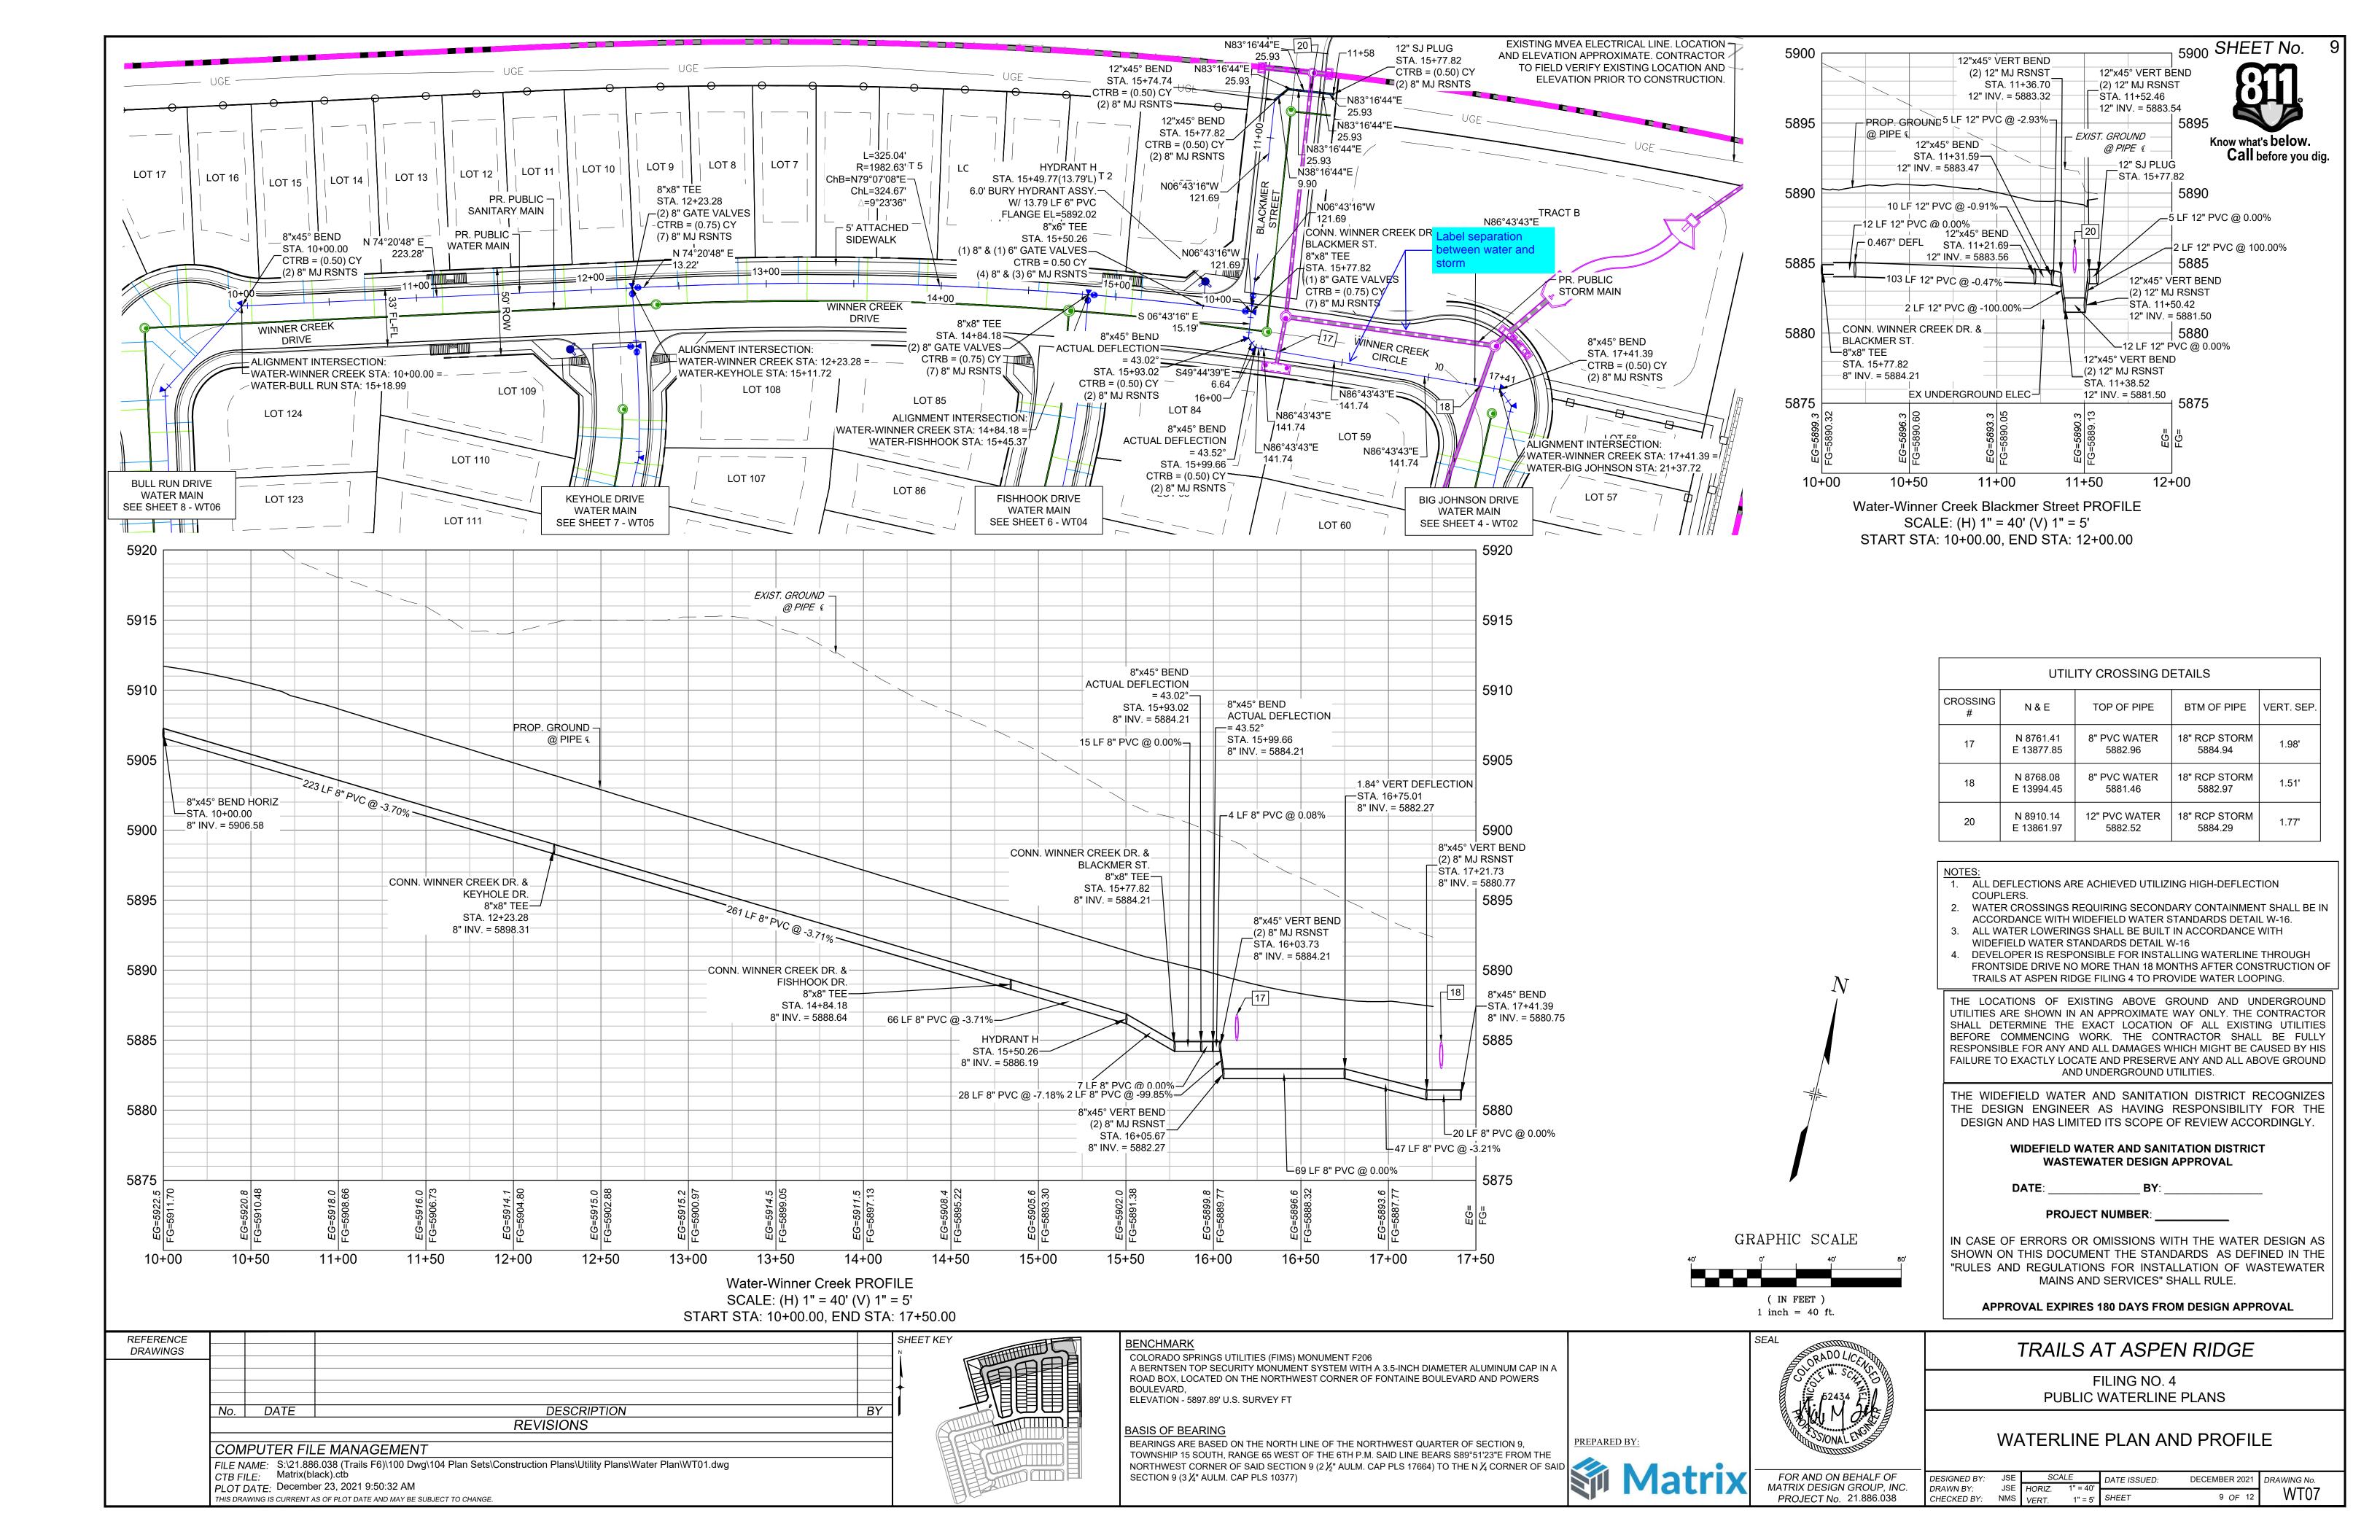


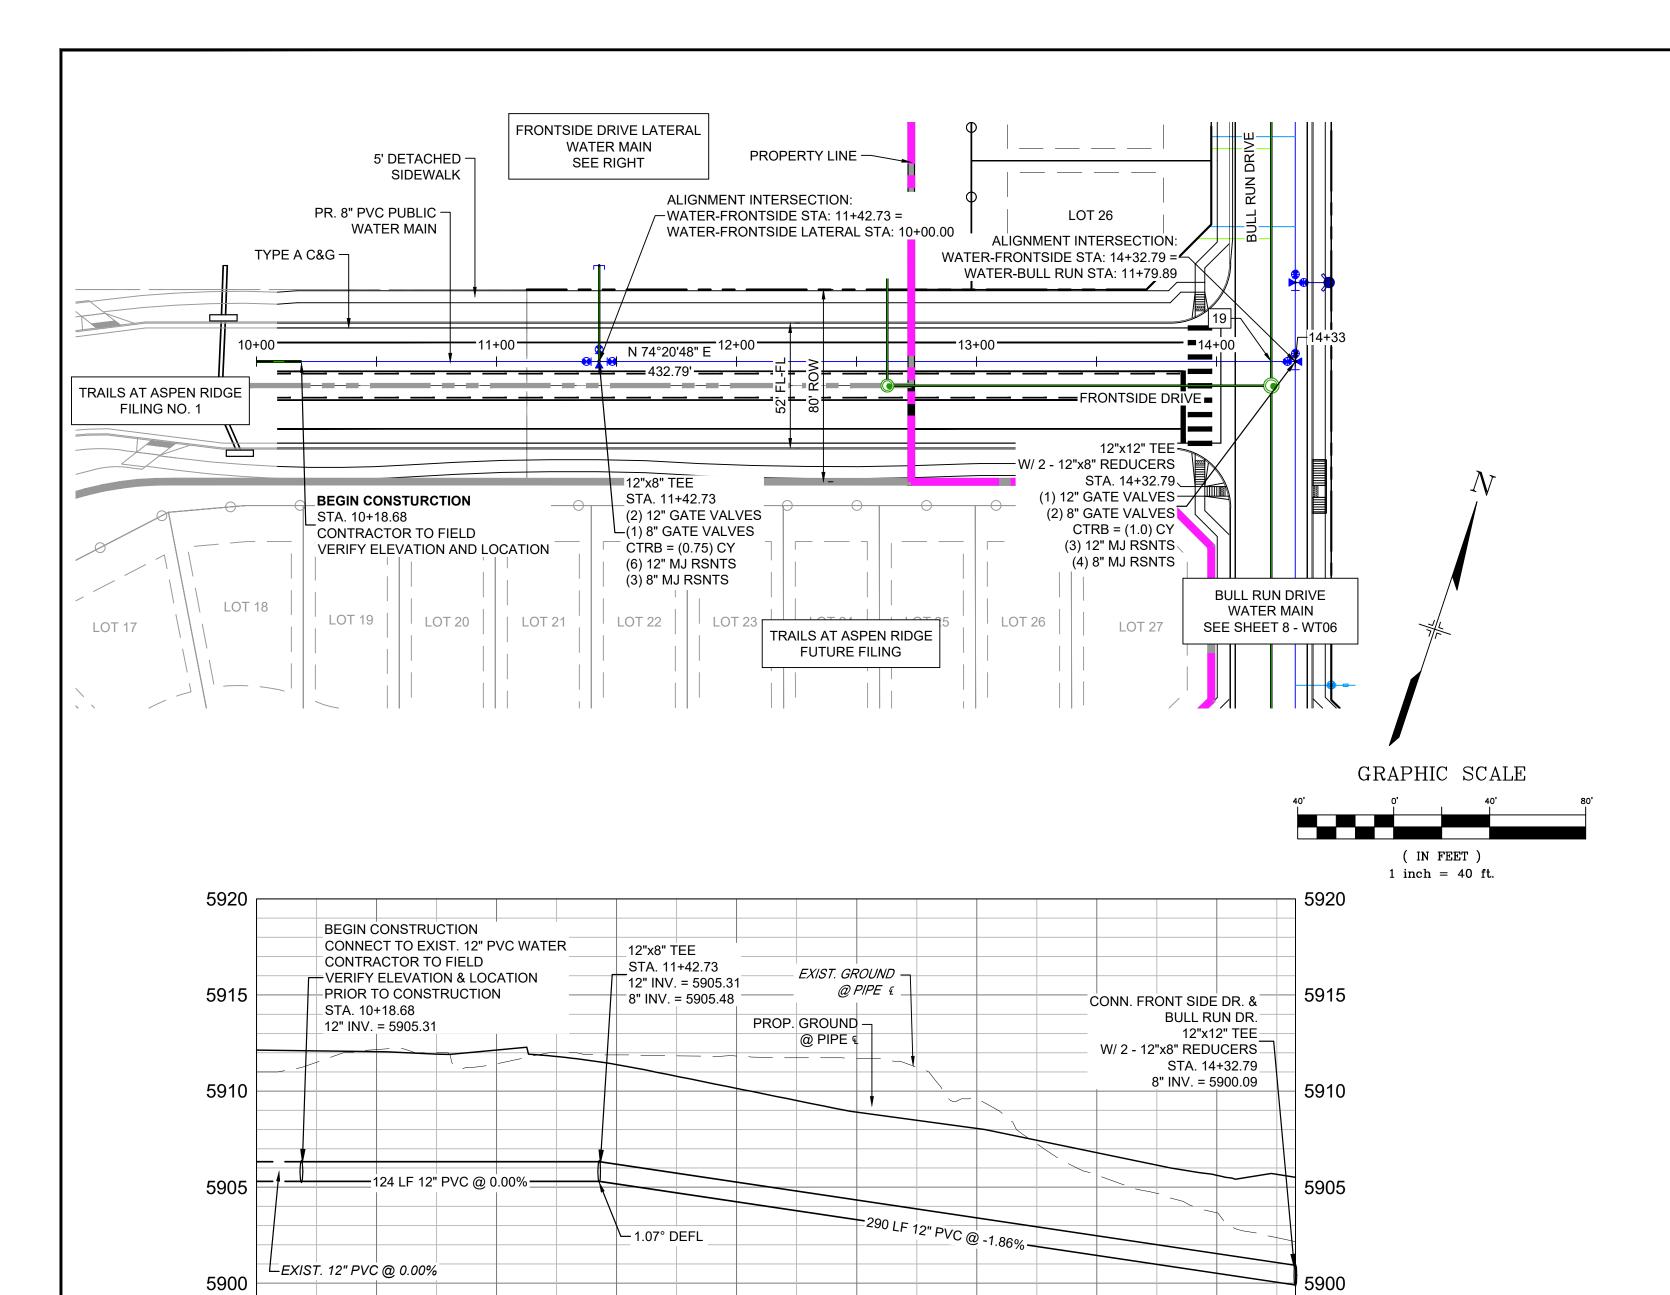

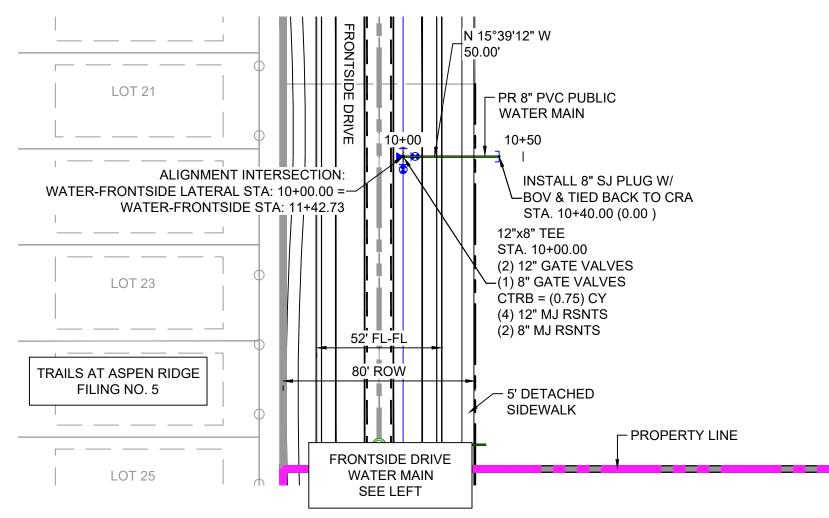


Water-Frontside Lateral PROFILE SCALE: (H) 1" = 40' (V) 1" = 5' START STA: 10+00.00, END STA: 10+50.00

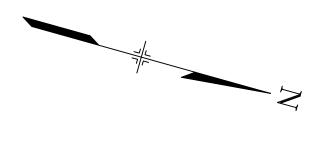

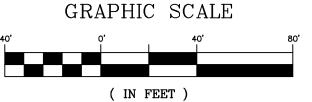

1 inch = 40 ft.

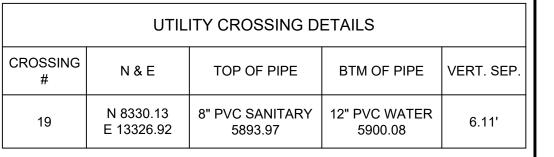

SHEET No. 10

Call before you dig.

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TRAILS AT ASPEN RIDGE

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12+00

Water-Frontside PROFILE SCALE: (H) 1" = 40' (V) 1" = 5' START STA: 10+00.00, END STA: 14+32.79

12+50

13+00

13+50

5895

10+50

11+00

11+50

19

14+00

5895

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# FILING NO. 4 PUBLIC WATERLINE PLANS

# WATERLINE PLAN AND PROFILE

DESIGNED BY:	JSE	SC	ALE	DATE ISSUED:	DECEMBER 2021	DRAWING No.
DRAWN BY:	JSE	HORIZ.	1" = 40'			\\/T\0
CHECKED BY:	NMS	VEDT	1" - 5'	SHFFT	10 OF 12	I VV I UO

FOR AND ON BEHALF OF MATRIX DESIGN GROUP, INC. PROJECT No. 21.886.038

