TRAILS AT ASPEN RIDGE FILING NO. 4

SHEET No.

EL PASO COUNTY, CO

ROADWAY & STORM IMPROVEMENT PLANS

SHEET N	AME S	SHEET No.
TS01	TITLE SHEET	1
GN01 - GN02	ROADWAY GENERAL NOTES	2 - 3
RDX1	ROADWAY CENTERLINE KEY MAP	4
RD01 - RD05	ROADWAY CENTERLINE PLAN & PROFILI	E 5-9
RDX2	ROADWAY FLOWLINE KEY MAP	10
RD06 - RD10	ROADWAY FLOWLINE PLAN & PROFILE	11 - 15
RDX3	ROADWAY INTERSECTION KEY MAP	16
RD11 - RD15	ROADWAY INTERSECTION DETAILS	17 - 21
SN01	SIGNING & STRIPING PLAN	22
SD00	STORM KEY MAP	23
SD01 - SD05	STORM DRAIN PLAN & PROFILE	24 - 28
DT01	POND PLANS	29
DT02 - DT04	POND DETAILS	30 - 32

OWNER/DEVELOPER COLA, LLC

555 MIDDLE CREEK PARKWAY, SUITE 380

COLORADO SPRINGS, CO 80921

(719) 382-9433

CIVIL ENGINEER MATRIX DESIGN GROUP

> 2435 RESEARCH PARKWAY, SUITE 300 COLORADO SPRINGS, CO 80920 NICOLE SCHANEL, (719) 659-6141

WATER & SANITARY

WIDEFIELD WATER AND SANITATION 8495 FONTAINE BOULEVARD COLORADO SPRINGS, CO 80925 ROBERT BANNISTER, (719) 390-7111

ELECTRIC MOUNTAINVIEW ELECTRIC ASSOCIATION

(719) 495-2283

GAS

COLORADO SPRINGS UTILITIES 1521 HANCOCK EXPRESSWAY COLORADO SPRINGS, CO MARY HOAGLUND (719) 668-4083

STREET


EL PASO COUNTY PUBLIC SERVICES


DEPARTMENT (719) 520-6460

DRAINAGE EL PASO COUNTY PUBLIC SERVICES DEPARTMENT (719) 520-6460

FIRE DEPARTMENT SECURITY FIRE DEPARTMENT

> 400 SECURITY BOULEVARD SECURITY, CO 80911 (719) 392-7121

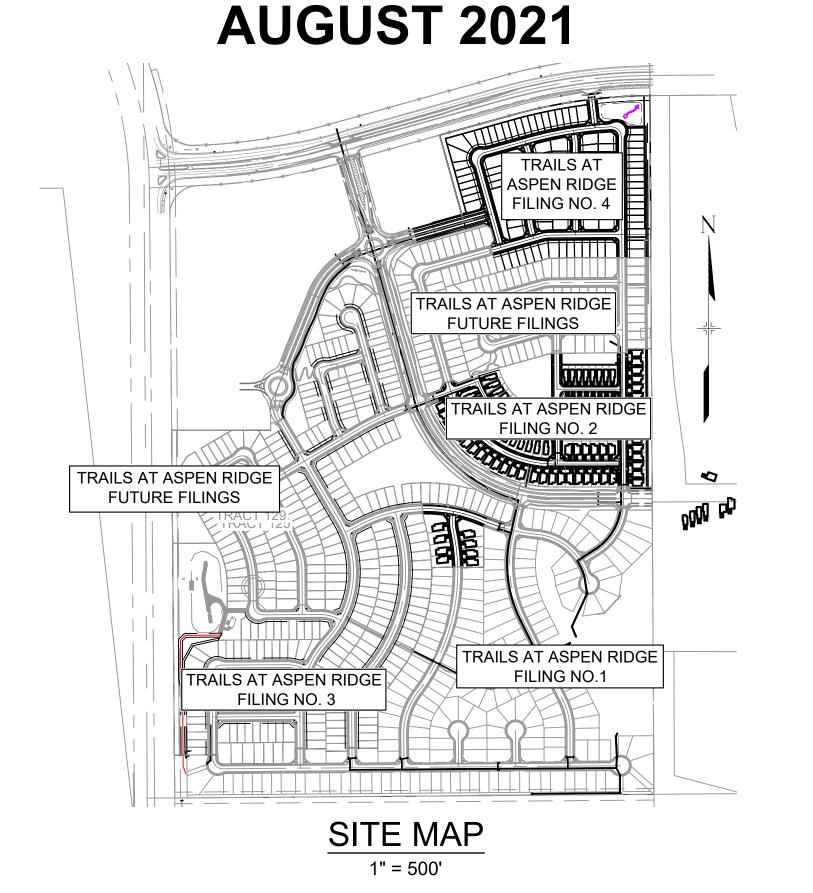

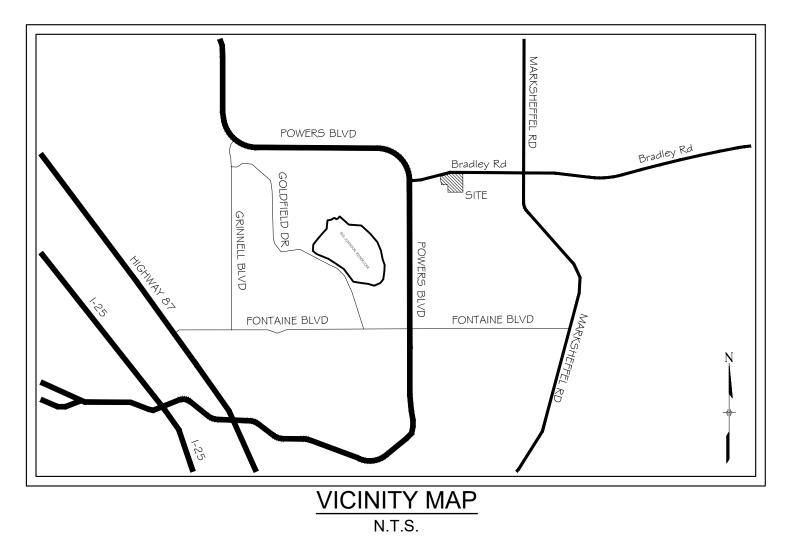

ENGINEER'S STATEMENT:

COUNTY FOR DETAILED DRAINAGE PLANS AND SPECIFICATIONS, AND SAID DETAILED PLANS AND SPECIFICATIONS ARE

Date: 01/10/203

NICOLE SCHANEL, PE #52434 FOR AND ON BEHALF OF MATRIX DESIGN GROUP, INC.

EL PASO COUNTY:

COUNTY IS NOT RESPONSIBLE FOR THE ACCURACY AND ADEQUACY OF THE DESIGN, DIMENSIONS, AND/OR ELEVATIONS WHICH SHALL BE CONFIRMED AT THE JOB SITE. THE COUNTY THROUGH THE APPROVAL OF THIS

CRITERIA MANUAL. VOLUMES 1 AND 2, AND ENGINEERING CRITERIA MANUAL AS AMENDED.

CONSTRUCTION HAS NOT STARTED WITHIN THOSE 2 YEARS, THE PLANS WILL NEED TO BE RESUBMITTED FOR APPROVAL, INCLUDING PAYMENT OF REVIEW FEES AT THE PLANNING AND COMMUNITY DEVELOPMENT DIRECTORS DISCRETION.

JOSHUA PALMER, P.E. COUNTY ENGINEER / ECM ADMINISTRATOR DATE

OWNER/DEVELOPER:

I, THE OWNER/DEVELOPER HAVE READ AND WILL COMPLY WITH THE REQUIREMENTS OF THE GRADING AND EROSION CONTROL PLAN AND ALL OF THE REQUIREMENTS SPECIFIED IN THESE DETAILED PLANS AND SPECIFICATIONS.

TIM BUSCHAR

DIRECTOR OF LAND ACQUISITION AND DEVELOPMENT COLA, LLC

555 MIDDLE PARKWAY COLORADO SPRINGS, CO 80921

SF-21-024


REFERENCE DRAWINGS			
	No. DATE	DESCRIPTION	BY
		REVISIONS	
	COMPUTER FILE MANAGEMENT		
	FILE NAME: S:\21.886.038 (Trails F6)\100 Dwg\104 Plan Set CTB FILE: Matrix(black).ctb PLOT DATE: January 4, 2023 1:34:31 PM	s\Construction Plans\Road & Storm Plans\TS01.dwg	
	THIS DRAWING IS CURRENT AS OF PLOT DATE AND MAY BE SUBJECT TO CHANG	E.	

BENCHMARK COLORADO SPRINGS UTILITIES (FIMS) MONUMENT F206 A BERNTSEN TOP SECURITY MONUMENT SYSTEM WITH A 3.5-INCH DIAMETER ALUMINUM CAP IN A ROAD BOX, LOCATED ON THE NORTHWEST CORNER OF FONTAINE BOULEVARD AND POWERS

ELEVATION - 5897.89' U.S. SURVEY FT

PREPARED BY: BEARINGS ARE BASED ON THE NORTH LINE OF THE NORTHWEST QUARTER OF SECTION 9, TOWNSHIP 15 SOUTH, RANGE 65 WEST OF THE 6TH P.M. SAID LINE BEARS S89°51'23"E FROM THE NORTHWEST CORNER OF SAID SECTION 9 (2 1/2" AULM. CAP PLS 17664) TO THE N 1/4 CORNER OF SAID SECTION 9 (3 1/4" AULM. CAP PLS 10377)



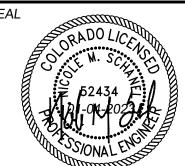

TRAILS AT ASPEN RIDGE FILING NO. 4

ROADWAY & STORM IMPROVEMENT PLANS

TITLE SHEET

MATRIX DESIGN GROUP, INC. PROJECT No. 21.886.038

DESIGNED BY: CAG DRAWN BY: CAG

SCALE DATE ISSUED: AUGUST 2021 DRAWING No. 1 OF 32

RELATED WORK ITEM.

- 1. ALL WORK SHALL BE DONE IN ACCORDANCE WITH THE EL PASO COUNTY ENGINEERING CRITERIA MANUAL AND CDOT STANDARD SPECIFICATIONS, LATEST REVISION.
- 2. IT SHALL BE THE CONTRACTOR'S RESPONSIBILITY TO ENSURE THAT ALL WORK IS PERFORMED IN ACCORDANCE WITH APPLICABLE STANDARDS AND REGULATIONS AS SET FORTH BY THE OCCUPATIONAL SAFETY AND HEALTH ADMINISTRATION (O.S.H.A.).
- 3. NO FIELD CHANGES SHALL BE MADE WITHOUT PRIOR WRITTEN APPROVAL OF THE FIELD
- 4. SUBMITTALS SHALL BE MADE FOR ALL MATERIALS TO BE INCORPORATED INTO THE PROJECT
- 5. UTILITY LINES AS SHOWN ON THE PLAN SHEETS ARE PLOTTED FROM THE BEST AVAILABLE INFORMATION. THE CONTRACTOR SHALL BE RESPONSIBLE FOR THE VERIFICATION AND PROTECTION OF ALL UTILITIES IN PLACE.
- 6. THE CONTRACTOR SHALL CONTACT THE UTILITY NOTIFICATION CENTER OF COLORADO AT 1-800-922-1987 TWO BUSINESS DAYS IN ADVANCE OF ANY EXCAVATION OR GRADING.
- 7. THE CONTRACTOR SHALL PROTECT AND MAINTAIN ALL UTILITY AND STRUCTURES AFFECTED BY THE WORK AND ANY DAMAGE SHALL BE REPAIRED AND RESTORED TO THE SATISFACTION OF THE RESPECTIVE UTILITY OWNER. THE CONTRACTOR IS RESPONSIBLE FOR THE LOCATION AND PROTECTION OF ALL UTILITIES DURING CONSTRUCTION. THE CONTRACTOR SHALL COORDINATE ALL UTILITY RELOCATIONS AS NECESSARY. THE COUNTY ENGINEERING INSPECTIONS, UTILITY DEPARTMENTS AND UTILITY OWNERS SHALL BE NOTIFIED A MINIMUM OF 48 HOURS PRIOR TO COMMENCING WORK WHERE THESE UTILITIES MAY BE AFFECTED
- IN SOME OF THE PROPOSED AREAS OF CONSTRUCTION EXISTING UNDERGROUND TELEPHONE, FIBER AND CABLE TELEVISION FACILITIES MAY BE LOCATED IN CLOSE PROXIMITY TO THE WORK. THE CONTRACTOR MAY, IF NECESSARY, TEMPORARILY DISPLACE THE CABLES DURING CONSTRUCTION AND REINSTALL THEM IN ACCORDANCE WITH THE APPROPRIATE TELEPHONE, FIBER OR CABLE COMPANY'S GUIDELINES. COORDINATION WITH BOTH THE TELEPHONE AND CABLE TELEVISION COMPANY IS REQUIRED TO BE DONE BY THE CONTRACTOR
- 9. THE CONTRACTOR SHALL OBTAIN AN APPROVED TRAFFIC CONTROL PLAN PRIOR TO COMMENCING CONSTRUCTION ACTIVITIES.
- 10. THE PHYSICAL FEATURES WITHIN THE LIMITS OF THE PROJECT HAVE BEEN SHOWN BASED ON THE BEST AVAILABLE INFORMATION AT THE TIME OF DESIGN. THE ENGINEER ASSUMES NO RESPONSIBILITY FOR THE ACCURACY OF THE FEATURES SHOWN. THE CONTRACTOR SHALL REVIEW AND VERIFY EXISTING PHYSICAL FEATURES AND ELEVATIONS THEMSELVES OF THE CONDITIONS TO BE ENCOUNTERED DURING THE CONSTRUCTION.
- 11. THE CONTRACTOR SHALL LIMIT ALL WORK AND STORAGE AREAS TO THE PUBLIC RIGHT-OF-WAYS AND EASEMENTS. USE OF ANY PRIVATE AREAS FOR THIS PROJECT BY THE CONTRACTOR MUST BE APPROVED IN WRITING BY THE PROPERTY OWNER WITH A COPY OF
- THIS APPROVAL PROVIDED TO THE FIELD ENGINEER PRIOR TO USAGE. 12. ALL CONSTRUCTION IS TO INCLUDE COMPACTION AND FINISH GRADING IN THE UNIT PRICE
- 13. ALL WORK SHALL BE DONE TO THE LINES, GRADES, SECTIONS, AND ELEVATIONS SHOWN ON THE PLANS UNLESS OTHERWISE NOTED OR APPROVED BY THE FIELD ENGINEER.
- 14. ALL MATERIALS AND WORKMANSHIP SHALL BE SUBJECT TO INSPECTION AND APPROVAL BY EL PASO COUNTY AND THE FIELD ENGINEER.
- 15. THE FIELD ENGINEER SHALL BE NOTIFIED WITHIN 48 HOURS PRIOR TO THE COMMENCEMENT OF ANY CONSTRUCTION.
- 16. PAYMENT, DIMENSIONS AND RADII ARE SHOWN TO THE LIP OF CURB UNLESS OTHERWISE NOTED.
- 17. THE CONTRACTOR SHALL LIMIT CONSTRUCTION ACTIVITIES TO THOSE AREAS WITHIN THE LIMITS OF DISTURBANCE AND/OR TOES OF SLOPE AS SHOWN ON THE PLANS. ANY DISTURBANCE BEYOND THESE LIMITS SHALL BE RESTORED TO ORIGINAL CONDITIONS BY THE CONTRACTOR AT HIS/HER OWN EXPENSE.
- 18. THE CONTRACTOR SHALL CLOSELY MONITOR ACCESS FOR HEAVY CONSTRUCTION EQUIPMENT THROUGH THE PROJECT AREAS.
- 19. WHERE PAVEMENT IS TO ABUT EXISTING PAVEMENT, THE EXISTING PAVEMENT SHALL BE REMOVED TO A NEAT VERTICAL LINE BY FULL DEPTH SAWING. SAWING WILL NOT BE PAID FOR SEPARATELY BUT SHALL BE INCIDENTAL TO "REMOVAL OF ASPHALT PAVEMENT". THE CONTRACTOR WILL BE REQUIRED TO PAINT THE EDGE OF CUT PAVEMENT WITH DILUTED EMULSIFIED ASPHALT (SLOW SETTING) PRIOR TO PAVING OPERATIONS. VERTICAL EDGES SHALL NOT REMAIN OVERNIGHT. DILUTED EMULSIFIED ASPHALT FOR TACK COAT SHALL CONSIST OF ONE PART EMULSIFIED ASPHALT AND ONE PART WATER.
- 20. WATER SHALL BE USED AS A DUST PALLIATIVE WHERE REQUIRED. LOCATIONS SHALL BE AS ORDERED. THE COST OF WATER SHALL BE INCIDENTAL TO OTHER BID ITEMS.
- 21. THE PHYSICAL FEATURES REQUIRING REMOVAL OR OBLITERATION WITHIN THE PROJECT SHALL BECOME THE PROPERTY OF THE CONTRACTOR AND BE DISPOSED OF OFF-SITE.
- 22. THE CONTRACTOR SHALL BE RESPONSIBLE FOR PRESERVING ANY MONUMENT, RANGE POINTS, TIES, BENCHMARKS AND/OR SURVEY CONTROL POINTS WHICH MAY BE DISTURBED OR DESTROYED BY CONSTRUCTION. SUCH POINTS SHALL BE REFERENCED AND REPLACED WITH APPROPRIATE MONUMENT BY A REGISTERED PROFESSIONAL LAND SURVEYOR AUTHORIZED TO PRACTICE LAND SURVEYING IN THE STATE OF COLORADO.
- 23. THE CONTRACTOR SHALL HAVE A COPY OF ALL APPLICABLE STANDARDS AND PLANS ON SITE FOR THE DURATION OF THE PROJECT.
- 24. THE CONTRACTOR SHALL NOT STOCKPILE MATERIAL WITHIN 10 FEET OF THE EDGE OF TRAVELED WAY.
- 25. ANY LAYER OF BITUMINOUS PAVEMENT THAT IS TO HAVE SUCCEEDING LAYER PLACED THEREON SHALL BE COMPLETED FULL WIDTH BEFORE SUCCEEDING LAYER IS PLACED.
- 26. BEFORE PLACEMENT OF THE TACK COAT, THE CONTRACTOR SHALL CLEAN THE PRESENT ROADWAY AS DIRECTED. CLEANING WILL NOT BE PAID FOR SEPARATELY, BUT SHALL BE INCLUDED IN THE COST OF THE PROJECT.
- 27. A TACK COAT OF EMULSIFIED ASPHALT (SLOW SETTING) IS TO BE APPLIED BETWEEN PAVEMENT COURSES TO IMPROVE BOND. DILUTED EMULSIFIED ASPHALT FOR TACK COAT SHALL CONSIST OF 1 PART EMULSIFIED ASPHALT AND 1 PART WATER.

- 28. THE CONTRACTOR SHALL FURNISH, INSTALL, AND MAINTAIN TEMPORARY TRAFFIC CONTROL DEVICES NECESSARY THROUGHOUT THE DURATION OF CONSTRUCTION. THE CONTRACTOR SHALL CONTACT TRAFFIC ENGINEERING FORTY-EIGHT (48) HOURS IN ADVANCE FOR ANY REQUIRED MODIFICATION OF TRAFFIC SIGNALS WITHIN CONSTRUCTION AREAS AS NECESSARY TO MAINTAIN SAFE OPERATIONS.
- 29. ANY DISCREPANCY WITHIN THESE PLANS SHOULD BE BROUGHT TO THE IMMEDIATE ATTENTION OF THE ENGINEER AND WORK SHALL STOP UNTIL THE DISCREPANCY IS DISCUSSED AND DECISIONS/AGREEMENTS HAVE BEEN MADE.

EARTHWORK:

- 1. THE CONTRACTOR SHALL BE RESPONSIBLE FOR THE LEGAL DISPOSAL OF ANY EXCESS SOIL, DEBRIS AND WASTE MATERIAL OFF OF THE PROJECT SITE.
- 2. ANY MATERIAL NOT SUITABLE FOR BACKFILL SHALL BE REMOVED FROM THE SITE AND DISPOSED OF, BY AND AT THE EXPENSE OF THE CONTRACTOR.
- 3. ANY SOIL LYING BELOW THE SUBGRADE ELEVATION WHICH IS DISTURBED BY CONSTRUCTION OPERATIONS SHALL BE REMOVED AND REPLACED WITH STRUCTURAL FILL IN ACCORDANCE WITH THE SPECIFICATION REQUIREMENTS.

BENCHMARK AND SURVEY CONTROL

- 1. THE CONTRACTOR SHALL BE RESPONSIBLE FOR CONSTRUCTION STAKING OF BOTH HORIZONTAL AND VERTICAL LAYOUT ON THIS PROJECT. COORDINATES ARE REFERENCED IN THE COORDINATE LIST SHOWN ON THESE PLANS. THE CONTRACTOR SHALL COORDINATE WITH THE PROJECT ENGINEER FOR INTERPRETATION AND INFORMATION IN STAKING OF THE PROJECT FOR CONSTRUCTION.
- 2. PRIOR TO PROJECT COMPLETION, THE CONTRACTOR SHALL BE RESPONSIBLE FOR THE REPLACEMENT OF ANY PROPERTY MONUMENTATION DISTURBED OR REMOVED BY CONSTRUCTION OPERATIONS. THIS WORK SHALL BE PERFORMED BY A LAND SURVEYOR LICENSED IN THE STATE OF COLORADO. PROPERTY CORNERS WHICH FALL WITHIN NEW CONCRETE FLATWORK SHALL BE DURABLE AND SET FLUSH. THIS SHALL BE CONSIDERED INCIDENTAL TO THE PROJECT.

TRAFFIC GENERAL NOTES:

- 1. THE CONTRACTOR SHALL PREPARE A DETAILED TRAFFIC CONTROL PLAN, SUBMIT TO EL PASO COUNTY DEPARTMENT OF PUBLIC WORKS FOR APPROVAL, AND OBTAIN APPROPRIATE PERMITS IN ACCORDANCE WITH THE M.U.T.C.D.
- 2. THE CONTRACTOR SHALL BE RESPONSIBLE FOR ALL WORK ZONE TRAFFIC CONTROL, INCLUDING PEDESTRIAN DETOURS. CONTRACTOR SHALL BE RESPONSIBLE FOR FURNISHING, INSTALLING, AND MAINTAINING THE TEMPORARY TRAFFIC CONTROL DEVICES THROUGHOUT THE DURATION OF THE PROJECT.
- 3 APPROVAL OF THESE PLANS BY THE COUNTY ENGINEER DOES NOT AUTHORIZE ANY WORK TO BE PERFORMED UNTIL A PERMIT HAS BEEN ISSUED.
- 4. THE APPROVAL OF THESE PLANS OR ISSUANCE OF A PERMIT BY EL PASO COUNTY DOES NOT AUTHORIZE THE OWNER OR CONTRACTOR TO VIOLATE ANY FEDERAL, STATE OR CITY LAWS, ORDINANCES, REGULATIONS, OR POLICIES.
- 5. ALL TRAFFIC SIGNS, PAVEMENT MARKINGS, AND TRAFFIC SIGNALS SHALL MEET OR EXCEED M.U.T.C.D. STANDARDS.
- 6. THE CONTRACTOR SHALL NOT REMOVE ANY EXISTING SIGNS, PAVEMENT MARKINGS, OR TRAFFIC SIGNALS DURING THE PROJECT WITHOUT SIGNED AUTHORIZATION OF THE EL PASO COUNTY INSPECTOR ASSIGNED TO THE PROJECT.

CONSTRUCTION NOTES

d. CDOT M & S STANDARDS

- ALL DRAINAGE AND ROADWAY CONSTRUCTION SHALL MEET THE STANDARDS AND SPECIFICATIONS OF THE CITY OF COLORADO SPRINGS/EL PASO COUNTY DRAINAGE CRITERIA MANUAL, VOLUMES 1 AND 2, AND THE EL PASO COUNTY ENGINEERING CRITERIA MANUAL.
- 2. CONTRACTOR SHALL BE RESPONSIBLE FOR THE NOTIFICATION AND FIELD NOTIFICATION OF ALL EXISTING UTILITIES. WHETHER SHOWN ON THE PLANS OR NOT. BEFORE BEGINNING CONSTRUCTION. LOCATION OF EXISTING UTILITIES SHALL BE VERIFIED BY THE CONTRACTOR PRIOR TO CONSTRUCTION. CALL 811 TO CONTACT THE UTILITY NOTIFICATION CENTER OF COLORADO (UNCC).
- 3. CONTRACTOR SHALL KEEP A COPY OF THESE APPROVED PLANS, THE GRADING AND EROSION CONTROL PLAN. THE STORMWATER MANAGEMENT PLAN (SWMP). THE SOILS AND GEOTECHNICAL REPORT. AND THE APPROPRIATE DESIGN AND CONSTRUCTION STANDARDS AND SPECIFICATIONS
- AT THE JOB SITE AT ALL TIMES, INCLUDING THE FOLLOWING a. EL PASO COUNTY ENGINEERING CRITERIA MANUAL (ECM)
 - b. CITY OF COLORADO SPRINGS/EL PASO COUNTY DRAINAGE CRITERIA MANUAL, VOLUMES 1
 - c. COLORADO DEPARTMENT OF TRANSPORTATION (CDOT) STANDARD SPECIFICATIONS FOR ROAD AND BRIDGE CONSTRUCTION
- 4. NOTWITHSTANDING ANYTHING DEPICTED IN THESE PLANS IN WORDS OR GRAPHIC REPRESENTATION, ALL DESIGN AND CONSTRUCTION RELATED TO ROADS, STORM DRAINAGE AND EROSION CONTROL SHALL CONFORM TO THE STANDARDS AND REQUIREMENTS OF THE MOST RECENT VERSION OF THE RELEVANT ADOPTED EL PASO COUNTY STANDARDS, INCLUDING THE LAND DEVELOPMENT CODE, THE ENGINEERING CRITERIA MANUAL, THE DRAINAGE CRITERIA MANUAL, AND THE DRAINAGE CRITERIA MANUAL VOLUME 2. ANY DEVIATIONS FROM REGULATIONS AND STANDARDS MUST BE REQUESTED, AND APPROVED, IN WRITING. ANY MODIFICATIONS NECESSARY TO MEET CRITERIA AFTER-THE-FACT WILL BE ENTIRELY THE DEVELOPER'S RESPONSIBILITY TO RECTIFY.
- IT IS THE DESIGN ENGINEER'S RESPONSIBILITY TO ACCURATELY SHOW EXISTING CONDITIONS, BOTH ONSITE AND OFFSITE, ON THE CONSTRUCTION PLANS. ANY MODIFICATIONS NECESSARY DUE TO CONFLICTS, OMISSIONS, OR CHANGED CONDITIONS WILL BE ENTIRELY THE DEVELOPER'S RESPONSIBILITY TO RECTIFY.

- 6. CONTRACTOR SHALL SCHEDULE A PRE-CONSTRUCTION MEETING WITH EL PASO COUNTY PLANNING AND COMMUNITY DEVELOPMENT (PCD) - INSPECTIONS, PRIOR TO STARTING CONSTRUCTION.
- 7. IT IS THE CONTRACTOR'S RESPONSIBILITY TO UNDERSTAND THE REQUIREMENTS OF ALL JURISDICTIONAL AGENCIES AND TO OBTAIN ALL REQUIRED PERMITS, INCLUDING BUT NOT LIMITED TO EL PASO COUNTY EROSION AND STORMWATER QUALITY CONTROL PERMIT (ESQCP), REGIONAL BUILDING FLOODPLAIN DEVELOPMENT PERMIT, U.S. ARMY CORPS OF ENGINEERS-ISSUED 401 AND/OR 404 PERMITS, AND COUNTY AND STATE FUGITIVE DUST PERMITS.
- 8. CONTRACTOR SHALL NOT DEVIATE FROM THE PLANS WITHOUT FIRST OBTAINING WRITTEN APPROVAL FROM THE DESIGN ENGINEER AND PCD. CONTRACTOR SHALL NOTIFY THE DESIGN ENGINEER IMMEDIATELY UPON DISCOVERY OF ANY ERRORS OR INCONSISTENCIES.
- 9. ALL STORM DRAIN PIPE SHALL BE CLASS III RCP UNLESS OTHERWISE NOTED AND APPROVED BY PCD.
- 10. CONTRACTOR SHALL COORDINATE GEOTECHNICAL TESTING PER ECM STANDARDS. PAVEMENT DESIGN SHALL BE APPROVED BY EL PASO COUNTY PCD PRIOR TO PLACEMENT OF CURB AND GUTTER AND PAVEMENT.
- 11. ALL CONSTRUCTION TRAFFIC MUST ENTER/EXIT THE SITE AT APPROVED CONSTRUCTION ACCESS
- 12. SIGHT VISIBILITY TRIANGLES AS IDENTIFIED IN THE PLANS SHALL BE PROVIDED AT ALL INTERSECTIONS. OBSTRUCTIONS GREATER THAN 18 INCHES ABOVE FLOWLINE ARE NOT ALLOWED WITHIN SIGHT TRIANGLES.
- 13. SIGNING AND STRIPING SHALL COMPLY WITH EL PASO COUNTY DOT AND MUTCD CRITERIA. [IF APPLICABLE. ADDITIONAL SIGNING AND STRIPING NOTES WILL BE PROVIDED.1
- 14. CONTRACTOR SHALL OBTAIN ANY PERMITS REQUIRED BY EL PASO COUNTY DOT, INCLUDING WORK WITHIN THE RIGHT-OF-WAY AND SPECIAL TRANSPORT PERMITS.
- 15. THE LIMITS OF CONSTRUCTION SHALL REMAIN WITHIN THE PROPERTY LINE UNLESS OTHERWISE NOTED. THE OWNER/DEVELOPER SHALL OBTAIN WRITTEN PERMISSION AND EASEMENTS, WHERE REQUIRED, FROM ADJOINING PROPERTY OWNER(S) PRIOR TO ANY OFF-SITE DISTURBANCE, GRADING, OR CONSTRUCTION.

SIGNING & STRIPING NOTES:

- 1. ALL SIGNS AND PAVEMENT MARKINGS SHALL BE IN COMPLIANCE WITH THE CURRENT MANUAL ON UNIFORM TRAFFIC CONTROL DEVICES (MUTCD).
- 2. REMOVAL OF EXISTING PAVEMENT MARKINGS SHALL BE ACCOMPLISHED BY A METHOD THAT DOES NOT MATERIALLY DAMAGE THE PAVEMENT. THE PAVEMENT MARKINGS SHALL BE REMOVED TO THE EXTENT THAT THEY WILL NOT BE VISIBLE UNDER DAY OR NIGHT CONDITIONS. AT NO TIME WILL IT BE ACCEPTABLE TO PAINT OVER EXISTING PAVEMENT MARKINGS.
- 3. ANY DEVIATION FROM THE STRIPING AND SIGNING PLAN SHALL BE APPROVED BY EL PASO COUNTY PLANNING AND COMMUNITY DEVELOPMENT.
- 4. ALL SIGNS SHOWN ON THE SIGNING AND STRIPING PLAN SHALL BE NEW SIGNS. EXISTING SIGNS MAY REMAIN OR BE REUSED IF THEY MEET CURRENT EL PASO COUNTY AND MUTCD STANDARDS.
- 5. STREET NAME AND REGULATORY STOP SIGNS SHALL BE ON THE SAME POST AT INTERSECTIONS.
- ALL REMOVED SIGNS SHALL BE DISPOSED OF IN A PROPER MANNER BY THE CONTRACTOR.
- 7. ALL STREET NAME SIGNS SHALL HAVE "D" SERIES LETTERS, WITH LOCAL ROADWAY SIGNS BEING 4" UPPER-LOWER CASE LETTERING ON 8" BLANK AND NON-LOCAL ROADWAY SIGNS BEING 6" LETTERING, UPPER-LOWER CASE ON 12" BLANK, WITH A WHITE BORDER THAT IS NOT RECESSED. MULTI-LANE ROADWAYS WITH SPEED LIMITS OF 40 MPH OR HIGHER SHALL HAVE 8" UPPER-LOWER CASE LETTERING ON 18" BLANK WITH A WHITE BORDER THAT IS NOT RECESSED. THE WIDTH OF THE NON-RECESSED WHITE BORDERS SHALL MATCH PAGE 255 OF THE 2012 MUTCD "STANDARD HIGHWAY SIGNS"
- 8. ALL TRAFFIC SIGNS SHALL HAVE A MINIMUM HIGH INTENSITY PRISMATIC GRADE SHEETING.
- 9. ALL LOCAL RESIDENTIAL STREET SIGNS SHALL BE MOUNTED ON A 1.75" X 1.75" SQUARE TUBE SIGN POST AND STUB POST BASE. FOR OTHER APPLICATIONS, REFER TO THE CDOT STANDARD S-614-8 REGARDING USE OF THE P2 TUBULAR STEEL POST SLIPBASE DESIGN.
- 10. ALL SIGNS SHALL BE SINGLE SHEET ALUMINUM WITH 0.100" MINIMUM THICKNESS.
- 11. ALL LIMIT LINES/STOP LINES, CROSSWALK LINES, PAVEMENT LEGENDS, AND ARROWS SHALL BE A MINIMUM 125 MIL THICKNESS PREFORMED THERMOPLASTIC PAVEMENT MARKINGS WITH TAPERED LEADING EDGES PER CDOT STANDARD S-627-1. WORD AND SYMBOL MARKINGS SHALL BE THE NARROW TYPE. STOP BARS SHALL BE 24" IN WIDTH. CROSSWALKS LINES SHALL BE 12" WIDE AND 8' LONG PER
- 12. ALL LONGITUDINAL LINES SHALL BE A MINIMUM 15MIL THICKNESS EPOXY PAINT. ALL NON-LOCAL RESIDENTIAL ROADWAYS SHALL INCLUDE BOTH RIGHT AND LEFT EDGE LINE STRIPING AND ANY ADDITIONAL STRIPING AS REQUIRED BY CDOT S-627-1.
- 13. THE CONTRACTOR SHALL NOTIFY EL PASO COUNTY PLANNING AND COMMUNITY DEVELOPMENT (719) 520-6819 PRIOR TO AND UPON COMPLETION OF SIGNING AND STRIPING.
- 14. THE CONTRACTOR SHALL OBTAIN A WORK IN THE RIGHT OF WAY PERMIT FROM THE EL PASO COUNTY DEPARTMENT OF PUBLIC WORKS (DPW) PRIOR TO ANY SIGNAGE OR STRIPING WORK WITHIN AN EXISTING EL PASO COUNTY ROADWAY.

PREPARED BY:

SF-21-024

SHEET No.

Know what's **below**.

Call before you dig.

DRAWINGS No. DATE DESCRIPTION REVISIONS COMPUTER FILE MANAGEMENT FILE NAME: S:\21.886.038 (Trails F6)\100 Dwg\104 Plan Sets\Construction Plans\Road & Storm Plans\GN01.dwg CTB FILE: Matrix(black).ctb PLOT DATE: January 4, 2023 1:34:38 PM THIS DRAWING IS CURRENT AS OF PLOT DATE AND MAY BE SUBJECT TO CHANGE.

BENCHMARK

COLORADO SPRINGS UTILITIES (FIMS) MONUMENT F206 A BERNTSEN TOP SECURITY MONUMENT SYSTEM WITH A 3.5-INCH DIAMETER ALUMINUM CAP IN A ROAD BOX, LOCATED ON THE NORTHWEST CORNER OF FONTAINE BOULEVARD AND POWERS BOULEVARD, ELEVATION - 5897.89' U.S. SURVEY FT

BEARINGS ARE BASED ON THE NORTH LINE OF THE NORTHWEST QUARTER OF SECTION 9, TOWNSHIP 15 SOUTH, RANGE 65 WEST OF THE 6TH P.M. SAID LINE BEARS S89°51'23"E FROM THE NORTHWEST CORNER OF SAID SECTION 9 (2 1/2" AULM. CAP PLS 17664) TO THE N 1/4 CORNER OF SAID SECTION 9 (3 1/4" AULM. CAP PLS 10377)



TRAILS AT ASPEN RIDGE

FILING NO. 4 ROADWAY & STORM IMPROVEMENT PLANS

ROADWAY GENERAL NOTES


DESIGNED BY: CAG DRAWN BY:


MATRIX DESIGN GROUP, INC. PROJECT No. 21.886.038


CHECKED BY:


CAG


SCALE DATE ISSUED: AUGUST 2021 DRAWING No. GN01 2 OF 32

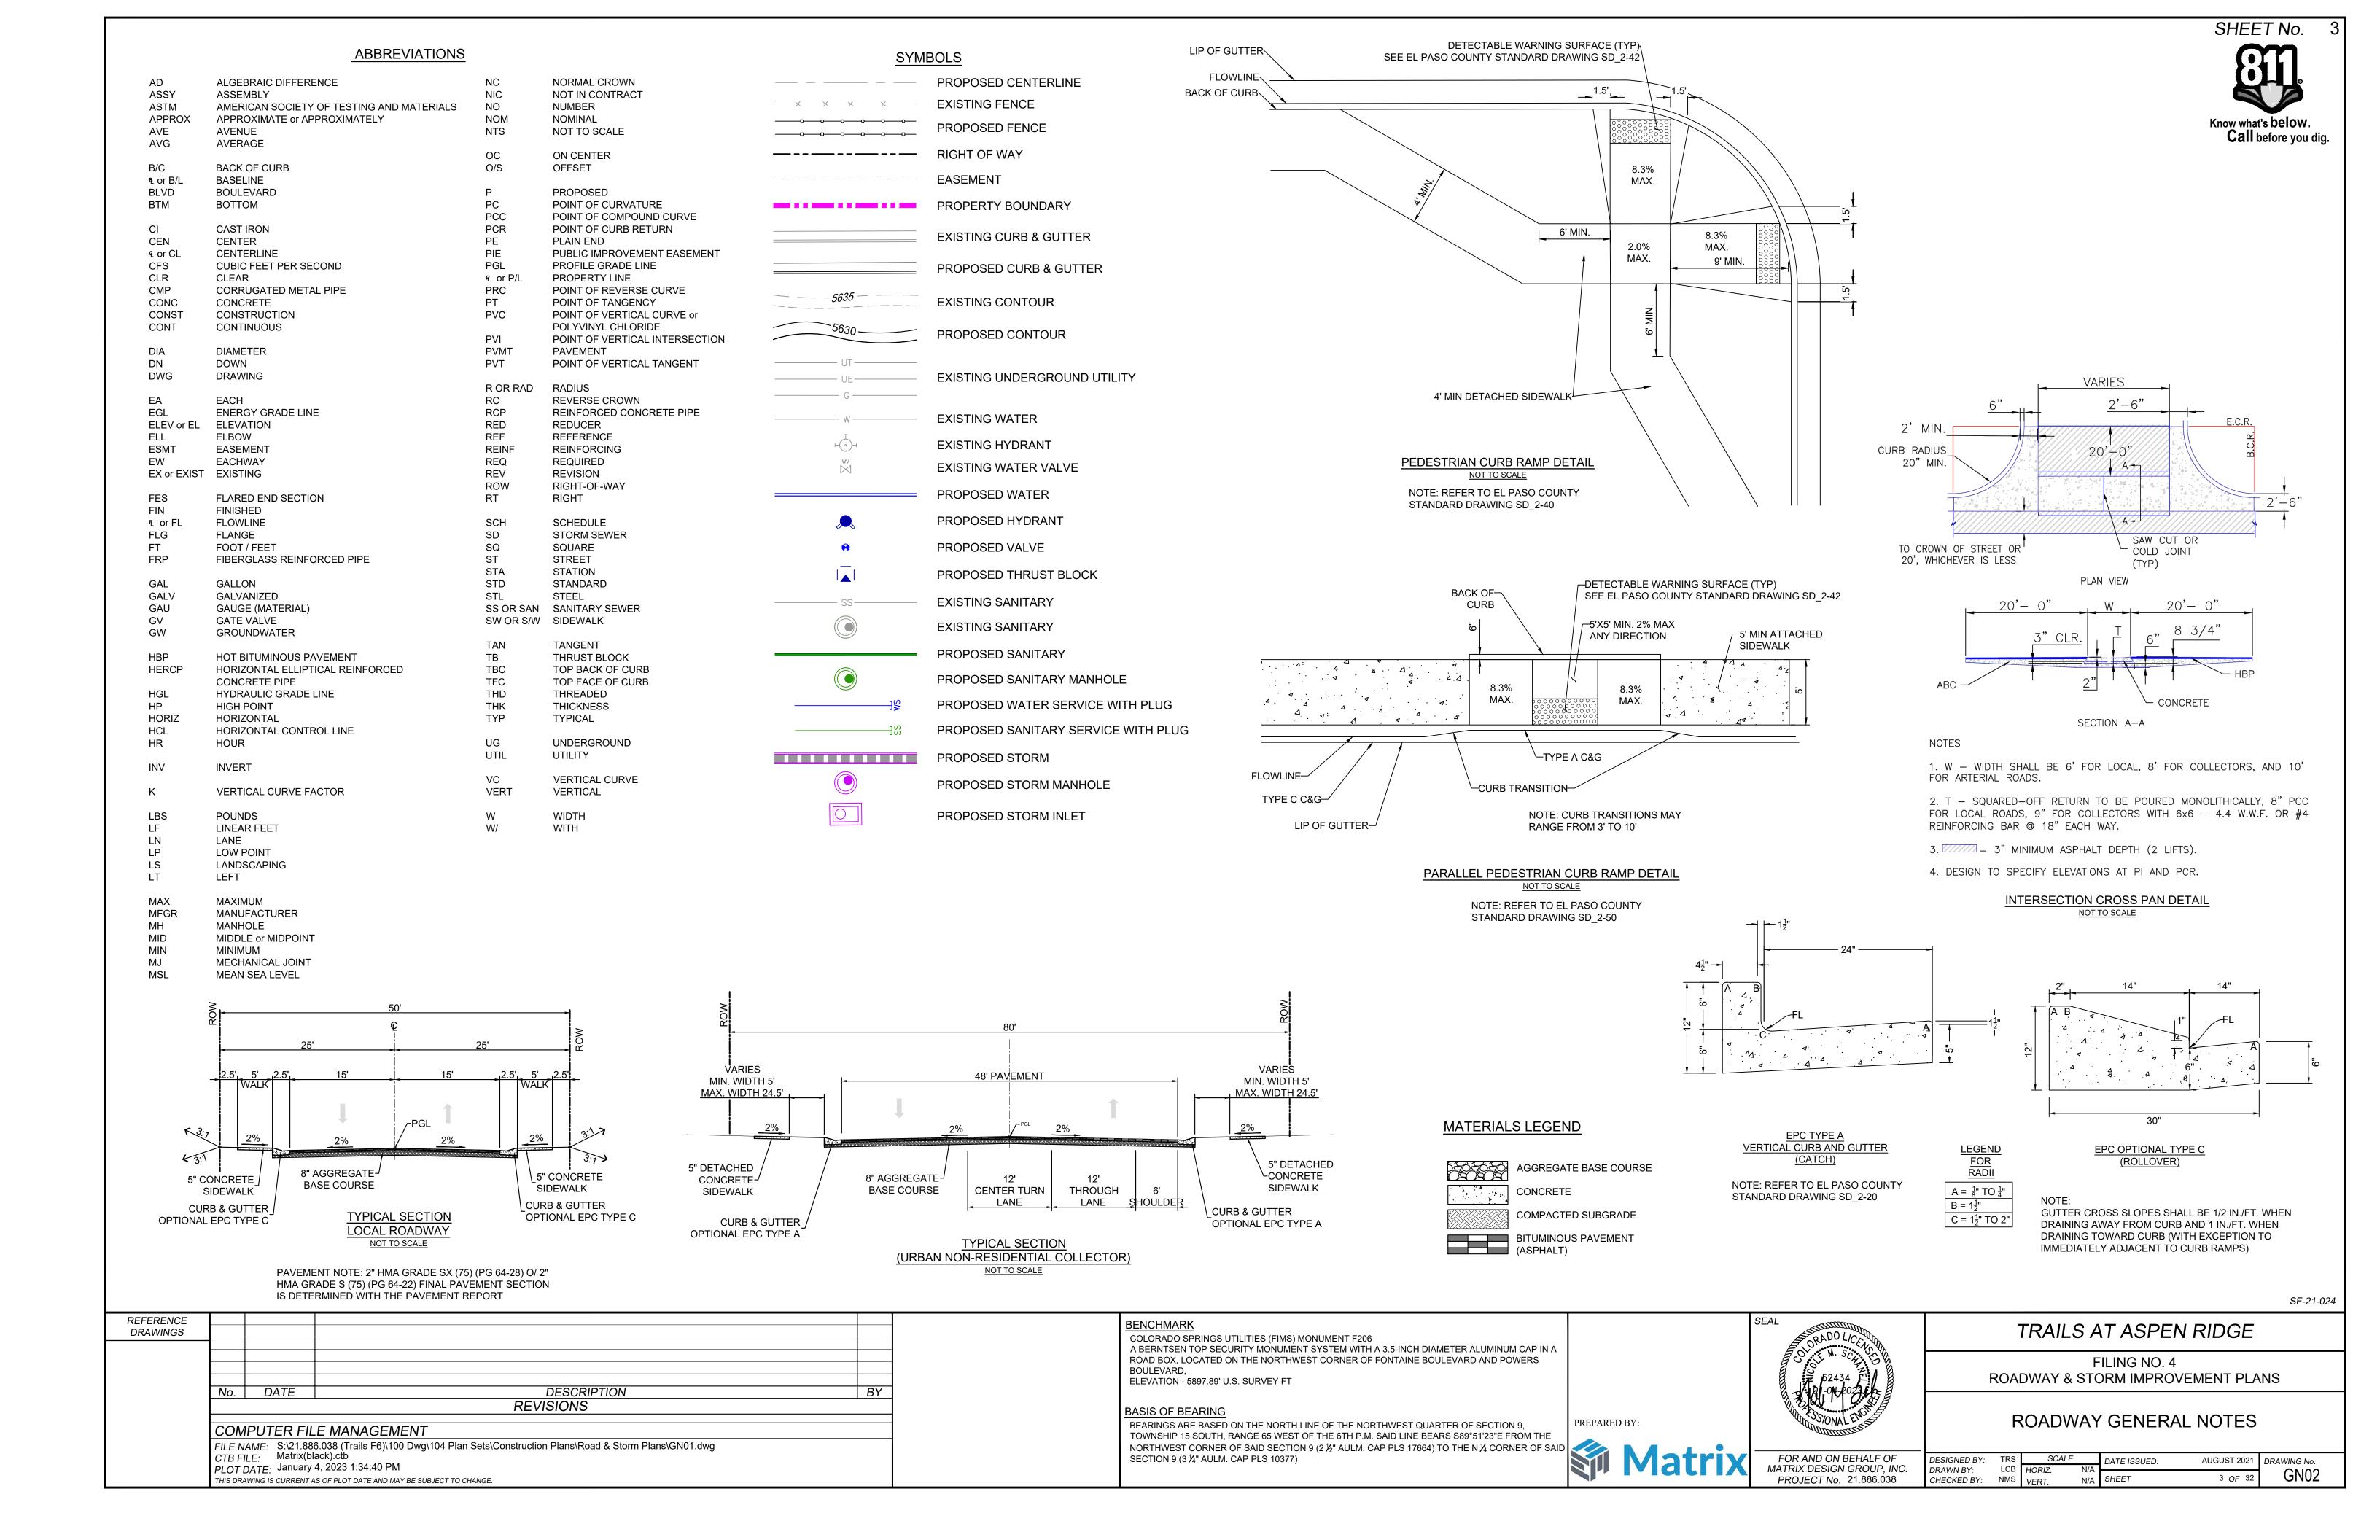

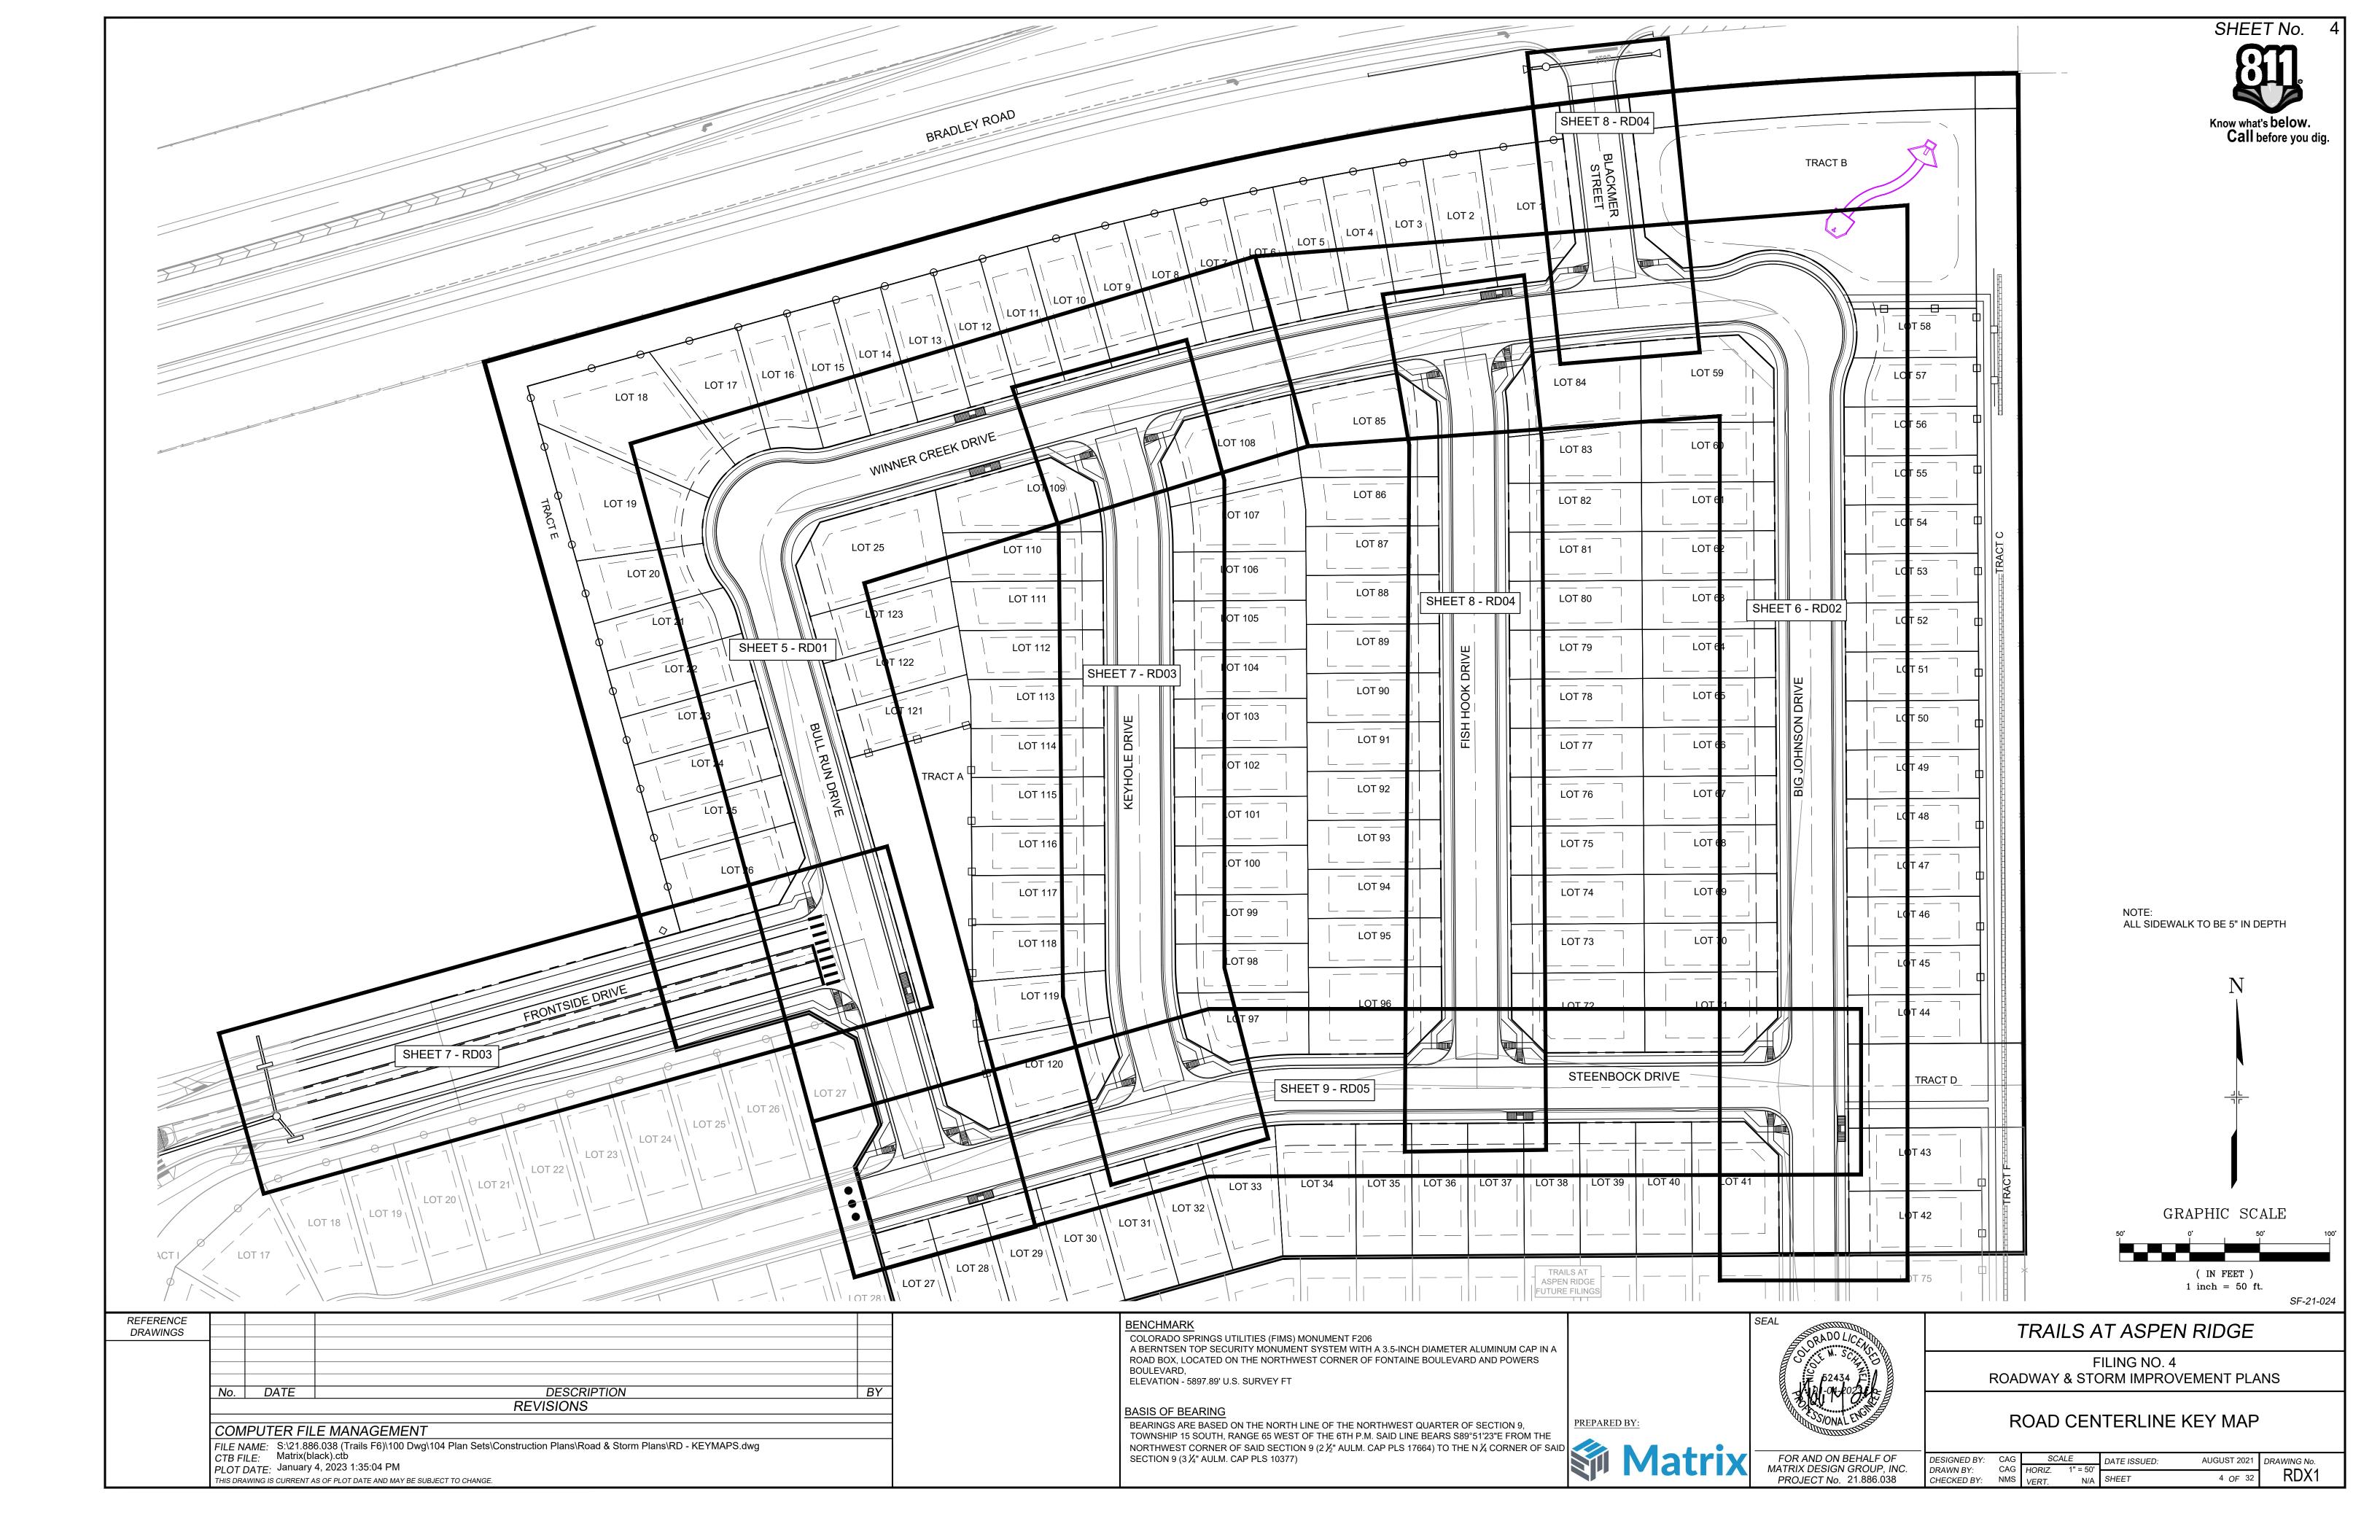

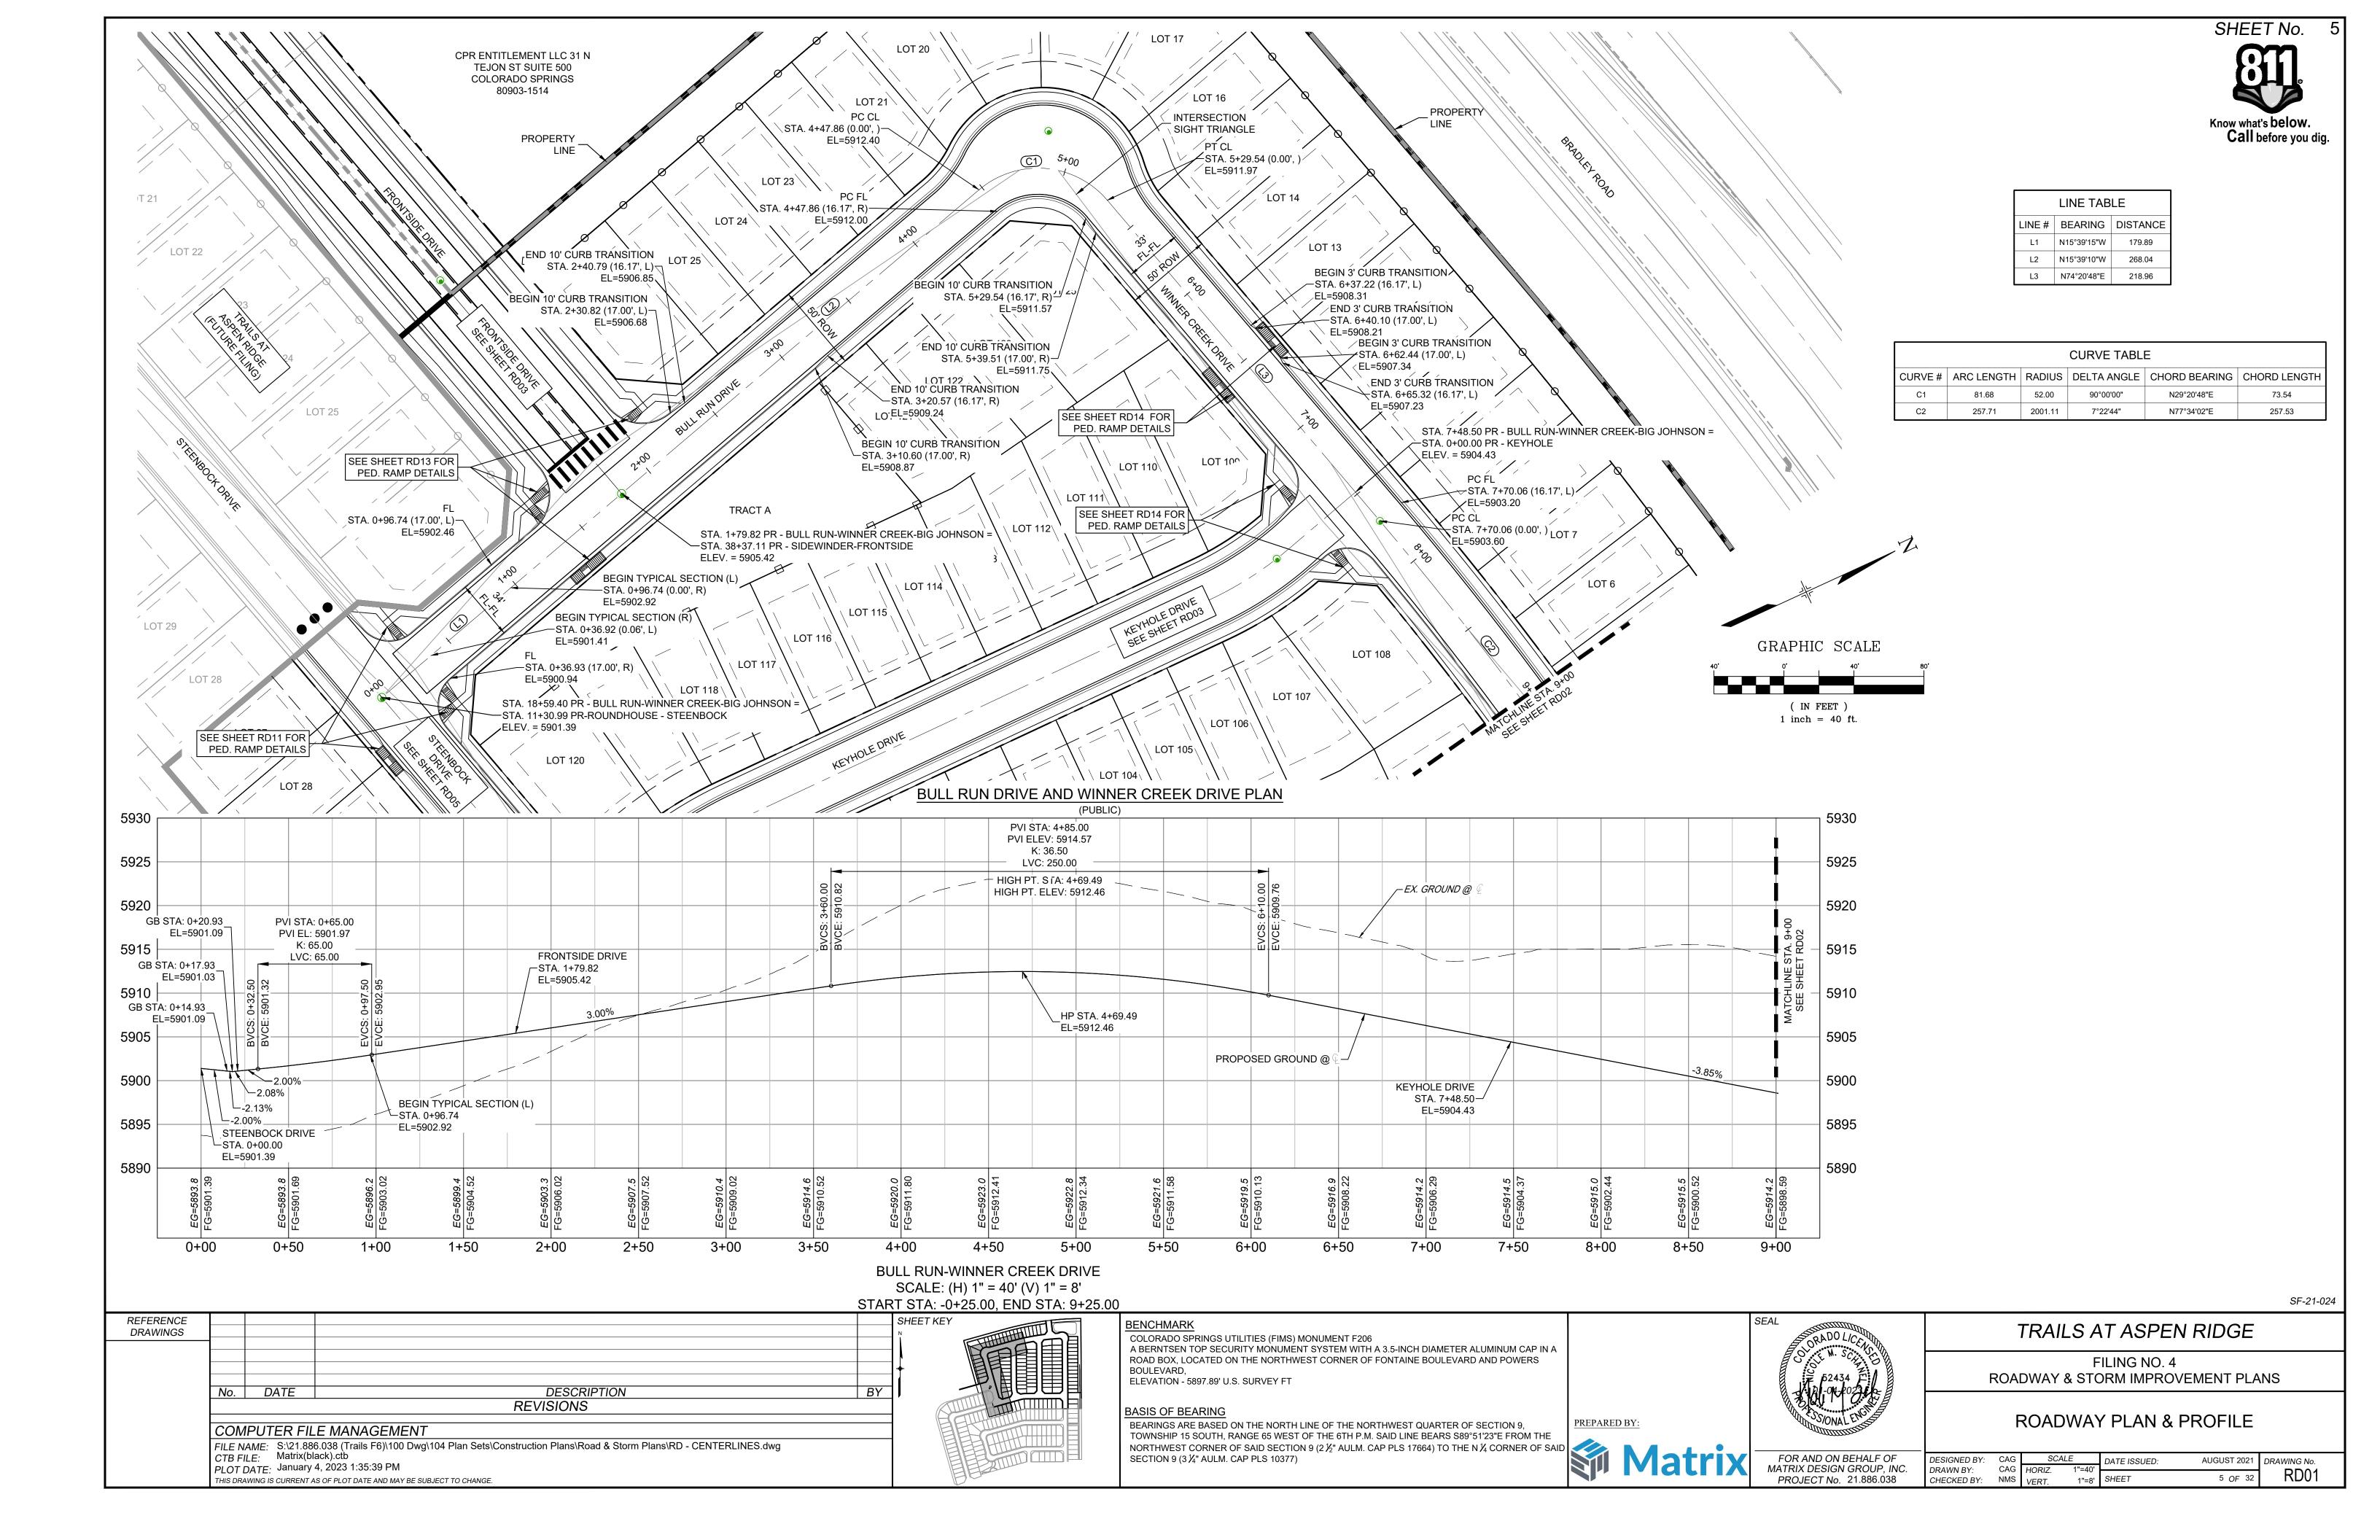

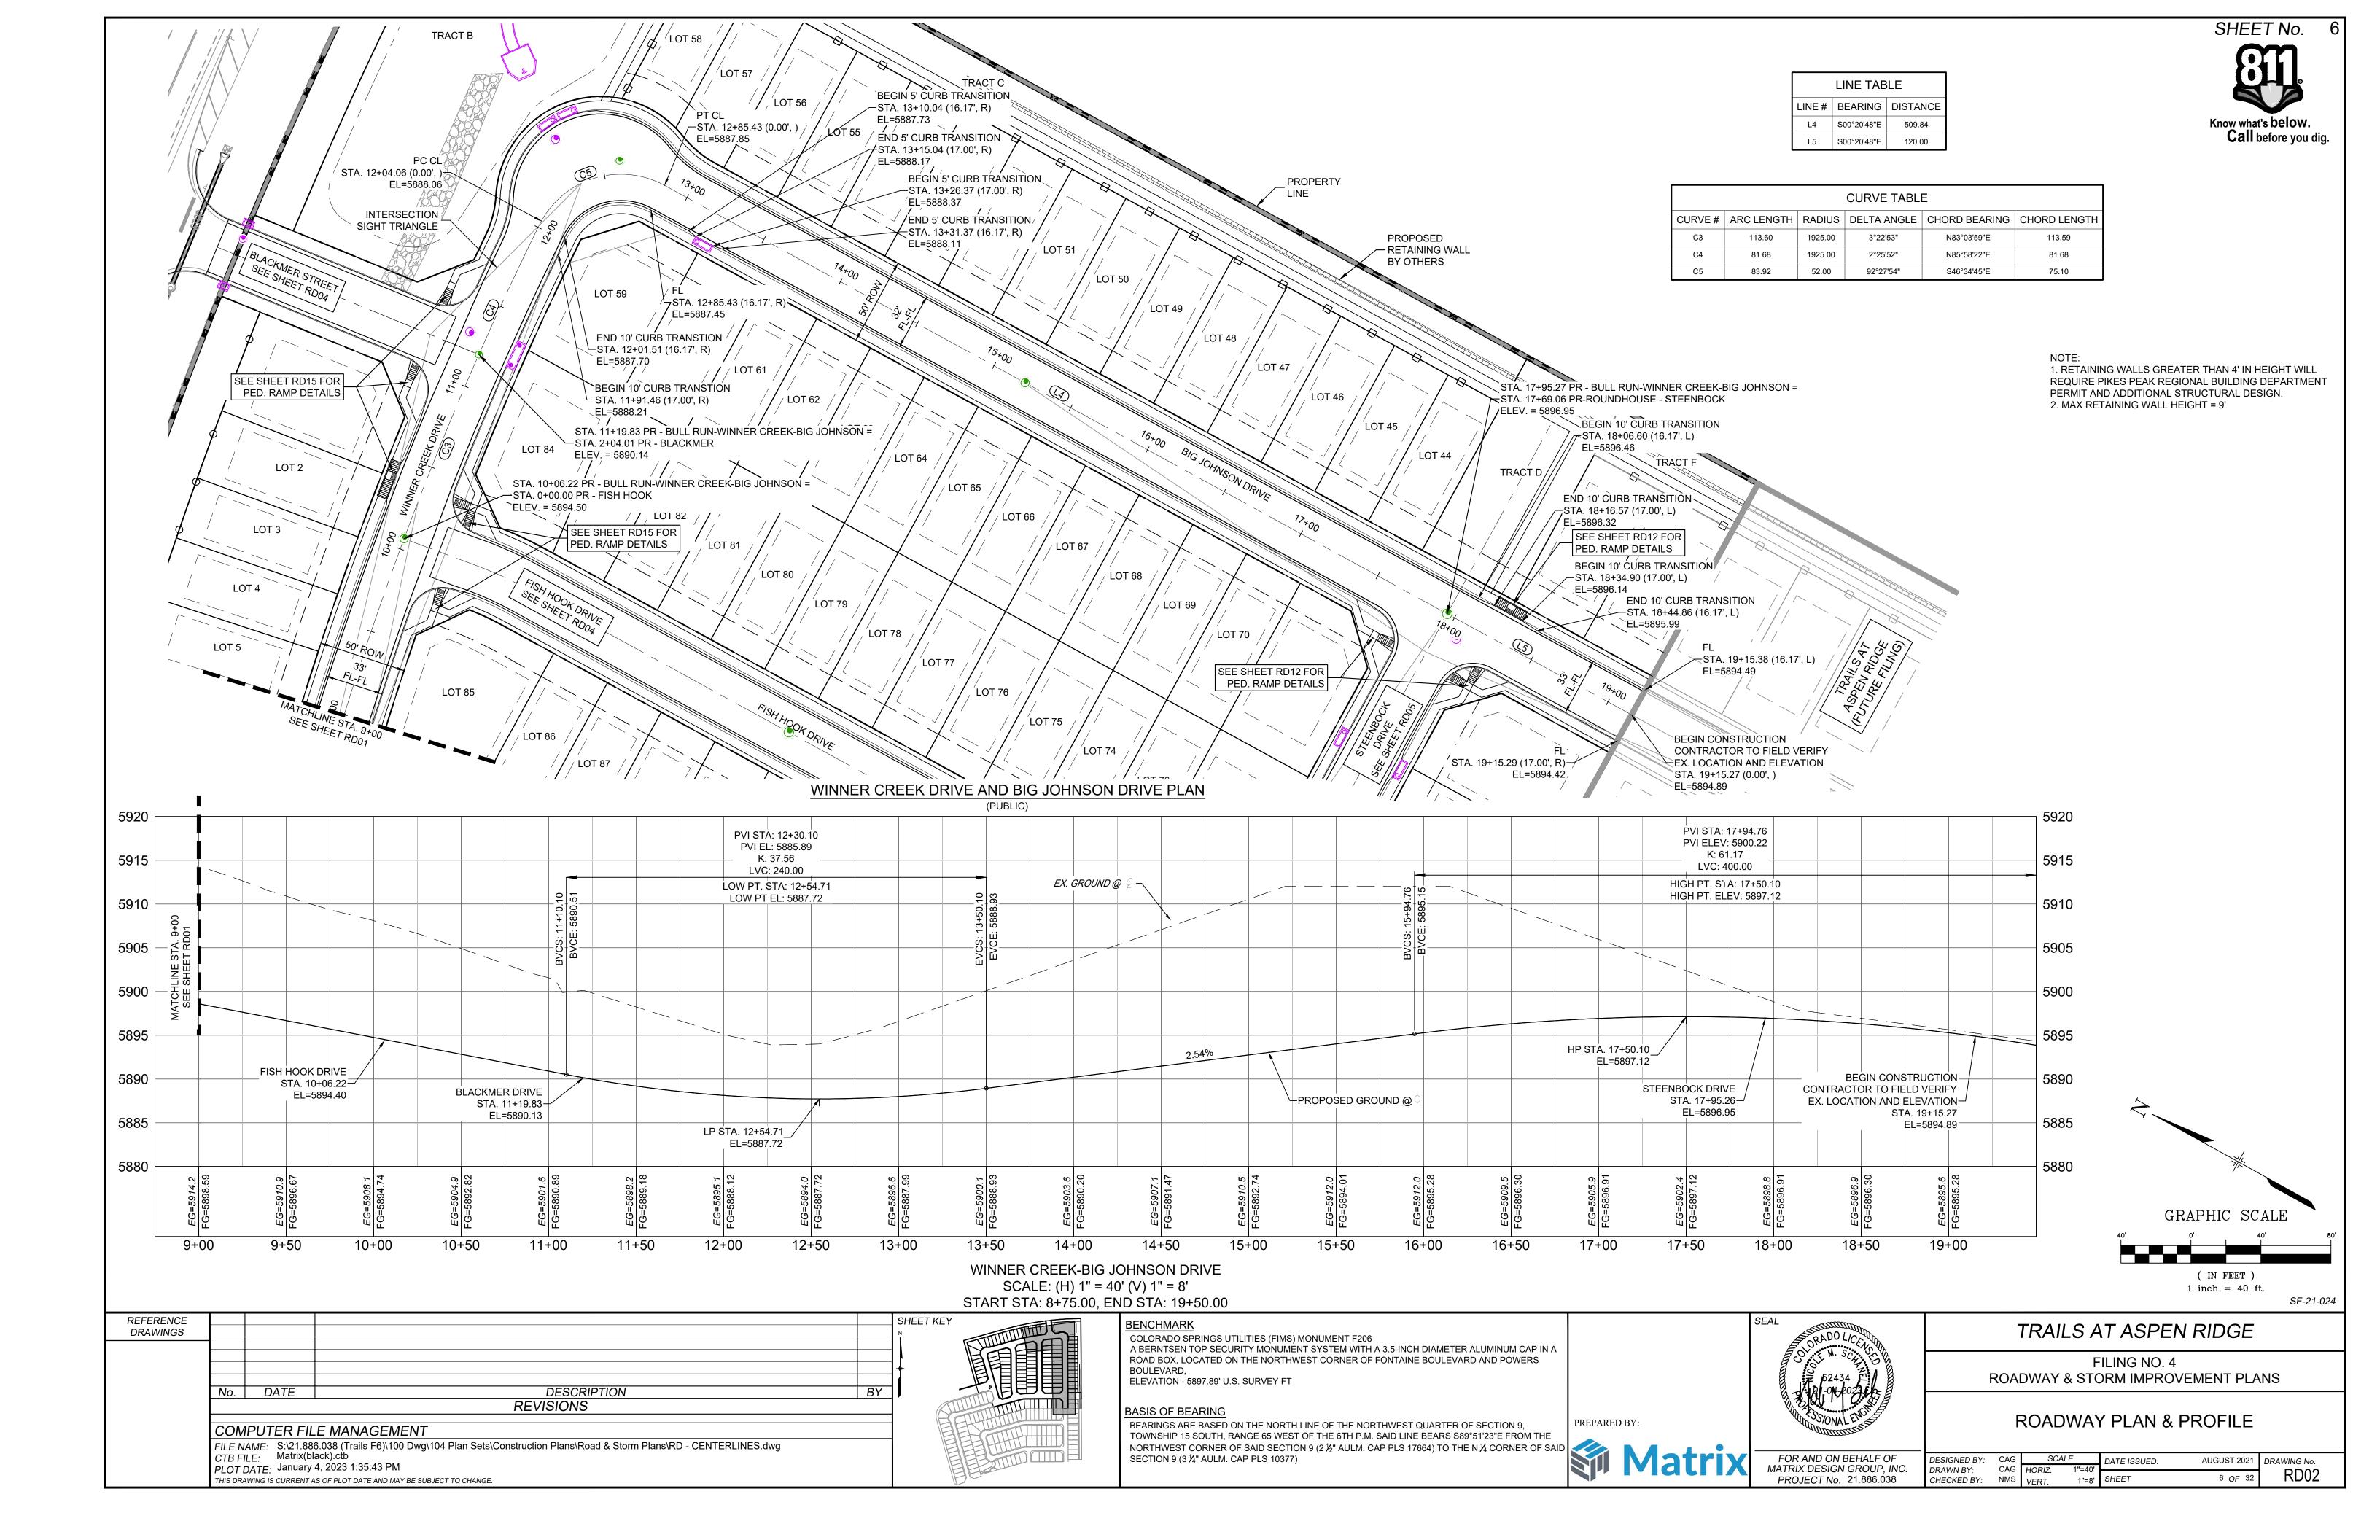

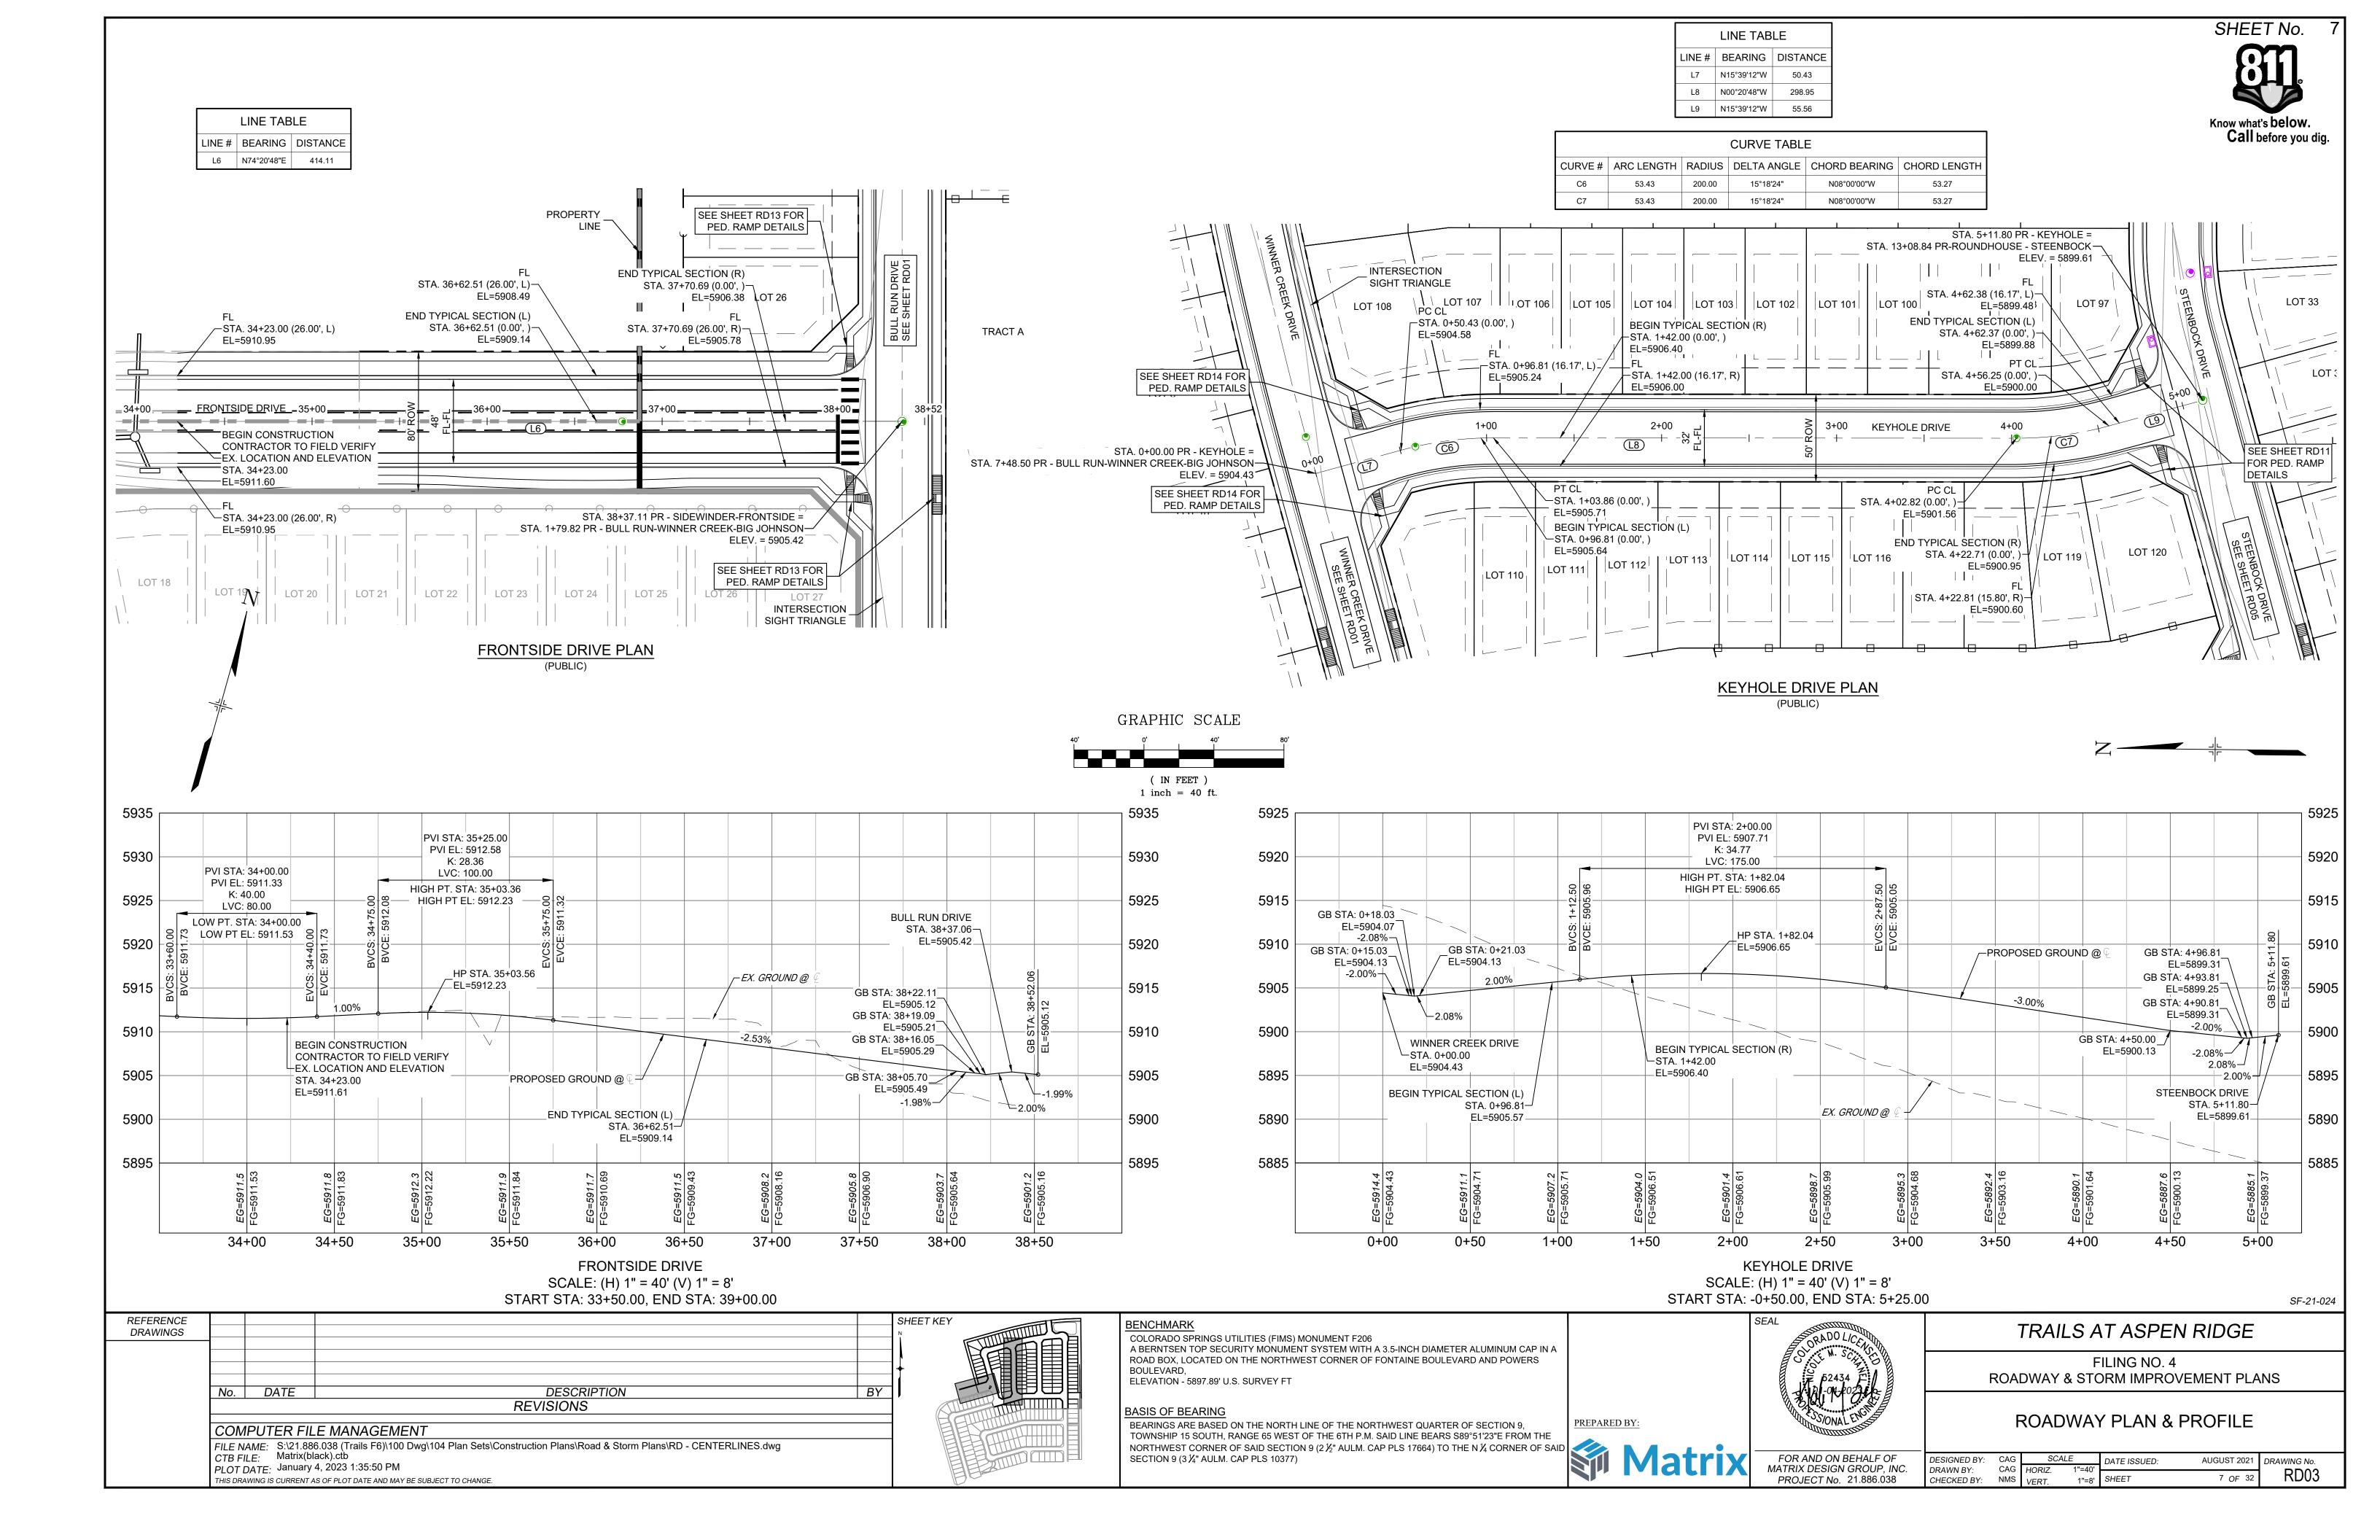

LINE TABLE LINE # | BEARING | DISTANCE L10 S08°37'27"E 45.15 L12 S00°20'48"E 470.05 **CURVE TABLE** 8°16'39"

PLOT DATE: January 4, 2023 1:35:59 PM

THIS DRAWING IS CURRENT AS OF PLOT DATE AND MAY BE SUBJECT TO CHANGE.



FOR AND ON BEHALF OF

PROJECT No. 21.886.038

MATRIX DESIGN GROUP, INC.

SCALE

CAG HORIZ. NMS VERT. CAG

DATE ISSUED:

DESIGNED BY: CAG


DRAWN BY:

CHECKED BY:


AUGUST 2021 DRAWING No.


8 OF 32

SHEET No.

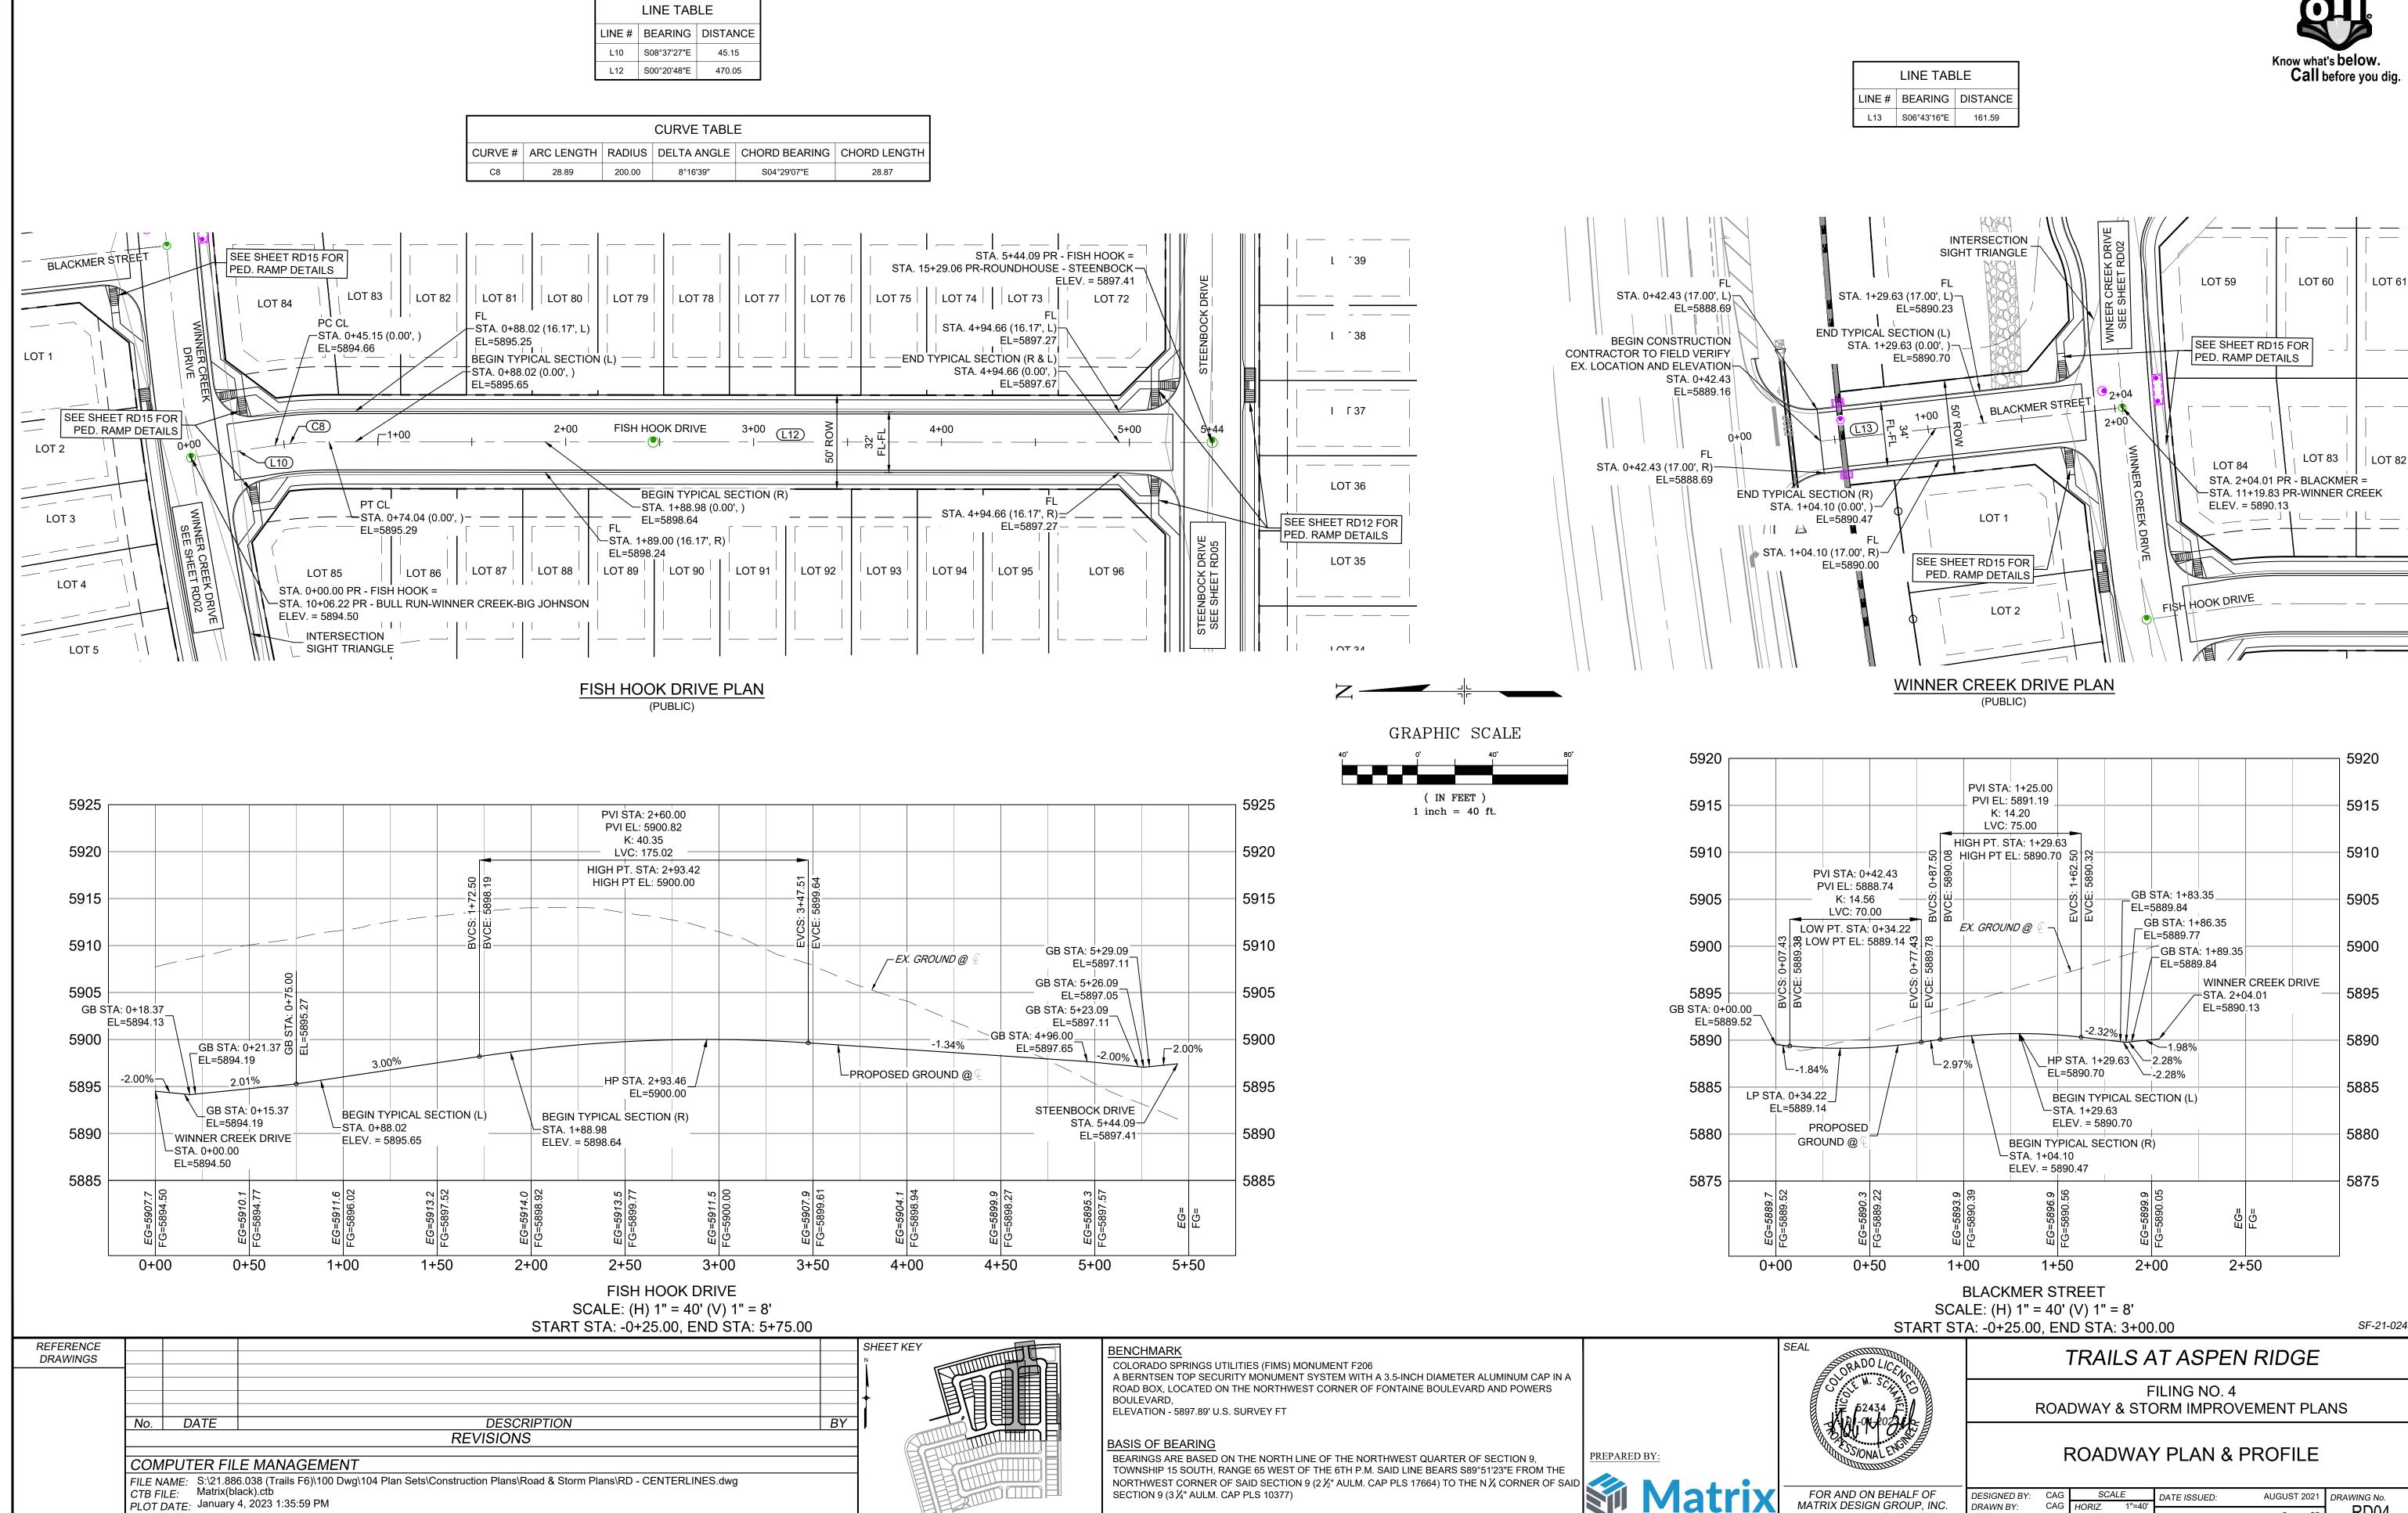




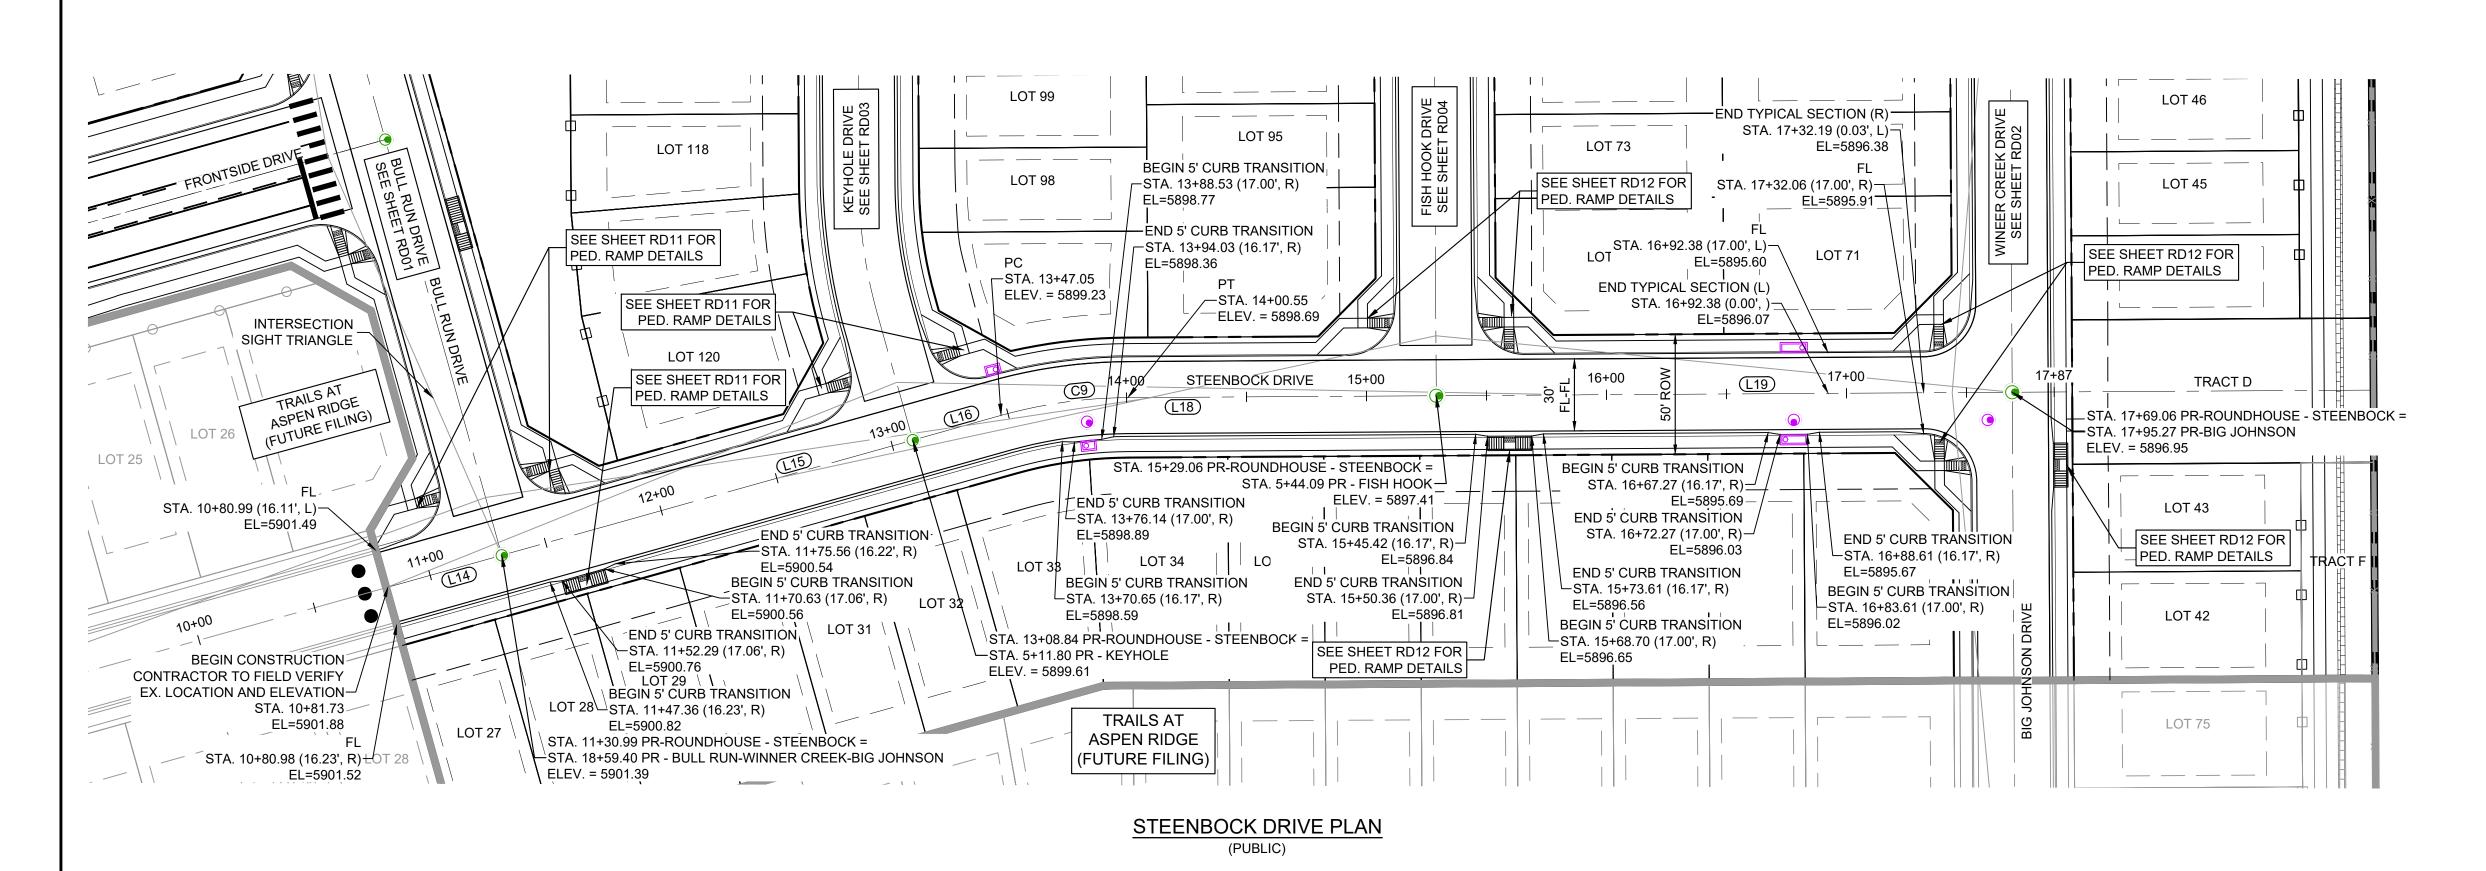


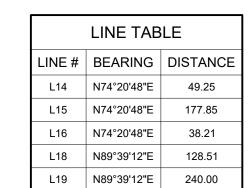

CURVE TABLE					
CURVE#	ARC LENGTH	RADIUS	DELTA ANGLE	CHORD BEARING	CHORD LENGT
C9	53.50	200.00	15°19'38"	N82°00'37"E	53.34

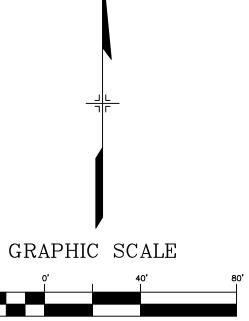

(IN FEET) 1 inch = 40 ft.

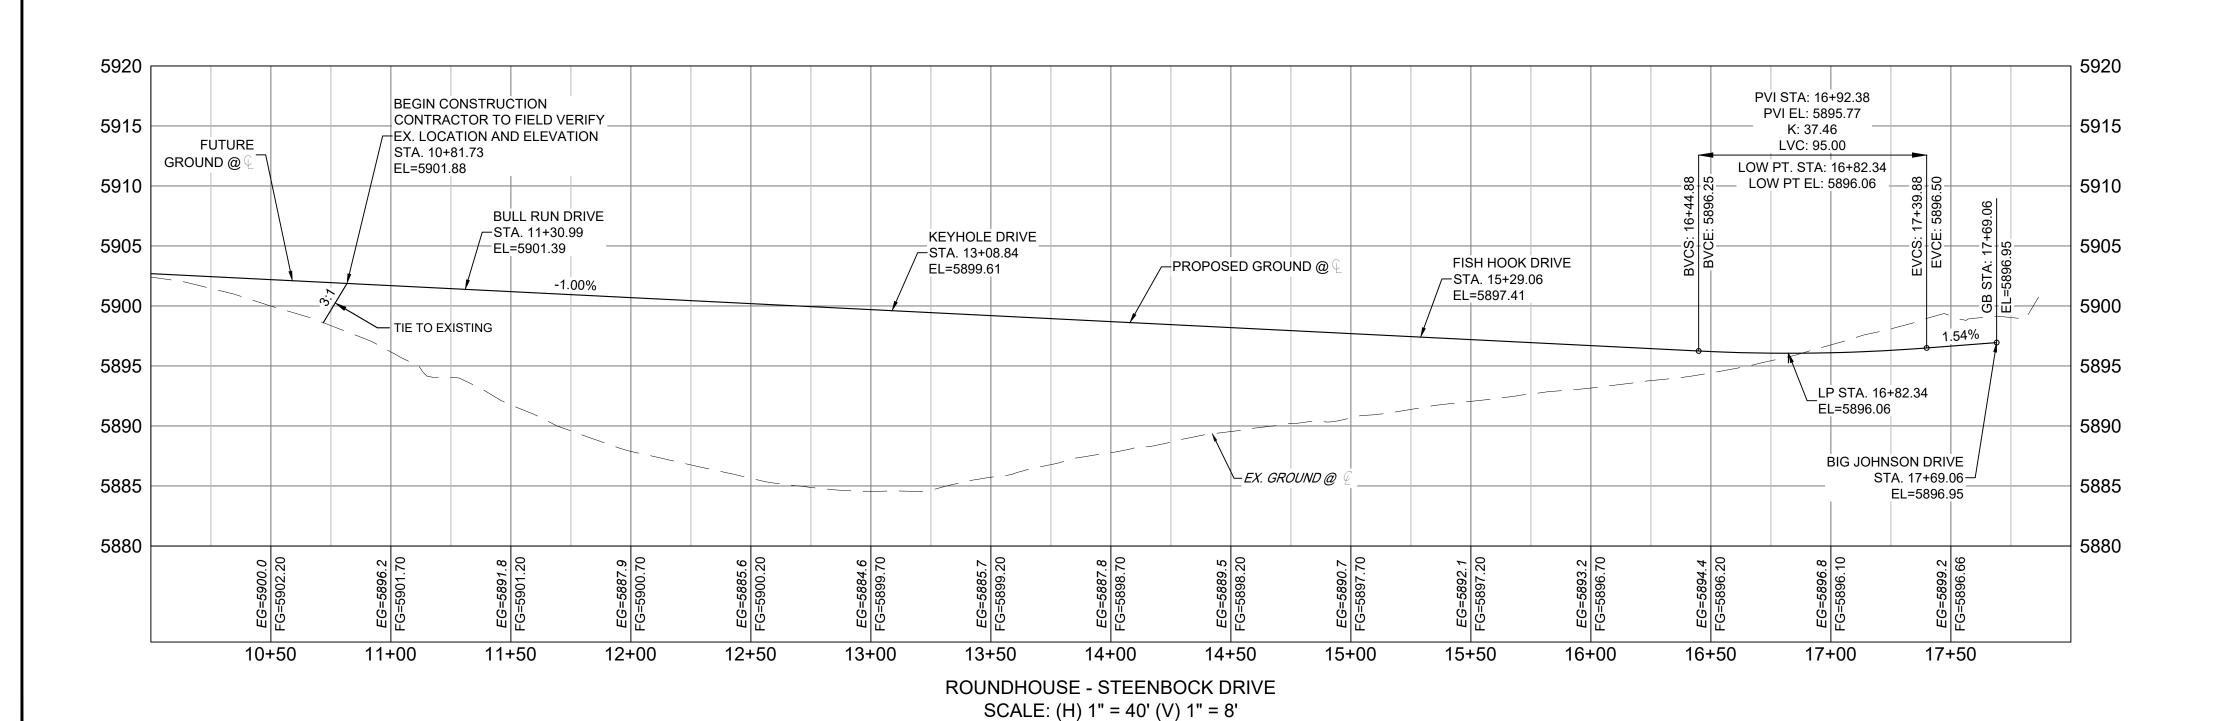

START STA: 10+00.00, END STA: 18+00.00

TRAILS AT ASPEN RIDGE

SF-21-024

RD05

9 OF 32

FILING NO. 4

ROADWAY & STORM IMPROVEMENT PLANS

ROADV	VAY PL	AN & I	PROFIL	Ε

FOR AND ON BEHALF OF MATRIX DESIGN GROUP, INC. PROJECT No. 21.886.038 CHECKED BY:

DESIGNED BY: CAG DRAWN BY: CAG

SCALE AUGUST 2021 DRAWING No. DATE ISSUED:

SHEET KEY DRAWINGS DESCRIPTION No. DATE REVISIONS COMPUTER FILE MANAGEMENT FILE NAME: S:\21.886.038 (Trails F6)\100 Dwg\104 Plan Sets\Construction Plans\Road & Storm Plans\RD - CENTERLINES.dwg CTB FILE: Matrix(black).ctb PLOT DATE: January 4, 2023 1:36:07 PM

THIS DRAWING IS CURRENT AS OF PLOT DATE AND MAY BE SUBJECT TO CHANGE.

BENCHMARK


COLORADO SPRINGS UTILITIES (FIMS) MONUMENT F206 A BERNTSEN TOP SECURITY MONUMENT SYSTEM WITH A 3.5-INCH DIAMETER ALUMINUM CAP IN A ROAD BOX, LOCATED ON THE NORTHWEST CORNER OF FONTAINE BOULEVARD AND POWERS BOULEVARD,


ELEVATION - 5897.89' U.S. SURVEY FT


BASIS OF BEARING


BEARINGS ARE BASED ON THE NORTH LINE OF THE NORTHWEST QUARTER OF SECTION 9, BEARINGS ARE BASED ON THE NORTH EIGHT TOWNSHIP 15 SOUTH, RANGE 65 WEST OF THE 6TH P.M. SAID LINE BEARS S89 51 Z3 E FIXON THE N A CORNER OF SAID SECTION 9 (2 ½" AULM. CAP PLS 17664) TO THE N ¼ CORNER OF SAID SECTION 9 (2 ½" AULM. CAP PLS 17664) TO THE N X Y AULM. CAP PLS 17664 (2 ½" AULM. CAP PLS 17664) TO THE N X Y AULM. CAP PLS 17664 (2 ½" AU


PREPARED BY:

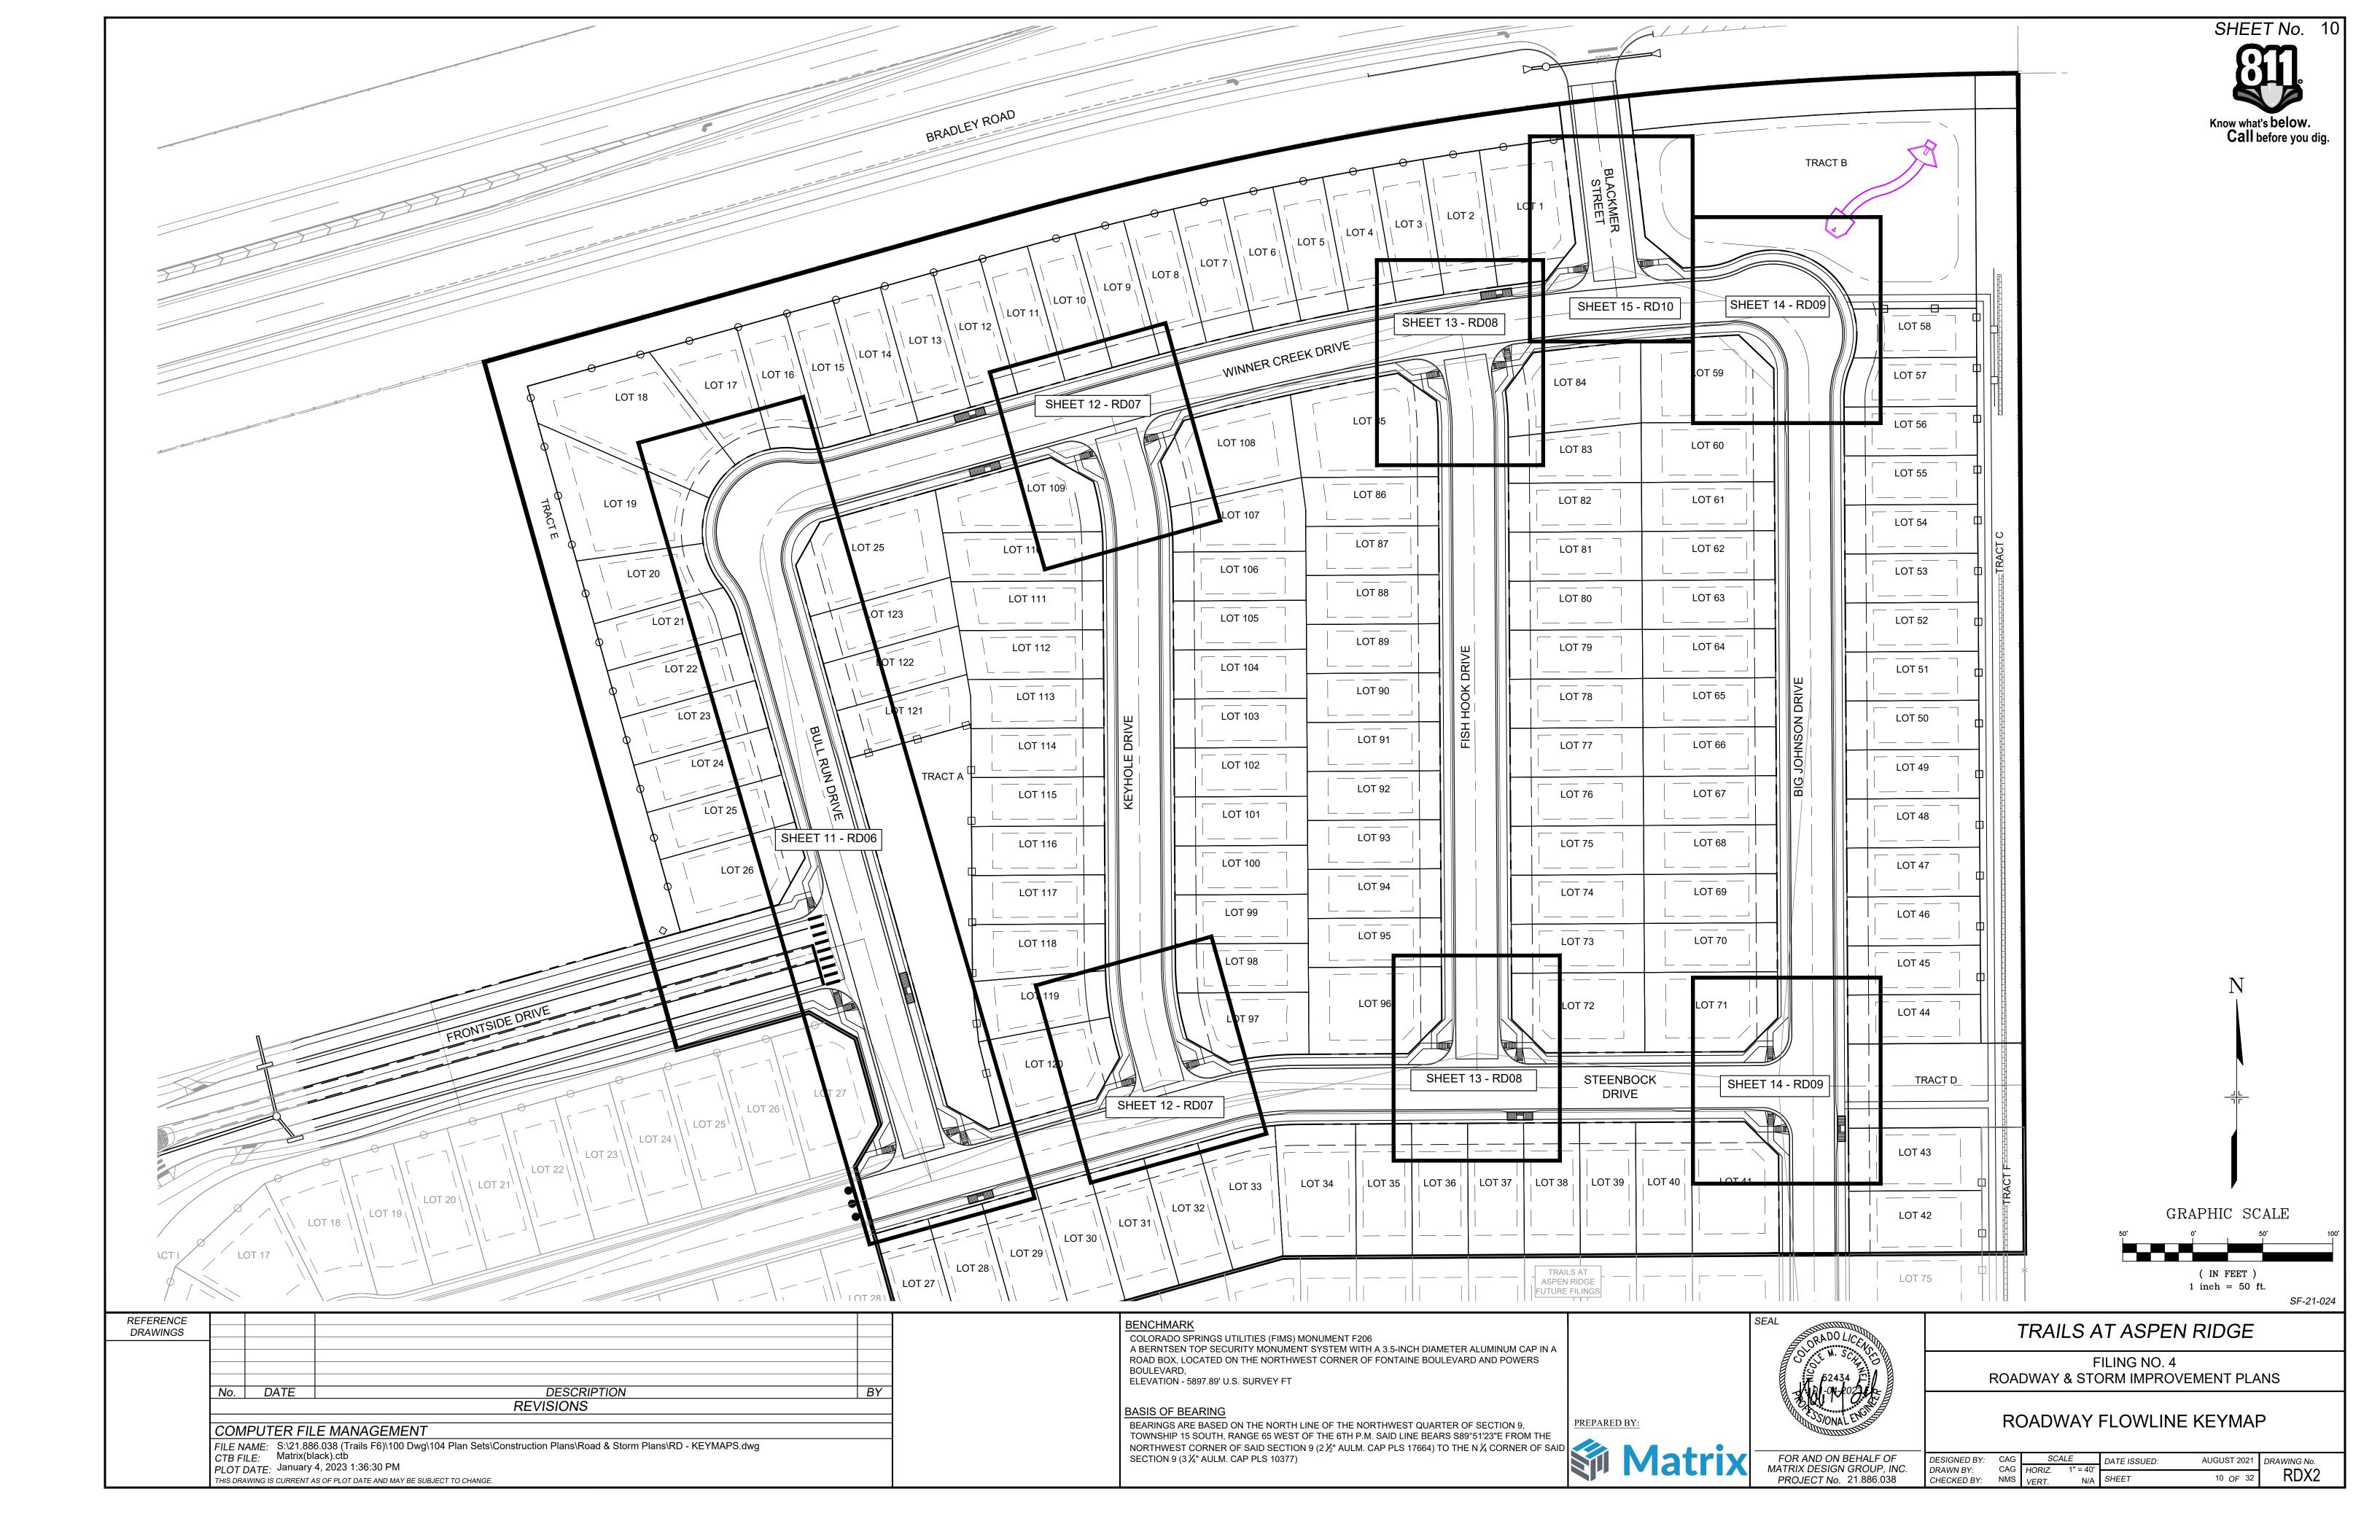

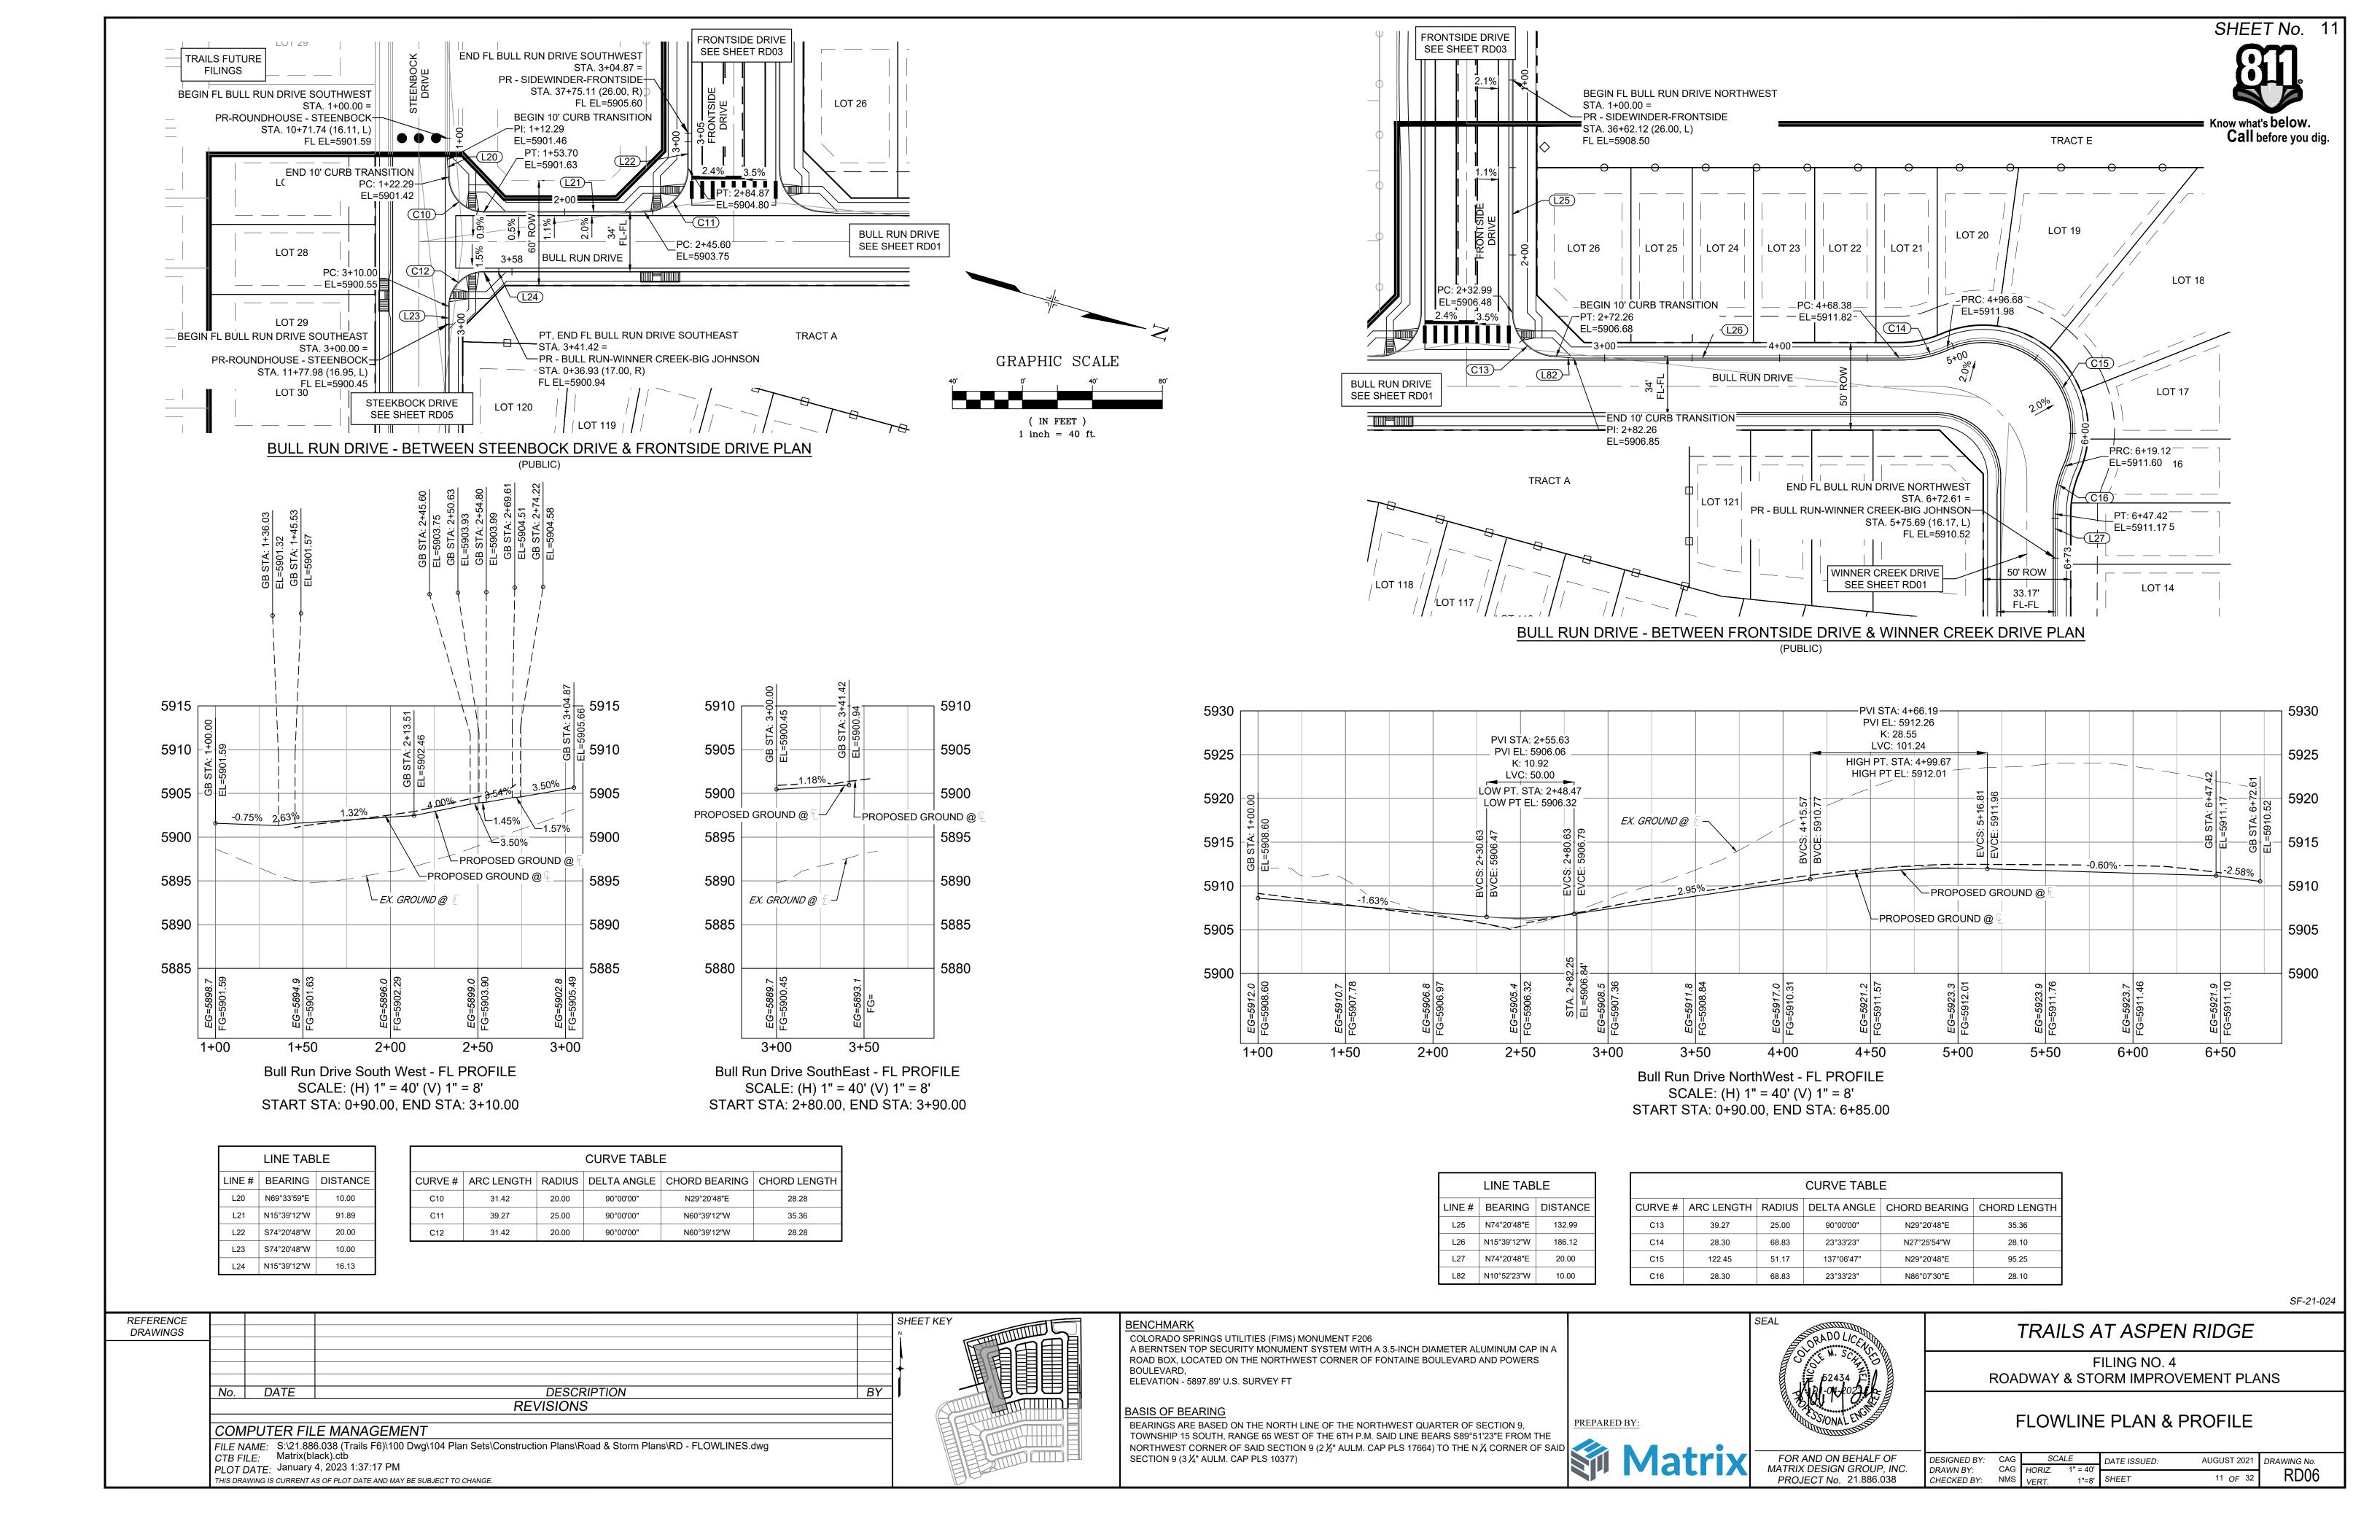

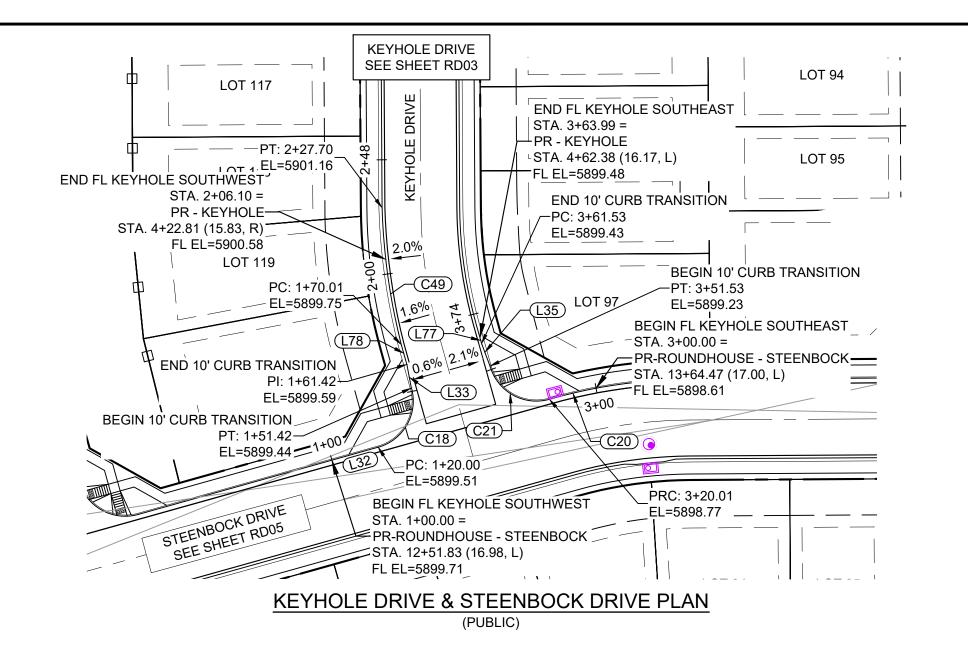


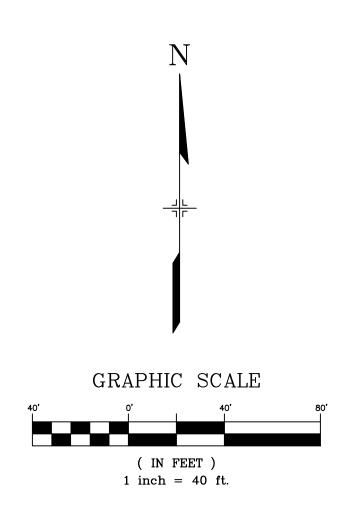

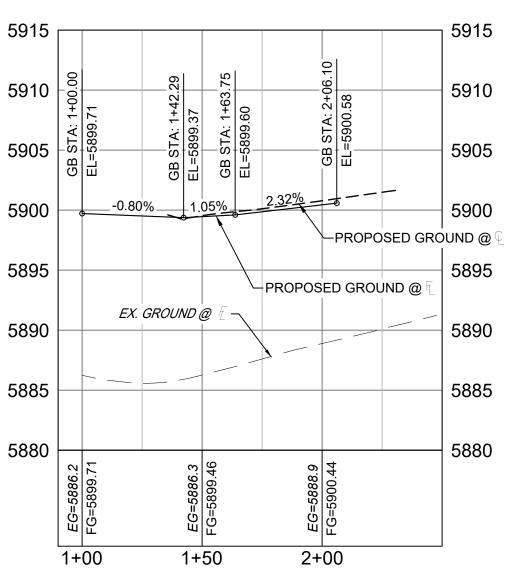

SCALE: (H) 1" = 40' (V) 1" = 8'

START STA: 0+90.00, END STA: 2+50.00

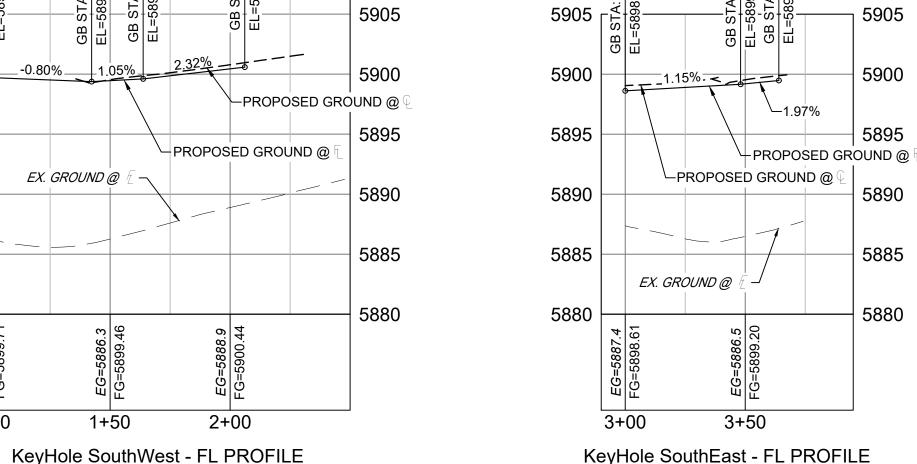

SCALE: (H) 1" = 40' (V) 1" = 8'

START STA: 2+90.00, END STA: 3+95.00

LINE TABLE LINE # BEARING DISTANCE L32 N74°20'48"E L33 N10°52'23"W L35 N20°26'01"W 10.00


L77 N15°41'14"W


L78 N15°39'12"W


CURVE TABLE						
CURVE#	ARC LENGTH	RADIUS	DELTA ANGLE	CHORD BEARING	CHORD LENGTH	
C18	31.42	20.00	90°00'00"	N29°20'48"E	28.28	
C20	20.01	217.01	5°16'56"	S76°41'41"W	20.00	
C21	31.52	20.00	90°17'35"	N60°48'00"W	28.36	
C49	36.10	264.79	7°48'37"	N10°20'12"W	36.07	

2.46

8.59

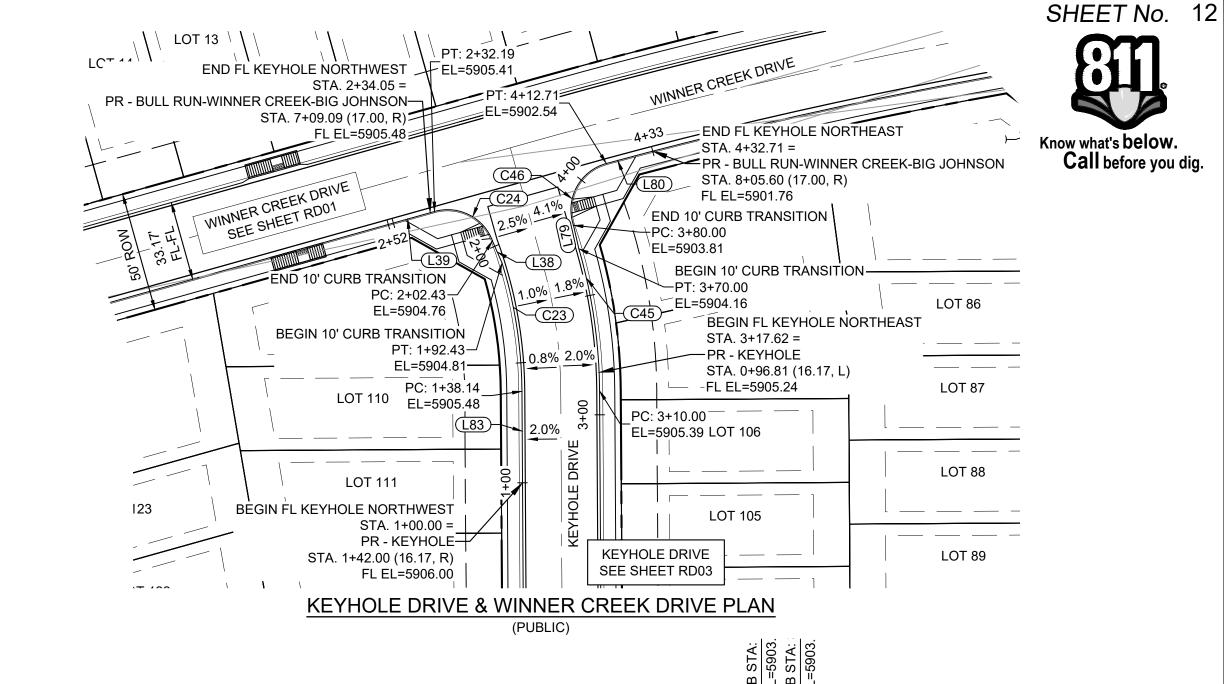

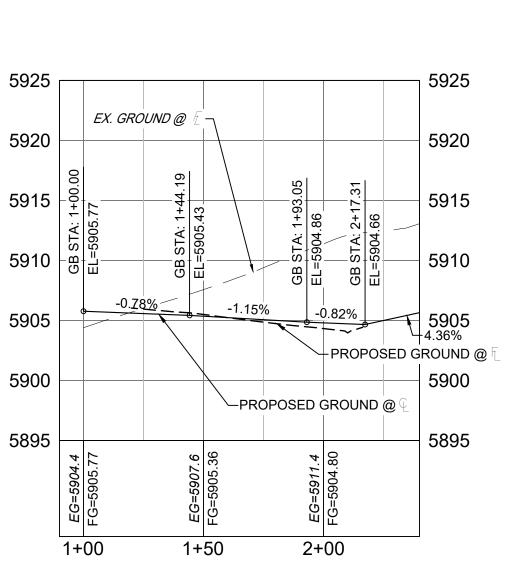

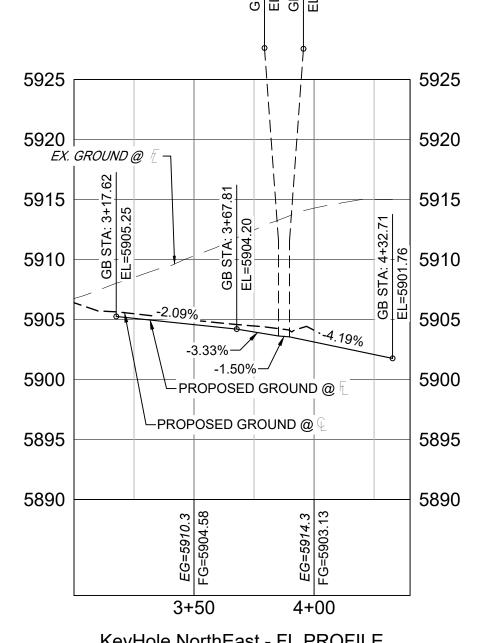

KeyHole NorthWest - FL PROFILE SCALE: (H) 1" = 40' (V) 1" = 8' START STA: 0+90.00, END STA: 2+40.00

PREPARED BY

KeyHole NorthEast - FL PROFILE SCALE: (H) 1" = 40' (V) 1" = 8' START STA: 3+00.00, END STA: 4+40.00

	LINE TABLE					
LINE#	BEARING	DISTANCE				
L38	S23°36'06"E	10.00				
L39	N74°20'48"E	20.00				
L79	N12°47'25"W	10.00				
L80	N75°06'15"E	20.00				
L83	S00°20'48"E	38.14				

	CURVE TABLE						
CURVE#	ARC LENGTH	RADIUS	DELTA ANGLE	CHORD BEARING	CHORD LENGTH		
C23	54.29	183.83	16°55'12"	S08°48'24"E	54.09		
C24	29.77	20.00	85°16'25"	S63°01'00"E	27.09		
C45	52.38	216.17	13°53'03"	N09°18'32"W	52.25		
C46	32.70	20.00	93°41'29"	N27°57'29"E	29.18		

SF-21-024

Call before you dig.

SHEET KEY DRAWINGS No. DATE DESCRIPTION REVISIONS COMPUTER FILE MANAGEMENT

FILE NAME: S:\21.886.038 (Trails F6)\100 Dwg\104 Plan Sets\Construction Plans\Road & Storm Plans\RD - FLOWLINES.dwg CTB FILE: Matrix(black).ctb

THIS DRAWING IS CURRENT AS OF PLOT DATE AND MAY BE SUBJECT TO CHANGE.

PLOT DATE: January 4, 2023 1:37:28 PM

BENCHMARK

COLORADO SPRINGS UTILITIES (FIMS) MONUMENT F206 A BERNTSEN TOP SECURITY MONUMENT SYSTEM WITH A 3.5-INCH DIAMETER ALUMINUM CAP IN A ROAD BOX, LOCATED ON THE NORTHWEST CORNER OF FONTAINE BOULEVARD AND POWERS BOULEVARD, ELEVATION - 5897.89' U.S. SURVEY FT

BASIS OF BEARING

BEARINGS ARE BASED ON THE NORTH LINE OF THE NORTHWEST QUARTER OF SECTION 9,







TRAILS AT ASPEN RIDGE

FILING NO. 4 ROADWAY & STORM IMPROVEMENT PLANS

FLOWLINE PLAN & PROFILE

FOR AND ON BEHALF OF	DESIGNED BY:	CAG	SCAL		DATE ISSUED:	AUGUST 2021	DRAWING No.
MATRIX DESIGN GROUP, INC. PROJECT No. 21.886.038	DRAWN BY: CHECKED BY:	CAG NMS	HORIZ. VERT.	1" = 40' 1"=8'	SHEET	12 OF 32	RD07

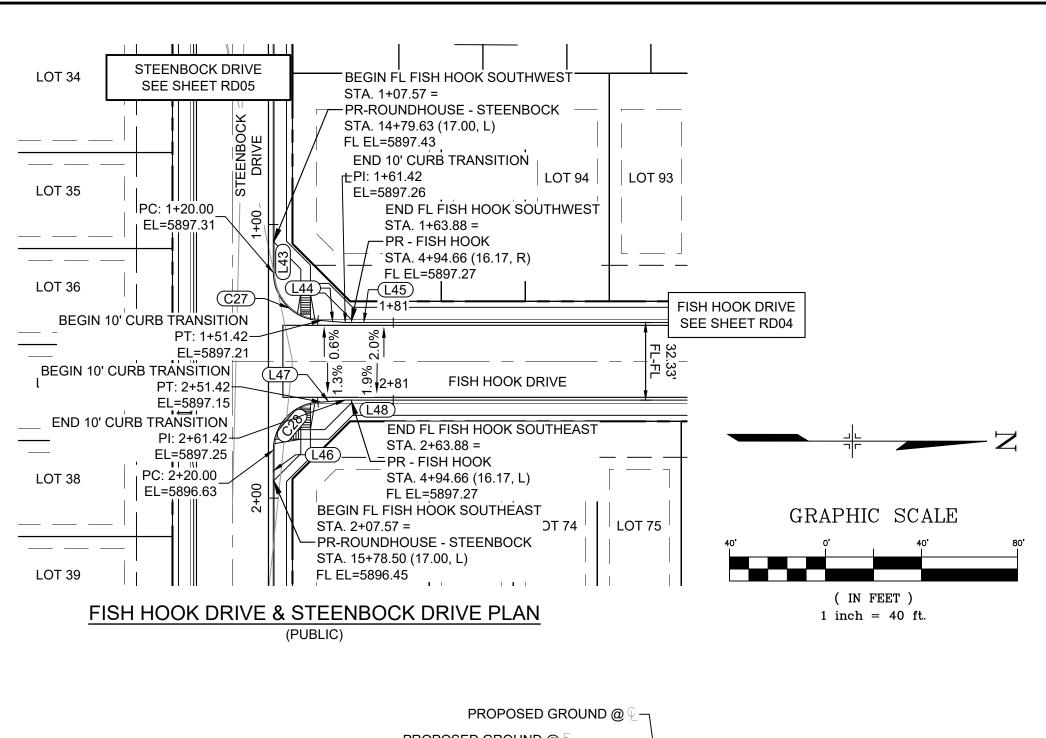

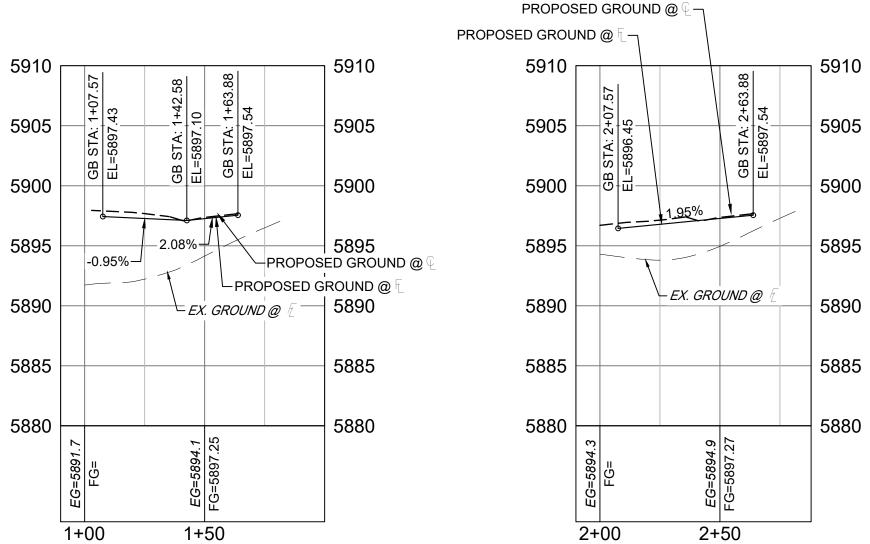


LINE TABLE						
LINE#	BEARING	DISTANCE				
L43	N89°39'12"E	20.00				
L44	N04°26'01"E	10.00				
L45	N00°20'48"W	20.00				
L46	N89°39'12"E	20.00				
L47	S05°07'36"E	10.00				
L48	S00°20'48"E	20.00				

Fish Hook SouthWest - FL PROFILE

SCALE: (H) 1" = 40' (V) 1" = 8'

START STA: 0+90.00, END STA: 2+00.00

	CURVE TABLE						
CURVE#	ARC LENGTH	RADIUS	DELTA ANGLE	CHORD BEARING	CHORD LENGTH		
C27	31.42	20.00	90°00'00"	N44°39'12"E	28.28		
C28	31.42	20.00	90°00'00"	S45°20'48"E	28.28		

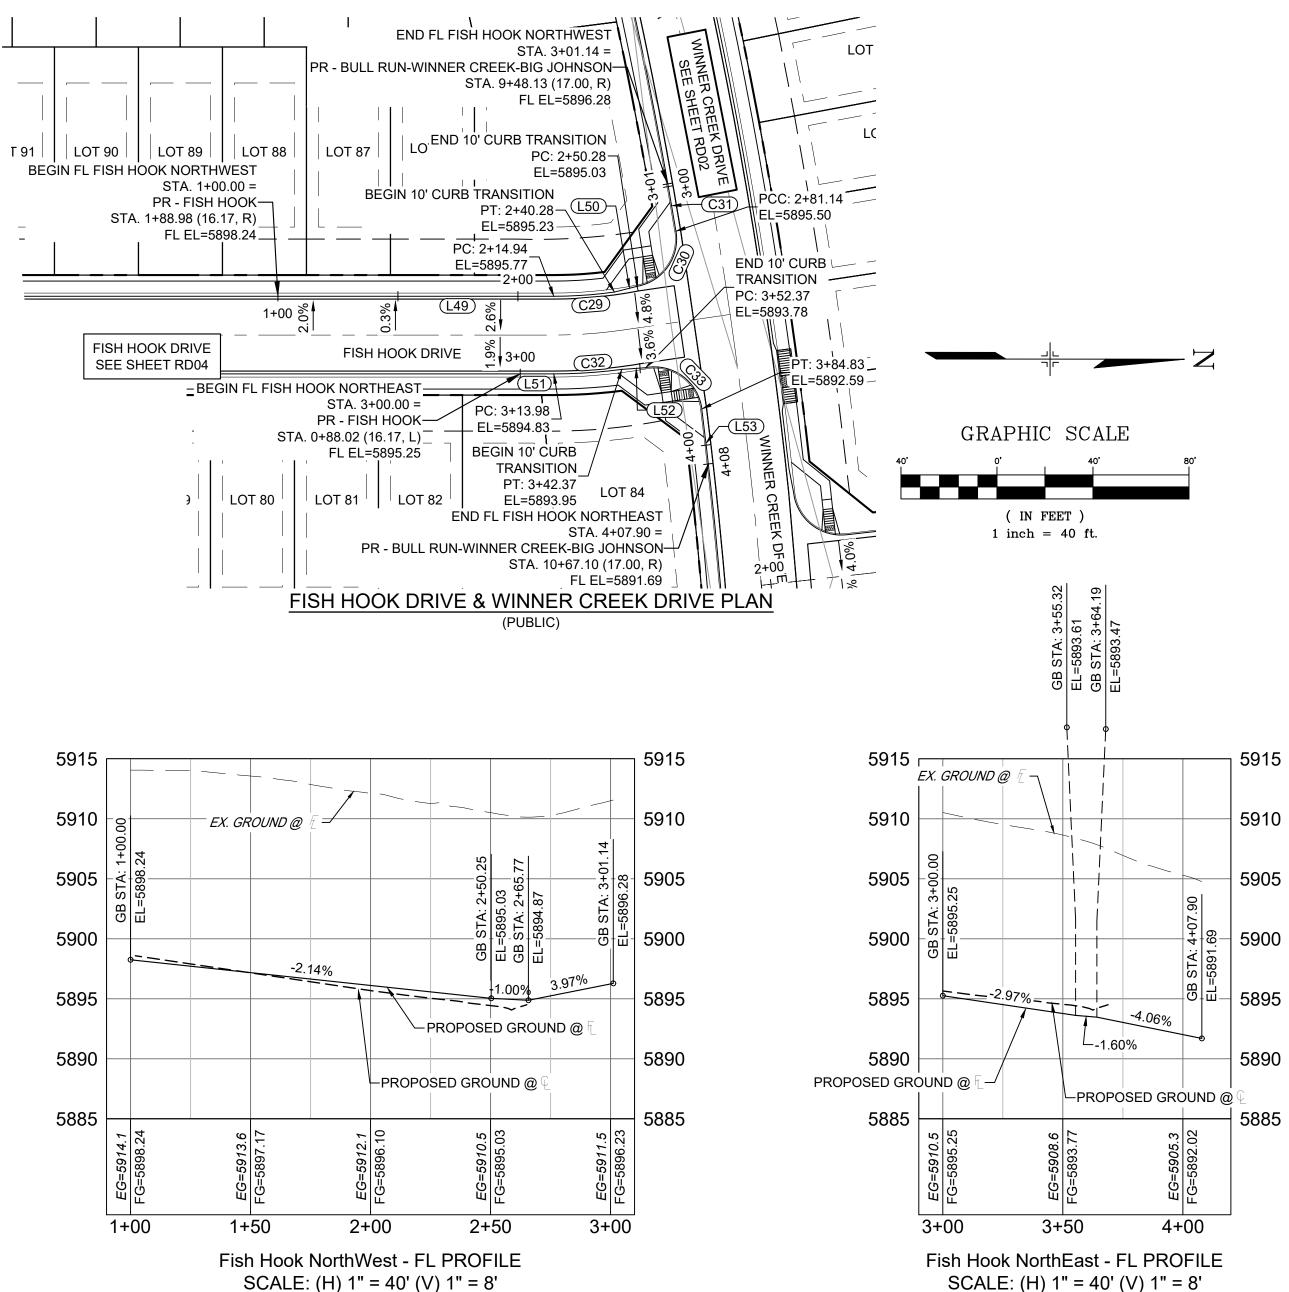

SCALE: (H) 1" = 40' (V) 1" = 8' START STA: 2+90.00, END STA: 4+20.00

LINE TABLE					
LINE#	BEARING	DISTANCE			
L49	S00°20'48"E	114.94			
L50	S14°34'57"E	10.00			
L51	N00°20'48"W	13.98			
L52	N04°24'37"W	10.00			
L53	N82°50'29"E	23.07			

CURVE TABLE					
CURVE#	ARC LENGTH	RADIUS	DELTA ANGLE	CHORD BEARING	CHORD LENGTH
C29	25.35	183.83	7°54'02"	S04°17'49"E	25.33
C30	30.85	20.00	88°23'32"	S55°33'24"E	27.88
C31	20.00	1908.00	0°36'02"	N79°56'49"E	20.00
C32	28.39	216.17	7°31'27"	N04°06'31"W	28.37
C33	32.46	20.00	93°00'08"	N35°59'38"E	29.02

SF-21-024

SHEET No. 13

Know what's **below**.

Call before you dig.

REFERENCE					SHEET K	ΈΥ
DRAWINGS	_				⊢ N	
					$+$ \mathbb{I}	
						
]	
	No.	DATE	DESCRIPTION	BY]	
			REVISIONS		,	
					(
	COM	<u>IPUTER FIL</u>	E MANAGEMENT			
			5.038 (Trails F6)\100 Dwg\104 Plan Sets\Construction Plans\Road & Storm Plans\RD - FLOWLINES.dwg			
	CTB FI	ILE: Matrix(bla	ack).ctb 4, 2023 1:37:37 PM			
			S OF PLOT DATE AND MAY BE SUBJECT TO CHANGE.			
	וחוס טותו	AVVING IS CURRENT A	OUT FLUT DATE AIND INIAT DE SUBJEUT TU CHAINGE.			

Fish Hook SouthEast - FL PROFILE

SCALE: (H) 1" = 40' (V) 1" = 8'

START STA: 1+90.00, END STA: 2+88.00

BENCHMARK


COLORADO SPRINGS UTILITIES (FIMS) MONUMENT F206 A BERNTSEN TOP SECURITY MONUMENT SYSTEM WITH A 3.5-INCH DIAMETER ALUMINUM CAP IN A ROAD BOX, LOCATED ON THE NORTHWEST CORNER OF FONTAINE BOULEVARD AND POWERS BOULEVARD,

START STA: 0+90.00, END STA: 3+10.00

ELEVATION - 5897.89' U.S. SURVEY FT

BASIS OF BEARING

BEARINGS ARE BASED ON THE NORTH LINE OF THE NORTHWEST QUARTER OF SECTION 9, TOWNSHIP 15 SOUTH, RANGE 65 WEST OF THE 6TH P.M. SAID LINE BEARS S89°51'23"E FROM THE NORTHWEST CORNER OF SAID SECTION 9 (2 1/2" AULM. CAP PLS 17664) TO THE N 1/4 CORNER OF SAID SECTION 9 (3 1/4" AULM. CAP PLS 10377)

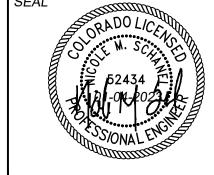

MATRIX DESIGN GROUP, INC.

PROJECT No. 21.886.038


TRAILS AT ASPEN RIDGE


FILING NO. 4 ROADWAY & STORM IMPROVEMENT PLANS

FLOWLINE PLAN & PROFILE


SCALE DATE ISSUED: AUGUST 2021 DRAWING No. DESIGNED BY: CAG CAG DRAWN BY: RD08 13 OF 32 CHECKED BY:

PREPARED BY:

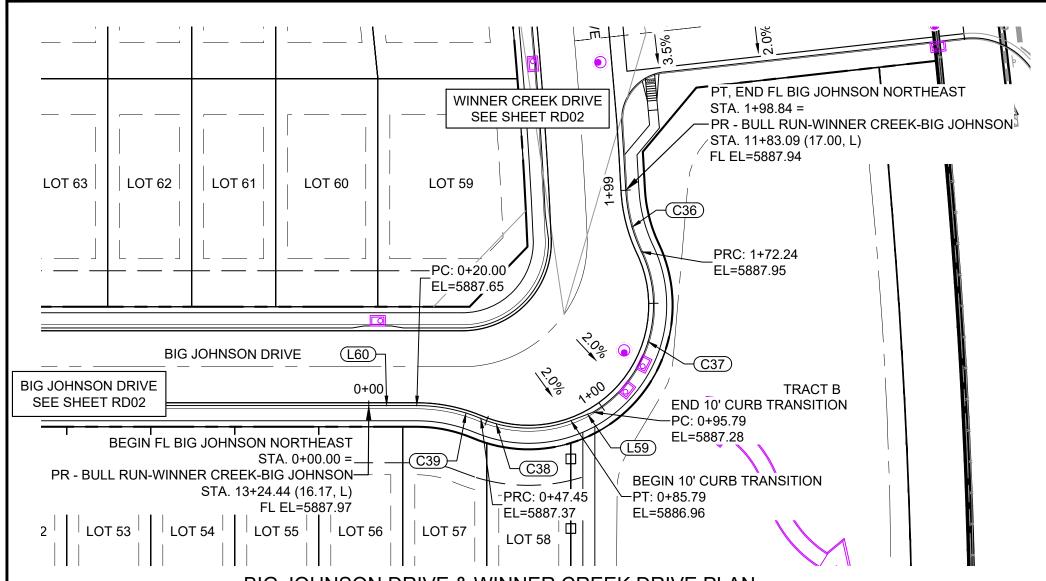

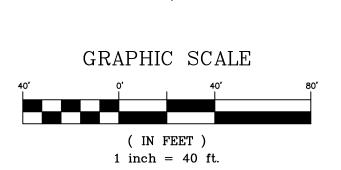



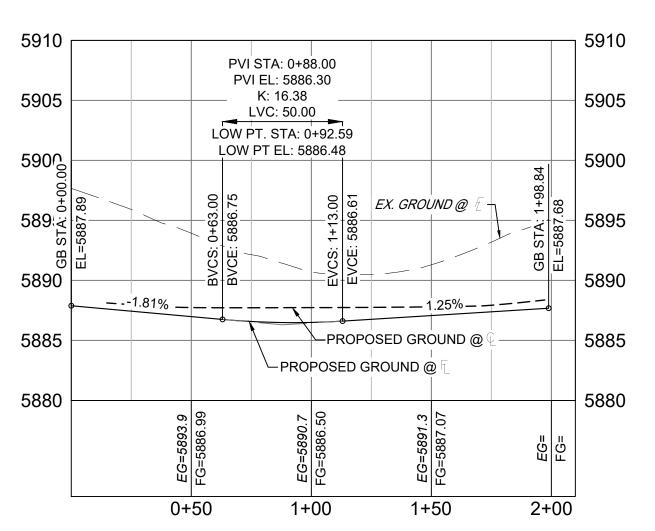

Big Johnson NorthEast - FL PROFILE SCALE: (H) 1" = 40' (V) 1" = 8' START STA: 0+00.00, END STA: 2+10.00


LINE TABLE				
LINE#	BEARING	DISTANCE		
L59	N21°14'07"W	10.00		
L60	N00°20'48"W	20.00		

	CURVE TABLE						
CURVE#	ARC LENGTH	RADIUS	DELTA ANGLE	CHORD BEARING	CHORD LENGTH		
C36	26.60	68.00	22°24'35"	S75°26'07"W	26.43		
C37	76.45	52.00	84°14'00"	N73°39'10"W	69.75		
C38	38.35	51.30	42°49'48"	N01°01'27"E	37.46		
C39	27.45	68.83	22°50'42"	N11°04'33"E	27.26		

DRAWINGS

No. DATE

COMPUTER FILE MANAGEMENT

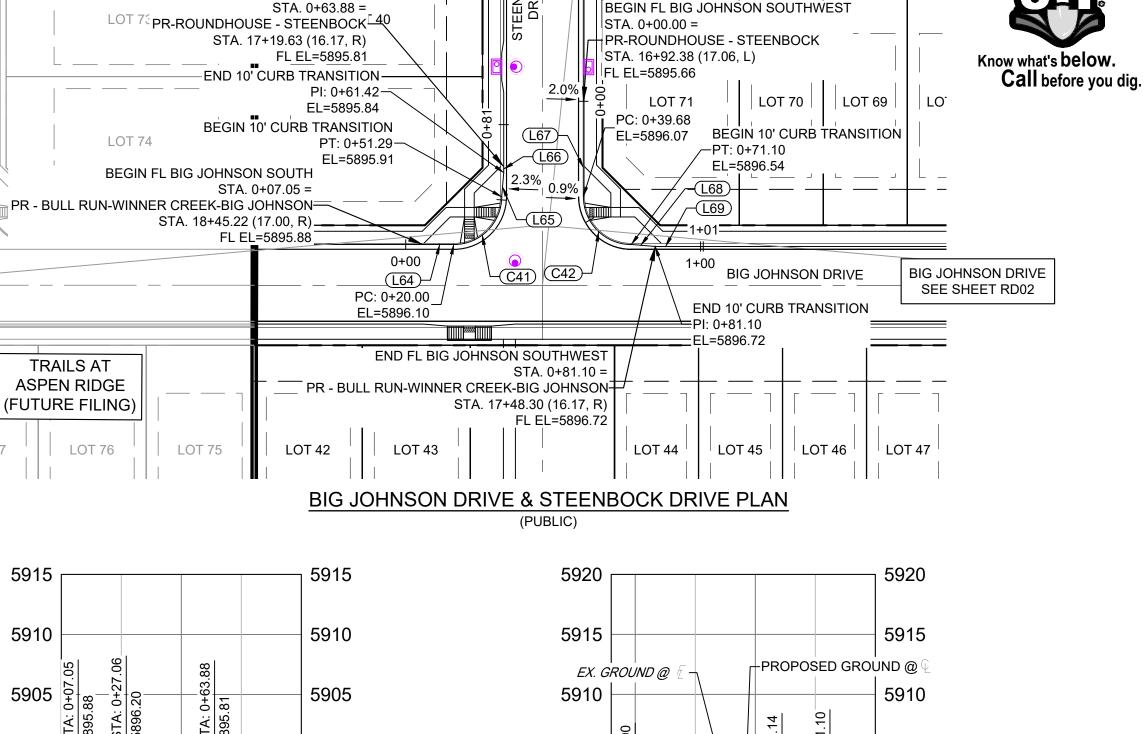

STEENBOCK DRIVE SEE SHEET RD05

Big Johnson South - FL PROFILE SCALE: (H) 1" = 40' (V) 1" = 8' START STA: 0+00.00, END STA: 1+00.00

∽ EX. GROUND @

│└─PROPOSED GROUND @ □


└-1.07%

PROPOSED GROUND @

5900 炽

5890

END FL BIG JOHNSON SOUTH

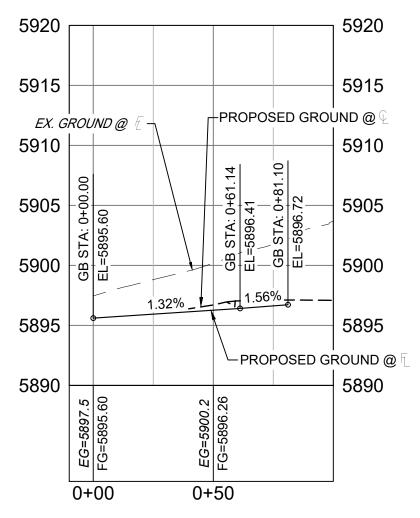

SHEET No. 14


Big Johnson SouthWest - FL PROFILE SCALE: (H) 1" = 40' (V) 1" = 8' START STA: -0+10.00, END STA: 1+00.00

LINE TABLE						
LINE#	DISTANCE					
L64	S00°20'48"E	12.95				
L65	S85°37'17"E	10.12				
L66	N89°39'12"E	2.47				
L67	N89°39'12"E	20.00				
L68	N04°26'01"E	10.00				
L69	N00°20'48"W	20.00				

CURVE TABLE					
CURVE#	ARC LENGTH	RADIUS	DELTA ANGLE	CHORD BEARING	CHORD LENGTH
C41	31.29	20.00	89°39'12"	S45°10'24"E	28.20
C42	31.42	20.00	90°00'00"	N44°39'12"E	28.28

BENCHMARK COLORADO SPRINGS UTILITIES (FIMS) MONUMENT F206 A BERNTSEN TOP SECURITY MONUMENT SYSTEM WITH A 3.5-INCH DIAMETER ALUMINUM CAP IN A ROAD BOX, LOCATED ON THE NORTHWEST CORNER OF FONTAINE BOULEVARD AND POWERS BOULEVARD, ELEVATION - 5897.89' U.S. SURVEY FT

BEARINGS ARE BASED ON THE NORTH LINE OF THE NORTHWEST QUARTER OF SECTION 9, BEARINGS ARE BASED ON THE NORTH ENGLY AND SAID LINE BEARS S89°51 23 E FROW THE TOWNSHIP 15 SOUTH, RANGE 65 WEST OF THE 6TH P.M. SAID LINE BEARS S89°51 23 E FROW THE NORTHWEST CORNER OF SAID SECTION 9 (2½" AULM. CAP PLS 17664) TO THE N¼ CORNER OF SAID S 10377)

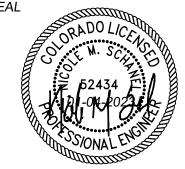

TRAILS AT ASPEN RIDGE FILING NO. 4

SF-21-024

ROADWAY & STORM IMPROVEMENT PLANS

FLOWLINE PLAN & PROFILE

FILE NAME: S:\21.886.038 (Trails F6)\100 Dwg\104 Plan Sets\Construction Plans\Road & Storm Plans\RD - FLOWLINES.dwg
CTB FILE: Matrix(black).ctb
PLOT DATE: January 4, 2023 1:37:46 PM THIS DRAWING IS CURRENT AS OF PLOT DATE AND MAY BE SUBJECT TO CHANGE.

REVISIONS


DESCRIPTION


PREPARED BY:


FOR AND ON BEHALF OF MATRIX DESIGN GROUP, INC. PROJECT No. 21.886.038


DRAWN BY: CAG SCALE DATE ISSUED:

CHECKED BY: NMS VERT. 1"=9" AUGUST 2021 DRAWING No. 14 OF 32

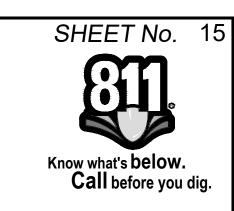


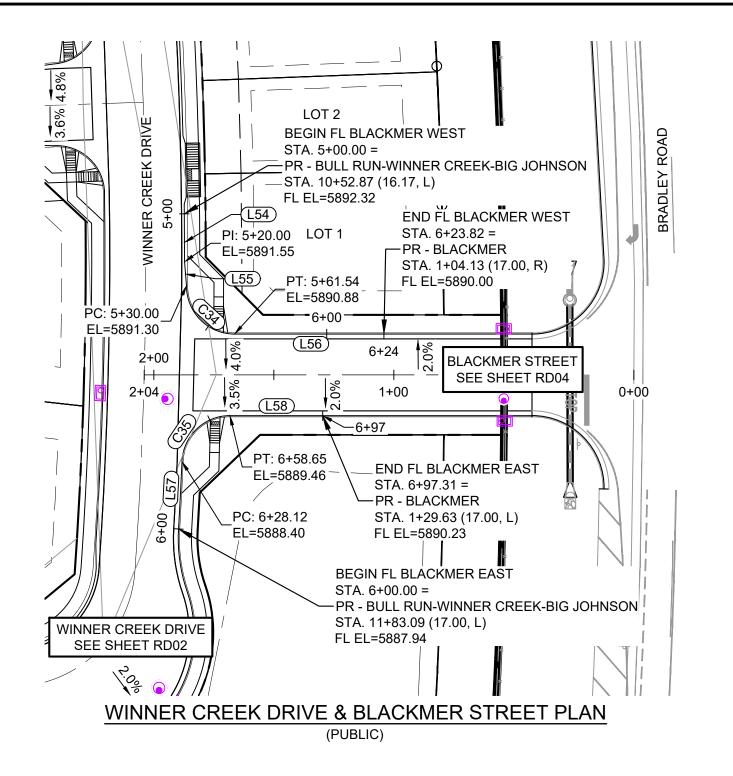

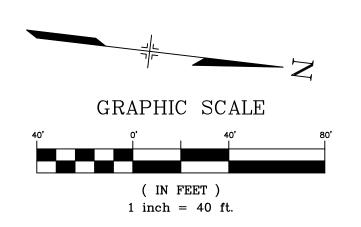

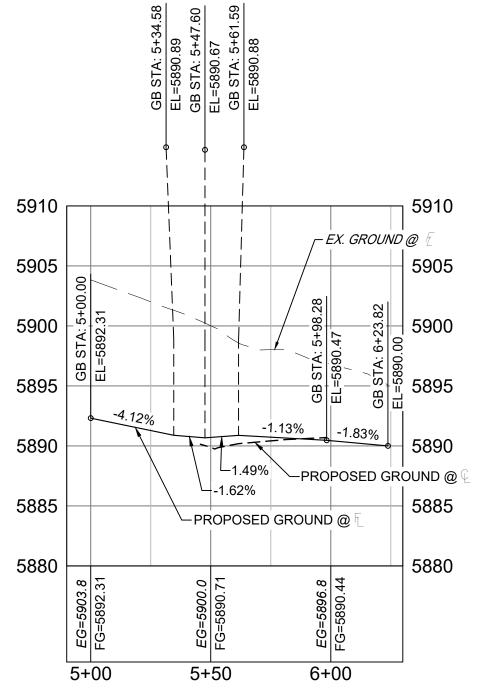

Blackmer West - FL PROFILE SCALE: (H) 1" = 40' (V) 1" = 8' START STA: 4+90.00, END STA: 6+30.00

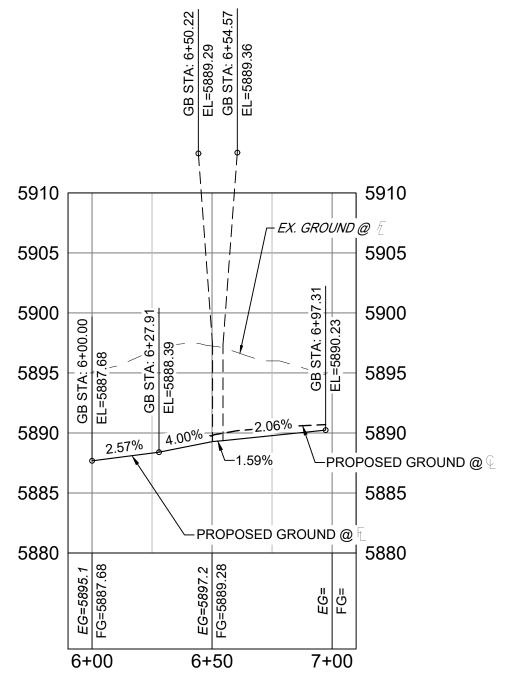

Blackmer East - FL PROFILE SCALE: (H) 1" = 40' (V) 1" = 8' START STA: 5+90.00, END STA: 7+10.00

LINE TABLE						
LINE#	BEARING	DISTANCE				
L54	N83°03'34"E	20.00				
L55	N78°43'17"E	10.00				
L56	N06°43'16"W	62.28				
L57	S86°13'31"W	28.12				
L58	N06°43'16"W	38.66				

CURVE TABLE							
CURVE#	ARC LENGTH	RADIUS	DELTA ANGLE	CHORD BEARING	CHORD LENGTH		
C34	31.54	20.00	90°22'11"	N38°27'50"E	28.38		
C35	30.53	20.00	87°28'07"	N50°27'19"W	27.65		

PREPARED BY:

REFERENCE DRAWINGS				SHEET KEY
	No. DATE	DESCRIPTION REVISIONS	BY	
	COMPUTER FILE MANAGEN FILE NAME: S:\21.886.038 (Trails F6)\10 CTB FILE: Matrix(black).ctb PLOT DATE: January 4, 2023 1:37:54 PN THIS DRAWING IS CURRENT AS OF PLOT DATE AND M.	00 Dwg\104 Plan Sets\Construction Plans\Road & Storm Plans\RD - FLOWLINES.dw //	/g	

BENCHMARK

COLORADO SPRINGS UTILITIES (FIMS) MONUMENT F206 A BERNTSEN TOP SECURITY MONUMENT SYSTEM WITH A 3.5-INCH DIAMETER ALUMINUM CAP IN A ROAD BOX, LOCATED ON THE NORTHWEST CORNER OF FONTAINE BOULEVARD AND POWERS BOULEVARD,

BASIS OF BEARING

ELEVATION - 5897.89' U.S. SURVEY FT

BEARINGS ARE BASED ON THE NORTH LINE OF THE NORTHWEST QUARTER OF SECTION 9, BEARINGS ARE BASED ON THE NORTH ENGLAND TOWNSHIP 15 SOUTH, RANGE 65 WEST OF THE 6TH P.M. SAID LINE BEARS S89°5123 E FROW THE NORTHWEST CORNER OF SAID SECTION 9 (2 ½" AULM. CAP PLS 17664) TO THE N ¼ CORNER OF SAID SECTION 9 (2 ½" AULM. CAP PLS 17664) TO THE N Å § (2 ½" AULM. CAP PLS 17664) TO THE N Å § (2 ½" AULM. CAP PLS 17664) TO THE N Å § (2



FILING NO. 4 ROADWAY & STORM IMPROVEMENT PLANS


FLOWLINE PLAN AND PROFILE


TRAILS AT ASPEN RIDGE


SF-21-024


FOR AND ON BEHALF OM MATRIX DESIGN GROUP,


FOR AND ON BEHALF OF	DESIGNED BY:	CAG	SCA	ALE	DATE ISSUED:	AUGUST 2021	DRAWING No.
MATRIX DESIGN GROUP, INC.	DRAWN BY:	CAG	HORIZ.	1" = 40'	SHEET	15 OF 32	RD10
PROJECT No. 21.886.038	CHECKED BY:	NMS	VERT.	1"=8'	SHEET	13 UF 32	

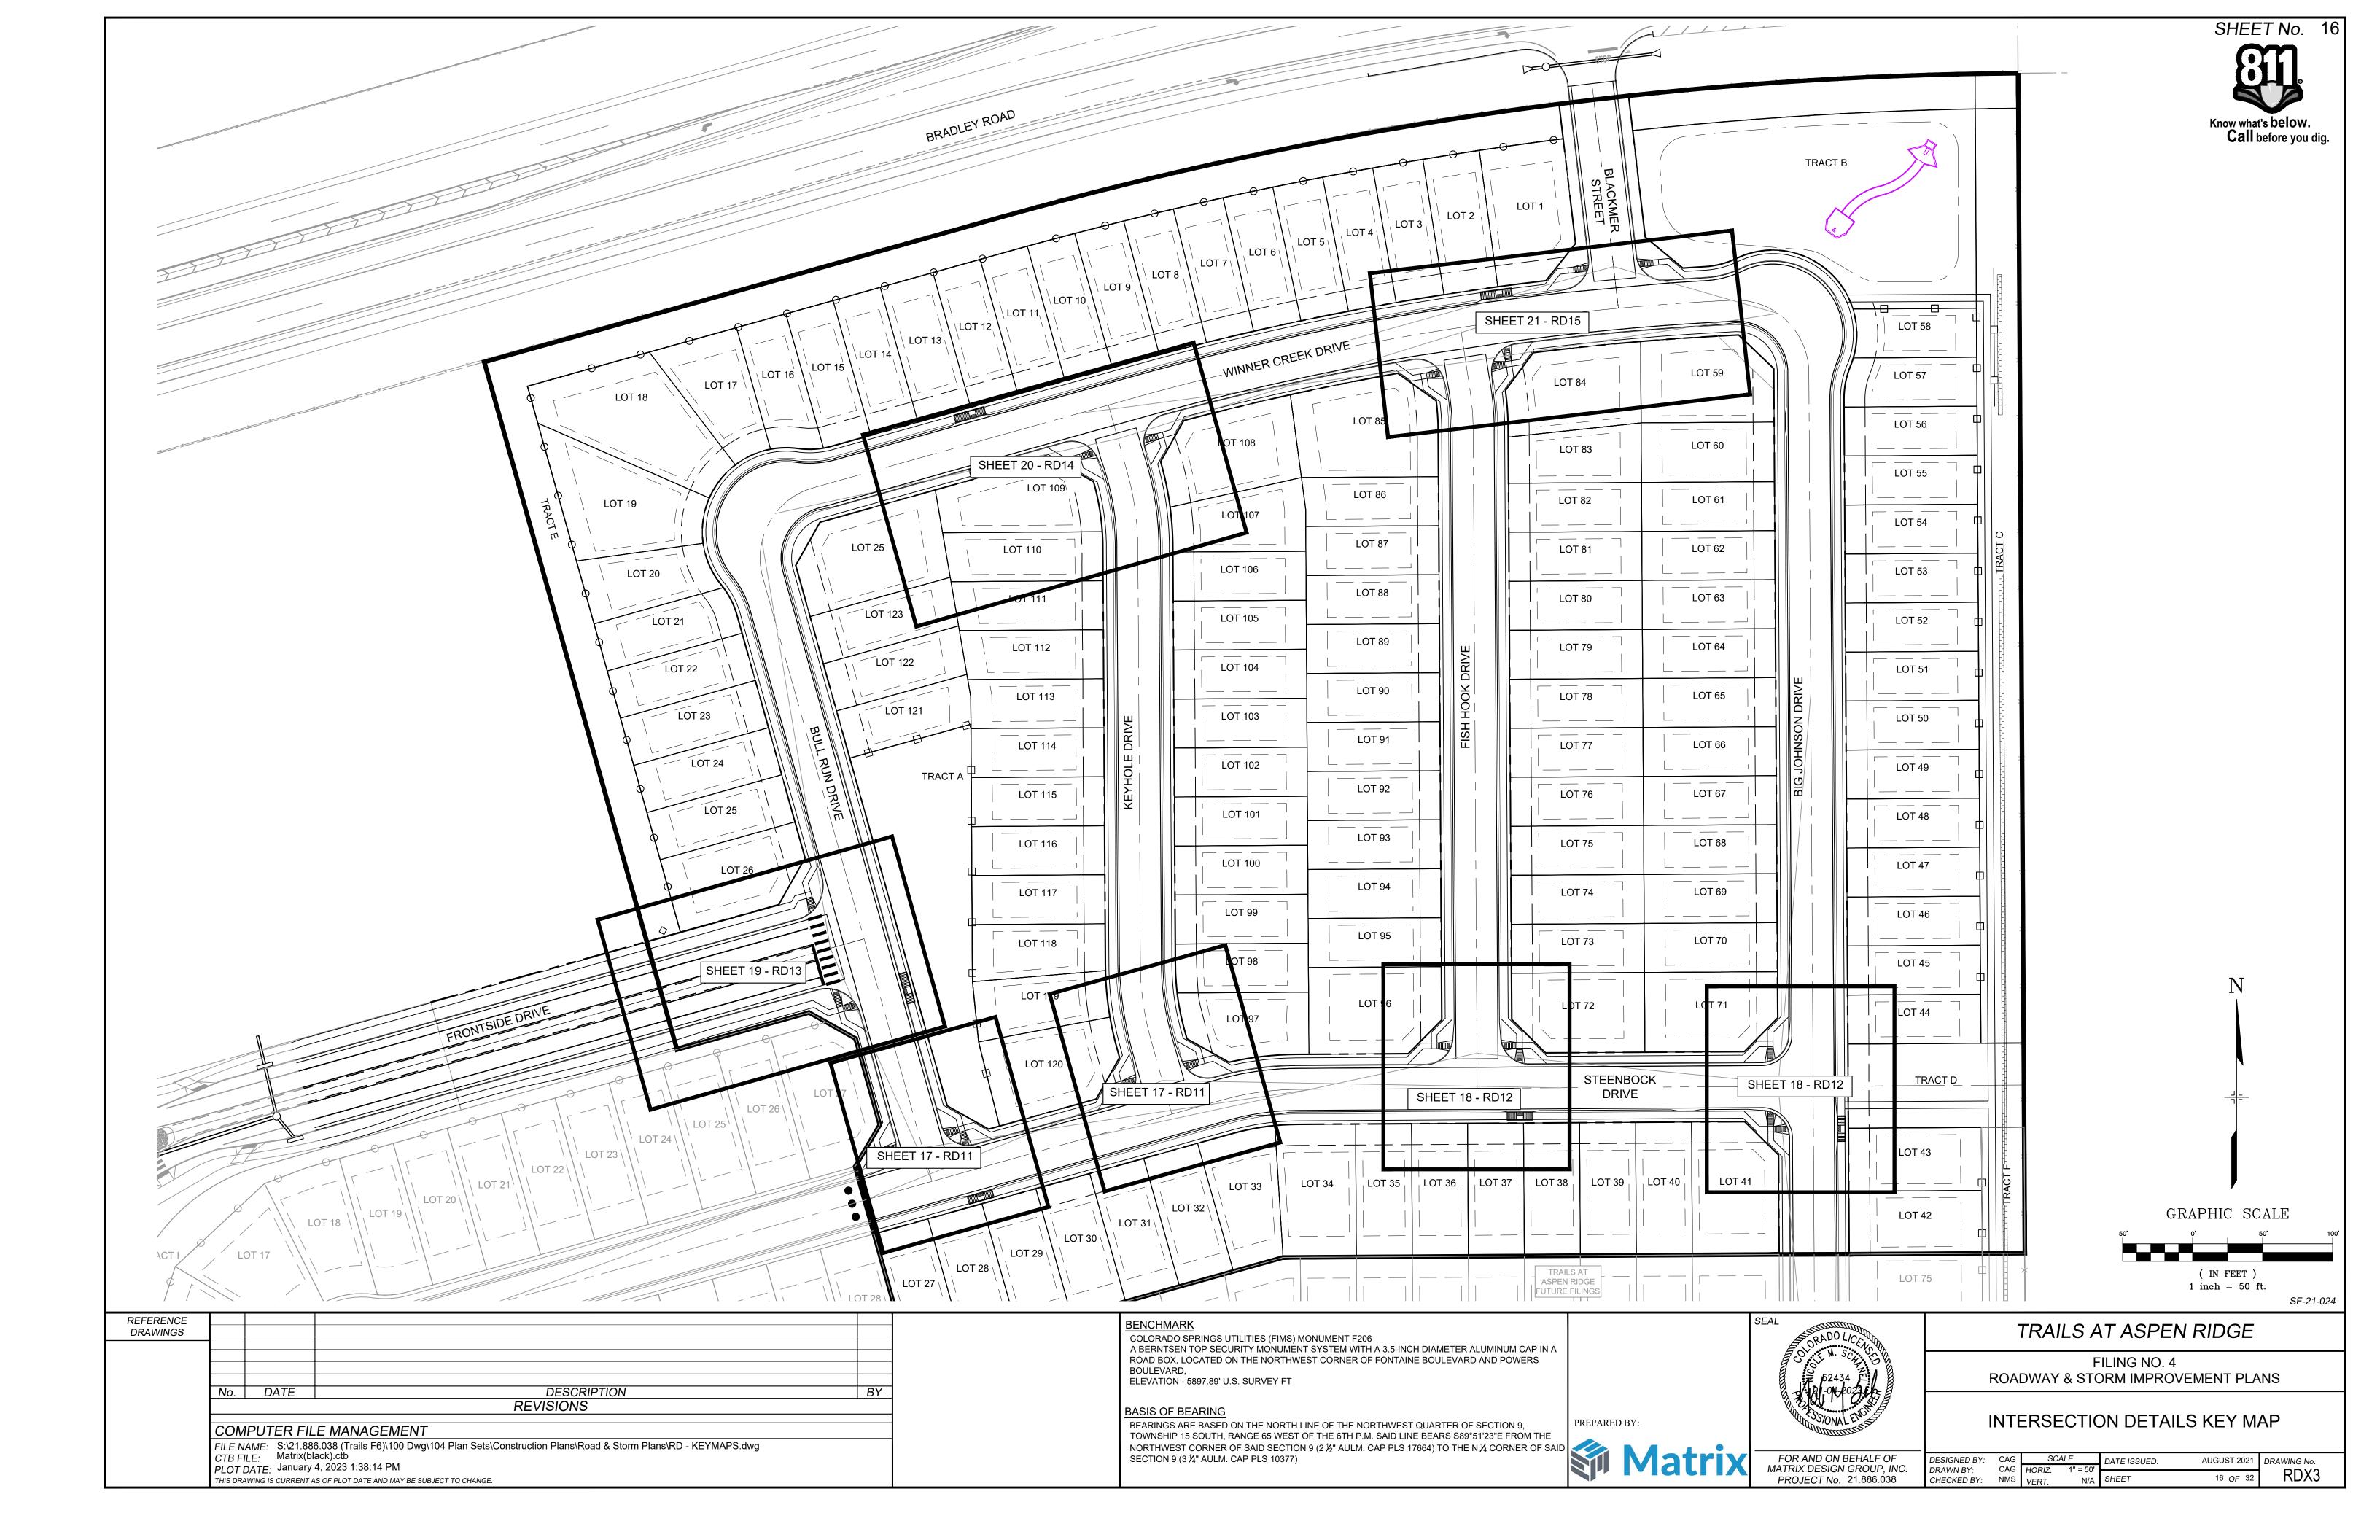


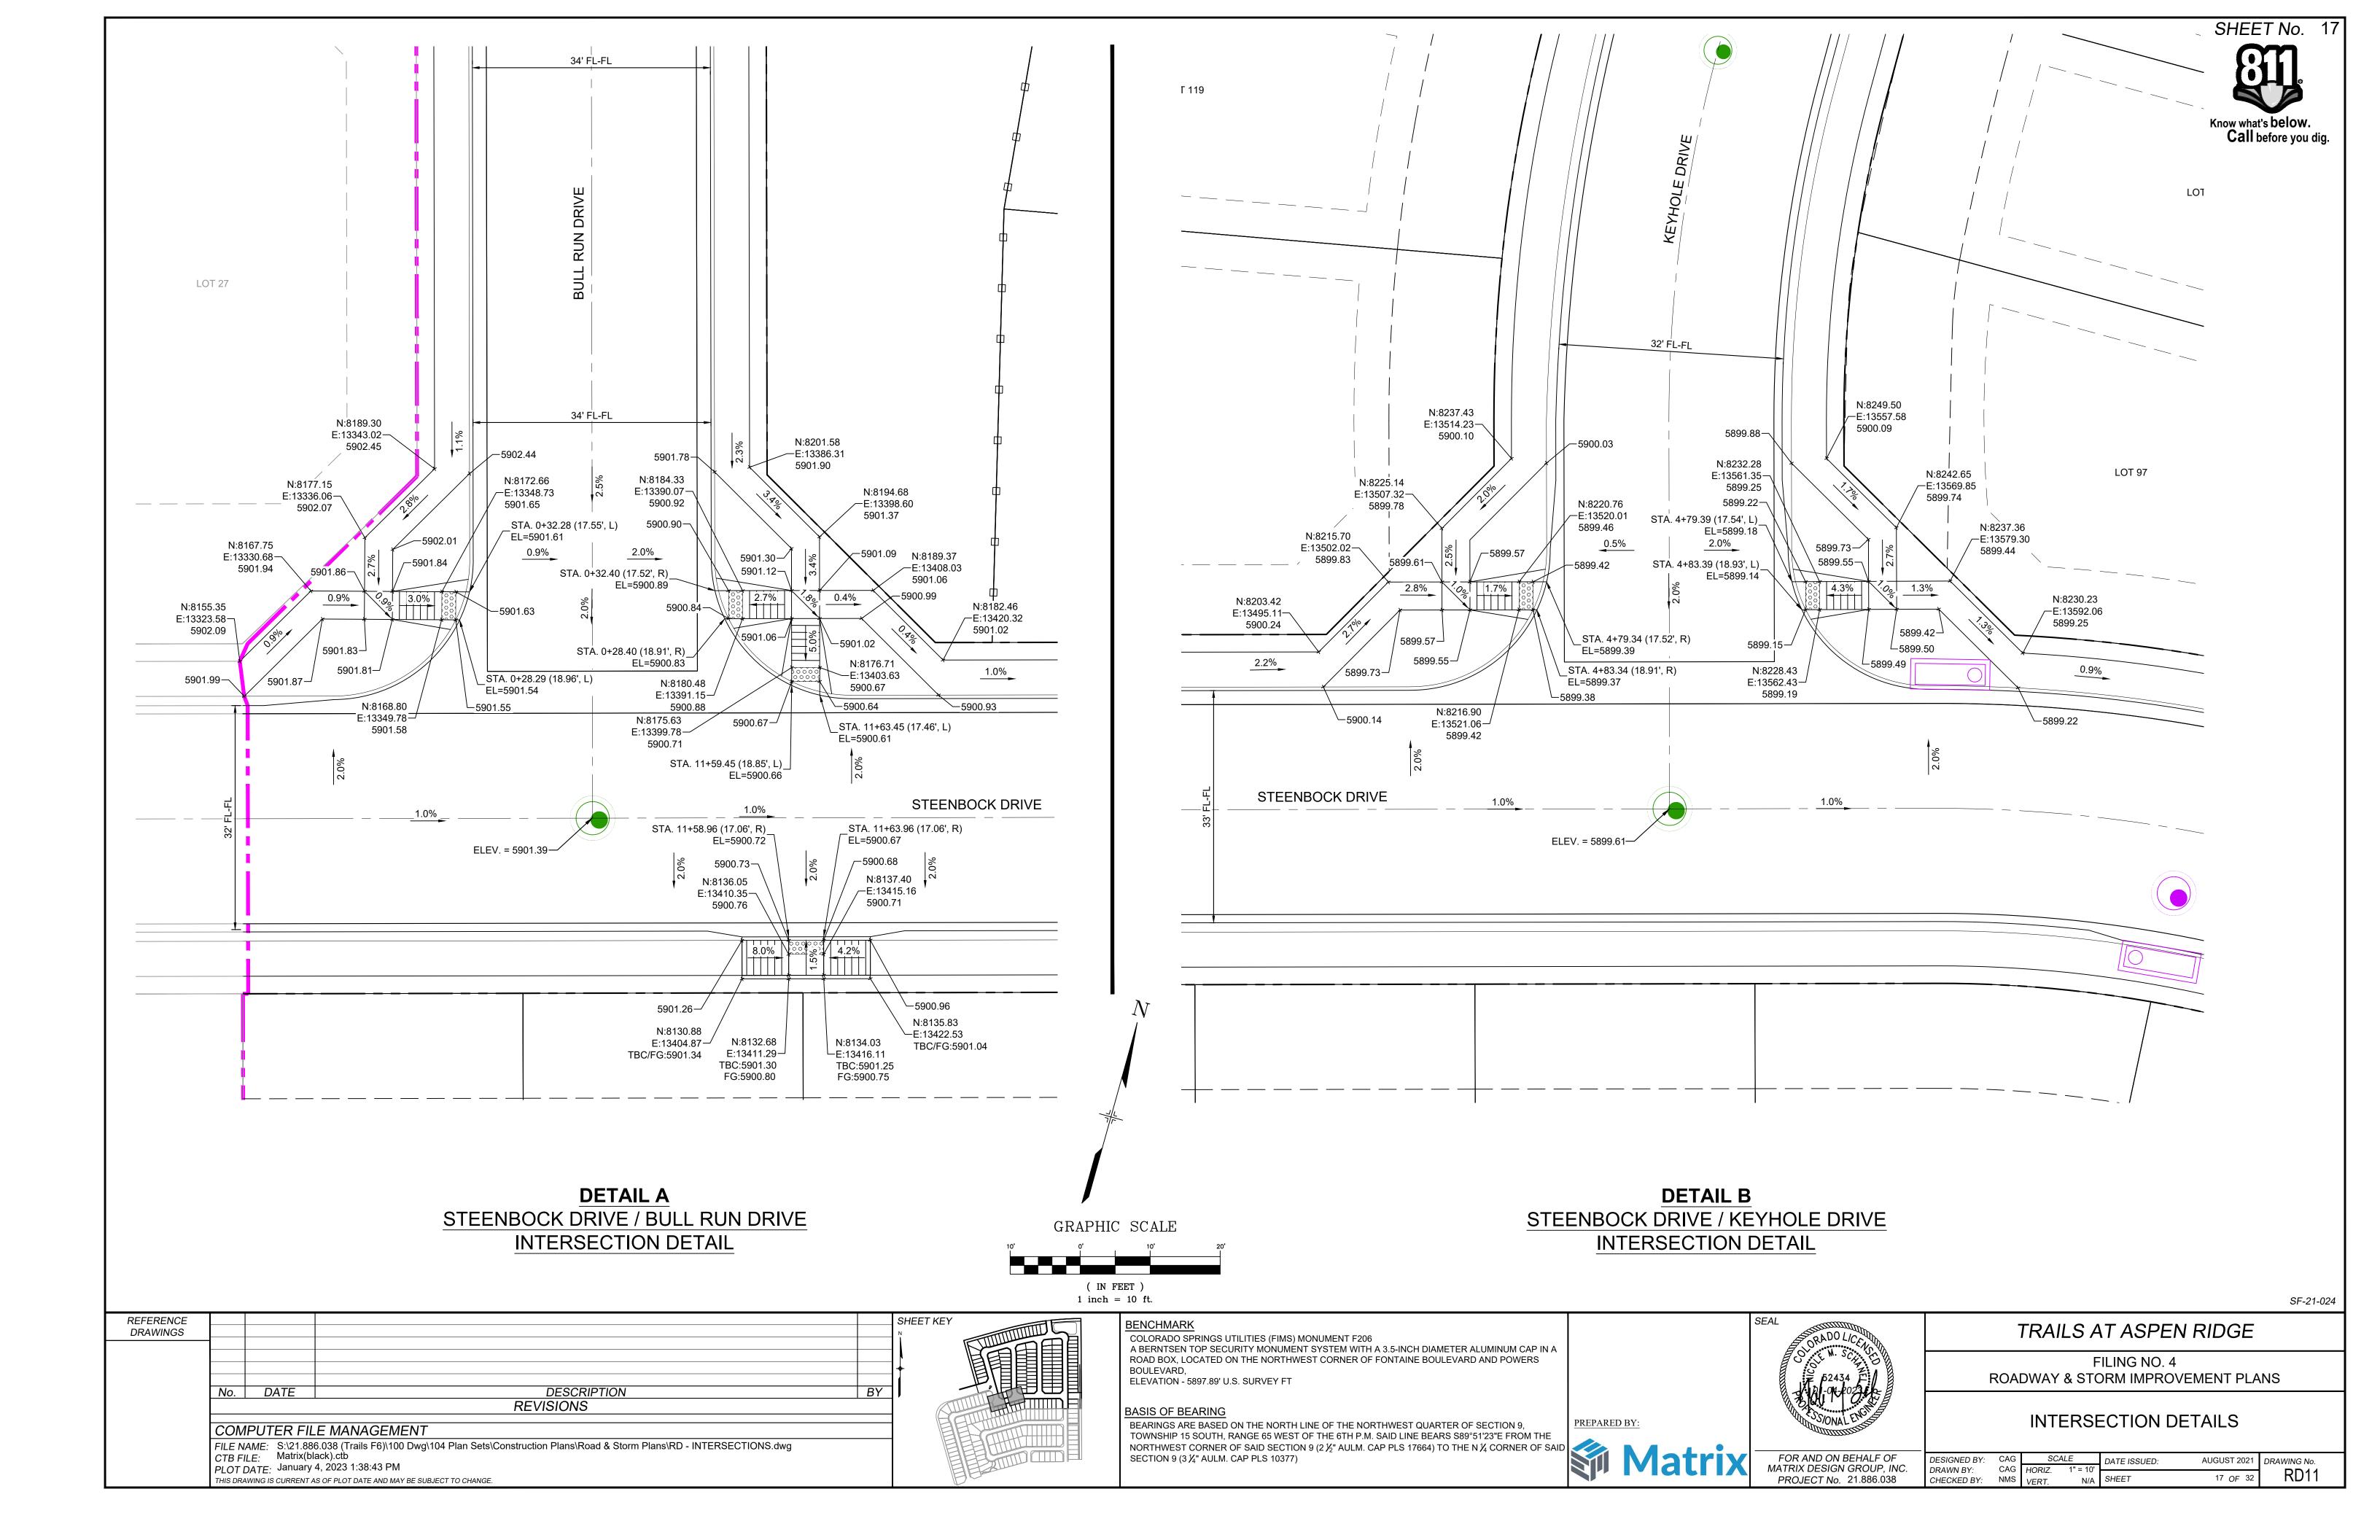


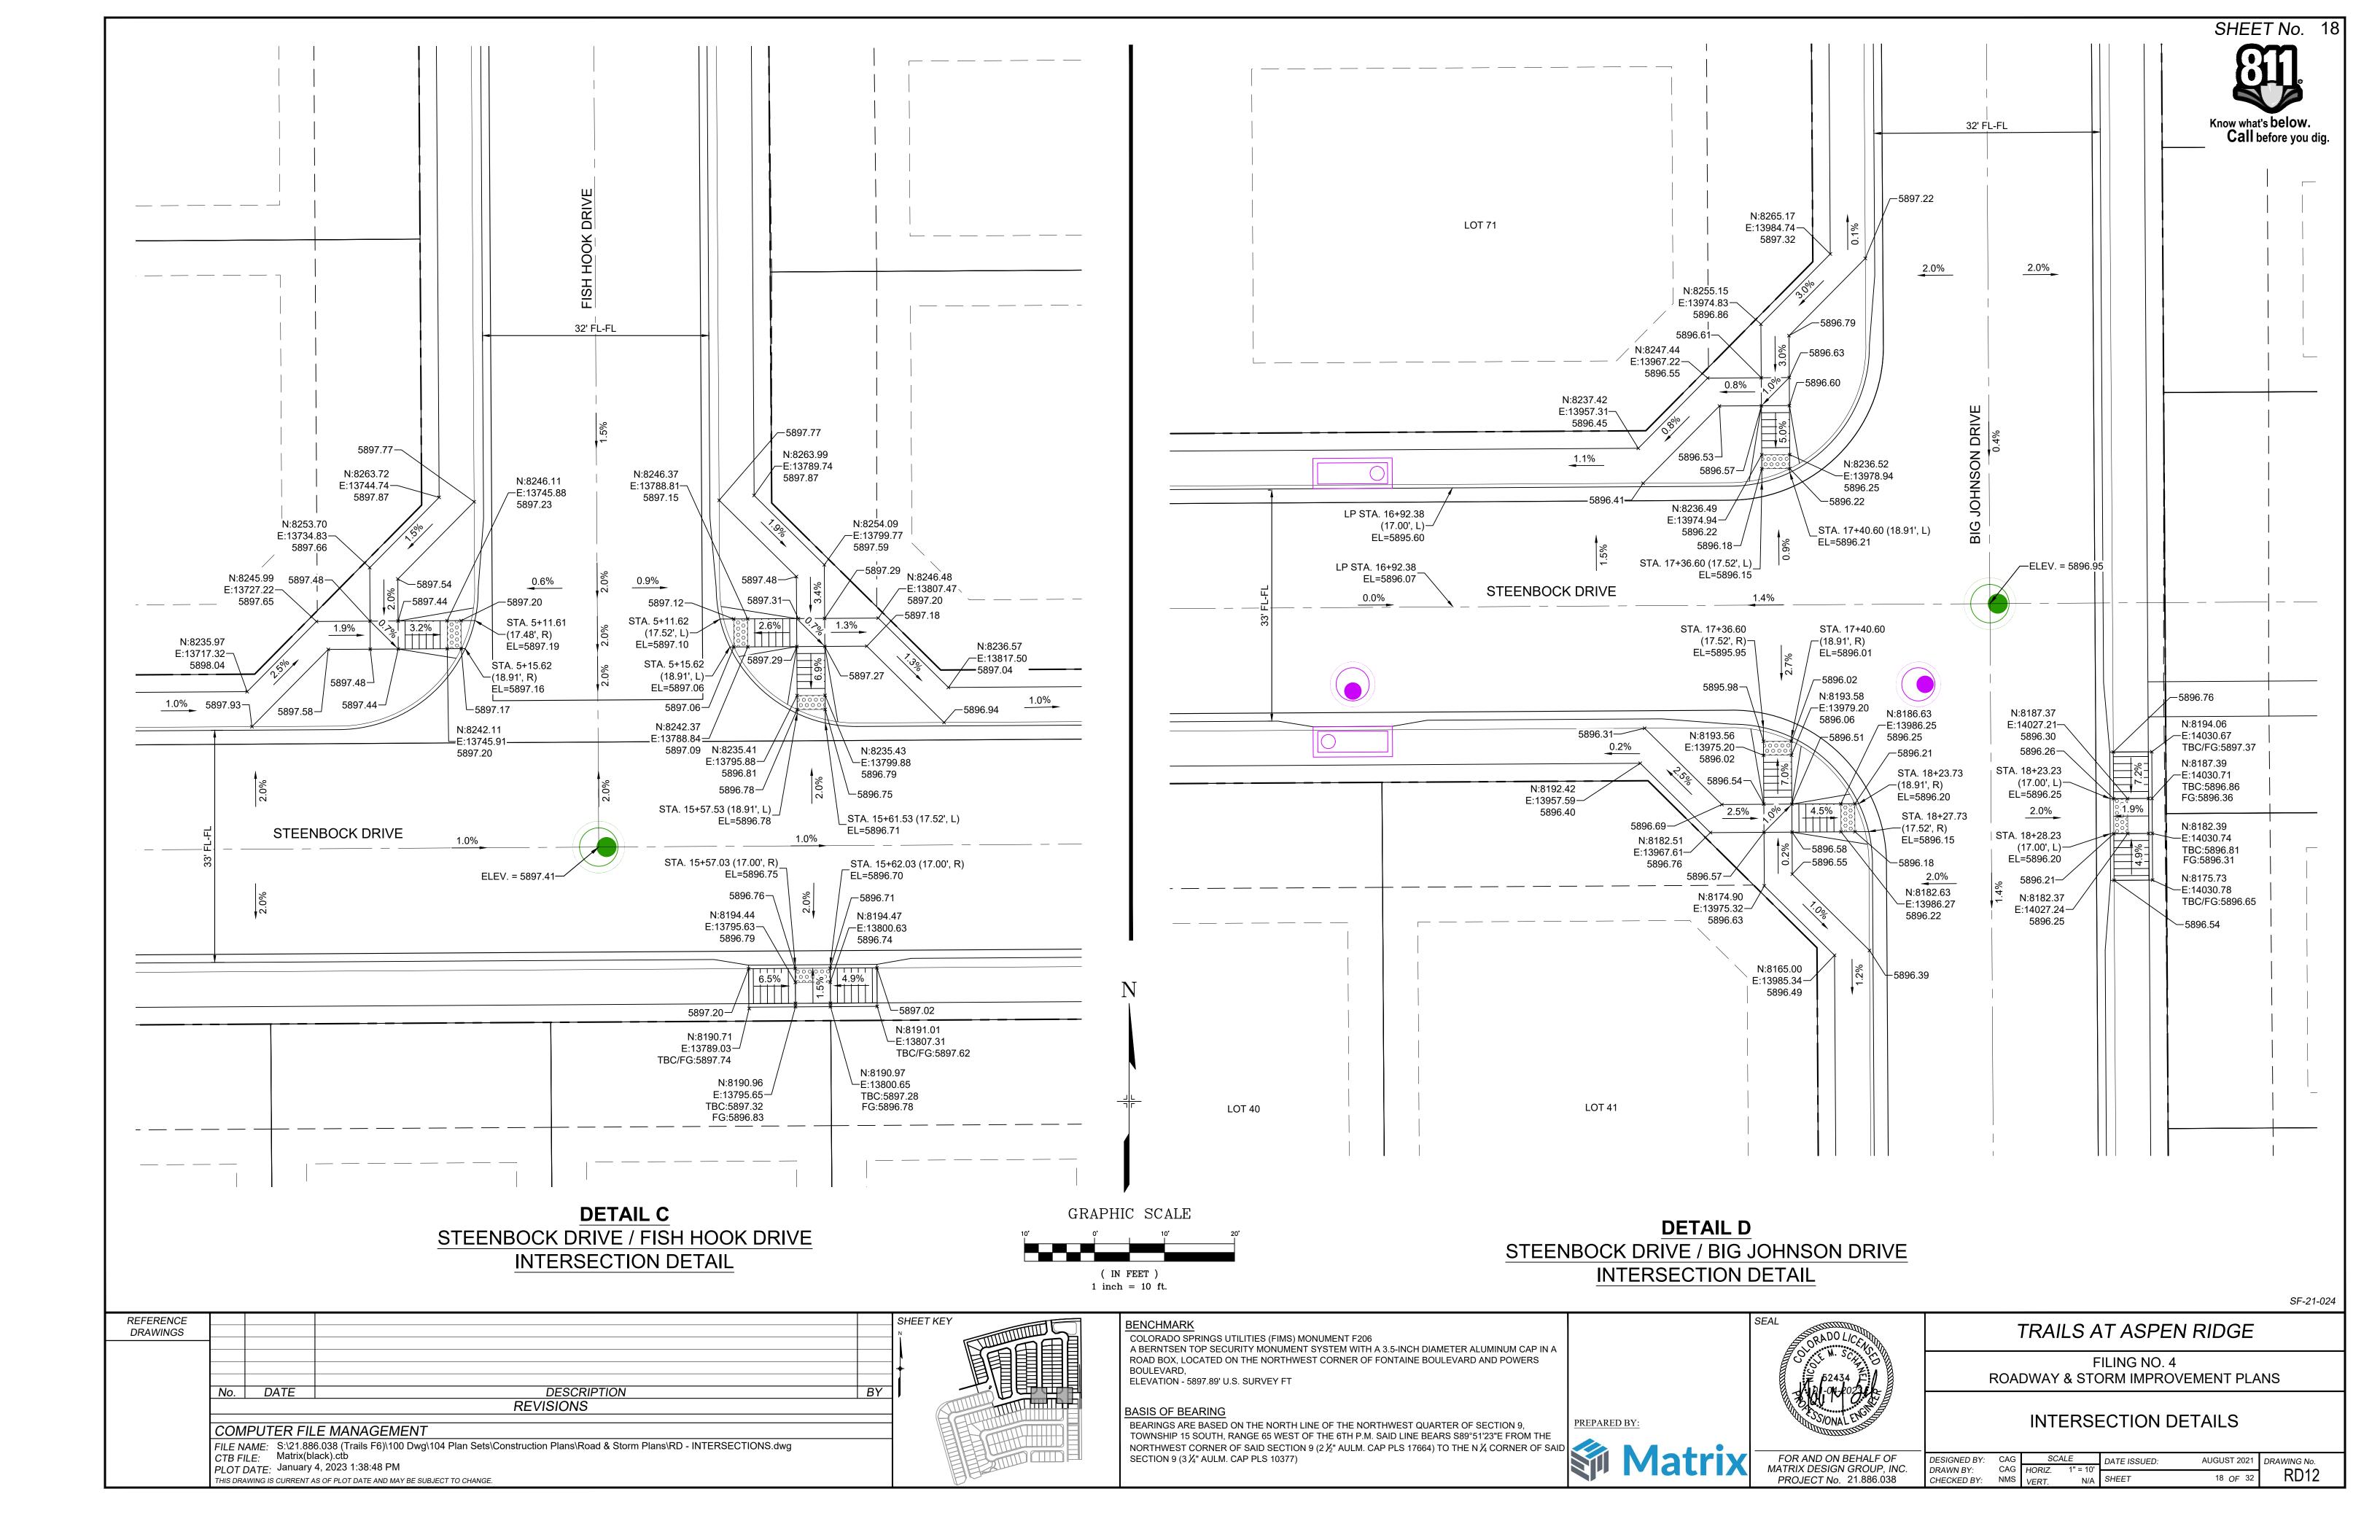


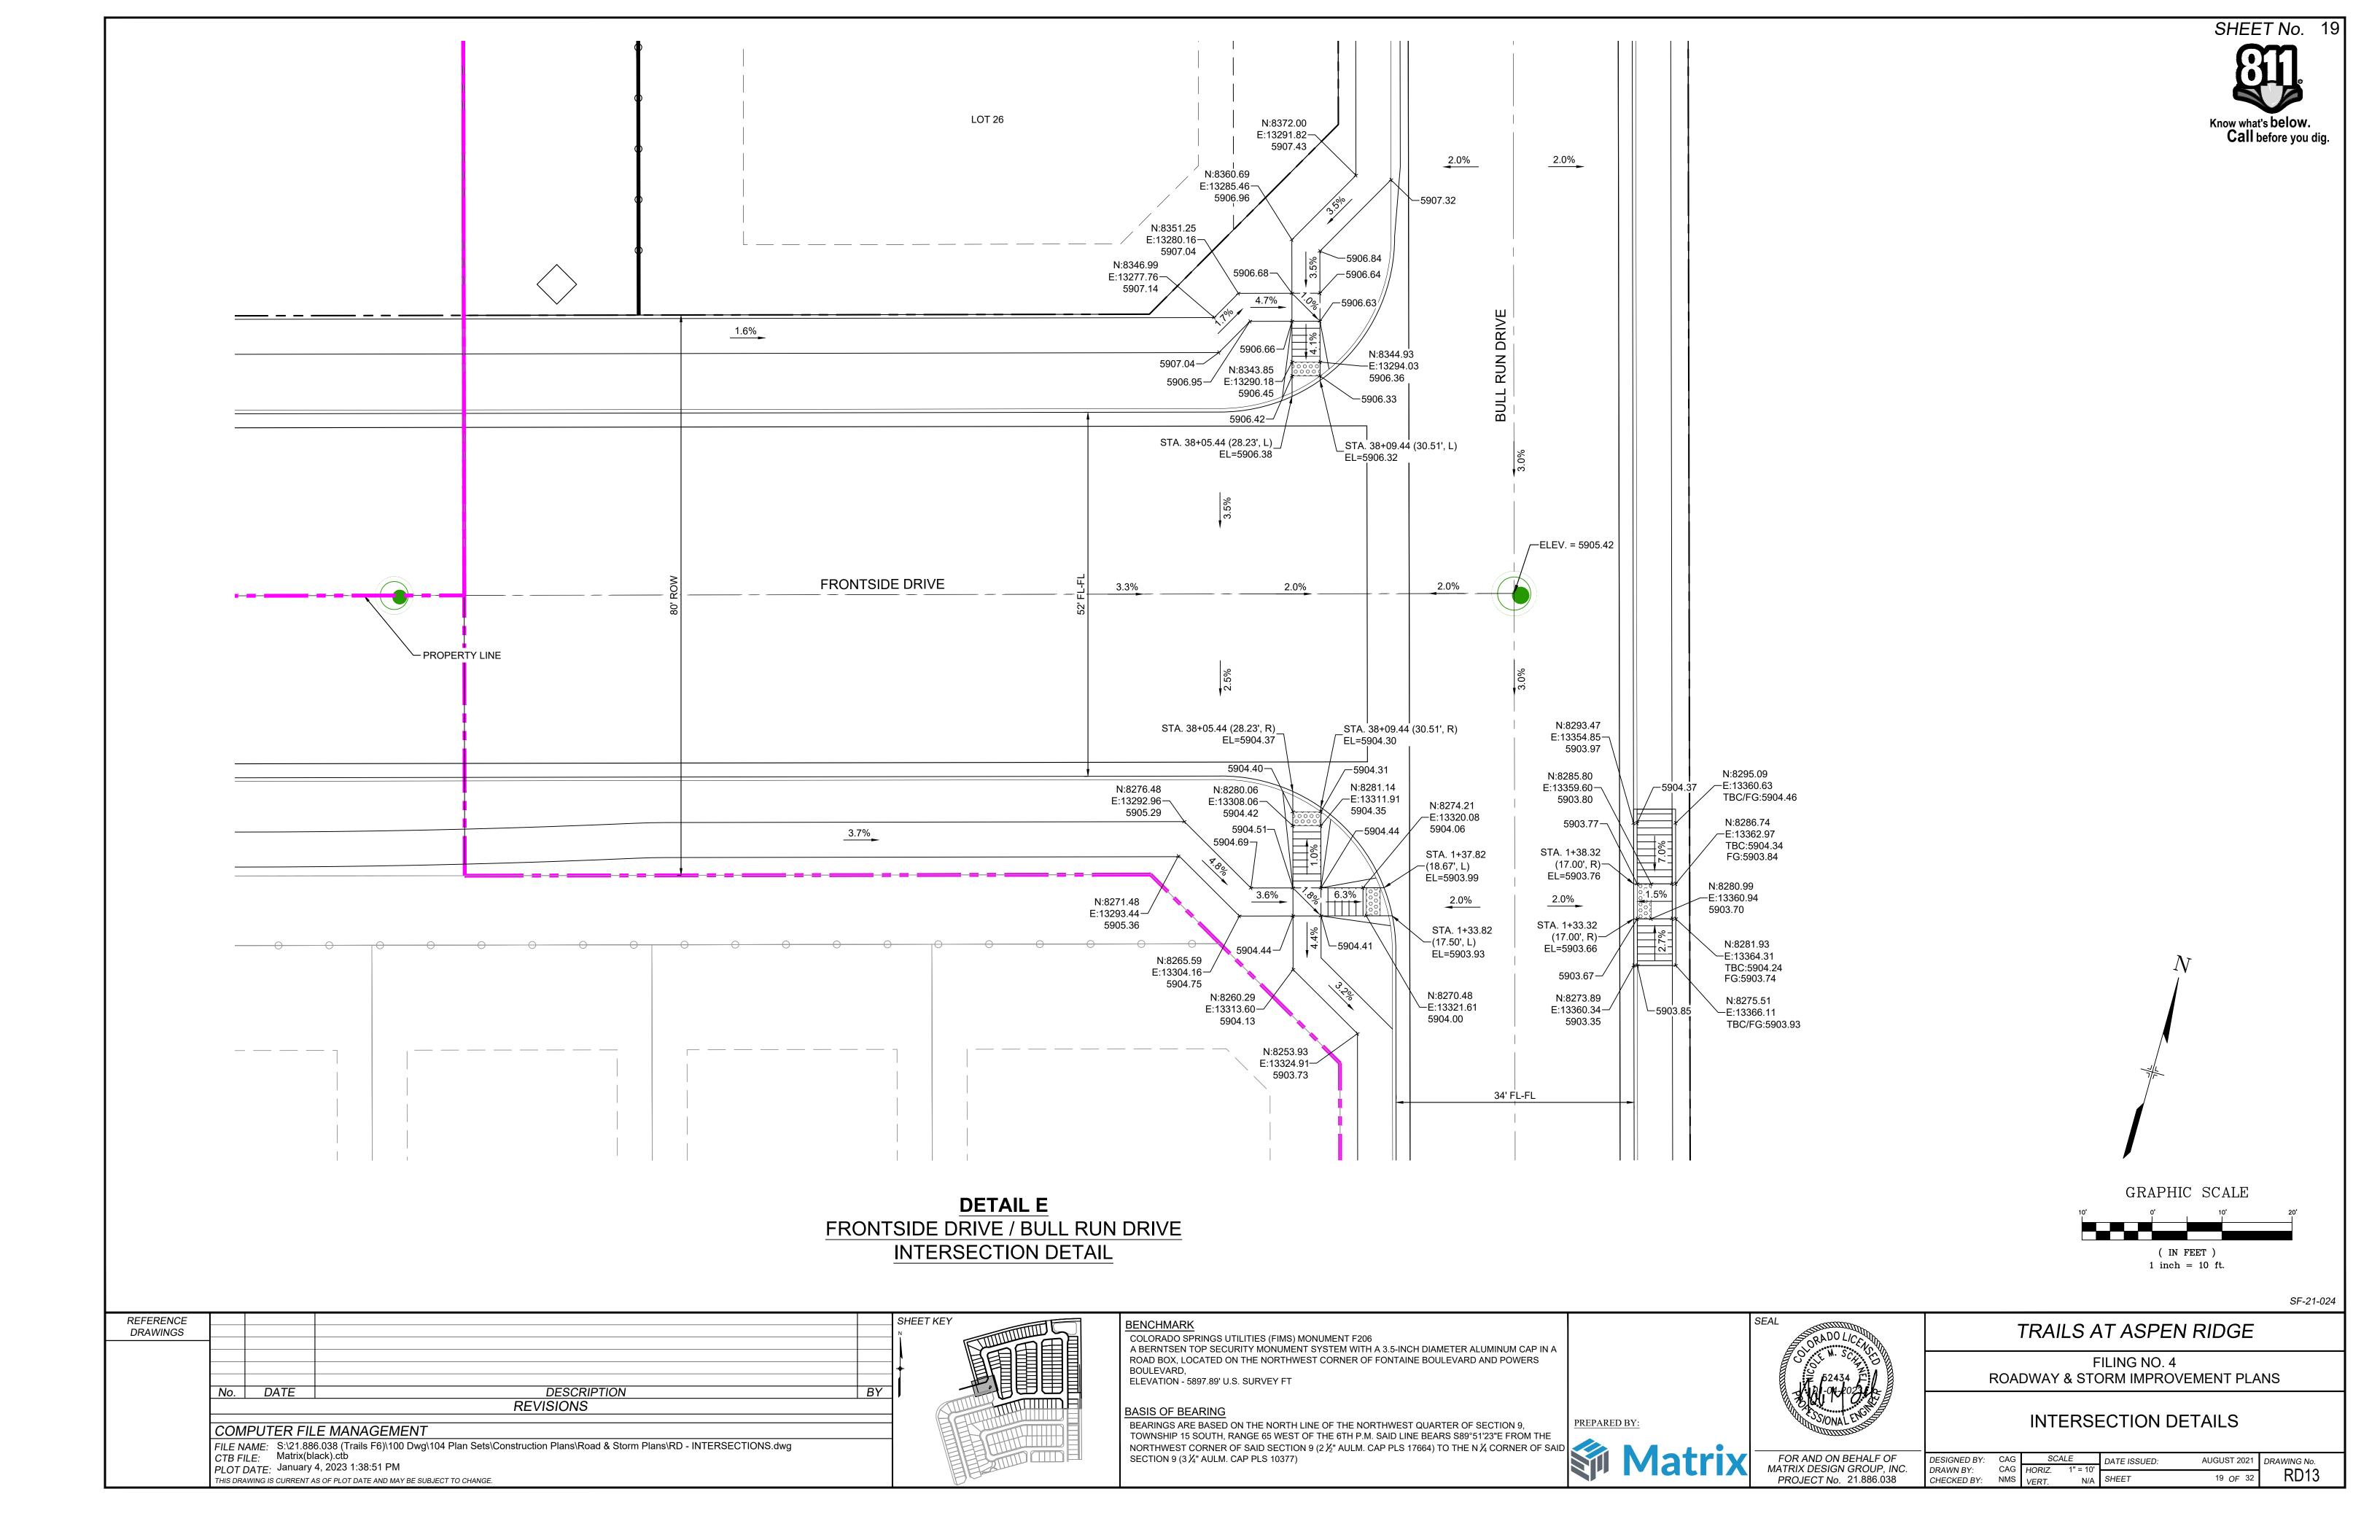


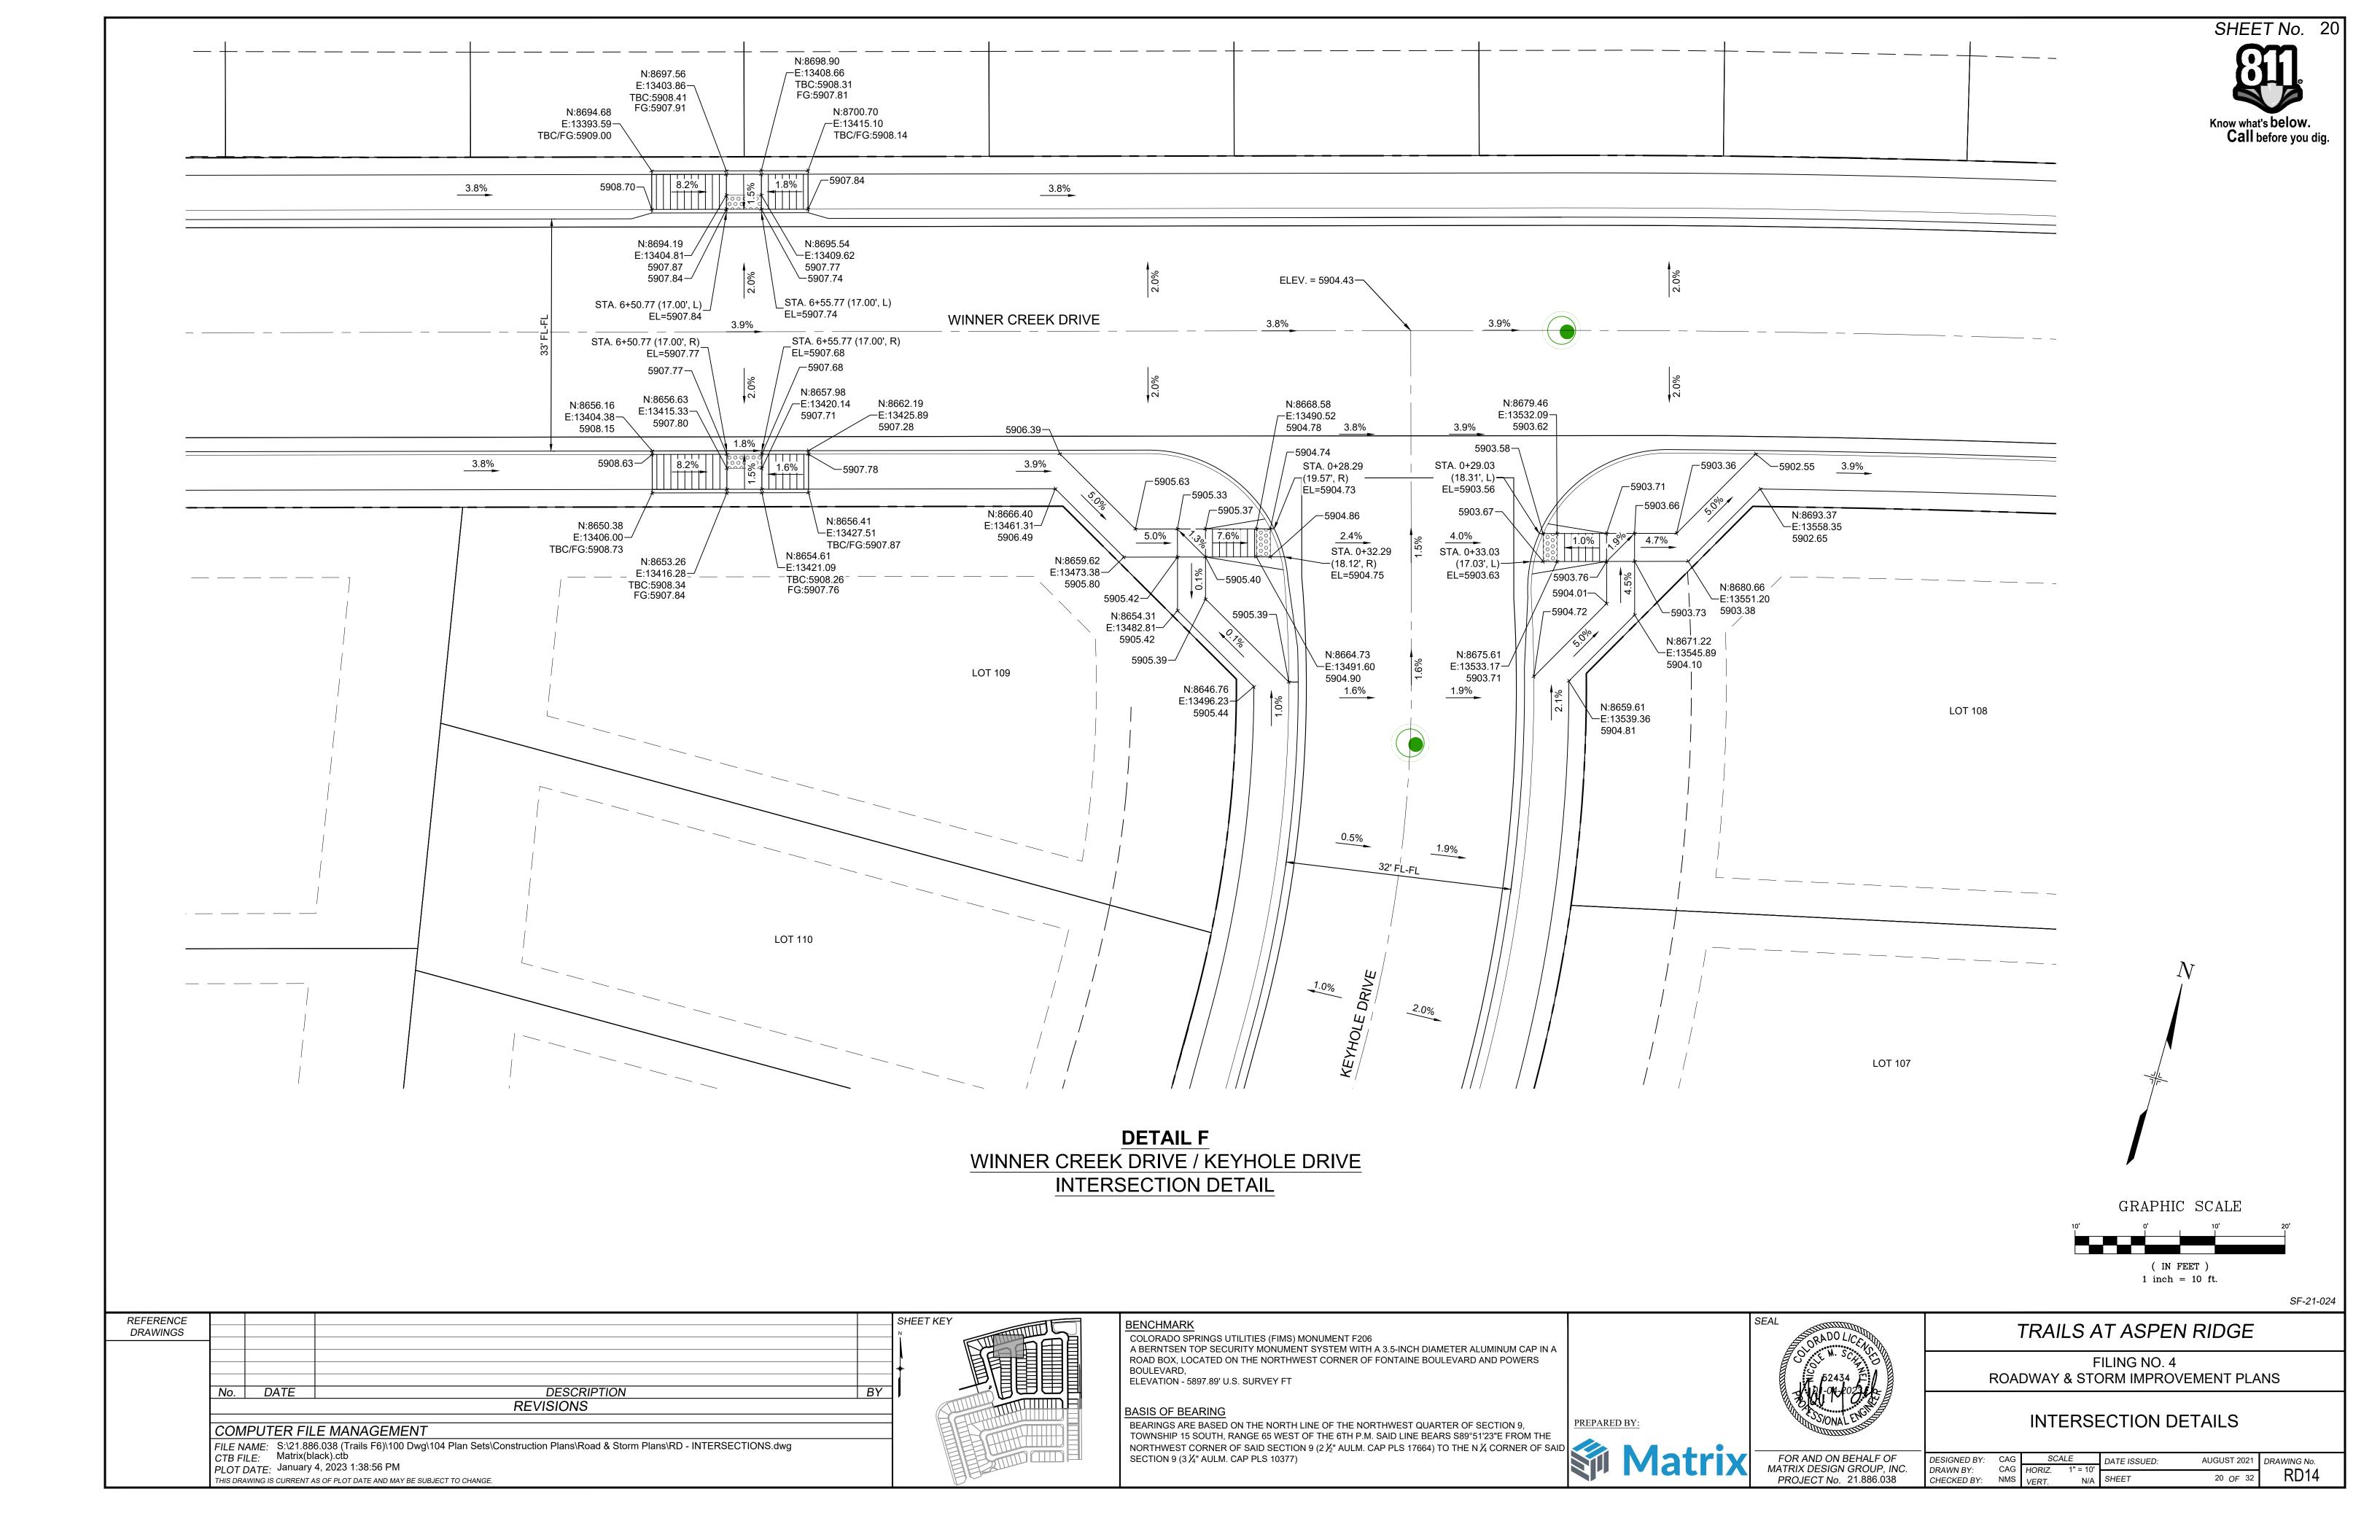


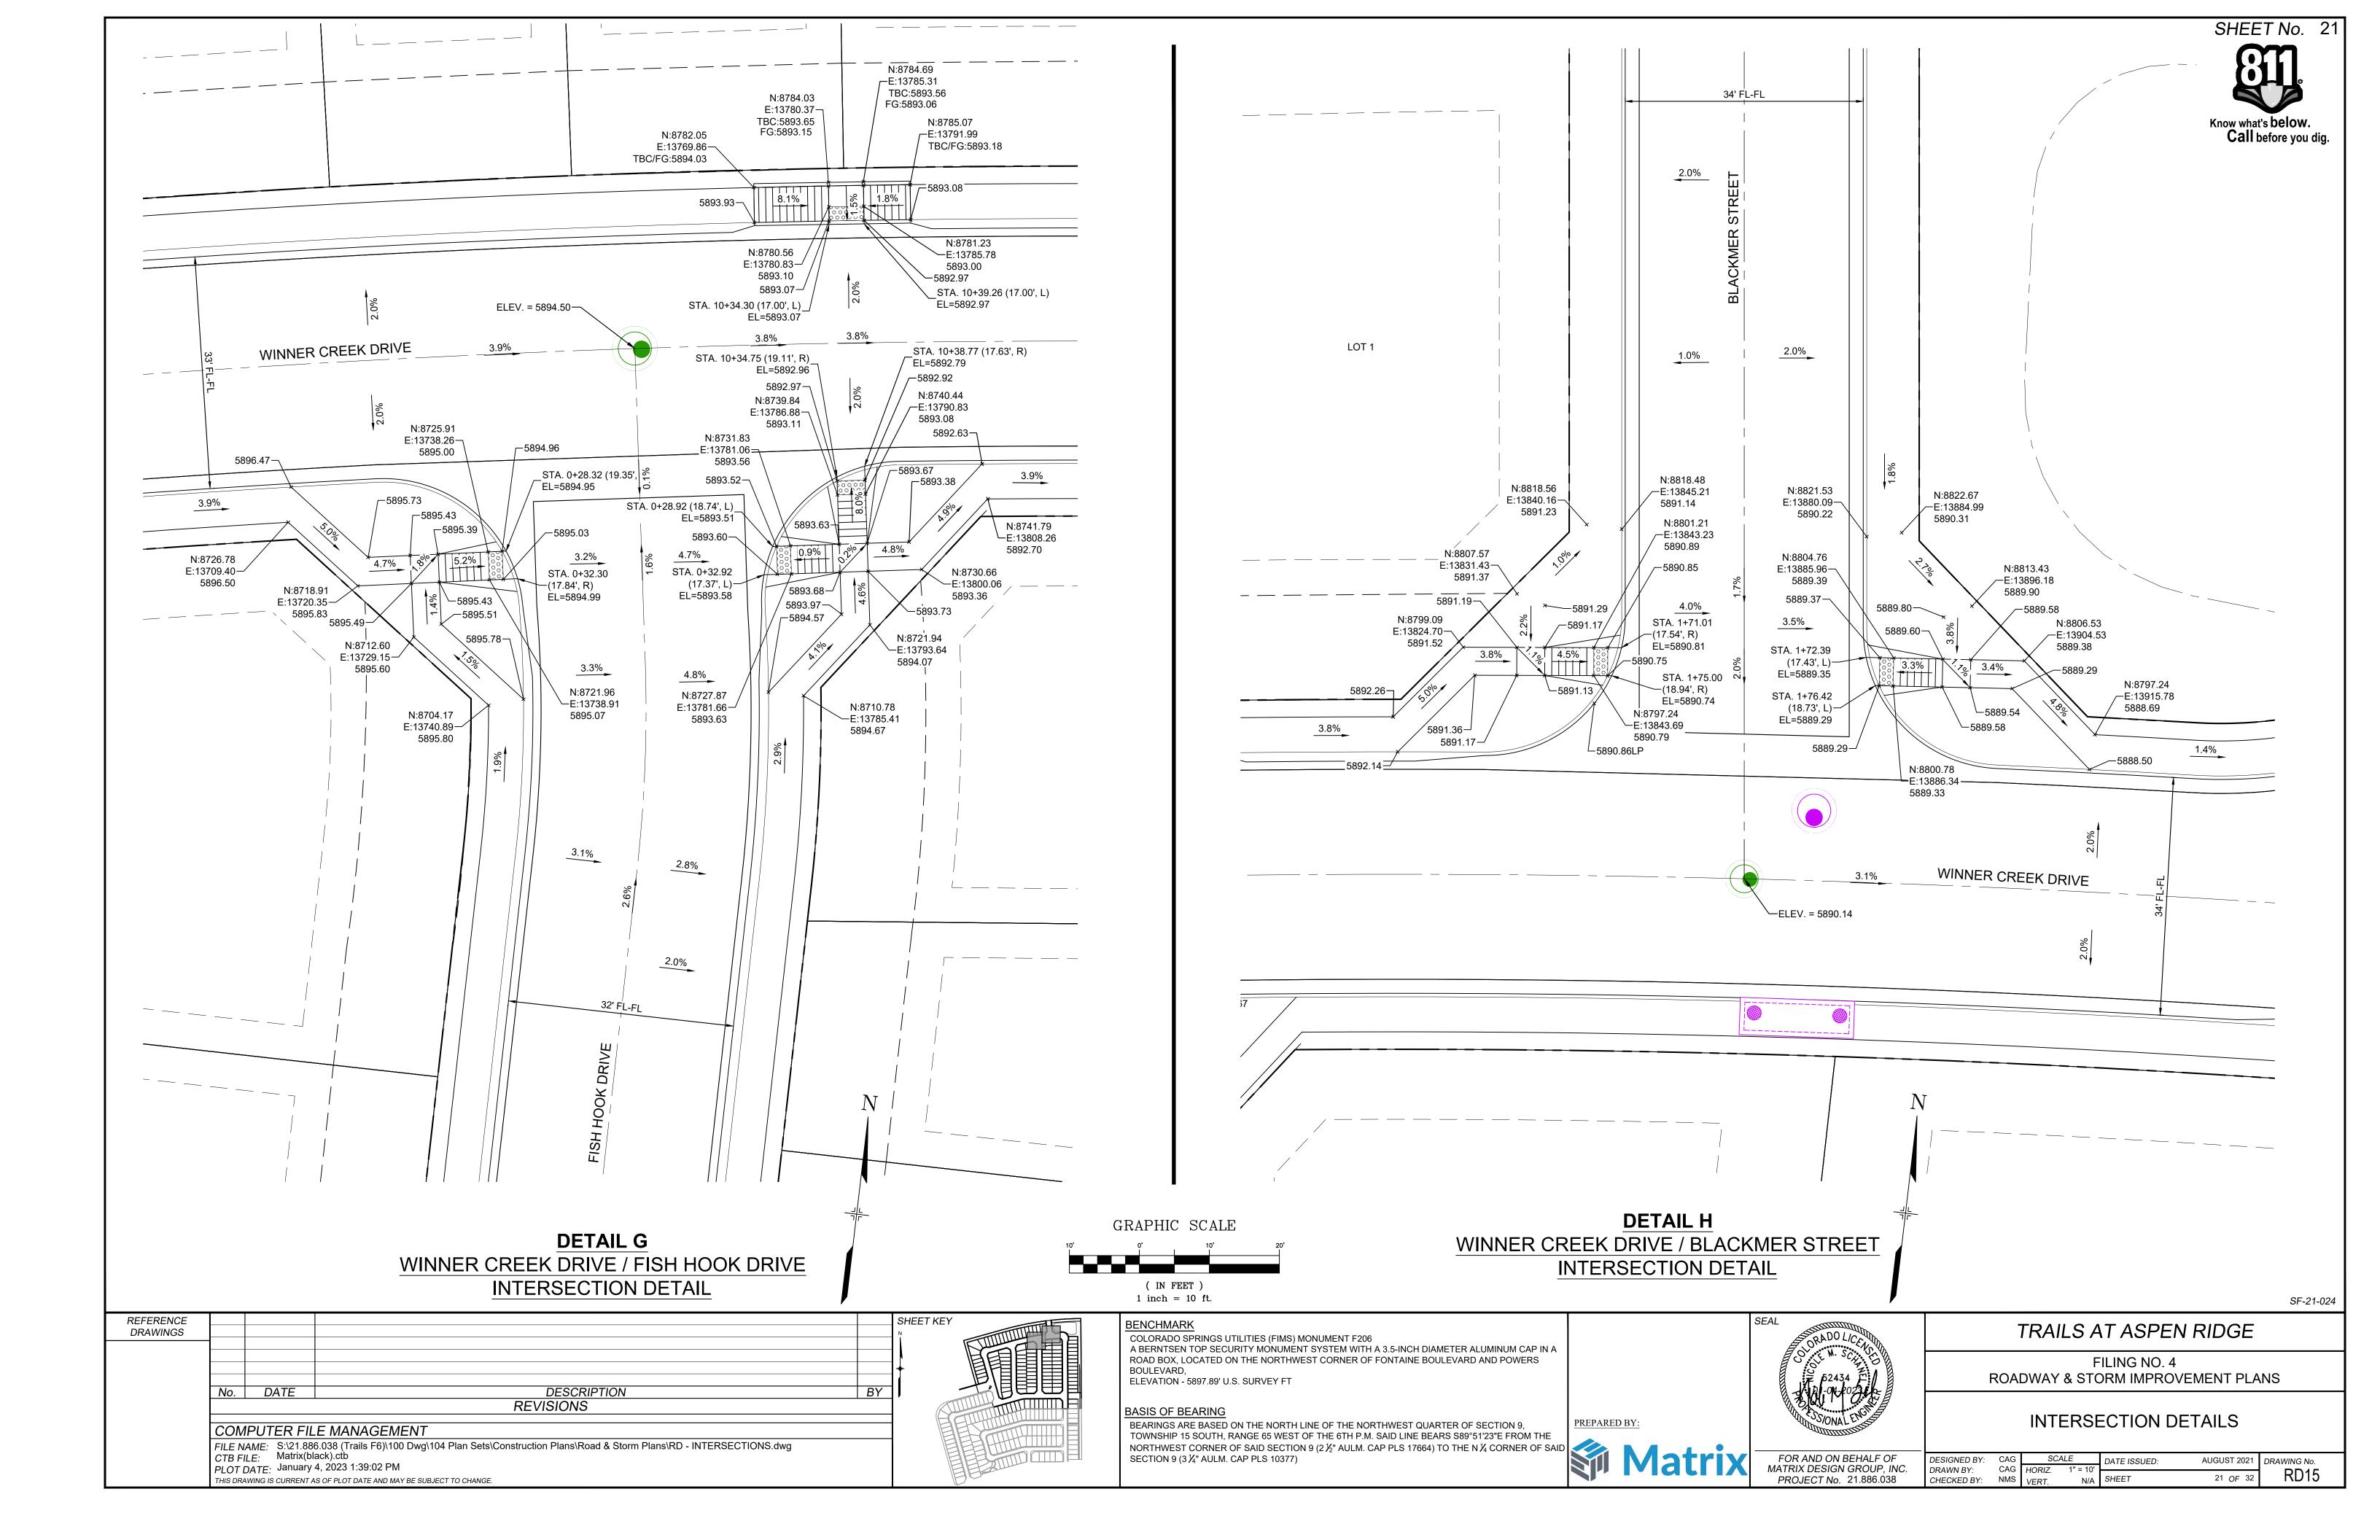

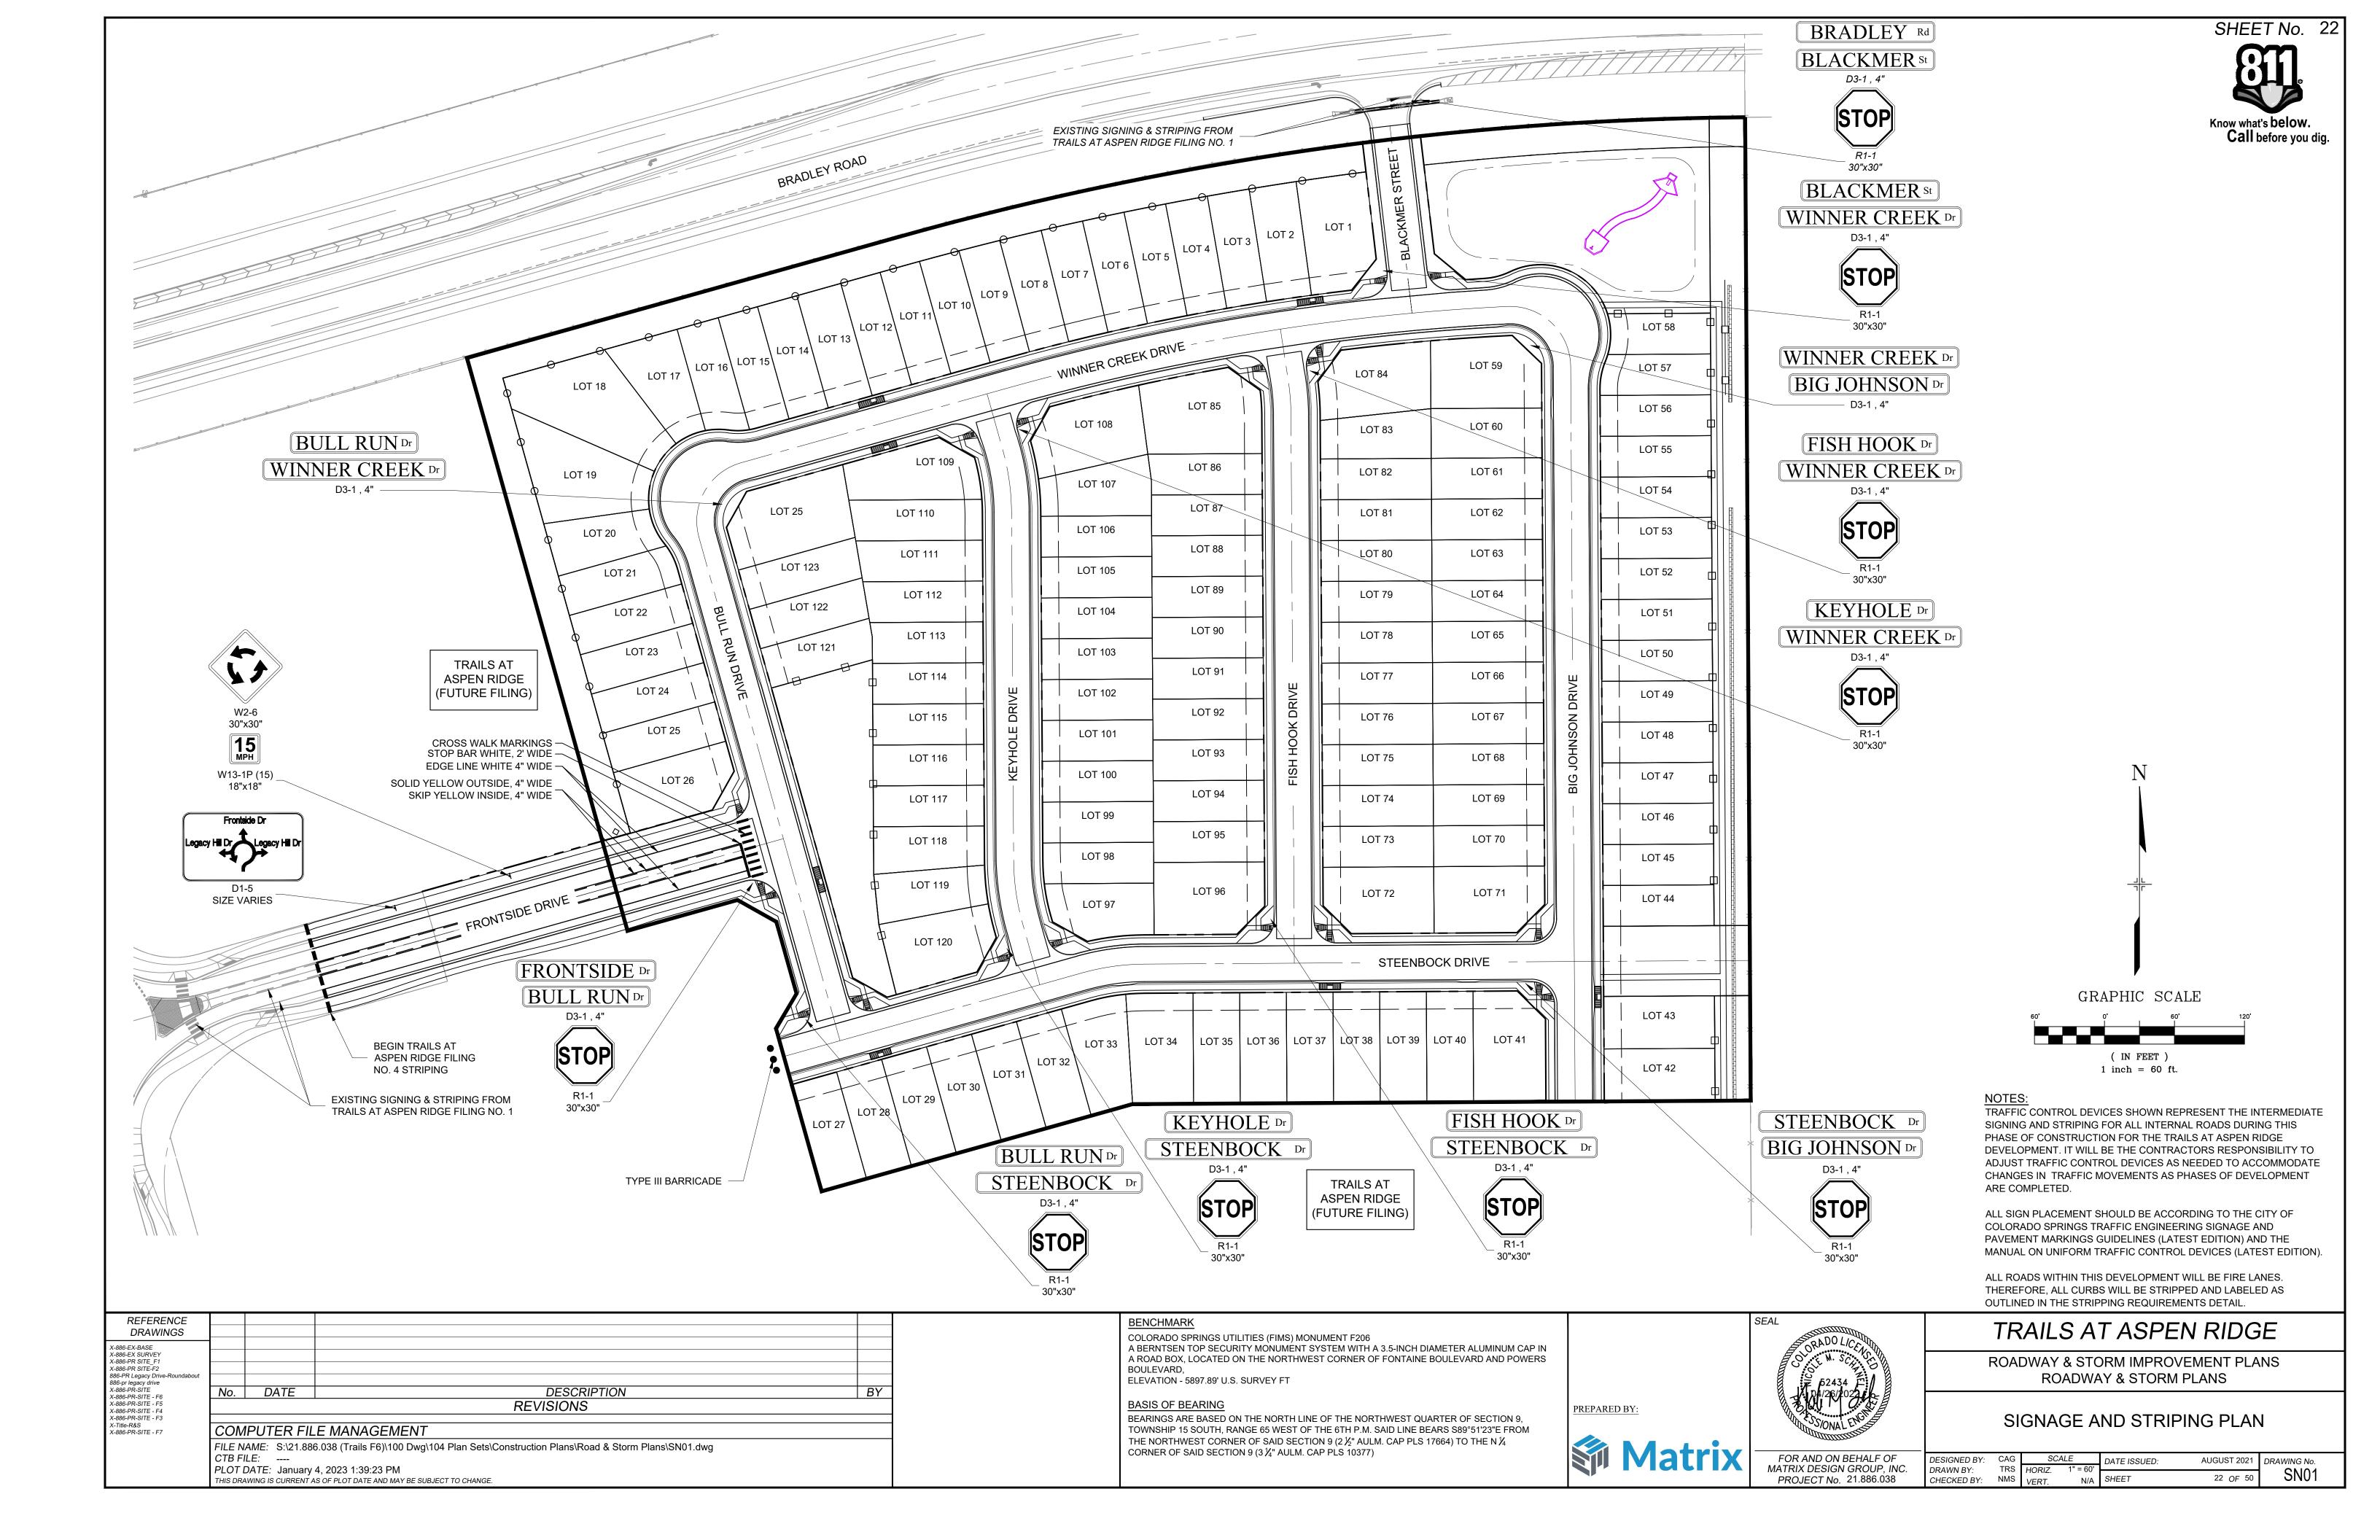

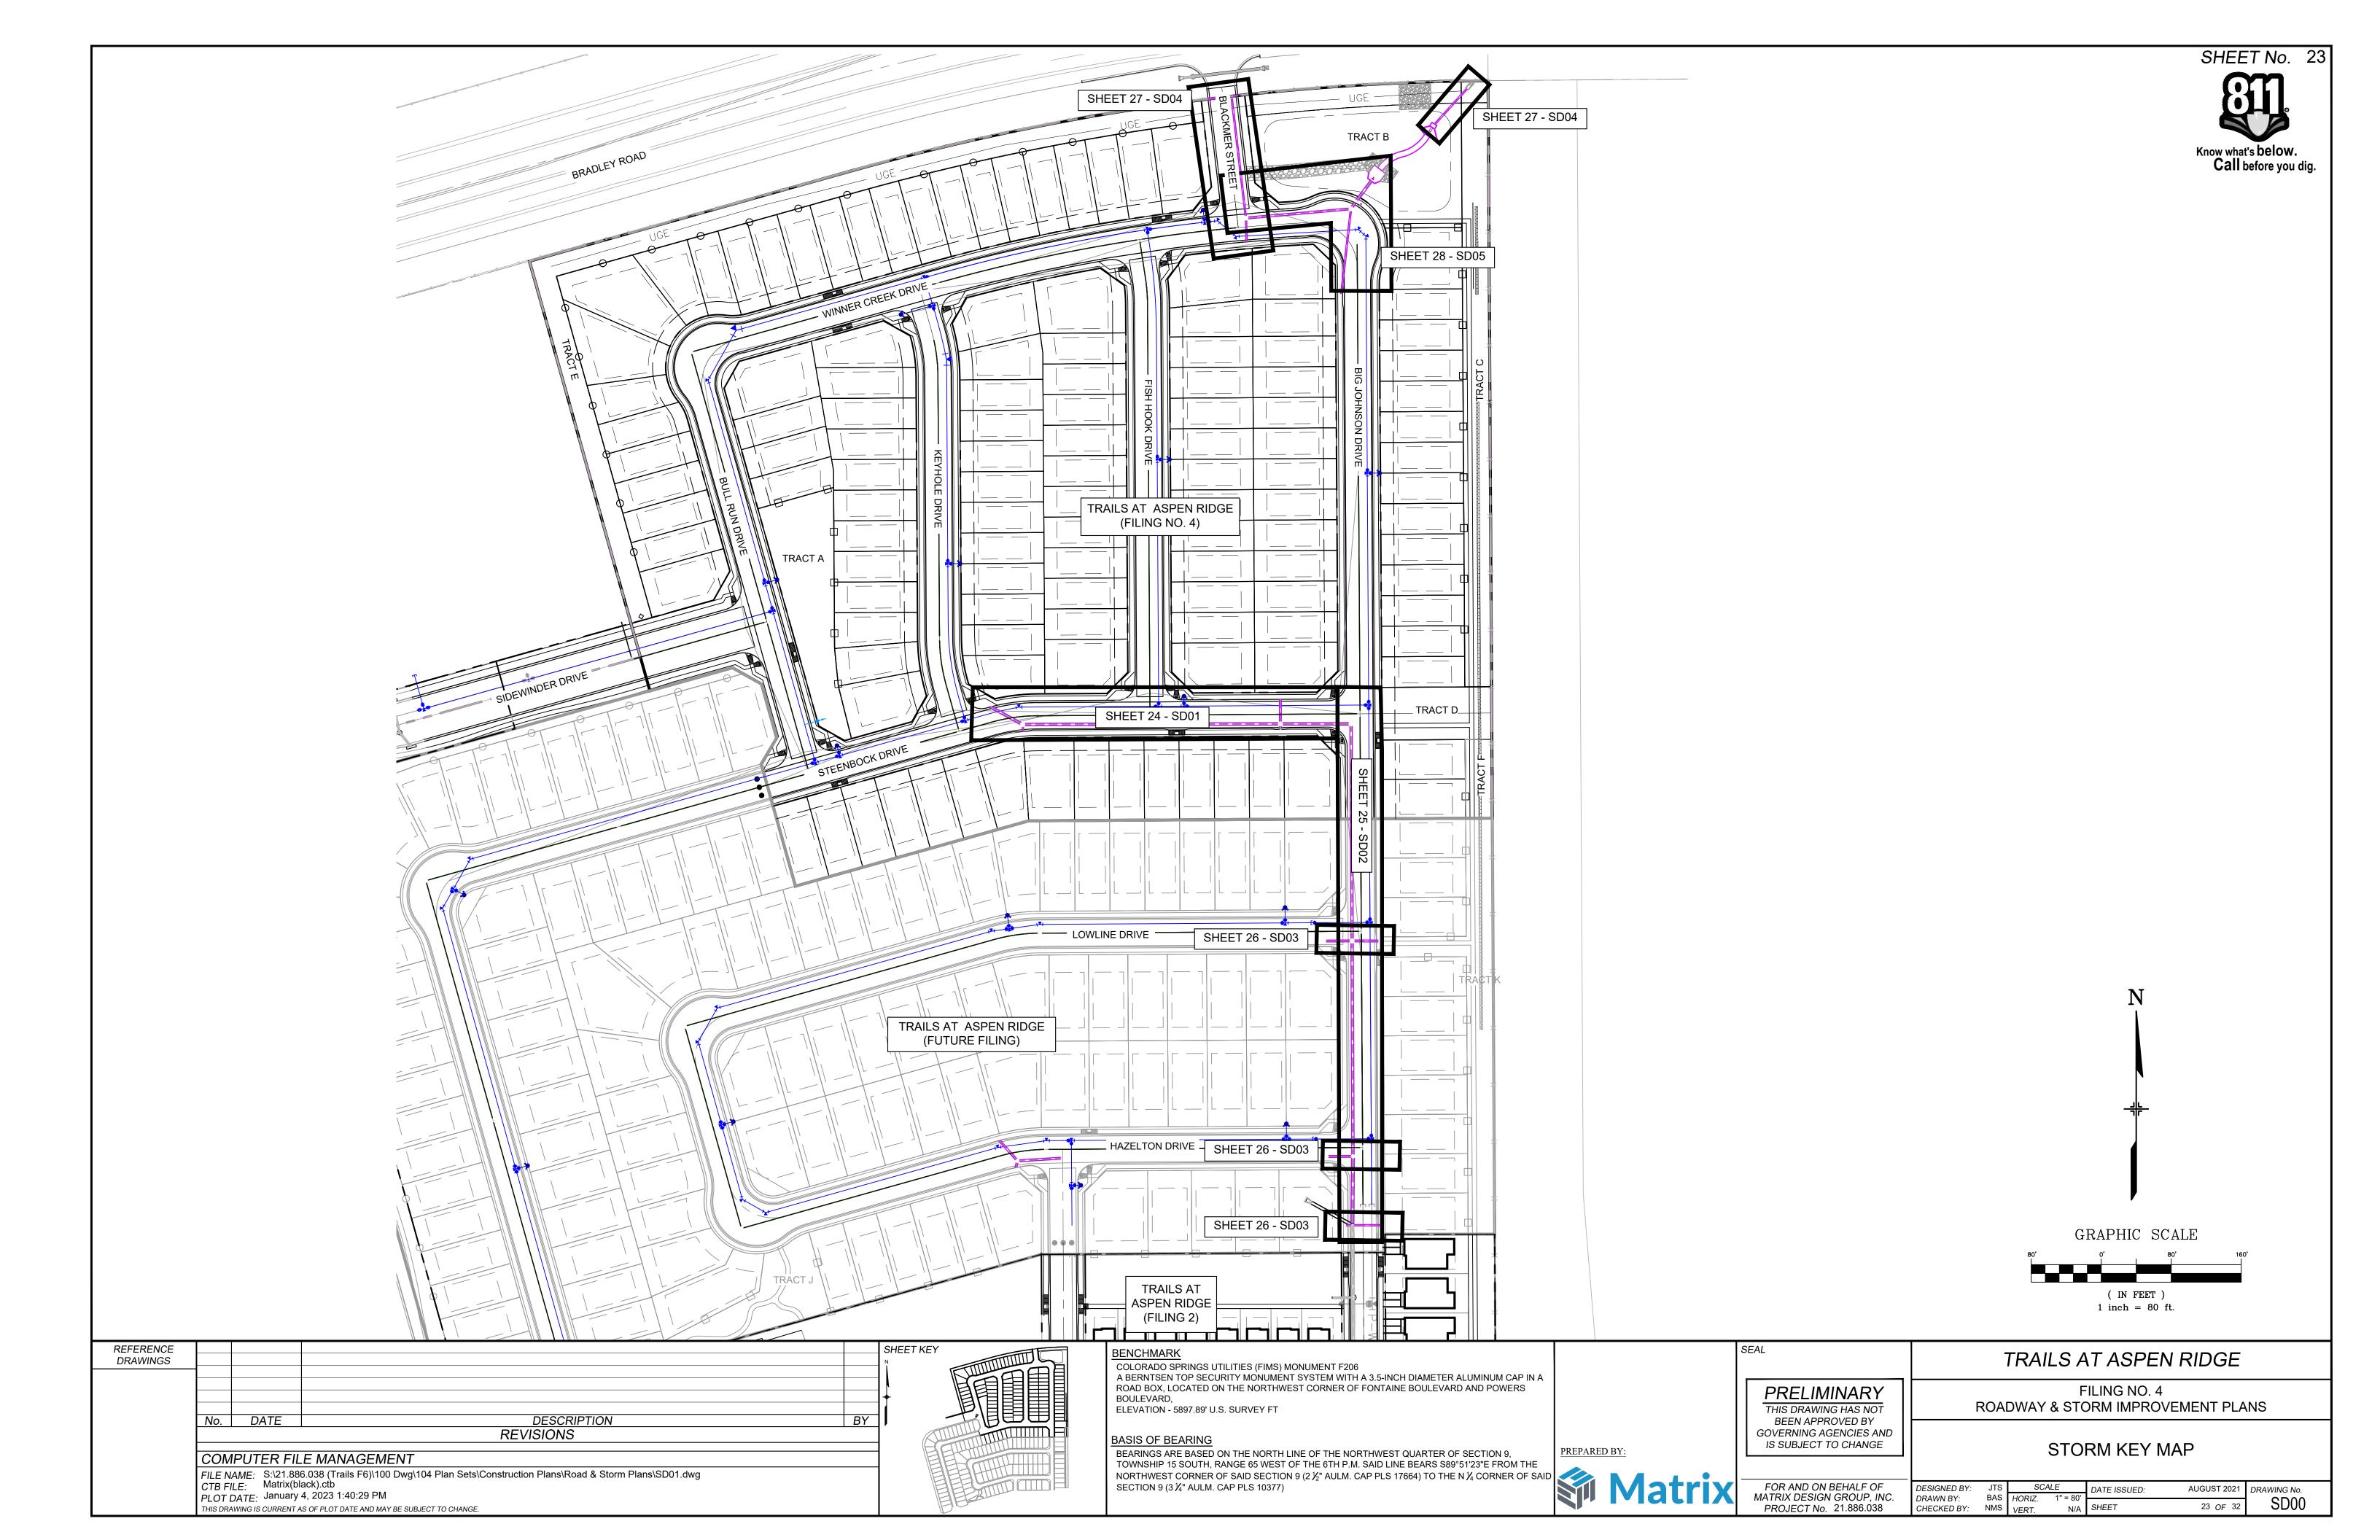


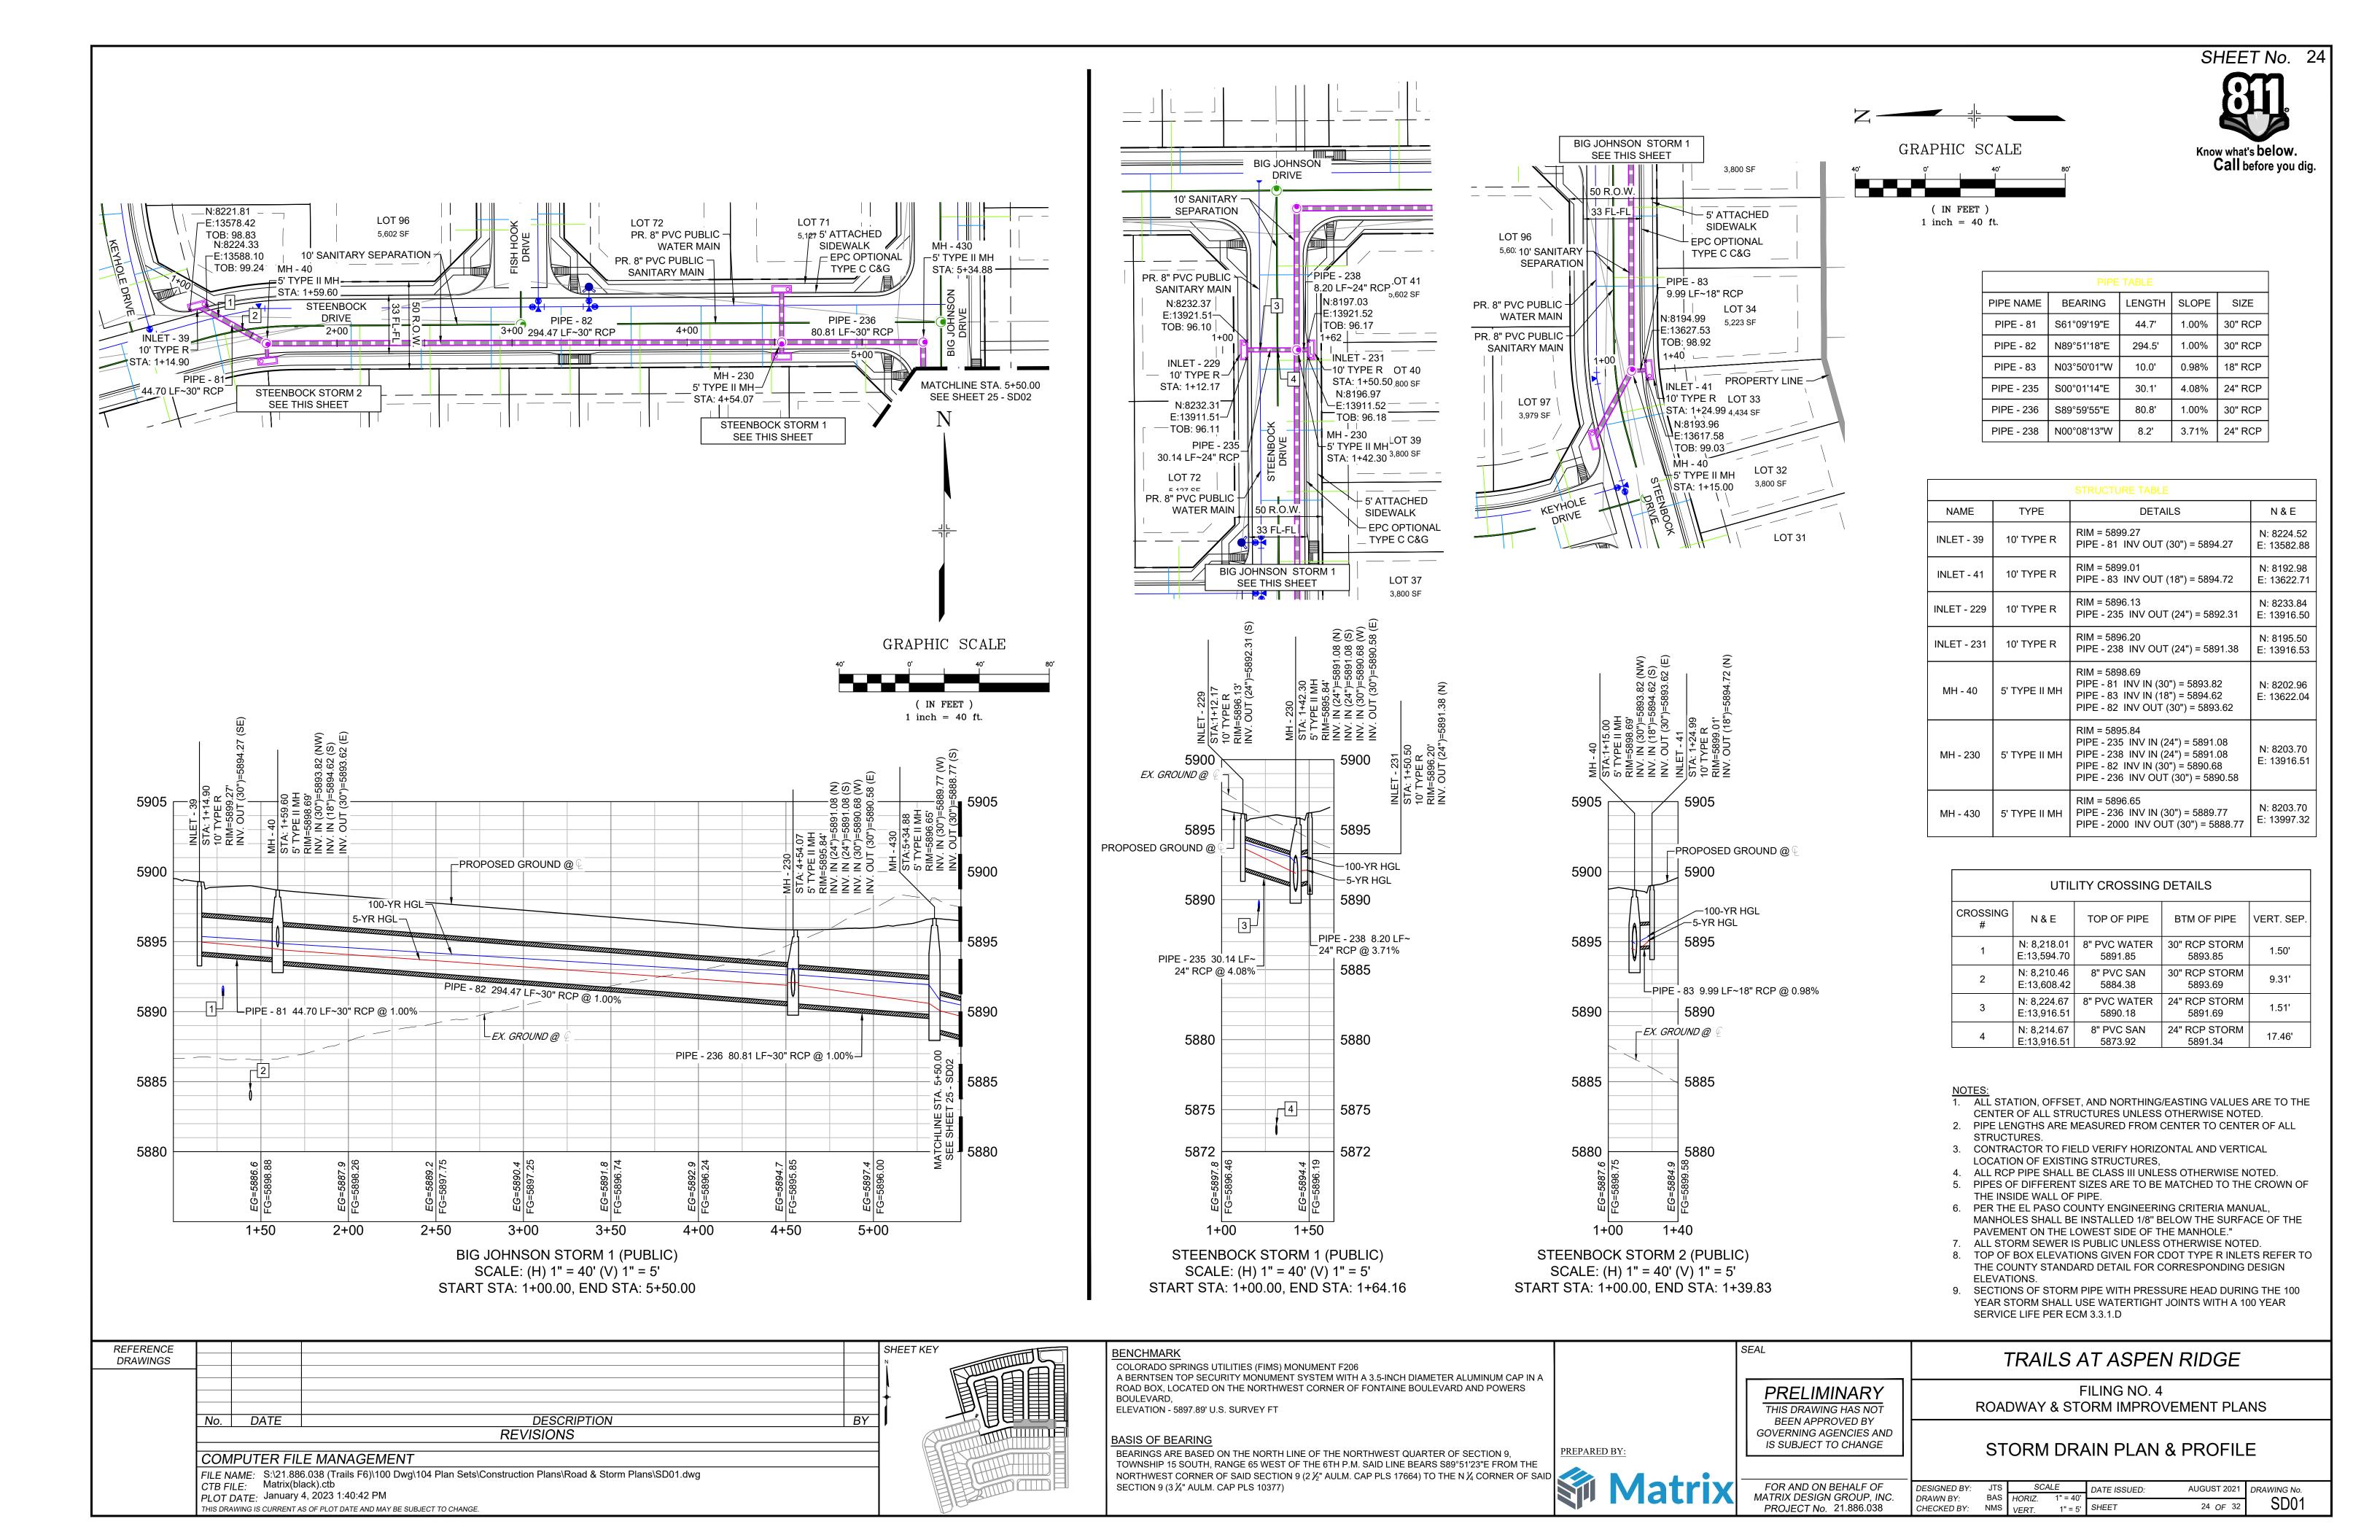

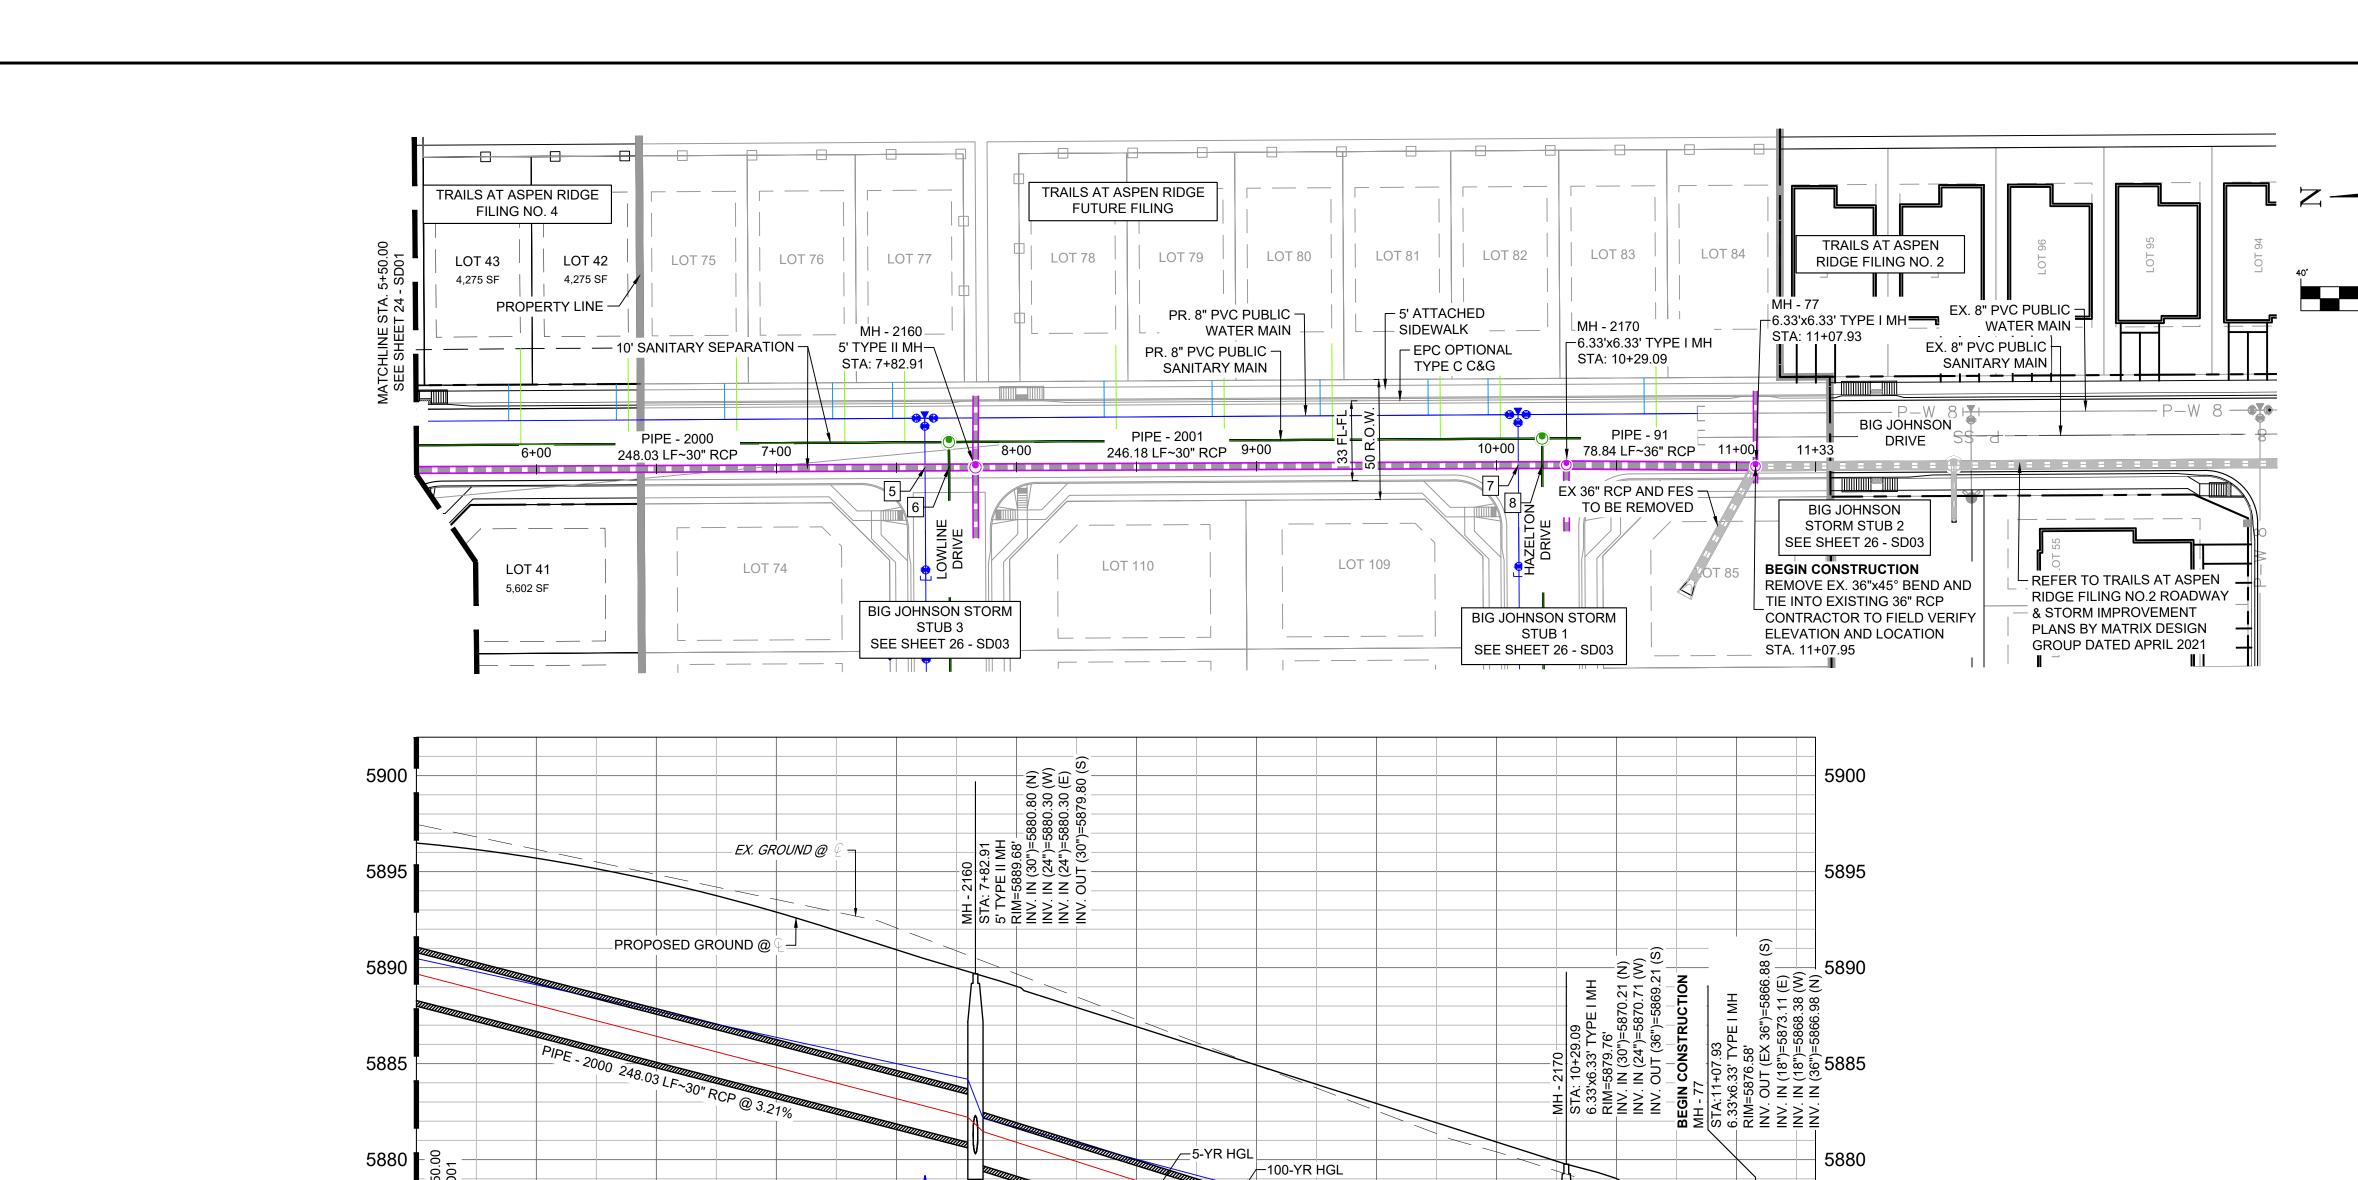



SHEET No. 25

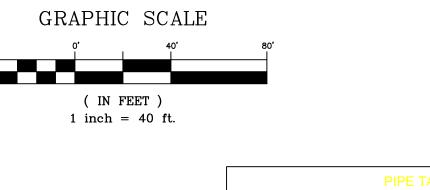

PIPE TABLE						
PIPE NAME	BEARING	LENGTH	SLOPE	SIZE		
PIPE - 91	S00°24'59"W	78.8'	2.83%	36" RCP		
PIPE - 2000	S00°16'42"E	248.0'	3.21%	30" RCP		
PIPE - 2001	S00°13'30"E	246.2'	3.90%	30" RCP		

STRUCTURE TABLE						
NAME	TYPE	DETAILS	N&E			
MH - 77	6.33'x6.33' TYPE I MH	RIM = 5876.58 PIPE - 105 INV IN (18") = 5873.11 PIPE - 104 INV IN (18") = 5868.38 PIPE - 91 INV IN (36") = 5866.98	N: 7630.66 E: 13998.92			
MH - 2160	5' TYPE II MH	RIM = 5889.68 PIPE - 2000 INV IN (30") = 5880.80 PIPE - 93 INV IN (24") = 5880.30 PIPE - 107 INV IN (24") = 5880.30 PIPE - 2001 INV OUT (30") = 5879.80	N: 7955.68 E: 13998.52			
MH - 2170	6.33'x6.33' TYPE I MH	RIM = 5879.76 PIPE - 2001 INV IN (30") = 5870.21 PIPE - 84 INV IN (24") = 5870.71 PIPE - 91 INV OUT (36") = 5869.21	N: 7709.49 E: 13999.49			

UTILITY CROSSING DETAILS								
CROSSING #	N&E	TOP OF PIPE	BTM OF PIPE	VERT. SEP.				
5	N: 7,976.68 E:13,998.42	8" PVC WATER 5879.18	30" RCP STORM 5881.18	2.00'				
6	N: 7,966.68 E:13,998.47	8" PVC SAN 5870.74	30" RCP STORM 5880.86	10.12'				
7	N: 7,729.50 E:13,999.41	8" PVC WATER 5869.18	30" RCP STORM 5870.70	1.52'				
8	N: 7,719.50 E:13,999.45	8" PVC SAN 5868.51	30" RCP STORM 5870.31	1.80'				

- NOTES:

 1. ALL STATION, OFFSET, AND NORTHING/EASTING VALUES ARE TO THE
- 2. PIPE LENGTHS ARE MEASURED FROM CENTER TO CENTER OF ALL STRUCTURES.
- 3. CONTRACTOR TO FIELD VERIFY HORIZONTAL AND VERTICAL
- LOCATION OF EXISTING STRUCTURES,
- 4. ALL RCP PIPE SHALL BE CLASS III UNLESS OTHERWISE NOTED. 5. PIPES OF DIFFERENT SIZES ARE TO BE MATCHED TO THE CROWN OF
- THE INSIDE WALL OF PIPE. 6. PER THE EL PASO COUNTY ENGINEERING CRITERIA MANUAL,
- MANHOLES SHALL BE INSTALLED 1/8" BELOW THE SURFACE OF THE PAVEMENT ON THE LOWEST SIDE OF THE MANHOLE."
- 7. ALL STORM SEWER IS PUBLIC UNLESS OTHERWISE NOTED. 8. TOP OF BOX ELEVATIONS GIVEN FOR CDOT TYPE R INLETS REFER TO
- THE COUNTY STANDARD DETAIL FOR CORRESPONDING DESIGN ELEVATIONS.
- 9. SECTIONS OF STORM PIPE WITH PRESSURE HEAD DURING THE 100 YEAR STORM SHALL USE WATERTIGHT JOINTS WITH A 100 YEAR SERVICE LIFE PER ECM 3.3.1.D

REFERENCE					SHEET KEY	
DRAWINGS					l N	
					H = H	
					<i>¶</i> 1⊦	
					1	
	No.	DATE	DESCRIPTION	BY	11 _	
			REVISIONS	•		
	0.014					
			E MANAGEMENT			
	FILE N	AME: S:\21.886	5.038 (Trails F6)\100 Dwg\104 Plan Sets\Construction Plans\Road & Storm Plans\SD01.dwg ack).ctb			
	CTB FI	ILE: Matrix(bla	ACK).CID			
			4, 2023 1:40:54 PM		I I I I	To the same of the
	THIS DRA	AWING IS CURRENT AS	S OF PLOT DATE AND MAY BE SUBJECT TO CHANGE.			

6+50

7+00

7+50

8+00

8+50

BIG JOHNSON STORM F5 (PUBLIC)

SCALE: (H) 1" = 40' (V) 1" = 5'

START STA: 5+50.00, END STA: 11+32.93

9+00

6+00

5865

5860

BASIS OF BEARING

9+50

COLORADO SPRINGS UTILITIES (FIMS) MONUMENT F206 A BERNTSEN TOP SECURITY MONUMENT SYSTEM WITH A 3.5-INCH DIAMETER ALUMINUM CAP IN A ROAD BOX, LOCATED ON THE NORTHWEST CORNER OF FONTAINE BOULEVARD AND POWERS

10+50

82.6 LF~36" RCP @ 2.96% ─

11+00

5875

5870

ELEVATION - 5897.89' U.S. SURVEY FT

_PIPE - 91 78.84 LF~36" RCP @ 2.83%ᆜ

10+00

BEARINGS ARE BASED ON THE NORTH LINE OF THE NORTHWEST QUARTER OF SECTION 9, TOWNSHIP 15 SOUTH, RANGE 65 WEST OF THE 6TH P.M. SAID LINE BEARS 509 5123 ETTROM THE NORTHWEST CORNER OF SAID SECTION 9 (2½" AULM. CAP PLS 17664) TO THE N¼ CORNER OF SAID SECTION 9 (3¾" AULM. CAP PLS 10377)


PREPARED BY:


PRELIMINARY THIS DRAWING HAS NOT BEEN APPROVED BY GOVERNING AGENCIES AND IS SUBJECT TO CHANGE


TRAILS AT ASPEN RIDGE FILING NO. 4 ROADWAY & STORM IMPROVEMENT PLANS

STORM DRAIN PLAN & PROFILE


AND ON BEHALF OF	DESIGNED BY:	JTS	SCA	4LE	DATE ISSUED:	AUGUST 2021	DRAWING No.
(DESIGN GROUP, INC.	DRAWN BY:	BAS	HORIZ.	1" = 40'			SD02
IECT No. 21.886.038	CHECKED BY:	NMS	VERT.	1" = 5'	SHEET	25 OF 32	2D02

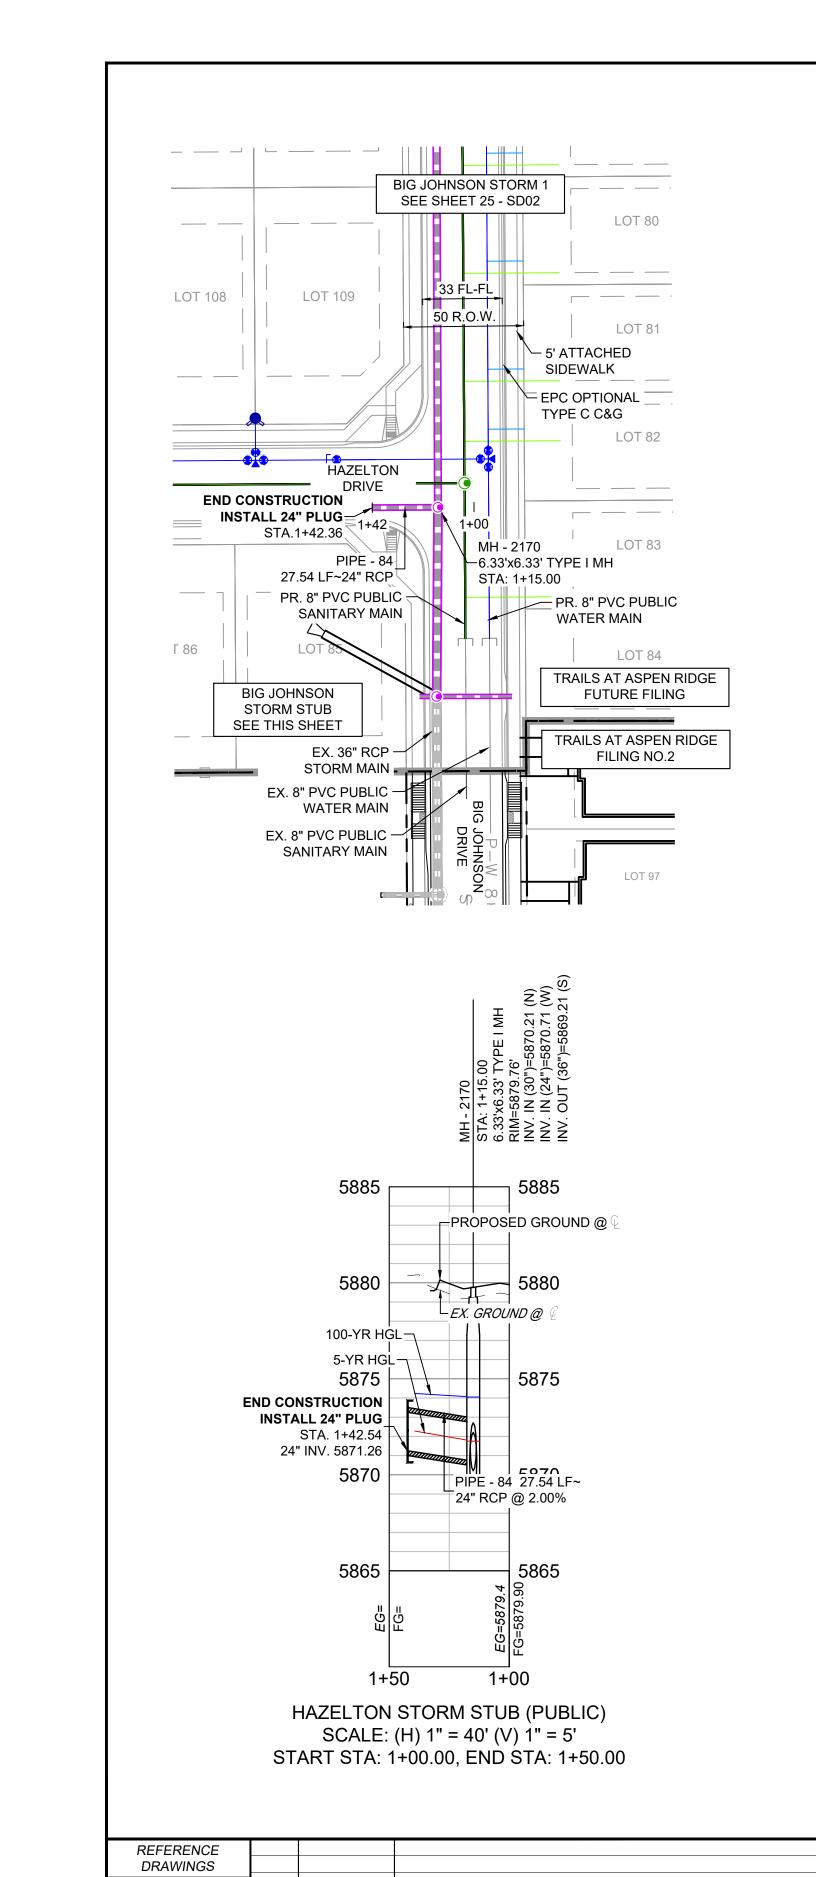


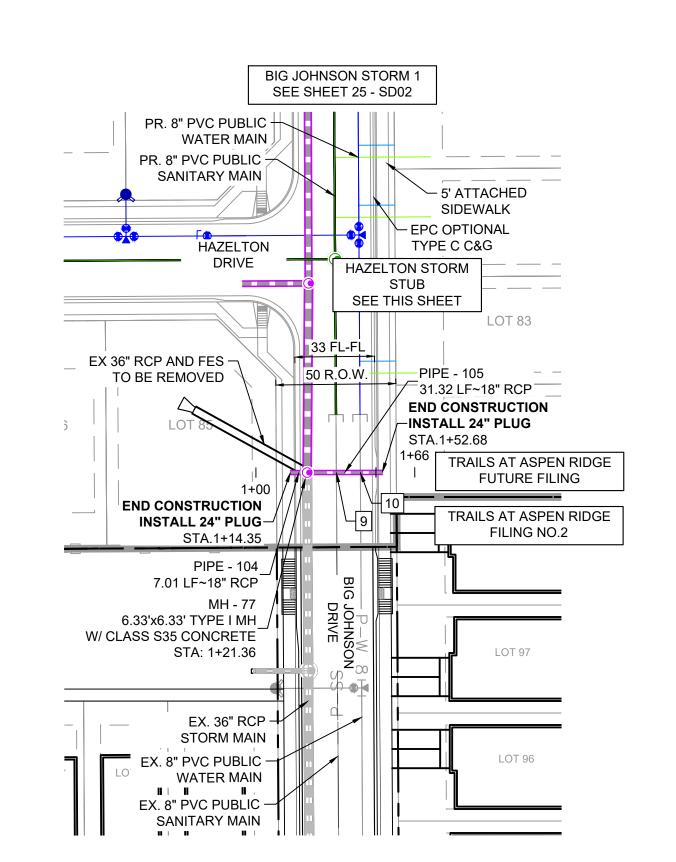


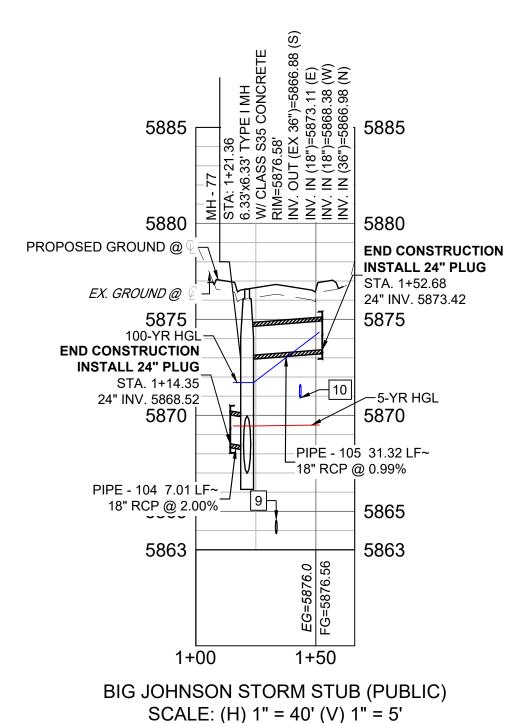

START STA: 1+00.00, END STA: 1+66.18

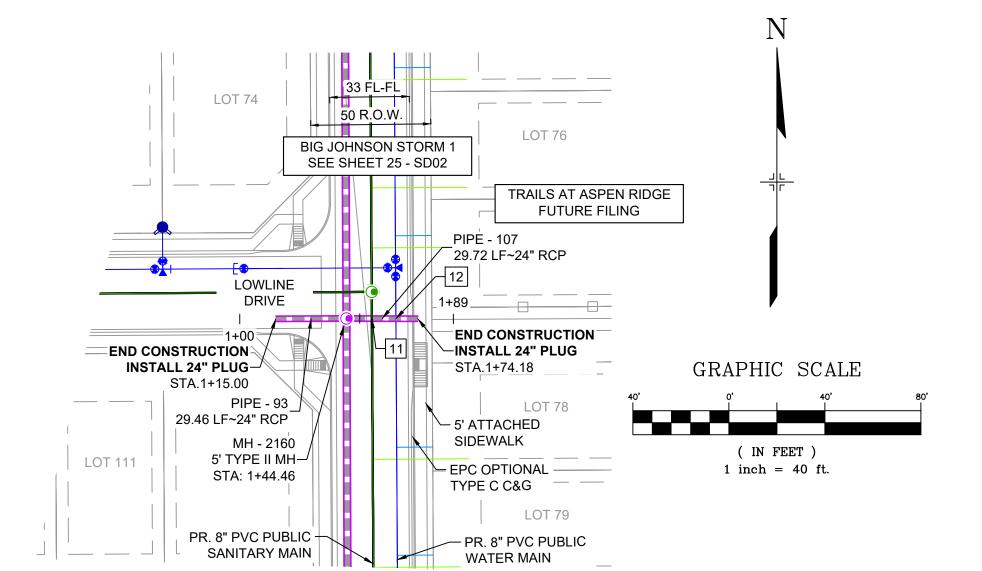

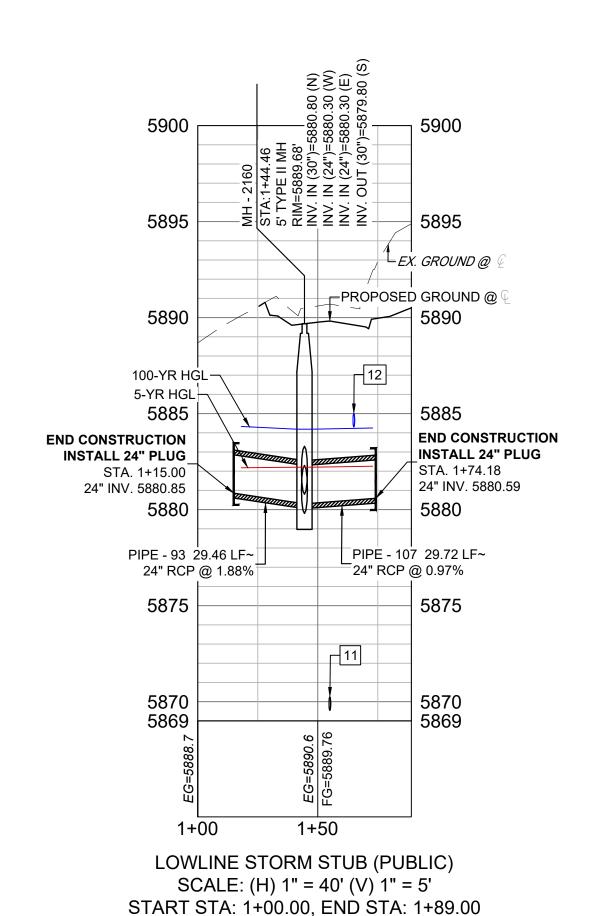

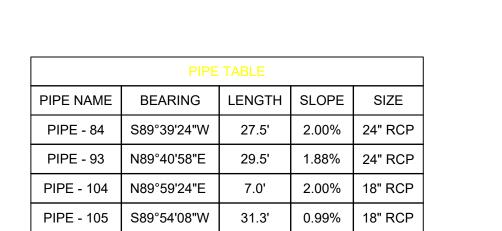

0.97%

PIPE - 107 | N89°44'16"W |

SHEET No. 26


Know what's below.

Call before you dig.

	STRUCTURE TABLE					
NAME	TYPE	DETAILS	N & E			
MH - 77	6.33'x6.33' TYPE I MH	RIM = 5876.58 PIPE - 105 INV IN (18") = 5873.11 PIPE - 104 INV IN (18") = 5868.38 PIPE - 91 INV IN (36") = 5866.98	N: 7630.66 E: 13998.92			
MH - 2160	5' TYPE II MH	RIM = 5889.68 PIPE - 2000 INV IN (30") = 5880.80 PIPE - 93 INV IN (24") = 5880.30 PIPE - 107 INV IN (24") = 5880.30 PIPE - 2001 INV OUT (30") = 5879.80	N: 7955.68 E: 13998.52			
MH - 2170	6.33'x6.33' TYPE I MH	RIM = 5879.76 PIPE - 2001 INV IN (30") = 5870.21 PIPE - 84 INV IN (24") = 5870.71 PIPE - 91 INV OUT (36") = 5869.21	N: 7709.49 E: 13999.49			

UTILITY CROSSING DETAILS							
CROSSING #	N&E	TOP OF PIPE	BTM OF PIPE	VERT. SEP.			
9	N: 7,630.68 E:14,011.08	8" PVC SAN 5864.55	24" RCP STORM 5867.96	3.41'			
10	N: 7,630.70 E:14,021.08	8" PVC WATER 5871.62	18" RCP STORM 5873.12	1.50'			
11	N: 7,955.63 E:14,009.11	8" PVC SAN 5870.25	24" RCP STORM 5880.15	9.90'			
12 N: 7,955.58 E:14,019.11		24" RCP STORM 5882.75	8" PVC WATER 5884.30	1.55'			

- 1. ALL STATION, OFFSET, AND NORTHING/EASTING VALUES ARE TO THE
- CENTER OF ALL STRUCTURES UNLESS OTHERWISE NOTED. 2. PIPE LENGTHS ARE MEASURED FROM CENTER TO CENTER OF ALL
- STRUCTURES.
- 3. CONTRACTOR TO FIELD VERIFY HORIZONTAL AND VERTICAL LOCATION OF EXISTING STRUCTURES,
- 4. ALL RCP PIPE SHALL BE CLASS III UNLESS OTHERWISE NOTED. 5. PIPES OF DIFFERENT SIZES ARE TO BE MATCHED TO THE CROWN OF
- THE INSIDE WALL OF PIPE.
- 6. PER THE EL PASO COUNTY ENGINEERING CRITERIA MANUAL MANHOLES SHALL BE INSTALLED 1/8" BELOW THE SURFACE OF THE
- PAVEMENT ON THE LOWEST SIDE OF THE MANHOLE." ALL STORM SEWER IS PUBLIC UNLESS OTHERWISE NOTED.
- 8. TOP OF BOX ELEVATIONS GIVEN FOR CDOT TYPE R INLETS REFER TO
- THE COUNTY STANDARD DETAIL FOR CORRESPONDING DESIGN **ELEVATIONS.**
- 9. SECTIONS OF STORM PIPE WITH PRESSURE HEAD DURING THE 100 YEAR STORM SHALL USE WATERTIGHT JOINTS WITH A 100 YEAR SERVICE LIFE PER ECM 3.3.1.D

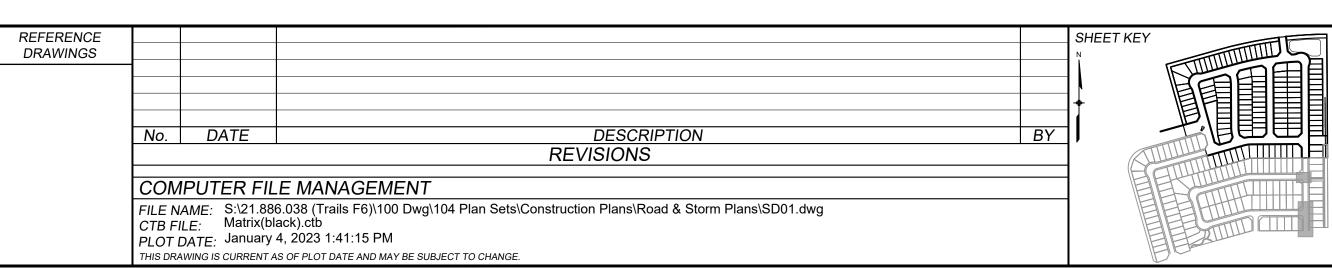

COLORADO SPRINGS UTILITIES (FIMS) MONUMENT F206 A BERNTSEN TOP SECURITY MONUMENT SYSTEM WITH A 3.5-INCH DIAMETER ALUMINUM CAP IN A ROAD BOX, LOCATED ON THE NORTHWEST CORNER OF FONTAINE BOULEVARD AND POWERS

BOULEVARD, ELEVATION - 5897.89' U.S. SURVEY FT

BASIS OF BEARING

BEARINGS ARE BASED ON THE NORTH LINE OF THE 150...
TOWNSHIP 15 SOUTH, RANGE 65 WEST OF THE 6TH P.M. SAID LINE BEARS S89*51*23*E FROM THE NORTHWEST CORNER OF SAID SECTION 9 (2 ½" AULM. CAP PLS 17664) TO THE N ¼ CORNER OF SAID

**CORNER OF SAID SECTION 9 (2 ½" AULM. CAP PLS 17664) TO THE N ¼ CORNER OF SAID

**CORNER OF SAID SECTION 9 (2 ½" AULM. CAP PLS 17664) TO THE N ¼ CORNER OF SAID

**CORNER OF SAID SECTION 9 (2 ½" AULM. CAP PLS 17664) TO THE N ¼ CORNER OF SAID SECTION 9 (2 ½" AULM. CAP PLS 17664) TO THE N X AULM. CAP PLS 17664 (2 ½" AULM. CAP PLS 17664) TO THE N X AULM. CAP PLS 17664 (2 ½" AULM. CAP PLS 17664) TO THE N X AULM. CAP PLS 17664 (2 ½" AULM. CAP PLS 17664) TO THE N X AULM. CAP PLS 17664 (2 ½" AULM. CAP PLS 17664 (2

PREPARED BY: FOR AND ON BE MATRIX DESIGN G PROJECT No. 2


PRELIMINARY THIS DRAWING HAS NOT BEEN APPROVED BY GOVERNING AGENCIES AND IS SUBJECT TO CHANGE


TRAILS AT ASPEN RIDGE


FILING NO. 4 ROADWAY & STORM IMPROVEMENT PLANS


STORM DRAIN PLAN & PROFILE


EHALF OF	DESIGNED BY:	JTS	SC	ALE	DATE ISSUED:	AUGUST 2021	DRAWING No.
GROUP, INC. 21.886.038	DRAWN BY: CHECKED BY:	BAS NMS	1101tiz.	1" = 40'	SHEET	26 OF 32	SD03
-1.000.000	OHLONED DT.		VERT.	1 – 3	· · · ·	O.	

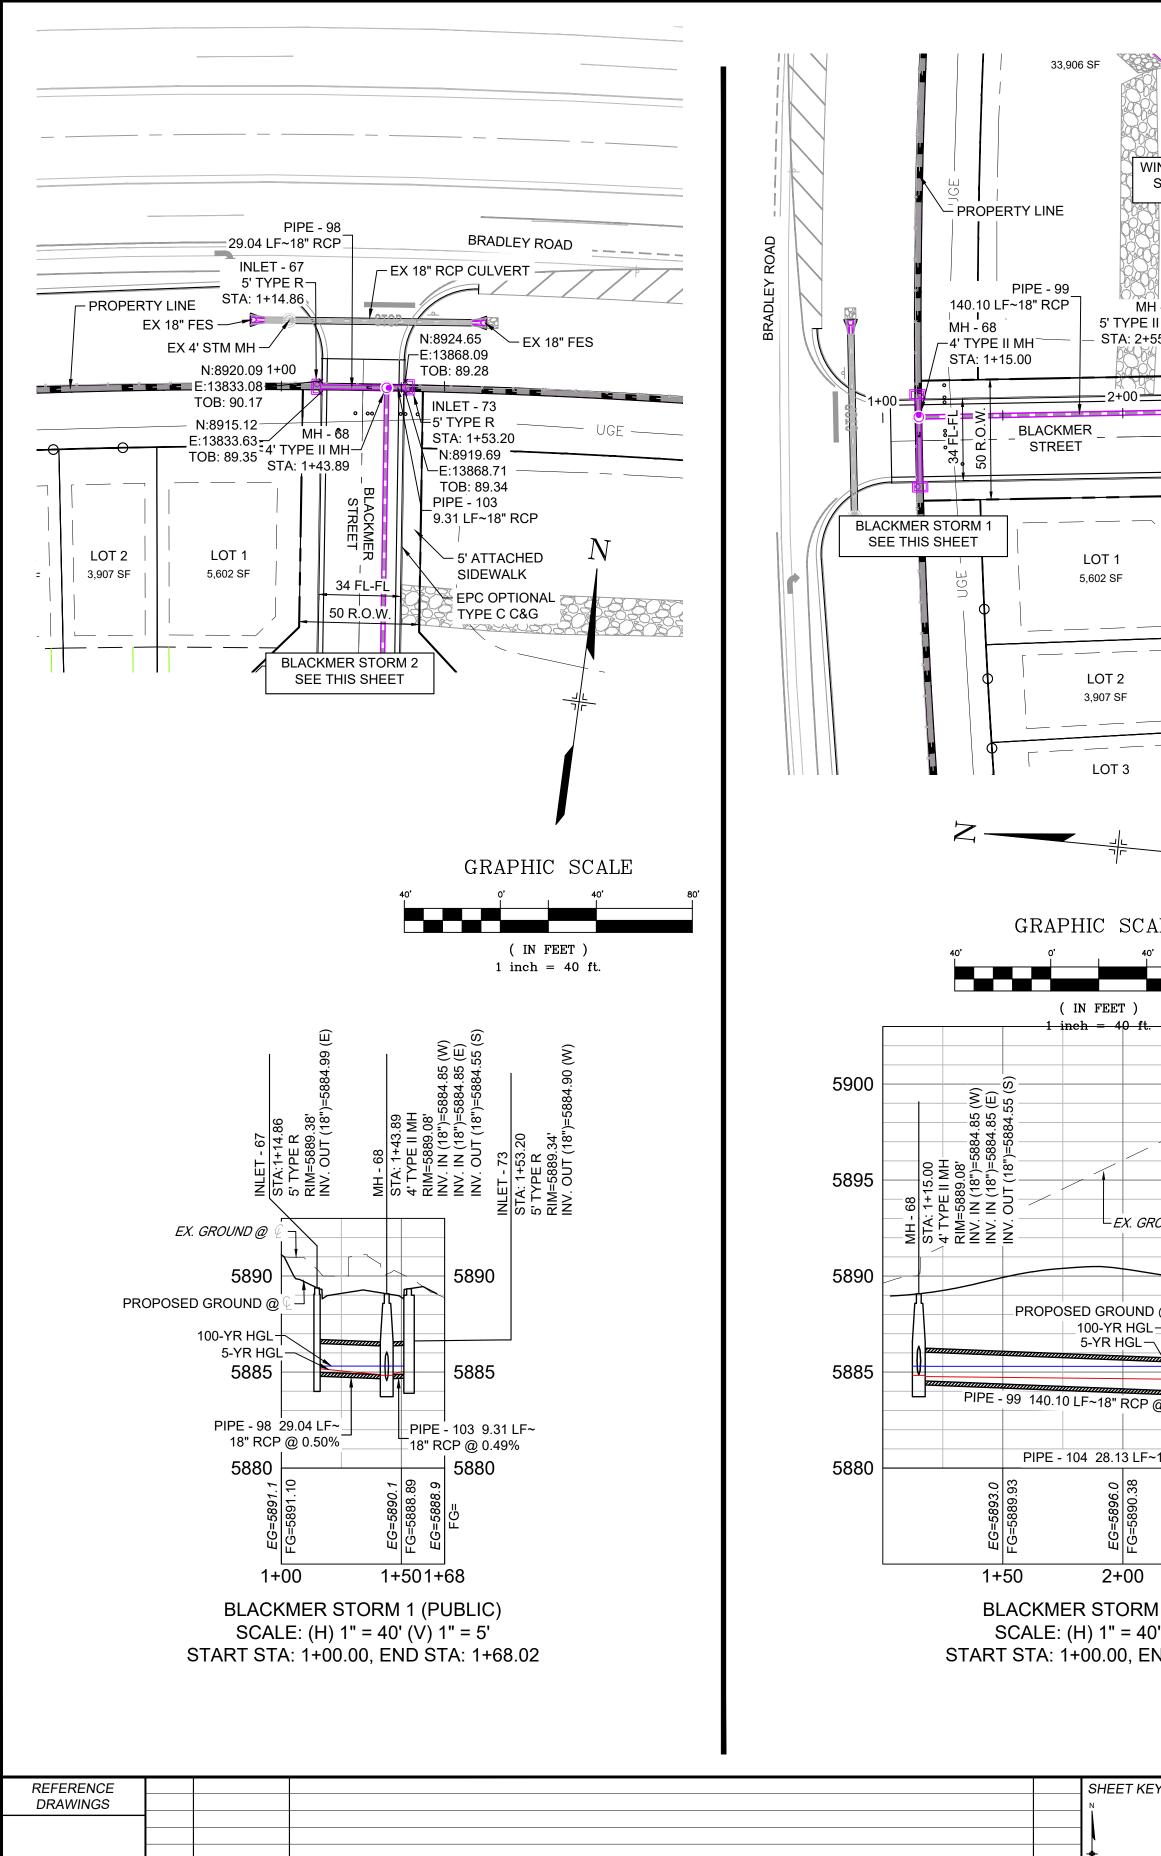


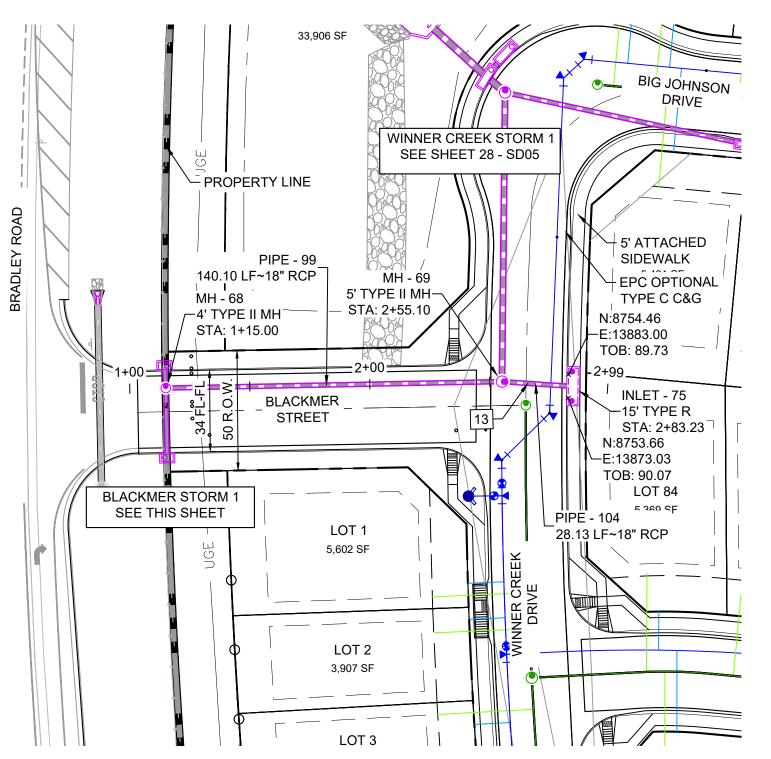

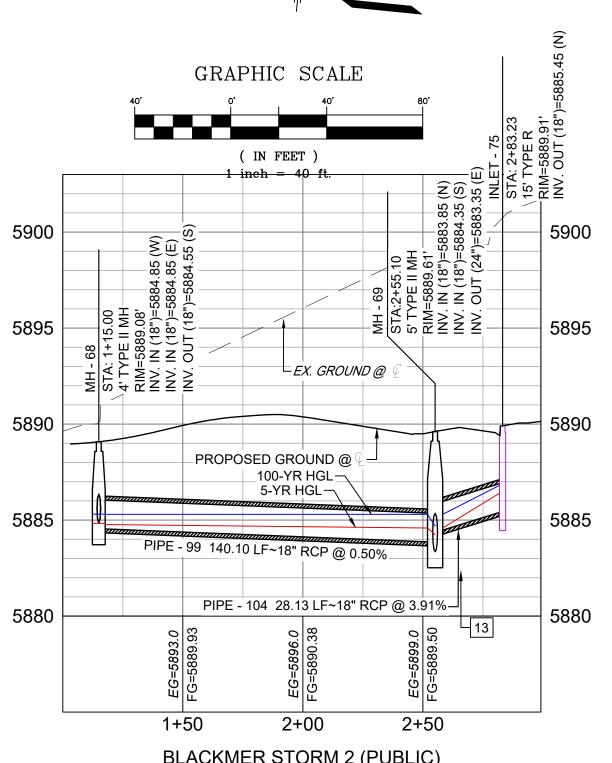


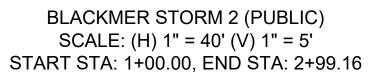


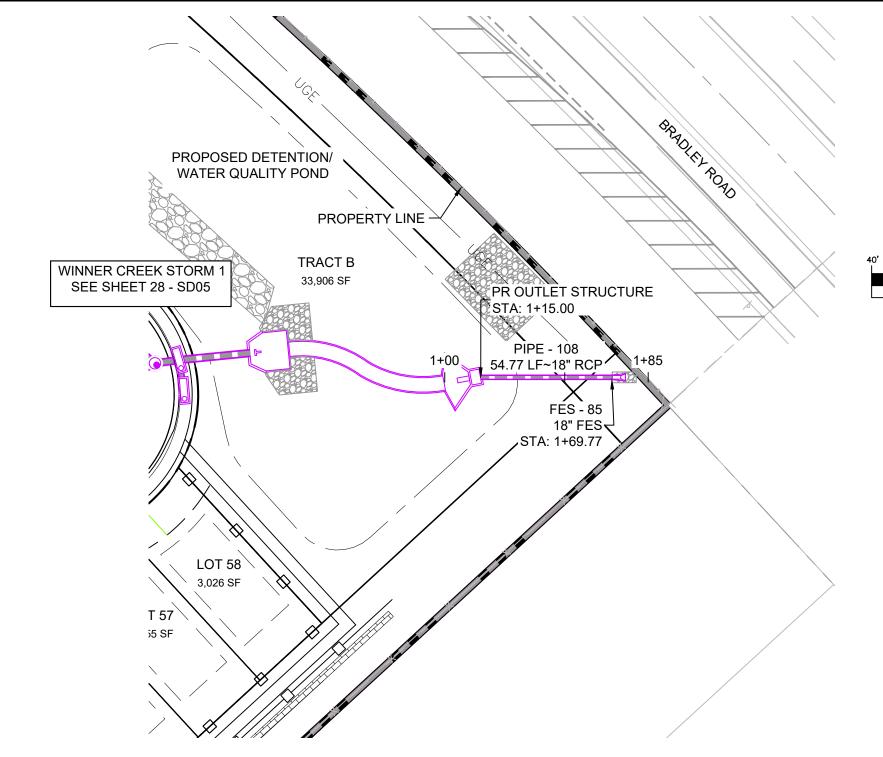

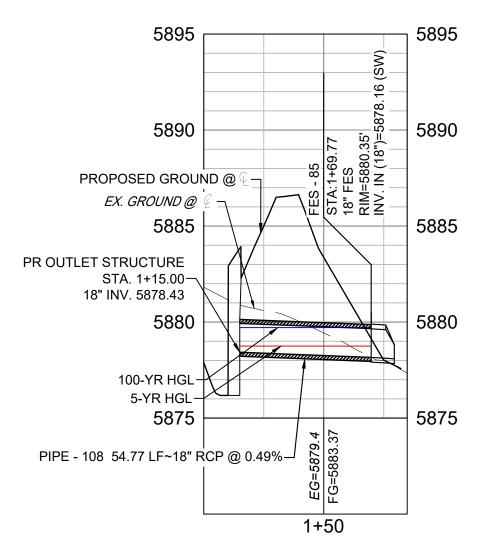

NE POND (PRIVATE) SCALE: (H) 1" = 40' (V) 1" = 5' START STA: 1+00.00, END STA: 1+84.77

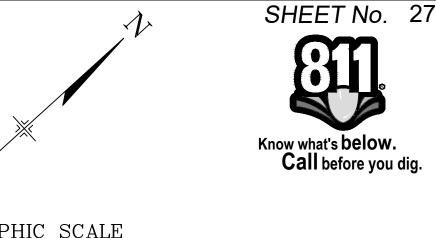

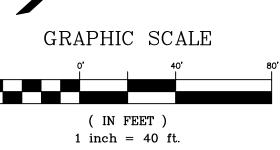

Γ							
	PIPE TABLE						
PIPE NAME	BEARING	LENGTH	SLOPE	SIZE			
PIPE - 98	N83°11'28"E	29.0'	0.50%	18" RCP			
PIPE - 99	S06°46'17"E	140.1'	0.50%	18" RCP			
PIPE - 103	S80°54'08"W	9.3'	0.49%	18" RCP			
PIPE - 104	N01°48'05"W	28.1'	3.91%	18" RCP			
PIPE - 108	N42°15'21"E	54.8'	0.49%	18" RCP			


	STRUCTURE TABLE						
NAME	TYPE	DETAILS	N&E				
FES - 85	18" FES	RIM = 5880.35 PIPE - 108 INV IN (18") = 5878.16	N: 8929.45 E: 14129.65				
INLET - 67	5' TYPE R	RIM = 5889.38 PIPE - 98 INV OUT (18") = 5884.99	N: 8917.44 E: 13831.86				
INLET - 73	5' TYPE R	RIM = 5889.34 PIPE - 103 INV OUT (18") = 5884.90	N: 8922.36 E: 13869.88				
INLET - 75	15' TYPE R	RIM = 5889.91 PIPE - 104 INV OUT (18") = 5885.45	N: 8753.65 E: 13878.10				
MH - 68	4' TYPE II MH	RIM = 5889.08 PIPE - 98 INV IN (18") = 5884.85 PIPE - 103 INV IN (18") = 5884.85 PIPE - 99 INV OUT (18") = 5884.55	N: 8920.89 E: 13860.70				
MH - 69	5' TYPE II MH	RIM = 5889.61 PIPE - 99 INV IN (18") = 5883.85 PIPE - 104 INV IN (18") = 5884.35 PIPE - 100 INV OUT (24") = 5883.35	N: 8781.76 E: 13877.21				
OS - 84	OUTLET STRUCTURE	RIM = 5880.64 PIPE - 108 INV OUT (18") = 5878.43	N: 8888.91 E: 14092.82				

UTILITY CROSSING DETAILS						
CROSSING #	N & E	TOP OF PIPE	BTM OF PIPE	VERT. SEP.		
13	N: 8,771.03 E:13,877.55	8" PVC WATER 5883.04	18" RCP STORM 5884.55	1.51'		

- NOTES:
 1. ALL STATION, OFFSET, AND NORTHING/EASTING VALUES ARE TO THE CENTER OF ALL STRUCTURES UNLESS OTHERWISE NOTED.
- 2. PIPE LENGTHS ARE MEASURED FROM CENTER TO CENTER OF ALL
- STRUCTURES.
- 3. CONTRACTOR TO FIELD VERIFY HORIZONTAL AND VERTICAL LOCATION OF EXISTING STRUCTURES,
- 4. ALL RCP PIPE SHALL BE CLASS III UNLESS OTHERWISE NOTED.
- 5. PIPES OF DIFFERENT SIZES ARE TO BE MATCHED TO THE CROWN OF THE INSIDE WALL OF PIPE.
- 6. PER THE EL PASO COUNTY ENGINEERING CRITERIA MANUAL MANHOLES SHALL BE INSTALLED 1/8" BELOW THE SURFACE OF THE PAVEMENT ON THE LOWEST SIDE OF THE MANHOLE."
- ALL STORM SEWER IS PUBLIC UNLESS OTHERWISE NOTED. 8. TOP OF BOX ELEVATIONS GIVEN FOR CDOT TYPE R INLETS REFER TO THE COUNTY STANDARD DETAIL FOR CORRESPONDING DESIGN
- **ELEVATIONS.** YEAR STORM SHALL USE WATERTIGHT JOINTS WITH A 100 YEAR

9. SECTIONS OF STORM PIPE WITH PRESSURE HEAD DURING THE 100 SERVICE LIFE PER ECM 3.3.1.D

REFERENCE			-		SHEET
DRAWINGS	+				$\frac{1}{1}$
]
					∤ †
	No.	DATE	DESCRIPTION	BY	
			REVISIONS		
	СОМІ	PUTER FIL	E MANAGEMENT		1
	FILE NA	F. Matrix(b	6.038 (Trails F6)\100 Dwg\104 Plan Sets\Construction Plans\Road & Storm Plans\SD01.dwg ack).ctb		
			4, 2023 1:41:37 PM AS OF PLOT DATE AND MAY BE SUBJECT TO CHANGE.		

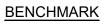

COLORADO SPRINGS UTILITIES (FIMS) MONUMENT F206 A BERNTSEN TOP SECURITY MONUMENT SYSTEM WITH A 3.5-INCH DIAMETER ALUMINUM CAP IN A ROAD BOX, LOCATED ON THE NORTHWEST CORNER OF FONTAINE BOULEVARD AND POWERS

BOULEVARD, ELEVATION - 5897.89' U.S. SURVEY FT

BASIS OF BEARING

BEARINGS ARE BASED ON THE NORTH LINE OF THE 6TH P.M. SAID LINE BEARS S89°51'23"E PROMITING NORTHWEST CORNER OF SAID SECTION 9 (2 ½" AULM. CAP PLS 17664) TO THE N ¼ CAP PLS 17664)

PREPARED BY:

PRELIMINARY THIS DRAWING HAS NOT BEEN APPROVED BY GOVERNING AGENCIES AND


IS SUBJECT TO CHANGE


TRAILS AT ASPEN RIDGE FILING NO. 4


STORM DRAIN PLAN & PROFILE

ROADWAY & STORM IMPROVEMENT PLANS

FOR AND ON BEHALF OF MATRIX DESIGN GROUP, INC. PROJECT No. 21.886.038 SCALE DATE ISSUED: DESIGNED BY: AUGUST 2021 DRAWING No. DRAWN BY: SD04 CHECKED BY: NMS VERT. 1" = 5' SHEET 27 OF 32

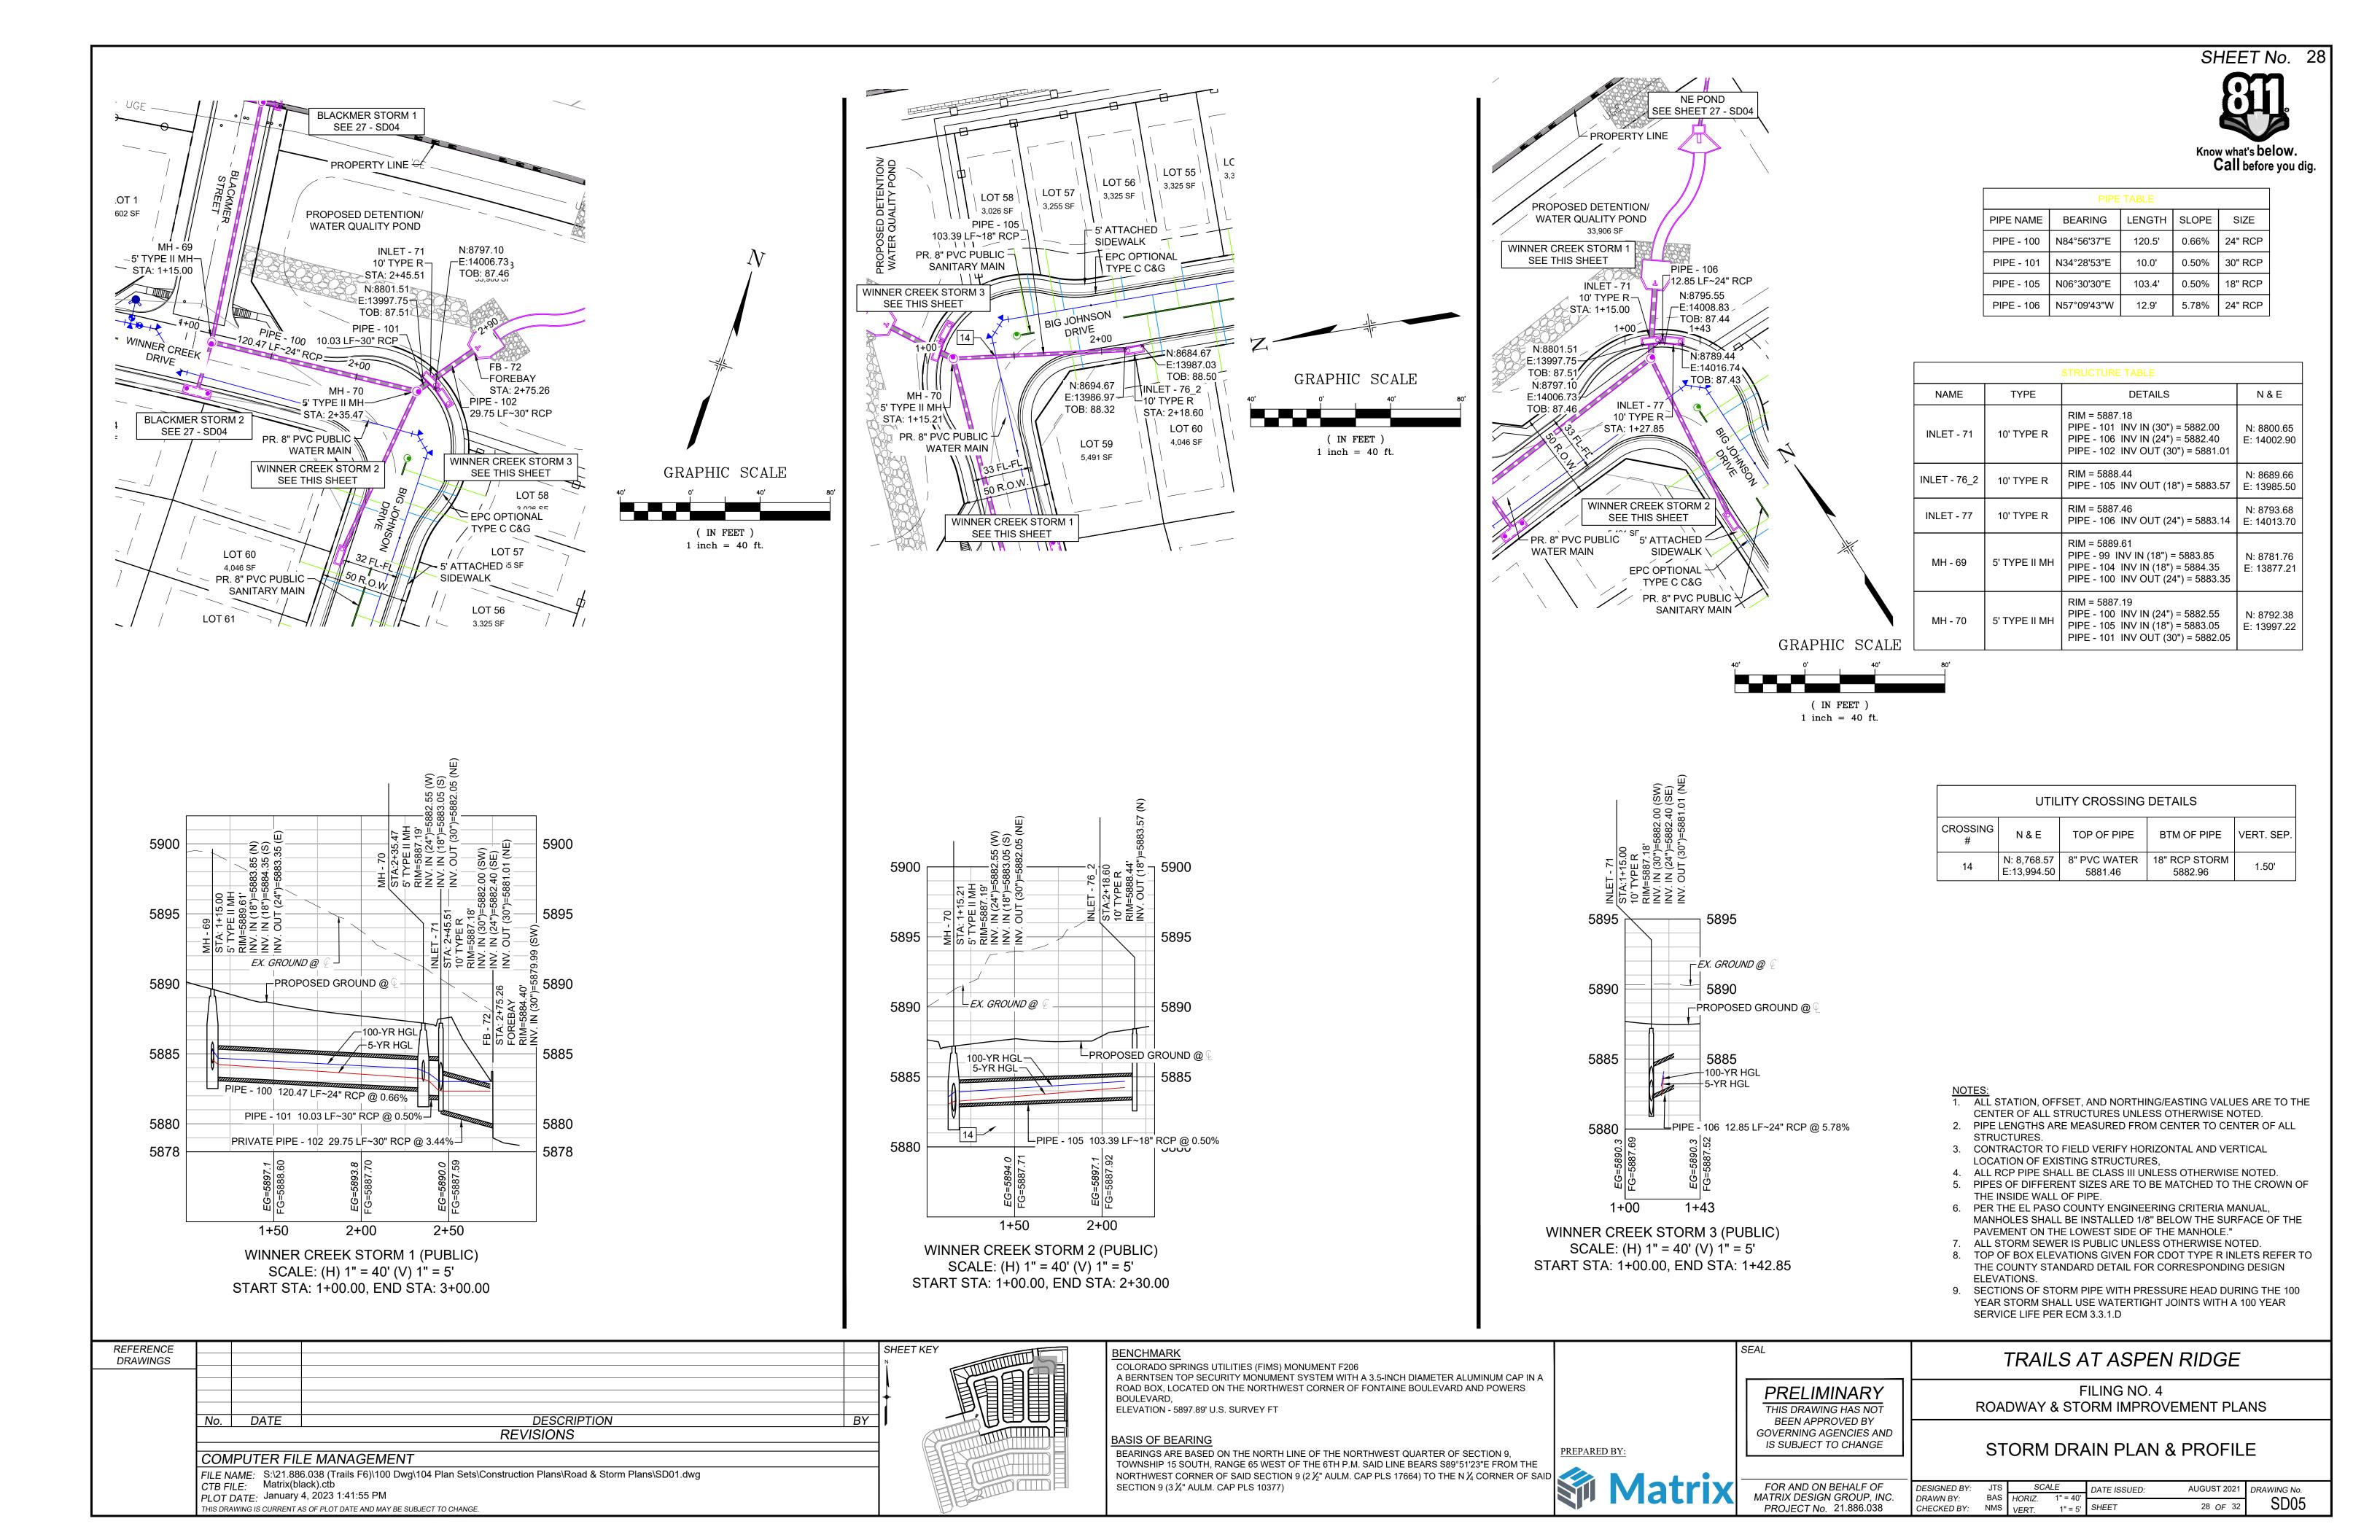

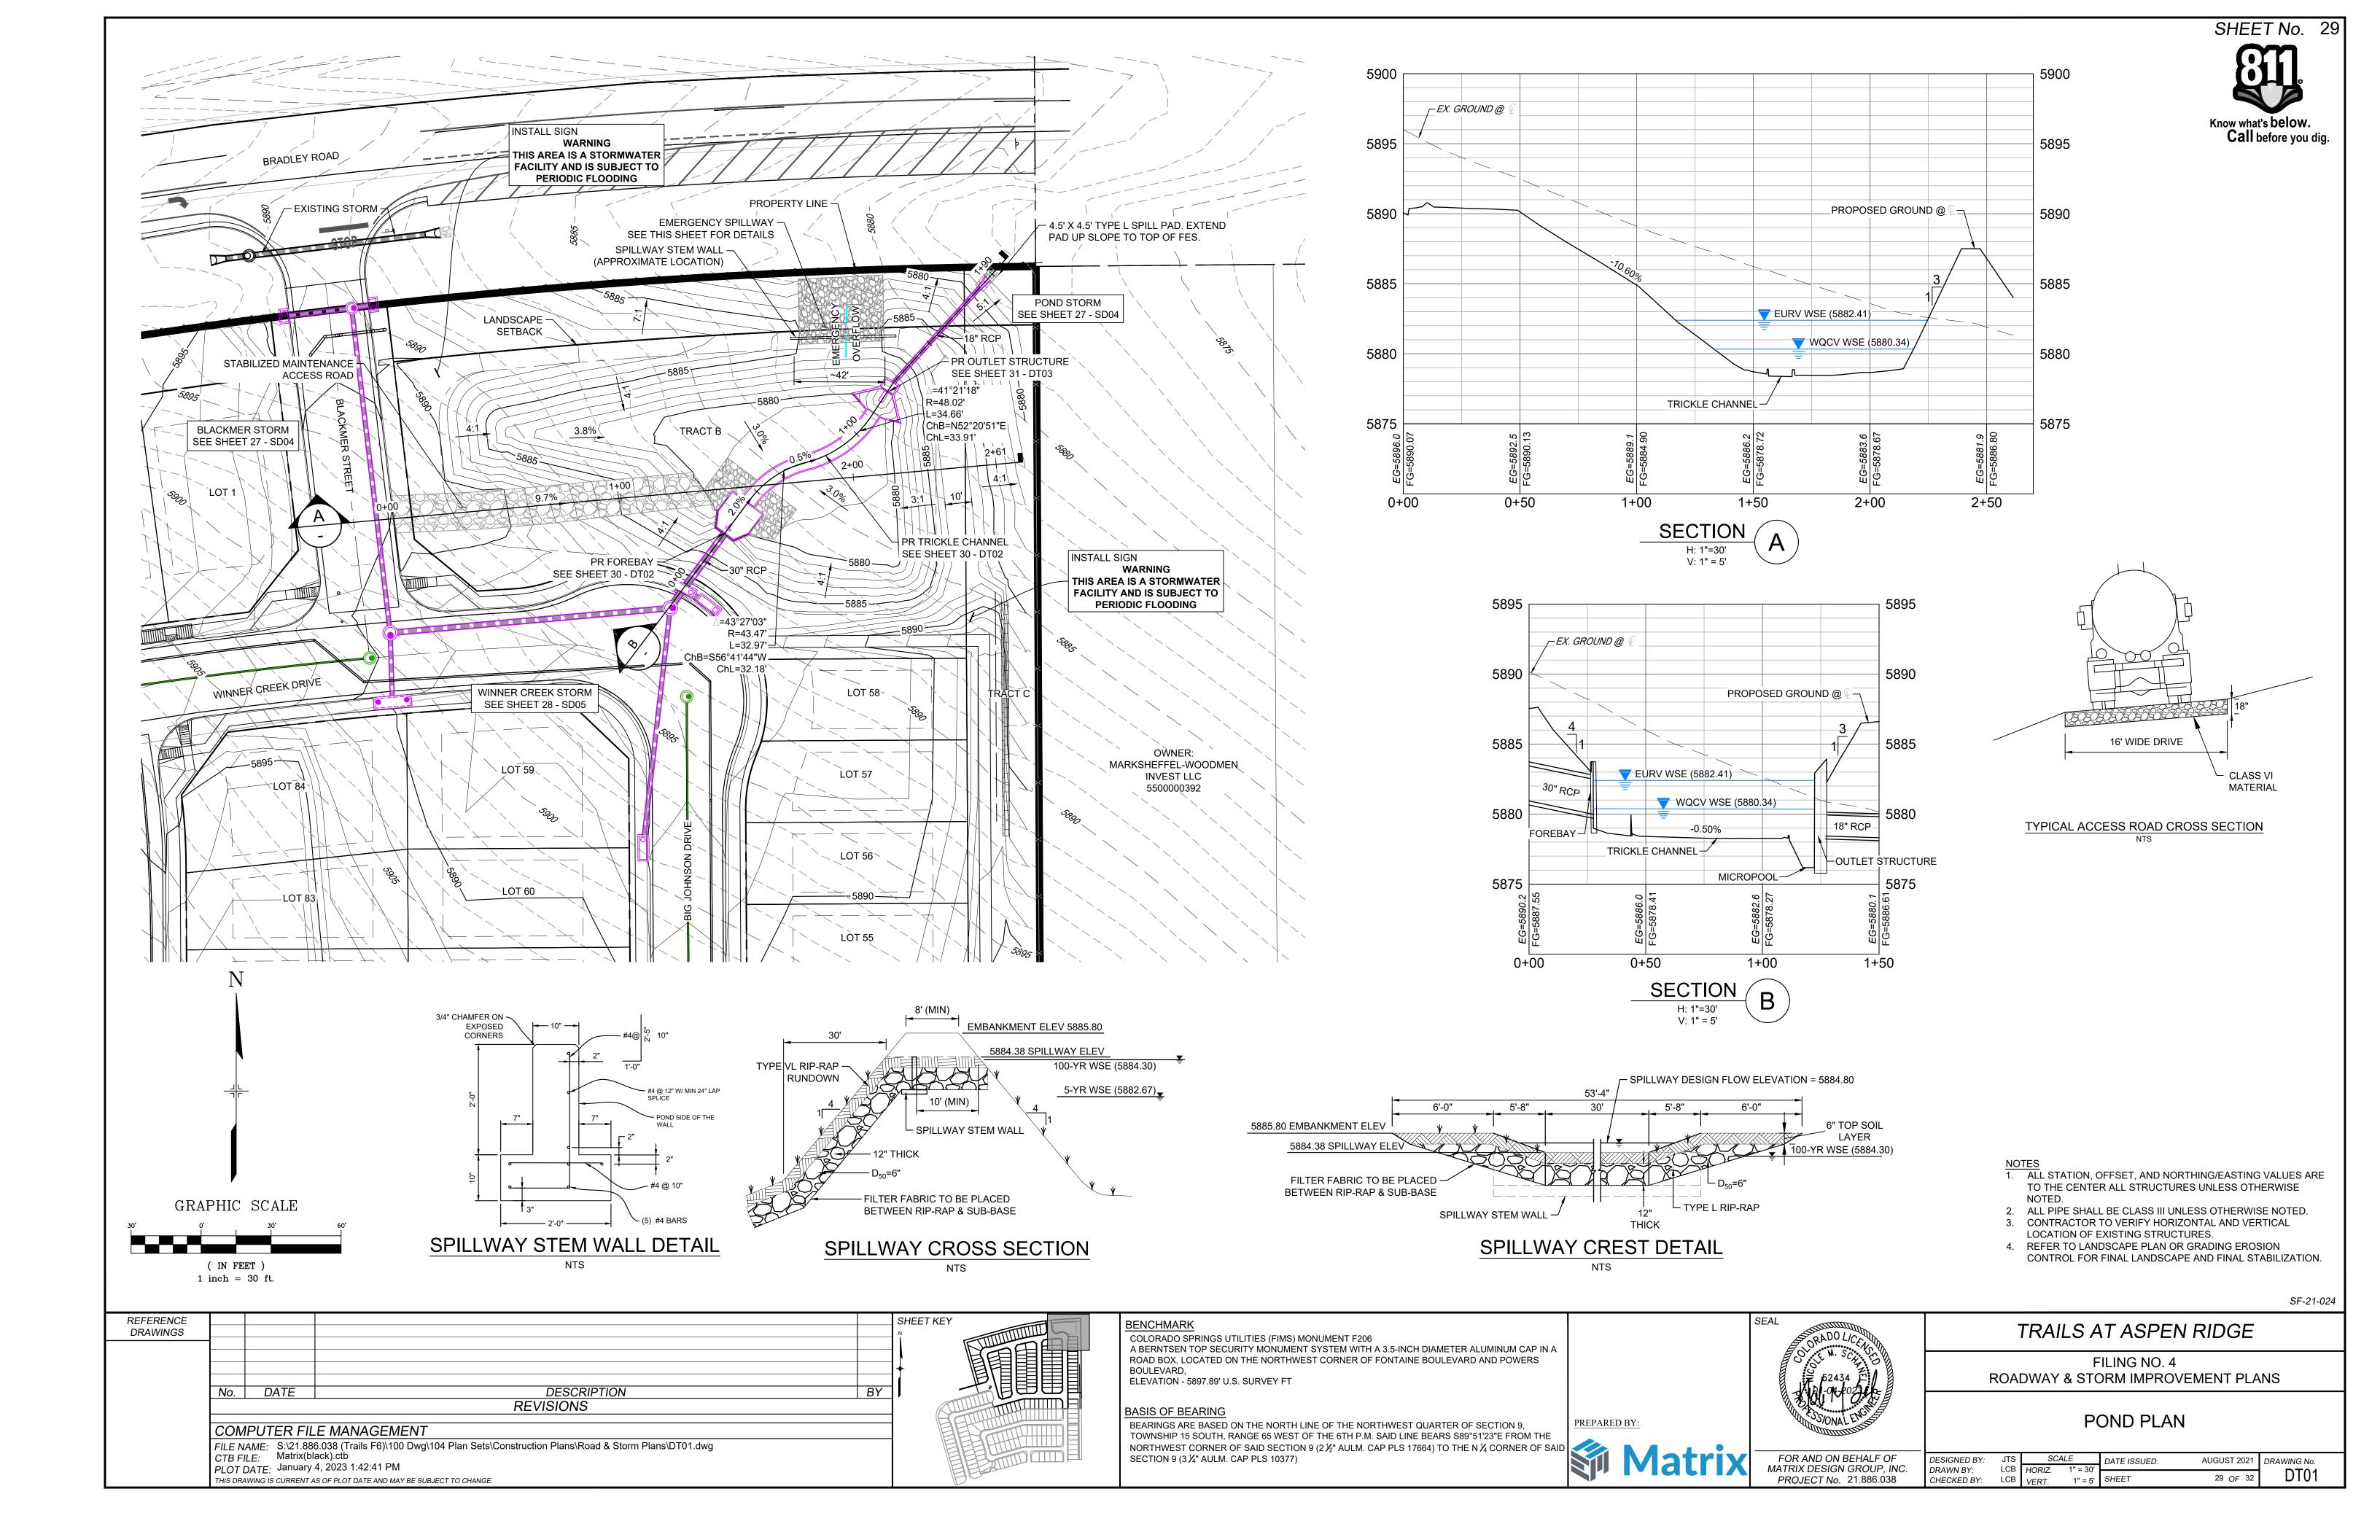

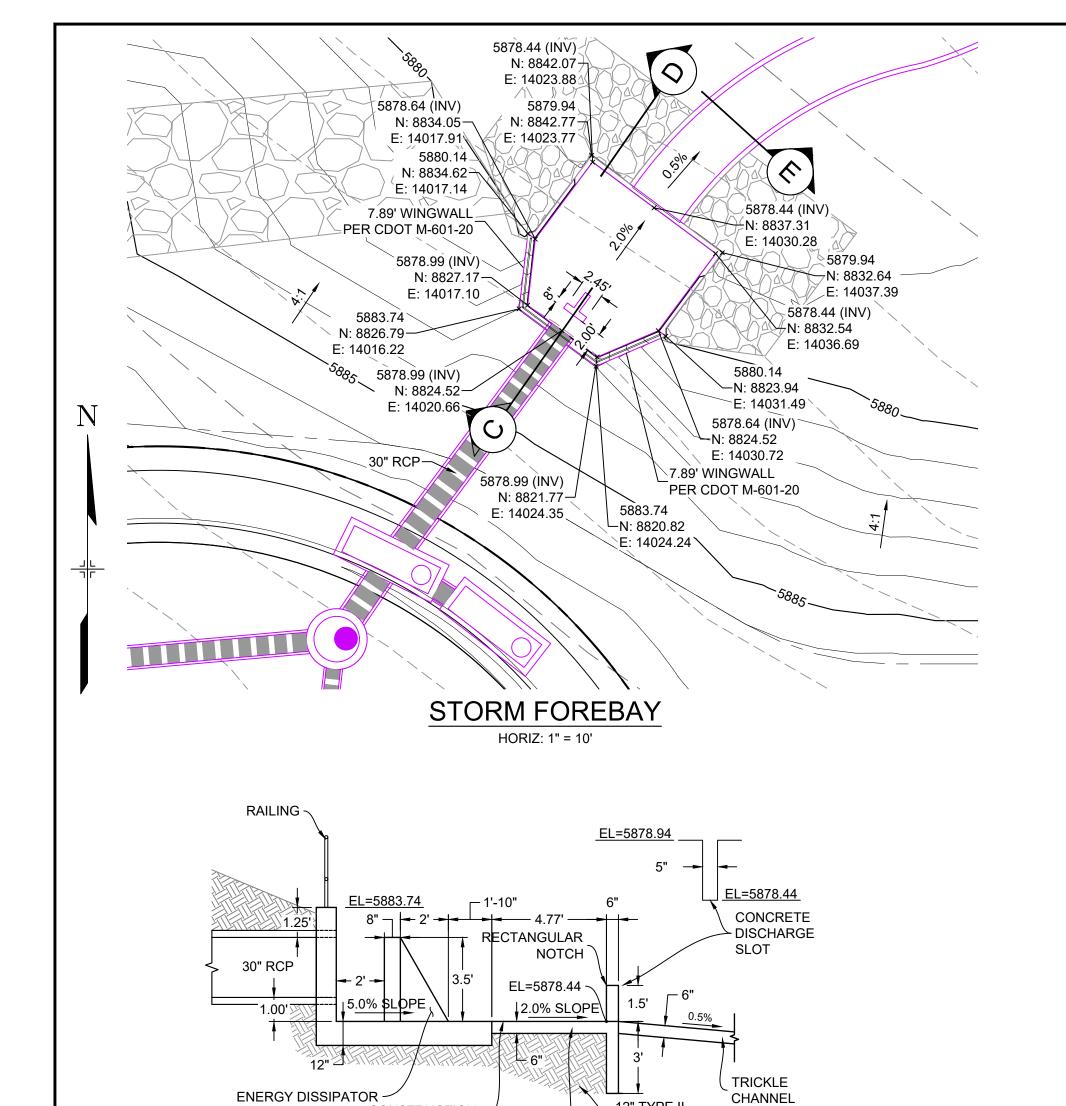

CONSTRUCTION

FOREBAY REINFORCING

PLOT DATE: January 4, 2023 1:43:01 PM

THIS DRAWING IS CURRENT AS OF PLOT DATE AND MAY BE SUBJECT TO CHANGE.


JOINT


6" 5000 PSI


SECTION

CONCRETE W/ -


FIBERMESH SLAB

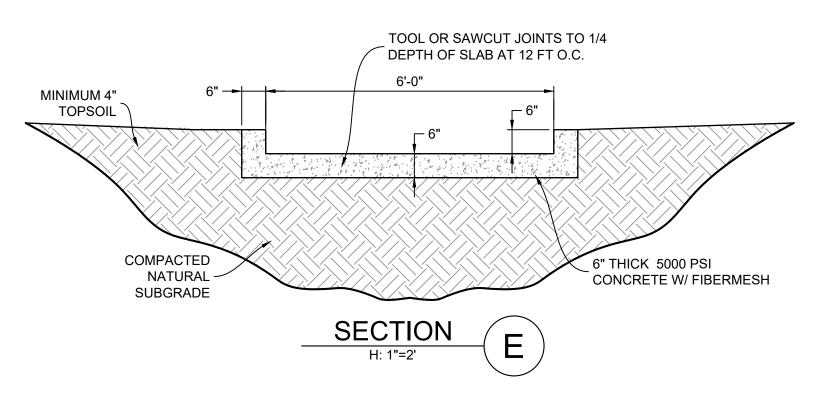

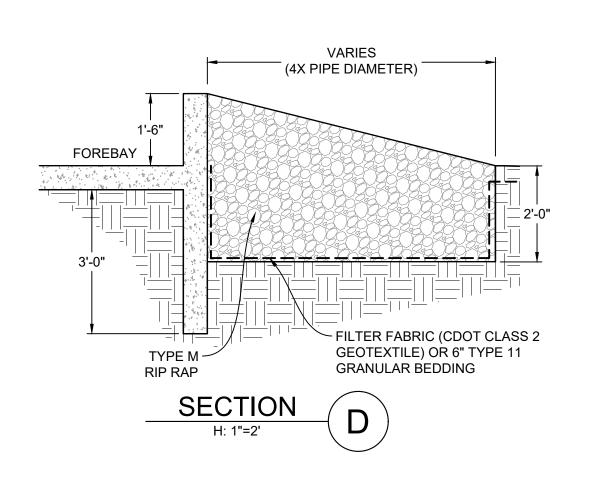

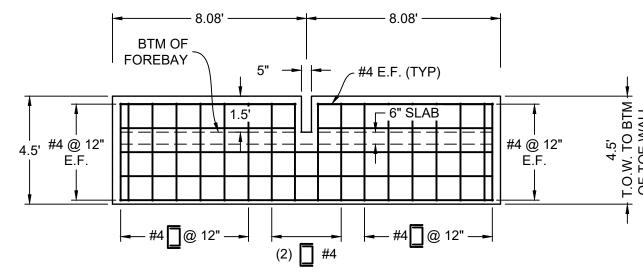

SAFETY RAILING

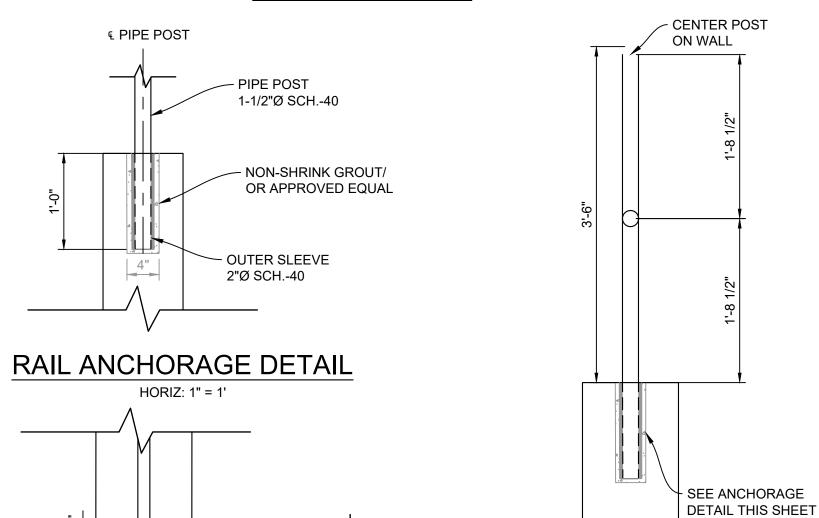

RAILING DETAIL HORIZ: 1" = 1'

RAILING NOTES:

1. ALL PIPE IS 1-1/2"

MOT-DIPPED GALV. SCH 40 STEEL PIPE.

10" MIN

SHEET No. 30

Know what's below.

Call before you dig.

- 2. DIMENSIONS SHOWN ARE FROM CENTER OF PIPE UNLESS OTHERWISE NOTED.
- 3. RAILING SHALL BE PLACED AT ALL LOCATIONS WHERE FALL HEIGHT IS GREATER THAN 30".

FOREBAY FRONT WALL PROFILE

REFERENCE DRAWINGS							
	No.	DATE	DESCRIPTION	В			
	REVISIONS						
	COM	PUTER FIL	E MANAGEMENT				
		AME: S:\21.880	6.038 (Trails F6)\100 Dwg\104 Plan Sets\Construction Plans\Road & Storm Plans\DT01.dwg				

12" TYPE II


BEDDING

BENCHMARK

COLORADO SPRINGS UTILITIES (FIMS) MONUMENT F206 A BERNTSEN TOP SECURITY MONUMENT SYSTEM WITH A 3.5-INCH DIAMETER ALUMINUM CAP IN A ROAD BOX, LOCATED ON THE NORTHWEST CORNER OF FONTAINE BOULEVARD AND POWERS BOULEVARD, ELEVATION - 5897.89' U.S. SURVEY FT

BASIS OF BEARING


BEARINGS ARE BASED ON THE NORTH LINE OF THE NORTHWEST QUARTER OF SECTION 9, TOWNSHIP 15 SOUTH, RANGE 65 WEST OF THE 6TH P.M. SAID LINE BEARS S89°51'23"E FROM THE NORTHWEST CORNER OF SAID SECTION 9 (2 ½" AULM. CAP PLS 17664) TO THE N ¼ CORNER OF SAID SECTION 9 (3 1/4" AULM. CAP PLS 10377)

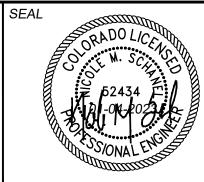

2 1/2"

RAIL CORNER DETAIL

HORIZ: 1" = 1'

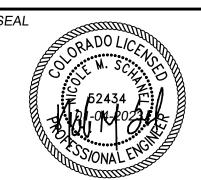

FILING NO. 4 ROADWAY & STORM IMPROVEMENT PLANS


TRAILS AT ASPEN RIDGE


SF-21-024


POND DETAILS


JTS SCALE DATE ISSUED:
LCB HORIZ. VARIES
LCB VERT. N/A SHEET DESIGNED BY: AUGUST 2021 DRAWING No. DRAWN BY: DT02 30 OF 32 CHECKED BY:




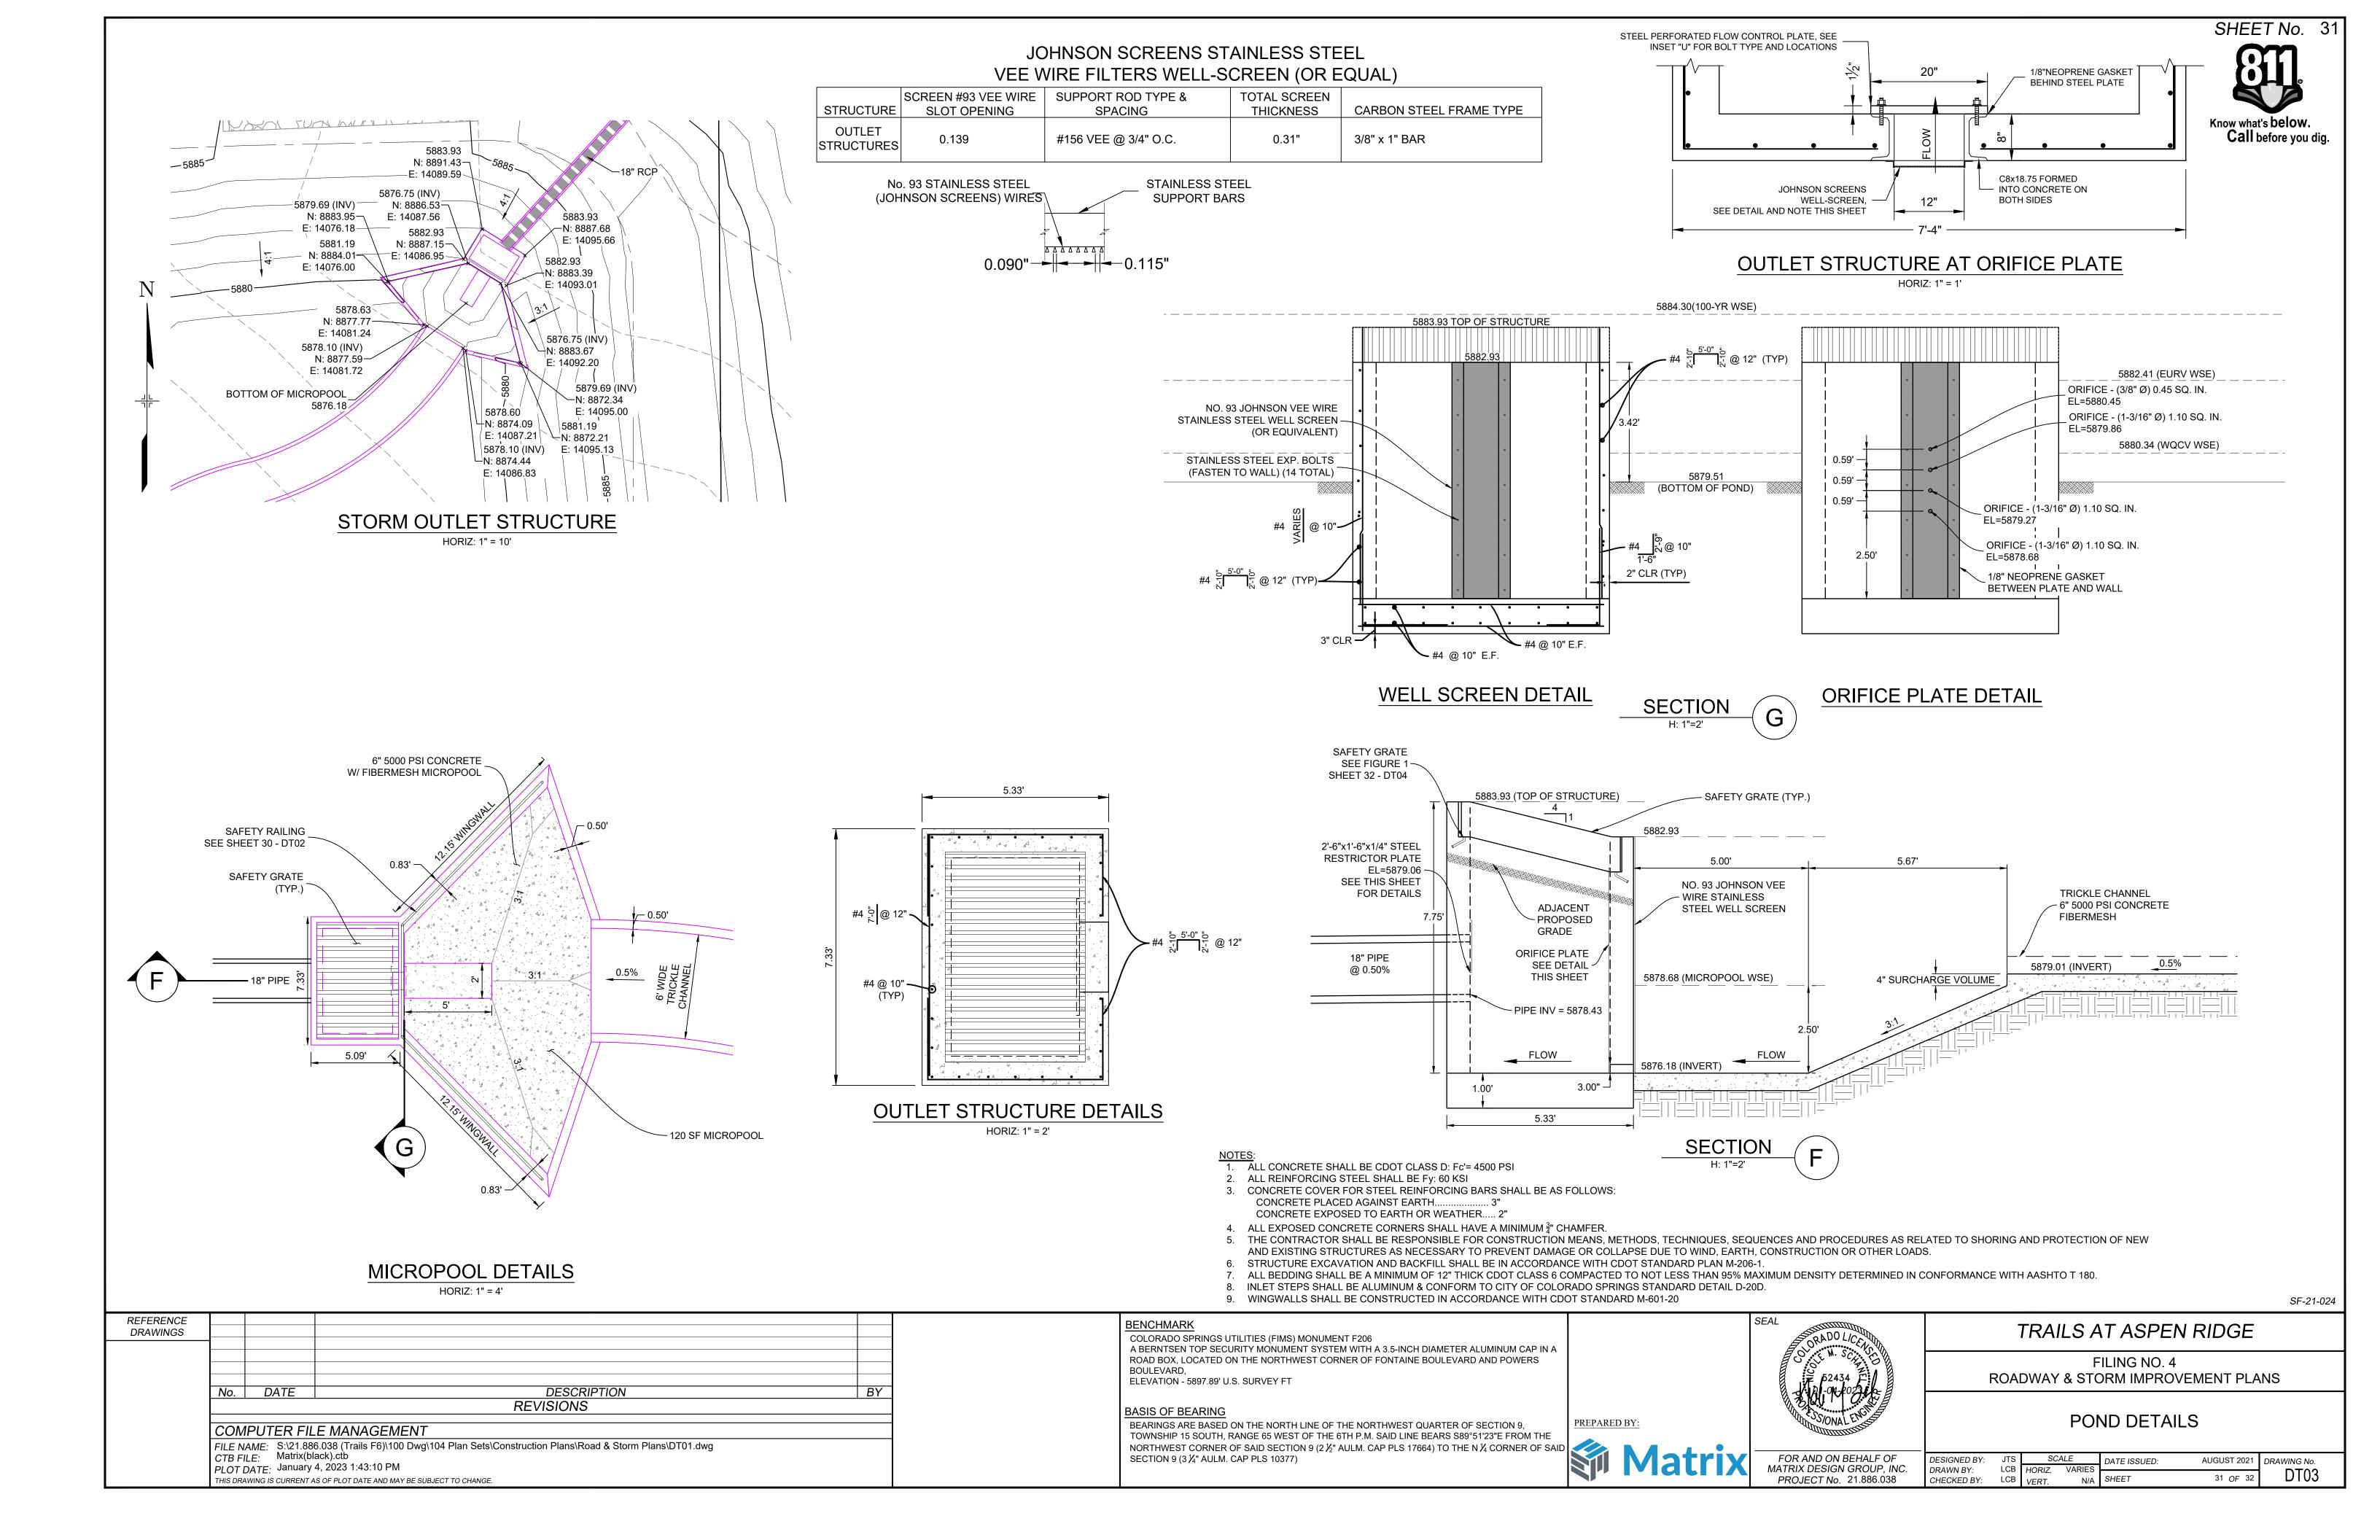


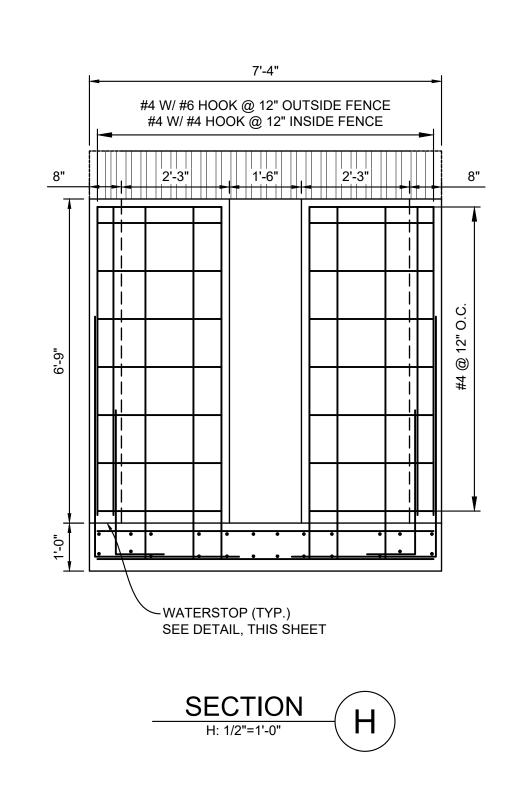

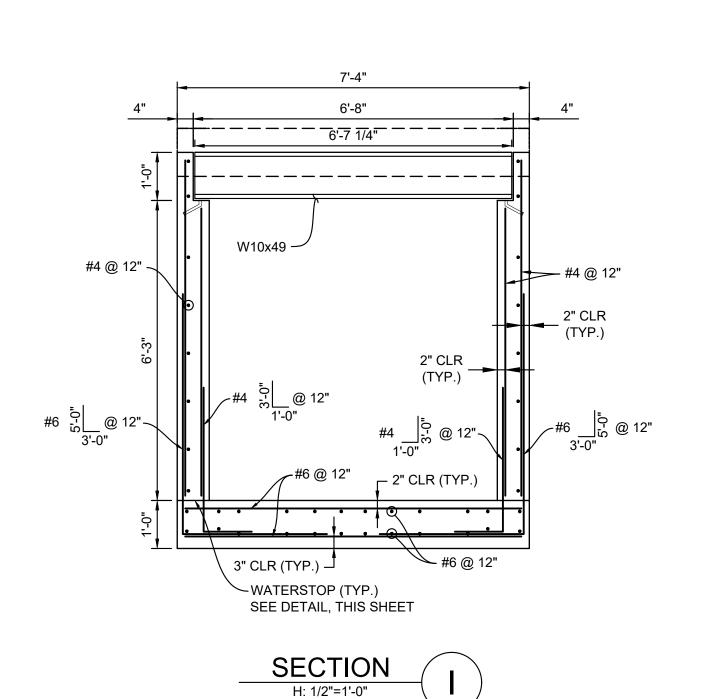

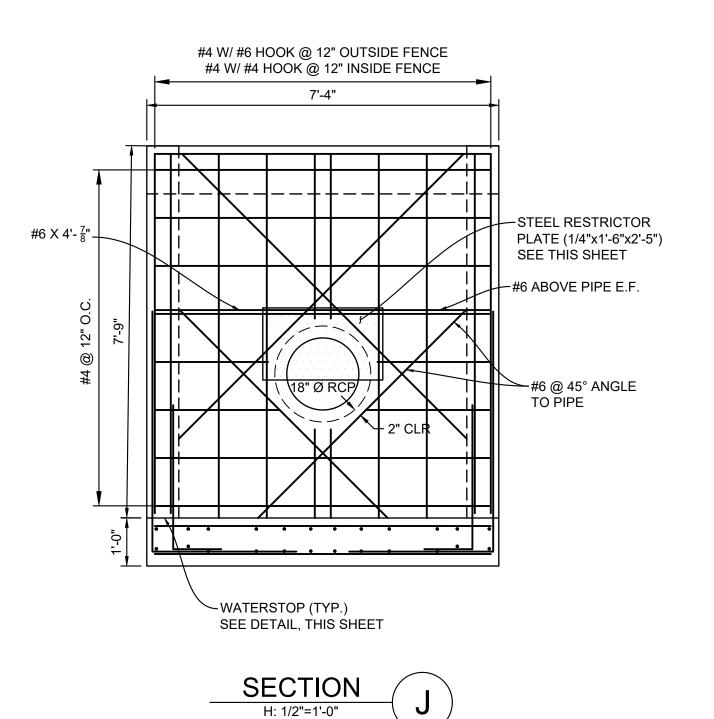

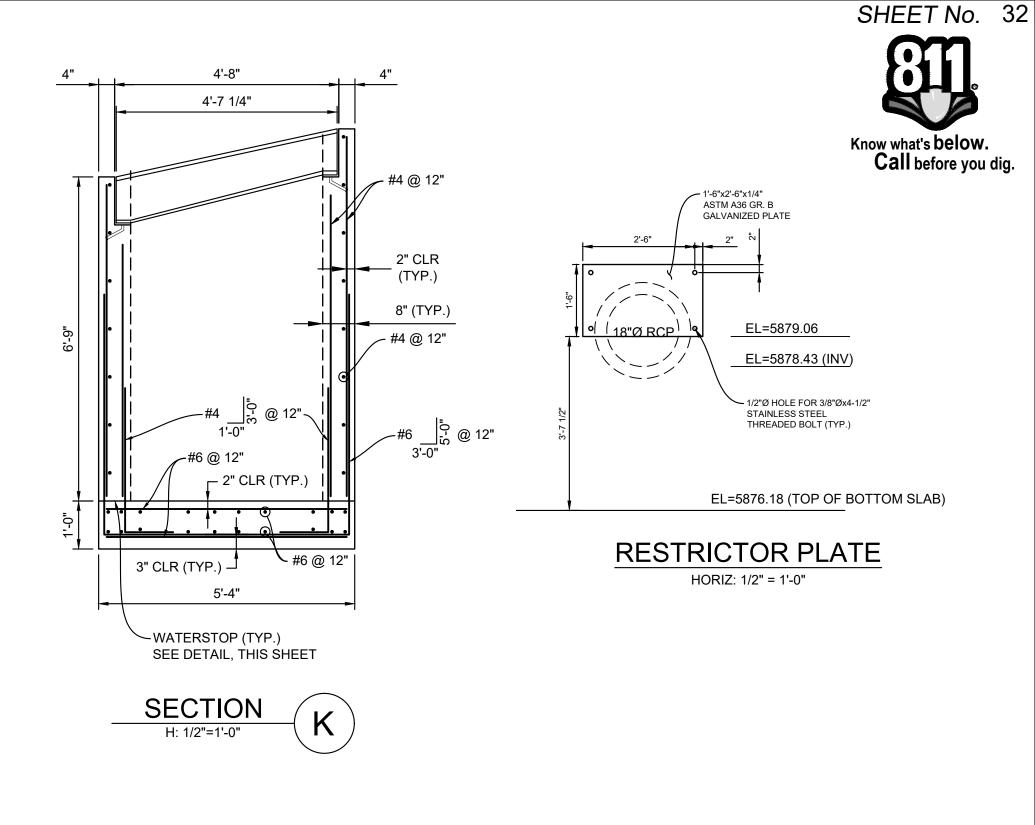

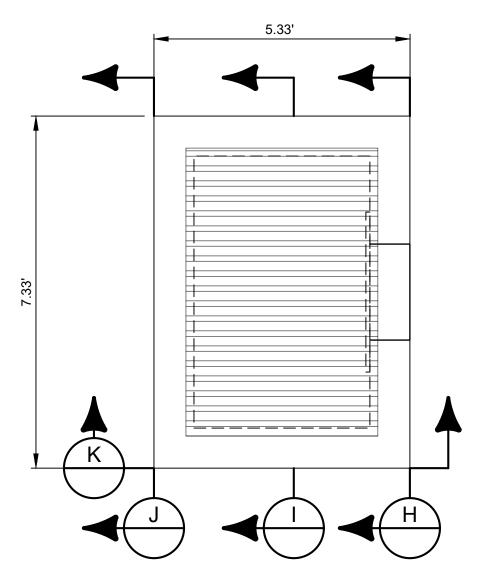


WATERSTOP SHALL BE VOLCLAY WATERSTOP RX 101 OR EARTHSHIELD JP 648 OR APPROVED EQUAL. PLACE WATERSTOP FOR ENTIRETY OF EACH HORIZONTAL & VERTICAL CONSTRUCTION WATERSTOP 3" COVER MIN INSTRUCTIONS.


WATERSTOP NOTES:

OUTLET STRUCTURE DETAILS HORIZ: 1" = 2'

- 1. ALL CONCRETE SHALL BE CDOT CLASS D: Fc'= 4500 PSI
- 2. ALL REINFORCING STEEL SHALL BE Fy: 60 KSI
- 3. CONCRETE COVER FOR STEEL REINFORCING BARS SHALL BE AS FOLLOWS: CONCRETE PLACED AGAINST EARTH...... 3" CONCRETE EXPOSED TO EARTH OR WEATHER..... 2"
- 4. ALL EXPOSED CONCRETE CORNERS SHALL HAVE A MINIMUM $\frac{3}{4}$ " CHAMFER.
- 5. THE CONTRACTOR SHALL BE RESPONSIBLE FOR CONSTRUCTION MEANS, METHODS, TECHNIQUES, SEQUENCES AND PROCEDURES AS RELATED TO SHORING AND PROTECTION OF NEW AND EXISTING STRUCTURES AS NECESSARY TO PREVENT DAMAGE OR COLLAPSE DUE TO WIND, EARTH, CONSTRUCTION OR OTHER LOADS.
- 6. STRUCTURE EXCAVATION AND BACKFILL SHALL BE IN ACCORDANCE WITH CDOT STANDARD PLAN M-206-1. 7. ALL BEDDING SHALL BE A MINIMUM OF 12" THICK CDOT CLASS 6 COMPACTED TO NOT LESS THAN 95% MAXIMUM
- DENSITY DETERMINED IN CONFORMANCE WITH AASHTO T 180.
- 8. INLET STEPS SHALL BE ALUMINUM & CONFORM TO CITY OF COLORADO SPRINGS STANDARD DETAIL D-20D.

9. WINGWALLS SHALL BE CONSTRUCTED IN ACCORDANCE WITH CDOT STANDARD M-601-20

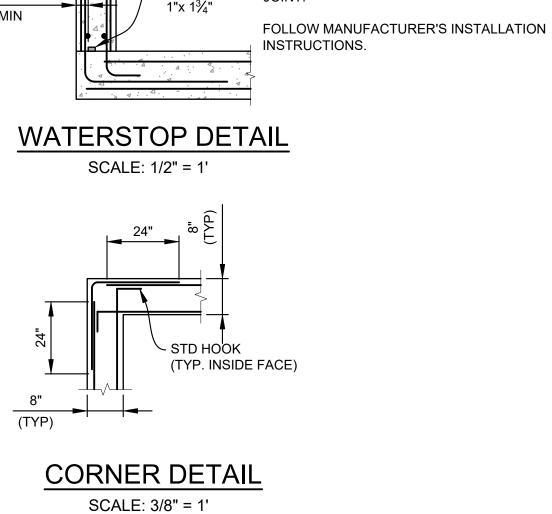

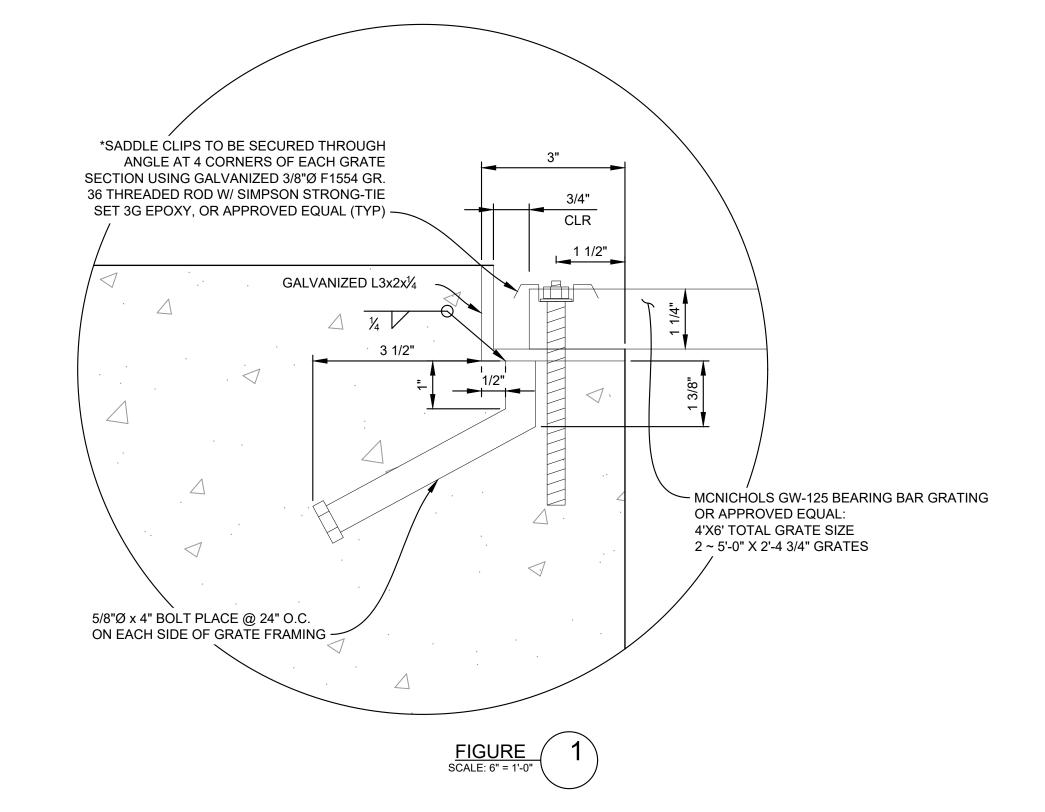

SF-21-024

REFERENCE DRAWINGS				
	No.	DATE	DESCRIPTION	BY
			REVISIONS	
COMPUTER FILE MANAGEMENT FILE NAME: S:\21.886.038 (Trails F6)\100 Dwg\104 Plan Sets\Construction Plans\Road & Storm Plans\DT01.dwg CTB FILE: Matrix(black).ctb PLOT DATE: January 4, 2023 1:43:28 PM THIS DRAWING IS CURRENT AS OF PLOT DATE AND MAY BE SUBJECT TO CHANGE.				

BENCHMARK

COLORADO SPRINGS UTILITIES (FIMS) MONUMENT F206 A BERNTSEN TOP SECURITY MONUMENT SYSTEM WITH A 3.5-INCH DIAMETER ALUMINUM CAP IN A ROAD BOX, LOCATED ON THE NORTHWEST CORNER OF FONTAINE BOULEVARD AND POWERS


BOULEVARD, ELEVATION - 5897.89' U.S. SURVEY FT

BASIS OF BEARING

BEARINGS ARE BASED ON THE NORTH LINE OF THE NORTHWEST QUARTER OF SECTION 9, PREPARED BY: TOWNSHIP 15 SOUTH, RANGE 65 WEST OF THE 6TH P.M. SAID LINE BEAKS S89 31 Z3 E FINOWITTE

NORTHWEST CORNER OF SAID SECTION 9 (2 ½" AULM. CAP PLS 17664) TO THE N ¼ CORNER OF SAID

SECTION 9 (3 ¾" AULM. CAP PLS 10377)

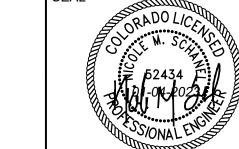

TRAILS AT ASPEN RIDGE

FILING NO. 4 ROADWAY & STORM IMPROVEMENT PLANS

POND DETAILS

FOR AND ON BEHALF OF
MATRIX DESIGN GROUP, INC.
PROJECT No. 21,886,038

DRAWN BY:

CHECKED BY:

SCALE DATE ISSUED: DESIGNED BY: CAG AUGUST 2021 DRAWING No. BAS HORIZ. VARIES DT04 32 OF 32 BAS VERT.