
#### EL PASO COUNTY:

COUNTY PLAN REVIEW IS PROVIDED ONLY FOR GENERAL CONFORMANCE WITH COUNTY DESIGN CRITERIA. THE COUNTY IS NOT RESPONSIBLE FOR THE ACCURACY AND ADEQUACY OF THE DESIGN DIMENSIONS, AND/ OR ELEVATIONS WHICH SHALL BE CONFIRMED AT THE JOB SITE. THE COUNTY THROUGH THE APPROVAL OF THIS DOCUMENT ASSUMES NO RESPONSIBILITY FOR COMPLETENESS AND/ OR ACCURACY OF THIS DOCUM

FILED IN ACCORDANCE WITH THE REQUIREMENTS OF THE EL PASO COUNTY LAND DEVELOPMENT CODE, DRAINAGE CRITERIA MANUAL, VOLUMES 1 AND 2, AND ENGINEERING CRITERIA MANUAL AS AMENDED.

IN ACCORDANCE WITH ECM SECTION 1.12, THESE CONSTRUCTION DOCUMENTS WILL BE VALID FOR CONSTRUCTION FOR A PERIOD OF 2 YEARS FROM THE DATE SIGNED BY THE EL PASO COUNTY ENGINEER. IF CONSTRUCTION HAS NOT STARTED WITHIN THOSE 2 YEARS, THE PLANS WILL NEED TO BE RESUBMITTED FOR APPROVAL, INCLUDING PAYMENT OF REVIEW FEES AT THE PLANNING AND COMMUNITY DEVELOPMENT DIRECTORS DISCRETION.

|                                  |   | CI  | nange to Joshua Palmer, PE  |  |  |
|----------------------------------|---|---|---|--|--|
| DWG                              | No.                                       | SHEET NAME  | E   | SHEET No.                                |  |
| TS01<br>GN01<br>SS01 -<br>SS09 - |   | WASTEWATE   | -<br>DTES, LEGEND & ABBREVIATIO<br>ER PLAN & PROFILE<br>ERVICE PLAN   | 1<br>DNS 2<br>3 - 10<br>11 - 12          |  |
|                                  |   |   |   |  |  |
|                                  |   |   |   |  |  |
|                                  |   |   |   |  |  |
| OWNER/D                          | EVELOPE                                   | R   | COLA, LLC<br>555 MIDDLE CREEK PARKWA<br>COLORADO SPRINGS, CO 80   | •  |  |
| CIVIL ENG                        | INEER                                     |   | MATRIX DESIGN GROUP<br>2435 RESEARCH PARKWAY,<br>COLORADO SPRINGS, CO 80  |  |  |
| WATER &                          | SANITARY                                  | ' SEWER   | WIDEFIELD WATER AND SAN<br>8495 FONTAINE BOULEVARD<br>COLORADO SPRINGS, CO 80<br>ROBERT BANNISTER, (719) 3  | 9925                                     |  |
| ELECTRIC                         |   |   | MOUNTAIN VIEW ELECTRIC /<br>(719) 495-2283  |  |  |
| GAS                              |   |   | COLORADO SPRINGS UTILIT<br>1521 HANCOCK EXPRESSWA<br>COLORADO SPRINGS, CO<br>MARY HOAGLUND (719) 668-4  | Υ  |  |
| STREET                           |   |   | EL PASO COUNTY PUBLIC SI<br>(719) 520-6460  | ERVICES DEPARTMENT                       |  |
| DRAINAGI                         |   |   | EL PASO COUNTY PUBLIC SI<br>(719) 520-6460  | ERVICES DEPARTMENT                       |  |
| FIRE DEP                         | ARTMENT                                   |   | SECURITY FIRE DEPARTMEN<br>400 SECURITY BOULEVARD<br>SECURITY, CO 80911<br>(719) 392-7121   | ΝT                                       |  |
| NGINEER'S                        | STATEMEN                                  | NT:   |   |  |  |
| UPERVISION /<br>REPARED AC       | AND IS CORF<br>CORDING TO<br>NS. I ACCEPT | RECT TO THE BES<br>THE CRITERIA E<br>RESPONSIBILITY | N WAS PREPARED UNDER MY DIREC<br>T OF MY KNOWLEDGE AND BELIEF.<br>STABLISHED BY THE COUNTY FOR G<br>FOR ANY LIABILITY CAUSED BY AN<br>PARING THIS REPORT. | SAID PLAN HAS BEEN<br>RADING AND EROSION |  |
| ICOLE SCHAN                      | EL, PE #5243                              | 34  | DATE  |  |  |
| ERENCE                           |   |   |   |  |  |
|                                  |   |   |   |  |  |
|                                  |   |   |   |  |  |
|                                  | No. L                                     | DATE  | F   | DESCRIPTION<br>REVISIONS                 |  |
|                                  |   |   |   |  |  |

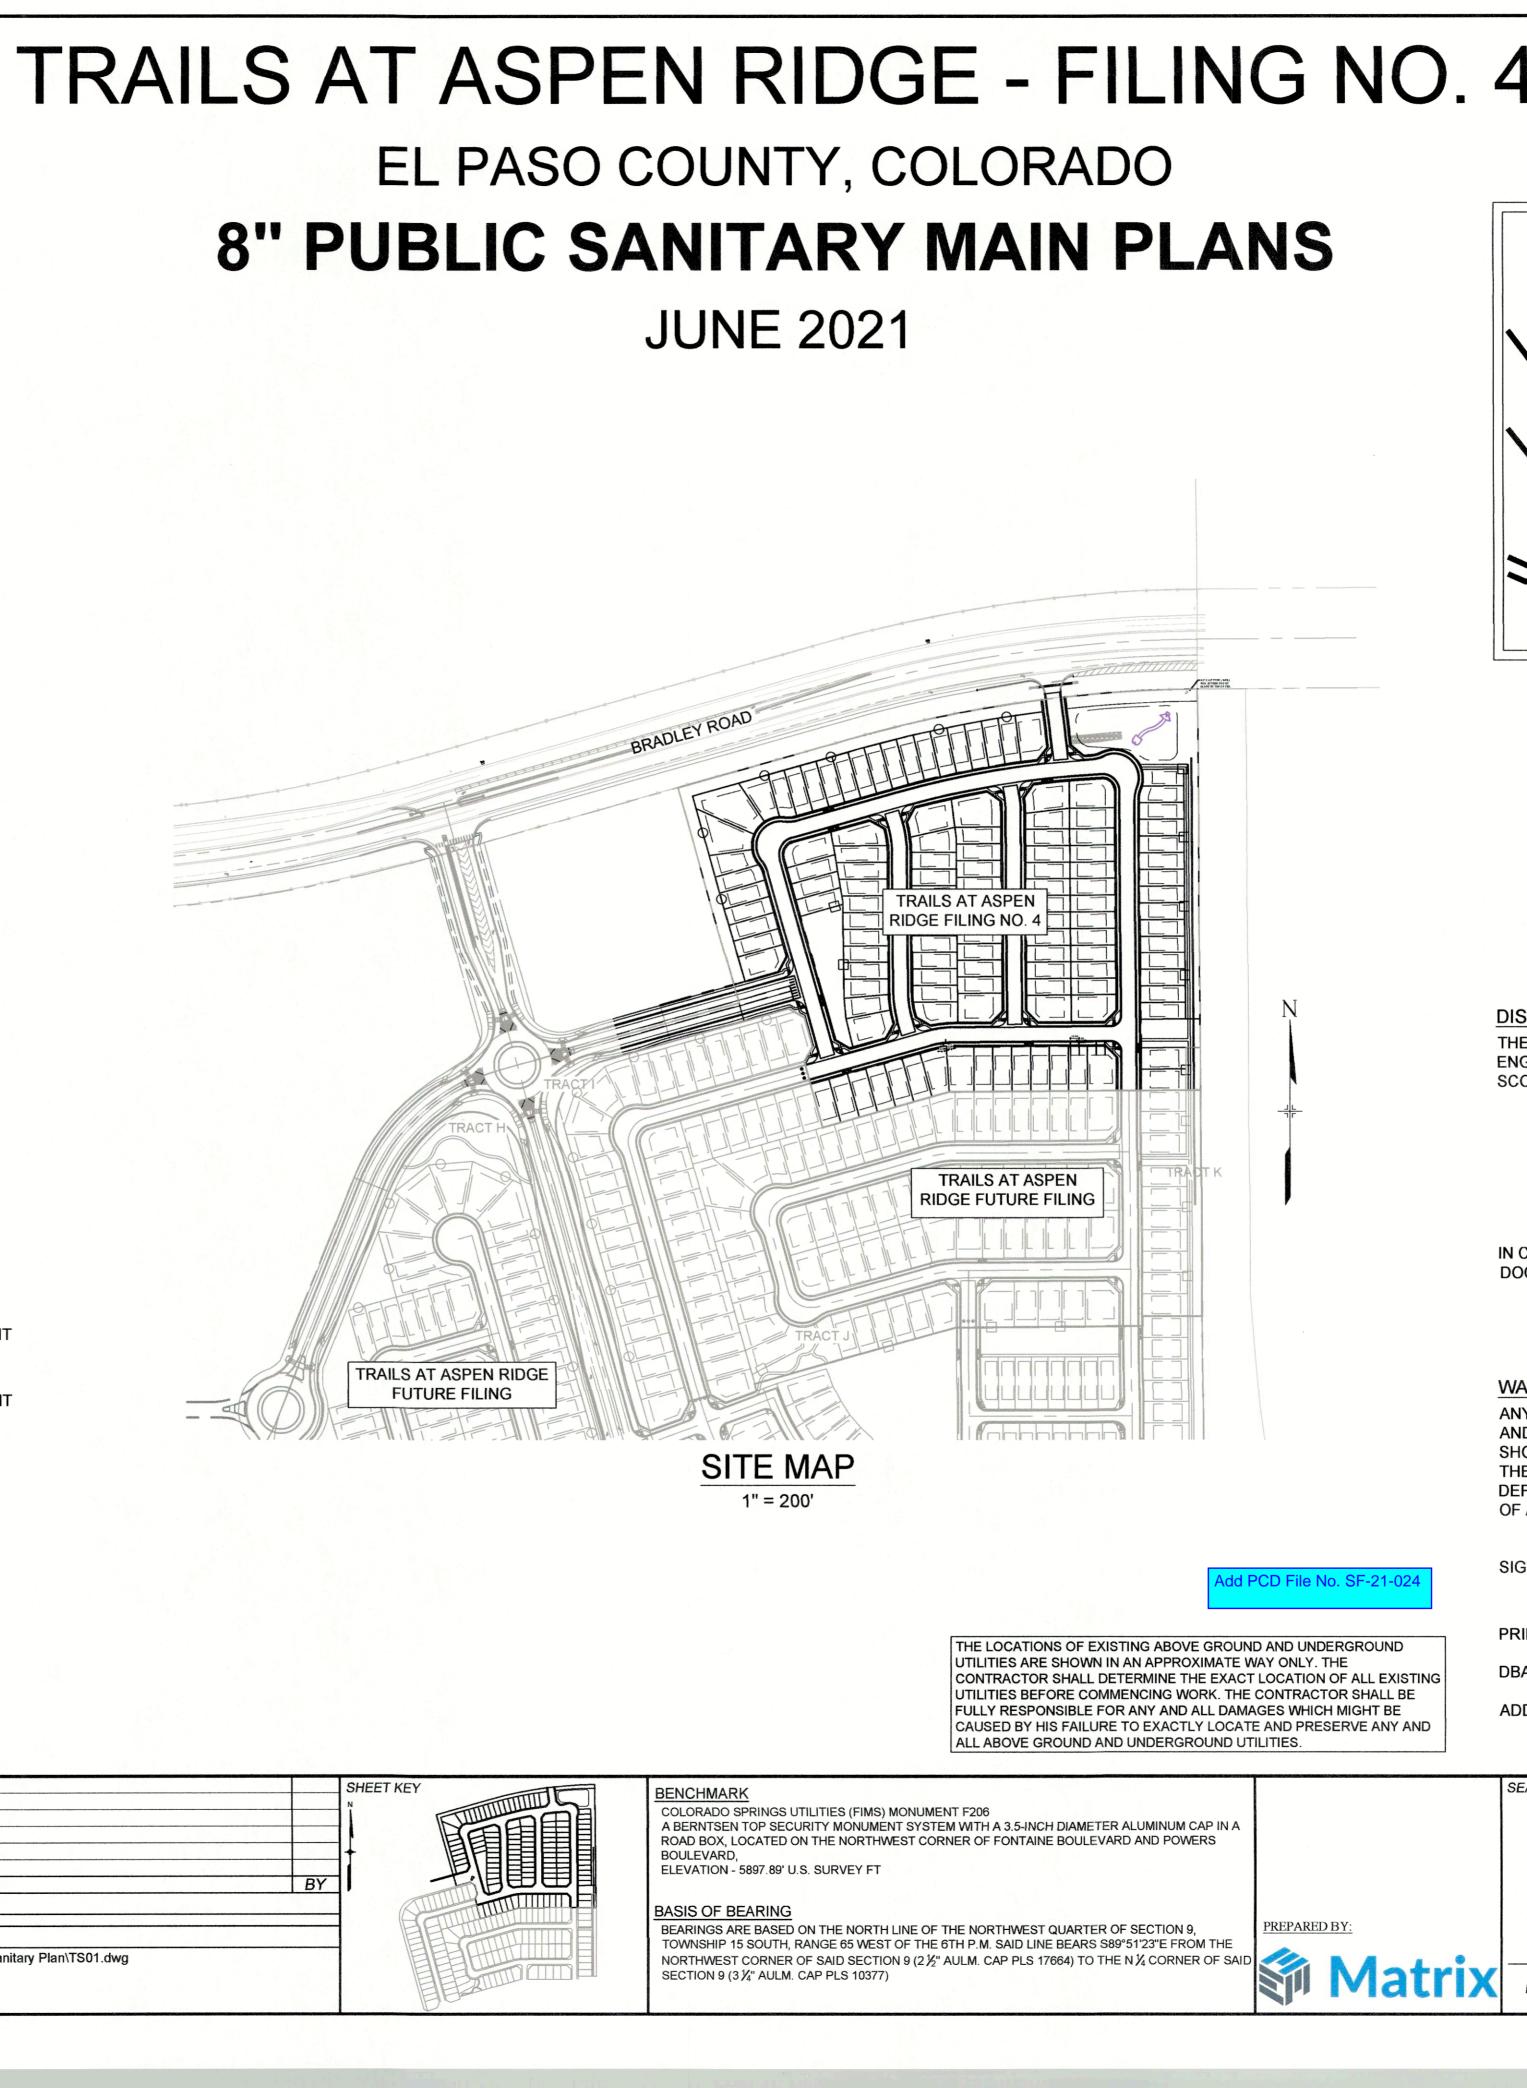

| 4   | SHEET<br>SHEET<br>Know what's<br>Call before   | J.                |
|---|--|-------------------|
| GRINNELL BLVD<br>FONT   | POWERS BLVD<br>POWERS BLVD<br>POWER |                   |
|   | ANITATION DISTRICT RECOGNIZES THE DESIGN<br>NSIBILITY FOR THE DESIGN AND HAS LIMITED ITS<br>IGLY.  |                   |
|   | WATER AND SANITATION DISTRICT<br>ATER DESIGN APPROVAL  |                   |
| DATE: August  | 24, 202BY: Pohrt Alloung -   |                   |
| N CASE OF ERRORS OR OMIS<br>DOCUMENT THE STANDARDS<br>INSTALLATION OF W       | NUMBER:<br>SIONS WITH THE WATER DESIGN AS SHOWN ON THIS<br>AS DEFINED IN THE "RULES AND REGULATIONS FOR<br>VATER MAINS AND SERVICES" SHALL RULE.   |                   |
| APPROVAL EXPIR  | RES 180 DAYS FROM DESIGN APPROVAL  |                   |
| ND/OR DEPTH OF COVER OF<br>HOWN ON THIS DRAWING SH<br>THE OWNER/DEVELOPER SHA | ANY WATER OR SEWER MAINS OR OTHER APPURTENANCE<br>HALL BE THE RESPONSIBILTY OF THE OWNER/DEVELOPER.<br>ILL BE RESPONSIBLE FOR ALL OPERATION DAMAGES AND<br>ID MATERIAL FOR MAINS AND SERVICES FROM THE DATE  |                   |
| BIGNED OWNER  | Burden DATE <u>C/22/21</u><br>R/DEVELOPER  |                   |
| RINT NAME TIM B   | USCHAR   |                   |
| DBA COLA, LL  |  |                   |
| DDRESS 55 MIDDLE  | CREEK PARKWAY, SUITS 500<br>DO SPRINKS, CO 80921   |                   |
| SEAL COLORA   |  |                   |
| ORADO LICENS  | TRAILS AT ASPEN RIDGE  |                   |
| 62434 F   | FILING NO. 4<br>8" SANITARY SEWER PLANS  |                   |
| SSIONAL ENGINE  | TITLE SHEET  |                   |
| FOR AND ON BEHALF OF<br>MATRIX DESIGN GROUP, INC.<br>PROJECT No. 21.886.038   | DESIGNED BY:BASSCALEDATE ISSUED:JUNE 2021DATE ISSUED:DRAWN BY:JLWHORIZ.N/ACHECKED BY:NMSVERT.N/A   | rawing №.<br>TS01 |
|   |  |                   |

### WIDEFIELD WATER AND SANITATION DISTRICT GENERAL NOTES

- 1. ALL UTILITY CONSTRUCTION TO BE CONDUCTED IN CONFORMANCE WITH THE CURRENT WIDEFIELD WATER AND SANITATION DISTRICT SPECIFICATIONS. COMPACTION REQUIREMENTS SHALL BE 95% STANDARD PROCTOR AS DETERMINED BY ASTM D698, UNLESS OTHERWISE APPROVED BY THE WIDEFIELD WATER AND SANITATION DISTRICT OR A HIGHER STANDARD IS IMPOSED BY ANOTHER AGENCY HAVING RIGHT-OF-WAY JURISDICTION.
- 2. ALL MATERIALS AND WORKMANSHIP SHALL BE SUBJECT TO INSPECTION BY THE WIDEFIELD WATER AND SANITATION DISTRICT. THE WIDEFIELD WATER AND SANITATION DISTRICT RESERVES THE RIGHT TO ACCEPT OR REJECT ANY SUCH MATERIALS AND WORKMANSHIP THAT DOES NOT CONFORM TO ITS STANDARDS AND SPECIFICATIONS.
- 3. THE DEVELOPER OR HIS ENGINEER HAS LOCATED ALL FIRE HYDRANTS AND FUTURE SERVICE STUBS. ANY REQUIRED REALIGNMENT, EITHER HORIZONTAL OR VERTICAL, SHALL BE AT THE EXPENSE OF THE DEVELOPER.
- 4. ALL DUCTILE IRON PIPE, TO INCLUDE FITTINGS, VALVES AND FIRE HYDRANTS WILL BE WRAPPED WITH POLYETHYLENE TUBING, AND ELECTRICALLY ISOLATED.
- ALL DUCTILE IRON PIPE AND FITTINGS SHALL BE DOUBLE BONDED. SPECIFICATIONS FOR CATHODIC PROTECTION ON BOTH DIP MAINS AND PVC MAINS IS SPECIFIED IN THE STANDARDS AND SPECIFICATIONS.
- 6. PVC MAIN LINES SHALL BE INSTALLED WITH COATED NO. 12 TRACER WIRE.
- 7. THE CONTRACTOR IS REQUIRED TO NOTIFY THE WIDEFIELD WATER AND SANITATION DISTRICT (390-7111) A MINIMUM OF 48 HOURS AND A MAXIMUM OF 96 HOURS PRIOR TO THE START OF CONSTRUCTION. THE CONTRACTOR SHALL ALSO NOTIFY AFFECTED UTILITY COMPANIES 48 HOURS PRIOR TO CONSTRUCTION ADJACENT TO THE KNOWN UTILITY LINES.
- THE LOCATION OF ALL UTILITIES AS SHOWN ON THESE DRAWINGS ARE APPROXIMATE ONLY. THE LOCATION OF ALL UTILITIES SHALL BE VERIFIED PRIOR TO CONSTRUCTION BY THE CONTRACTOR.
- 9. THE CONTRACTOR SHALL FIELD EXCAVATE AND VERIFY THE VERTICAL AND HORIZONTAL LOCATION OF ALL TIE-INS. CONTRACTOR SHALL NOTIFY THE WIDEFIELD WATER AND SANITATION DISTRICT AND THE ENGINEER OF THE FIELD VERIFIED INFORMATION PRIOR TO CONSTRUCTION.
- 10. ALL BENDS SHALL BE FIELD STAKED PRIOR TO CONSTRUCTION.
- 11. ANY WATER UTILITY MATERIAL REMOVED AND NOT REUSED SHALL BE RETURNED TO THE WIDEFIELD WATER AND SANITATION DISTRICT IF THE DISTRICT SO REQUESTS.
- 12. THE CONTRACTOR SHALL AT HIS EXPENSE SUPPORT AND PROTECT ALL UTILITY MAINS SO THAT THEY WILL FUNCTION CONTINUOUSLY DURING CONSTRUCTION. SHOULD A UTILITY MAIN FAIL AS A RESULT OF THE CONTRACTOR'S OPERATION, IT WILL BE REPLACED IMMEDIATELY BY EITHER THE CONTRACTOR OR THE WIDEFIELD WATER AND SANITATION DISTRICT AT FULL COST OF LABOR AND MATERIALS TO THE CONTRACTOR.
- 13. ANY PUMPING OR BYPASS OPERATIONS MUST BE REVIEWED AND APPROVED PRIOR TO EXECUTION BY BOTH THE WIDEFIELD WATER AND SANITATION DISTRICT AND THE ENGINEER.
- 14. CONTRACTOR MUST REPLACE OR REPAIR ANY DAMAGE TO ALL SURFACE IMPROVEMENTS, INCLUDING BUT NOT LIMITED TO FENCES, CURB AND GUTTER AND/OR ASPHALT THAT MAY BE CAUSED DURING CONSTRUCTION.
- 15. ALL WATER LINES 6" AND LARGER, AND ALL SEWER LINES 8" AND LARGER, SHALL HAVE AS "AS-BUILT" PLANS PREPARED AND APPROVED PRIOR TO FINAL ACCEPTANCE BY THE WIDEFIELD WATER AND SANITATION DISTRICT
- 16. PRIOR TO CONSTRUCTION, A PRE-CONSTRUCTION CONFERENCE IS REQUIRED A MINIMUM OF 72 HOURS IN ADVANCE OF COMMENCEMENT OF WORK. TO SET THE PRE-CONSTRUCTION CONFERENCE, CONTACT ROB BANNISTER, DISTRICT ENGINEER AT (719) 390-7111 OF THE WIDEFIELD WATER AND SANITATION DISTRICT FOR A TIME. NO PRE-CONSTRUCTION CONFERENCE TIMES WILL BE SET UNTIL 4 SETS OF SIGNED DRAWINGS ARE RECEIVED BY THE WIDEFIELD W & S DISTRICT. PRE-CONSTRUCTION DATE/INITIALS

### ABBREVIATIONS

REFERENCE

DRAWINGS

| <u>· · · · · · · · · · · · · · · · · · · </u> |  |                   |
|---|--|-------------------|
| ASSY  | ASSEMBLY                               |                   |
| BOP   | BOTTOM OF PIPE                         |                   |
| BOV   | BLOWOFF ASSEMBLY AND VALVE             |                   |
| CPLG.   | COUPLING                               |                   |
| (INS.)  | (INSULATING)                           |                   |
| (RED.)  | (REDUCING)                             |                   |
| (STR.)  | (STRAIGHT)                             |                   |
| ČRA (   | CONCRETE REVERSE ANCHOR                |                   |
| CTRB  | CONCRETE THRUST REACTION BLOCK         | LEGEND            |
| DEFL  | DEFLECT                                |                   |
| DIP   | DUCTILE IRON PIPE                      |                   |
| EL.   | ELEVATION                              |                   |
| EX  | EXISTING                               | <u>N</u>          |
| FLG   | FLANGE                                 |                   |
| FH  | FIRE HYDRANT                           |                   |
| GPM   | GALLONS PER MINUTE                     | $\longrightarrow$ |
| GRD BRK                                       | V.P.I. GRADE BREAK                     | Ň                 |
| HYD ASSY                                      | INCLUDES FIRE HYDRANT, LATERAL, VALVE, |                   |
|   | TIE RODS, AND REVERSE ANCHOR.          | ]                 |
| INV   | INVERT                                 | <b>A</b>          |
| LT  | LEFT OF CENTER LINE                    | ~                 |
| MIN   | MINIMUM                                | <b>A</b>          |
| MJ  | MECHANICAL JOINT                       |                   |
| N,S,E,W                                       | NORTH,SOUTH,EAST,WEST                  |                   |
| PL  | PROPERTY LINE                          |                   |
| PSI   | POUNDS PER SQUARE INCH                 | ———— E-G          |
| PVC   | POLYVINYL CHLORIDE PIPE                | ———— E-W 8 ————   |
| RCP   | REINFORCED CONCRETE PIPE               |                   |
| RED   | REDUCER                                |                   |
| RSNTS   | MJ RESTRAINT (i.e. MEGALUG)            |                   |
| RT  | RIGHT OF CENTER LINE                   |                   |
| SJ  | SLIP JOINT                             |                   |
| SS  | SANITARY SEWER                         | E-SS 8            |
| STA   | STATION                                | 1 00 0            |
| STS   | STORM SEWER                            |                   |
| TOP   | TOP OF PIPE                            |                   |
| TYP   | TYPICAL                                |                   |
| WL  | WATER LINE                             | ()                |
|   |  |                   |

EL PASO COUNTY STANDARD CONSTRUCTION NOTES:

- 1. ALL DRAINAGE AND ROADWAY CONSTRUCTION SHALL MEET THE STANDARDS AND SPECIFICATIONS OF THE CITY OF COLORADO SPRINGS/EL PASO COUNTY DRAINAGE MANUAL
- 2. CONTRACTOR SHALL BE RESPONSIBLE FOR THE NOTIFICATION AND FIELD NOTIFICATION OF ALL EXISTING UTILITIES, WHETHER SHOWN ON THE PLANS OR NOT, BEFORE BEGINNING CONSTRUCTION. LOCATION OF EXISTING UTILITIES SHALL BE VERIFIED BY THE CONTRACTOR PRIOR TO CONSTRUCTION. CALL 811 TO CONTACT THE UTILITY NOTIFICATION CENTER OF COLORADO (UNCC).
- 3. CONTRACTOR SHALL KEEP A COPY OF THESE APPROVED PLANS, THE GRADING AND EROSION CONTROL PLAN, THE STORMWATER MANAGEMENT PLAN (SWMP), THE SOILS AND GEOTECHNICAL REPORT, AND THE APPROPRIATE DESIGN AND CONSTRUCTION STANDARDS AND SPECIFICATIONS AT THE JOB SITE AT ALL TIMES, INCLUDING THE FOLLOWING:
  - a. EL PASO COUNTY ENGINEERING CRITERIA MANUAL (ECM) b. CITY OF COLORADO SPRINGS/EL PASO COUNTY DRAINAGE CRITERIA MANUAL, VOLUMES 1 AND 2
  - c. COLORADO DEPARTMENT OF TRANSPORTATION (CDOT) STANDARD SPECIFICATIONS FOR ROAD AND BRIDGE CONSTRUCTION
- d. CDOT M & S STANDARDS 4. NOTWITHSTANDING ANYTHING DEPICTED IN THESE PLANS IN WORDS OR GRAPHIC REPRESENTATION, ALL DESIGN AND CONSTRUCTION RELATED TO ROADS, STORM DRAINAGE AND EROSION CONTROL SHALL CONFORM TO THE STANDARDS AND REQUIREMENTS OF THE MOST RECENT VERSION OF THE RELEVANT ADOPTED EL PASO COUNTY STANDARDS, INCLUDING THE LAND DEVELOPMENT CODE, THE ENGINEERING CRITERIA MANUAL, THE DRAINAGE CRITERIA MANUAL, AND THE DRAINAGE CRITERIA MANUAL VOLUME 2. ANY DEVIATIONS FROM REGULATIONS AND STANDARDS MUST BE REQUESTED, AND APPROVED, IN WRITING. ANY MODIFICATIONS NECESSARY TO MEET CRITERIA AFTER-THE-FACT WILL BE ENTIRELY THE DEVELOPER'S RESPONSIBILITY TO RECTIFY.
- 5. IT IS THE DESIGN ENGINEER'S RESPONSIBILITY TO ACCURATELY SHOW EXISTING CONDITIONS, BOTH ONSITE AND OFFSITE, ON THE CONSTRUCTION PLANS. ANY WILL BE ENTIRELY THE DEVELOPER'S RESPONSIBILITY TO RECTIFY.
- 6. CONTRACTOR SHALL SCHEDULE A PRE-CONSTRUCTION MEETING WITH EL PASO COUNTY PLANNING AND COMMUNITY DEVELOPMENT (PCD) - INSPECTIONS, PRIOR TO STARTING CONSTRUCTION.
- 7. IT IS THE CONTRACTOR'S RESPONSIBILITY TO UNDERSTAND THE REQUIREMENTS OF ALL LIMITED TO EL PASO COUNTY EROSION AND STORMWATER QUALITY CONTROL PERMIT ENGINEERS-ISSUED 401 AND/OR 404 PERMITS. AND COUNTY AND STATE FUGITIVE DUST PERMITS.
- 8. CONTRACTOR SHALL NOT DEVIATE FROM THE PLANS WITHOUT FIRST OBTAINING WRITTEN APPROVAL FROM THE DESIGN ENGINEER AND PCD. CONTRACTOR SHALL NOTIFY THE DESIGN ENGINEER IMMEDIATELY UPON DISCOVERY OF ANY ERRORS OR INCONSISTENCIES.
- 9. ALL STORM DRAIN PIPE SHALL BE CLASS III RCP UNLESS OTHERWISE NOTED AND APPROVED BY PCD.
- 10. CONTRACTOR SHALL COORDINATE GEOTECHNICAL TESTING PER ECM STANDARDS. PAVEMENT DESIGN SHALL BE APPROVED BY EL PASO COUNTY PCD PRIOR TO PLACEMENT OF CURB AND GUTTER AND PAVEMENT.
- 11. ALL CONSTRUCTION TRAFFIC MUST ENTER/EXIT THE SITE AT APPROVED CONSTRUCTION ACCESS POINTS.
- 12. SIGHT VISIBILITY TRIANGLES AS IDENTIFIED IN THE PLANS SHALL BE PROVIDED AT ALL ALLOWED WITHIN SIGHT TRIANGLES.
- 13. SIGNING AND STRIPING SHALL COMPLY WITH EL PASO COUNTY DOT AND MUTCO CRITERIA. [IF APPLICABLE, ADDITIONAL SIGNING AND STRIPING NOTES WILL BE PROVIDED.]
- 14. CONTRACTOR SHALL OBTAIN ANY PERMITS REQUIRED BY EL PASO COUNTY DOT, INCLUDING WORK WITHIN THE RIGHT-OF-WAY AND SPECIAL TRANSPORT PERMITS.
- 15. THE LIMITS OF CONSTRUCTION SHALL REMAIN WITHIN THE PROPERTY LINE UNLESS OTHERWISE NOTED. THE OWNER/DEVELOPER SHALL OBTAIN WRITTEN PERMISSION AND EASEMENTS, WHERE REQUIRED, FROM ADJOINING PROPERTY OWNER(S) PRIOR TO ANY OFF-SITE DISTURBANCE, GRADING, OR CONSTRUCTION.

| <u> </u>                  |                            | PROPOSED WATER                              |    |
|---------------------------|----------------------------|---|----|
|                           |                            | EXISTING STORM DRAIN                        |    |
|                           |                            | PROPOSED STORM DRAIN                        |    |
|                           | ———— E—SS 8 ————           | EXISTING SAN. SEWER                         |    |
| _                         |                            | PROPOSED SAN. SEWER                         |    |
|                           |                            | EXISTING MANHOLE                            |    |
|                           |                            | PROPOSED MANHOLE                            |    |
| _                         |                            | MATCHLINE                                   |    |
|                           |                            |   |    |
|                           |                            |   |    |
|                           |                            |   |    |
|                           |                            |   |    |
|                           |                            |   |    |
|                           |                            |   |    |
|                           |                            | DESCRIPTION                                 | BY |
|                           | REVIS                      | SIONS                                       |    |
|                           | -                          |   |    |
| E MANAGEMENT              |                            |   |    |
| 3 038 (Trails E6)\100 Dwg | 101 Plan Sete\Construction | Plane/Litility Plane/Sanitary Plan/GN01 dwg |    |

VALVE (PROPOSED) VALVE (EXISTING) **BLOWOFF (PROPOSED)** BLOWOFF (EXISTING)

PLUG (PROPOSED)

EXISTING FIRE HYDRANT

PROPOSED FIRE HYDRANT

PLUG (EXISTING)

PROPERTY LINE

EXISTING WATER

EXISTING GAS MAIN

CURB LINE

COMPUTER FILE FILE NAME: S:\21.886.038 (Trails F6)\100 Dwg\104 Plan Sets\Construction Plans\Utility Plans\Sanitary Plan\GN01.dwg

CTB FILE: Matrix(black).ctb PLOT DATE: August 3, 2022 1:18:28 PM

No. DATE


THIS DRAWING IS CURRENT AS OF PLOT DATE AND MAY BE SUBJECT TO CHANGE.

CRITERIA MANUAL, VOLUMES 1 AND 2, AND THE EL PASO COUNTY ENGINEERING CRITERIA

MODIFICATIONS NECESSARY DUE TO CONFLICTS, OMISSIONS, OR CHANGED CONDITIONS

JURISDICTIONAL AGENCIES AND TO OBTAIN ALL REQUIRED PERMITS, INCLUDING BUT NOT (ESQCP), REGIONAL BUILDING FLOODPLAIN DEVELOPMENT PERMIT, U.S. ARMY CORPS OF

INTERSECTIONS. OBSTRUCTIONS GREATER THAN 18 INCHES ABOVE FLOWLINE ARE NOT

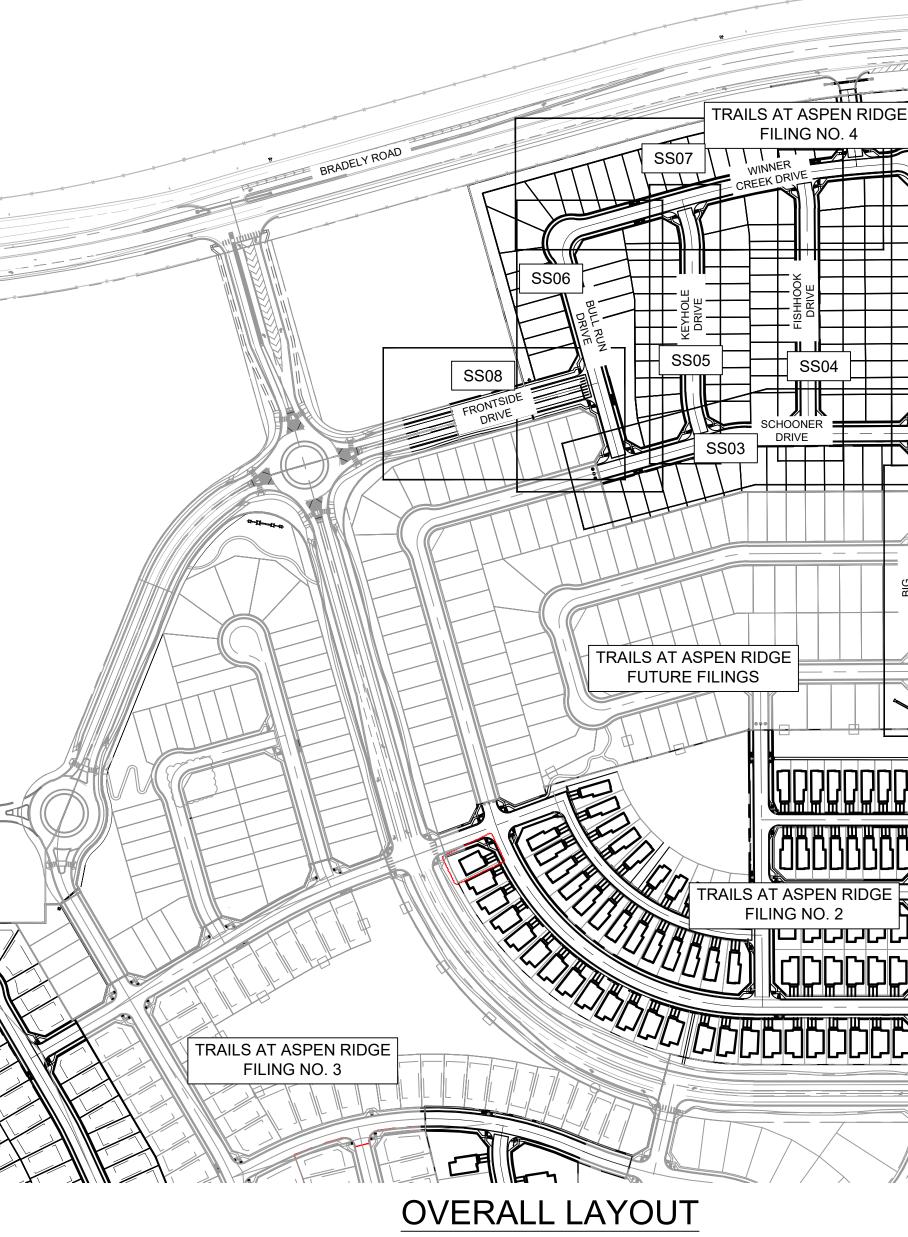

SCALE: 1" = 200'

| Y | SHEET KEY | BENCHMARK   COLORADO SPRINGS UTILITIES (FIMS) MONUMENT F206   A BERNTSEN TOP SECURITY MONUMENT SYSTEM WITH A 3.5-INCH DIAMETER ALUMINUM CAP IN A   ROAD BOX, LOCATED ON THE NORTHWEST CORNER OF FONTAINE BOULEVARD AND POWERS   BOULEVARD,   ELEVATION - 5897.89' U.S. SURVEY FT   BASIS OF BEARING   BEARINGS ARE BASED ON THE NORTH LINE OF THE NORTHWEST QUARTER OF SECTION 9,   TOWNSHIP 15 SOUTH, RANGE 65 WEST OF THE 6TH P.M. SAID LINE BEARS S89°51'23"E FROM THE   NORTHWEST CORNER OF SAID SECTION 9 (2 ½" AULM. CAP PLS 17664) TO THE N ¼ CORNER OF SAID   SECTION 9 (3 ¼" AULM. CAP PLS 10377) | PREPARED BY:<br>V\@_lagae and Bending\Lagae Matrin Design GroupT\Vierkender\Standard\Watrin Hertannial Color R88.jog |
|---|-----------|--|--|
|   | E         |  |  |



| UTILITY CROSSING DETAILS |                         |                         |                          |           |  |  |  |
|--------------------------|-------------------------|-------------------------|--------------------------|-----------|--|--|--|
| CROSSING<br>#            | N & E                   | TOP OF PIPE             | BTM OF PIPE              | VERT. SEP |  |  |  |
| 1                        | N 7719.33<br>E 13971.45 | 8" PVC SEWER<br>5868.79 | 18" RCP STORM<br>5871.66 | 2.87'     |  |  |  |
| 2                        | N 7719.50<br>E 13999.37 | 8" PVC SEWER<br>5868.51 | 30" RCP STORM<br>5870.32 | 1.81'     |  |  |  |
| 3                        | N 7729.56<br>E 14010.51 | 8" PVC SEWER<br>5868.48 | 8" PVC WATER<br>5875.04  | 6.56'     |  |  |  |
| 4                        | N 7955.64<br>E 14009.11 | 8" PVC SEWER<br>5870.25 | 24" RCP STORM<br>5880.25 | 10.00'    |  |  |  |
| 5                        | N 7966.50<br>E 13968.99 | 8" PVC SEWER<br>5871.04 | 24" RCP STORM<br>5881.02 | 9.98'     |  |  |  |
| 6                        | N 7966.69<br>E 13998.38 | 8" PVC SEWER<br>5870.75 | 30" RCP STORM<br>5881.03 | 10.28'    |  |  |  |
| 7                        | N 7976.74<br>E 14008.98 | 8" PVC SEWER<br>5870.69 | 8" PVC WATER<br>5885.18  | 14.49'    |  |  |  |
| 8                        | N 8225.22<br>E 14007.48 | 8" PVC SEWER<br>5872.23 | 8" PVC WATER<br>5891.28  | 19.05'    |  |  |  |
| 9                        | N 8214.67<br>E 13916.16 | 8" PVC SEWER<br>5873.93 | 24" RCP STORM<br>5891.37 | 17.44'    |  |  |  |
| 10                       | N 8210.47<br>E 13608.46 | 8" PVC SEWER<br>5884.38 | 30" RCP STORM<br>5893.69 | 9.31'     |  |  |  |
| 11                       | N 8223.77<br>E 13767.48 | 8" PVC SEWER<br>5877.12 | 8" PVC WATER<br>5891.88  | 14.76'    |  |  |  |
| 12                       | N 8204.91<br>E 13546.71 | 8" PVC SEWER<br>5887.65 | 8" PVC WATER<br>5894.12  | 6.47'     |  |  |  |
| 13                       | N 8156.91<br>E 13375.46 | 8" PVC SEWER<br>5889.40 | 8" PVC WATER<br>5895.90  | 6.50'     |  |  |  |
| 14                       | N 8330.13<br>E 13326.92 | 8" PVC SEWER<br>5893.97 | 12" PVC WATER<br>5900.08 | 6.11'     |  |  |  |
| 15                       | N 8641.09<br>E 13287.58 | 8" PVC SEWER<br>5898.76 | 8" PVC WATER<br>5906.56  | 7.80'     |  |  |  |
| 16                       | N 8704.16<br>E 13512.68 | 8" PVC SEWER<br>5891.60 | 8" PVC WATER<br>5898.29  | 6.69'     |  |  |  |
| 17                       | N 8758.76<br>E 13765.98 | 8" PVC SEWER<br>5880.34 | 8" PVC WATER<br>5888.74  | 8.40'     |  |  |  |

SS02 SS01 

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THE WIDEFIELD WATER AND SANITATION DISTRICT RECOGNIZES THE DESIGN ENGINEER AS HAVING RESPONSIBILITY FOR THE DESIGN AND HAS LIMITED ITS SCOPE OF REVIEW ACCORDINGLY.

#### WIDEFIELD WATER AND SANITATION DISTRICT WATER DESIGN APPROVAL

BY: DATE:

**PROJECT NUMBER:** 

IN CASE OF ERRORS OR OMISSIONS WITH THE WATER DESIGN AS SHOWN ON THIS DOCUMENT THE STANDARDS AS DEFINED IN THE "RULES AND REGULATIONS" FOR INSTALLATION OF WATER MAINS AND SERVICES" SHALL RULE.

APPROVAL EXPIRES 180 DAYS FROM DESIGN APPROVAL

# TRAILS AT ASPEN RIDGE


SF-21-02

FILING NO. 4 **8" SANITARY SEWER PLANS** 

# GENERAL NOTES, LEGEND & ABBREVIATIONS

| FOR AND ON BEHALF OF      |  |
|---------------------------|--|
| MATRIX DESIGN GROUP, INC. |  |
| PROJECT No. 21.886.038    |  |
|                           |  |


SCALE \_\_\_\_ DATE ISSUED: DESIGNED BY: BAS JUNE 2022 DRAWING No. JLW DRAWN BY: HORIZ. GN01 2 OF 12 SHEET CHECKED BY: NMS VERT. N/A

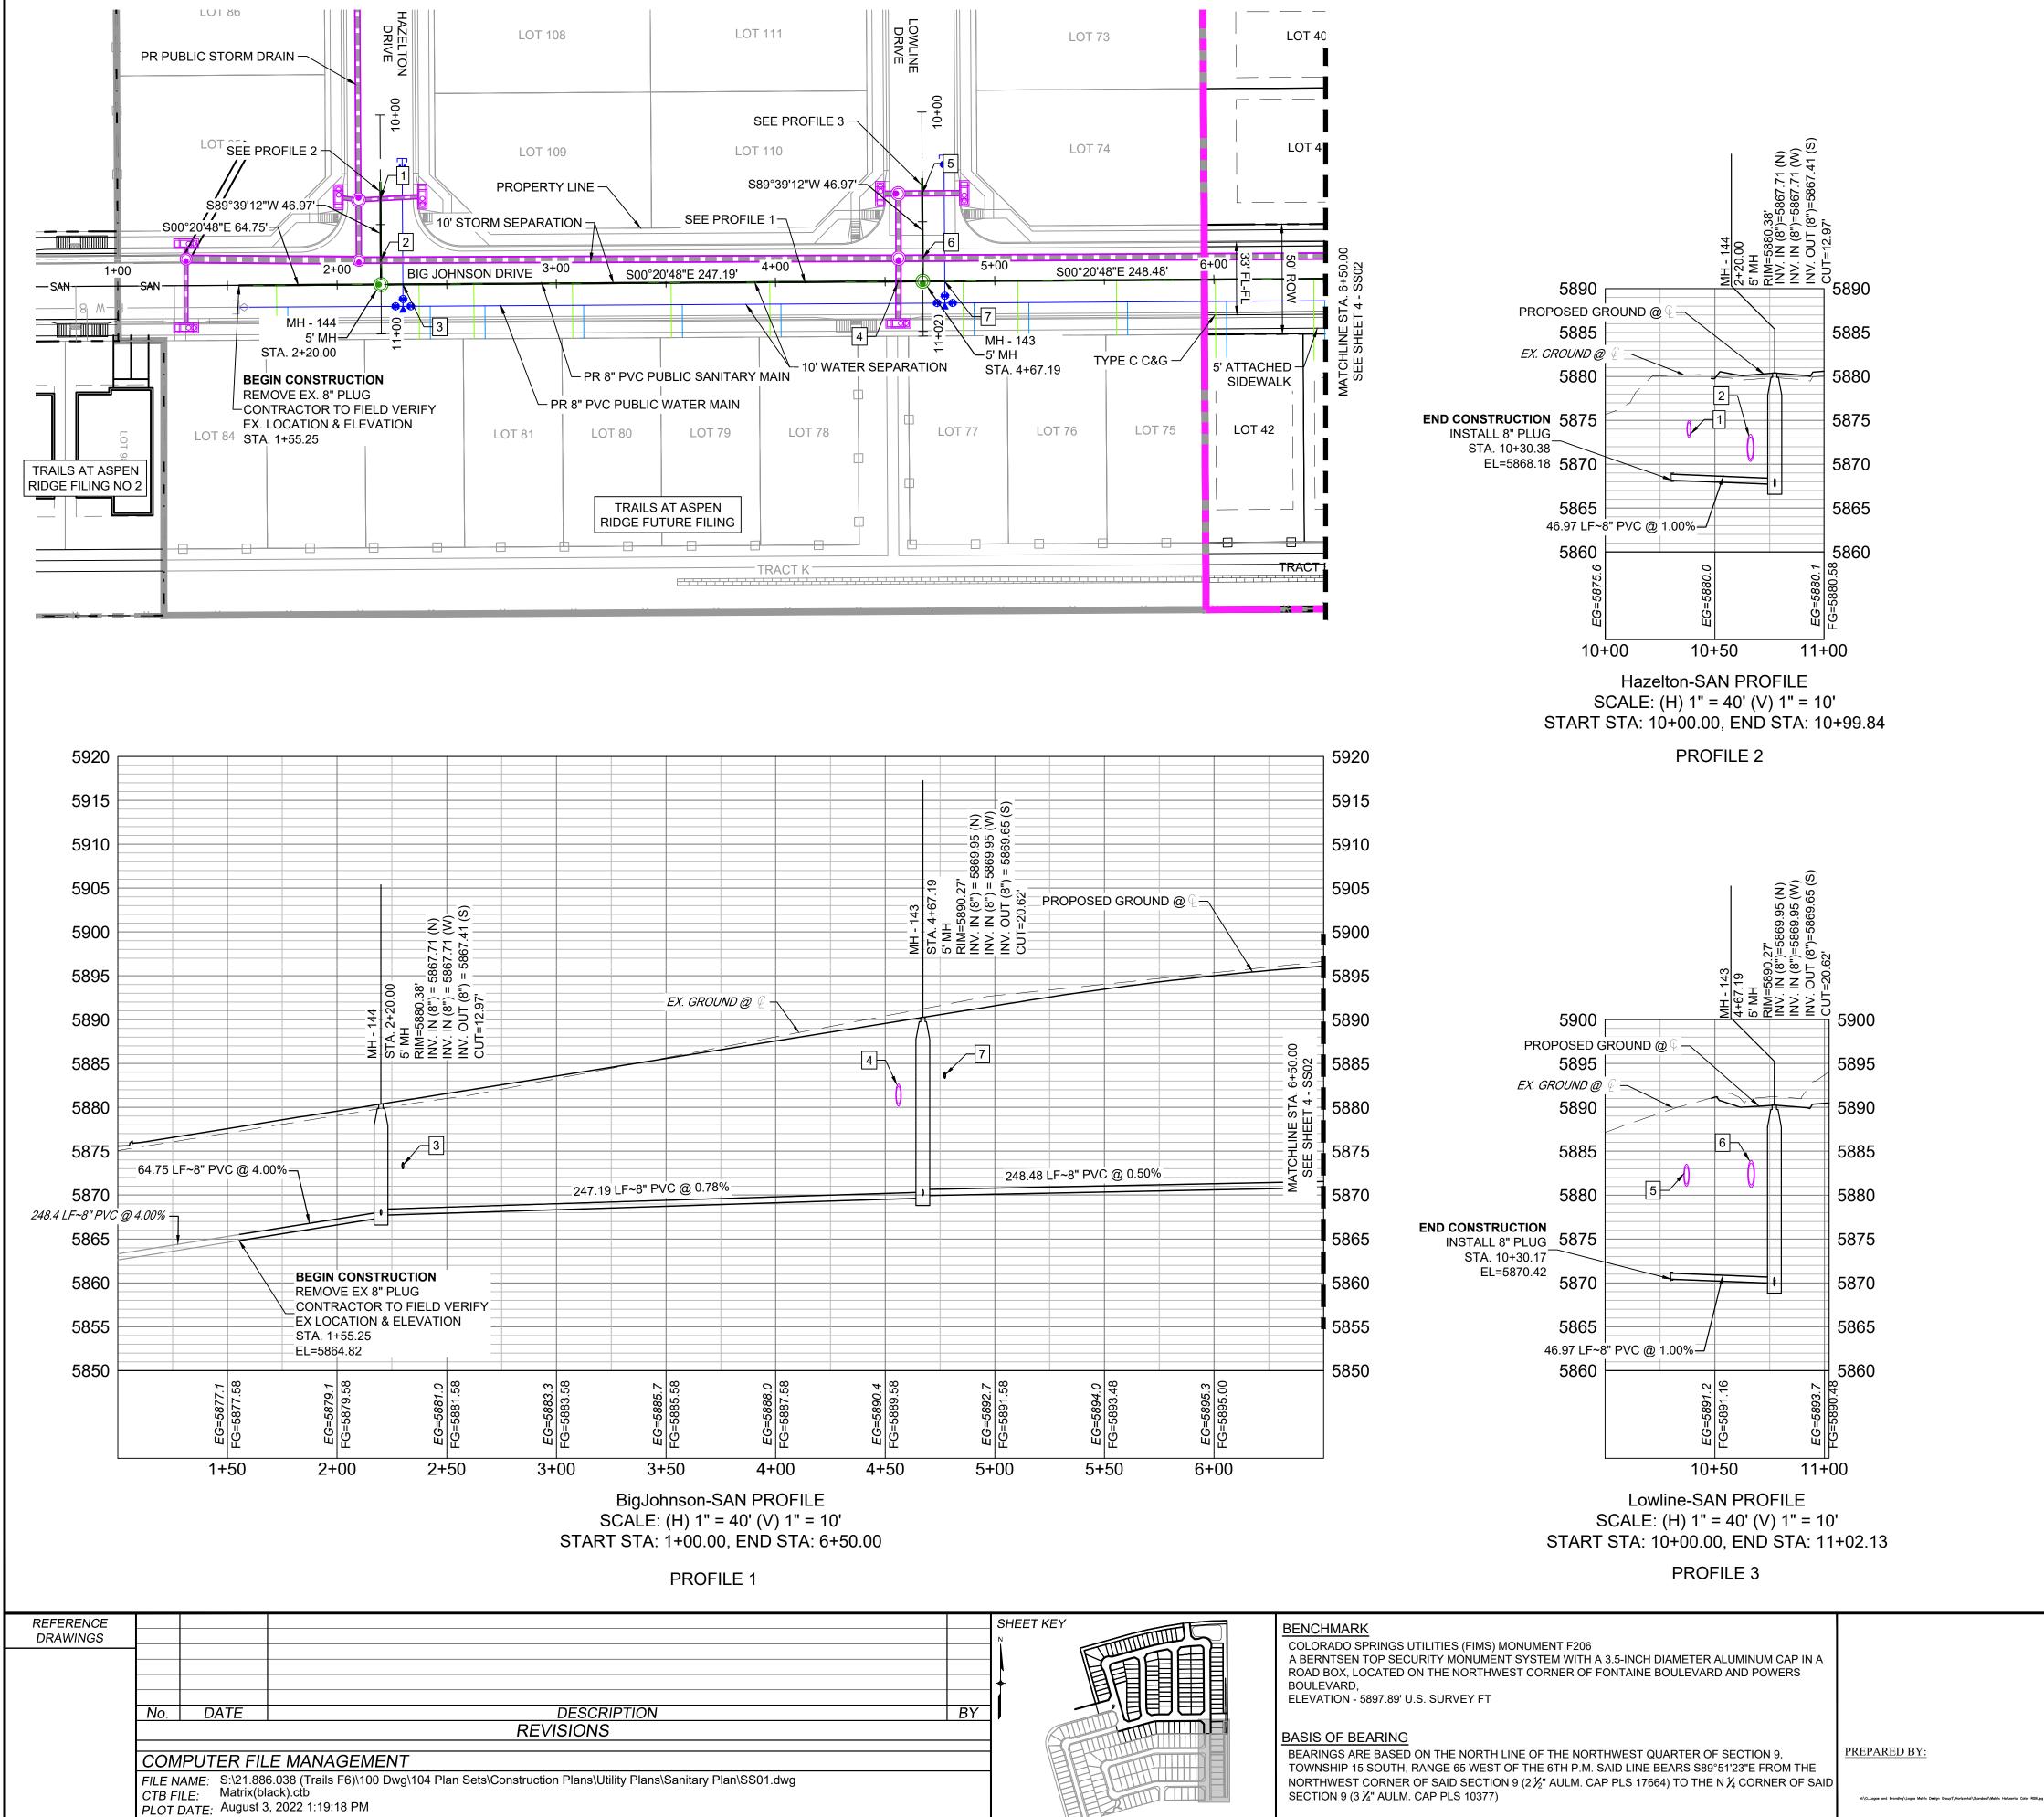


THIS DRAWING IS CURRENT AS OF PLOT DATE AND MAY BE SUBJECT TO CHANGE.



| UTILITY CROSSING DETAILS |                         |                         |                          |            |  |  |  |  |
|--------------------------|-------------------------|-------------------------|--------------------------|------------|--|--|--|--|
| CROSSING<br>#            | N & E                   | TOP OF PIPE             | BTM OF PIPE              | VERT. SEP. |  |  |  |  |
| 1                        | N 7719.33<br>E 13971.45 | 8" PVC SEWER<br>5868.79 | 18" RCP STORM<br>5873.06 | 4.27'      |  |  |  |  |
| 2                        | N 7719.50<br>E 13999.37 | 8" PVC SEWER<br>5868.51 | 30" RCP STORM<br>5870.32 | 1.81'      |  |  |  |  |
| 3                        | N 7729.56<br>E 14010.51 | 8" PVC SEWER<br>5868.48 | 8" PVC WATER<br>5873.00  | 4.52'      |  |  |  |  |
| 4                        | N 7955.64<br>E 14009.11 | 8" PVC SEWER<br>5870.25 | 24" RCP STORM<br>5880.25 | 10.00'     |  |  |  |  |
| 5                        | N 7966.50<br>E 13968.99 | 8" PVC SEWER<br>5871.04 | 24" RCP STORM<br>5881.02 | 9.98'      |  |  |  |  |
| 6                        | N 7966.69<br>E 13998.38 | 8" PVC SEWER<br>5870.75 | 30" RCP STORM<br>5880.86 | 10.11'     |  |  |  |  |
| 7                        | N 7976.74<br>E 14008.98 | 8" PVC SEWER<br>5870.69 | 8" PVC WATER<br>5883.32  | 12.63'     |  |  |  |  |

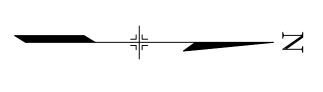

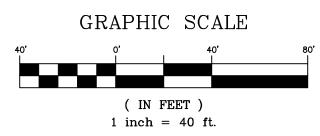

THE LOCATIONS OF EXISTING ABOVE GROUND AND UNDERGROUND UTILITIES ARE SHOWN IN AN APPROXIMATE WAY ONLY. THE CONTRACTOR SHALL DETERMINE THE EXACT LOCATION OF ALL EXISTING UTILITIES BEFORE COMMENCING WORK. THE CONTRACTOR SHALL BE FULLY RESPONSIBLE FOR ANY AND ALL DAMAGES WHICH MIGHT BE CAUSED BY HIS FAILURE TO EXACTLY LOCATE AND PRESERVE ANY AND ALL ABOVE GROUND AND UNDERGROUND UTILITIES.

THE WIDEFIELD WATER AND SANITATION DISTRICT RECOGNIZES THE DESIGN ENGINEER AS HAVING RESPONSIBILITY FOR THE DESIGN AND HAS LIMITED ITS SCOPE OF REVIEW ACCORDINGLY.

> WIDEFIELD WATER AND SANITATION DISTRICT WASTEWATER DESIGN APPROVAL

> > BY:


DATE:

**PROJECT NUMBER**:

IN CASE OF ERRORS OR OMISSIONS WITH THE WATER DESIGN AS SHOWN ON THIS DOCUMENT THE STANDARDS AS DEFINED IN THE "RULES AND REGULATIONS FOR INSTALLATION OF WASTEWATER MAINS AND SERVICES" SHALL RULE.

APPROVAL EXPIRES 180 DAYS FROM DESIGN APPROVAL


SF-21-0

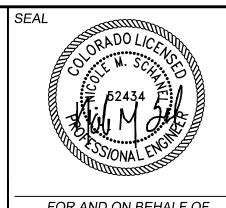


# TRAILS AT ASPEN RIDGE

FILING NO. 4 **8" SANITARY SEWER PLANS** 

| FOR AND ON BEHALF OF      | DESIGNED BY: | BAS | SC.    | ALE      | DATE ISSUED: | JUNE 2022 | DRAWING No. |
|---------------------------|--------------|-----|--------|----------|--------------|-----------|-------------|
| MATRIX DESIGN GROUP, INC. | DRAWN BY:    | JLW | HORIZ. | 1" = 40' |              |           | SS01        |
| PROJECT No. 21.886.038    | CHECKED BY:  | NMS | VERT.  | 1" = 10' | SHEET        | 3 OF 12   | 3301        |
|                           |              |     |        |          |              |           |             |

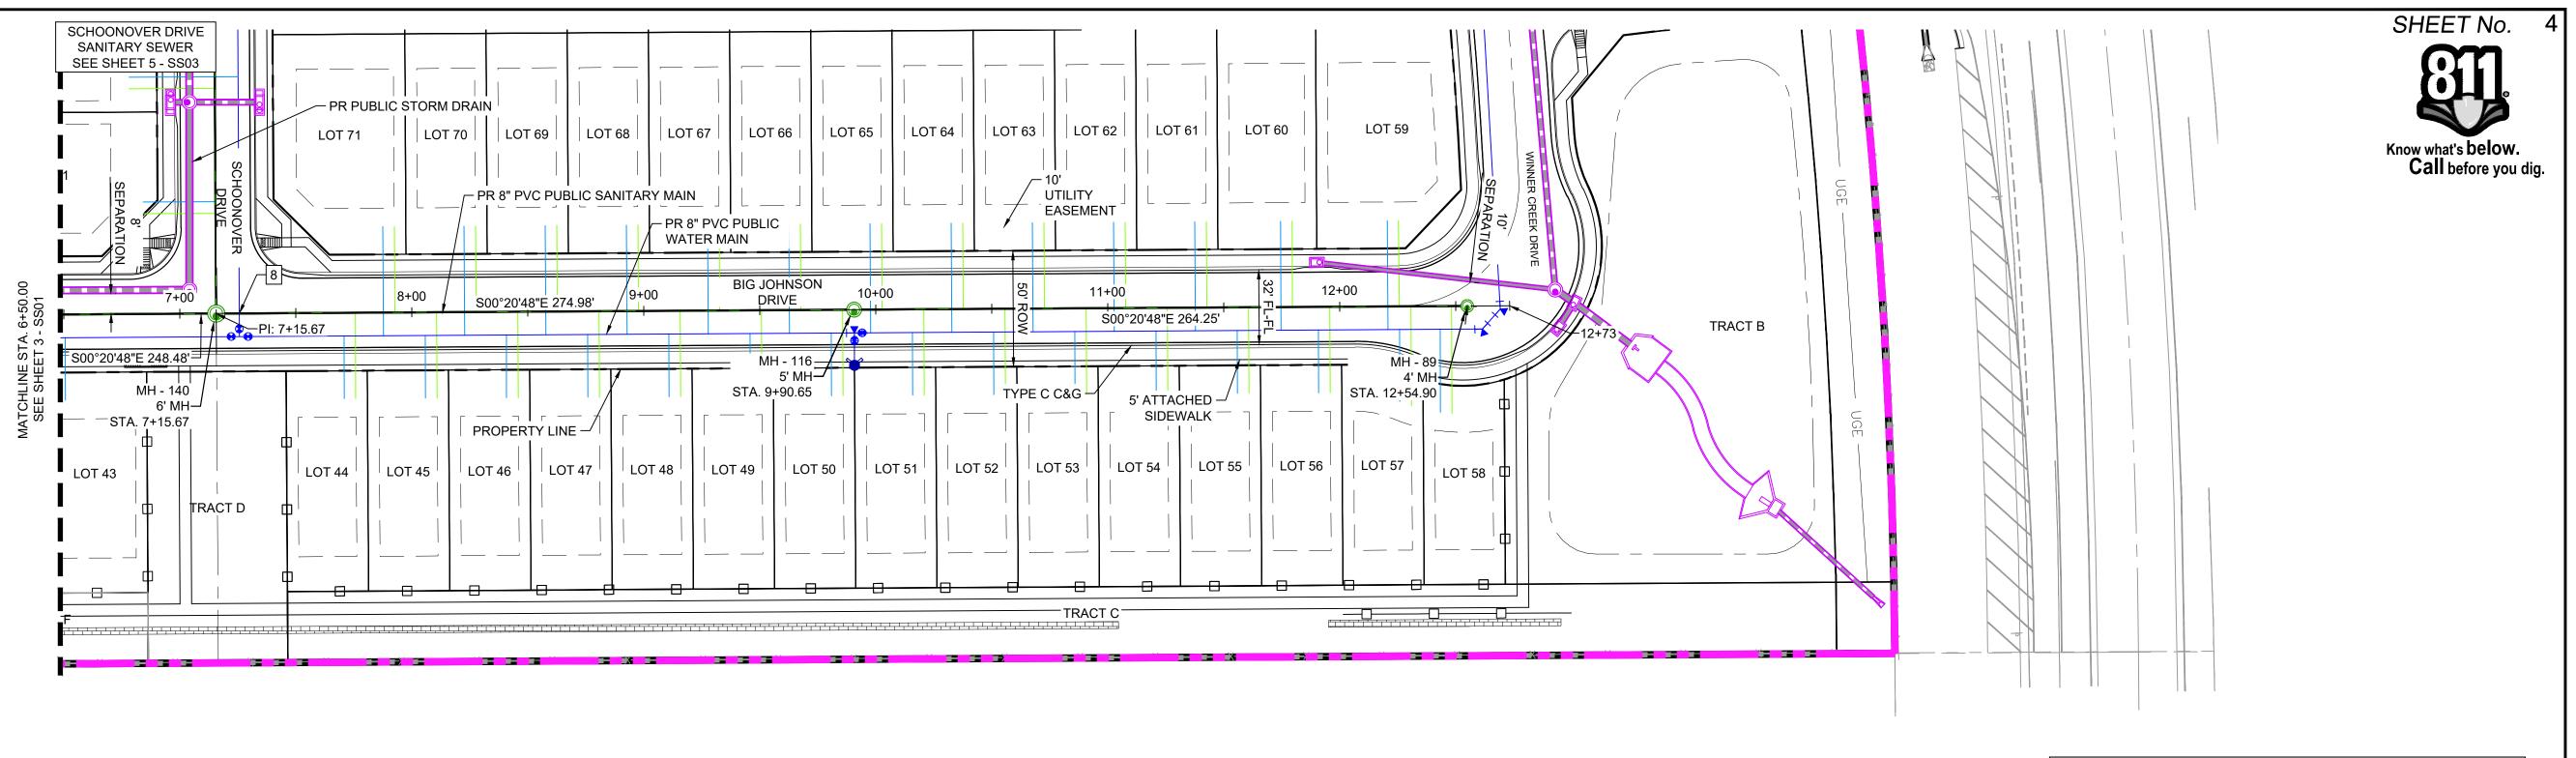

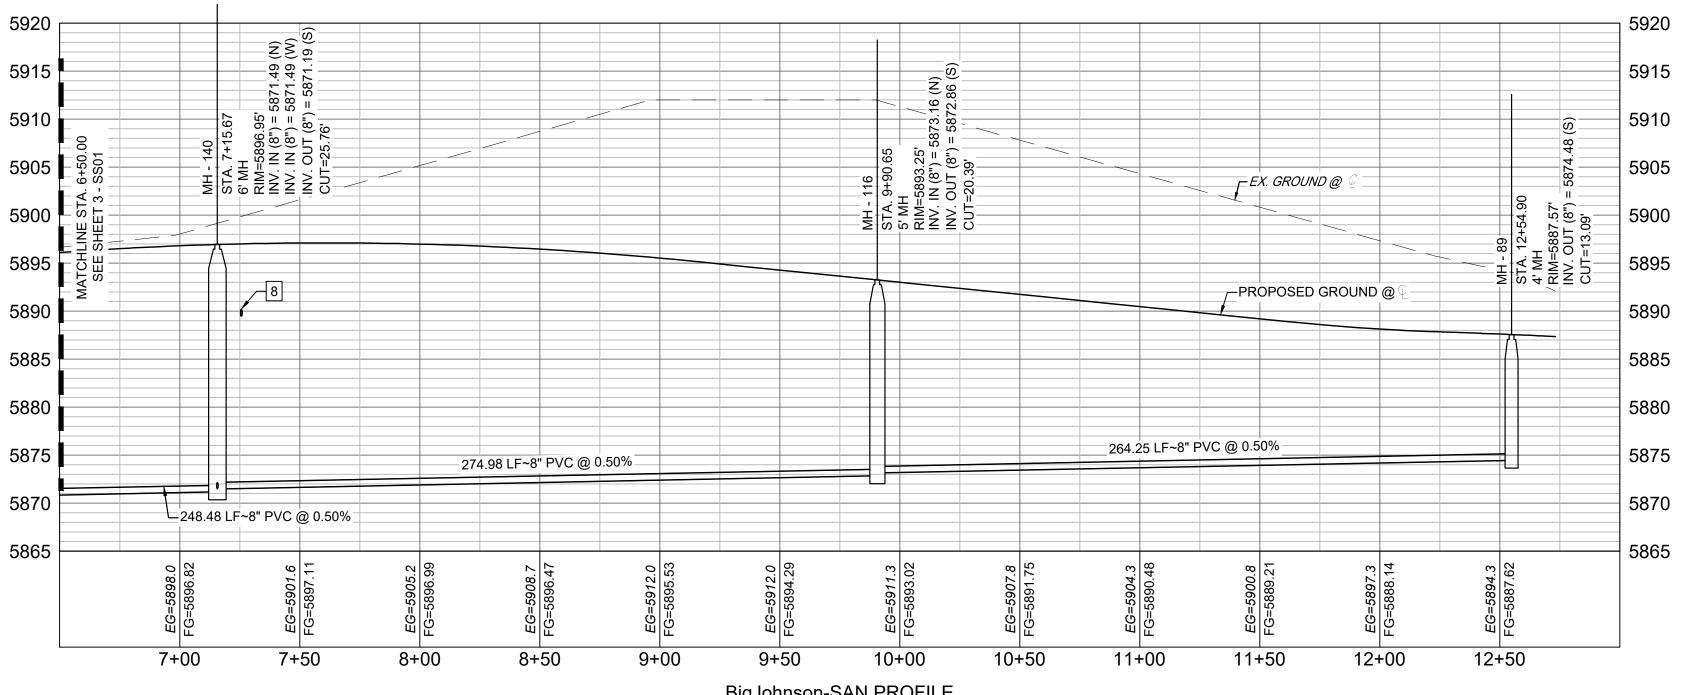



| REFERENCE |                            |                |   |    |
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|           | FILE N<br>CTB FI<br>PLOT I | u ⊢· Matrix(bl | 6.038 (Trails F6)\100 Dwg\104 Plan Sets\Construction Plans\Utility Plans\Sanitary Plan\SS01.dwg<br>ack).ctb<br>9, 2022 1:19:30 PM |    |
|           |                            |                | S OF PLOT DATE AND MAY BE SUBJECT TO CHANGE.  |    |

BigJohnson-SAN PROFILE SCALE: (H) 1" = 40' (V) 1" = 10' START STA: 6+50.00, END STA: 13+00.00

| SHEET KEY | BENCHMARK<br>COLORADO SPRINGS UTILITIES (FIMS) MONUMENT F206<br>A BERNTSEN TOP SECURITY MONUMENT SYSTEM WITH A 3.5-INCH DIAMETER ALUMINUM CAP IN A<br>ROAD BOX, LOCATED ON THE NORTHWEST CORNER OF FONTAINE BOULEVARD AND POWERS<br>BOULEVARD,<br>ELEVATION - 5897.89' U.S. SURVEY FT   |   |
|-----------|---|---|
|           | BASIS OF BEARING<br>BEARINGS ARE BASED ON THE NORTH LINE OF THE NORTHWEST QUARTER OF SECTION 9,<br>TOWNSHIP 15 SOUTH, RANGE 65 WEST OF THE 6TH P.M. SAID LINE BEARS S89°51'23"E FROM THE<br>NORTHWEST CORNER OF SAID SECTION 9 (2 $\frac{1}{2}$ " AULM. CAP PLS 17664) TO THE N $\frac{1}{4}$ CORNER OF SAID<br>SECTION 9 (3 $\frac{1}{4}$ " AULM. CAP PLS 10377) | PREPARED BY:<br>W\Q_Logue and Brunding\Logue Mairix Design Group?(Verisental\Standard\Mairis Harizantal Color ROB.gog |

| UTILITY CROSSING DETAILS |                         |                         |                         |            |  |  |  |
|--------------------------|-------------------------|-------------------------|-------------------------|------------|--|--|--|
| CROSSING<br>#            | N & E                   | TOP OF PIPE             | BTM OF PIPE             | VERT. SEP. |  |  |  |
| 8                        | N 8225.22<br>E 14007.48 | 8" PVC SEWER<br>5872.23 | 8" PVC WATER<br>5889.66 | 17.43'     |  |  |  |

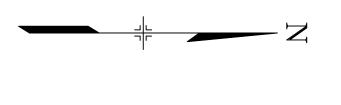

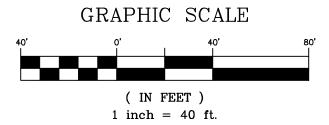

THE LOCATIONS OF EXISTING ABOVE GROUND AND UNDERGROUND UTILITIES ARE SHOWN IN AN APPROXIMATE WAY ONLY. THE CONTRACTOR SHALL DETERMINE THE EXACT LOCATION OF ALL EXISTING UTILITIES BEFORE COMMENCING WORK. THE CONTRACTOR SHALL BE FULLY RESPONSIBLE FOR ANY AND ALL DAMAGES WHICH MIGHT BE CAUSED BY HIS FAILURE TO EXACTLY LOCATE AND PRESERVE ANY AND ALL ABOVE GROUND AND UNDERGROUND UTILITIES.

THE WIDEFIELD WATER AND SANITATION DISTRICT RECOGNIZES THE DESIGN ENGINEER AS HAVING RESPONSIBILITY FOR THE DESIGN AND HAS LIMITED ITS SCOPE OF REVIEW ACCORDINGLY.

#### WIDEFIELD WATER AND SANITATION DISTRICT WASTEWATER DESIGN APPROVAL


DATE: \_\_\_\_\_ BY:

PROJECT NUMBER:

IN CASE OF ERRORS OR OMISSIONS WITH THE WATER DESIGN AS SHOWN ON THIS DOCUMENT THE STANDARDS AS DEFINED IN THE "RULES AND REGULATIONS FOR INSTALLATION OF WASTEWATER MAINS AND SERVICES" SHALL RULE.

APPROVAL EXPIRES 180 DAYS FROM DESIGN APPROVAL

SF-21-024

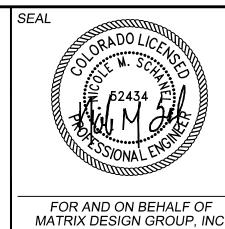


# TRAILS AT ASPEN RIDGE

FILING NO. 4

8" SANITARY SEWER PLANS

| FOR AND ON BEHALF OF      | DESIGNED BY: | BAS | SCA    | LE       | DATE ISSUED: | JUNE 2022 | DRAWING No. |
|---------------------------|--------------|-----|--------|----------|--------------|-----------|-------------|
| MATRIX DESIGN GROUP, INC. | DRAWN BY:    | JLW | HORIZ. | 1" = 40' |              |           | SS02        |
| PROJECT No. 21.886.038    | CHECKED BY:  | NMS | VERT.  | 1" = 10' | SHEET        | 4 OF 12   | 5502        |
|                           |              |     |        |          |              |           |             |

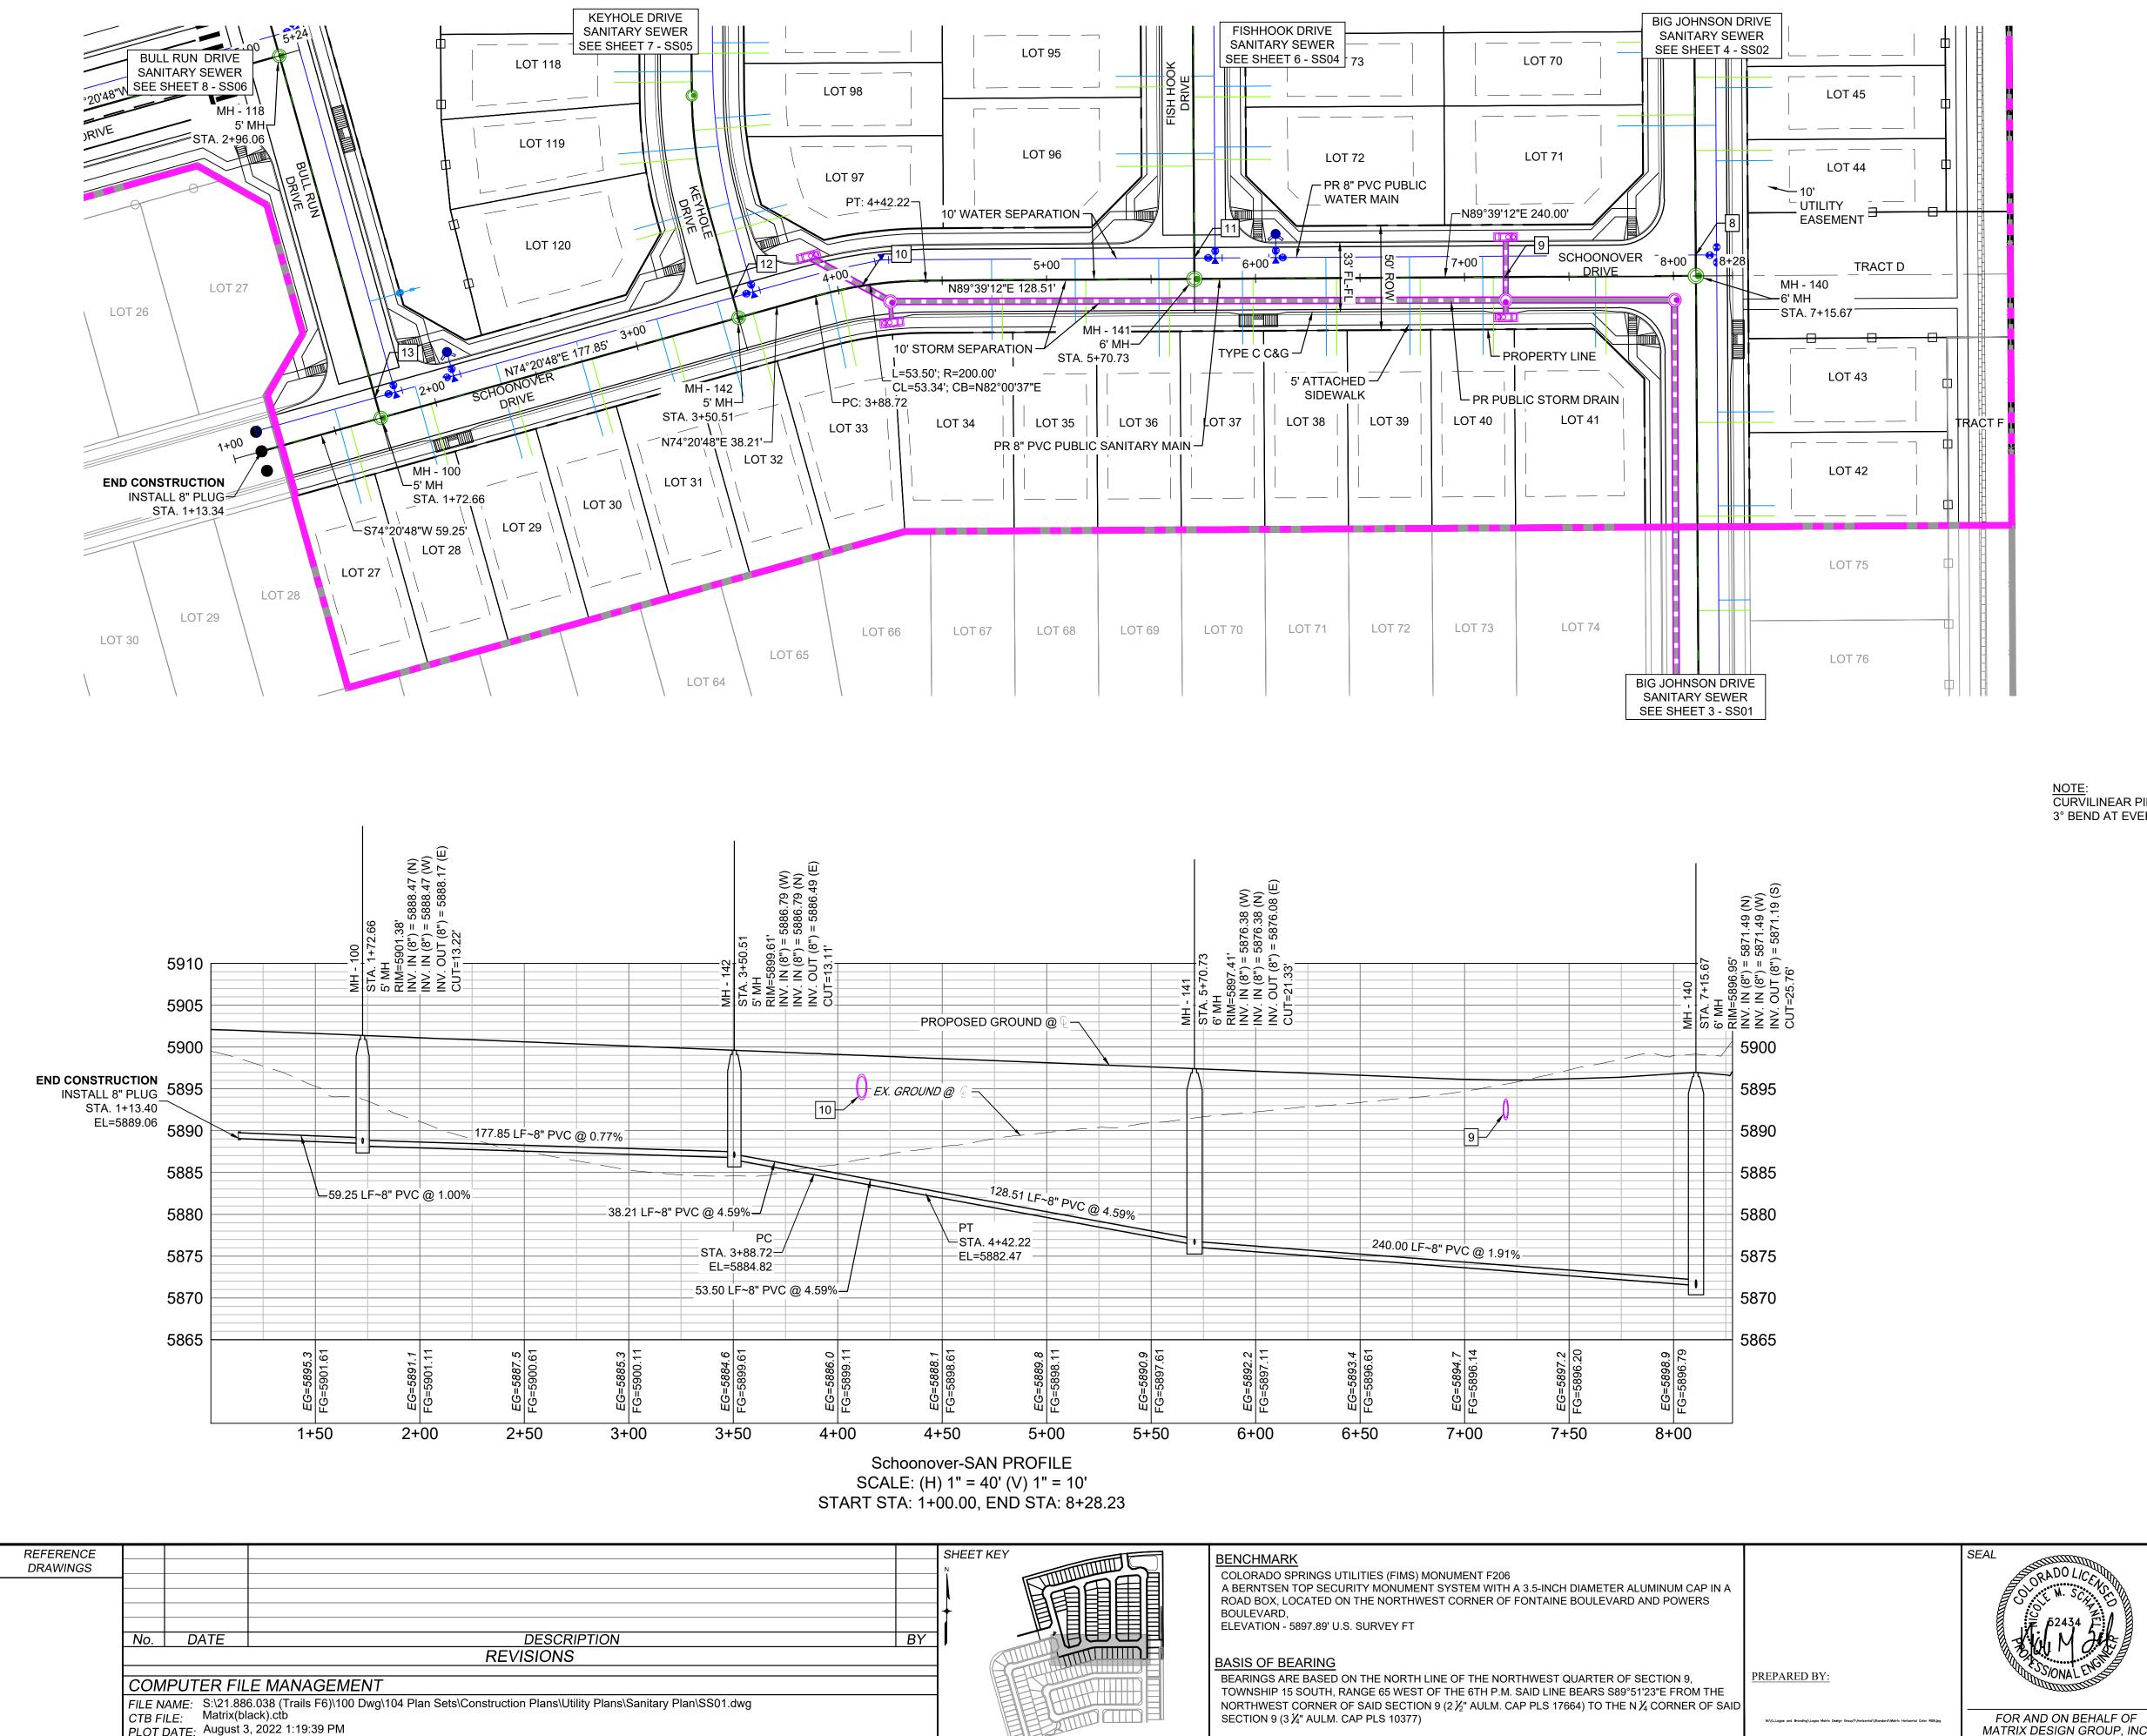


PLOT DATE: August 3, 2022 1:19:39 PM

THIS DRAWING IS CURRENT AS OF PLOT DATE AND MAY BE SUBJECT TO CHANGE.



#### UTILITY CROSSING DETAILS CROSSING TOP OF PIPE BTM OF PIPE VERT. SEP. N & E # 8" PVC SEWER 24" RCP STORM N 8214.67 17.44' 9 E 13916.16 5873.93 5891.37 N 8210.47 8" PVC SEWER 30" RCP STORM 10 9.31' E 13608.46 5884.38 5893.69

CURVILINEAR PIPE TO BE ACHIEVED USING 3° BEND AT EVERY OTHER JOINT.

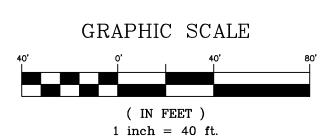

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#### WIDEFIELD WATER AND SANITATION DISTRICT WASTEWATER DESIGN APPROVAL

BY

DATE:

**PROJECT NUMBER:** 

IN CASE OF ERRORS OR OMISSIONS WITH THE WATER DESIGN AS SHOWN ON THIS DOCUMENT THE STANDARDS AS DEFINED IN THE "RULES AND REGULATIONS FOR INSTALLATION OF WASTEWATER MAINS AND SERVICES" SHALL RULE.


APPROVAL EXPIRES 180 DAYS FROM DESIGN APPROVAL


SF-21-0

# TRAILS AT ASPEN RIDGE

FILING NO. 4 **8" SANITARY SEWER PLANS** 

| FOR AND ON BEHALF OF                                | DESIGNED BY:             | BAS        | SCA             | \LE                  | DATE ISSUED: | JUNE 2022 | DRAWING No. |
|---|--------------------------|------------|-----------------|----------------------|--------------|-----------|-------------|
| MATRIX DESIGN GROUP, INC.<br>PROJECT No. 21.886.038 | DRAWN BY:<br>CHECKED BY: | JLW<br>NMS | HORIZ.<br>VERT. | 1" = 40'<br>1" = 10' | SHEET        | 5 OF 12   | SS03        |
|   |                          |            | VEITI.          |                      |              |           |             |

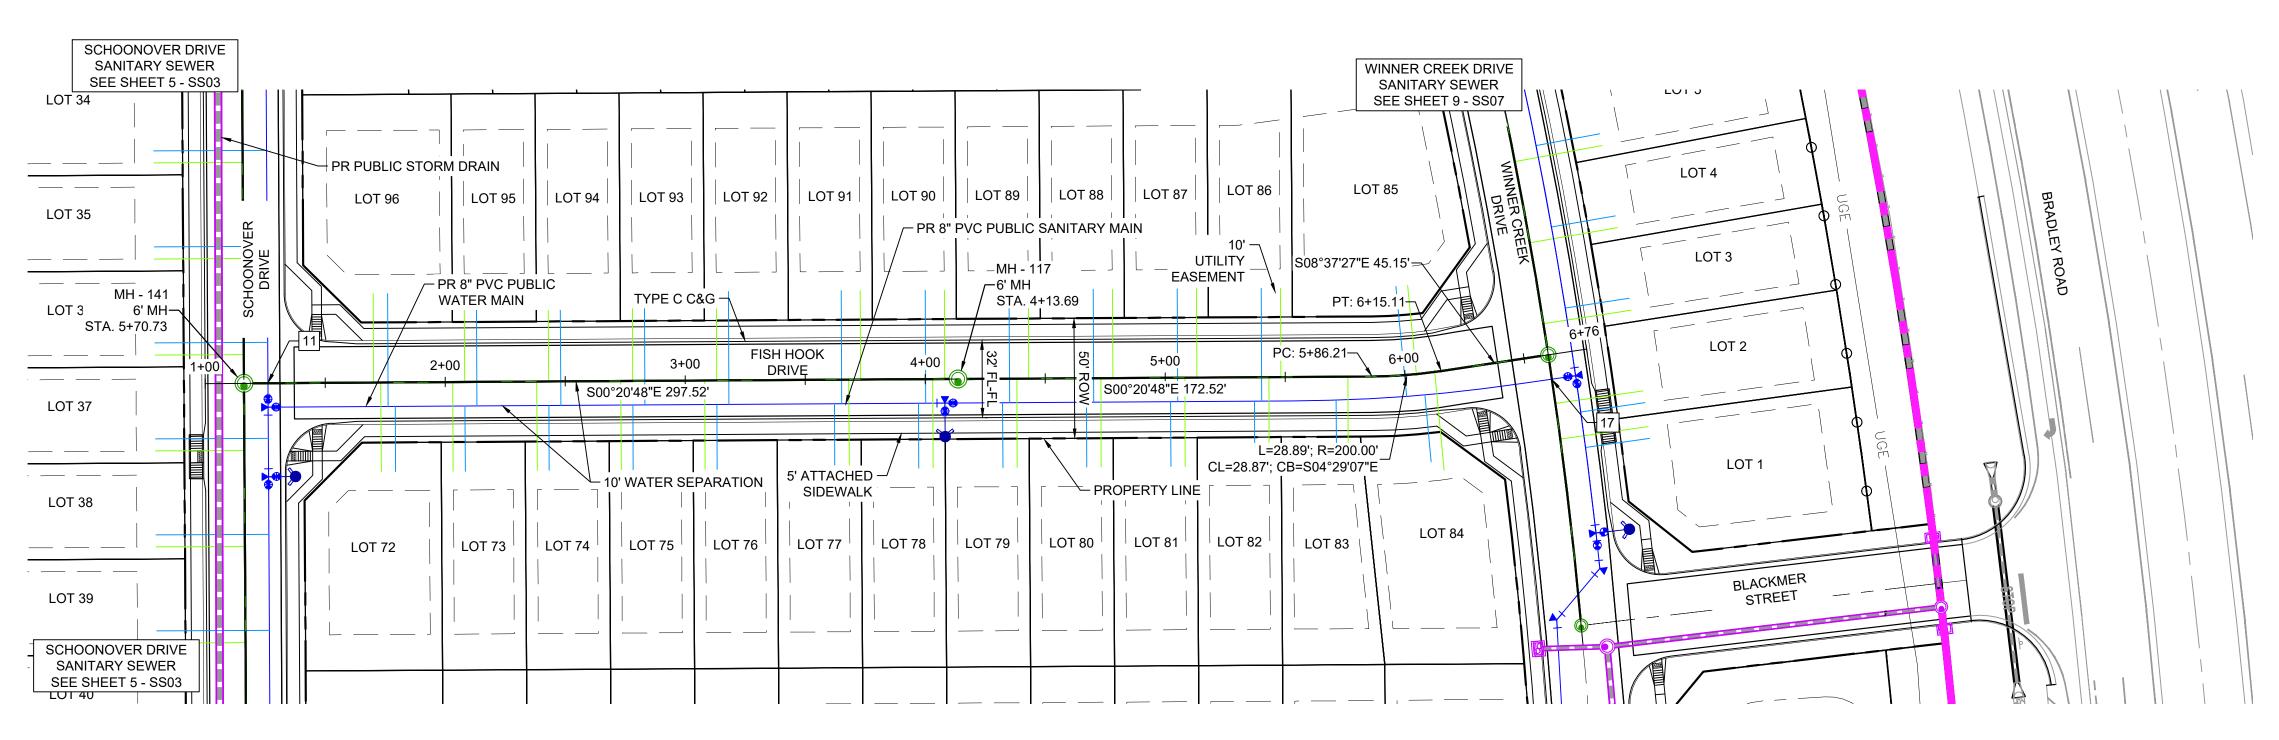

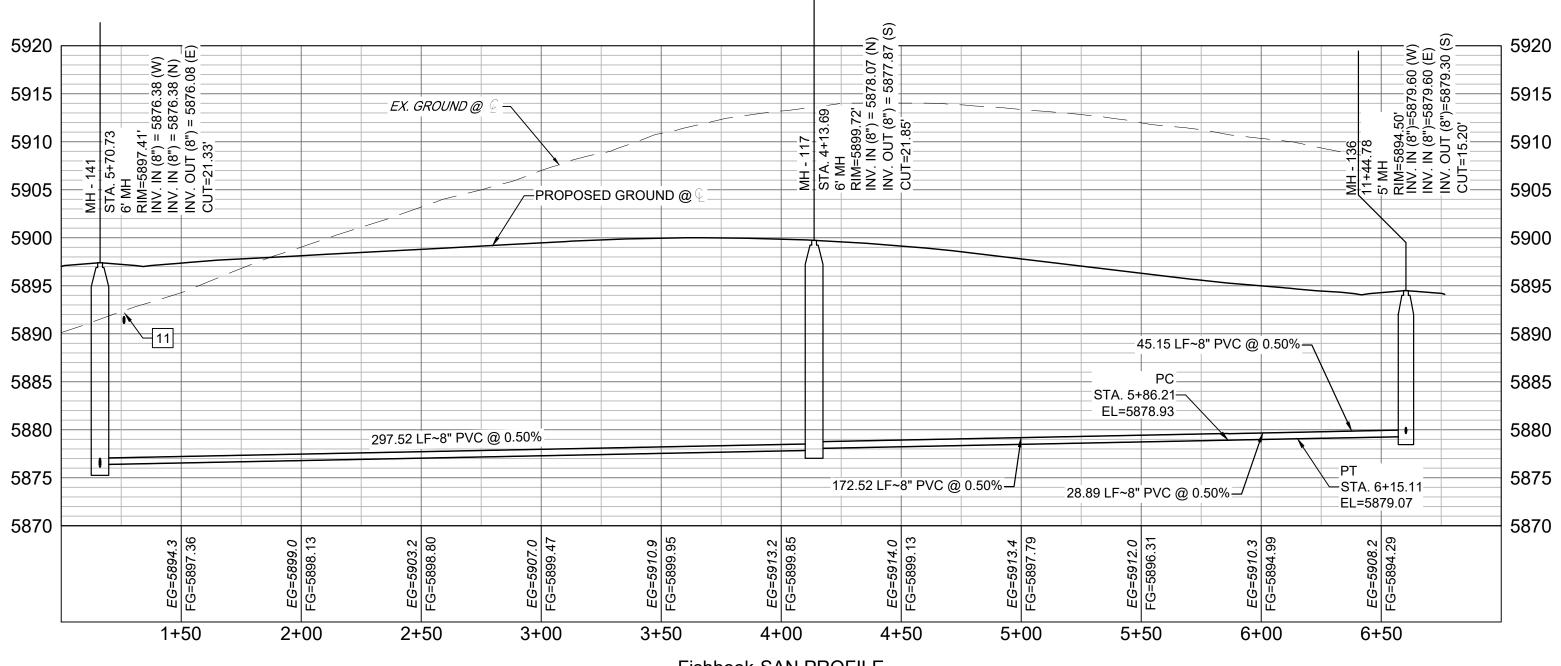

| REFERENCE |                             |  |   |  |
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| DRAWINGS  |                             |  |   |  |
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|           | FILE N.<br>CTB FI<br>PLOT I | AME: S:\21.88<br>LE: Matrix(bl<br>DATE: August 3 | 6.038 (Trails F6)\100 Dwg\104 Plan Sets\Construction Plans\Utility Plans\Sanitary Plan\SS01.dwg |  |

Fishhook-SAN PROFILE SCALE: (H) 1" = 40' (V) 1" = 10'

START STA: 1+00.00, END STA: 7+00.00


#### BENCHMARK COLORADO SPRINGS UTILITIES (FIMS) MONUMENT F206

A BERNTSEN TOP SECURITY MONUMENT SYSTEM WITH A 3.5-INCH DIAMETER ALUMINUM CAP IN A ROAD BOX, LOCATED ON THE NORTHWEST CORNER OF FONTAINE BOULEVARD AND POWERS BOULEVARD,

ELEVATION - 5897.89' U.S. SURVEY FT


BASIS OF BEARING

BEARINGS ARE BASED ON THE NORTH LINE OF THE NORTHWEST QUARTER OF SECTION 9, TOWNSHIP 15 SOUTH, RANGE 65 WEST OF THE 6TH P.M. SAID LINE BEARS S89°51'23"E FROM THE NORTHWEST CORNER OF SAID SECTION 9 (2 1/2" AULM. CAP PLS 17664) TO THE N 1/4 CORNER OF SAID SECTION 9 (3 ¼" AULM. CAP PLS 10377)

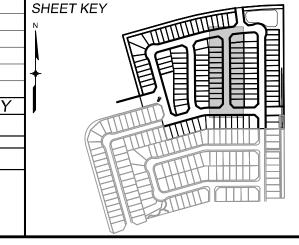

PREPARED BY:


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| UTILITY CROSSING DETAILS |   |                         |                         |        |  |  |  |  |
|--------------------------|---|-------------------------|-------------------------|--------|--|--|--|--|
| CROSSING<br>#            | NG N & E TOP OF PIPE BTM OF PIPE VERT. SEP. |                         |                         |        |  |  |  |  |
| 11                       | N 8223.77<br>E 13767.48                     | 8" PVC SEWER<br>5877.12 | 8" PVC WATER<br>5891.49 | 14.37' |  |  |  |  |

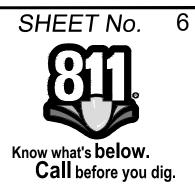

NOTE: CURVILINEAR PIPE TO BE ACHIEVED USING 3° BEND AT EVERY OTHER JOINT.



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### WIDEFIELD WATER AND SANITATION DISTRICT WASTEWATER DESIGN APPROVAL

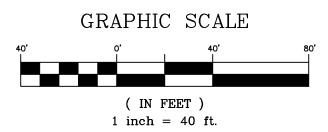BY:


DATE:

**PROJECT NUMBER**:

IN CASE OF ERRORS OR OMISSIONS WITH THE WATER DESIGN AS SHOWN ON THIS DOCUMENT THE STANDARDS AS DEFINED IN THE "RULES AND REGULATIONS FOR INSTALLATION OF WASTEWATER MAINS AND SERVICES" SHALL RULE.

APPROVAL EXPIRES 180 DAYS FROM DESIGN APPROVAL


SF-21-02

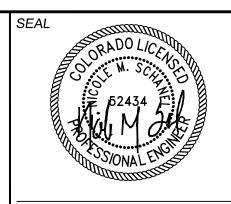


# TRAILS AT ASPEN RIDGE

FILING NO. 4 **8" SANITARY SEWER PLANS** 

| FOR AND ON BEHALF OF                                | DESIGNED BY:             | BAS        | SCA             | LE                   | DATE ISSUED: | JUNE 2022 | DRAWING No. |
|---|--------------------------|------------|-----------------|----------------------|--------------|-----------|-------------|
| MATRIX DESIGN GROUP, INC.<br>PROJECT No. 21.886.038 | DRAWN BY:<br>CHECKED BY: | JLW<br>NMS | HORIZ.<br>VERT. | 1" = 40'<br>1" = 10' | SHEET        | 6 OF 12   | SS04        |
|   |                          |            |                 |                      | _            |           |             |

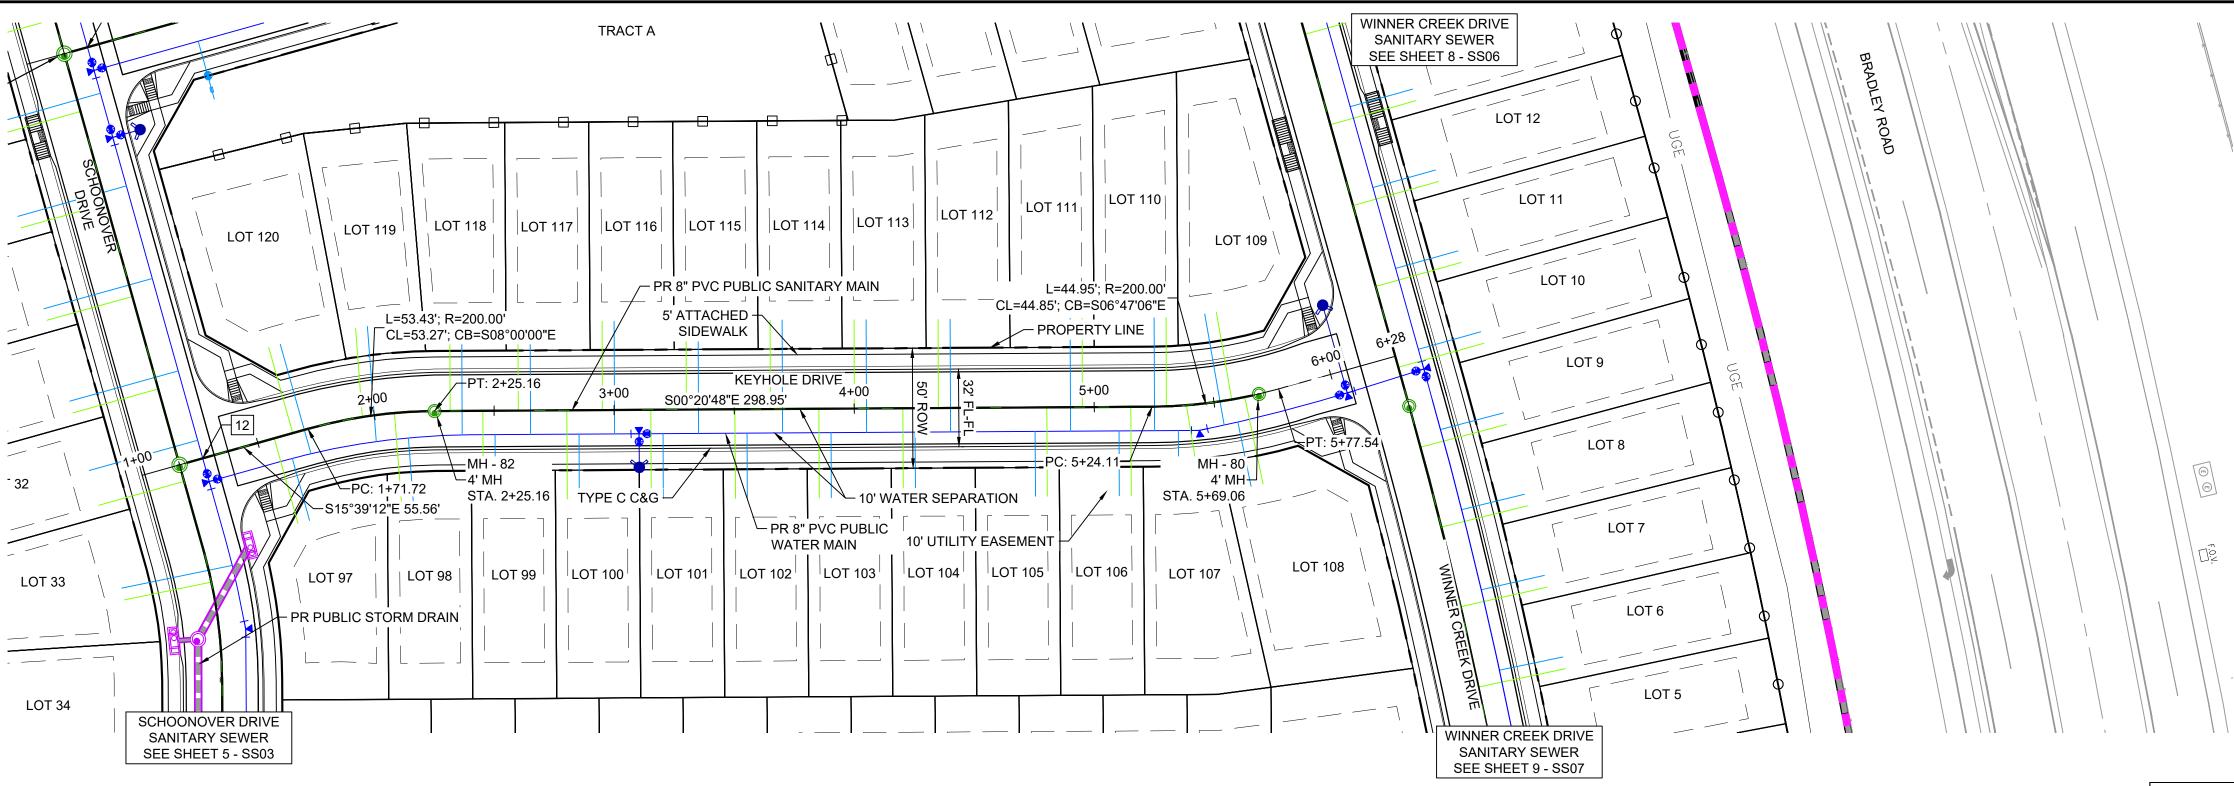


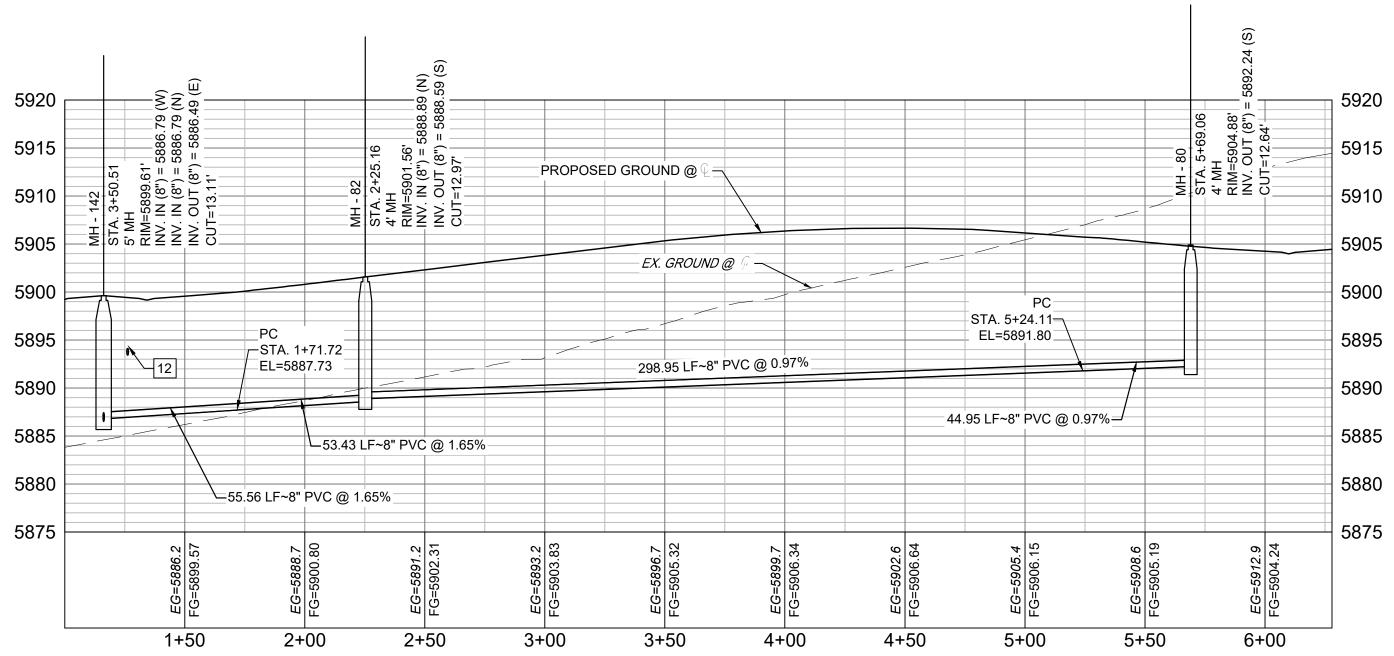



SCALE: (H) 1" = 40' (V) 1" = 10' START STA: 1+00.00, END STA: 6+27.97

| REFERENCE<br>DRAWINGS Image: Construction Plans/Utility Plans/Sanitary Plan/SS01.dwg   Image: CTB FILE: Matrix(black).ctb   PLOT DATE: August 3, 2022 1:19:58 PM   THIS DRAWING IS CURRENT AS OF PLOT DATE AND MAY BE SUBJECT TO CHANGE.   |          |                                      |                   |   |   |  |  |  |  |  |
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| Image: No. DATE DESCRIPTION B   No. DATE DESCRIPTION B   REVISIONS   FILE NAME: S:\21.886.038 (Trails F6)\100 Dwg\104 Plan Sets\Construction Plans\Utility Plans\Sanitary Plan\SS01.dwg   COMPUTER FILE MANAGEMENT   FILE NAME: S:\21.886.038 (Trails F6)\100 Dwg\104 Plan Sets\Construction Plans\Utility Plans\Sanitary Plan\SS01.dwg   CTB FILE: Matrix(black).ctb   PLOT DATE: August 3, 2022 1:19:58 PM |          |                                      |                   |   |   |  |  |  |  |  |
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| REVISIONS   COMPUTER FILE MANAGEMENT   FILE NAME: S:\21.886.038 (Trails F6)\100 Dwg\104 Plan Sets\Construction Plans\Utility Plans\Sanitary Plan\SS01.dwg   CTB FILE: Matrix(black).ctb   PLOT DATE: August 3, 2022 1:19:58 PM   |          |                                      |                   |   |   |  |  |  |  |  |
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| FILE NAME: S:\21.886.038 (Trails F6)\100 Dwg\104 Plan Sets\Construction Plans\Utility Plans\Sanitary Plan\SS01.dwg<br>CTB FILE: Matrix(black).ctb<br>PLOT DATE: August 3, 2022 1:19:58 PM  |          |                                      |                   |   |   |  |  |  |  |  |
| PLOT DATE: August 3, 2022 1:19:58 PM   |          |                                      |                   |   |   |  |  |  |  |  |
| THIS DRAWING IS CURRENT AS OF PLOT DATE AND MAY BE SUBJECT TO CHANGE.  |          | PLOT DATE: August 3, 2022 1:19:58 PM |                   |   |   |  |  |  |  |  |
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Keyhole-SAN PROFILE



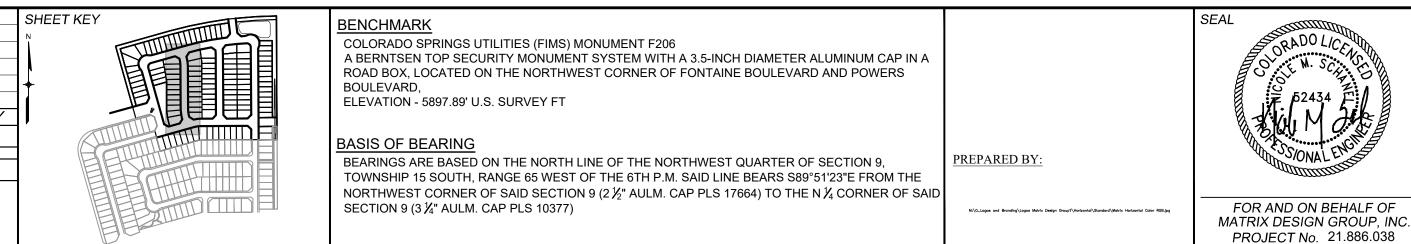

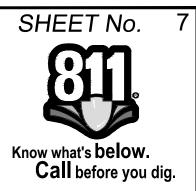

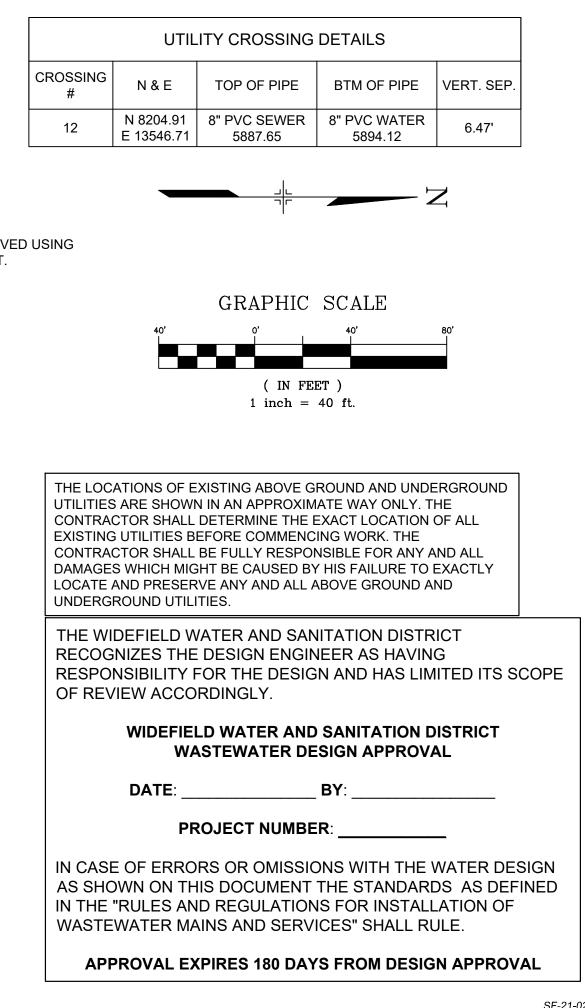
<u>NOTE</u>: CURVILINEAR PIPE TO BE ACHIEVED USING 3° BEND AT EVERY OTHER JOINT.

IN CASE OF ERRORS OR OMISSIONS WITH THE WATER DESIGN AS SHOWN ON THIS DOCUMENT THE STANDARDS AS DEFINED

# TRAILS AT ASPEN RIDGE

FILING NO. 4 **8" SANITARY SEWER PLANS** 

| OR AND ON BEHALF OF                              | DESIGNED BY:             | BAS        | SCA             | ALE                  | DATE ISSUED: | JUNE 2022 | DRAWING No. |   |
|--|--------------------------|------------|-----------------|----------------------|--------------|-----------|-------------|---|
| TRIX DESIGN GROUP, INC.<br>ROJECT No. 21.886.038 | DRAWN BY:<br>CHECKED BY: | JLW<br>NMS | HORIZ.<br>VERT. | 1" = 40'<br>1" = 10' | SHEET        | 7 OF 12   | SS05        |   |
|  |                          |            |                 |                      |              |           |             | _ |

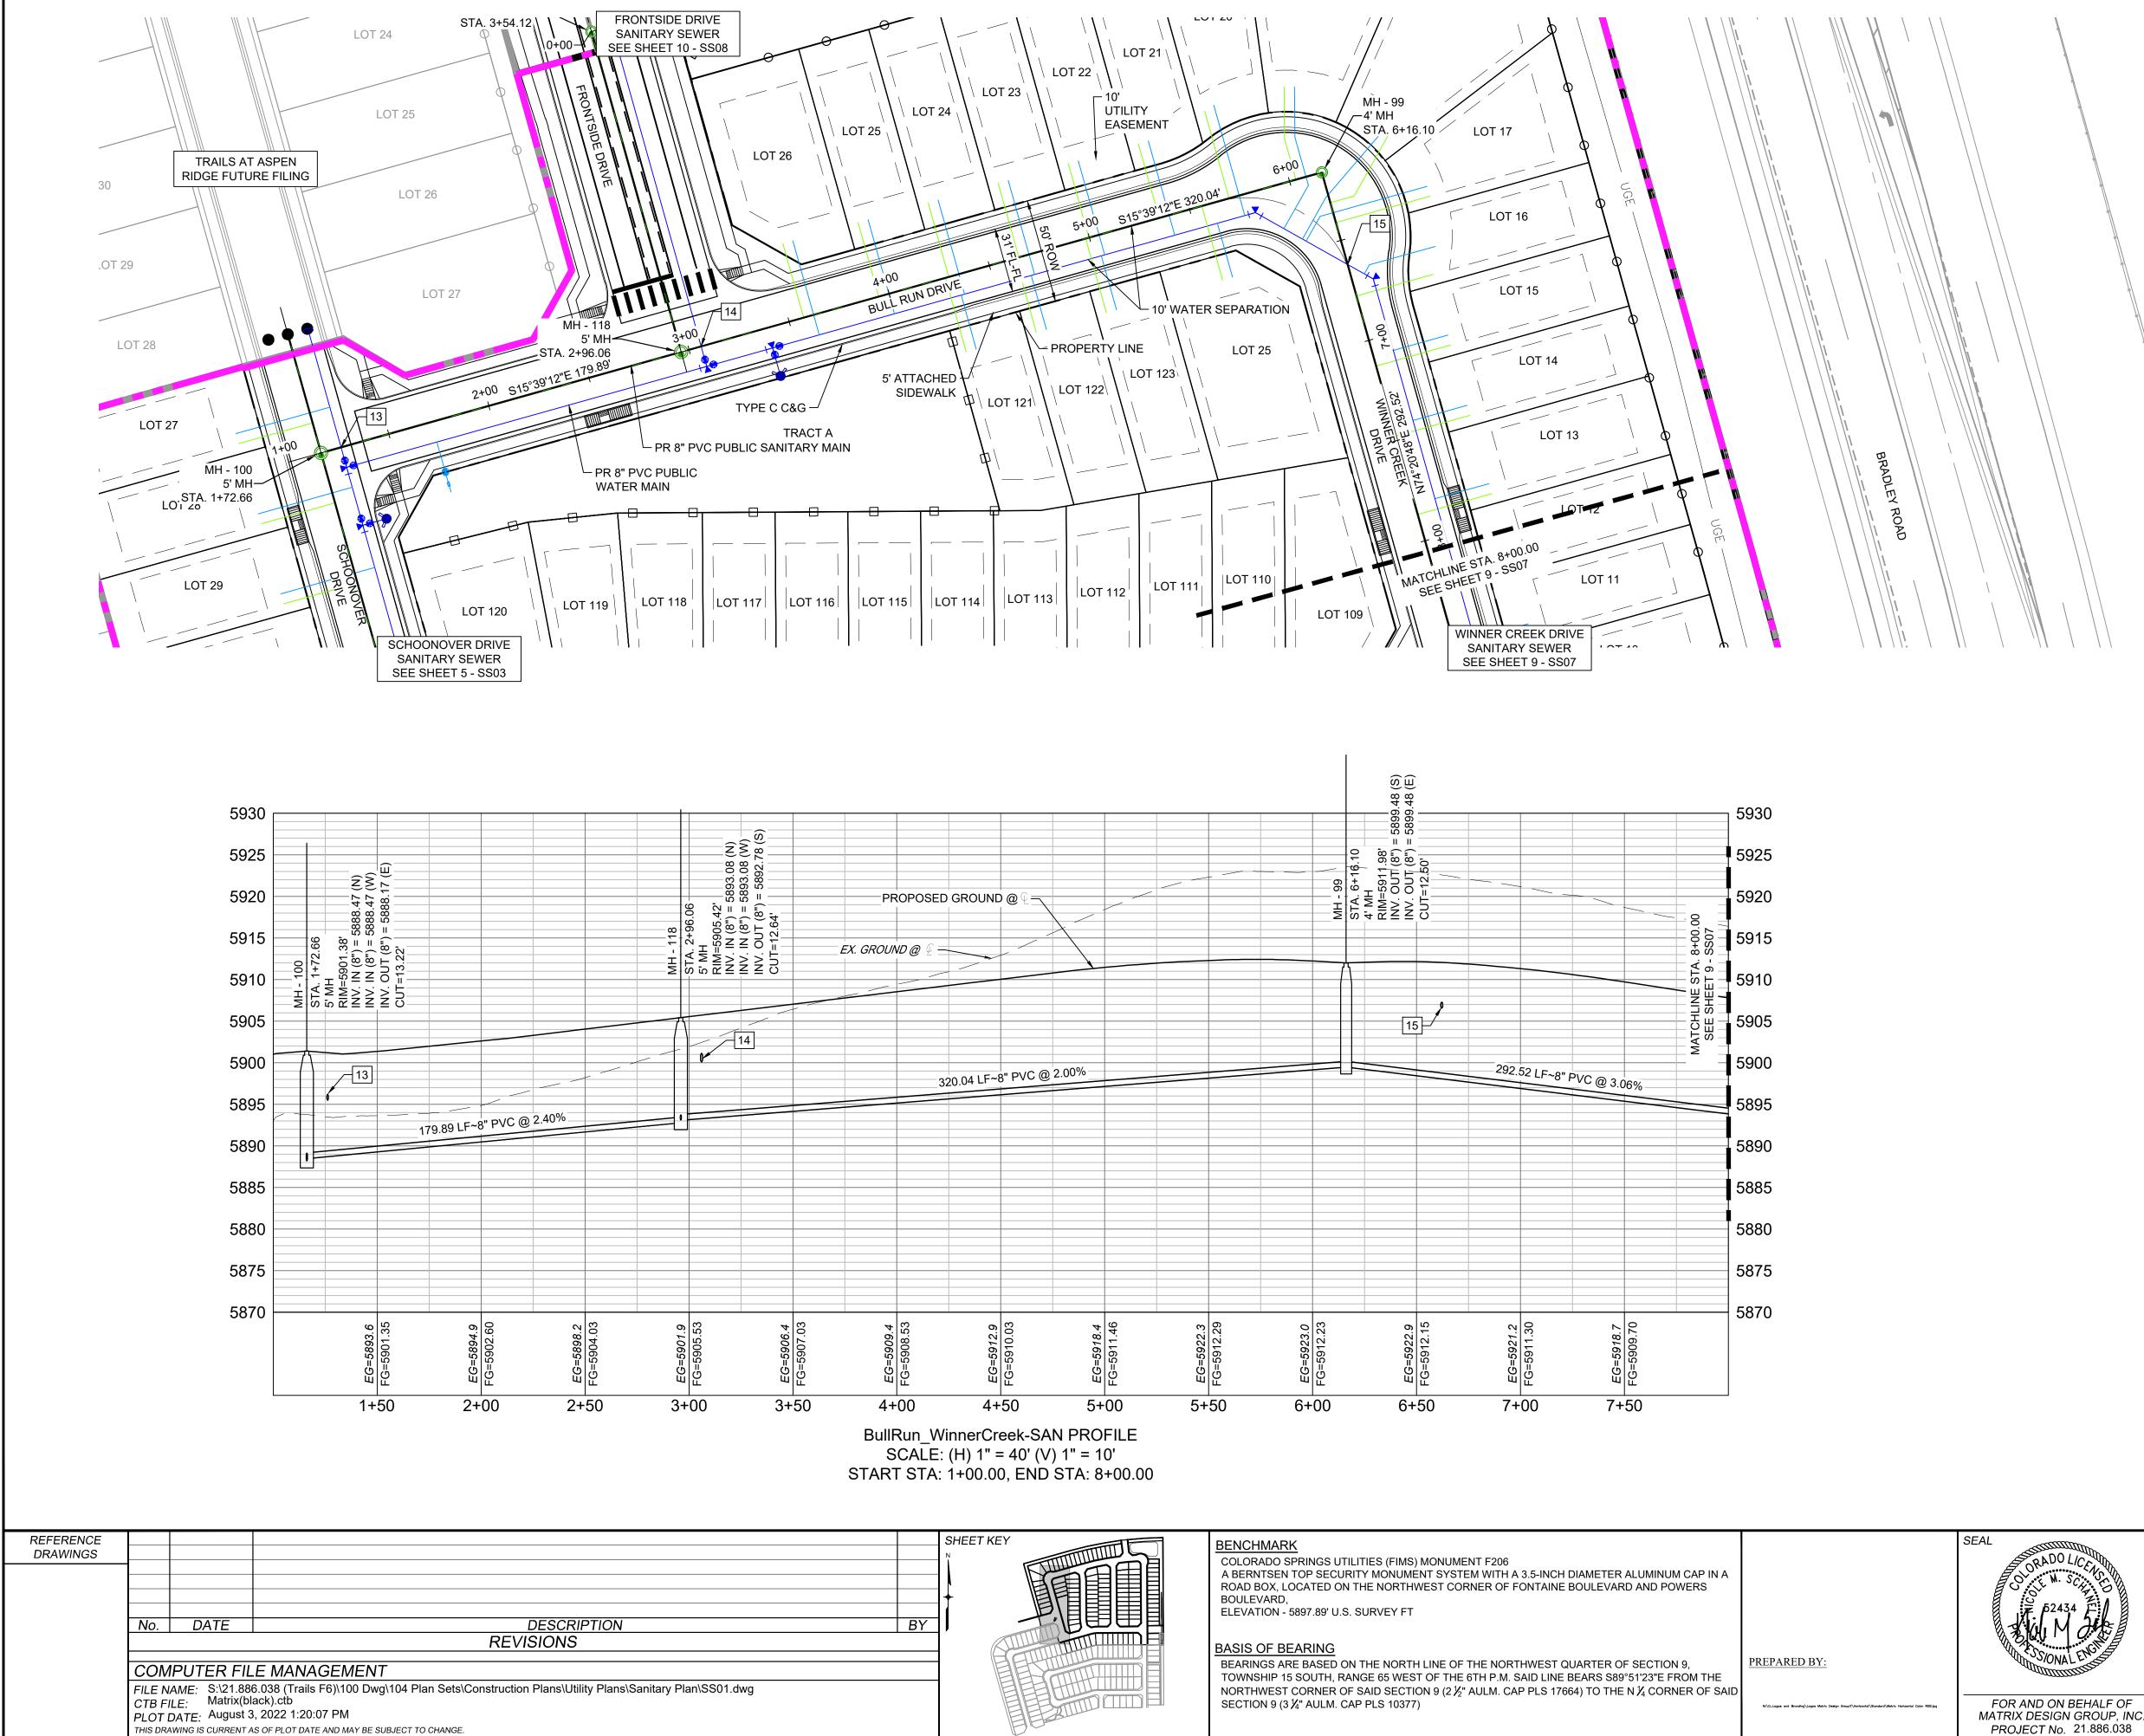


THIS DRAWING IS CURRENT AS OF PLOT DATE AND MAY BE SUBJECT TO CHANGE.



| UTILITY CROSSING DETAILS |                         |                         |                          |            |  |  |  |  |
|--------------------------|-------------------------|-------------------------|--------------------------|------------|--|--|--|--|
| CROSSING<br>#            | N & E                   | TOP OF PIPE             | BTM OF PIPE              | VERT. SEP. |  |  |  |  |
| 13                       | N 8156.91<br>E 13375.46 | 8" PVC SEWER<br>5889.40 | 8" PVC WATER<br>5895.90  | 6.50'      |  |  |  |  |
| 14                       | N 8330.13<br>E 13326.92 | 8" PVC SEWER<br>5893.97 | 12" PVC WATER<br>5900.08 | 6.11'      |  |  |  |  |
| 15                       | N 8641.09<br>E 13287.58 | 8" PVC SEWER<br>5898.76 | 8" PVC WATER<br>5906.56  | 7.80'      |  |  |  |  |



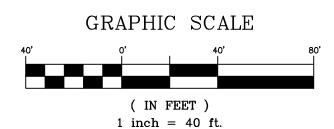

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### WIDEFIELD WATER AND SANITATION DISTRICT WASTEWATER DESIGN APPROVAL

BY:

DATE:

**PROJECT NUMBER**:

IN CASE OF ERRORS OR OMISSIONS WITH THE WATER DESIGN AS SHOWN ON THIS DOCUMENT THE STANDARDS AS DEFINED IN THE "RULES AND REGULATIONS FOR INSTALLATION OF WASTEWATER MAINS AND SERVICES" SHALL RULE.

APPROVAL EXPIRES 180 DAYS FROM DESIGN APPROVAL


SF-21-02

# TRAILS AT ASPEN RIDGE

FILING NO. 4

**8" SANITARY SEWER PLANS** 

| ND ON BEHALF OF                         | DESIGNED BY:             | BAS        | SCA             | \LE                  | DATE ISSUED: | JUNE 2022 | DRAWING No. |
|---|--------------------------|------------|-----------------|----------------------|--------------|-----------|-------------|
| DESIGN GROUP, INC.<br>CT No. 21.886.038 | DRAWN BY:<br>CHECKED BY: | JLW<br>NMS | HORIZ.<br>VERT. | 1" = 40'<br>1" = 10' | SHEET        | 8 OF 12   | SS06        |
| 01110. 21.000.000                       | ONEONED DT.              | 11110      | VERT.           | 1 - 10               |              |           |             |

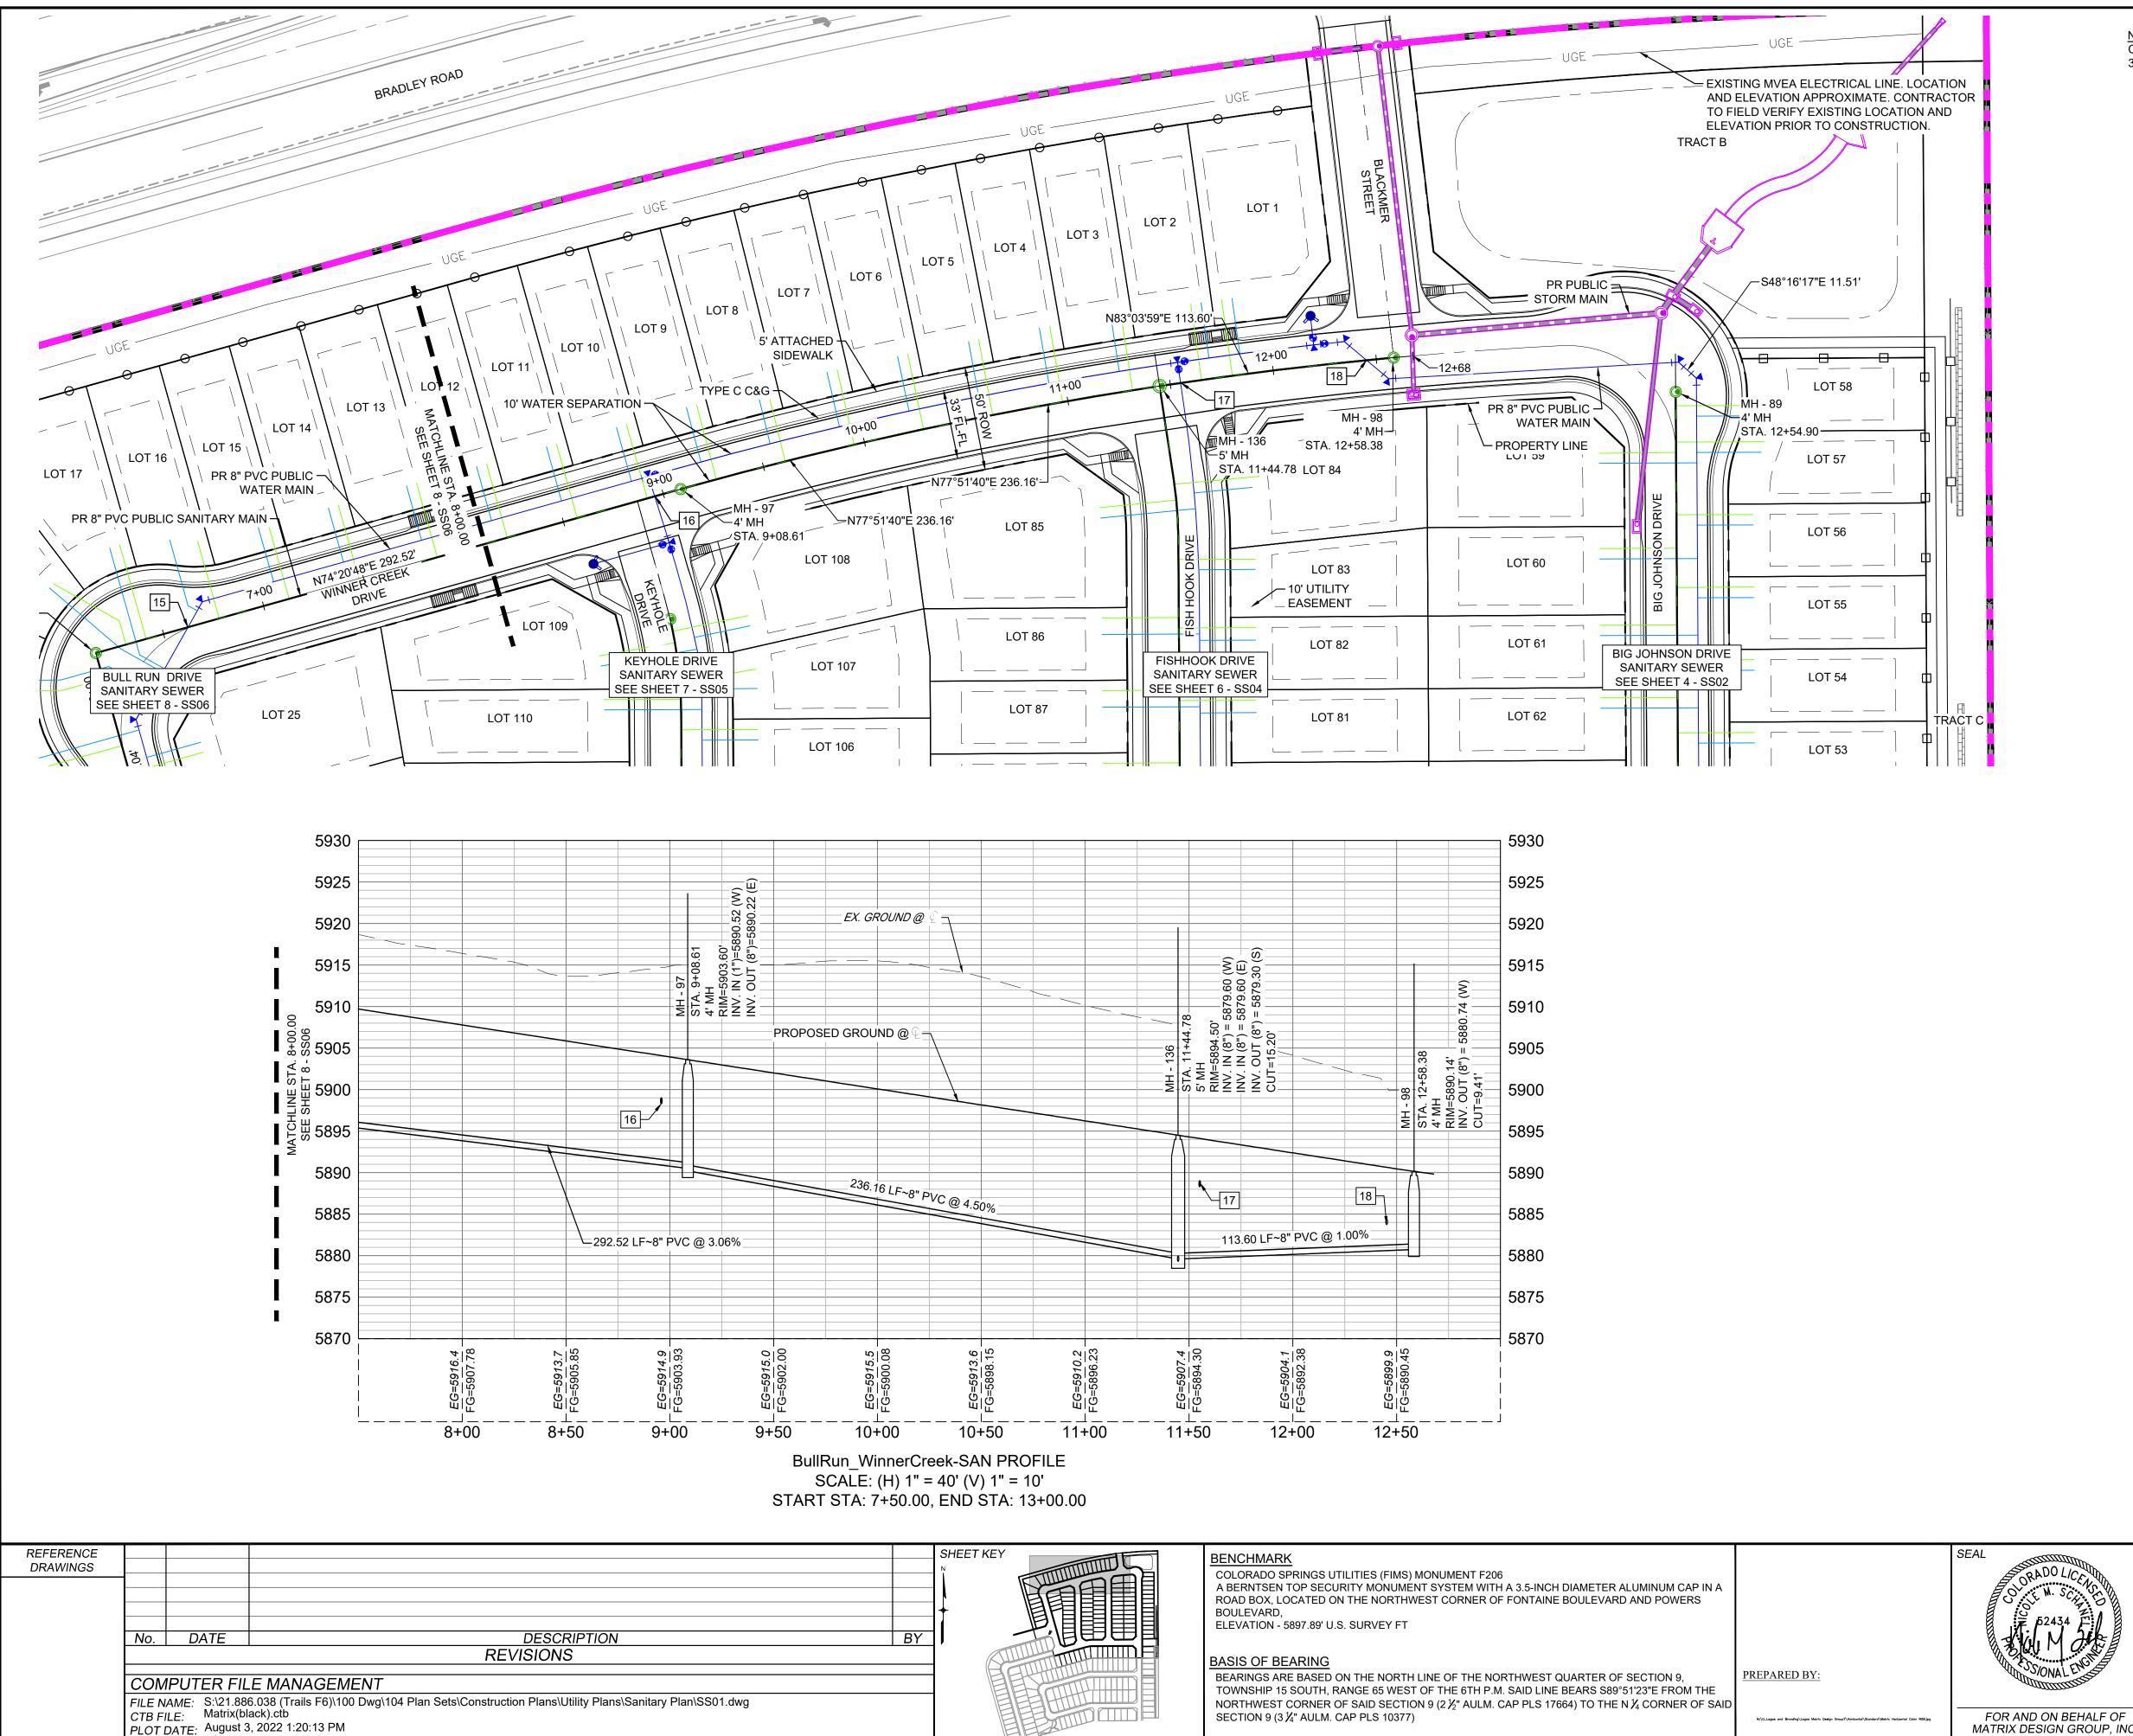


PLOT DATE: August 3, 2022 1:20:13 PM THIS DRAWING IS CURRENT AS OF PLOT DATE AND MAY BE SUBJECT TO CHANGE.

| <br>SHEET KEY | BENCHMARK<br>COLORADO SPRINGS UTILITIES (FIMS) MONUMENT F206<br>A BERNTSEN TOP SECURITY MONUMENT SYSTEM WITH A 3.5-INCH DIAMETER ALUMINUM CAP IN A<br>ROAD BOX, LOCATED ON THE NORTHWEST CORNER OF FONTAINE BOULEVARD AND POWERS                         |  | 3 |
|---------------|--|--|---|
|               | BOULEVARD,<br>ELEVATION - 5897.89' U.S. SURVEY FT<br>BASIS OF BEARING<br>BEARINGS ARE BASED ON THE NORTH LINE OF THE NORTHWEST QUARTER OF SECTION 9,   | PREPARED BY:   |   |
|               | TOWNSHIP 15 SOUTH, RANGE 65 WEST OF THE 6TH P.M. SAID LINE BEARS S89°51'23"E FROM THE NORTHWEST CORNER OF SAID SECTION 9 (2 $\frac{1}{2}$ " AULM. CAP PLS 17664) TO THE N $\frac{1}{4}$ CORNER OF SAID SECTION 9 (3 $\frac{1}{4}$ " AULM. CAP PLS 10377) | M/Q_Lagan and Branding/Lagan Mohis Design Group?/Horizonia/Standard/Mohis Horizonial Calor ROB.jpg | _ |

CURVILINEAR PIPE TO BE ACHIEVED USING 3° BEND AT EVERY OTHER JOINT.



| UTILITY CROSSING DETAILS |                         |                         |                         |            |  |  |  |  |
|--------------------------|-------------------------|-------------------------|-------------------------|------------|--|--|--|--|
| CROSSING<br>#            | N & E                   | TOP OF PIPE             | BTM OF PIPE             | VERT. SEP. |  |  |  |  |
| 16                       | N 8704.16<br>E 13512.68 | 8" PVC SEWER<br>5891.60 | 8" PVC WATER<br>5898.29 | 6.69'      |  |  |  |  |
| 17                       | N 8758.76<br>E 13765.98 | 8" PVC SEWER<br>5880.39 | 8" PVC WATER<br>5888.30 | 7.91'      |  |  |  |  |
| 18                       | N 8770.00<br>E 13858.47 | 8" PVC SEWER<br>5881.30 | 8" PVC WATER<br>5883.72 | 2.42'      |  |  |  |  |

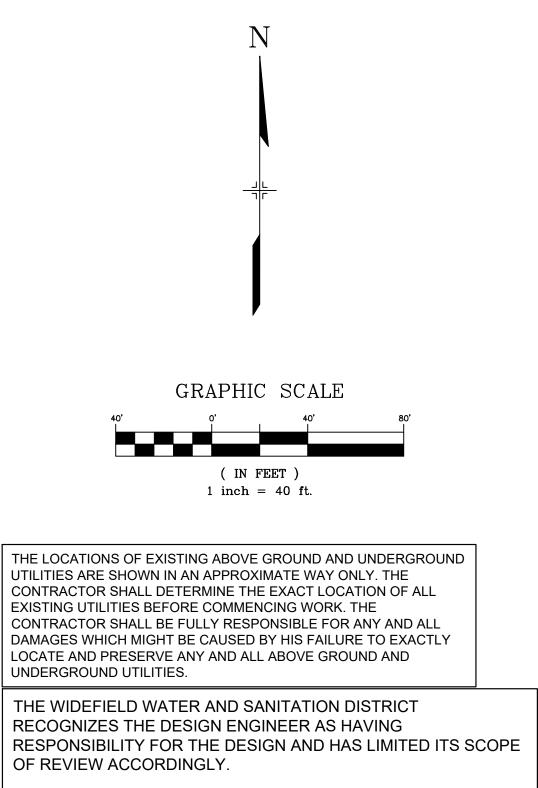

WIDEFIELD WATER AND SANITATION DISTRICT WASTEWATER DESIGN APPROVAL

BY:

DATE:

**PROJECT NUMBER**:

IN CASE OF ERRORS OR OMISSIONS WITH THE WATER DESIGN AS SHOWN ON THIS DOCUMENT THE STANDARDS AS DEFINED IN THE "RULES AND REGULATIONS FOR INSTALLATION OF WASTEWATER MAINS AND SERVICES" SHALL RULE.


APPROVAL EXPIRES 180 DAYS FROM DESIGN APPROVAL


SF-21-02

# TRAILS AT ASPEN RIDGE

FILING NO. 4 **8" SANITARY SEWER PLANS** 


| FOR AND ON BEHALF OF      | DESIGNED BY: | BAS | SCA    | \LE      | DATE ISSUED: | JUNE 2022 | DRAWING No. |
|---------------------------|--------------|-----|--------|----------|--------------|-----------|-------------|
| MATRIX DESIGN GROUP, INC. | DRAWN BY:    | JLW | HORIZ. | 1" = 40' |              |           | 0007        |
|                           |              | -   | HURIZ. | 1 - 40   |              | 0 0 0 10  | 5022        |
| PROJECT No. 21.886.038    | CHECKED BY:  | NMS | VERT.  | 1" = 10' | SHEET        | 9 OF 12   | 0007        |
|                           |              |     |        |          |              |           |             |
|                           |              |     |        |          |              |           |             |

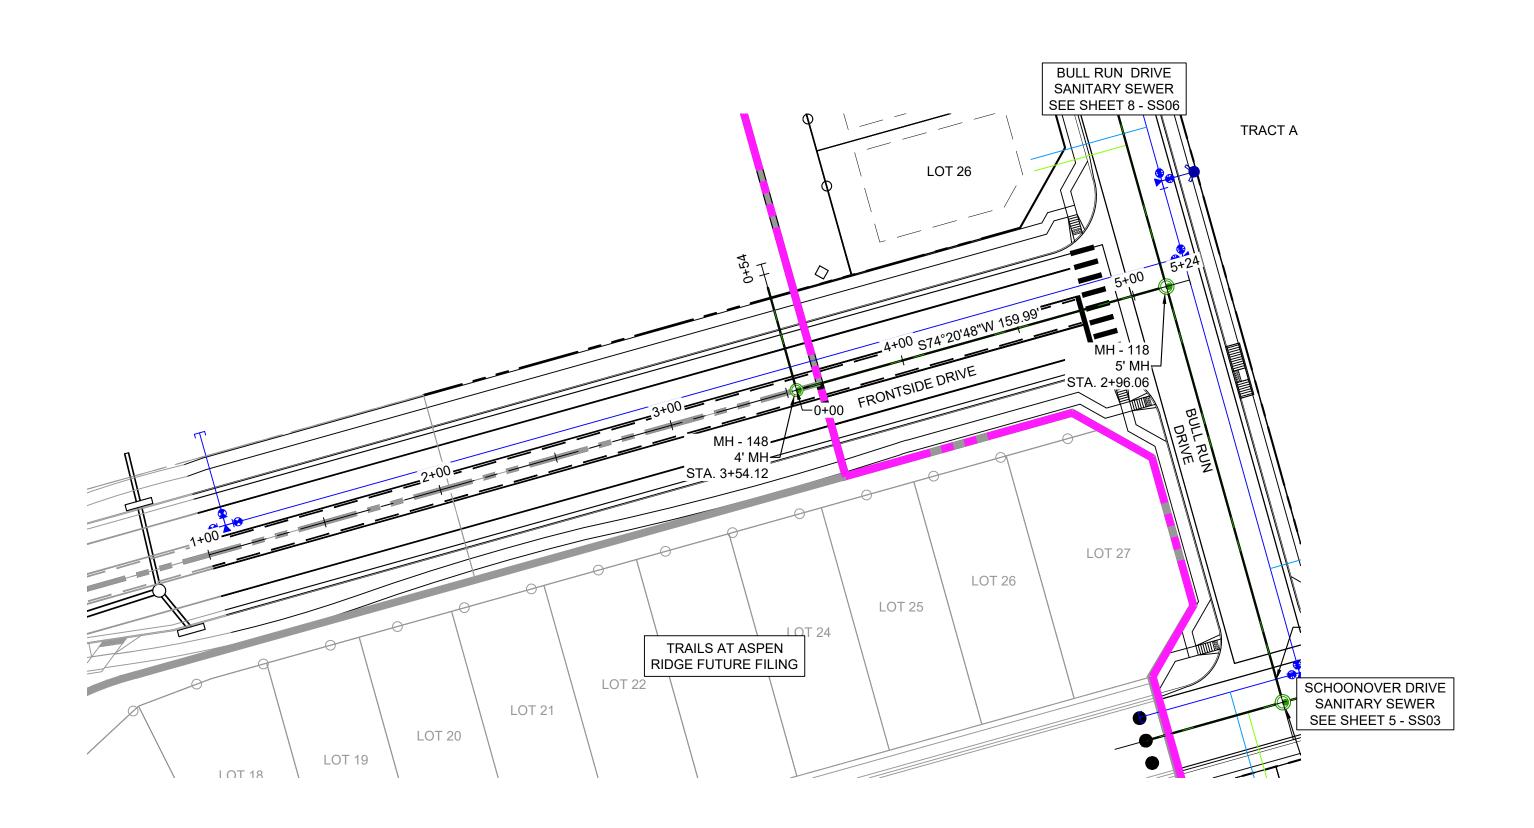

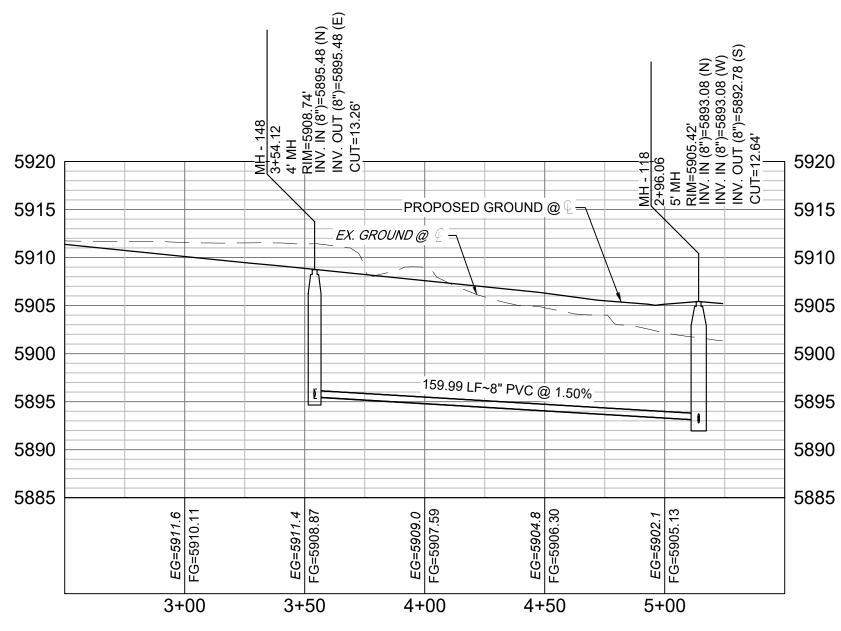

Frontside-SAN PROFILE SCALE: (H) 1" = 40' (V) 1" = 10' START STA: 2+50.00, END STA: 5+50.00


| REFERENCE |   |                   |  |   |  |  |  |  |
|-----------|---|-------------------|--|---|--|--|--|--|
| DRAWINGS  |   |                   |  |   |  |  |  |  |
|           |   |                   |  |   |  |  |  |  |
|           |   |                   |  |   |  |  |  |  |
|           |   |                   |  |   |  |  |  |  |
|           |   |                   |  | B |  |  |  |  |
|           | No.   | DATE              | DESCRIPTION                                  |   |  |  |  |  |
|           | REVISIONS   |                   |  |   |  |  |  |  |
|           |   |                   |  |   |  |  |  |  |
|           | COMPUTER FILE MANAGEMENT  |                   |  |   |  |  |  |  |
|           | FILE NAME: S:\21.886.038 (Trails F6)\100 Dwg\104 Plan Sets\Construction Plans\Utility Plans\Sanitary Plan\SS01.dwg   CTB FILE: Matrix(black).ctb   PLOT DATE: August 30, 2022 12:53:54 PM |                   |  |   |  |  |  |  |
|           | THIS DRA  | WING IS CURRENT A | S OF PLOT DATE AND MAY BE SUBJECT TO CHANGE. |   |  |  |  |  |

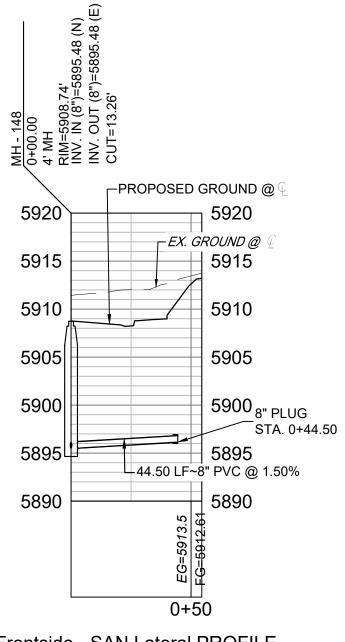


Frontside - SAN Lateral PROFILE SCALE: (H) 1" = 40' (V) 1" = 10' START STA: 0+00.00, END STA: 0+54.50


SEAL

RADOL

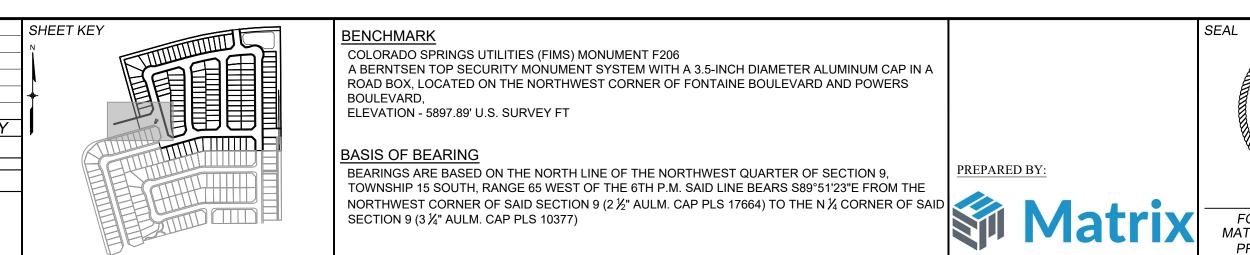

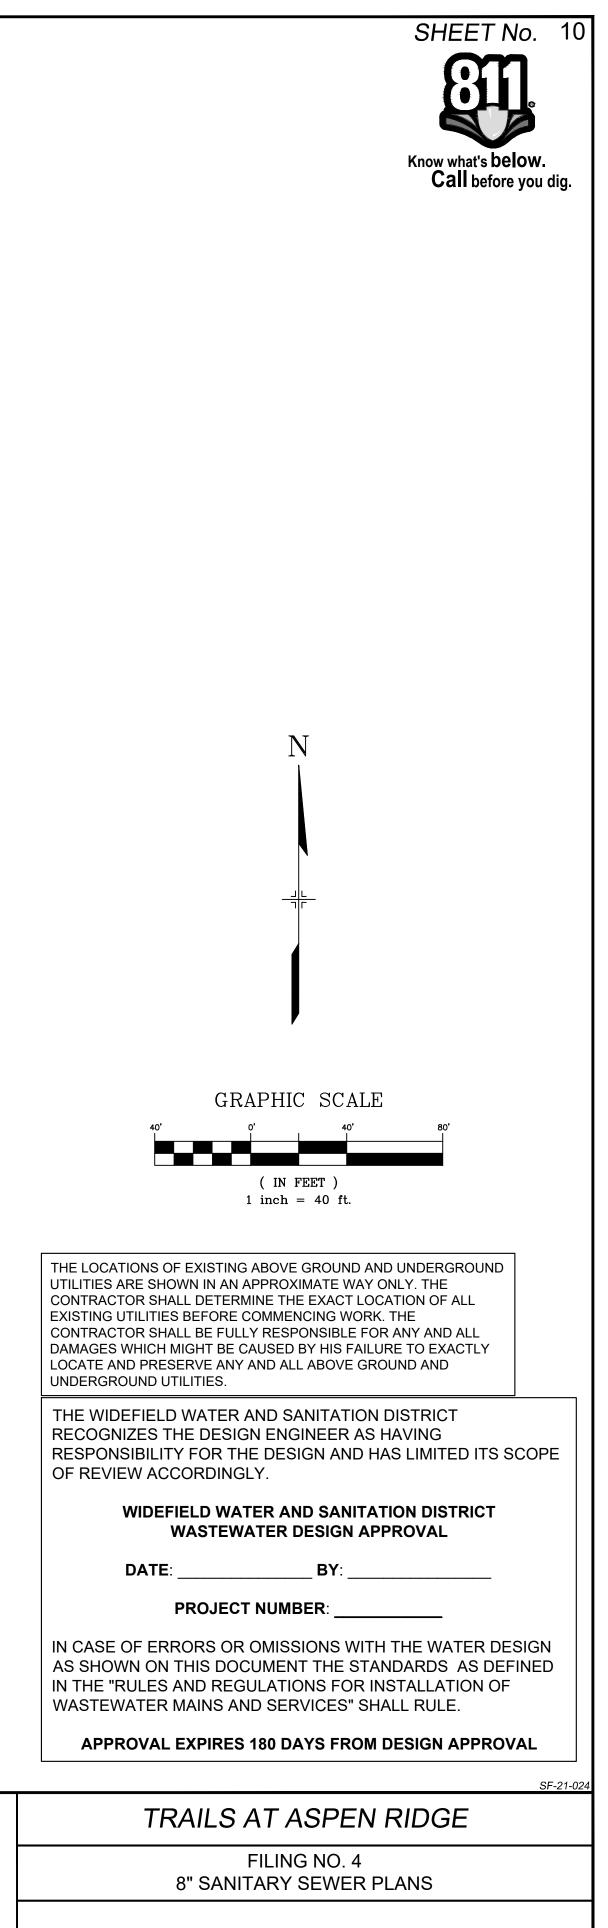

| FOR AND ON BEHALF OF      | DESIGNED BY:  | BAS    | SCA      | ALE      | DATE ISSUED: | JUNE 2022 | DRAWING No. |
|---------------------------|---------------|--------|----------|----------|--------------|-----------|-------------|
| IATRIX DESIGN GROUP, INC. | DRAWN BY: JLW | HORIZ. | 1" = 40' |          |              | SS08      |             |
| PROJECT No. 21.886.038    | CHECKED BY:   | NMS    | VERT.    | 1" = 10' | SHEET        | 10 OF 12  | 3300        |
|                           |               |        |          |          |              |           |             |

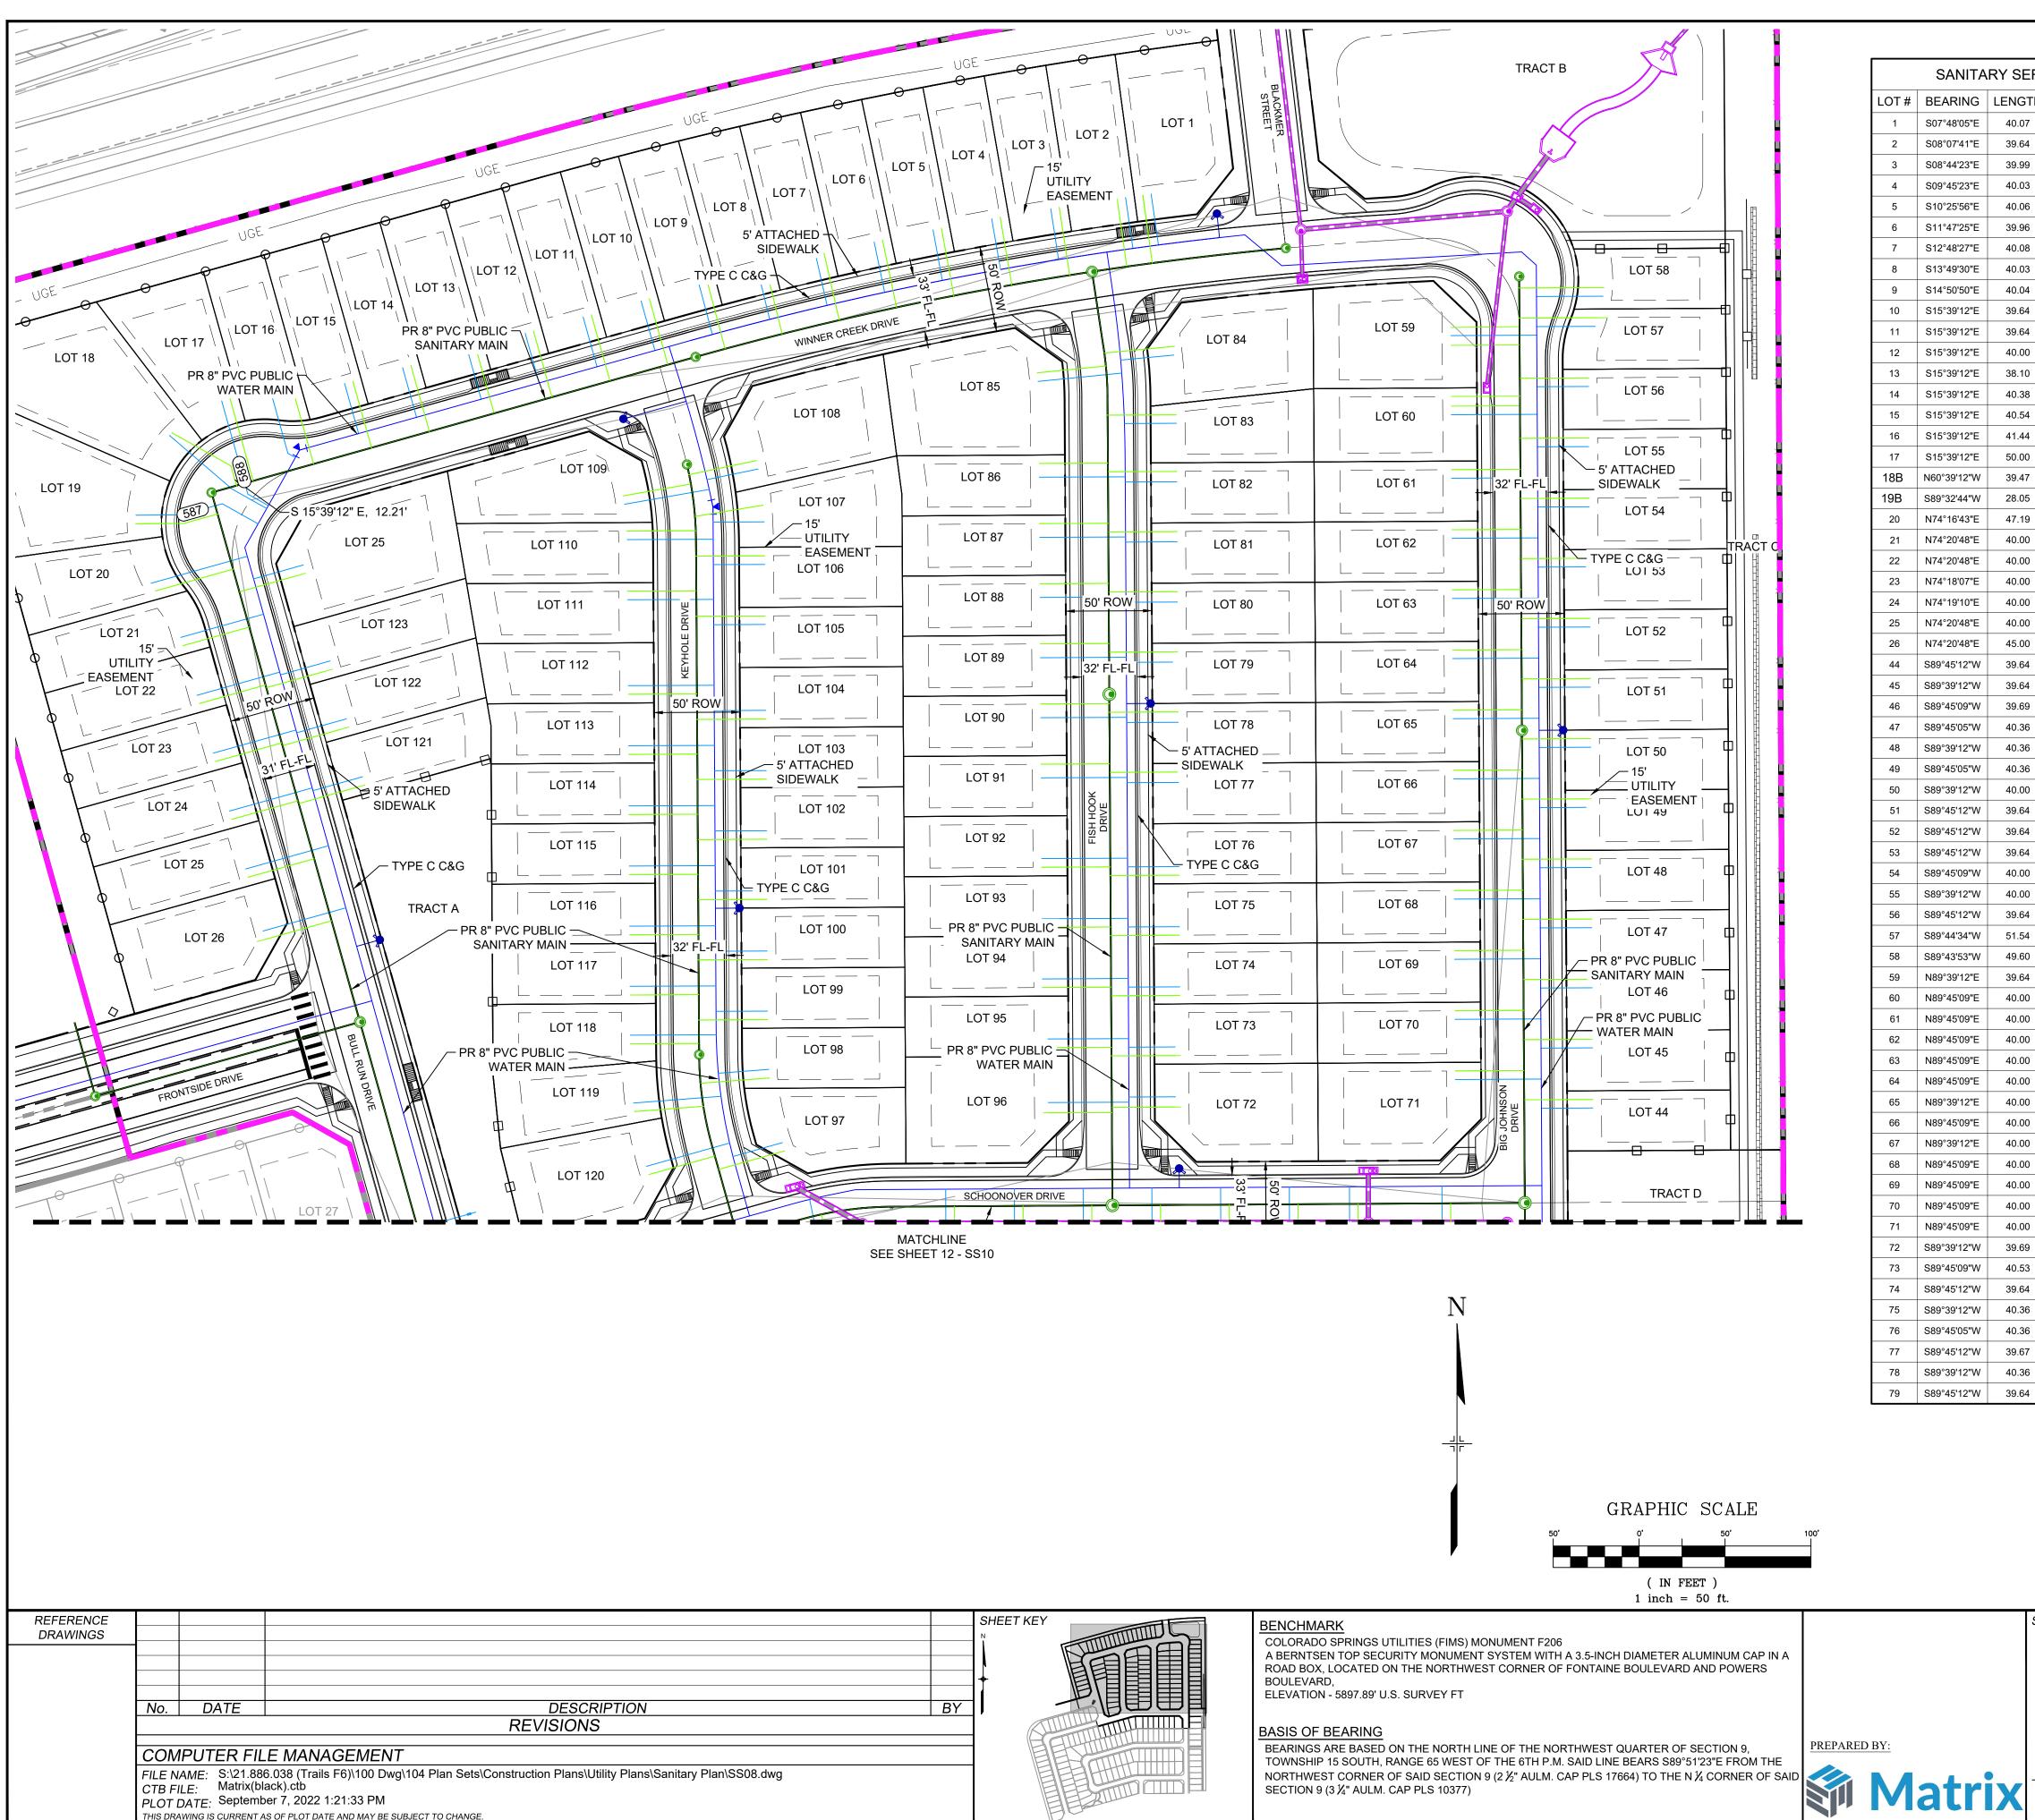

PLOT DATE: September 7, 2022 1:21:33 PM

THIS DRAWING IS CURRENT AS OF PLOT DATE AND MAY BE SUBJECT TO CHANGE.

| ERV      | /ICE TABLE         |                      |
|----------|--------------------|----------------------|
| GTH      | NORTHING           | EASTING              |
| 07       | 8801.81            | 13785.35             |
| 64       | 8799.71            | 13770.26             |
| 99       | 8794.71            | 13736.60             |
| 03       | 8788.94            | 13702.21             |
| 06       | 8782.58            | 13668.01             |
| 96       | 8775.58            | 13633.75             |
| 08       | 8768.01            | 13599.70             |
| 03       | 8759.79            | 13565.79             |
| 04<br>64 | 8750.99<br>8741.59 | 13531.86             |
| 64       | 8732.15            | 13464.32             |
| 00       | 8722.71            | 13430.62             |
| 10       | 8711.78            | 13397.33             |
| 38       | 8702.74            | 13359.26             |
| 54       | 8693.45            | 13325.52             |
| 44       | 8685.21            | 13291.48             |
| 00       | 8683.58            | 13253.93             |
| 47       | 8644.16            | 13254.59             |
| 10       | 8610.69            | 13227.14             |
| 19<br>00 | 8571.34            | 13210.64<br>13226.70 |
| 00       | 8505.85            | 13236.14             |
| 00       | 8472.12            | 13245.60             |
| 00       | 8438.43            | 13255.04             |
| 00       | 8404.75            | 13264.47             |
| 00       | 8367.28            | 13269.78             |
| 64       | 8275.39            | 14047.18             |
| 64       | 8310.46            | 14046.96             |
| 69       | 8345.39            | 14046.44             |
| 36<br>36 | 8380.39<br>8415.46 | 14046.54             |
| 36       | 8450.39            | 14046.33             |
| 00       | 8485.46            | 14045.90             |
| 64       | 8520.39            | 14045.69             |
| 64       | 8555.39            | 14045.48             |
| 64       | 8590.39            | 14045.27             |
| 00       | 8625.39            | 14045.06             |
| 00       | 8660.46            | 14044.85             |
| 64       | 8695.39            | 14044.63             |
| 54       | 8730.44            | 14055.61             |
| 60<br>64 | 8747.94            | 14053.56             |
| 00       | 8684.61            | 13964.70             |
| 00       | 8642.04            | 13964.96             |
| 00       | 8607.04            | 13965.17             |
| 00       | 8572.04            | 13965.38             |
| 00       | 8537.04            | 13965.59             |
| 00       | 8501.97            | 13965.80             |
| 00       | 8467.04            | 13966.01             |
| 00       | 8431.98            | 13966.23             |
| 00       | 8397.05            | 13966.44             |
| 00       | 8362.05            | 13966.65             |
| 00       | 8292.05            | 13967.07             |
| 69       | 8271.01            | 13807.25             |
| 53       | 8300.94            | 13807.19             |
| 64       | 8335.94            | 13806.81             |
| 36       | 8371.01            | 13806.59             |
| 36       | 8405.94            | 13806.38             |
| 67       | 8465.94            | 13806.02             |
| 36       | 8501.01            | 13805.81             |
| 64       | 8535.94            | 13805.60             |
|          |                    |                      |

| SANITARY SERVICE TABLE |             |        |          |          |  |  |
|------------------------|-------------|--------|----------|----------|--|--|
| LOT #                  | BEARING     | LENGTH | NORTHING | EASTING  |  |  |
| 80                     | S89°45'12"W | 39.64  | 8570.94  | 13805.38 |  |  |
| 81                     | S89°45'12"W | 39.64  | 8605.94  | 13805.17 |  |  |
| 82                     | S89°45'12"W | 39.64  | 8640.93  | 13804.96 |  |  |
| 83                     | S89°45'05"W | 40.36  | 8673.91  | 13804.76 |  |  |
| 84                     | S84°37'31"W | 39.99  | 8713.66  | 13802.65 |  |  |
| 85                     | N84°20'43"E | 40.39  | 8698.36  | 13723.87 |  |  |
| 86                     | N89°44'51"E | 40.00  | 8645.59  | 13724.93 |  |  |
| 87                     | N89°45'09"E | 40.00  | 8610.59  | 13725.14 |  |  |
| 88                     | N89°39'12"E | 40.00  | 8575.52  | 13725.35 |  |  |
| 89                     | N89°45'09"E | 40.00  | 8540.59  | 13725.57 |  |  |
| 90                     | N89°45'09"E | 40.00  | 8505.59  | 13725.78 |  |  |
| 91                     | N89°45'09"E | 40.00  | 8470.59  | 13725.99 |  |  |
| 92                     | N89°39'12"E | 40.00  | 8410.52  | 13726.35 |  |  |
| 93                     | N89°45'09"E | 40.00  | 8375.59  | 13726.56 |  |  |
| 94                     | N89°45'09"E | 40.00  | 8340.59  | 13726.78 |  |  |
| 95                     | N89°45'09"E | 40.00  | 8305.60  | 13726.99 |  |  |
| 96                     | N89°45'09"E | 40.00  | 8267.60  | 13727.22 |  |  |
| 97                     | S74°20'48"W | 39.84  | 8245.43  | 13576.73 |  |  |
| 98                     | S85°35'48"W | 39.84  | 8287.91  | 13567.88 |  |  |
| 99                     | S89°39'12"W | 40.36  | 8321.90  | 13566.89 |  |  |
| 100                    | S89°45'05"W | 40.36  | 8356.83  | 13566.67 |  |  |
| 101                    | S89°39'12"W | 39.66  | 8391.90  | 13566.48 |  |  |
| 102                    | S89°39'12"W | 39.77  | 8426.90  | 13566.38 |  |  |
| 103                    | S89°39'12"W | 40.43  | 8461.90  | 13566.13 |  |  |
| 104                    | S89°45'07"W | 40.42  | 8496.83  | 13565.89 |  |  |
| 105                    | S89°45'05"W | 40.36  | 8556.82  | 13565.47 |  |  |
| 106                    | S89°45'05"W | 40.31  | 8591.82  | 13565.23 |  |  |
| 107                    | S80°33'50"W | 39.98  | 8621.33  | 13564.19 |  |  |
| 108                    | S78°13'07"W | 40.35  | 8647.28  | 13560.35 |  |  |
| 109                    | N79°59'52"E | 39.64  | 8626.73  | 13482.83 |  |  |
| 110                    | N89°45'09"E | 40.03  | 8606.26  | 13485.04 |  |  |
| 111                    | N89°45'12"E | 39.64  | 8571.26  | 13485.38 |  |  |
| 112                    | N89°45'05"E | 39.86  | 8511.26  | 13485.88 |  |  |
| 113                    | N89°39'12"E | 39.98  | 8476.20  | 13485.97 |  |  |
| 114                    | N89°39'12"E | 40.00  | 8441.20  | 13486.16 |  |  |
| 115                    | N89°45'09"E | 40.00  | 8406.27  | 13486.37 |  |  |
| 116                    | N89°39'12"E | 40.00  | 8371.20  | 13486.59 |  |  |
| 117                    | N89°39'12"E | 40.00  | 8336.20  | 13486.80 |  |  |
| 118                    | N89°45'12"E | 39.65  | 8307.83  | 13486.99 |  |  |
| 119                    | N85°35'48"E | 40.47  | 8268.37  | 13489.48 |  |  |
| 120                    | N74°20'48"E | 39.14  | 8231.89  | 13498.50 |  |  |
| 121                    | S74°20'48"W | 34.63  | 8457.09  | 13327.69 |  |  |
| 122                    | S74°20'48"W | 34.63  | 8490.79  | 13318.26 |  |  |
| 123                    | S74°20'48"W | 34.64  | 8524.50  | 13308.82 |  |  |
| 124                    | S74°20'48"W | 34.65  | 8580.34  | 13293.16 |  |  |
| 19A                    | N74°20'48"E | 20.74  | 8610.69  | 13227.14 |  |  |
| 18A                    | S15°39'12"E | 12.21  | 8644.16  | 13254.59 |  |  |
| 10/1                   | 0.0 00 12 L | 12.21  | JU-7.10  | 10207.03 |  |  |

THE LOCATIONS OF EXISTING ABOVE GROUND AND UNDERGROUND UTILITIES ARE SHOWN IN AN APPROXIMATE WAY ONLY. THE CONTRACTOR SHALL DETERMINE THE EXACT LOCATION OF ALL EXISTING UTILITIES BEFORE COMMENCING WORK. THE CONTRACTOR SHALL BE FULLY RESPONSIBLE FOR ANY AND ALL DAMAGES WHICH MIGHT BE CAUSED BY HIS FAILURE TO EXACTLY LOCATE AND PRESERVE ANY AND ALL ABOVE GROUND AND UNDERGROUND UTILITIES.

THE WIDEFIELD WATER AND SANITATION DISTRICT RECOGNIZES THE DESIGN ENGINEER AS HAVING RESPONSIBILITY FOR THE DESIGN AND HAS LIMITED ITS SCOPE OF REVIEW ACCORDINGLY.

### WIDEFIELD WATER AND SANITATION DISTRICT WASTEWATER DESIGN APPROVAL


BY:

PROJECT NUMBER:

DATE:

IN CASE OF ERRORS OR OMISSIONS WITH THE WATER DESIGN AS SHOWN ON THIS DOCUMENT THE STANDARDS AS DEFINED IN THE "RULES AND REGULATIONS FOR INSTALLATION OF WASTEWATER MAINS AND SERVICES" SHALL RULE.

APPROVAL EXPIRES 180 DAYS FROM DESIGN APPROVAL

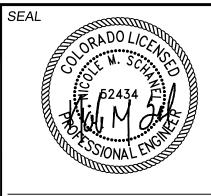

# TRAILS AT ASPEN RIDGE


FILING NO. 4 **8" SANITARY SEWER PLANS** 


# SANITARY SERVICE PLAN

| MATRIX DESIGN GROUP, INC.<br>PROJECT No. 21.886.038DRAWN BY:<br>CHECKED BY:JLW<br>NMSHORIZ.1" = 50'<br>VERT.N/ASHEET11 OF 12SS09 | FOR AND ON BEHALF OF   | DESIGNED BY: | BAS | SC     | ALE      | DATE ISSUED: | JUNE 2022 | DRAWING No. |
|--|------------------------|--------------|-----|--------|----------|--------------|-----------|-------------|
| PROJECT No. 21.886.038 CHECKED BY: NMS VERT. N/A SHEET 11 OF 12 0003   |                        |              |     | HORIZ. | 1" = 50' |              | 11 10     |             |
|  | PROJECT No. 21.886.038 | CHECKED BY:  | NMS | VERT.  | N/A      | SHEET        | 11 OF 12  | 0003        |



|         | MATCHLINE<br>SEE SHEET 11 - 1  | ss           |
|---------|--|--------------|
| .OT 2   | LOT 120  |              |
|         | PR 8" PVC PUBLIC   | .ot          |
|         | WATER MAIN<br>LOT 32<br>LOT 29   |              |
| 29      | LOT 28   |              |
|         | LOT 62   |              |
| OT 5    | LOT 59   |              |
|         | LOT 117 LOT 116 LOT 115 LOT 11<br>LOT 118 LOT 117 LOT 116 LOT 115 LOT 11   | <br> 4  <br> |
| LOT     | LOT 120  |              |
|         | LOT 102   LOT 103   LOT 104   LOT 10<br>LOT 101   LOT 101   LOT 101   LOT 104   LOT 104   LOT 104  | )5           |
|         | LOT 96   |              |
|         | LOT 90 LOT 89  |              |
|         | LOT 91   |              |
|         |  |              |
|         |  |              |
|         |  |              |
| FERENCE |  |              |
| -       | D. DATE DESCRIPTION  | B            |
|         | DATE DESCRIPTION   D. DATE DESCRIPTION   REVISIONS   OMPUTER FILE MANAGEMENT   E NAME: S:\21.886.038 (Trails F6)\100 Dwg\104 Plan Sets\Construction Plans\Utility Plans\Sanitary Plan\SS08.dwg   B FILE: Matrix(black).ctb | <br>         |

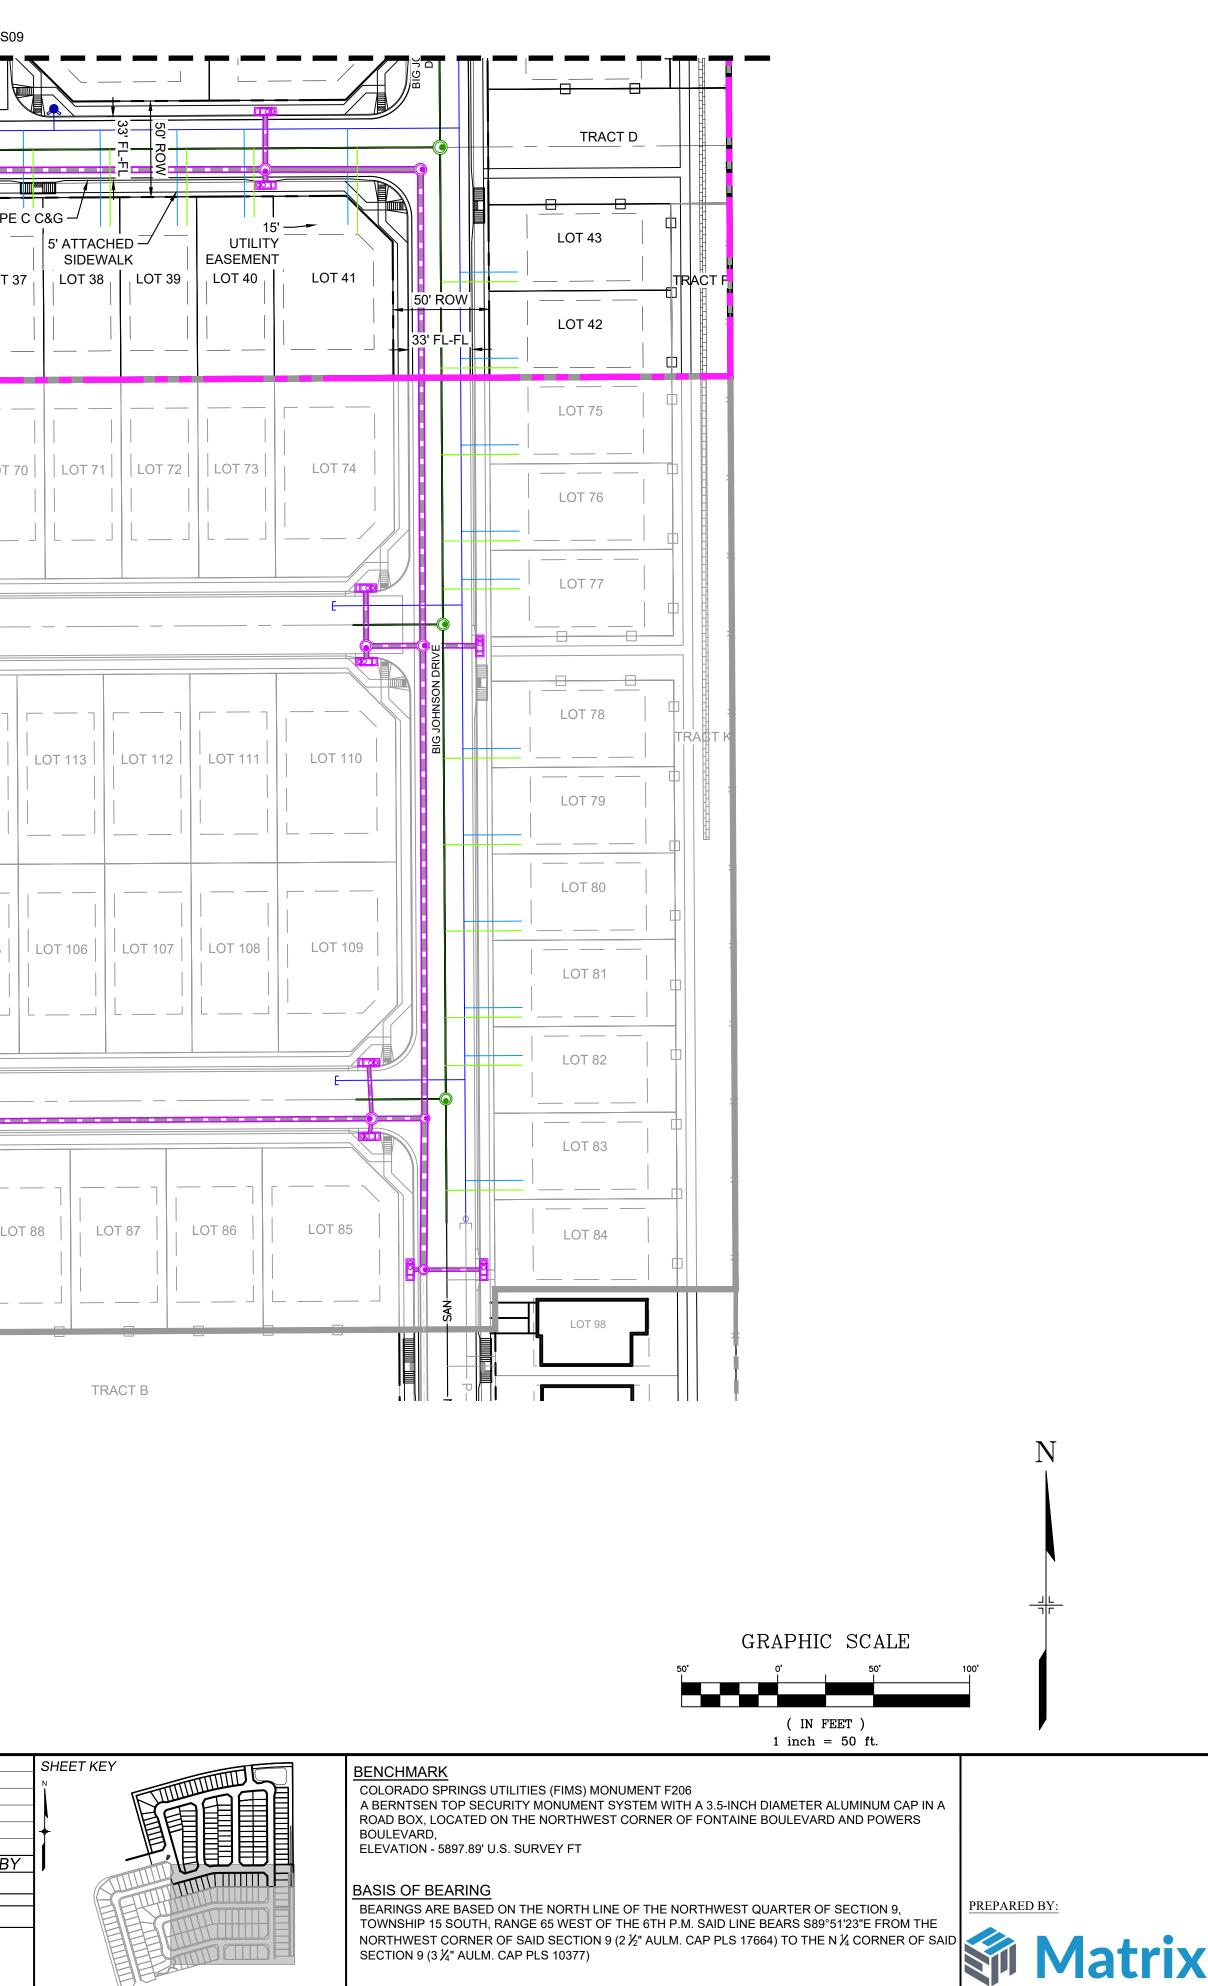

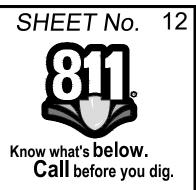

|       | SANITARY SERVICE TABLE           |       |         |          |  |  |  |  |
|-------|----------------------------------|-------|---------|----------|--|--|--|--|
| LOT # | # BEARING LENGTH NORTHING EASTIN |       |         |          |  |  |  |  |
| 27    | N15°39'12"W                      | 40.00 | 8104.72 | 13374.51 |  |  |  |  |
| 28    | N15°39'12"W                      | 40.00 | 8115.50 | 13412.98 |  |  |  |  |
| 29    | N15°38'07"W                      | 40.00 | 8126.30 | 13451.54 |  |  |  |  |
| 30    | N15°38'07"W                      | 40.00 | 8137.09 | 13490.05 |  |  |  |  |
| 31    | N15°38'07"W                      | 40.00 | 8147.89 | 13528.57 |  |  |  |  |
| 32    | N15°39'12"W                      | 40.00 | 8158.68 | 13567.09 |  |  |  |  |
| 33    | N11°35'48"W                      | 40.00 | 8169.36 | 13606.26 |  |  |  |  |
| 34    | N00°14'51"W                      | 40.00 | 8173.21 | 13675.72 |  |  |  |  |
| 35    | N00°14'51"W                      | 40.00 | 8173.46 | 13715.72 |  |  |  |  |
| 36    | N00°14'51"W                      | 40.00 | 8173.70 | 13755.72 |  |  |  |  |
| 37    | N00°14'51"W                      | 38.25 | 8175.69 | 13795.71 |  |  |  |  |
| 38    | N00°20'48"W                      | 40.00 | 8174.18 | 13835.78 |  |  |  |  |
| 39    | N00°14'51"W                      | 40.00 | 8174.42 | 13875.71 |  |  |  |  |
| 40    | N00°14'51"W                      | 40.00 | 8174.64 | 13910.71 |  |  |  |  |
| 41    | N00°14'16"W                      | 45.00 | 8169.96 | 13964.58 |  |  |  |  |
| 42    | S89°45'05"W                      | 40.36 | 8100.40 | 14048.23 |  |  |  |  |
| 43    | S89°45'12"W                      | 39.62 | 8145.26 | 14047.94 |  |  |  |  |
| 575   | S89°39'12"W                      | 40.36 | 8055.33 | 14048.51 |  |  |  |  |
| 576   | S89°39'12"W                      | 39.64 | 8010.33 | 14048.78 |  |  |  |  |
| 577   | S89°39'12"W                      | 39.64 | 7985.33 | 14048.93 |  |  |  |  |
| 578   | S89°39'12"W                      | 39.64 | 7897.20 | 14049.46 |  |  |  |  |
| 579   | S89°39'12"W                      | 40.36 | 7852.20 | 14049.74 |  |  |  |  |
| 580   | S89°39'12"W                      | 39.64 | 7807.20 | 14050.01 |  |  |  |  |
| 581   | S89°39'12"W                      | 40.00 | 7762.20 | 14050.28 |  |  |  |  |
| 582   | S89°39'12"W                      | 40.36 | 7737.20 | 14050.43 |  |  |  |  |
| 583   | S89°39'12"W                      | 40.00 | 7672.21 | 14050.82 |  |  |  |  |

THE LOCATIONS OF EXISTING ABOVE GROUND AND UNDERGROUND UTILITIES ARE SHOWN IN AN APPROXIMATE WAY ONLY. THE CONTRACTOR SHALL DETERMINE THE EXACT LOCATION OF ALL EXISTING UTILITIES BEFORE COMMENCING WORK. THE CONTRACTOR SHALL BE FULLY RESPONSIBLE FOR ANY AND ALL DAMAGES WHICH MIGHT BE CAUSED BY HIS FAILURE TO EXACTLY LOCATE AND PRESERVE ANY AND ALL ABOVE GROUND AND UNDERGROUND UTILITIES.

THE WIDEFIELD WATER AND SANITATION DISTRICT RECOGNIZES THE DESIGN ENGINEER AS HAVING RESPONSIBILITY FOR THE DESIGN AND HAS LIMITED ITS SCOPE OF REVIEW ACCORDINGLY.

#### WIDEFIELD WATER AND SANITATION DISTRICT WASTEWATER DESIGN APPROVAL


BY:

PROJECT NUMBER:

DATE:

IN CASE OF ERRORS OR OMISSIONS WITH THE WATER DESIGN AS SHOWN ON THIS DOCUMENT THE STANDARDS AS DEFINED IN THE "RULES AND REGULATIONS FOR INSTALLATION OF WASTEWATER MAINS AND SERVICES" SHALL RULE.

APPROVAL EXPIRES 180 DAYS FROM DESIGN APPROVAL

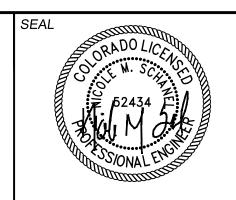

# TRAILS AT ASPEN RIDGE

FILING NO. 4 8" SANITARY SEWER PLANS

# SANITARY SERVICE PLAN

| MATRIX DESIGN GROUP, INC. DRAWN BY: JLW HORIZ. 1" = 50'<br>PROJECT NO. 21.886.038 CHECKED BY: NMS VERT N/A SHEET 12 OF 12 SS10 | FOR AND ON BEHALF OF | DESIGNED BY: | BAS | SCA             | ALE             | DATE ISSUED: | JUNE 2022 | DRAWING No. |
|--|----------------------|--------------|-----|-----------------|-----------------|--------------|-----------|-------------|
|  |                      |              |     | HORIZ.<br>VERT. | 1" = 50'<br>N/A | SHEET        | 12 OF 12  |             |