J61428

General Notes:

Soils Report and Foundation Design by a Licensed Colorado Engineer or Architect to be On Site at Time of First Inspection.

Verify All Foundation Steps with Actual On Site Conditions After Excavation.

Mechanical Notes:

<u>Plumbing:</u> Floor Drain Required within 10' of Water Heaters (Except Attic Units). Must have Backwater Valve if Located in Crawlspace.

Pipes in Exterior Walls must have R-11 Insulation for Freezing Protection.

Dryer Vent: Provide 100 SQ Inches of Makeup for Spaces Less Than 500 SF.

Max Vent Length 25 FT (Each 90 Elbow = 5 FT, 45 Elbow = 2-1/2 FT), Do Not Vent within 3 FT of Openings that Allow Air into Occupied Areas. Do Not Vent in the Same Room as a Gas Burning Appliance without Louvered Door.

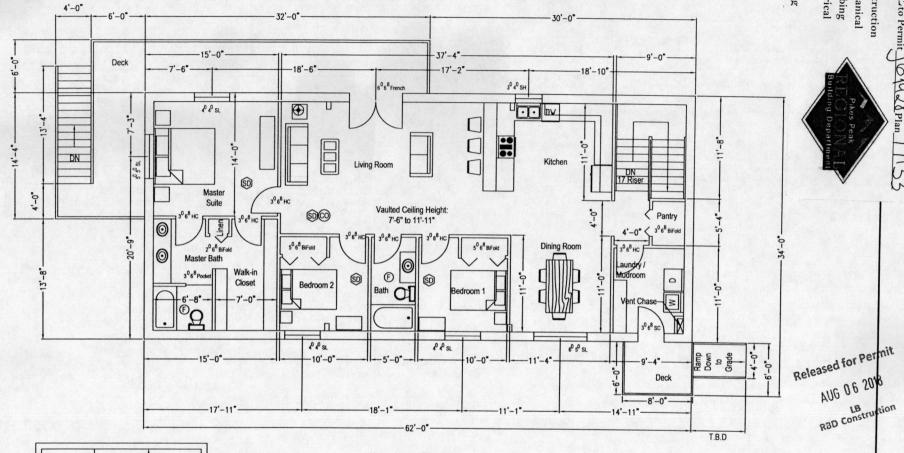
<u>Fireplace:</u> All New Installed Units Must be Listed with a Nationally Recognized Listing Agency such as UL.

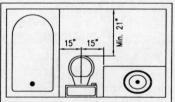
Electrical Notes:

A) Electrical Work Shall Conform to the National Electric Code and Any Applicable Local Codes.

B) Provide 110 V Hardwired Smoke Detectors, with Battery Backup, on All Floors and in Each Bedroom. Verify with Local Code Requirementsand Security System Contractor if Applicable. Do Not Install Within 3' of Peak or Heat Register, or Within 4' of a Corner or Wall. Wall Mounted Detectors Must Be Within 12" of Ceiling.

C) Provide Ground Fault Protection Per Code and on All New Kitchen, Bath and Garage Outlets.





This Layout is Only

Intended to Provide

Minimum Dimensional

References for Every

Bathroom. Fixtures or

Objects May Vary.

Typical Bathroom Dimension Layout
Not to Scale

Upper Level - Floor Plan

Project: 14-0518	
Sheet: 1 of 7	Project Name and Addre
Date: 21 Oct 2014	Tom Nogle 11980 Sand Place Lot # 3, Block # 1, Snyder Subdivision El Paso County, Colorado
Revised: 27 Feb 2015	
Revised: 13 Apr 2018	
Scale: 1/8" = 1'	
Drawn by: djp	
Checked by: cem	

GEOQUEST, LLC.

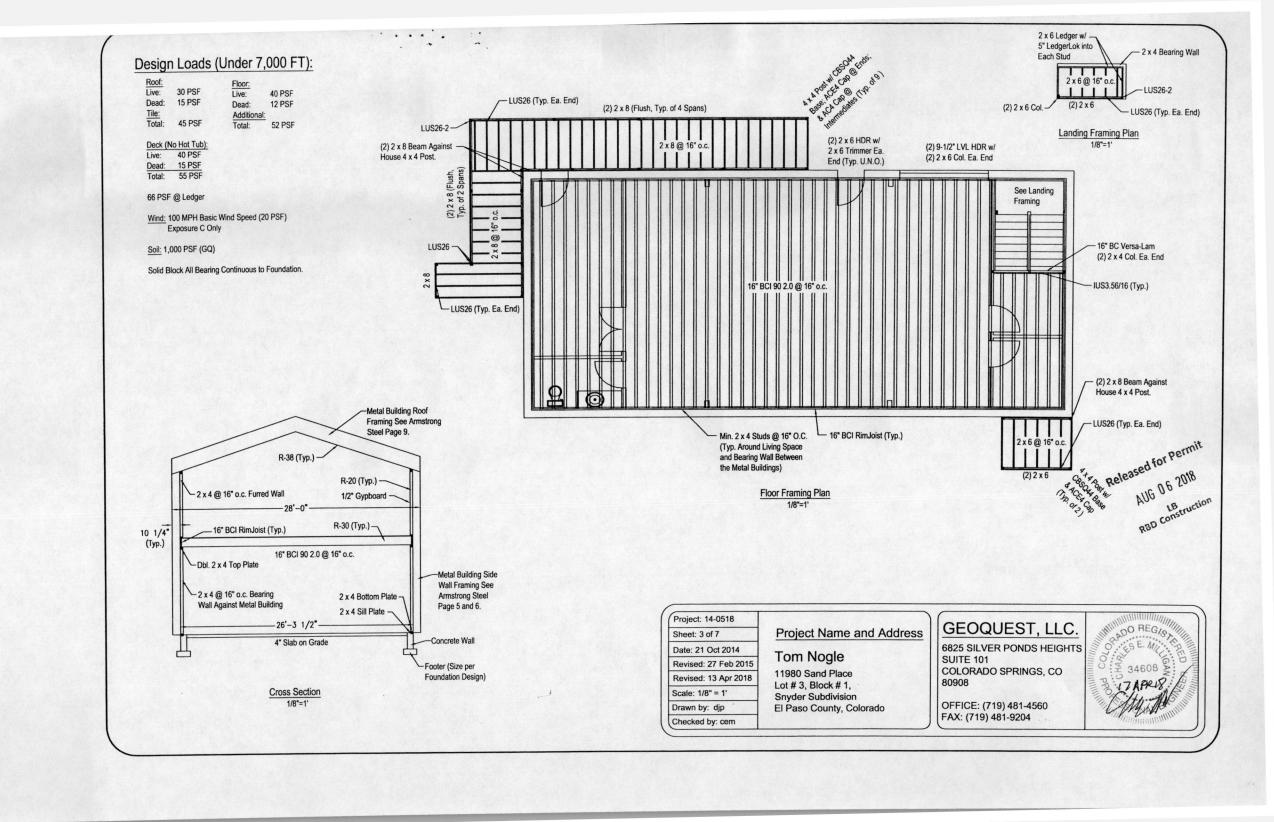
6825 SILVER PONDS HEIGHTS SUITE 101 COLORADO SPRINGS, CO 80908

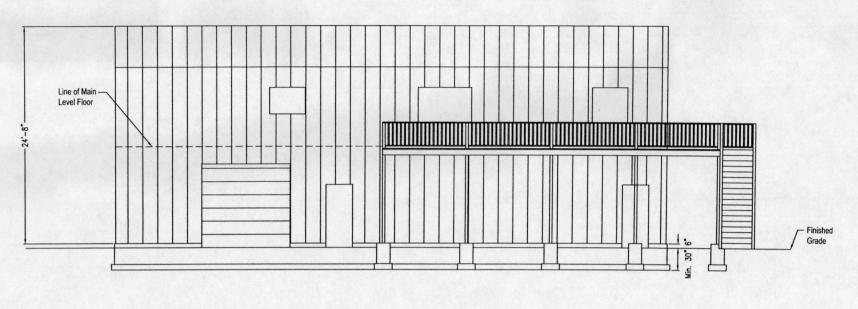
OFFICE: (719) 481-4560 FAX: (719) 481-9204

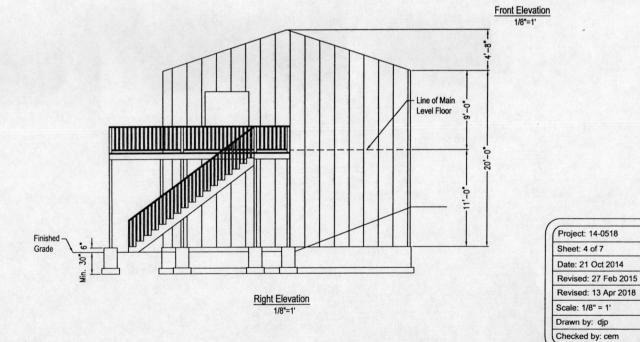


SPLICE to Perm

Com
O Mec
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O Elec
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Released for Permit

AUG 06 2018

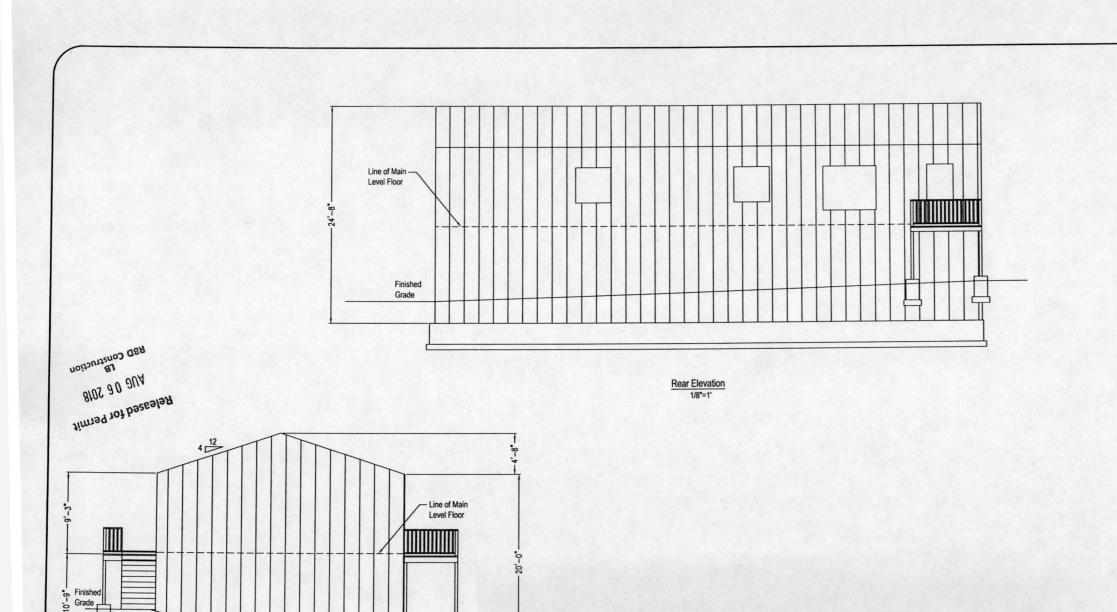
Project Name and Address

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11980 Sand Place Lot # 3, Block # 1, Snyder Subdivision El Paso County, Colorado GEOQUEST, LLC.
6825 SILVER PONDS HEIGHTS
SUITE 101
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80908

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Left Elevation 1/8"=1'

Project: 14-0518

Sheet: 5 of 7
Date: 21 Oct 2014

Revised: 27 Feb 2015 Revised: 13 Apr 2018

Scale: 1/8" = 1'

Drawn by: djp Checked by: cem Project Name and Address

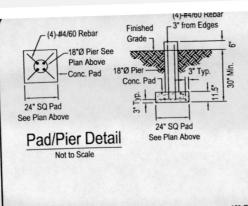
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Design Loads (Under 7,000 FT):

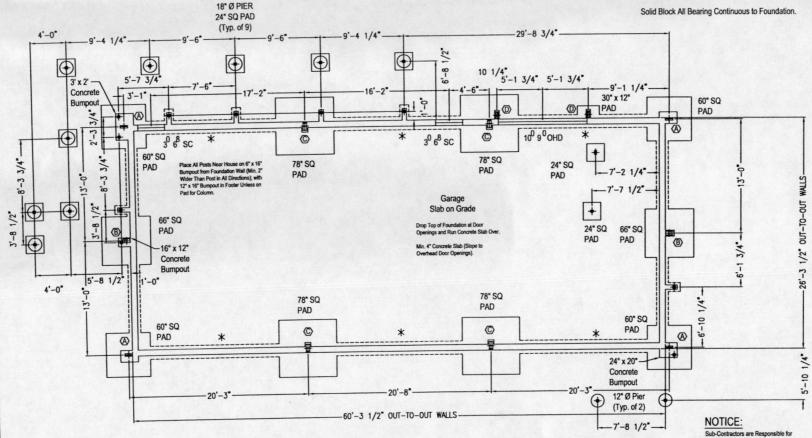
Roof:		Floor:	
Live:	30 PSF	Live:	40 PSF
Dead:	15 PSF	Dead:	10 PSF
Tile:		Additional:	
Total:	45 PSF	Total:	50 PSF

Deck (No Hot Tub): Live: 40 PSF Dead: 15 PSF Total: 55 PSF

66 PSF @ Ledger

Wind: 100 MPH Basic Wind Speed (20 PSF) Exposure C Only

Soil: 1,000 PSF (GQ)



All Pads 36" SQ to 54" SQ are 11.5" Thick, Reinforced with #4/60 Rebar @ 10" O.C.E.W.

60" SQ Pad - 11.5" Thick Reinforced with #4/60 rebar @ 6" O.C.E.W.

66" SQ Pad - 13.5" Thick Reinforced with #4/60 rebar @ 6" O.C.E.W.

78" SQ Pad - 13.5" Thick Reinforced with #4/60 rebar @ 6" O.C.E.W.

Foundation Design

16" Wide x 7.5" Thick Reinforced Concrete Footer Centered Under an 8" Reinforced Concrete Foundation Perimeter Wall, Reinforced with (2)#4/60 Rebar Continuous Held 3" from Bottom and Sides (U.O.N.)

* 18" Wide x 7.5" Thick Reinforced Concrete Footer Centered Under an 8" Reinforced Concrete Foundation Perimeter Wall, Reinforced with (2) #4/60 Rebar Continuous Held 3" from Bottom and Sides (Walls as Marked)

Ensuring that the Copy Being Used for Construction, is the Most Current, and

Matches the Approved (Stamped) Regional Building Set. See Armstrong Steel, Job Number: 53630 (Dated: 9/16/14) for Additional Information.
Any Updated Versions, Must be Presented to Engineer to Verify Foundation Elements

GENERAL NOTES

- 1. The Specifications, Soils Report, and Open Hole Letter are Part of this
- 2. Verify Location of Pads and Piers.
- 3. Load Bearing Components Susceptibile to the Weather Shall be Finished to a Minimum of 30" Below Grade and 6" Above Finished Grade.
- 4. Footer, Pad, and Pier Sizes Shown on this Design are a Minimum and may be Up Sized.
- 5. All Pads 36" SQ thru 54" SQ are 11.5" Thick, Reinforced with #4/60 Rebar @ 10" O.C.E.W. See Detail Sheet for Additional Information.
- 6. Wall Thicknesses Shown are Nominal. Wall Heights Vary, Refer to Architectural Drawings and Detail Sheets.
- 7. If Wall Heights Exceed 6 FT, or if Any Unforseen Conditions Arise, Contact the Engineer.
- 8. Refer to Detail Sheets for Reinforcement Schedule and Additional Information
- 9. Block-outs for Beam Pockets and Doorways are Required. See Architectural Drawings for Locations and Sizes.
- 10. Place the Concrete Slab or Other Suitable Lateral Restraint, in Addition to Floor Joists and Subfloor, Prior to Backfilling.
- 11. Place and Compact Backfill in Lifts Along the Entire Length of Wall. See Released for Permy Specifications.

FOUNDATION DESIGN:

1000 PSF (GQ) Special Soils Exist - See Soils Report Soil Bearing Must Be 1000 PSF or Higher for this Foundation Design to be Valid.

RBD Construc No. Revision/Issue/Change Revised Foundation to Support Revised Framing 27 Feb 2015 2 Revised Deck Location 13 Apr 2018

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6825 SILVER PONDS HEIGHTS SUITE 101 COLORADO SPRINGS, CO 80908

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Project: 14-0518	Project Name and Address
Sheet: 6 of 7	Tom Nogle
	Tomitogic

Date: 21 Oct 2014 Scale: 1/8" = 1' Drawn by: djp

Checked by: cem

11980 Sand Place Lot # 3, Block # 1, Snyder Subdivision El Paso County, Colorado