
By:Nina Ruiz Date:08/22/2019

El Paso County Planning & Community Development

This tiny house is being approved as a guest house meeting the requirements of both the guest house provisions as well as the tiny house on a single parcel. The guest house affidavit is required prior to placement.

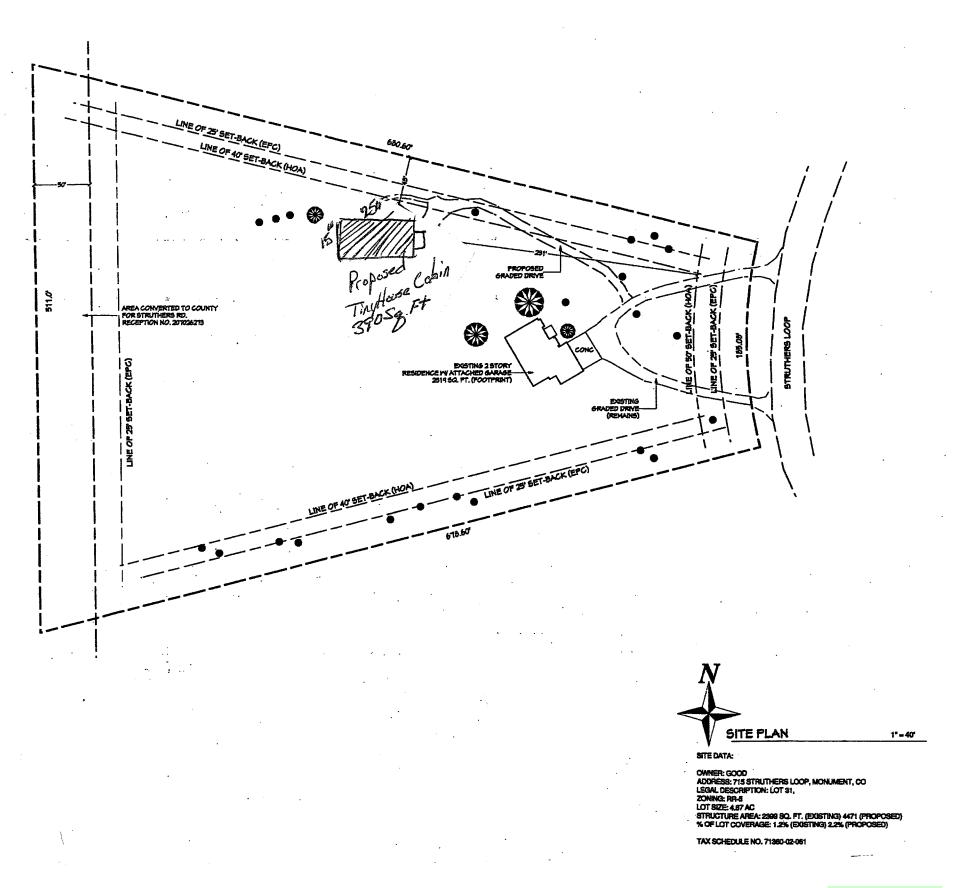

RELYSIONS ST.

mpass Remodel
ruckecompassemodelcom
prone 115-640-3331
0-640 Geoldence
obed Good Residence
free, loop Calanda Service

ODERT, J. MAIXNER, Architects Wedgefield Drive, Hilton Head Island South Carolina 19926 (TIS) 660-6183 RAMARCECEAGLOM



04 / 4 / 20k
SQUARE FOOTAG
Main Level
Upper Lot

INDEX
SD Site Plan
All Plan 4 Sport Loft Pla
A2 Elevation 4 Section
Si Roardstion Plan

DRAMN
RUM
CHICADO
RUM
DATE
03 / 31 / 2016
23 NO.
16 - 101
SHIRET NO.

SD-1

- 5.2.52. Tiny House, Single Lot
- (A) Applicability. The following standards apply to tiny houses used as a guest house or as a principle use on an individual lot or parcel. This section does not apply to tiny houses located in a Recreational Vehicle Park zoning district.
- (B) Number of Tiny Houses per Lot or Parcel. One tiny house shall be allowed as a principle use on an individual lot or parcel, except in the A-35 (Agricultural) zoning district where two tiny houses may be allowed. One additional tiny house may be allowed on an individual lot or parcel where a guest house is permitted.
- (C) Minimum Construction Standard. Tiny houses shall be constructed to ANSI RVIA standards. Tiny houses not constructed to ANSI RVIA standards shall be allowed with certification by a licensed professional structural engineer certifying that, at a minimum, the unit and support structure has been designed in accordance with all applicable horizontal and vertical loads as required by the local authority having jurisdiction.
- (D) Exterior Appearance Single-Family in Character.
- (1) All tiny houses shall be designed and constructed so as to comply with the following:
- Be finished on all sides with finished wood panel siding, vinyl siding, brick or stone veneer siding, stucco finish siding, other architecturally finished veneer, or with other types of siding as approved by the PCD Director;
- Have no attached motor as the means of propulsion;
- Have premanufactured insulated residential grade exterior doors;
- Have premanufactured insulated residential grade windows; and
- Have residential style/type roofing materials.
- (2) Tiny Houses shall have a minimum of four of the following design features:
- More than one type of exterior siding listed above in subsection D.1 on a single side in an integrated manner;
- Upgraded entry feature, such as transom or side windows around an exterior door;
- Exterior accessories, such as permanent shutters, or fixed sunshade devices, or gutters/downspouts;
- Pitched roofline (3:12 pitch or steeper);
- · Dormers;
- · Premanufactured skylights;
- Built-in porch or deck;
- Exterior residential light sconces or downcans; or
- Other features as otherwise approved by the PCD Director.

The provision of more than one item within the same category of design features may be counted independently towards the overall minimum requirements (e.g., including both a sunshade and shutters).

- (E) Screening. Tiny house wheels, running gear, and hitch components shall be either:
- Removed and the tiny houses set on a platform;
- Screened from view with skirting of the same exterior siding and materials as the tiny house;
- Screened from view via placement on a subsurface pad serving as a foundation and with integrated plantings and landscaping; or
- Screened with other methods as otherwise approved by the PCD Director.
- (F) Interior Storage of Water Prohibited. No interior water storage tank, unless otherwise approved as an integrated water system by the PCD Director in consultation with El Paso County Public Health, shall be allowed within a tiny house.
- (G) Storage of Wastewater Prohibited. No interior storage of wastewater, unless approved by the PCD Director in consultation with El Paso County Public Health, shall be allowed within a tiny house.
- (H) Proof of Utilities. Proof of electric, natural gas, and/or propane availability is required. Proof of water and wastewater service is required unless otherwise approved by the PCD Director pursuant to subsections F and G above. Electrical, natural gas, propane, water, and wastewater connections must meet the requirements of the utility provider and/or El Paso County Public Health, as appropriate. Individual wells and on-site wastewater treatment systems (OWTS) shall be permitted in accordance with state and local regulations. A permit from the local jurisdiction having authority is required for electrical, gas, propane, and plumbing connections.
- (I) Tiny House Site Plan Review Required. A tiny house site plan application shall be applied for and approved prior to the placement of the tiny house on an individual lot or parcel. Tiny house residential site plan applications shall, at a minimum, consist of the following:
- Proof of ANSI RVIA construction or certification by a licensed professional structural engineer;
- Elevation drawings of the tiny house to include the method of screening/skirting and identification of the type of siding material(s);
- Floorplan of the tiny house;
- Proof of utilities;
- · Applicable landscaping plan with subsurface pad; and
- Additional documentation as required by the PCD Director that may be necessary, in his or her opinion, to approve the site plan.

MEMORANDUM OF

SUPPLEMENTAL INSTRUCTIONS

Date: August 13, 2019

Subject: Tiny House Review and Foundations

Project: David and Camilla Good Tiny Home

Address: Struther's Loop, Colorado Springs, CO (Lot 31 Cahparral Hills Su

Work Code:

Requested By: David and Camilla Good

Company: Homeowner
Completed By: Redge Hudson, P.E.
Reviewed By: Redge Hudson, P.E.

Distribution: Kevin Olsen - Olsen Construction

Total Pages: 1
(INCLUDING THIS SHEET)




Remarks:

The attached tiny house was reviewed and was designed in accordance to the minimum design standards as set for by PPRBD namely wind zone 1, thermal zone 3 and a design roof load of 30 psf. The homeowner shall note that the tiny home shall be installed on 24" diameter drilled pier that extends a minimum of 36" below grade. Affix a 12" sq. by 1/2" thick steel plate with (4)1/2" diameter headed anchor studs. The dircular footing shall be install as noted on the manufacturer's plans. Weld the carrying beams to the steel plates with 3/16" fillet weld, a minimum of 4" long. The homeowner shall take care during winter months to mitgate snow removal from the roof. No other revisions to the structural are required for life safety or code compliance.

To the best of my knowledge, the structural work has been completed in conformance with the structural construction documents. Should you have any further questions, please don't hesitate to contact Redge Hudson, P.E. at 385-203-7170

SPECIAL ONE UNIT ONLY: PM077

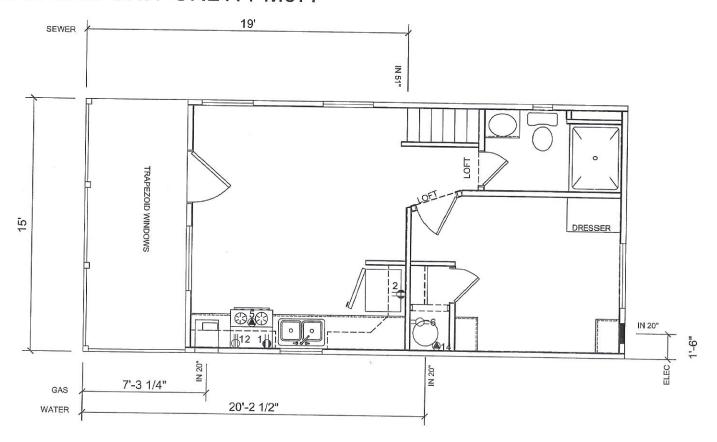

	APPROVER'S SEAL	MODIFICATIONS	MODEL: 05-514-	FD-LOFT-MIRRO	SIETT
CHAMPION			390 SQ FT 1 BE	EDROOM 1 BATH W/DECK	NED 1
			SERVICE ENTRANCES S-10		S-101
		PROPRIETARY AND CONFIDENTIAL THESE DRAWINGS AND SPECIFICATIONS ARE ORIGINAL,	DRAWN BY: STAFF	DATE: 04-22-13	
3200 ENTERPRISE AVE. YORK, NE 68467		PROPRIETARY AND CONFIDENTIAL MATERIALS OF CHAMPION. COPYRIGHT © 1976-2012 BY CHAMPION	SCALE: 1/8" = 1'-0"		


SPECIAL ONE UNIT ONLY: PM077


PIER NOTES

20 PSF ROOF LOAD MAX.	30 PSF ROOF LOAD MAX.
2000 PSF SOIL MIN. 8'-0" O.C. SPACING MAX. 14' / 28' WIDE - 20" × 20" × 6" FOOTING 16' / 32' WIDE - 20" × 20" × 6" FOOTING	2000 PSF SOIL MIN. 8'-0" O.C. SPACING MAX. 14' / 28' WIDE - 21" x 21" x 6" FOOTING 16' / 32' WIDE - 22" x 22" x 7" FOOTING
NOTE: FOR AL	OTHER INCORMATION

NOTE: FOR ALL OTHER INFORMATION SEE CHAMPION HOMES SET-UP MANUAL.

PIER LEGEND

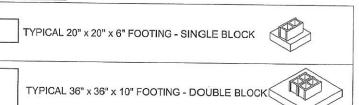

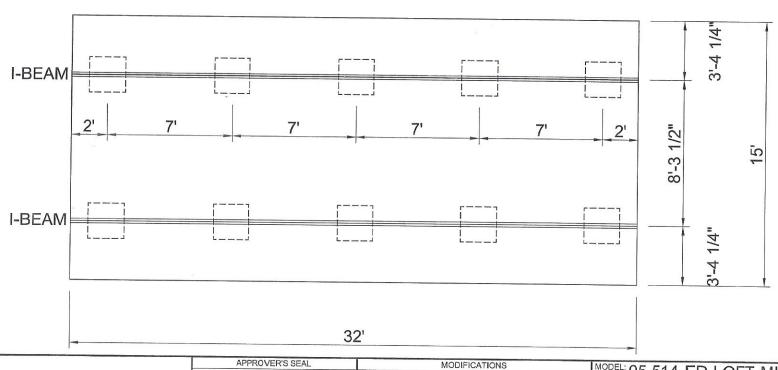

CHAMPION

PROPRIETARY AND CONFIDENTIAL THESE DRAWINGS AND SPECIFICATIONS ARE ORIGINAL, PROPRIETARY AND CONFIDENTIAL MATERIALS OF CHAMPION. COPYRIGHT @ 1976-2012 BY CHAMPION

390 SQ FT 1 BEDROOM 1 BATH W/DECK

F-101 PIER FOUNDATION

DRAWN BY: STAFF DATE: 04-03-13 SCALE: 1/8" = 1'-0"


3200 ENTERPRISE AVE. YORK, NE 68467


PIER NOTES

20 PSF ROOF LOAD MAX.	30 PSF ROOF LOAD MAX.
2000 PSF SOIL MIN.	2000 PSF SOIL MIN.
8'-0" O.C. SPACING MAX.	8'-0" O.C. SPACING MAX.
14' / 28' WIDE - 20" x 20" x 6" FOOTING	14' / 28' WIDE - 21" x 21" x 6" FOOTING
16' / 32' WIDE - 20" x 20" x 6" FOOTING	16' / 32' WIDE - 22" x 22" x 7" FOOTING

NOTE: FOR ALL OTHER INFORMATION SEE CHAMPION HOMES SET-UP MANUAL.

PIER LEGEND TYPICAL 20" x 20" x 6" FOOTING - SINGLE BLOCK O TYPICAL 36" x 36" x 10" FOOTING - DOUBLE BLOCK

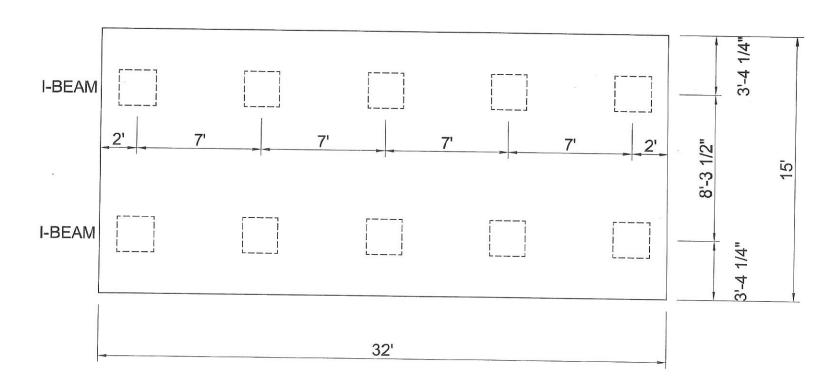

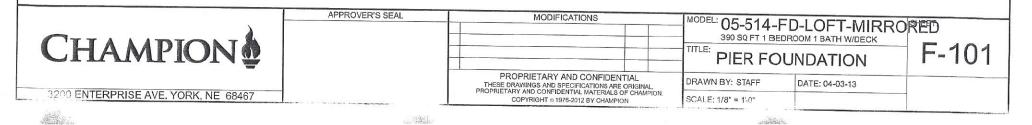





Form No. GWS-25.

OFFICE OF THE STATE ENGINEER COLORADO DIVISION OF WATER RESOURCES

818 Centennial Bldg., 1313 Sherman St., Denver, Colorado 80203 (303) 866-3581

797

APPLICANT

WELL PERMIT NUMBER DES. BASIN MD WD DIV. 2

Lot: 31 Block: Filing: Subdiv: CHAPARRAL HILLS

APPROVED WELL LOCATION **EL PASO COUNTY**

NW 1/4 Section 36 SE 1/4

6th P.M. 11 S RANGE 67 W

HERBERT HAROLD AND CAROL M PRICE 4070 IRON HORSE TRAIL CO SPGS CO 80917

(719)591-8971

DISTANCES FROM SECTION LINES

Section Line North

1900 Ft. from 1600 Ft. from

West

Section Line

PERMIT TO CONSTRUCT A WELL

ISSUANCE OF THIS PERMIT DOES NOT CONFER A WATER RIGHT CONDITIONS OF APPROVAL

- This well shall be used in such a way as to cause no material injury to existing water rights. The issuance of the permit does not assure the applicant that no injury will occur to another vested water right or preclude another owner of a vested water right from seeking relief in a civil court action.
- The construction of this well shall be in compliance with the Water Well Construction and Pump Installation Rules 2 CCR 402-2, unless approval of a variance has been granted by the State Board of Examiners of Water Well Construction and Pump Installation Contractors in accordance with Rule 17.
- Approved pursuant to CRS 37-92-602(3)(b)(II)(A) as the only well on a residential site of 5.22 acres described as Lot 31, Chaparrall Hills Subdivision, El Paso County.
- The use of ground water from this well is limited to ordinary household purposes inside a single family dwelling and the watering of the user's noncommercial domestic animals. The ground water shall not be used for irrigation or other purposes.
- Production from this well is restricted to the Denver aquifer which corresponds to the interval between 170 feet and 835 feet below ground surface. Plain casing shall be installed and sealed to prevent production from other zones.
- The maximum pumping rate shall not exceed 15 GPM.
- The return flow from the use of the well must be through an individual waste water disposal system of the non-evaporative type where the water is returned to the same stream system in which the well is located.
- This well shall be constructed not more than 200 feet from the location specified on this permit.

To insure a maximum productive life of this well, perforated casing should be set through the entire producing interval of the approved zone or aquifer indicated above.

Note: Permit No. 135135 (expired) was previously issued on April 23, 1984, for this lot. MAS & 31-93

APPROVED

MAS

0354661 Receipt No.

JUN 3 0 1993 DATE ISSUED

JUN 3 0 1995 **EXPIRATION DATE**

NOTE: It is the responsibility of the applicant to ensure compliance with the Colorado Division of Water Resources. The applicant must contact the State to verify they do not require an additional permit or modification of this permit in order to utilize the same well permit for the tiny house.



Environmental Health Division

1675 W. Garden of the Gods Rd., Saine 2044 Colorado Springs, GO 80907 (719) 578-3199 photo (719) 575-3188 fax www.clpasocountyhealth.org

Prevent • Promote • Protect

CONVENTIONAL (NON-ENGINEERED) ON-SITE WASTEWATER TREATMENT SYSTEM (OWTS) DESIGN WORKSHEET (MUST BE COMPLETED FOR ALL CONVENTIONAL DESIGNS)

Wastewater Flow	
Total number of bedrooms:	
Design wastewater flow (gallons/day) from Table 6-1:	<u> </u>
Septic Tank	
Septic tank size (in gallons) from Table 9-1:	1500 (1250)
Tank burial depth (from top of tank, in inches) (NOTE: Shall not exceed 48 inch depth by regulation)	36"
Will groundwater affect tank?	Yes No
Will an effluent screen be installed?	Yes No
(Note: Effluent screens are required for all new systems or	replacement of the septic tank)
Soil Treatment Area (STA) Long Term Acceptance Rate (LTAR) From Table 10-1:	. 50
tong Term Acceptance hate (CIAN) From Table 10-1.	
Unadjusted STA size (see 8.10.C.4) – show calculation:	875
<u>Design flow (gallons per day)</u> LTAR (gallons/day/sq.ft.) =	41250 368 5
Depth of STA (cannot exceed 48"):	
Tre	nches are preferred. If bed system is selected,
the selection reason must be specified:	
Type of STA (check which applies):	FOR REPAIRS ONLY (check which applies):
Æ Trench □ Bed	☐ Wide Bed (more than 12 feet wide)
	Deep Gravel Trenches
	☐ Seepage Pit☐ None of the Above

Method of Septic Tank Effluent Application (check wh	ich applies):
☐ Gravity ☐ Pump to gravity	
Dispersed by siphon	
Type of Distribution Media (check which applies):	
□ Rock	
☐ Tire chips	
Other	Other type
Adjusted STA size, using factors from Table 10-2 & 10-3 (show ca	alculation, with adjustment factors utilized):
 Depths of all components (or elevation) Location of the soil profile test pit excess Location of the alternate STA site North direction arrow Graphic scale (1"= 20", 1"= 30", etc.) Contours, OR slope direction and % slopes Note: It is recommended that the design document is completed.	TA configuration (trench, bed, etc.) I(s) distances to all applicable physical features in Table 7-1 his relative to a designated benchmark) evation(s), or percolation test holes, if required the professional in the OWTS industry. EPCPH does not
The proposed STA sites must be protected from disturbance.	
other effective methods.	compaction, or other damage by staking, renemg, posting c
Certification	7 · 1 -
f & CElin	Broder Exerus Tlag
Signature	Company Name
	Company Name
MICHAN TOROGRAMS	5510052 NI
Print Name 8 - 9- 16	719-338-4630
Date	Ohana
715 STN there COOP	2. brodera D Q. Com
Property Address	Email

(See attached Tables and Design Document examples)

9/2014




Existing Soil Treatment Area (STA) is abandoned..

Prevent • Promote • Protect

1675 W. Garden of the Gods Rd., Suite 2044 Colorado Springs, CO 80907 (719) 578-3199 plune (719) 575-8664 fax: www.elpasocountyhealth.org

ON-SITE WASTEWATER TREATMENT SYSTEM INSPECTION FORM	ON-SITE ID: <u>ON0036190</u> P APN # _7136002061 DATE: <u>8/29/2016</u>
APPROVED YES NO Environmental Health Specialist: Janet Chri Address: 715 Struthers Loop 80921 Owner: Residence: #Bedrooms: 4 Commercial: System Installer: Broders Excavating SEPTIC TANK: Construction Material Concrete (Installed 6/4/97)	<u>istensen</u> <u>David Good.</u> Capacity Gallon <u>1500</u>
SOIL TREATMENT AREA: Trench: Depth (Range): Width: Total Length: Sq. Ft.: Bed: Depth (Range): Width: Total Length: Sq. Ft.: Depth of Rock: Under PVC: Type of cover on Rock:	
SEEPAGE PITS: # of Pits: Working Depth #1: #2: Size (L x W) #1	#2 Total Sq. Ft
CHAMBER SYSTEMS:	
Type of Chamber: <u>ARC 36</u> #Chambers: <u>42</u> Sq. Ft./Chamber: <u>15</u> Bed: Trench: <u>875</u> Sq. Ft. Required (10-2): <u>875</u> Sq. Ft. Required (10-3): <u>613</u> Sq. Ft. Required	
Sq. Ft. Installed: 624	_
Engineer Design: Y N Engineering Firm: Approval Letter Provided: Y Well installed at time of OWTS Inspection: Y N N Public Water: Y N N N N N N N N N N N N N N N N N N	1
110/103	

It is the responsibility of the applicant to verify the existing septic system may be utilized for the tiny house and that no additional permits or approvals are required. The applicant must contact EPC Health to verify compliance.

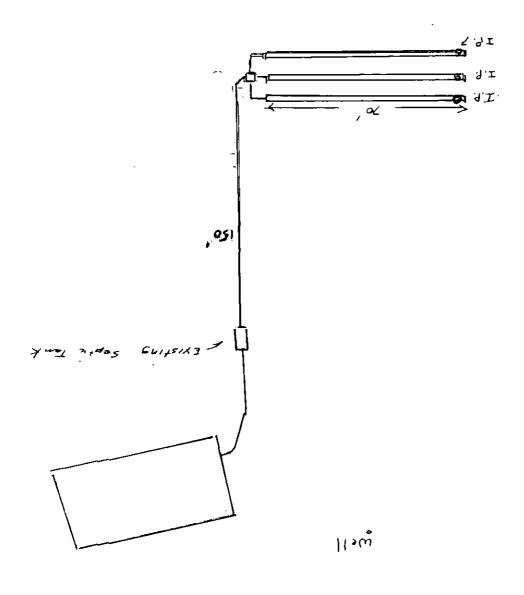

Struttures Loop

As-Built Strutters Loop 715 Strutters Loops 120,002 SIT WAA 120,002 12016

Z

Notify Environmental Health of any change of ownership, type of business activity, business name, or billing address by calling (719) 578-3199. Failure to notify Environmental Health may result in late penalties, Permit/License denial or revocation, and business closure. PERMITS/LICENSES TO OPERATE AND ANNUAL FEE PAYMENTS ARE NOT TRANSFERABLE. Permits become void on change of ownership. New owners must apply and pay for a new Permit(s)/License(s) prior to beginning operation.

Attn: DAVID GOOD

715 STRUTHERS LOOP COLORADO SPRINGS, CO

80921-2432



EL PASO COUNTY PUBLIC HEALTH ENVIRONMENTAL HEALTH DIVISION

1675 W. GARDEN OF THE GODS ROAD, SUITE 2044 COLORADO SPRINGS, CO 80907 PHONE: (719) 578-3199 FAX: (719) 578-3188 www.elpasocountyhealth.org

MAJOR REPAIR PERMIT - OWTS

Valid From 8/23/2016 To 8/23/2017

PERMITEE:

DAVID GOOD 715 STRUTHERS LOOP COLORADO SPRINGS, CO 80921-2432

Onsite ID: ON0036190
Tax Schedule #: 7136002061

Permit Issue Date: 08/23/2016

Dwelling Type: RESIDENTIAL

OWNER NAME:

GOOD DAVID A

of Bedrooms (if Res): 4
Proposed Use (if Comm):
Designed Gallons/Day:

Water Source: PRIVATE WELL

System Installation Requirements:

- The existing On-Site Wastewater Treatment System (OWTS) was installed for 3 bedroom Sep. 1994. A 1250 gallon septic tank and 360 square feet of chambers in a trench.
- A major repair was installed June 1997. The installation was for a 4 bedroom. The existing 1250 septic tank was abandoned and a new 1500 gallon tank installed and an additional trench with chambers of 361 square feet for total 721 square feet of Soil Treatment Area (STA).
- The existing STA is failing and will be abandoned and a new STA installed.
- A minimum of 613 square feet in a trench configuration per approved design document will be installed.
- The existing septic tank has been pumped and inspected for sound condition.

The OWTS must be installed per the stamped and approved Design Document dated 08/23/2016.

This permit is issued in accordance with 25-10-106 Colorado Revised Statutes. The PERMIT EXPIRES upon completion/installation of the Onsite Wastewater Treatment System, or at the end of twelve (12) months from date of issue, whichever occurs first. If both a Building Permit and an Onsite Wastewater Treatment System Permit are issued for the same property and construction has not commenced prior to the expiration date of the Building Permit, the Onsite Wastewater Permit shall expire at the same time as the Building Permit. This permit is revocable if all stated requirements are not met. The Onsite Wastewater Treatment System must be installed by an El Paso County Licensed System Contractor, or the property owner

The Health Officer shall assume no responsibility in case of failure or inadequacy of an Onsite Wastewater Treatment System, beyond consulting in good faith with the property owner or representative. Access to the property shall be authorized at reasonable time for the purpose of making such inspections as are necessary to determine compliance with the requirements of this law (permit).

Inspection request line: Call (719) 575-8699 before 8:30 a.m. of the day that the inspection is requested Weekends & Holidays excluded.

Authorized By: Environmental Health Specialist



Environmental Health Division

1675 W. Garden of the Gods Rd., Suite 2044 Colorado Springs, CO 80907 (719) 578-3199 phone (719) 578-3188 fax www.elpasocountyhealth.org

Prevent • Promote • Protect

APPLICATION FOR AN ON-SITE WASTEWATER TREATMENT SYSTEM PERMIT	
■ NEW PERMIT ■ MAJOR REPAIR PERMIT ■ MINOR REPAIR PERMIT	
Owner David Good Daytime Phone	
System Installer Broders Exc Daytime Phone 719- 338-4630	
Property Address 7/5 3 Tru Head Coop City and Zip 8 0921	
Legal Description 607 31 CHUNNIANI HILLS EXOT CONV. TO COUNTY 207 02 6273	
Owners Mailing Address 5'd me	
Email Address 2 brode14 0 Q, Com Fax #	
Tax Schedule # 7/36 0020 6/ Lot Size 5 Ac	
Site Located Inside City Limits Yes No Primary Contact Owner Contractor	
Proposed Use: Single Family Multi-Family Commercial	
Water Supply:	
CURRENT FEES AS APPROVED BY THE EI PASO COUNTY BOARD OF HEALTH	
New Permit: \$685.00 (EPCPH Charge) + \$147.00 (EPC Planning Dept. Surcharge) + \$23.00 (CDPHE Surcharge) = \$855.00	
<u>Major Repair Permit:</u> \$525.00 (EPCPH Charge) + \$23.00 (CDPHE Surcharge) = \$548.00	
Minor Repair Permit: \$240.00 (EPCPH Charge) + \$23.00 (CDPHE Surcharge) = \$263.00	
All Payments are due at the time of application submittal; by cash, check or major credit card (Visa / MC) This permit will expire one year from the date of issuance.	
1 certify that the information provided on this application is in compliance with Section 8.3, Chapter 8 of the Onsite Wastewater System (OWS) Regulations of the El	
Paso County Board of Health. I also authorize the assigned representative of El Paso County Public Health to enter onto this property in order to obtain information	
Applicants Signature: Date: 8 9-16	
Applicants Signature: Date: 0770	
Site Insp. Date: 8-11-16 Perc. Rate: LTAR? 0.60 Permit #0N0036190	
E.H.S. Review Notes: Leather Chans Rd off Bantist Rd	
Buck of house faces I: 25 0	
3 Soil Test Pits done Aug. 19, 2016. Test Pit 3 location usa	۹
Date to: E.P.C. Development Services N/A Flood Plain and Enumerations N/A	
Permit Requirements: design + ow 525	
Conventional	
875 x 1.0 = 875	
- 0 13 K 1.0 - 8/3	

Min. Absorption Area

Reviewed 2016 approved fee (12/30/2015)

/ Josep X

10-

Min. Septic Tank Capacity

Approved Denied



APN - 7:13:6002061



ENTECH

505 ELKTON DRIVE COLORADO SPRINGS, CO 80907 PHONE (719) 531-5599 FAX (719) 531-5238

August 19, 2016

Broders Excavation 557 Rose Drive Colorado Springs, Colorado 80911

Attn: Richard Broders

Re: Test Pit Observation - OWTS Repair

715 Struthers Loop El Paso County, Colorado

Dear Mr. Broders:

As requested, personnel of Entech Engineering, Inc. have observed the excavation of three test pits at the above referenced site. This letter presents the results of our testing.

The following recommendations are based on conditions observed on August 16, 2016. Entech Engineering, Inc. should be notified if any changes in conditions are encountered or if the proposed absorption field location should change. A Test Pit Location Map is included as Figure 1.

Soil types observed in the test pit excavations were found to consist of sand, sandy clay loam and clay overlying weathered to formational sandstone. Grain size analysis of the upper sand soils resulted in 4 to 21 percent or the soil particles passing the No. 200 sieve. Weathered to formational sandstone bedrock was encountered at approximately 4 to 5 feet in Test Pit Nos. 1 and 2, which were excavated to depths 5 to 8 feet. Bedrock was not encountered in Test Pit No. 3, which was excavated to 8 feet. Signs of seasonal groundwater were observed at depths of approximately 4 to 5 feet in Test Pit Nos. 1 and 2, and at approximately 7 feet in Test Pit No. 3. Test Pit logs are presented in Figures 2 and 3.

Based on the soils observed the area of Test Pit No. 3 has been chosen for the new OWTS field location. A LTAR Value of 0.60 for Treatment Level 1 is recommended for the design of the field repair. The field should be sized based on the number of bedrooms and anticipated usage. If gravity flow is not possible, a pump and pumping chamber will be required. A minimal separation of 4 feet is required between the absorption field and the groundwater or bedrock.

The absorption field should be installed in accordance with El Paso County Health Department regulations.

Broders Excavation
Test Pit Observation – OWTS Repair
715 Struthers Loop
El Paso County, Colorado
Page Two

We trust this has provided you with the information you required. If you have any questions or need additional information, please do not hesitate to contact us.

Respectfully Submitted,

ENTECH ENGINEERING, INC.

Logan L. Langford


Geologist

LLL/crf

Encl.

Entech Job No. 161641 AAproject/2018/161641 tpo Reviewed by:

Goode, Jr., P.E.

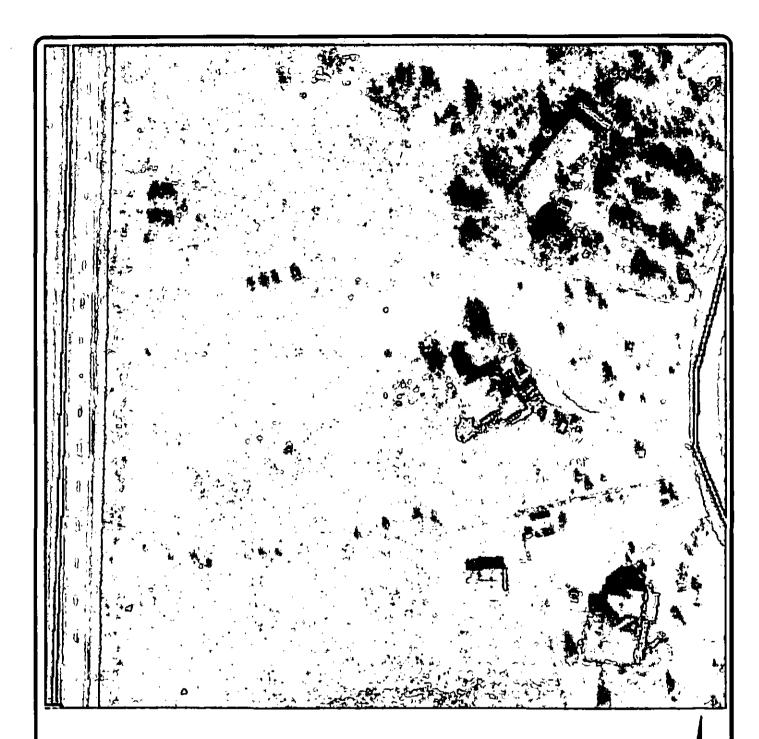



TP- APPROXIMATE TEST PIT LOCATION AND NUMBER

\P

BM- APPROXIMATE BENCHMARK LOCATION 39°3'2.51"N, 104°50'40.42"W

- 270' N X 180' W OF BM



ENTECH ENGINEERING, INC. Site Plan/Test Pit Location Map 715 Struthers Loop El Paso County, CO. For: Broders Excavation

DRAWN: DATE: CHECKED: LLL 8/19/16

JOB NO.: 161641

FIG NO.:

DATE:

TEST PIT NO. 2 **TEST PIT NO.** DATE EXCAVATED 8/16/2016 DATE EXCAVATED 8/16/2016 **BRODERS EXCAVATION** Job # 161641 CLIENT LOCATION 715 STRUTHERS LOOP REMARKS REMARKS Natercontent % Natercontent % Blows per foot Blows per foot Soil Type Samples K Symbol topsoil - sandy loam, fine to topsoil - sandy loam, fine to coarse grained, dark brown coarse grained, dark brown 2 sand, fine to coarse grained sand, fine to coarse grained with gravel, tan with gravel, tan 3 3 sandy clay loam, fine to coarse grained, grayish tan sandstone, fine to coarse grained, tan sandstone, very silty, fine grained, tan sandstone, fine to coarse grained, tan 8

ENTECH ENGINEERING, INC. 505 ELKTON DRIVE
COLORADO SPRINGS, COLORADO 8

TEST PIT LOG			
DRAWN:	DATE:	CHECKED:	DATE: Q/14//6

JOB NO: [4]64] FIGNO:

TEST PIT NO. **TEST PIT NO.** 3 DATE EXCAVATED 8/16/2016 DATE EXCAVATED 8/16/2016 Job# 161641 CLIENT **BRODERS EXCAVATION** LOCATION 715 STRUTHERS LOOP REMARKS REMARKS Natercontent % Watercontent % Blows per foot **Blows per foot** Depth (ft) Symbol Samples Samples Soil Type Depth (ft) K Symbol topsoil - sandy loam, fine to coarse grained, dark brown 1 2 sand, fine to coarse grained, 2 tan 3 3 5 6 7 clay, reddish gray 8 9

	ENTECH ENGINEERING, INC.
17	COLORADO SPRINGS, COLORADO 6

TEST PIT LOG			
DRAWN;	DATE	CHECKED:	DATE: 8/19/16

JOB NO:


FIG NO.:

BORING NO. **TP-1** DEPTH(ft) 4.5-5 UNIFIED CLASSIFICATION **AASHTO CLASSIFICATION** TEST BY BL JOB NO. 161641

SM

CLIENT **PROJECT** **BRODERS EXCAVATING**

715 STRUTHERS LOOP

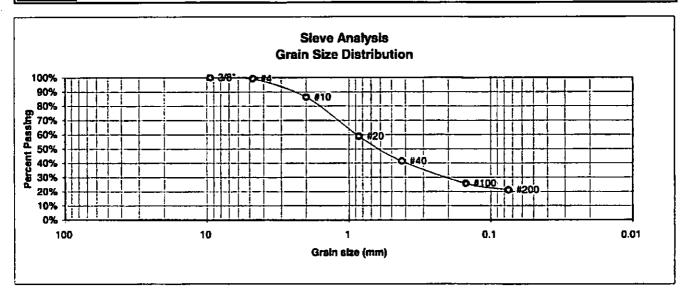

U.S.	Percent	Atterberg	
Sieve #	<u>Finer</u>	<u>Limits</u>	
3"		Plastic Limit 18	
1 1/2"		Liquid Limit 19	
3/4"		Plastic Index 1	
1/2"			
3/8"	100.0%		
4	99.2 %	<u>Swell</u>	
10	86.1%	Moisture at start	
20	58.8%	Moisture at finish	
40	41.3%	Moisture increase	
100	25.7%	Initial dry density (pcf)	
200	21.0%	Swell (psf)	




LABORATORY TEST RESULTS										
DRAWN:	DATE:	CHECKED:	B/I1//							

JOB NO.: 161641 FIG NO: 4

BORING NO. TP-3 DEPTH(ft) 1.5-7 UNIFIED CLASSIFICATION **AASHTO CLASSIFICATION** TEST BY BL

JOB NO. 161641

CLIENT PROJECT **BRODERS EXCAVATING** 715 STRUTHERS LOOP

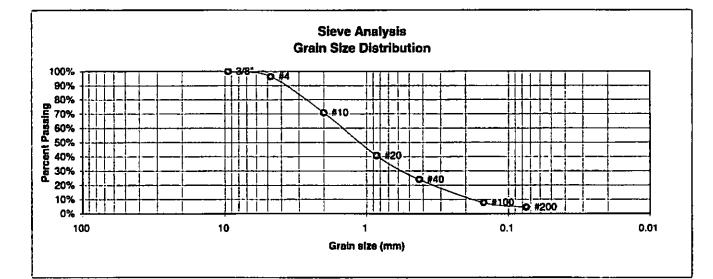

U.S. <u>Sieve #</u> 3"	Percent <u>Finer</u>	Atterbe rg <u>Llmits</u> Plastic Limit
1 1/2"		Liquid Limit
3/4"		Plastic Index
1/2"		
3/8"	100.0%	
4	96.4%	<u>Swell</u>
10	70.8%	Moisture at start
20	40.7%	Moisture at finish
40	23.9%	Moisture increase
100	7.7%	Initial dry density (pcf)
200	4.4%	Swell (psf)



	LABORATO RESULTS	ORY TEST	
DRAWN;	DATE:	CHECKED:	DATE: B/19/14

JOB NO: 161641 FIG NO: 5

8-27-16 Brodom Excounting

115 STNHHER LOOP 0NOO 36190 APN# 7136 00 2061

Abdudon old
Line

150

14

14

14

Approved design document 8-23-16 family

1"= 40

J9318556 NA actual neithago: WARN ODOTHERRY CONCESSOR apparent form of the parties of the THE APPLICANT HAS BEEN DULY RECISTERED IN THIS OFFICE AS THE OWNER OF THE MOTOR VEHICLE DISCRIPED 47M513391 O NOT ACCEPT WITHOUT VEBREYING FACIE WATERINARK IN PAR ODOMESTIC 02/27/2017 03/31/2017 04/27/2017 SUBJECT TO LIEVS AND ENCLMBRANCES IN THE ORDER SHOWN, S12615X32 47E950696 115 116 41230 MALT SETY ISATE. MANTHURY DATE MATERITY CALLS OME 1930 CITING MOVE DATEMENT VOIDSHE APPERED DIGITACHADOR INNOVO CERTIFICATE OF TITLE TILL SAMES MARKATRAIL ERRARD THE NUMBER THENDRED MENDER VANCOUNT DISCOUNTY CHAM GENERALINGERIOOSE 2015 650 SKY VIEW LN #116 LARKSPUR, CO 80118 SUN HOME SERVICES AMERICAN DESIGNOR, COLORADO DE SUN HOME SERVICES INC 109133241E5324074 BARBARA BROML

TRANSFER OF OWNERSHIP/BUYER(S) REQUIREMENT: Upon the sale or transfer of a motor vehicle the owner in whose name the certificate of title is issued shall execute a formal transfer of the vehicle. Within 80 days the buyer shall present the certificate of title topether with an application for title to an authorized agent pursuant to C.R.S. 42-6-110.

TRANSFER OF OWNERSHIP/SELLER(S) REQUIREMENT- When the owner of a motor vehicle transfers or

certificate of title to a buyer, the registration of such vehicle shall expire and the seller shall remove the incense plates pursuant to C.R.S. 42-3-115.	ODCIMETER CENTIFICATION. Foderal and state large requires the sefer to declare the relicage of the motion retrieve and requires the buyer to accommon the minese of the motion upon which upon transfer of currentlying. The welfer and buyer are required to print and sept their name to additionabilities the mileage personnt to 49 USC 307.	THE SELLENS CENTRES UNDER PENALTY OF PERCIFF IN THE SECOND DECIGE. THAT THE SELLENS SIGNATURES RELEASES AND THANSFERS INTEREST IN THE VEHICLE AND THE ODOMETER READING AND DECLARATION AND THUE AND CORRECT TO THE 61ST OF THEIR KNOWLEDGE.	ASSIGNMENT AND ALL ASSIGNMENTS THAT FOLLOW Byon's limit franch from the or GOOG Byon's limit franch from the or GOOG Byon's limit franch from the or GOOG	Bryan's Mand Printed Name	Buyer's Hard Proted Name	Buyer's Hand Printed Name	lus-	5 Calos pac, CO 8092.1	BY LICENSED DEALERS. Buyer's hand prented Name(s)	Super's Signature Acknowledges Odocrater Neading	Buyer's Hand Proted Name(N)	e Buyer's Hand Printed Name	se Buyer's Physical Address, Chy. Stelle, ZIP	Buyer's hand printed Namelal majority Doors's Secretary Actionshipse Odcouter Beading		e Bayer's Hand Printed Name	er Bayer's Physical Address, Chy. Stats, ZIP	Bayer's hand printed flametsi ingerey Baser's Servatives Achouslednes Octonoles Tractino		e Buyer's Hand Primed Name	Wen Applicable) Auction Number Buyer's Physical Address, City, Starte, ZIP
certificate of title to a buyer, the registration of such vehicl pursuant to C.R.S. 42-3-115.	ODOMETER CERTIFICATION- Foderal and state law sequents the select to di- on-mineups of the motor vahiotic upon transfer of currenting. The select and pursuant to 49 USC 307.	THE SELLENS! CERTIFIES, UNDER PENALTY OF PERSONY IN THE STRANSFERS INTEREST IN THE VEHICLE AND THE ODOMETER READING KNOWLEDGE.	法没 度 原	0/18	No. Separature Separature Separature Separature Hand Printed Manuals	Series Squaters	eters hand Punied Name(s)	Color Sepulium Purchase Pres	THE FOLLOWING REASSIGNM Operator Reserve	Selling Destire Name Destired Destire Name Destired Destire Name Destired Destire Name	Appendix House Phonest Name Date of Sole	Agent's Signature Purchase Price	D. Auction Name (What Application)	N. Oddomine Reading Distriction of Manager as mines of Manager of London A Security of Manager as mines of Manager of London A Security of Manager of Manager of Manager of Manager of Manager of London A Security of Manager of M	Nume	E. Agent's Separative Price	Auction Name (When Applicable) Auction Name (When Applicable)	A Analysis Reading O Analysis Misage of Machanist Limits of Machan	Agent's Hand Period Name Date of Sale	Agent's Signature	Auction Name (When Applicable) Auction Number