EL PASO COUNTY - ENGINEERING REVIEW

PLANNING AND DEVELOPMENT 2880 INTERNATIONAL CIRCLE, SUITE 110 COLORADO SPRINGS, CO 80910 TELE: (719) 520-6300

CONTACT: JEFF RICE, P.E. (719) 520-6300 EMAIL: JEFFRICE@ELPASOCO.COM

TRAFFIC ENGINEERING

EL PASO COUNTY DEPARTMENT OF PUBLIC WORKS 3275 AKERS DRIVE COLORADO SPRINGS, CO 80922 CONTACT: JOSHUA PALMER EMAIL: JOSHUAPALMER@ELPASOCO.COM

APPLICANT

HR GREEN DEVELOPMENT, LLC 1975 RESEARCH PARKWAY SUITE 230 COLORADO SPRINGS, CO 80920 TELE: (719) 394-2433 CONTACT: COLLEEN MONAHAN EMAIL: CMONAHAN@HRGREEN.COM

LANDSCAPE ARCHITECT

HR GREEN DEVELOPMENT, LLC 1975 RESEARCH PARKWAY SUITE 230 COLORADO SPRINGS, CO 80920 TELE: (720) 602-4941 CONTACT: PHIL STUEPFERT EMAIL: PSTUEPFERT@HRGREEN.COM

SURVEYOR EDWARD-JAMES SURVEYING, INC. 1005 ELKTON DRIVE

COLORADO SPRINGS, CO 80907 TELE: 719-576-1216 TRAFFIC ENGINEER

LSC TRANSPORTATION CONSULTANTS, INC. 545 EAST PIKES PEAK AVENUE, SUITE 210 COLORADO SPRINGS, CO 80903 TELE: (719) 633-2868 CONTACT: JEFF HODSDON

EMAIL: JEFF@LSCTRANS.COM

GEOTECHNICAL ENGINEER

CTL THOMPSON INC. 5170 MARK DABLING BLVD COLORADO SPRINGS, CO 80918 TELE: (719) 528-8300 CONTACT: JEFFREY M. JONES P.E

WATER & WASTE WATER

GRANDVIEW RESERVE METROPOLITAN DISTRICT 1272 KELLY JOHNSON BLVD SUITE100 TELE: (719) 499-8416 CONTACT: -PAUL HOWARD EMAIL: PAULINFINTY1@MSN.COM

ELECTRIC

MOUNTAIN VIEW ELECTRIC ASSOCIATION, INC. 11140 E. WOODMEN RD FALCON, CO 80831-8127 TELE: (719) 495-2283

NATURAL GAS

BLACK HILLS ENERGY 198 COUNTY LINE RD PALMER LAKE, CO 80133 TELE: (719) 332-5856 CONTACT: BOB SWATEK EMAIL: BOB.SWATEK@BLACKHILLSCORP.COM

FIRE DEPARTMENT


EMAIL: FALCONFIRE@FALCONFIREPD.ORG

PEYTON, CO 80831 TELE: (719) 495-4050

FALCON FIRE PROTECTION DISTRICT ADMINISTRATION 7030 OLD MERIDIAN RD

EASTONVILLE ROAD FROM LONDONDERRY DRIVE TO REX ROAD SEGMENT 1 IMPROVEMENTS **STATIONING 14+55.00 - 47+00.00**

LOCATED IN A PORTION OF SECTION 28, TOWNSHIP 12 SOUTH, RANGE 64 WEST OF THE 6TH PRINCIPAL MERIDIAN **COUNTY OF EL PASO, STATE OF COLORADO MARCH 2024**

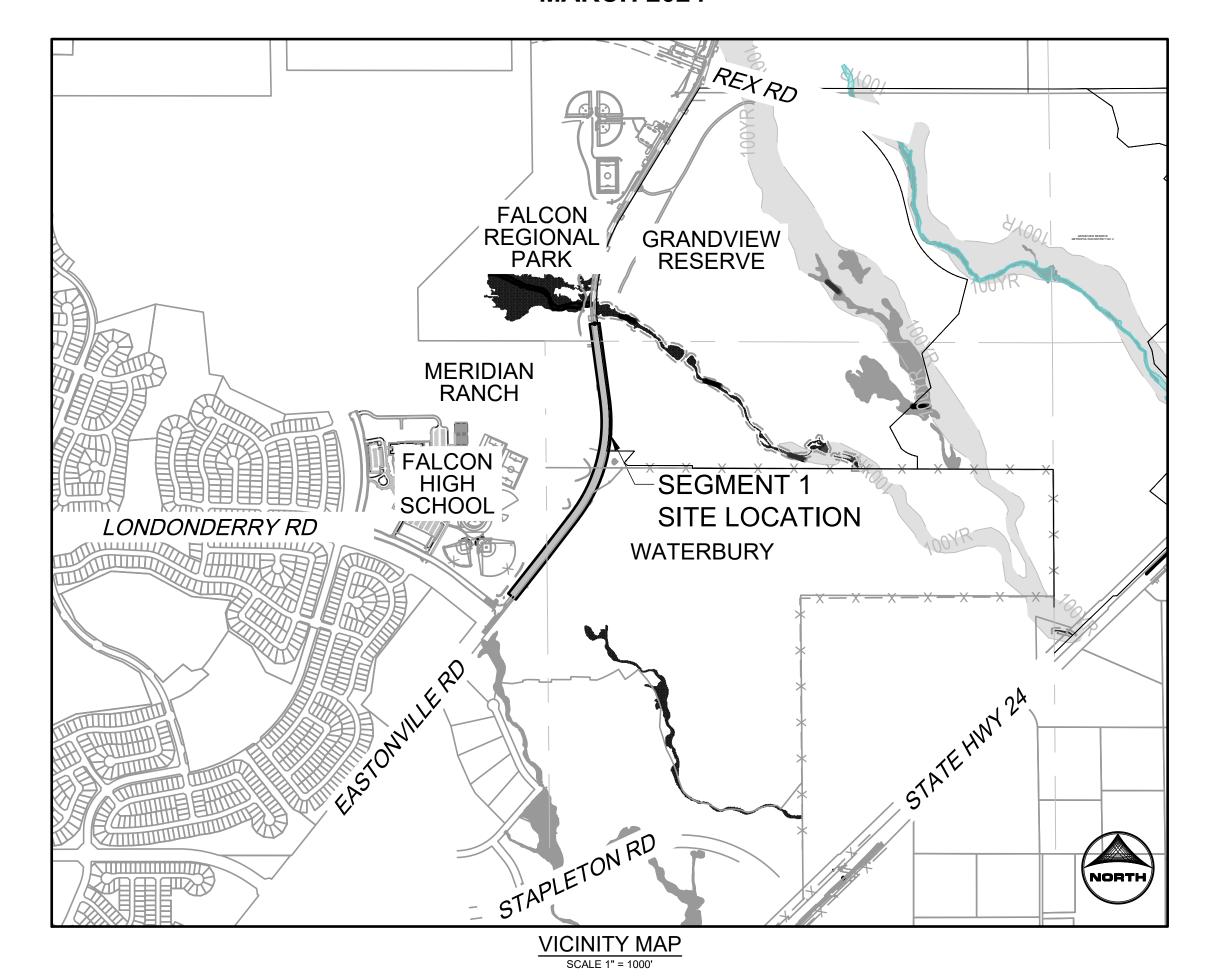

OVERAL	L INDEX
SEGMENT 1	SHEETS 1-32
SEGMENT 2	SHEETS 33-61

SHEET INDEX						
SHEET NUMBER	Sheet Description	SHEET TITLE				
1	CS.1	COVER				
2	GN.1	NOTES & LEGEND				
3	GN.2	TYPICAL ROAD SECTIONS				
4 - 6	DM.1 - DM.3	DEMOLITION PLAN				
7 - 10	PP.1 - PP.4	PLAN & PROFILE				
11-12	GEC.1-GEC.2	GRADING & EROSION CONTROL PLAN				
13 - 14	SS.1 - SS.2	STRIPING PLAN				
15 - 25	PD.1-PD.8	POND PLANS				
26 - 29	STM.1 - STM.4	STORM PLAN & PROFILE				
30-32	DT.1-DT.2	DETAILS				

BENCHMARK

THE BENCHMARK FOR THIS TOPOGRAPHICAL MAP IS NGS MONUMENT F24, WITH A

BASIS OF BEARING

THE BASIS OF BEARING IS THE NORTH LINE OF SECTION 28 TOWNSHIP 12 SOUTH, RANGE 64 WEST OF THE 6TH P.M. BEING MONUMENTED AT EACH END BY A 3-1/4" ALUMINUM CAP STAMPED "PS INC LS 30087, ASSUMED TO BEAR S89°47'04", A DISTANCE

NOTE: CONTRACTOR SHALL PROTECT ALL EXISTING SURVEY MONUMENTATION. CONTRACTOR SHALL HAVE LICENSED SURVEYOR REPLACE ANY DAMAGED OR DISTURBED MONUMENTATION AT THEIR COST.

SURVEYOR TO OBTAIN AUTOCAD FILE FROM ENGINEER AND VERIFY ALL HORIZONTAL CONTROL DIMENSIONING PRIOR TO CONSTRUCTION STAKING. SURVEYOR MUST VERIFY ALL BENCHMARK, BASIS OF BEARING AND DATUM INFORMATION TO ENSURE IMPROVEMENTS WILL BE AT THE SAME HORIZONTAL AND VERTICAL LOCATIONS SHOWN ON THE DESIGN CONSTRUCTION DRAWINGS. PRIOR TO CONSTRUCTION STAKING ANY DISCREPANCY MUST BE REPORTED TO OWNER AND ENGINEER PRIOR TO CONTINUATION OF ANY FURTHER STAKING OR CONSTRUCTION WORK.

EL PASO COUNTY

COUNTY PLAN REVIEW IS PROVIDED ONLY FOR GENERAL CONFORMANCE WITH COUNTY DESIGN CRITERIA. THE COUNTY IS NOT RESPONSIBLE FOR THE ACCURACY AND ADEQUACY OF THE DESIGN, DIMENSIONS, AND/ OR ELEVATIONS WHICH SHALL BE CONFIRMED AT THE JOB SITE. THE COUNTY THROUGH THE APPROVAL OF THIS DOCUMENT ASSUMES NO RESPONSIBILITY FOR COMPLETENESS AND/ OR ACCURACY OF

FILED IN ACCORDANCE WITH THE REQUIREMENTS OF THE EL PASO COUNTY LAND DEVELOPMENT CODE, DRAINAGE CRITERIA MANUAL, VOLUMES 1 AND 2, AND ENGINEERING CRITERIA MANUAL AS AMENDED.

IN ACCORDANCE WITH ECM SECTION 1.12, THESE CONSTRUCTION DOCUMENTS WILL BE VALID FOR CONSTRUCTION FOR A PERIOD OF 2 YEARS FROM THE DATE SIGNED BY THE EL PASO COUNTY ENGINEER. IF CONSTRUCTION HAS NOT STARTED WITHIN THOSE 2 YEARS, THE PLANS WILL NEED TO BE RESUBMITTED FOR APPROVAL, INCLUDING PAYMENT OF REVIEW FEES AT THE PLANNING AND COMMUNITY DEVELOPMENT DIRECTORS

JOSHUA PALMER P.E **COUNTY ENGINEER**

OWNER'S STATEMENT

I, THE OWNER/DEVELOPER HAVE READ AND WILL COMPLY WITH THE REQUIREMENTS OF THE GRADING AND EROSION CONTROL PLAN AND ALL OF THE REQUIREMENTS SPECIFIED ON THESE DETAILED PLANS AND SPECIFICATIONS

ENGINEER'S STATEMENT

THESE DETAILED PLANS AND SPECIFICATIONS WERE PREPARED UNDER MY DIRECTION AND SUPERVISION. SAID PLANS AND SPECIFICATIONS HAVE BEEN PREPARED ACCORDING TO THE CRITERIA ESTABLISHED BY THE COUNTY FOR DETAILED ROADWAY, DRAINAGE, GRADING AND EROSION CONTROL PLANS AND SPECIFICATIONS, AND SAID PLANS AND SPECIFICATIONS ARE IN CONFORMITY WITH APPLICABLE MASTER DRAINAGE PLANS AND MASTER TRANSPORTATION PLANS. SAID PLANS AND SPECIFICATIONS MEET THE PURPOSES FOR WHICH THE PARTICULAR ROADWAY AND DRAINAGE FACILITIES ARE DESIGNED AND ARE CORRECT TO THE BEST OF MY KNOWLEDGE AND I ACCEPT RESPONSIBILITY FOR ANY LIABILITY CAUSED BY ANY NEGLIGENT ACTS, ERRORS OR OMISSIONS ON MY PART IN PREPARATION OF THESE DETAILED PLANS AND SPECIFICATIONS.



COLLEEN P. MONAHAN, COLORADO P.E. NO. 0056067

3/22/2024

DISTRICT APPROVALS

THESE DOCUMENTS HAVE BEEN REVIEWED AND APPROVED FOR STORM DRAIN AND ASSOCIATED UTILITY SERVICE CONSTRUCTION.

FOR AND ON BEHALF OF THE GRANDVIEW RESERVE METROPOLITAN DISTRICT



Add a "CDR" before "2321" (my mistake with my comment in Review 1)

EDARP FILING NO. 2321

BAR IS ONE INCH ON JOB DATE: DRAWN BY: ACH 3/6/2024 OFFICIAL DRAWINGS. APPROVED: CMM JOB NUMBER: 201662.08 IF NOT ONE INCH, CAD DATE: 3/22/2024 CAD FILE: J:\2020\201662\CAD\Dwgs\C\Eastonville_Road_662.08\Segment_1\CD\Road_CDs\Cover_N_p tails REVISION DESCRIPTION

NO. | DATE | BY

HR GREEN - COLORADO SPRINGS 1975 RESEARCH PARKWAY SUITE 230 COLORADO SPRINGS CO 80920 PHONE: 719.300.4140 HRGreen FAX: 713.965.0044

EASTONVILLE ROAD IMPROVEMENTS DR. HORTON EL PASO COUNTY, COLORADO



COVER

EASTONVILLE ROAD SEGEMENT 1 IMPROVEMENTS

NOTES:

- 1. STORMWATER DISCHARGES FROM CONSTRUCTION SITES SHALL NOT CAUSE OR THREATEN TO CAUSE POLLUTION, CONTAMINATION, OR DEGRADATION OF STATE WATERS. ALL WORK AND EARTH DISTURBANCE SHALL BE DONE IN A MANNER THAT MINIMIZES POLLUTION OF ANY ON-SITE OR OFF-SITE WATERS, INCLUDING WETLANDS
- 2. NOTWITHSTANDING ANYTHING DEPICTED IN THESE PLANS IN WORDS OR GRAPHIC REPRESENTATION, ALL DESIGN AND CONSTRUCTION RELATED TO ROADS, STORM DRAINAGE, AND EROSION CONTROL SHALL CONFORM TO THE STANDARDS AND REQUIREMENTS OF THE MOST RECENT VERSION OF THE RELEVANT ADOPTED EL PASO COUNTY STANDARDS. INCLUDING THE CRITERIA MANUAL VOLUME 2. ANY DEVIATIONS FROM REGULATIONS AND STANDARDS MUST BE REQUESTED. AND APPROVED. IN WRITING.
- 3. A SEPARATE STORMWATER MANAGEMENT PLAN (SWMP) FOR THIS PROJECT SHALL BE COMPLETED AND AN EROSION AND STORMWATER QUALITY CONTROL PERMIT (ESQCP) ISSUED PRIOR TO COMMENCITNG CONSTRUCTION. MANAGEMENT OF THE SWMP DURING CONSTRUCTION IS THE RESPONSIBILITY OF THE DESIGNATED QUALIFIED STORMWATER MANAGER OF CERTIFIED EROSION CONTROL INSPECTOR. THE SWMP SHALL BE LOCATED ON SITE AT ALL TIMES DURING CONSTRUCTION AND SHALL BE KEPT UP TO DATE WITH WORK PROGRESS AND CHANGES IN THE FIELD.
- 4. ONCE THE ESQCP IS APPROVED AND A "NOTICE TO PROCEED" HAS BEEN ISSUED, THE CONTRACTOR MAY INSTALL THE INITIAL STAGE EROSION AND SEDIMENT CONTROL MEASURES AS INDICATED ON THE APPROVED GEC. A

 24. OWNER/DEVELOPER AND THEIR AGENTS SHALL COMPLY WITH THE PRECONSTRUCTION MEETING BETWEEN THE CONTRACTOR, ENGINEER, AND THE EL PASO COUNTY WILL BE HELD PRIOR TO ANY CONSTRUCTION. IT IS THE RESPONSIBILITY OF THE APPLICANT TO COORDINATE THE MEETING TIME AND PLACE WITH COUNTY STAFF.
- 5. CONTROL MEASURES MUST BE INSTALLED PRIOR TO COMMENCEMENT OF ACTIVITIES THAT COULD CONTRIBUTE POLLUTANTS TO STORMWATER. CONTROL MEASURES FOR ALL SLOPES, CHANNELS, DITCHES, AND DISTURBED LAND AREAS SHALL BE INSTALLED IMMEDIATELY UPON COMPLETION OF THE DISTURBANCE.
- 6. ALL TEMPORARY SEDIMENT AND EROSION CONTROL MEASURES SHALL BE MAINTAINED AND REMAIN IN EFFECTIVE OPERATION CONDITION UNTIL PERMANENT SOIL EROSION CONTROL MEASURES ARE IMPLEMENTED AND 26. PRIOR TO CONSTRUCTION THE PERMITEE SHALL VERIFY THE LOCATION OF FINAL STABILIZATION IS ESTABLISHED. ALL PERSONS ENGAGED IN LAND DISTURBANCE ACTIVITIES SHALL ASSESS THE ADEQUACY OF CONTROL MEASURES AT THE SITE AND IDENTIFY IF CHANGES TO THOSE CONTROL MEASURES ARE NEEDED TO ENSURE THE CONTINUED EFFECTIVE PERFORMANCE OF THE CONTROL MEASURES. ALL CHANGES TO TEMPORARY SEDIMENT AND EROSION CONTROL MEASURES MUST BE INCORPORATED INTO THE STORMWATER MANAGEMENT PLAN.
- 7. TEMPORARY STABILIZATION SHALL BE IMPLEMENTED ON DISTURBED AREAS AND STOCKPILES WHERE GROUND DISTURBING ACTIVITY HAS PERMANENTLY CEASED OR TEMPORARILY CEASED FOR LONGER THAN 14 DAYS
- 8. FINAL STABILIZATION MUST BE IMPLEMENTED AT ALL APPLICABLE CONSTRUCTION SITES. FINAL STABILIZATION IS ACHIEVED WHEN ALL GROUND DISTURBING ACTIVITIES ARE COMPLETE AND ALL DISTURBED AREAS EITHER HAVE A UNIFORM VEGETATIVE COVER WITH INDIVIDUAL PLANT DENSITY OF 70 PERCENT OF PRE-DISTURBANCE LEVELS ESTABLISHED OR EQUIVALENT PERMANENT ALTERNATIVE STABILIZATION METHOD IS IMPLEMENTED. ALL TEMPORARY SEDIMENT AND EROSION CONTROL MEASURES SHALL BE REMOVED UPON FINAL STABILIZATION AND 32. WQCD - PERMITS BEFORE PERMIT CLOSURE
- 9. ALL PERMANENT STORMWATER FACILITIES SHALL BE INSTALLED AS DESIGNED IN THE APPROVED PLANS. ANY PROPOSED CHANGES THAT EFFECT THE DESIGN OF FUNCTION OF PERMANENT STORMWATER MANAGEMENT STRUCTURES MUST BE APPROVED BY THE ECM ADMINISTRATOR PRIOR TO IMPLEMENTATION.
- 10. EARTH DISTURBANCES SHALL BE CONDUCTED IN SUCH A MANNER AS TO EFFECTIVELY MINIMIZE ACCELERATED SOIL EROSION AND RESULTING SEDIMENTATION. ALL DISTURBANCES HALL BE DESIGNED, CONSTRUCTED AND COMPLETED SO THAT THE EXPOSED AREA OF ANY DISTURBED LAND SHALL BE LIMITED TO THE SHORTEST PRACTICAL PERIOD OF TIME. PRE-EXISTING VEGETATION SHALL BE PROTECTED AND MAINTAINED WITHIN 50 HORIZONTAL FEET OF A WATERS OF THE STATE UNLESS SHOWN TO BE INFEASIBLE AND SPECIFICALLY REQUESTED AND APPROVED.
- 11. COMPACTION OF SOIL MUST BE PREVENTED IN AREAS DESIGNATED FOR INFILTRATION CONTROL MEASURES OF WHERE FINAL STABILIZATION WILL BE ACHIEVED BY VEGETATIVE COVER. AREAS DESIGNATED FOR INFILTRATION CONTROL MEASURES SHALL ALSO BE PROTECTED FROM SEDIMENTATION DURING CONSTRUCTION UNTIL FINAL STABILIZATION IS ACHIEVED. IF COMPACTION PREVENTION IS NOT FEASIBLE DUE TO SITE CONSTRAINTS, ALL ARES DESIGNATED FOR INFILTRATION AND VEGETATION CONTROL MEASURES MUST BE LOOSENED PRIOR TO INSTALLATION OF THE CONTROL MEASURE(S)
- 12. ANY TEMPORARY OR PERMANENT FACILITY DESIGNED AND CONSTRUCTED FOR THE CONVEYANCE OF STORMWATER AROUND, THROUGH, OR FROM THE EARTH DISTURBANCE AREA SHALL BE A STABILIZED CONVEYANCE DESIGNED TO MINIMIZE EROSION AND THE DISCHARGE OF SEDIMENT OFF
- 13. CONCRETE WASH WATER SHALL BE CONTAINED AND DISPOSED OF IN ACCORDANCE WITH THE SWMP. NO WASH WATER SHALL BE DISCHARGED TO OR ALLOWED TO ENTER STATE WATERS, INCLUDING ANY SURFACE OR SUBSURFACE STORM DRAINAGE SYSTEM OR FACILITIES. CONCRETE WASHOUTS SHALL NOT BE LOCATED IN AN AREA WHERE SHALLOW GROUNDWATER MAY BE PRESENT, OR WITHIN 50 FEET OF A SURFACE WATER BODY, CREEK OR STREAM.
- 14. DURING DEWATERING OPERATIONS OF UNCONTAMINATED GROUND WATER MAY BE DISCHARGED ON SITE, BUT SHALL NOT LEAVE THE SITE IN THE FORM OF SURFACE RUNOFF UNLESS AN APPROVED STATE DEWATERING PERMIT IS IN PLACE.
- 15. EROSION BLANKET OR OTHER PROTECTIVE COVERING SHALL BE USED ON SLOPES STEEPER THAN 3:1.
- 16. CONTRACTOR SHALL BE RESPONSIBLE FOR THE REMOVAL OF ALL WASTES FROM THE CONSTRUCTION SITE FOR DISPOSAL IN ACCORDANCE WITH LOCAL AND STATE REGULATORY REQUIREMENTS. NO CONSTRUCTION DEBRIS, TREE SLASH, BUILDING MATERIAL WASTES OR UNUSED BUILDING MATERIALS SHALL BE BURIED, DUMPED OR DISCHARGED AT THIS SITE. 17. WASTE MATERIALS SHALL NOT BE TEMPORARILY PLACED OR STORED IN THE STREET. ALLEY OR OTHER PUBLIC WAY, UNLESS IN ACCORDANCE WITH AN APPROVED TRAFFIC CONTROL PLAN. CONTROL MEASURES MAY BE REQUIRED BY EL PASO COUNTY ENGINEERING IF DEEMED NECESSARY, BASED ON SPECIFIC CONDITIONS AND CIRCUMSTANCES.

Call before you dig.

18. TRACKING OF SOILS AND CONSTRUCTION DEBRIS OFF-SITE SHALL BE MINIMIZED. MATERIALS TRACKED OFF-SITE SHALL BE CLEANED UP

PROPERLY AND PROPERLY DISPOSED OF IMMEDIATELY 19. THE OWNER/DEVELOPER SHALL BE RESPONSIBLE FOR THE REMOVAL OF ALL CONSTRUCTION, DEBRIS, DIRT, TRASH, ROCK, SEDIMENT, SOIL AND SAND THAT MAY ACCUMULATE IN ROADS, STORM DRAINS AND OTHER DRAINAGE CONVEYANCE SYSTEMS AND STORMWATER APPURTENANCES

AS A RESULT OF THE SITE DEVELOPMENT 20. THE QUANTITY OF MATERIALS STORED ON THE PROJECT SITE SHALL BE LIMITED, AS MUCH AS PRACTICAL, TO THAT QUANTITY REQUIRED TO PERFORM THE WORK IN AN ORDERLY SEQUENCE. ALL MATERIALS STORED ON-SITE SHALL BE STORED IN AN EAT, ORDERLY MANNER, IN THEIR ORIGINAL CONTAINERS. WITH ORIGINAL MANUFACTURER'S LABEL. 21. NO CHEMICAL(S) HAVING THE POTENTIAL TO BE RELEASED IN STORMWATER ARE TO BE STORED OR USED ONSITE UNLESS PERMISSION FOR THE USE OF SUCH CHEMICAL(S) IS GRANTED IN WRITING BY THE ECM ADMINISTRATOR. IN GRANTING APPROVAL FOR THE USE OF SUCH CHEMICAL(S) SPECIAL CONDITIONS AND MONITORING MAY BE REQUIRED.

22. BULK STORAGE OF ALLOWED PETROLEUM PRODUCTS OR OTHER ALLOWED LIQUID CHEMICALS IN EXCESS OF 55 GALLONS SHALL REQUIRED ADEQUATE SECONDARY PROTECTION TO CONTAIN AL SPILLS ONSITE AND TO PREVENT ANY SPILLED MATERIALS FROM ENTERING STATE WATERS, ANY SURFACE OR SUBSURFACE STORM DRAINAGE SYSTEM OR OTHER FACILITIES.

23. NO PERSON SHALL CAUSE THE IMPEDIMENT OF STORMWATER FLOW IN THE CURB AND GUTTER OR DITCH EXCEPT WITH APPROVED SEDIMENT CONTROL MEASURES.

"COLORADO WATER QUALITY CONTROL ACT" (TITLE 25, ARTICLE 8, CRS) AND THE "CLEAN WATER ACT" (33 USC 1344), IN ADDITION TO THE REQUIREMENTS OF THE LAND DEVELOPMENT CODE, DCM VOLUME II AND ECM APPENDIX I. ALL APPROPRIATE PERMITS MUST BE OBTAINED BY THE CONTRACTOR PRIOR TO CONSTRUCTION (1041, NPDES, FLOODPLAIN, 404, FUGITIVE DUST, ETC). IN THE EVENT OF CONFLICTS BETWEEN THESE REQUIREMENTS AND OTHER LAWS RULES OR REGULATIONS OF OTHER FEDERAL, STATE, LOCAL OR COUNTY AGENCIES, THE MOST RESTRICTIVE LAWS, RULES OR REGULATIONS SHALL APPLY

25. ALL CONSTRUCTION TRAFFIC MUST ENTER/EXIT THE SITE ONLY AT APPROVED CONSTRUCTION ACCESS POINTS.

EXISTING UTILITIES.

27. A WATER SOURCE SHALL BE AVAILABLE ON SITE DURING EARTHWORK OPERATIONS AND SHALL BE UTILIZED AS REQUIRED TO MINIMIZE DUST FROM EARTHWORK EQUIPMENT AND WIND.

28. THE SOILS REPORT FOR THE SITE HAS BEEN PREPARED BY ENTECH

ENGINEERING, INC. AND SHALL BE CONSIDERED A PART OF THESE PLANS. 29. AT LEAST (10) DAYS PRIOR TO THE ANTICIPATED START OF CONSTRUCTION, FOR PROJECTS THAT WILL DISTURB ONE (1) ACRE OR MORE, THE OWNER OR OPERATOR OF CONSTRUCTION ACTIVITY SHALL SUBMIT A PERMIT APPLICATION FOR STORMWATER DISCHARGE TO THE COLORADO DEPARTMENT OF PUBLIC HEALTH AND ENVIRONMENT, WATER QUALITY DIVISION. THE APPLICATION CONTAINS CERTIFICATION OF COMPLETION OF A STORMWATER MANAGEMENT PLAN (SWMP), OF WHICH THIS GRADING AND EROSION CONTROL PLAN MAY BE A PART. FOR INFORMATION OR APPLICATION MATERIALS CONTACT:

30. COLORADO DEPARTMENT OF PUBLIC HEALTH AND ENVIRONMENT 31. WATER QUALITY CONTROL DIVISION

33. 4300 CHERR CREEK DRIVE SOUTH

34. DENVER, CO 80246-1530 ATTN: PERMITS UNIT

NOTED. THE OWNER/DEVELOPER SHALL OBTAIN WRITTEN PERMISSION AND EASEMENTS, WHERE REQUIRED, FROM ADJOINING PROPERTY OWNER(S) PRIOR TO ANY OFF-SITE DISTURBANCE, GRADING, OR CONSTRUCTION.

GENERAL NOTES:

- 1. IT SHALL BE THE RESPONSIBILITY OF THE CONTRACTOR TO VERIFY THE EXISTENCE AND LOCATION OF ALL UNDERGROUND UTILITIES ALONG THE ROUTE OF THE WORK. THE OMISSION FROM OR THE INCLUSION OF UTILITY LOCATIONS ON THE PLANS IS NOT TO BE CONSIDERED AS THE NONEXISTENCE OF OR A DEFINITE LOCATION OF EXISTING UNDERGROUND UTILITIES.
- 2. THE CONTRACTOR WILL TAKE THE NECESSARY PRECAUTIONS TO PROTECT EXISTING UTILITIES FROM DAMAGE DUE TO THIS OPERATION. ANY DAMAGE TO THE UTILITIES WILL BE REPAIRED AT THE CONTRACTOR'S EXPENSE, AND ANY SERVICE DISRUPTION WILL BE SETTLED BY THE CONTRACTOR.
- 3. ADDITIONAL EROSION CONTROL STRUCTURES MAY BE REQUIRED AT THE TIME OF CONSTRUCTION
- 4. ALL BACKFILL, SUB-BASE, AND/OR BASE COURSE (CLASS 6) MATERIAL SHALL BE COMPACTED PER THE SOILS ENGINEER'S RECOMMENDATIONS AND APPROVED BY EL PASO COUNTY PCD.
- 5. ALL STATIONING IS CENTERLINE OF IMPROVEMENTS UNLESS OTHERWISE INDICATED. ALL ELEVATIONS ARE FLOW LINE UNLESS OTHERWISE INDICATED AS TOP BACK OF CURB (TBC), ASPHALT (ASP), OR TOP OF INLET OR BOX (TOB).
- 6. ALL DISTURBED PAVEMENT EDGES SHALL BE CUT TO NEAT LINES. REPAIR SHALL CONFORM TO EPC ECM APPENDIX K - 1.2C
- 7. ALL INTERSECTION ACCESSES TO BE CONSTRUCTED WITH A 25 FOOT SIGHT VISIBILITY TRIANGLES EXCEPT [VOLLMER ROAD, MARKSHEFFEL ROAD, BRAIRGATE PARKWAY] WHICH IS AN ARTERIAL AND A 50 FOOT SIGHT VISIBILITY TRIANGLE IS REQUIRED AND THERE SHALL BE NO OBSTRUCTIONS GREATER THAN 18" IN THIS AREA.
- 8. ALL CULVERTS AND STORM DRAIN PIPES SHALL BE SMOOTH INTERIOR CORRUGATED POLYETHYLENE PIPE (HDPE), REINFORCED CONCRETE PIPE (RCP). ALL CULVERTS SHALL BE PLACED COMPLETE WITH FLARED END SECTIONS. ADEQUACY OF MATERIAL THICKNESS FOR ANY CSP INSTALLED SHALL BE VERIFIED BY OWNER'S GEOTECHNICAL ENGINEER TO SUPPORT MINIMUM 50 YEAR DESIGN LIFE. CULVERTS MUST CONFORM TO EPC ECM SECTION 3.32 - CULVERTS.
- 9. ASPHALT THICKNESS AND BASE COURSE THICKNESS (COMPACTED) FOR ROADS SHALL BE PER DESIGN REPORT BY OWNER'S GEOTECHNICAL ENGINEER. OWNER'S GEOTECHNICAL ENGINEER TO BE ON SITE AT THE TIME OF ROAD CONSTRUCTION TO EVALUATE SOIL CONDITIONS AND DETERMINE IF ADDITIONAL MEASURES ARE NECESSARY TO ASSURE STABILITY OF THE NEW ROADS. PAVEMENT DESIGN SHALL BE APPROVED BY EL PASO COUNTY ENGINEERING DIVISION PRIOR TO CONSTRUCTION.

STANDARD NOTES

FOR EL PASO COUNTY CONSTRUCTION PLANS:

- ALL DRAINAGE AND ROADWAY CONSTRUCTION SHALL MEET THE STANDARDS AND SPECIFICATIONS OF THE CITY OF COLORADO SPRINGS/EL PASO COUNTY DRAINAGE CRITERIA MANUAL, VOLUMES 1 AND 2, AND THE EL PASO COUNTY ENGINEERING CRITERIA MANUAL.
- CONTRACTOR SHALL BE RESPONSIBLE FOR THE NOTIFICATION AND FIELD NOTIFICATION OF ALL EXISTING UTILITIES, WHETHER SHOWN ON THE PLANS OR NOT, BEFORE BEGINNING CONSTRUCTION. LOCATION OF EXISTING UTILITIES SHALL BE VERIFIED BY THE CONTRACTOR PRIOR TO CONSTRUCTION. CALL 811 TO CONTACT THE UTILITY NOTIFICATION CENTER OF COLORADO (UNCC).
- CONTRACTOR SHALL KEEP A COPY OF THESE APPROVED PLANS, THE GRADING AND EROSION CONTROL PLAN, THE STORMWATER MANAGEMENT PLAN (SWMP), THE SOILS AND GEOTECHNICAL REPORT AND THE APPROPRIATE DESIGN AND CONSTRUCTION STANDARDS AND SPECIFICATIONS AT THE JOB SITE AT ALL TIMES, INCLUDING THE **FOLLOWING:**
- EL PASO COUNTY ENGINEERING CRITERIA MANUAL (ECM) CITY OF COLORADO SPRINGS/EL PASO COUNTY DRAINAGE CRITERIA MANUAL, VOLUMES 1 AND 2
- COLORADO DEPARTMENT OF TRANSPORTATION (CDOT) STANDARD SPECIFICATIONS FOR ROAD AND BRIDGE CONSTRUCTION CDOT M & S STANDARDS
- 4. NOTWITHSTANDING ANYTHING DEPICTED IN THESE PLANS IN WORDS OR GRAPHIC REPRESENTATION, ALL DESIGN AND CONSTRUCTION RELATED TO ROADS, STORM DRAINAGE AND EROSION CONTROL SHALL CONFORM TO THE STANDARDS AND REQUIREMENTS OF THE MOST RECENT VERSION OF THE RELEVANT ADOPTED EL PASO COUNTY STANDARDS. INCLUDING THE LAND DEVELOPMENT CODE, THE ENGINEERING CRITERIA MANUAL, THE DRAINAGE CRITERIA MANUAL, AND THE DRAINAGE CRITERIA MANUAL VOLUME 2. ANY DEVIATIONS FROM REGULATIONS AND STANDARDS MUST BE REQUESTED, AND APPROVED, IN WRITING. ANY MODIFICATIONS NECESSARY TO MEET CRITERIA AFTER-THE-FACT WILL BE ENTIRELY THE DEVELOPER'S RESPONSIBILITY TO RECTIFY.
- IT IS THE DESIGN ENGINEER'S RESPONSIBILITY TO ACCURATELY SHOW EXISTING CONDITIONS, BOTH ONSITE AND OFFSITE, ON THE CONSTRUCTION PLANS. ANY MODIFICATIONS NECESSARY DUE TO CONFLICTS, OMISSIONS, OR CHANGED CONDITIONS WILL BE ENTIRELY THE DEVELOPER'S RESPONSIBILITY TO RECTIFY.
- CONTRACTOR SHALL SCHEDULE A PRE-CONSTRUCTION MEETING WITH EL PASO COUNTY INSPECTIONS, PRIOR TO STARTING CONSTRUCTION.
- IT IS THE CONTRACTOR'S RESPONSIBILITY TO UNDERSTAND THE REQUIREMENTS OF ALL JURISDICTIONAL AGENCIES AND TO OBTAIN ALL REQUIRED PERMITS, INCLUDING BUT NOT LIMITED TO EL PASO COUNTY EROSION AND STORMWATER QUALITY CONTROL PERMIT (ESQCP), REGIONAL BUILDING FLOODPLAIN DEVELOPMENT PERMIT, U.S. ARMY CORPS OF ENGINEERS-ISSUED 401 AND/OR 404 PERMITS, AND COUNTY AND STATE FUGITIVE DUST PERMITS.
- CONTRACTOR SHALL NOT DEVIATE FROM THE PLANS WITHOUT FIRST OBTAINING WRITTEN APPROVAL FROM THE DESIGN ENGINEER AND EPC CONTRACTOR SHALL NOTIFY THE DESIGN ENGINEER IMMEDIATELY UPON DISCOVERY OF ANY ERRORS OR INCONSISTENCIES.
- ALL STORM DRAIN PIPE SHALL BE CLASS IIL RCP UNLE Th NOTED AND APPROVED BY CONTRACTOR SHALL COORDINATE GEOTECHNICAL TESTING PER ECM STANDARDS. PAVEMENT DESIGN APPROVED BY EL PASO COUNTY PRIOR TO PLACEMENT OF
- CURB AND GUTTER AND PAVEMENT. 10. ALL CONSTRUCTION TRAFFIC MUST ENTER/EXIT THE SITE AT APPROVED CONSTRUCTION ACCESS POINTS.
- SIGHT VISIBILITY TRIANGLES AS IDENTIFIED IN THE PLANS SHALL BE PROVIDED AT ALL INTERSECTIONS. OBSTRUCTIONS GREATER THAN 18 INCHES ABOVE FLOWLINE ARE NOT ALLOWED WITHIN SIGHT TRIANGLES. 12. SIGNING AND STRIPING SHALL COMPLY WITH EL PASO COUNTY AND
- MUTCD CRITERIA. 13. CONTRACTOR SHALL OBTAIN ANY PERMITS REQUIRED BY EL PASO COUNTY, INCLUDING WORK WITHIN THE RIGHT-OF-WAY AND SPECIAL
- TRANSPORT PERMITS. 14. THE LIMITS OF CONSTRUCTION SHALL REMAIN WITHIN THE PROPERTY LINE UNLESS OTHERWISE NOTED. THE OWNER/DEVELOPER SHALL OBTAIN WRITTEN PERMISSION AND EASEMENTS, WHERE REQUIRED, FROM ADJOINING PROPERTY OWNER(S) PRIOR TO ANY OFF-SITE DISTURBANCE. GRADING, OR CONSTRUCTION.

LEGEND

	EXISTING	PROPOSED
MATCH LINE		
PHASE LINE		
SECTION LINE		
PROPERTY BOUNDARY	/	
PROPERTY LINE		
EASEMENT LINE		
RIGHT OF WAY		
CENTERLINE		
CHAIN LINK FENCE		
VOODEN FENCE	——————————————————————————————————————	
SPLIT RAIL FENCE		
GUARDRAIL	· -	·
CABLE TV	TV	TV
J.G. ELECTRIC	— — — UE—	— — — UE—
OVERHEAD ELECTRIC	OE	———— OE ————
FIBER OPTIC	— — — FO—	— — — FO—
GAS MAIN		— . — . — . — .
SANITARY SEWER	ss	
STORM DRAIN		
TELEPHONE	UT	UT
NATER MAIN	— — W—	W
SWALE	· 	
TRAIL		
CURB & GUTTER		
DRAINAGE BASIN		
INDEX CONTOUR		
NTER. CONTOUR		
100-YR FLOODPLAIN		
FLOODWAY		
TRAIL		
PARK		
EDGE OF WETLANDS	[L
DRAINAGE		
DIVAIIVAGE	EXISTING	PROPOSED
	2,007,110	77.07.0022
DRAINAGE BASIN		
BASIN TAG		I.D. AREA
DESIGN POINT		$\stackrel{-}{\mathbb{A}}$

SIGNING AND STRIPING NOTES:

- ALL SIGNS AND PAVEMENT MARKINGS SHALL BE IN COMPLIANCE WITH THE CURRENT MANUAL ON UNIFORM TRAFFIC CONTROL DEVICES (MUTCD) REMOVAL OF EXISTING PAVEMENT MARKINGS SHALL BE ACCOMPLISHED BY A METHOD THAT DOES NOT MATERIALLY DAMAGE THE PAVEMENT. THE PAVEMENT MARKINGS SHALL BE REMOVED TO THE EXTENT THAT THEY WILL NOT BE VISIBLE UNDER DAY OR NIGHT CONDITIONS. AT NO TIME WILL IT BE ACCEPTABLE TO PAINT OVER EXISTING PAVEMENT MARKINGS.
- ANY DEVIATION FROM THE STRIPING AND SIGNING PLAN SHALL BE APPROVED BY EL PASO COUNTY PLANNING AND COMMUNITY DEVELOPMENT.
- ALL SIGNS SHOWN ON THE SIGNING AND STRIPING PLAN SHALL BE NEW SIGNS. EXISTING SIGNS MAY REMAIN OR BE REUSED IF THEY MEET CURRENT EL PASO COUNTY AND MUTCD STANDARDS.
- 5. STREET NAME AND REGULATORY STOP SIGNS SHALL BE ON THE SAME POST AT INTERSECTIONS.
- 6. ALL REMOVED SIGNS SHALL BE DISPOSED OF IN A PROPER MANNER BY THE CONTRACTOR
- ALL STREET NAME SIGNS SHALL HAVE "D" SERIES LETTERS, WITH LOCAL ROADWAY SIGNS BEING 4" UPPER-LOWER CASE LETTERING ON 8" BLANK AND NON-LOCAL ROADWAY SIGNS BEING 6" LETTERING, UPPER-LOWER CASE ON 12" BLANK, WITH A WHITE BORDER THAT IS NOT RECESSED. MULTI-LANE ROADWAYS WITH SPEED LIMITS OF 35 MPH OR HIGHER SHALL HAVE 8" UPPER-LOWER CASE LETTERING ON 12" BLANK WITH A WHITE BORDER THAT IS NOT RECESSED. THE WIDTH OF THE NON-RECESSED WHITE BORDERS SHALL MATCH PAGE 255 OF THE 2012 MUTCD "STANDARD HIGHWAY SIGNS". SIGNAL POLE MOUNTED AND OVERHEAD STREET NAME SIGNS SHALL BE PER MUTCD SIZE STANDARDS.
- ALL TRAFFIC SIGNS SHALL HAVE A MINIMUM HIGH INTENSITY PRISMATIC GRADE SHEETING.
- ALL LOCAL RESIDENTIAL STREET SIGNS SHALL BE MOUNTED ON A 1.75" X 1.75" SQUARE TUBE SIGN POST AND STUB POST BASE. FOR OTHER APPLICATIONS, REFER TO THE CDOT STANDARD S-614-8 REGARDING USE OF THE P2 TUBULAR STEEL POST SLIPBASE
- ALL SIGNS SHALL BE SINGLE SHEET ALUMINUM WITH 0.100" MINIMUM THICKNESS. ALL LIMIT LINES/STOP LINES, CROSSWALK LINES, PAVEMENT LEGENDS, AND ARROWS
- SHALL BE A MINIMUM 125 MIL THICKNESS PREFORMED THERMOPLASTIC PAVEMENT MARKINGS WITH TAPERED LEADING EDGES PER CDOT STANDARD S-627-1. STOP BARS SHALL BE 24" IN WIDTH. CROSSWALKS LINES SHALL BE 24" WIDE AND A MINIMUM OF 9'
- 12. WORD AND SYMBOL MARKINGS SHALL BE THE NARROW TYPE.
- 13. ALL LONGITUDINAL LINES SHALL BE A MINIMUM 15MIL THICKNESS EPOXY PAINT. ALL NON-LOCAL RESIDENTIAL ROADWAYS SHALL INCLUDE BOTH RIGHT AND LEFT EDGE LINE STRIPING AND ANY ADDITIONAL STRIPING AS REQUIRED BY CDOT S-627-1.
- 14. THE CONTRACTOR SHALL NOTIFY EL PASO COUNTY (719) 520-6819 PRIOR TO AND UPON COMPLETION OF SIGNING AND STRIPING.
- THE CONTRACTOR SHALL OBTAIN A WORK IN THE RIGHT OF WAY PERMIT FROM THE EL PASO COUNTY DEPARTMENT OF PUBLIC WORKS (DPW) PRIOR TO ANY SIGNAGE OR STRIPING WORK WITHIN AN EXISTING EL PASO COUNTY ROADWAY.

STORM SEWER

MANHOLE

GATE VALVE

MANHOLE

REDUCER

ELECTRIC METER

LIGHT POLE

FIBER OPTIC VAULT

METER

TEE

STORM INLET FLARED END SECTION RIPRAP		
SANITARY SEWER		
CLEAN OUT	\$	ļ
MANHOLE	<u>s</u>	<u>(S)</u>
PLUG	3	3
WATER		
FIRE HYDRANT	~	*
FIRE DEPT. CONNECTION	FDC	STOCK OF THE PARTY

EXISTING

DRY UTILITIES

ELECTRIC PEDESTAL ELECTRICAL CABINET ELECTRIC VAULT FIBER OPTIC PULL BOX FIBER OPTIC MANHOLE FIBER OPTIC PEDESTAL FIBER OPTIC SIGN FIBER OPTIC VAULT GAS METER GAS SIGN GAS VAULT TELEPHONE CABINET TELEPHONE MANHOLE TELEPHONE SIGNAL/MAST TELEPHONE SIGN TELEPHONE PEDESTAL TRANSFORMER

MISCELLANEOUS

PROPOSED

SIGN BOLLLARD ACCESSIBLE PARKING EVL

LIST OF ABBREVIATIONS Δ - DEFLECTION ANGLE L - LENGTH R - RADIUS CB - CHORD BEARING C - CHORD LENGTH N - NORTH/NORTHING W - WFST E - EAST/EASTING S - SOUTH DET - DETAIL EX - EXISTING W/ - WITH PC - POINT OF CURVATURE/PORTLAND CEMENT WWF - WELDED WIRE FABRIC VFRT - VFRTICAL

FDC - FIRE DEPARTMENT CONNECTION CT - COURT DR - DRIVE TYP - TYPICAL **REC - RECEPTION NUMBER** Ø. DIA - DIAMETER PT - POINT OF TANGENCY MIN - MINIMUM

OC - ON CENTER

MAX - MAXIMUM HDPE - HIGH DENSITY POLYETHYLENE

3/22/202*4*/

EDARP FILING NO. 2321

BAR IS ONE INCH ON NO. | DATE | BY 3/6/2024 REVISION DESCRIPTION DRAWN BY: ACH JOB DATE: OFFICIAL DRAWINGS. APPROVED: CMM JOB NUMBER: 201662.08 IF NOT ONE INCH, CAD DATE: 3/22/2024 CAD_FILE: J:\2020\201662\CAD\Dwgs\C\Eastonville_Road_662.08\Segment_1\CD\Road_CDs\Cover_N_Details



HR GREEN - COLORADO SPRINGS 1975 RESEARCH PARKWAY SUITE 230 COLORADO SPRINGS CO 80920 PHONE: 719.300.4140 HRGreen FAX: 713.965.0044


EASTONVILLE ROAD IMPROVEMENTS DR. HORTON


EL PASO COUNTY, COLORADO

D·R·HORTON America's Builder

EASTONVILLE ROAD SEGEMENT 1 IMPROVEMENTS **NOTES & LEGEND**



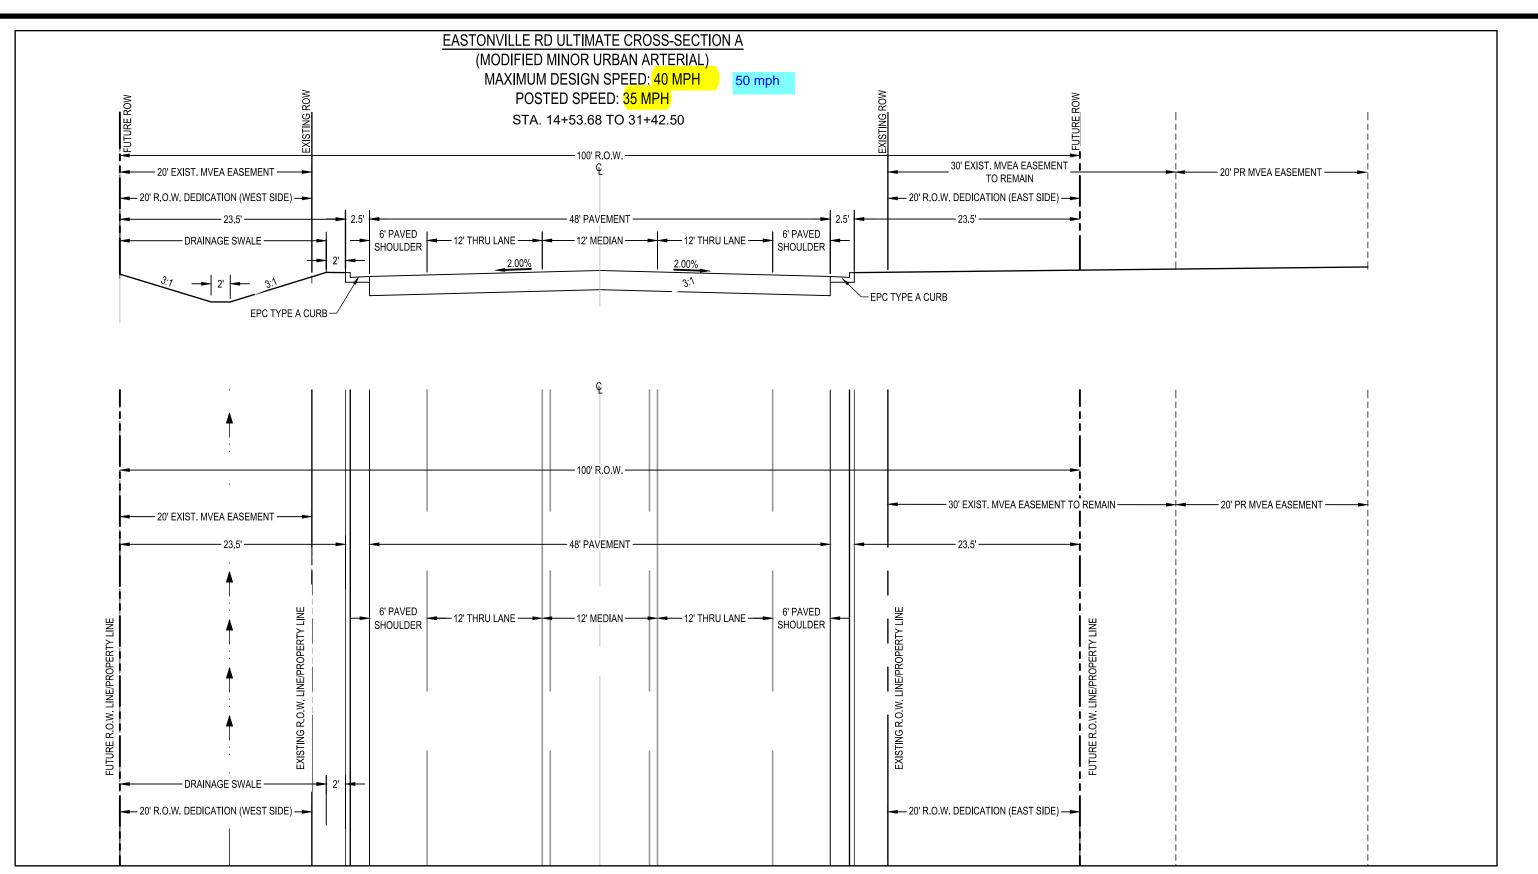

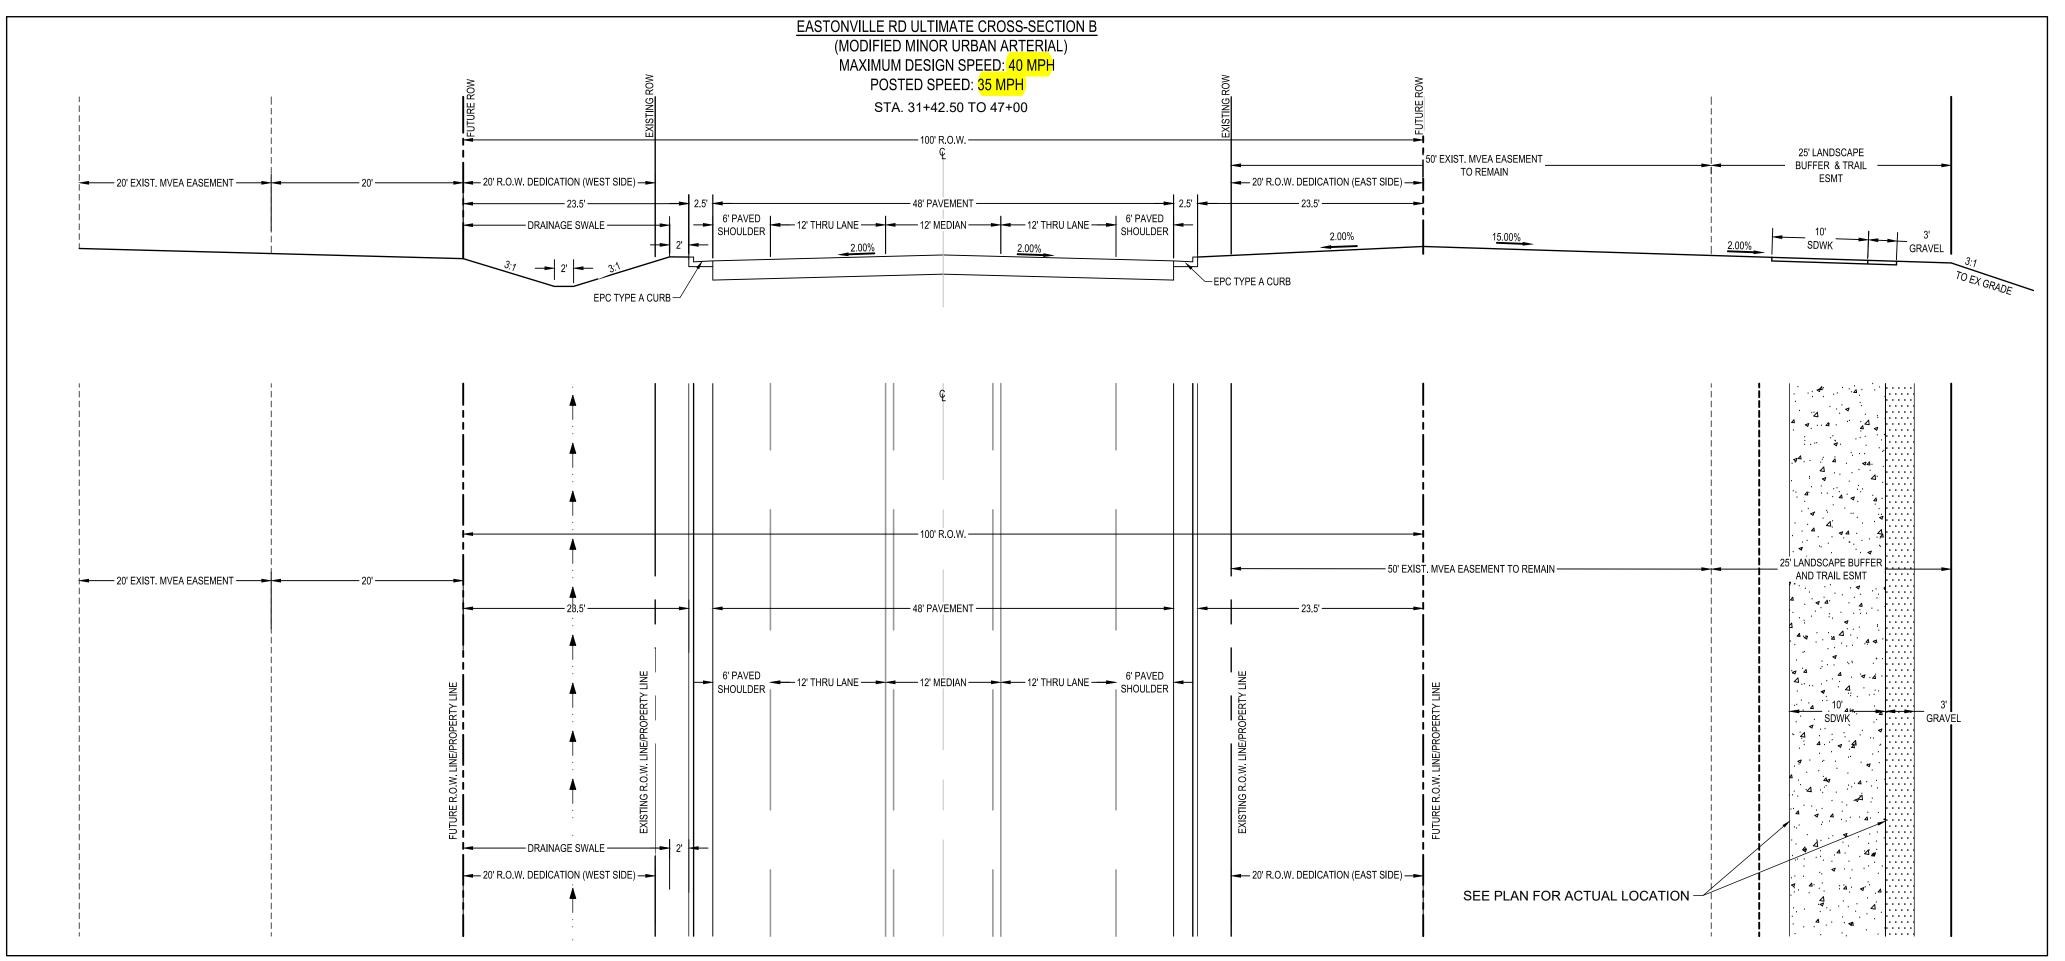



EDARP FILING NO. 2321


	HR GREEN - COLORADO SPRINGS 1975 RESEARCH PARKWAY SUITE 230
	COLORADO SPRINGS CO 80920
LIDO	PHONE: 719.300.4140
HHGreen	FAX: 713.965.0044

EASTONVILLE ROAD IMPROVEMENTS
DR. HORTON
EL PASO COUNTY, COLORADO

EASTONVILLE ROAD SEGEMENT 1 IMPROVEMENTS

TYPICAL ROAD SECTIONS

GN.2

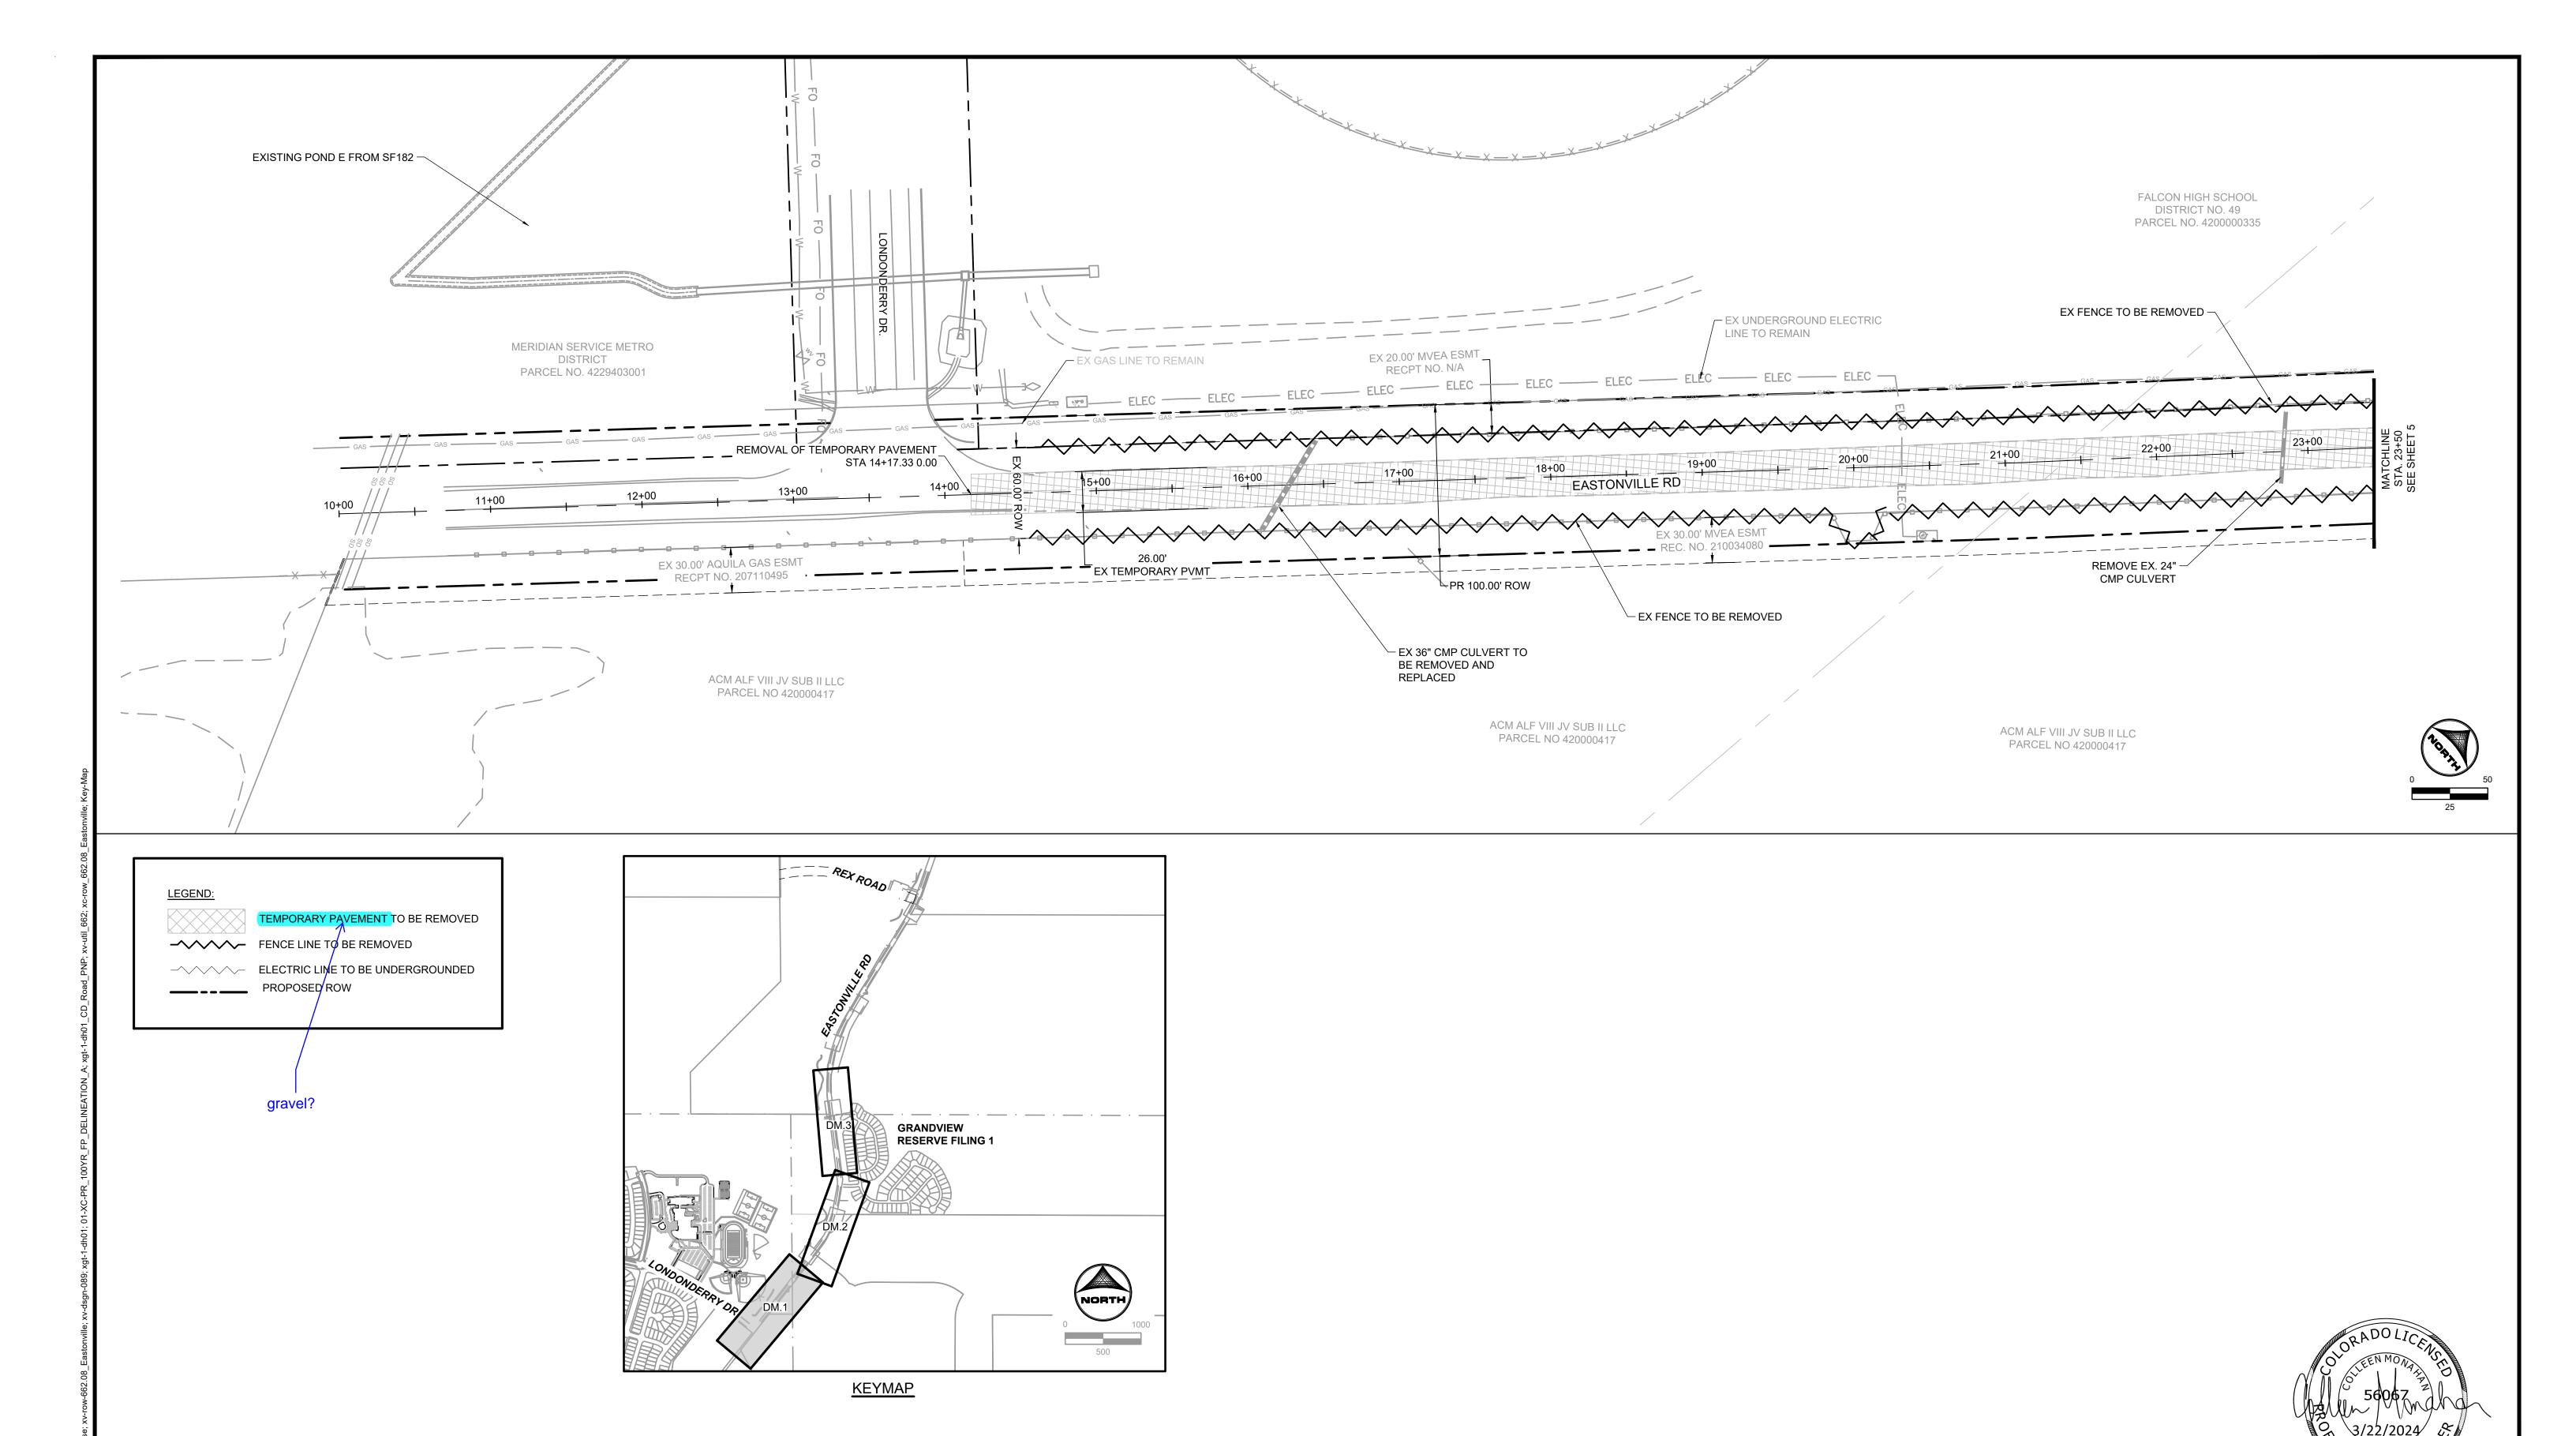

EDARP FILING NO. 2321

BAR IS ONE INCH ON OFFICIAL DRAWINGS. REVISION DESCRIPTION NO. DATE BY JOB DATE: <u>3/18/2024</u> DRAWN BY: ACH APPROVED: CPM JOB NUMBER: 201662.08 CAD DATE: 3/22/2024 CAD FILE: J:\2020\201662\CAD\Dwgs\C\Eastonville_Road_662.08\Segment_1\CD\Road_CDs\Demo_Plan



HR GREEN - COLORADO SPRINGS
1975 RESEARCH PARKWAY SUITE 230
COLORADO SPRINGS CO 80920
PHONE: 719.300.4140
FAX: 713.965.0044


EASTONVILLE ROAD IMPROVEMENTS

D'R'HORTON


America's Builder

EASTONVILLE ROAD SEGEMENT 1 IMPROVEMENTS DEMOLITION PLAN

DM.1

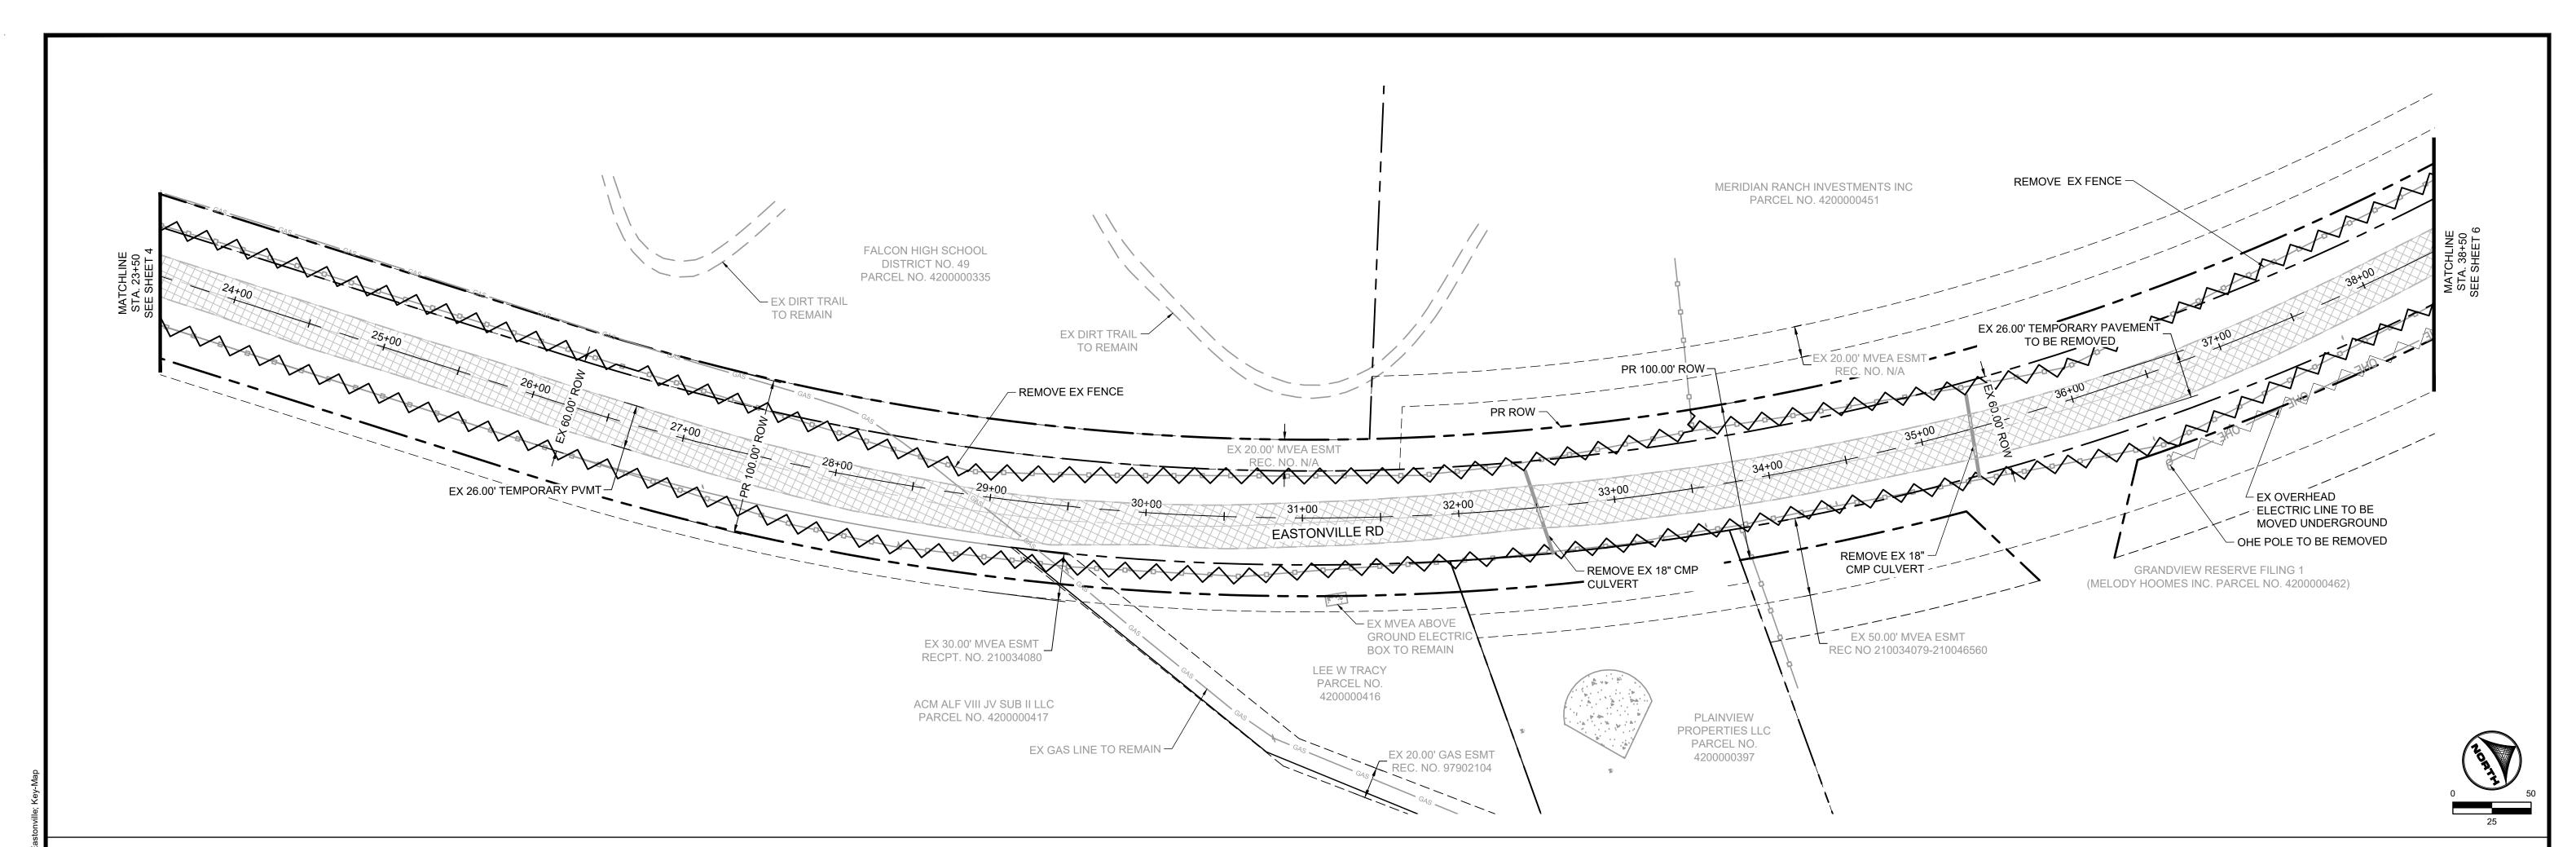

LEGEND: TEMPORARY PAVEMENT TO BE REMOVED FENCE LINE TO BE REMOVED -__\ ELECTRIC LINE TO BE UNDERGROUNDED PROPOSED ROW

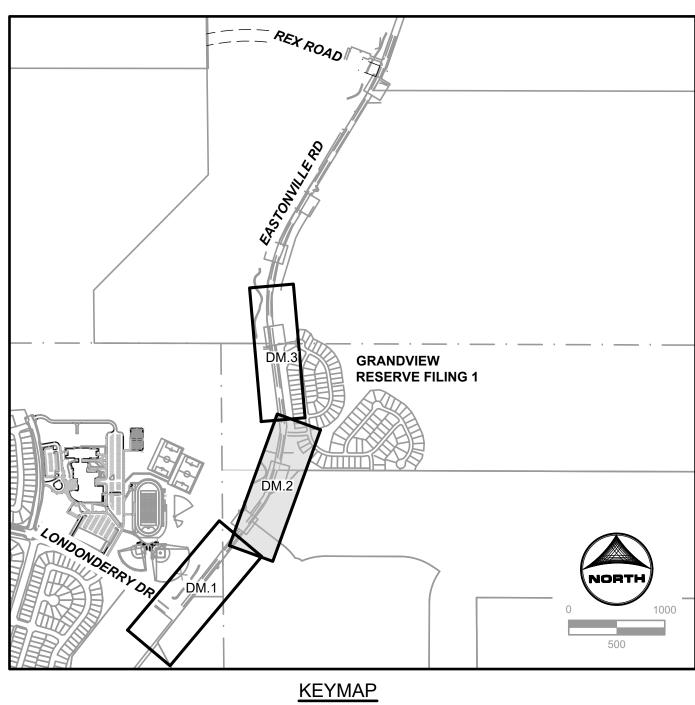



EDARP FILING NO. 2321

BAR IS ONE INCH ON OFFICIAL DRAWINGS. NO. DATE BY JOB DATE: <u>3/18/2024</u> REVISION DESCRIPTION DRAWN BY: ACH APPROVED: CPM JOB NUMBER: 201662.08 CAD DATE: 3/22/2024 CAD FILE: J:\2020\201662\CAD\Dwgs\C\Eastonville_Road_662.08\Segment_1\CD\Road_CDs\Demo_Plan




HR GREEN - COLORADO SPRINGS
1975 RESEARCH PARKWAY SUITE 230
COLORADO SPRINGS CO 80920
PHONE: 719.300.4140
FAX: 713.965.0044


EASTONVILLE ROAD IMPROVEMENTS DR. HORTON EL PASO COUNTY, COLORADO

70. 11	OWYOU	
·K·H	ORTON	
tmerica	a's Builder	

EASTONVILLE ROAD SEGEMENT 1 IMPROVEMENTS DEMOLITION PLAN

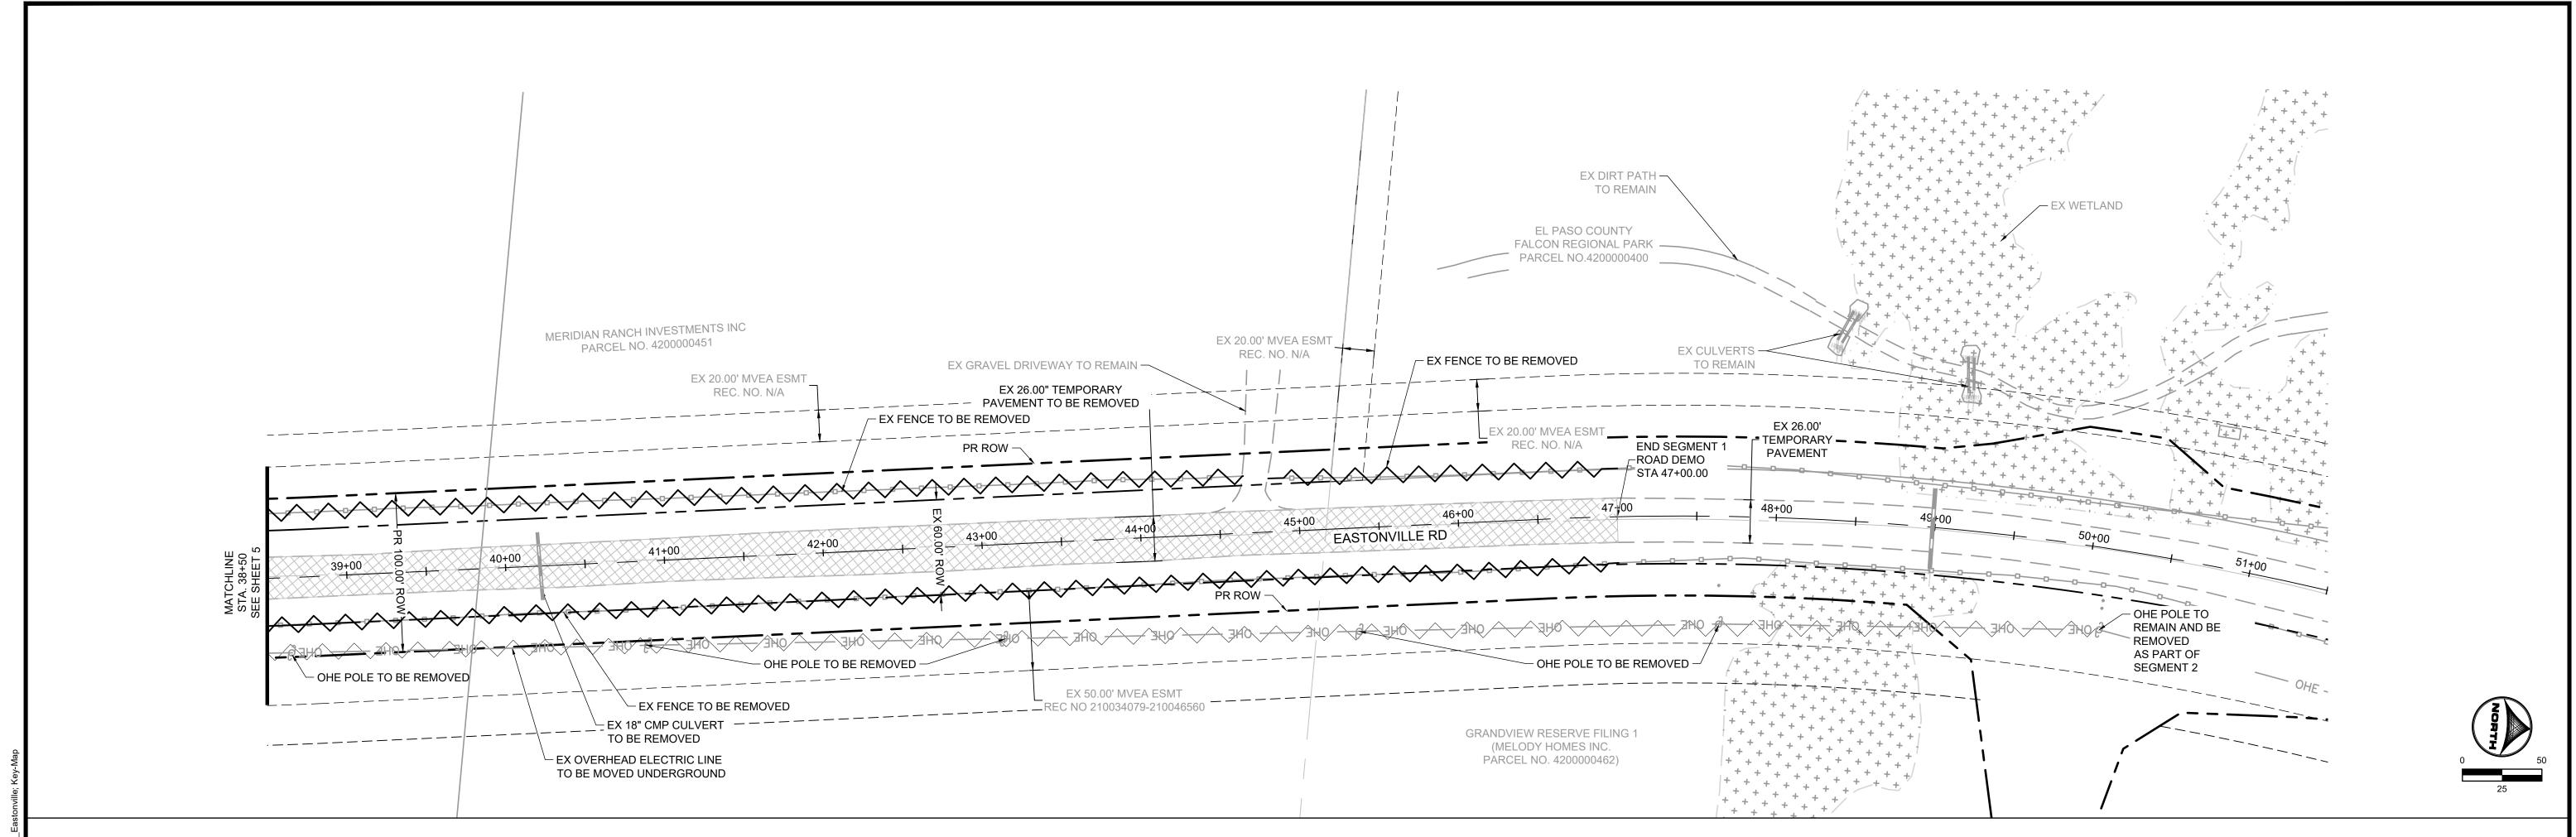

LEGEND: TEMPORARY PAVEMENT TO BE REMOVED -__\ ELECTRIC LINE TO BE UNDERGROUNDED PROPOSED ROW

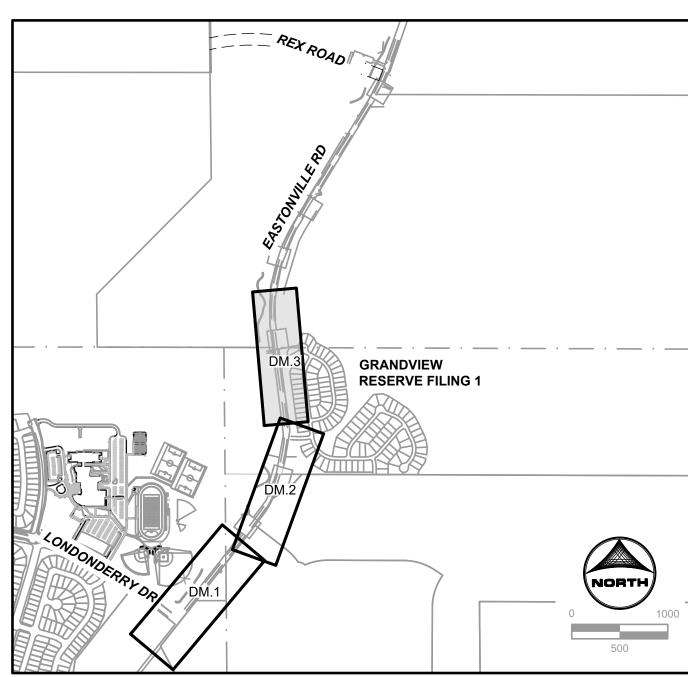

<u>KEYMAP</u>



EDARP FILING NO. 2321

BAR IS ONE INCH ON OFFICIAL DRAWINGS. NO. DATE BY JOB DATE: <u>3/18/2024</u> REVISION DESCRIPTION DRAWN BY: ACH APPROVED: CPM JOB NUMBER: <u>201662.08</u> CAD DATE: 3/22/2024 CAD FILE: J:\2020\201662\CAD\Dwgs\C\Eastonville_Road_662.08\Segment_1\CD\Road_CDs\Demo_Plan

HR GREEN - COLORADO SPRINGS
1975 RESEARCH PARKWAY SUITE 230
COLORADO SPRINGS CO 80920
PHONE: 719.300.4140
FAX: 713.965.0044


EASTONVILLE ROAD IMPROVEMENTS


D'R'HORTON

America's Builder

EASTONVILLE ROAD SEGEMENT 1 IMPROVEMENTS DEMOLITION PLAN

DM.3

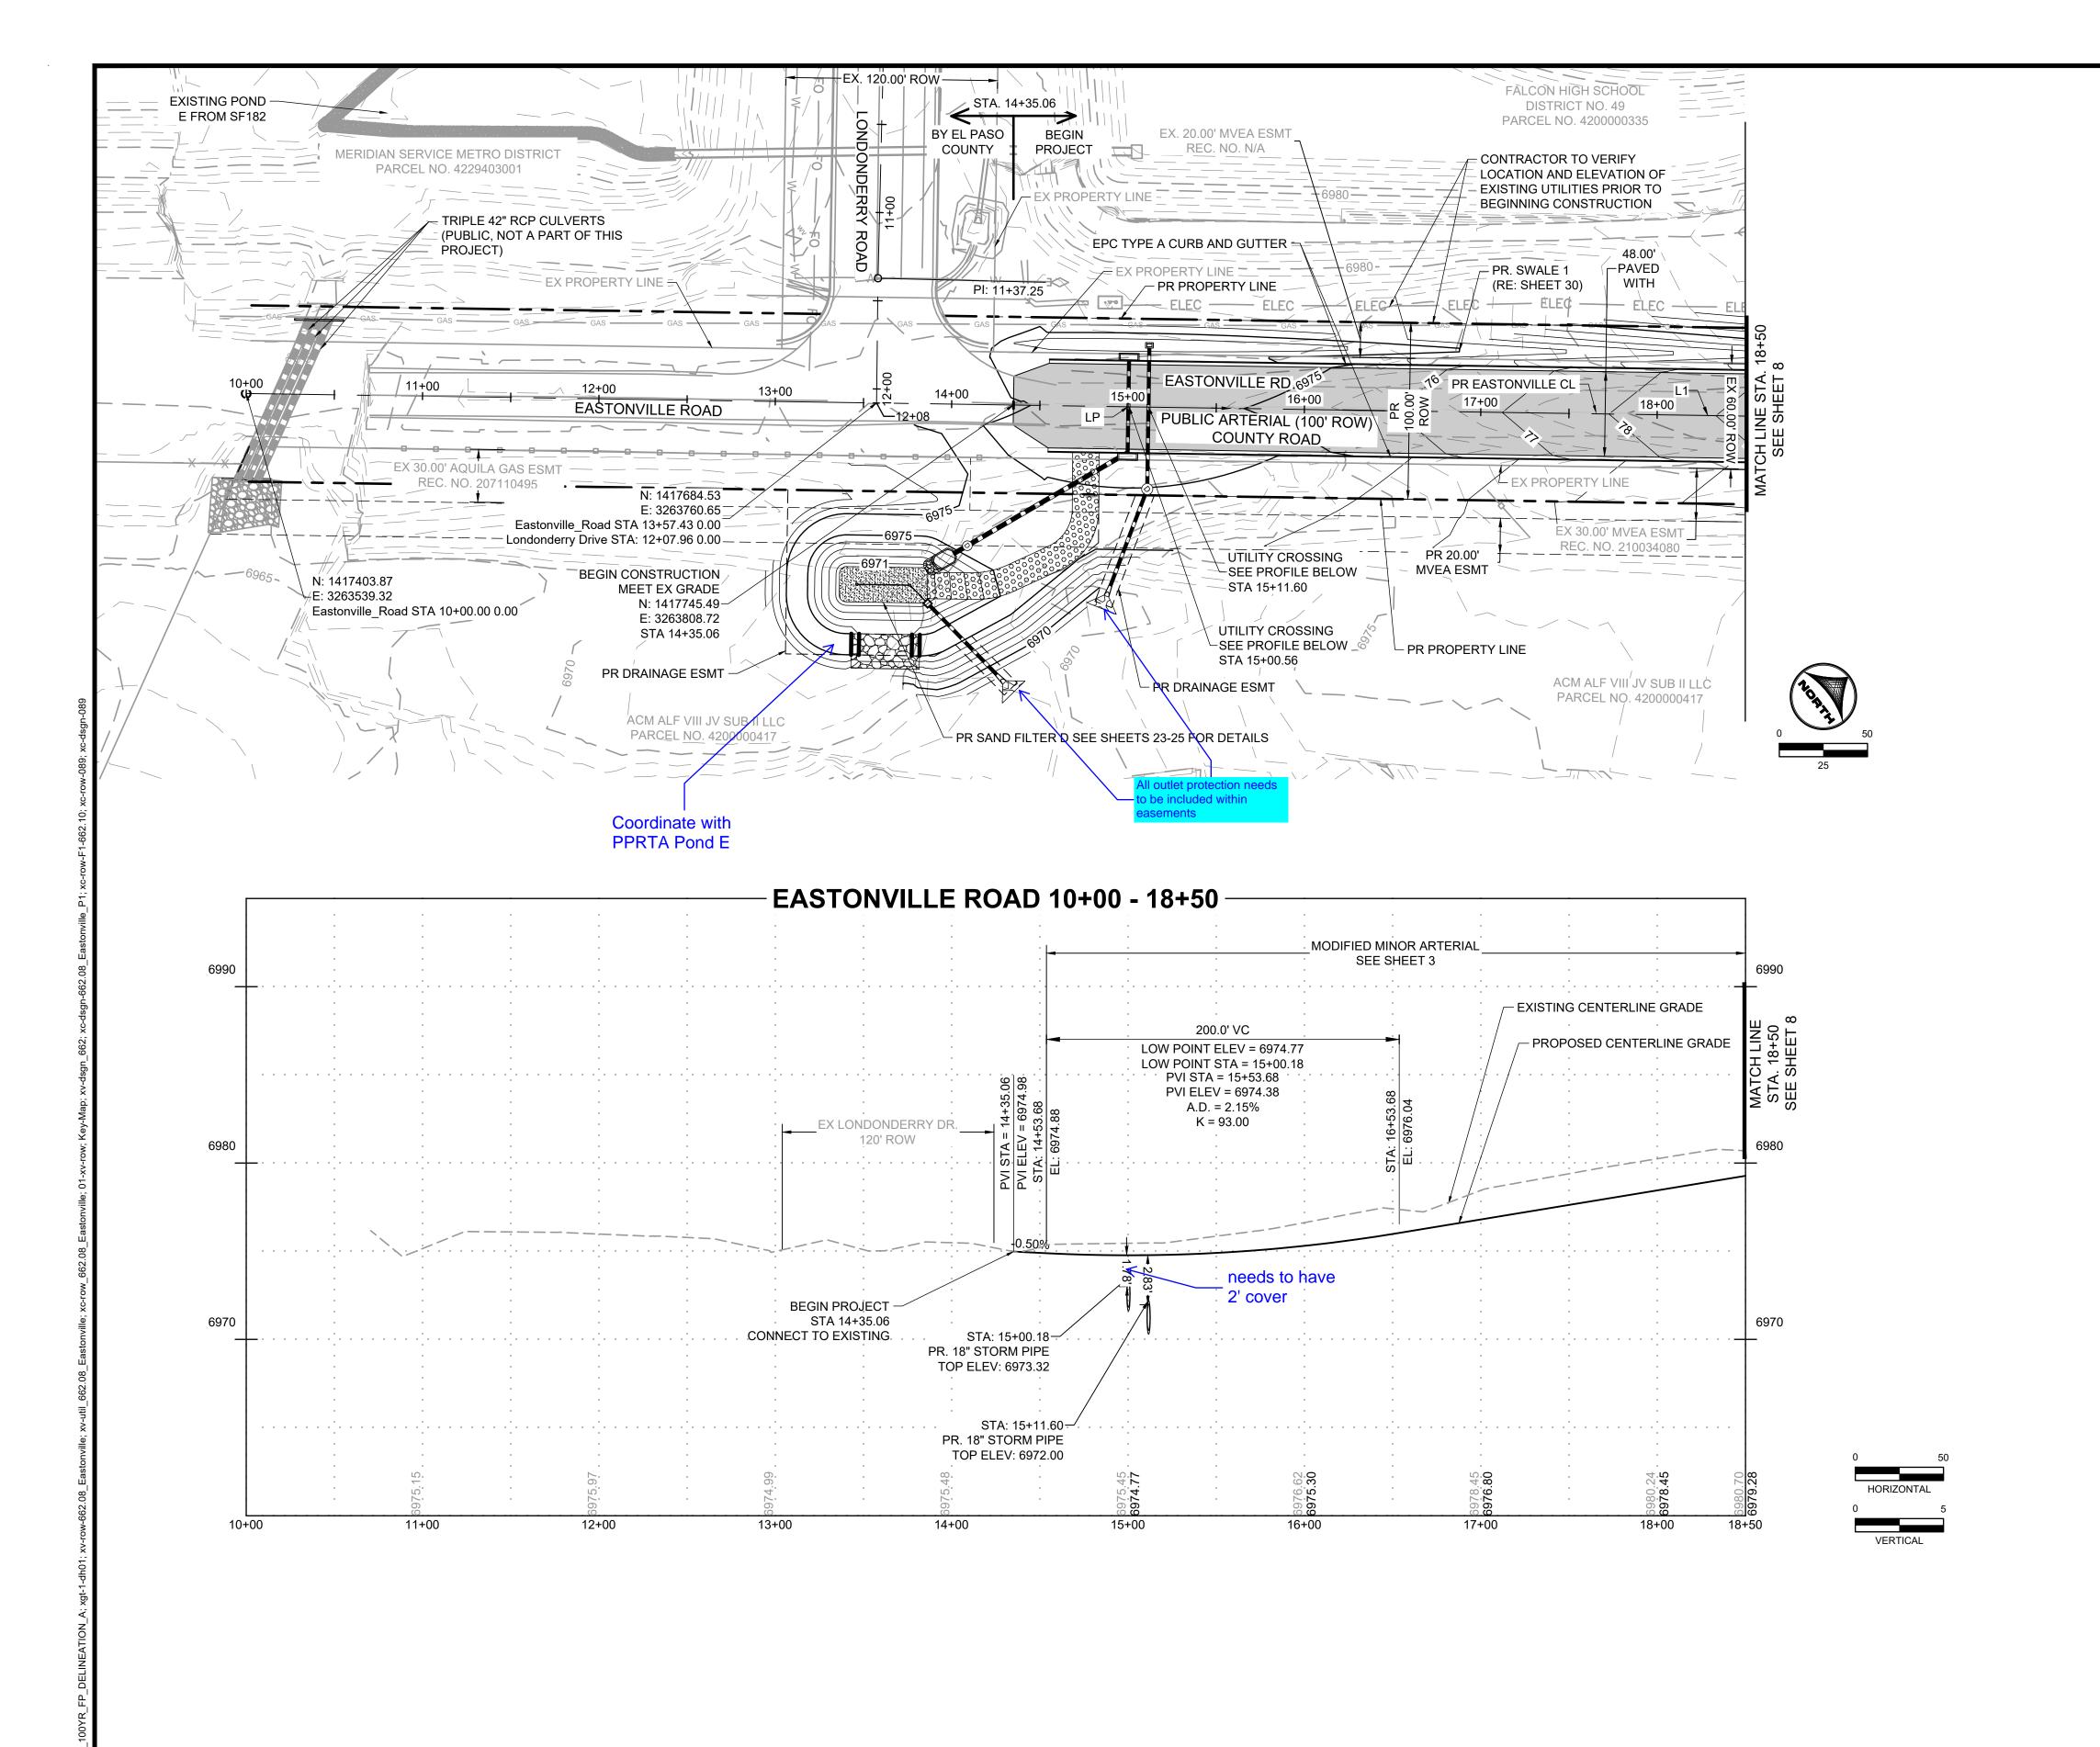

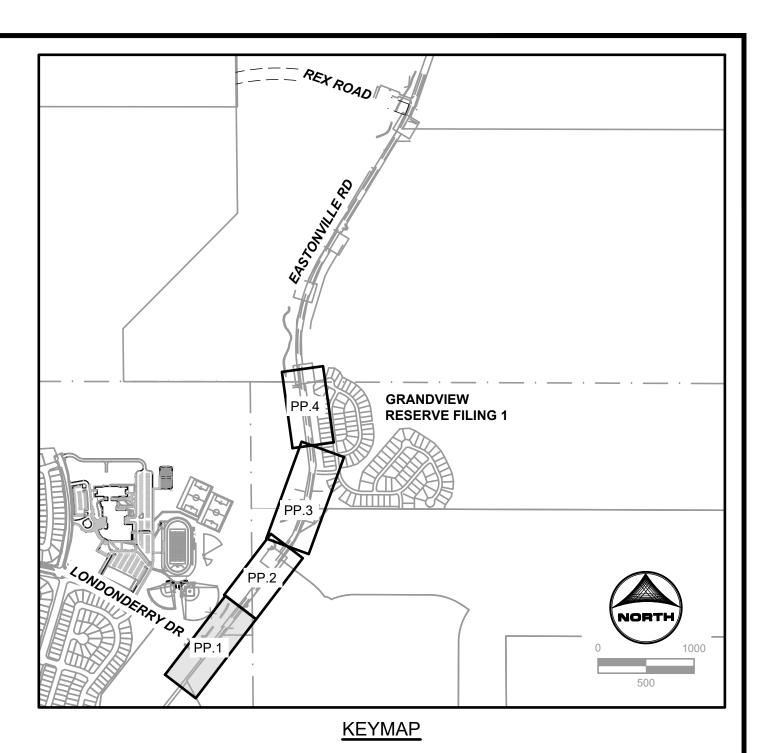

Line Table

Line # Length Direction

L1 460.78 N 38°15'31" E



Know what's below.
Call before you dig.

EDARP FILING NO. 2321

DRAWN BY: ACH JOB DATE: 3/21/2024 BAR IS ONE INCH ON OFFICIAL DRAWINGS.

APPROVED: CPM JOB NUMBER: 201662.08 0 IF NOT ONE INCH,
ADJUST SCALE ACCORDINGLY.
CAD FILE: J:\2020\201662\CAD\Dwgs\C\Eastonville_Road_662.08\Segment_1\CD\Road_CDs\Road_Pnp


REVISION DESCRIPTION


HR GREEN - COLORADO SPRINGS
1975 RESEARCH PARKWAY SUITE 230
COLORADO SPRINGS CO 80920
PHONE: 719.300.4140
FAX: 713.965.0044

EASTONVILLE ROAD IMPROVEMENTS
DR. HORTON
EL PASO COUNTY, COLORADO


EASTONVILLE ROAD SEGEMENT 1 IMPROVEMENTS
PLAN & PROFILE

PP.1

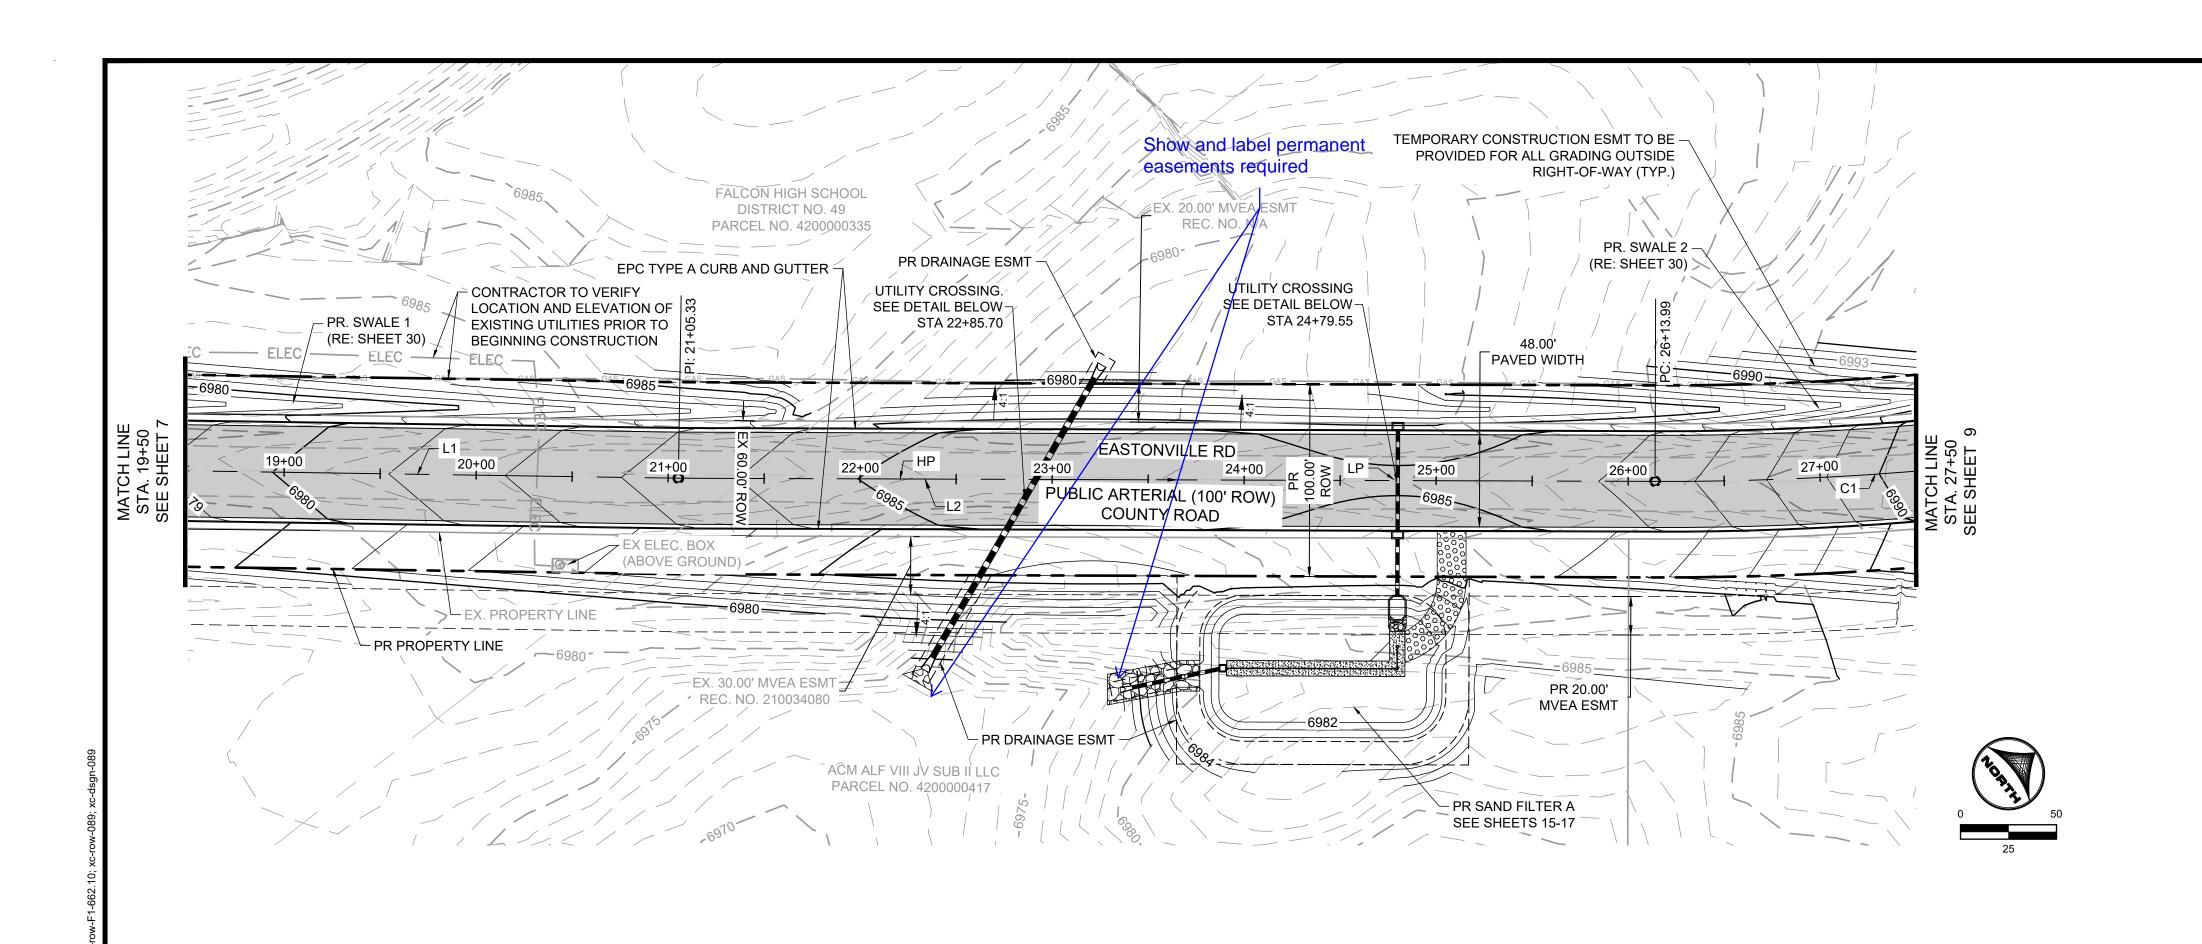

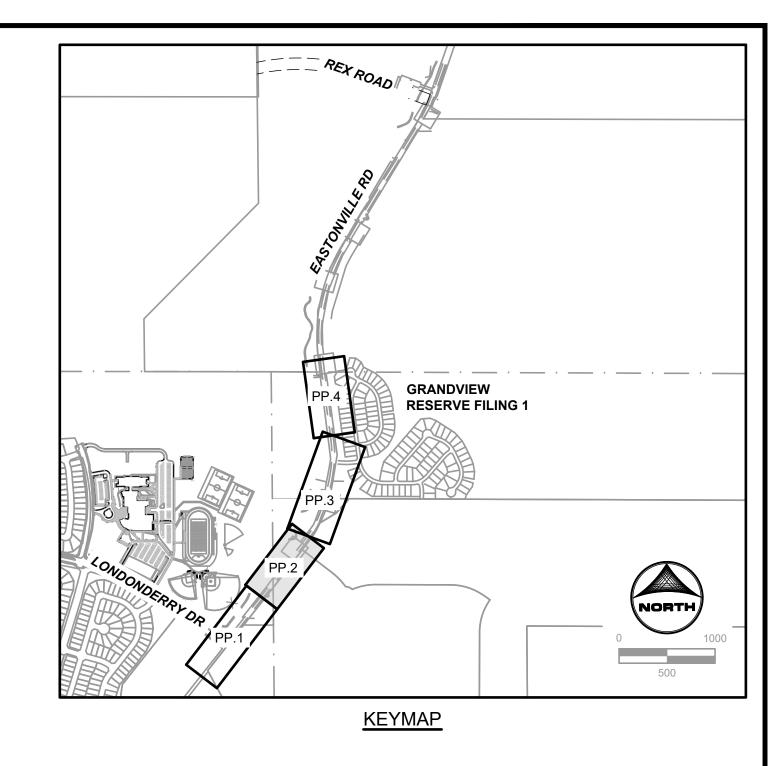

Line # Length Direction Curve # Length Radius Delta L1 460.78 N 38°15'31" E C1 1263.66 1600.00 45°15'05" L2 508.66 N 37°34'53" E		Line T	able	Curve Table							
	Line #	Length	Direction	Curve #	Length	Radius	Delta				
L2 508.66 N 37°34'53" E	L1	460.78	N 38°15'31" E	C1	1263.66	1600.00	45°15'05"				
	L2	508.66	N 37°34'53" E								

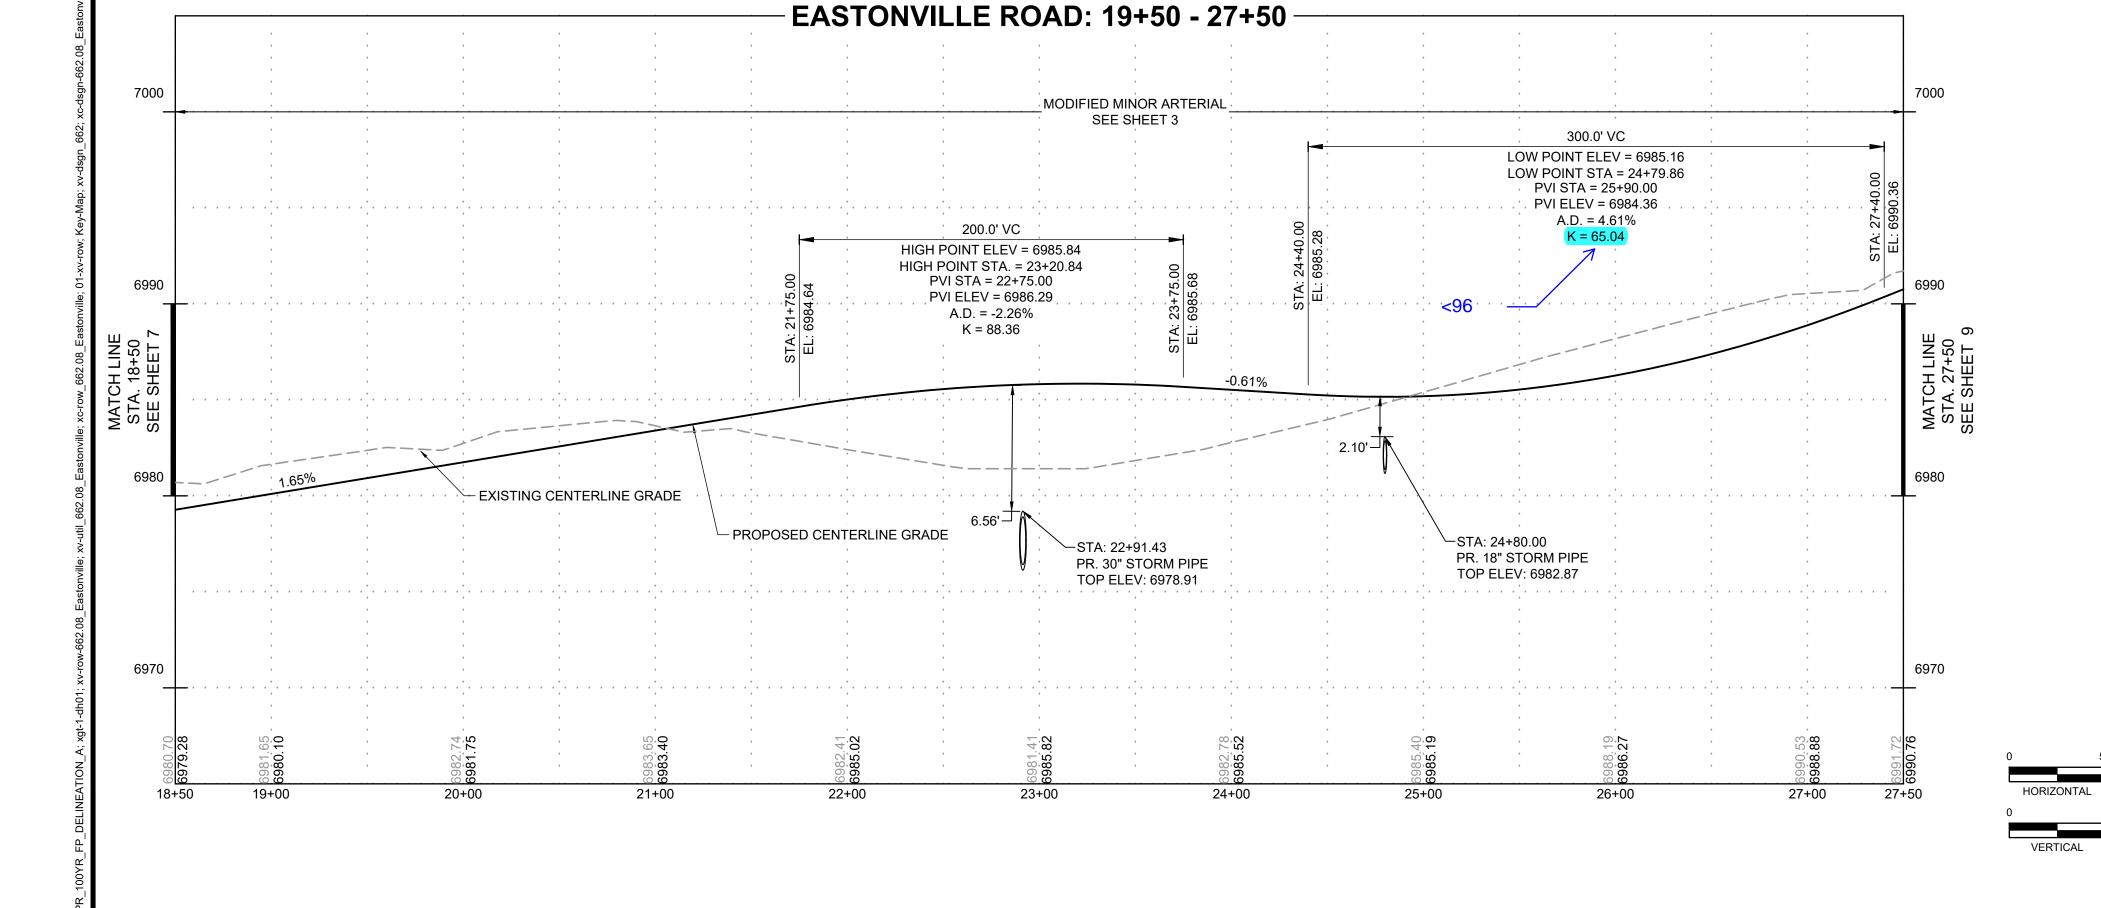

NO. DATE BY




PLAN & PROFILE

EDARP FILING NO. 2321

EASTONVILLE ROAD SEGEMENT 1 IMPROVEMENTS


Call before you dig.


APPROVED: <u>CPM</u> JO	B NUMBER:	201662.08	0 1"
CAD DATE: <u>3/22/2024</u>			IF NOT ONE INCH, ADJUST SCALE ACCORDINGLY.
CAD FILE: <u>J:\2020\201662\CAD\</u>	Owgs\C\Easto	nville_Road_662.08\Segr	ment_1\CD\Road_CDs\Road_Pnp

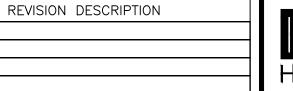



HR GREEN - COLORADO SPRINGS
1975 RESEARCH PARKWAY SUITE 230
COLORADO SPRINGS CO 80920
PHONE: 719.300.4140
FAX: 713.965.0044

EASTONVILLE ROAD IMPROVEMENTS DR. HORTON EL PASO COUNTY, COLORADO

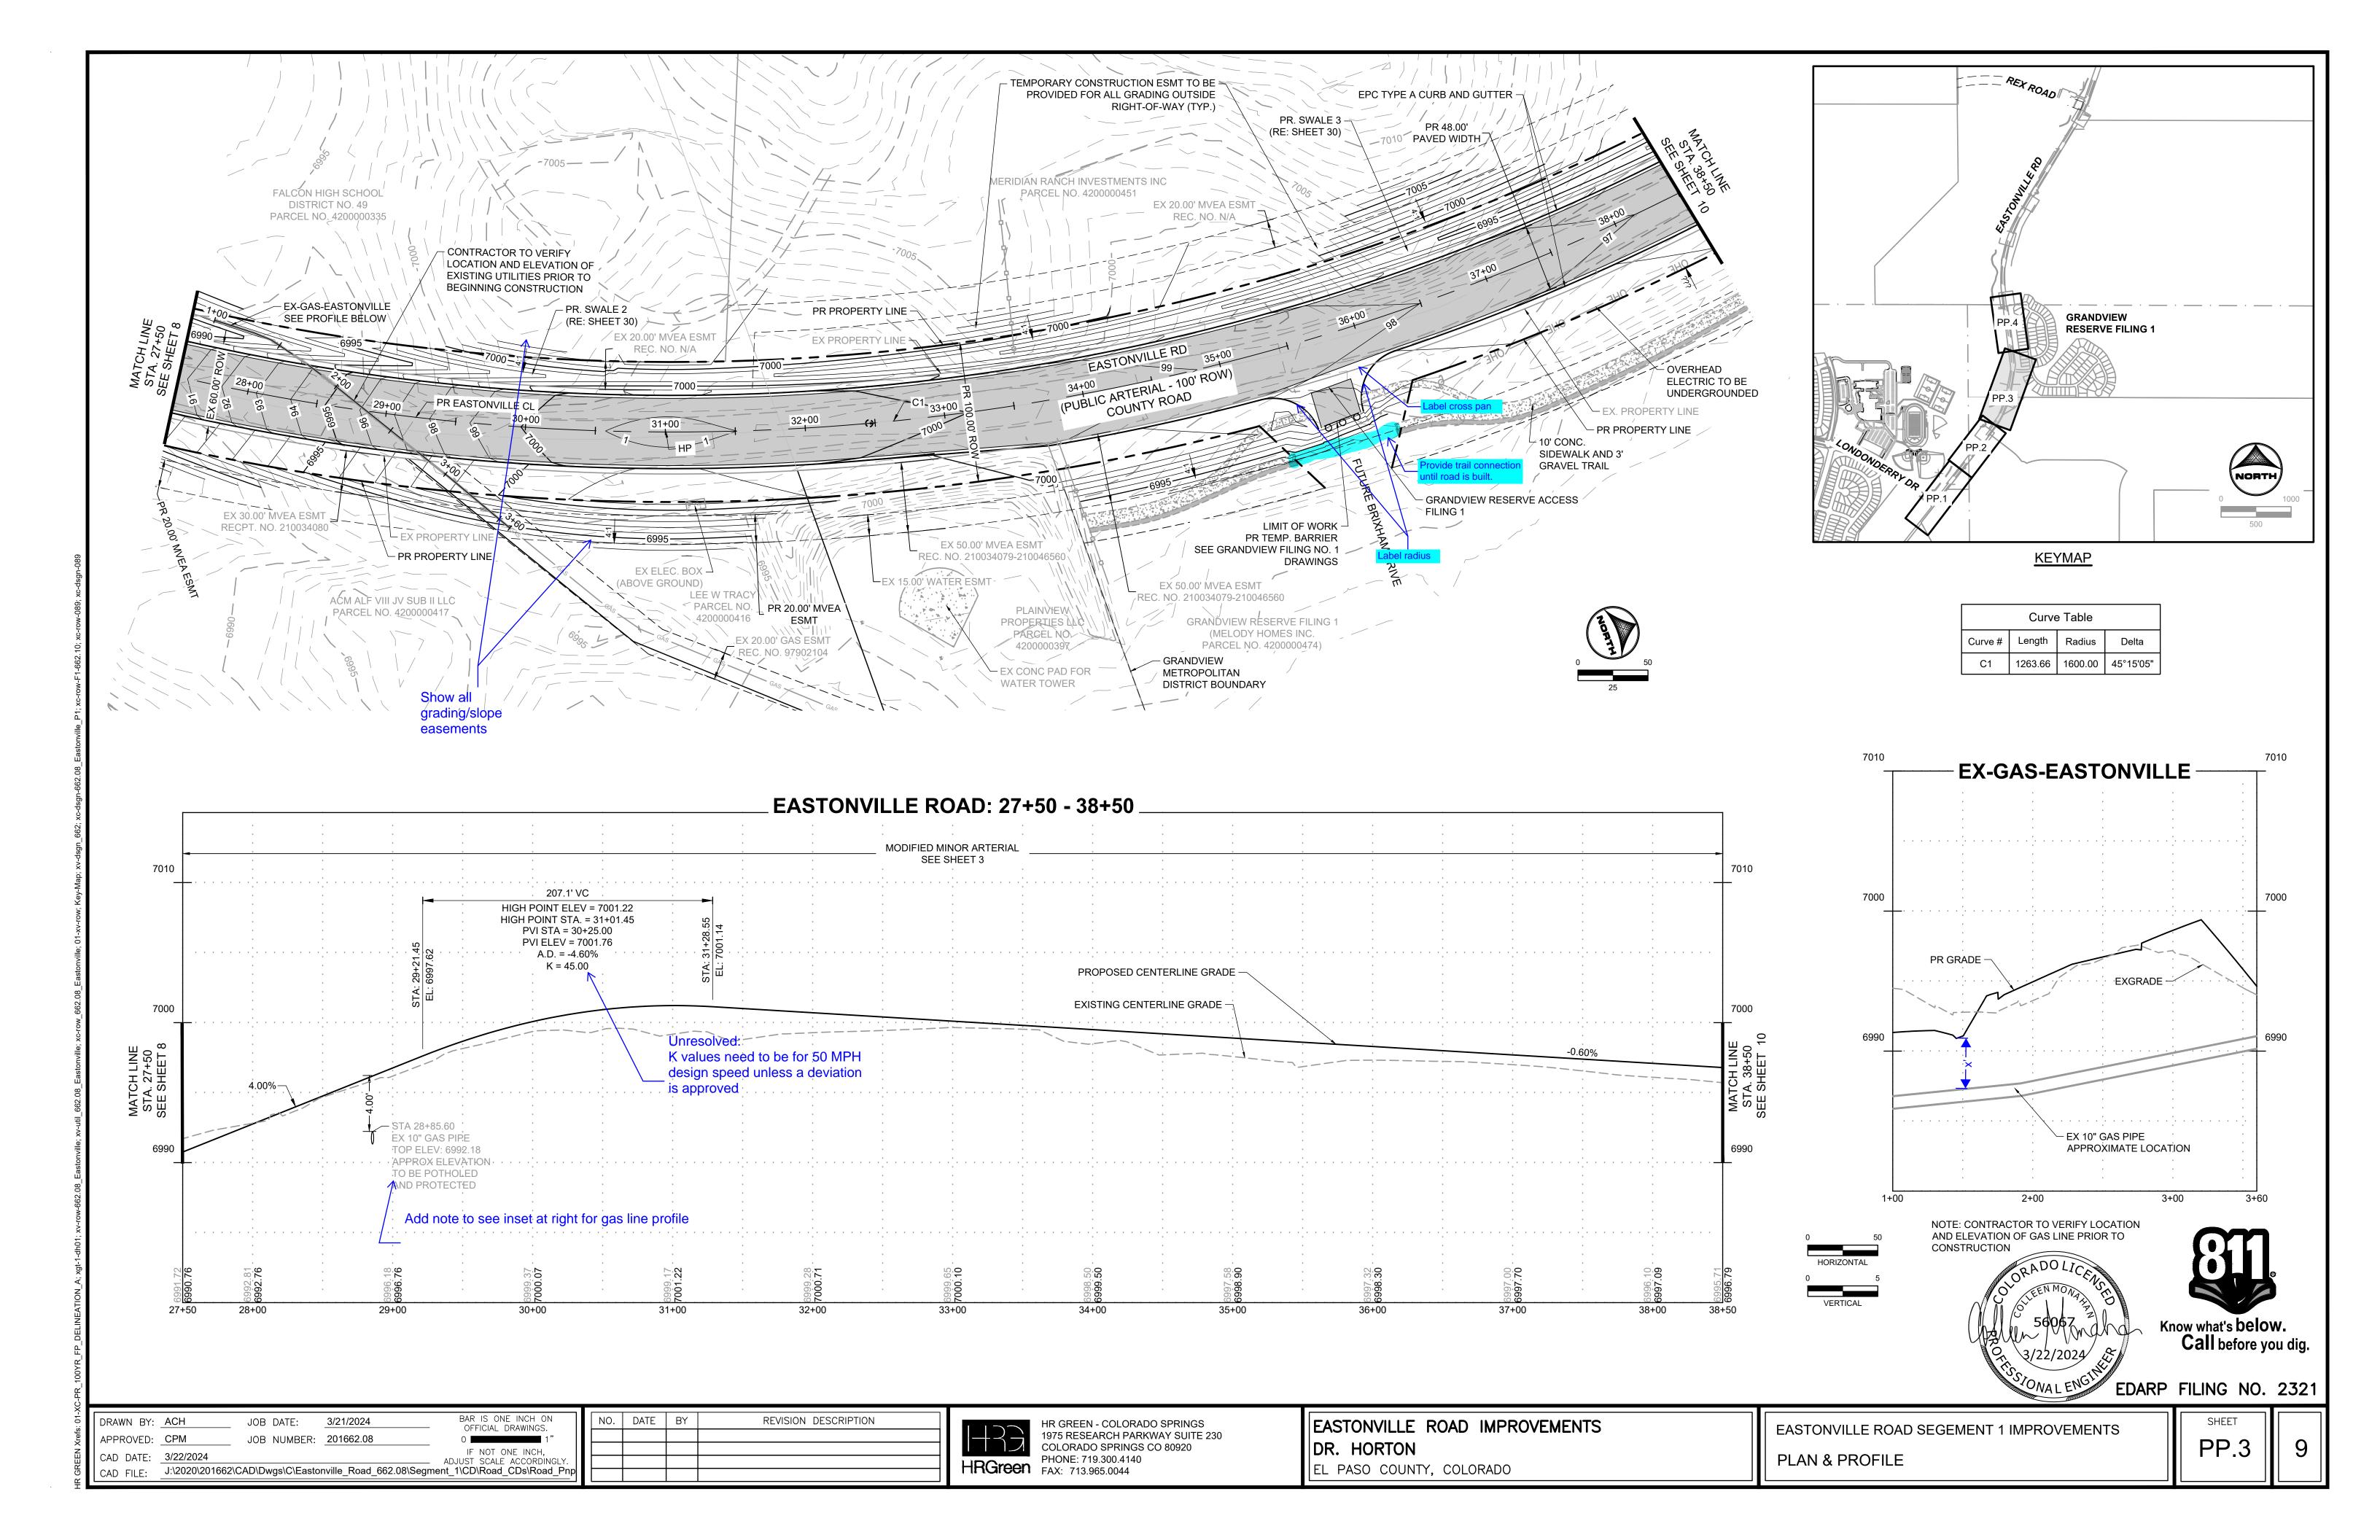

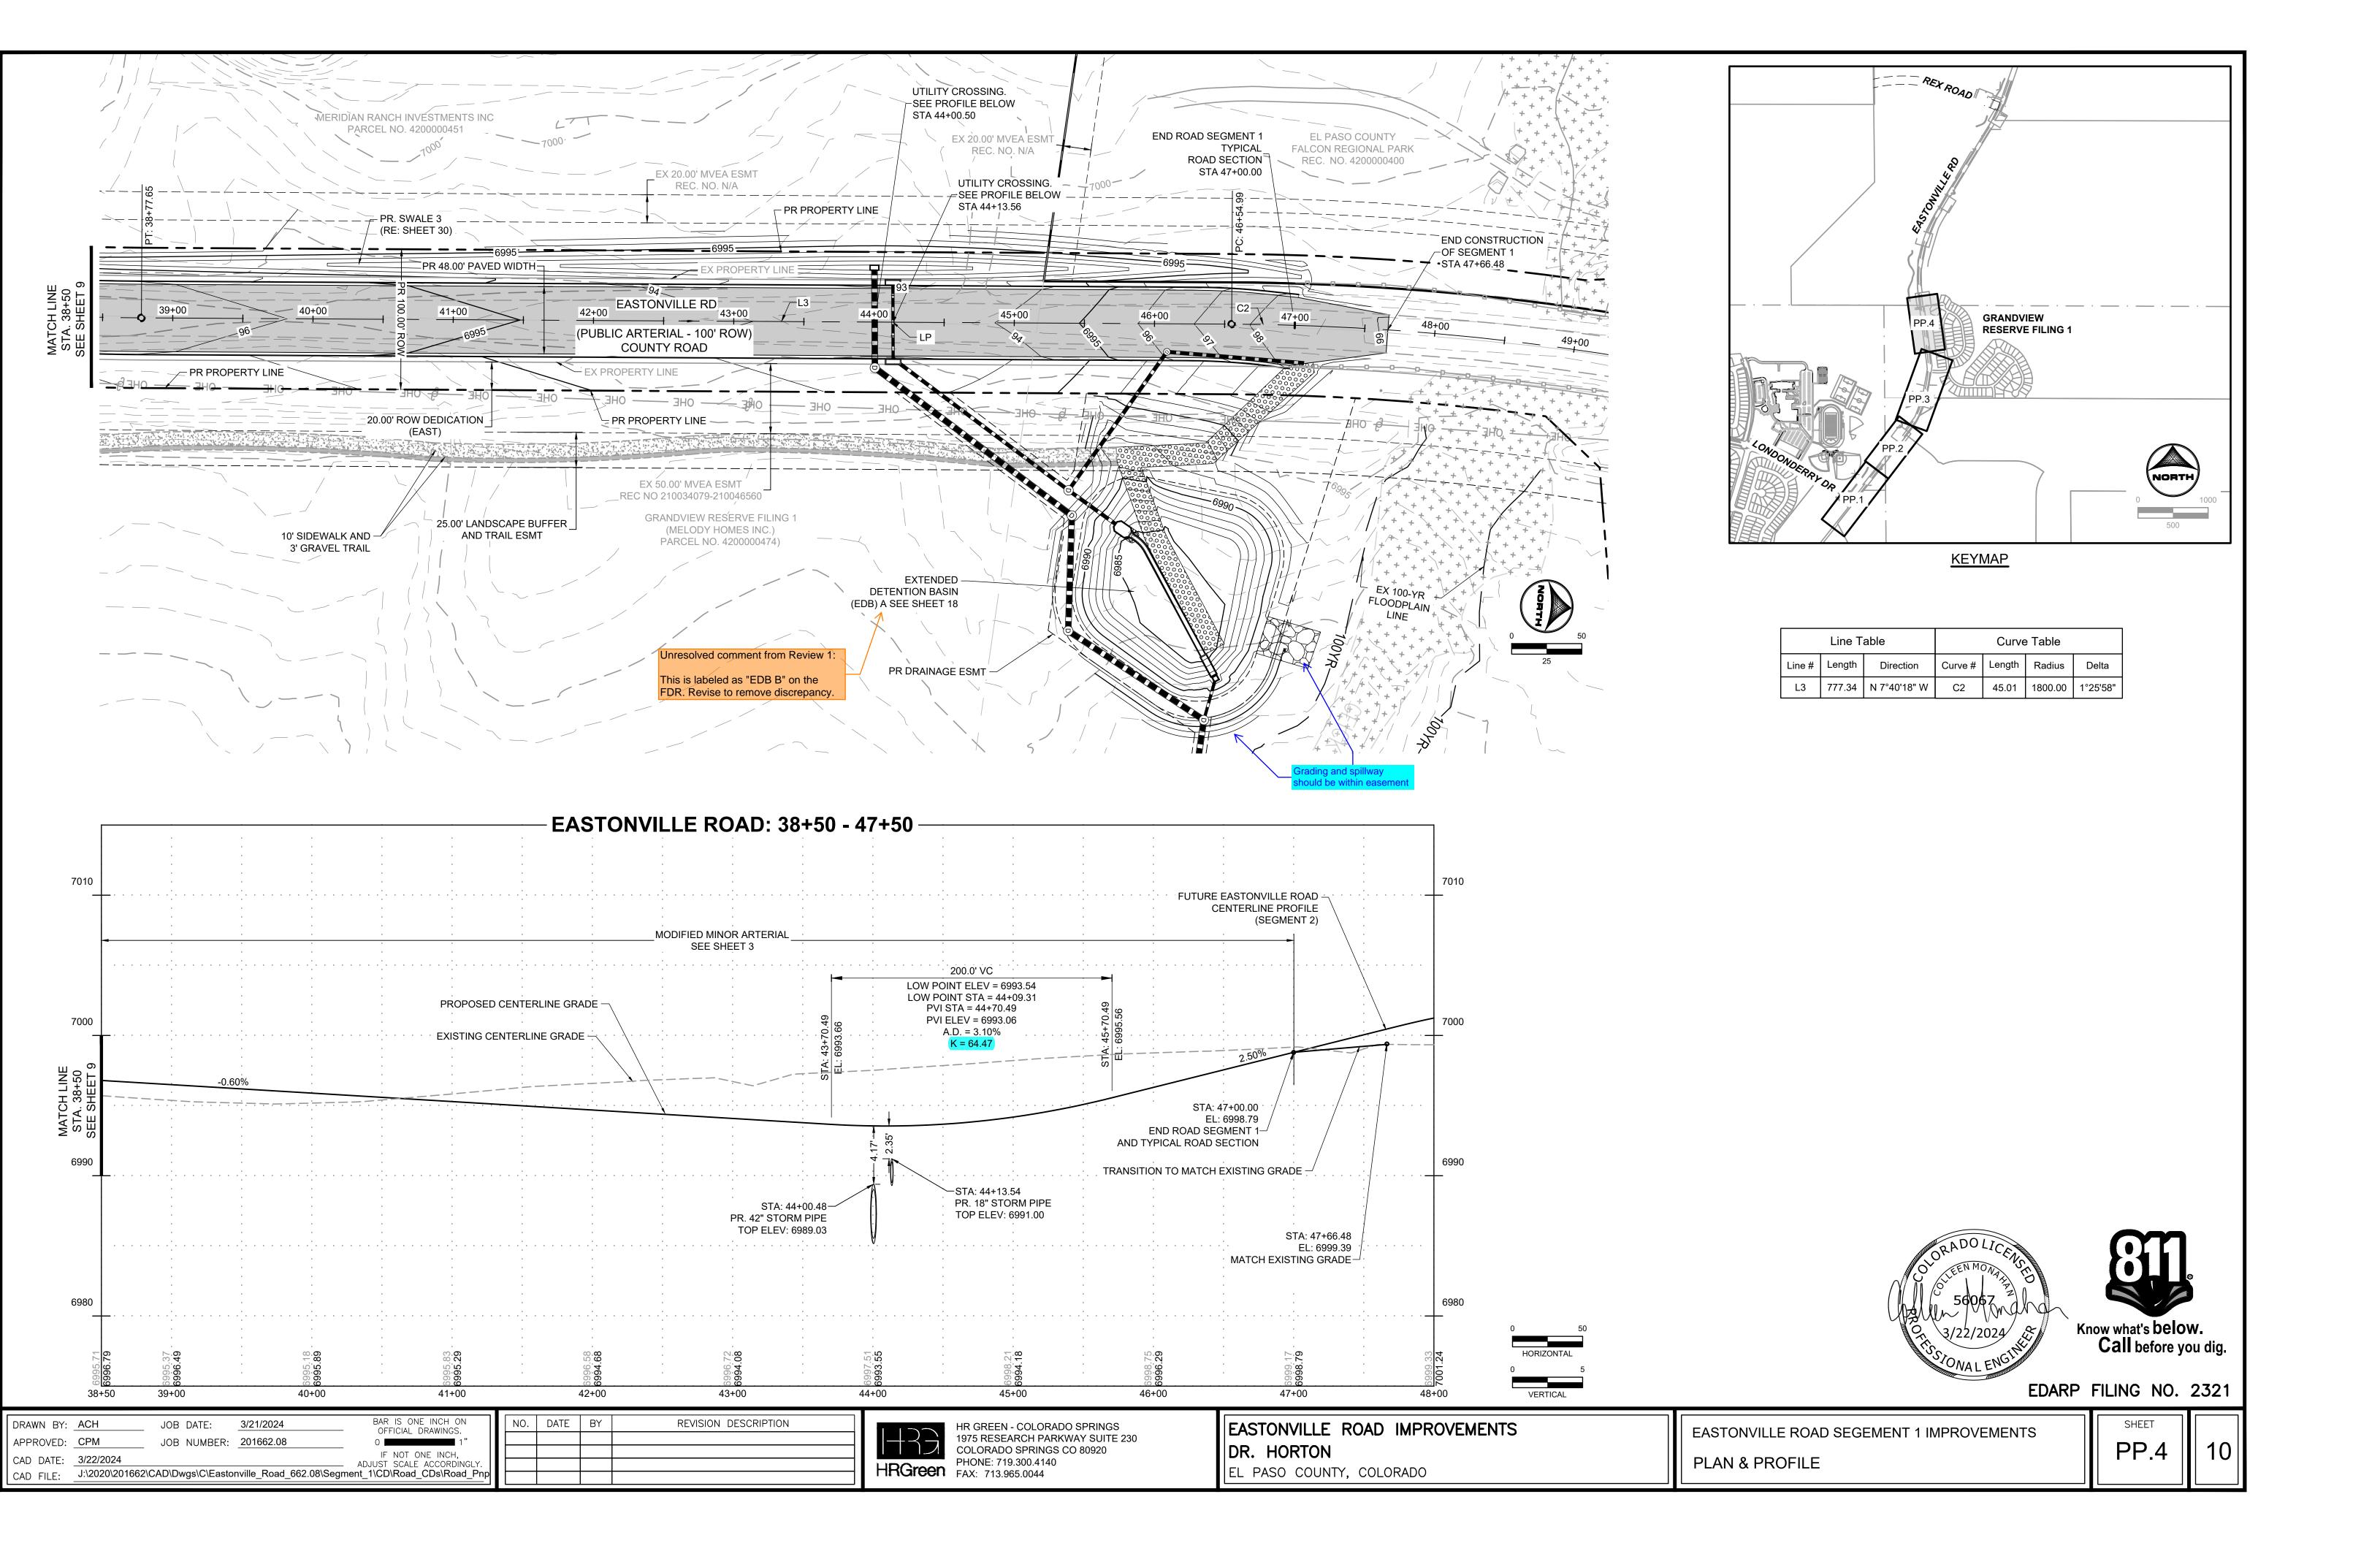

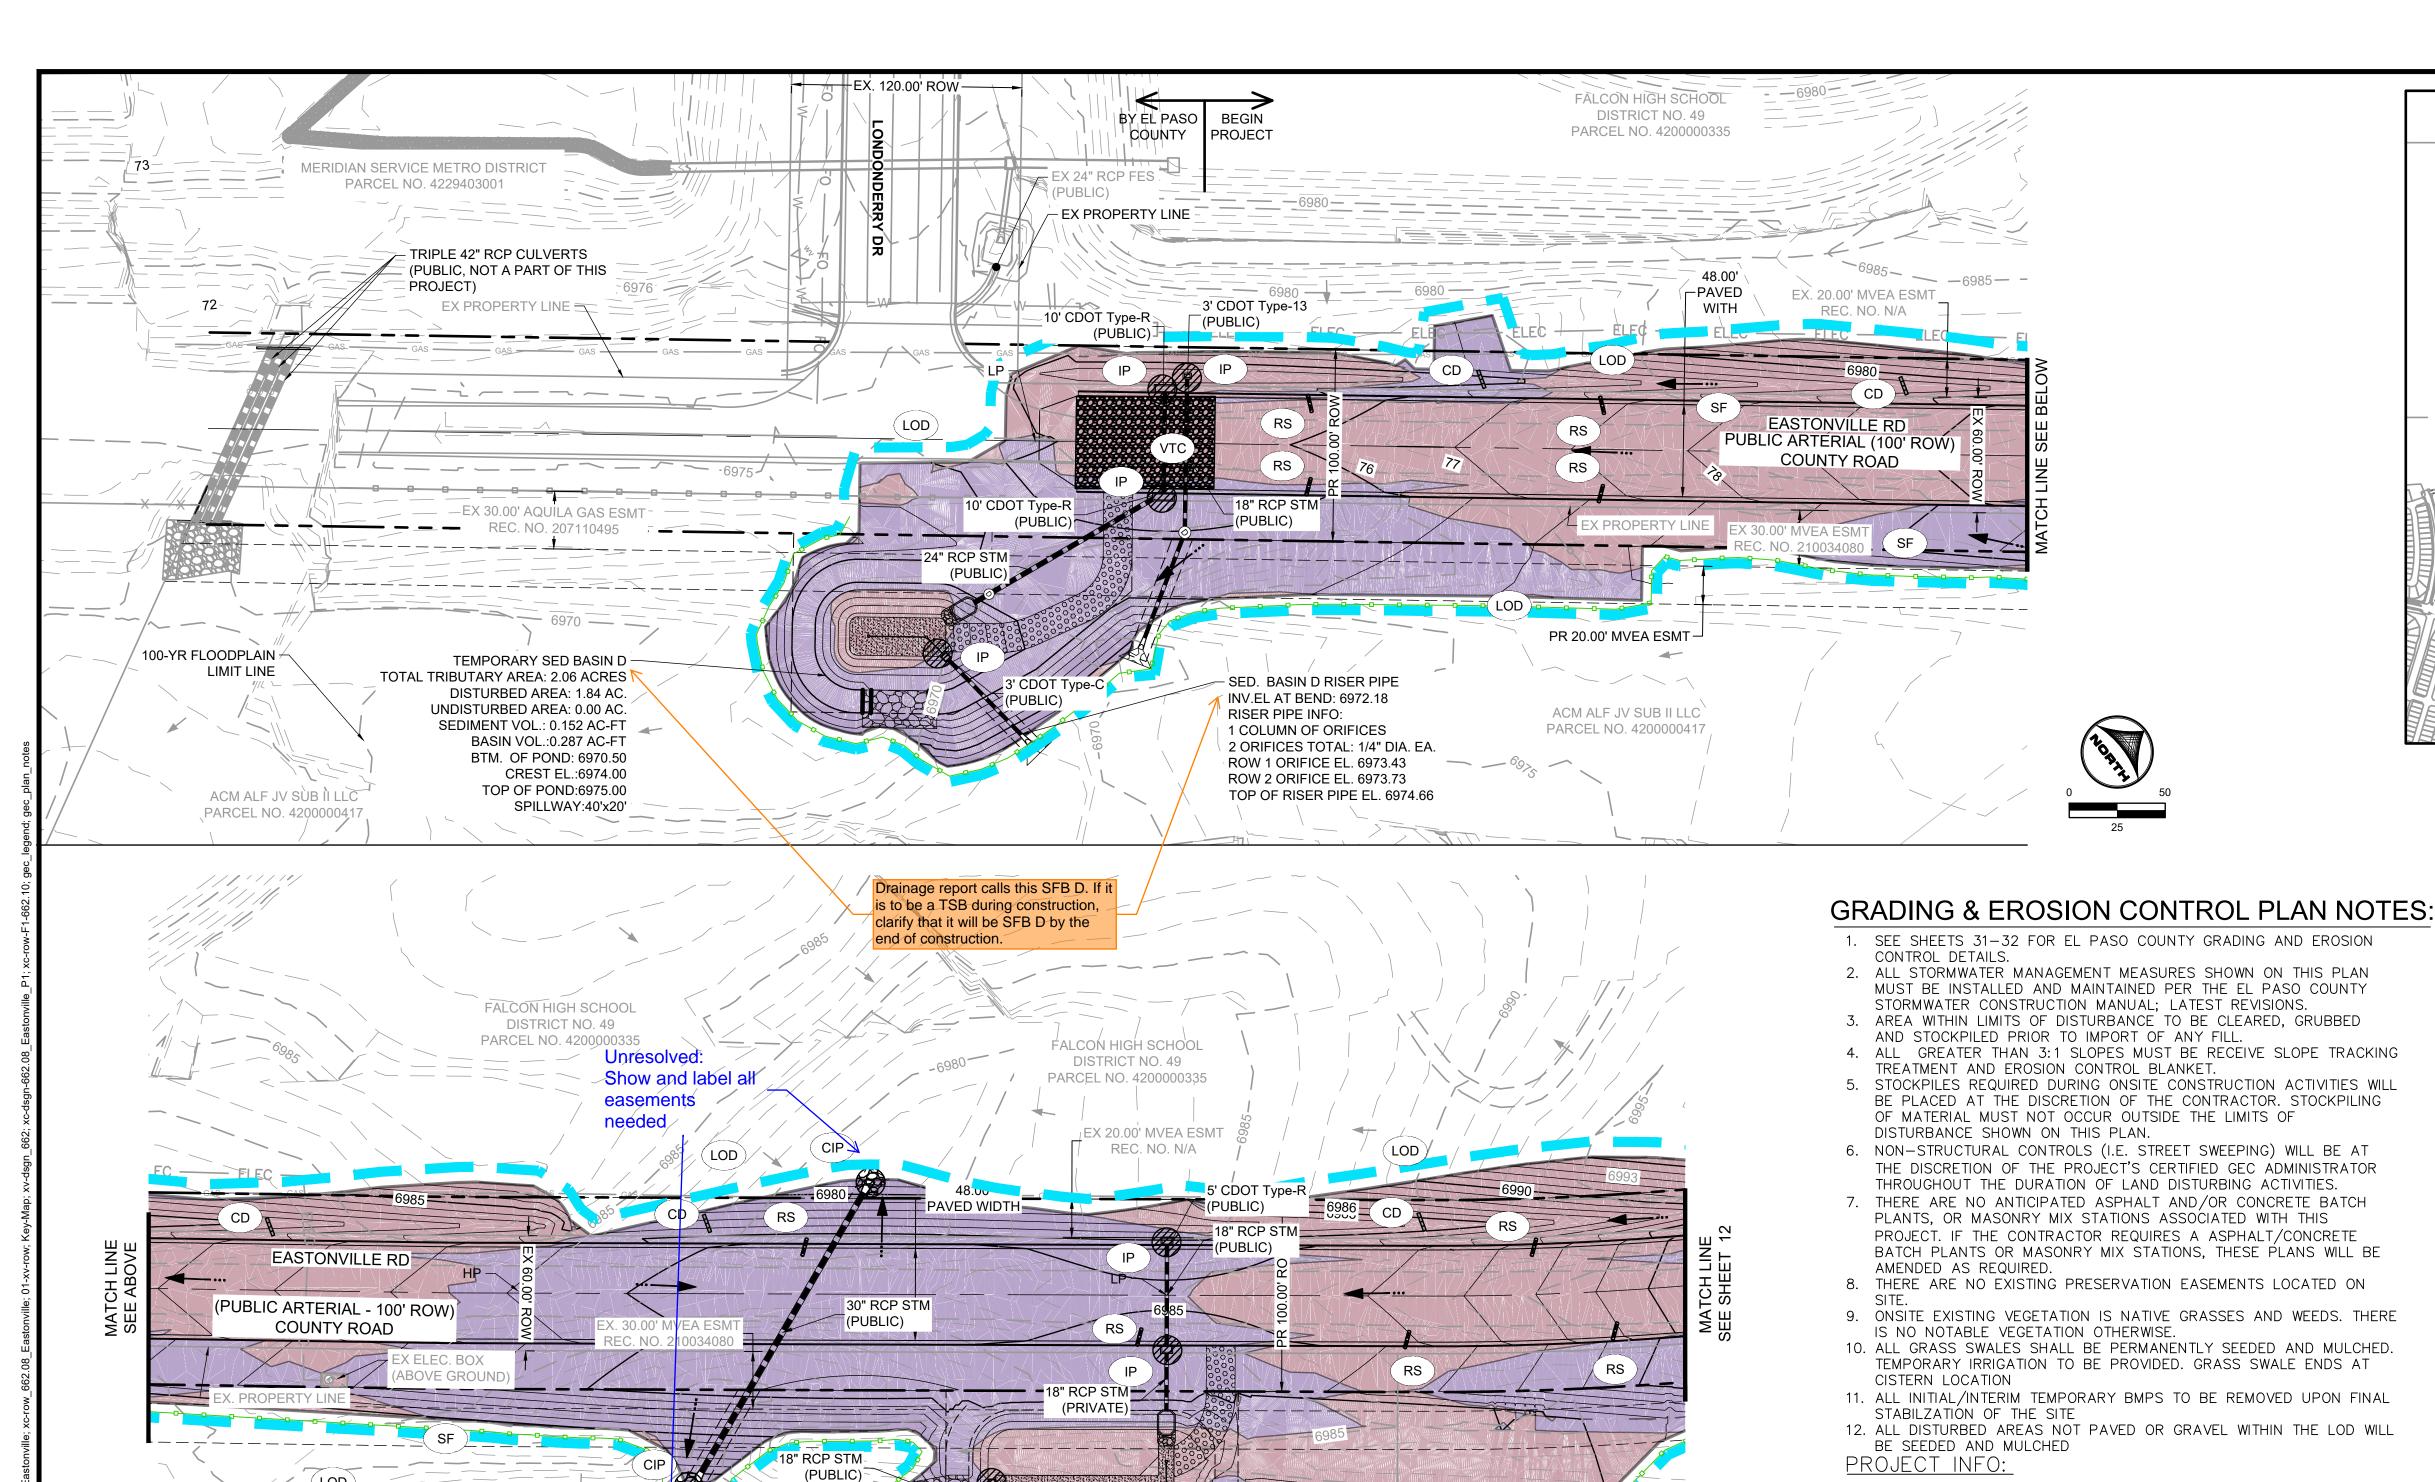

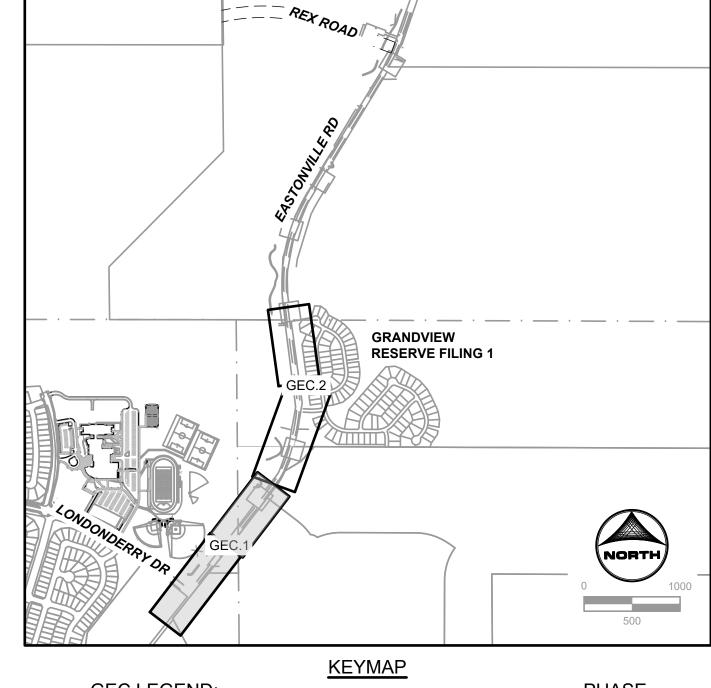

GEC LEGEND: PHASE (CWA) CONCRETE WASHOUT AREA INTERIM IP) INLET PROTECTION INTERIM INTERIM (CIP) CULVERT INLET PROTECTION SF) SILT FENCE INITIAL/INTERIM SSA) STABILIZED STAGING AREA INTERIM VTC) VEHICLE TRACKING CONTROL INITIAL (EDB) EXTENDED DETENTION BASIN FINAL INTERIM TSB) TEMPORARY SEDIMENT BASIN INTERIM CD) CHECK DAM INTERIM (RS) ROCK SOCK (LOD) LIMITS OF CONSTRUCTION/ DISTURBANCE PROP FLOW DIRECTION EX FLOW DIRECTION EX PROPERTY LINE EX RIGHT OF WAY **CUT CONDITION** FILL CONDITION

NOTE: ALL DISTURBED AREAS OUTSIDE OF THE PROPOSED ROADWAY SECTION SHALL BE RESEEDED AND MULCHED WITH NATIVE GRASSES PER EL PASO COUNTY SEED MIX

FINAL

CUT VOLUME: 15,904 CY

FILL VOLUME: 24,305 CY

NET: 8,401 (FILL) CY [UNADJUSTED FOR PAVEMENT DEPTH]

NET: 5.417 (FILL) CY [ADJUSTED FOR 6" PAVEMENT DEPTH]



TABLE 1.1 - STRAW BAI	LE CHECK DAM SPACING
SLOPE @ CHANNEL FLOWLINE (%)	MAX SPACING (FEET)
0.5 - 0.75	200
0.75 - 1	150
1 - 1.25	120
1.25 - 1.5	100
1.5 - 1.75	85
1.75 - 2	75
2-2.5	60

Know what's below.
Call before you dig.

EDARP FILING NO. 2321

DRAWN BY: ACH JOB DATE: 3/18/2024 BAR IS ONE INCH ON OFFICIAL DRAWINGS.

APPROVED: CPM JOB NUMBER: 201662.08 0 IF NOT ONE INCH, ADJUST SCALE ACCORDINGLY.

CAD DATE: 3/22/2024 IF NOT ONE INCH, ADJUST SCALE ACCORDINGLY.

CAD FILE: J:\2020\201662\CAD\Dwgs\C\Eastonville_Road_662.08\Segment_1\CD\GEC\GEC

SED. BASIN A RISER PIFE INV.

3 ORIFICES TOTAL: 7/16" DIA. EA.

EL. AT BEND:6780.97

1 COLUMN OF ORIFICES

ROW 1 ORIFICE EL. 6982.22

ROW 2 ORIFICE EL. 6982.55

ROW 3 ORIFICE EL. 6982.88

TOP OF RISER PIPE EL. 6982.70

RISER PIPE INFO:

NO. DATE BY REVISION DESCRIPTION

ACM ALF JV SUB II LLC

PARCEL NO. 4200000417

es? Easement need for

4" PVC STM

(PRIVATE)

HR GREEN - COLOR 1975 RESEARCH PAI COLORADO SPRING PHONE: 719.300.414 FAX: 713.965.0044

PROPOSED SAND FILTER A

SEE SHEETS 16-17

HR GREEN - COLORADO SPRINGS 1975 RESEARCH PARKWAY SUITE 230 COLORADO SPRINGS CO 80920 PHONE: 719.300.4140 FAX: 713.965.0044

∸ TEMPORARY SED BASIN A

DISTURBED AREA: 2.06 AC.

UNDISTURBED AREA: 0.00 AC.

SEDIMENT VOL.: 0.17 AC-FT

BASIN VOL.:0.606 AC-FT

BTM. OF POND: 6981.00

TOP OF POND:6985.00

CREST EL::6984.00

SPILLWAY:50'x15'

TOTAL TRIBUTARY AREA: 2.06 ACRES

EASTONVILLE ROAD IMPROVEMENTS


DR. HORTON


EL PASO COUNTY, COLORADO

EASTONVILLE ROAD SEGEMENT 1 IMPROVEMENTS
GRADING & EROSION CONTROL PLAN

GEC.1

. 2.1

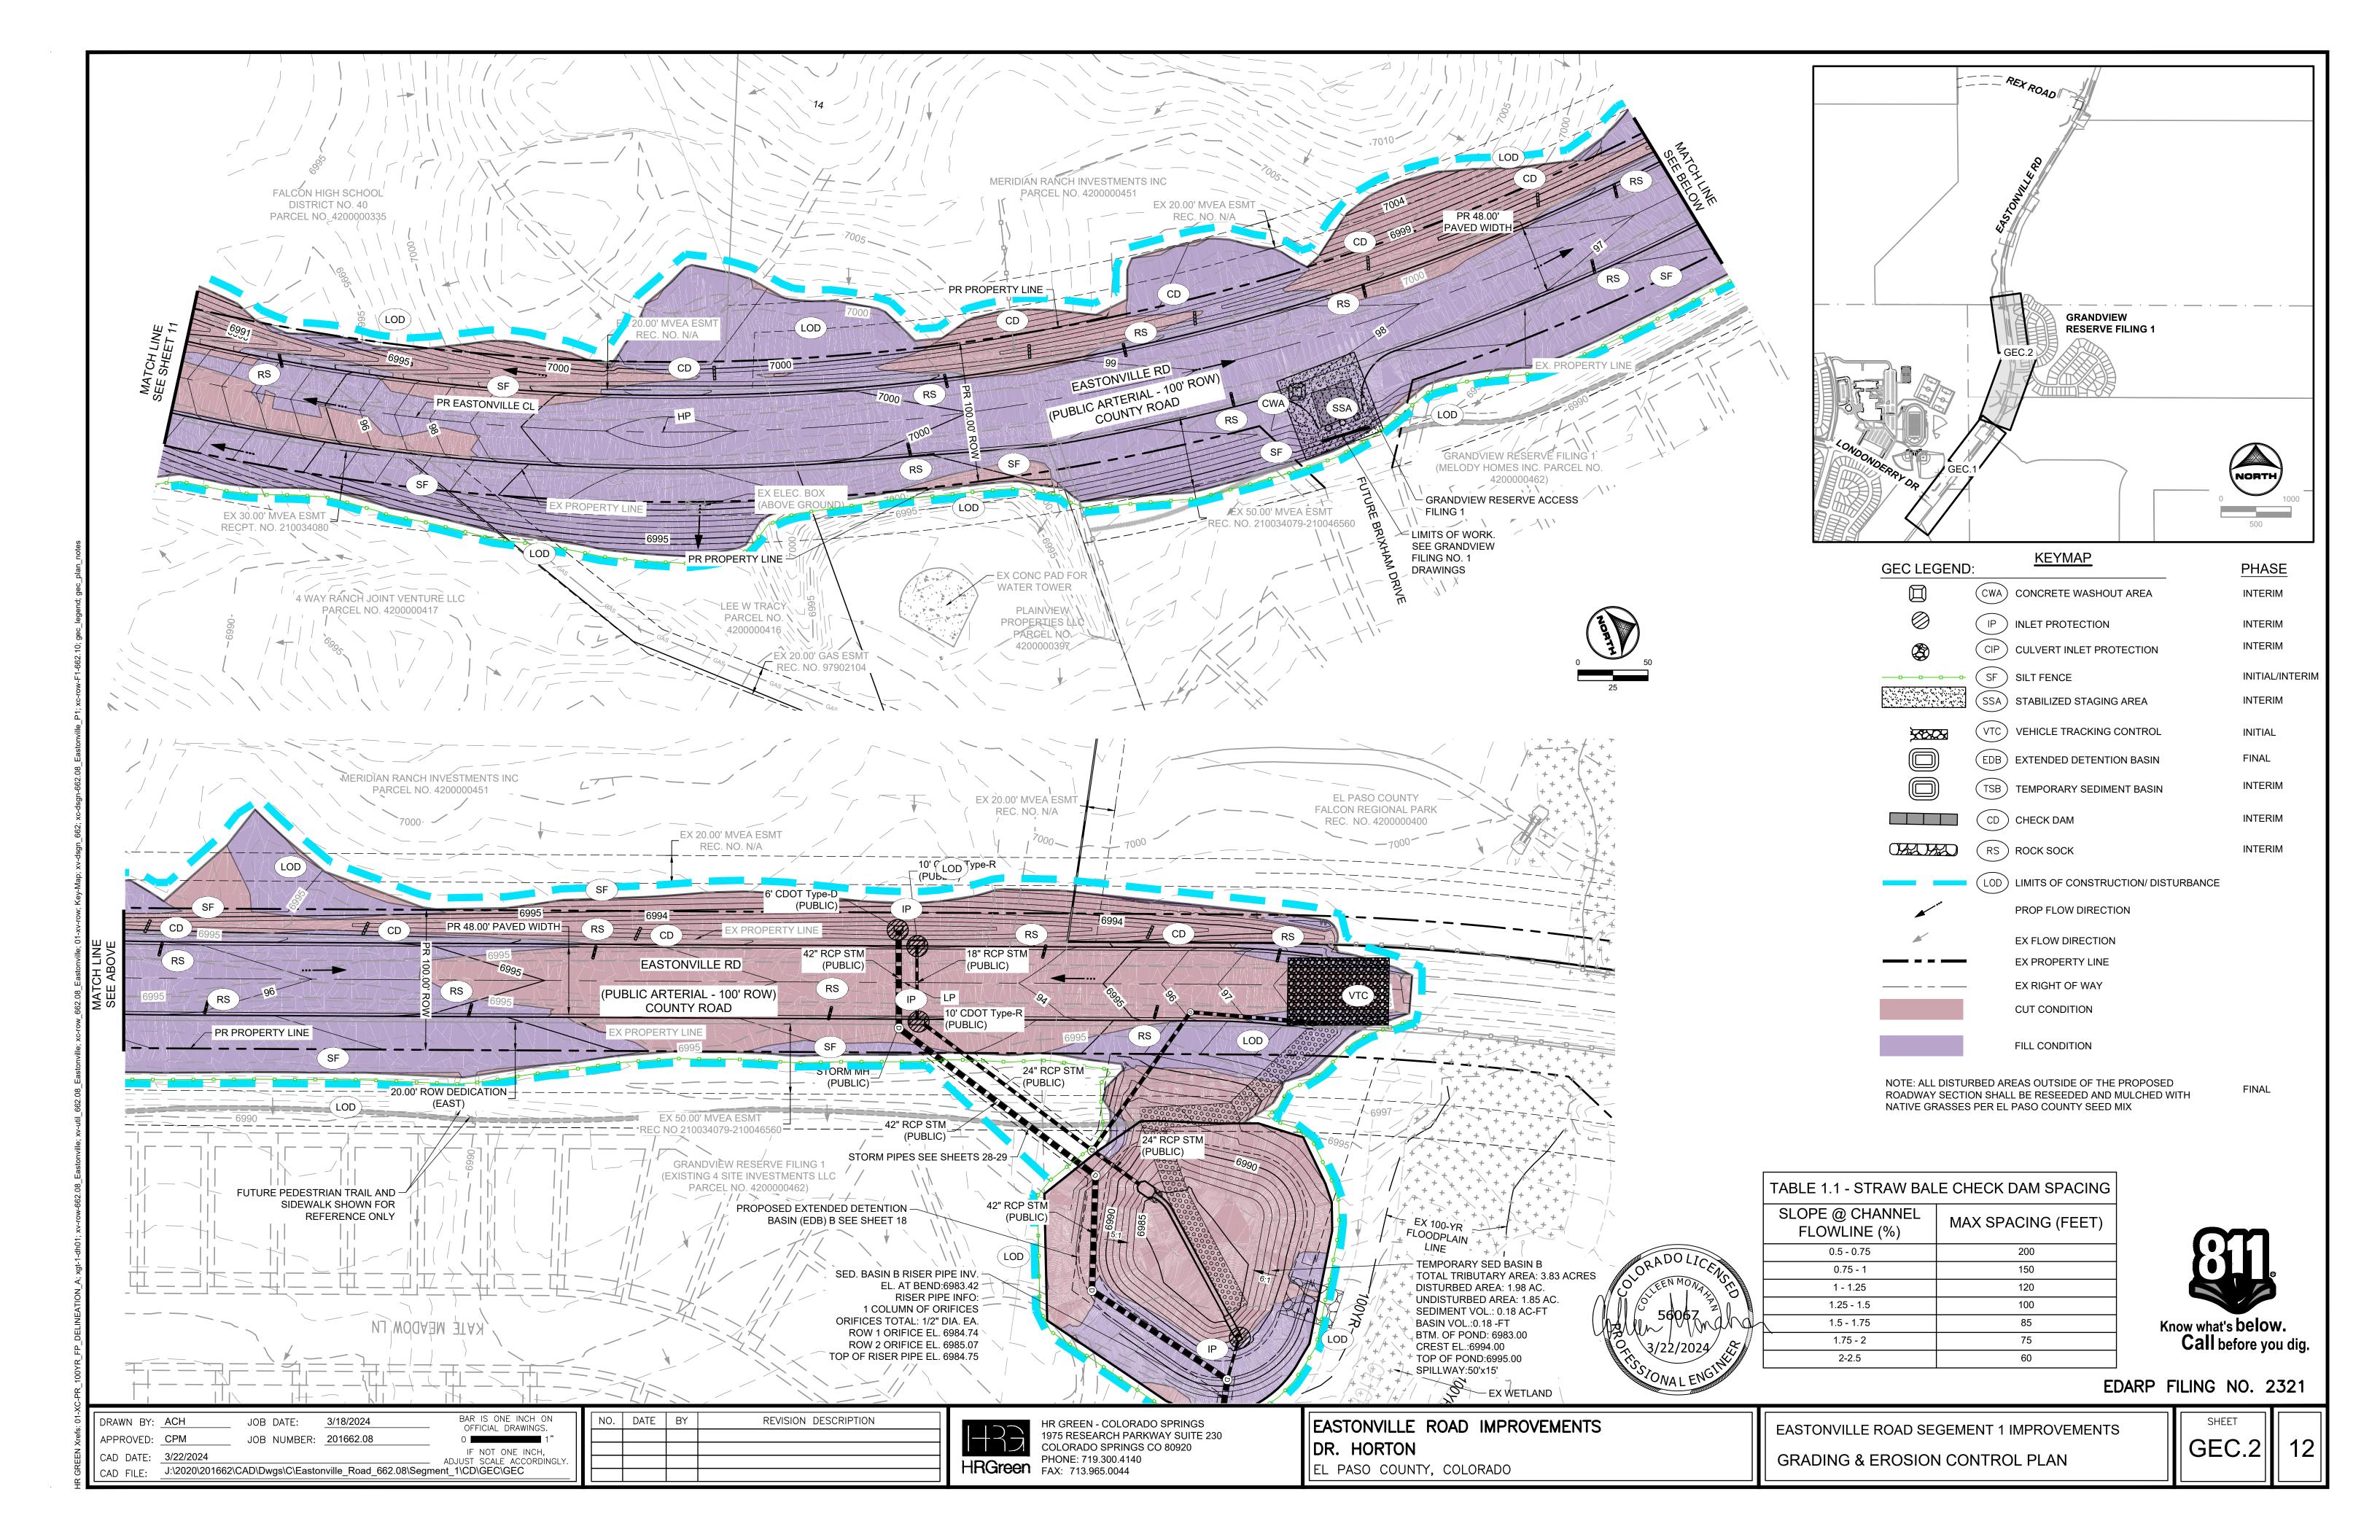

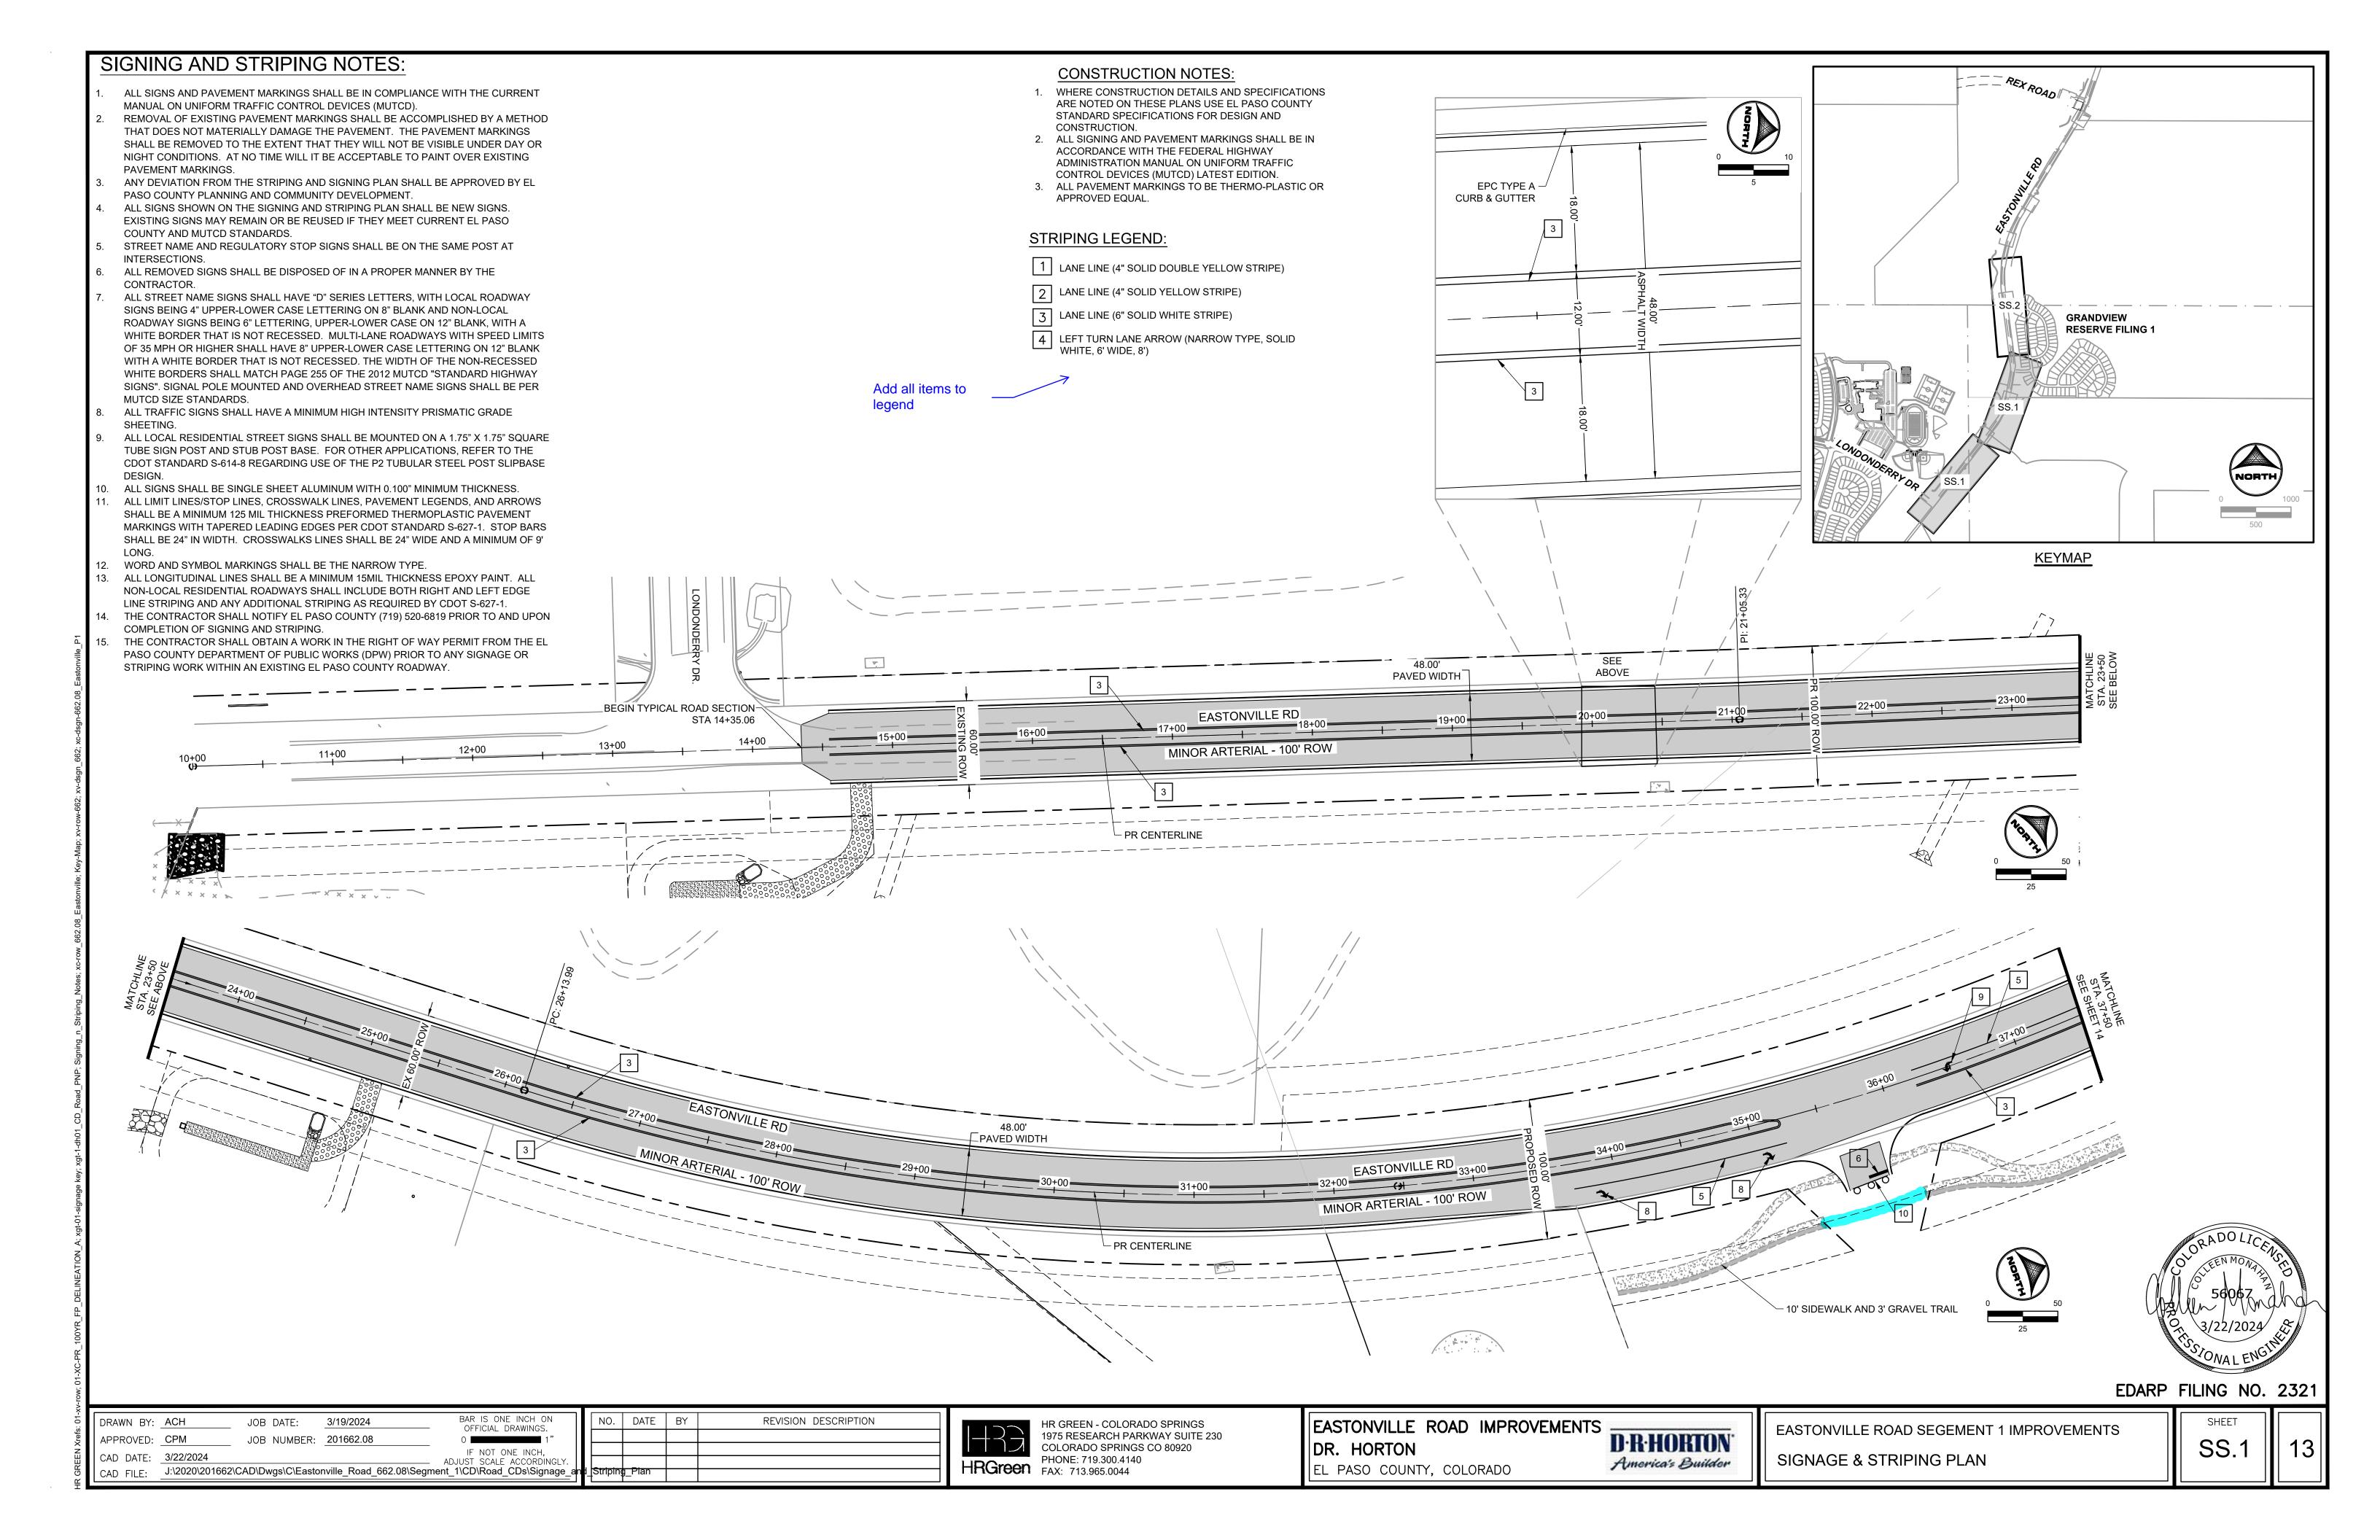


CONSTRUCTION NOTES:

- WHERE CONSTRUCTION DETAILS AND SPECIFICATIONS ARE NOTED ON THESE PLANS USE EL PASO COUNTY STANDARD SPECIFICATIONS FOR DESIGN AND CONSTRUCTION.
- 2. ALL SIGNING AND PAVEMENT MARKINGS SHALL BE IN ACCORDANCE WITH THE FEDERAL HIGHWAY ADMINISTRATION MANUAL ON UNIFORM TRAFFIC CONTROL DEVICES (MUTCD) LATEST EDITION.
- 3. ALL PAVEMENT MARKINGS TO BE THERMO-PLASTIC OR APPROVED EQUAL.

STRIPING LEGEND:

- 1 LANE LINE (4" SOLID DOUBLE YELLOW STRIPE)
- 2 LANE LINE (4" SOLID YELLOW STRIPE)
- 3 LANE LINE (6" SOLID WHITE STRIPE)
- LEFT TURN LANE ARROW (NARROW TYPE, SOLID WHITE, 6' WIDE, 8')



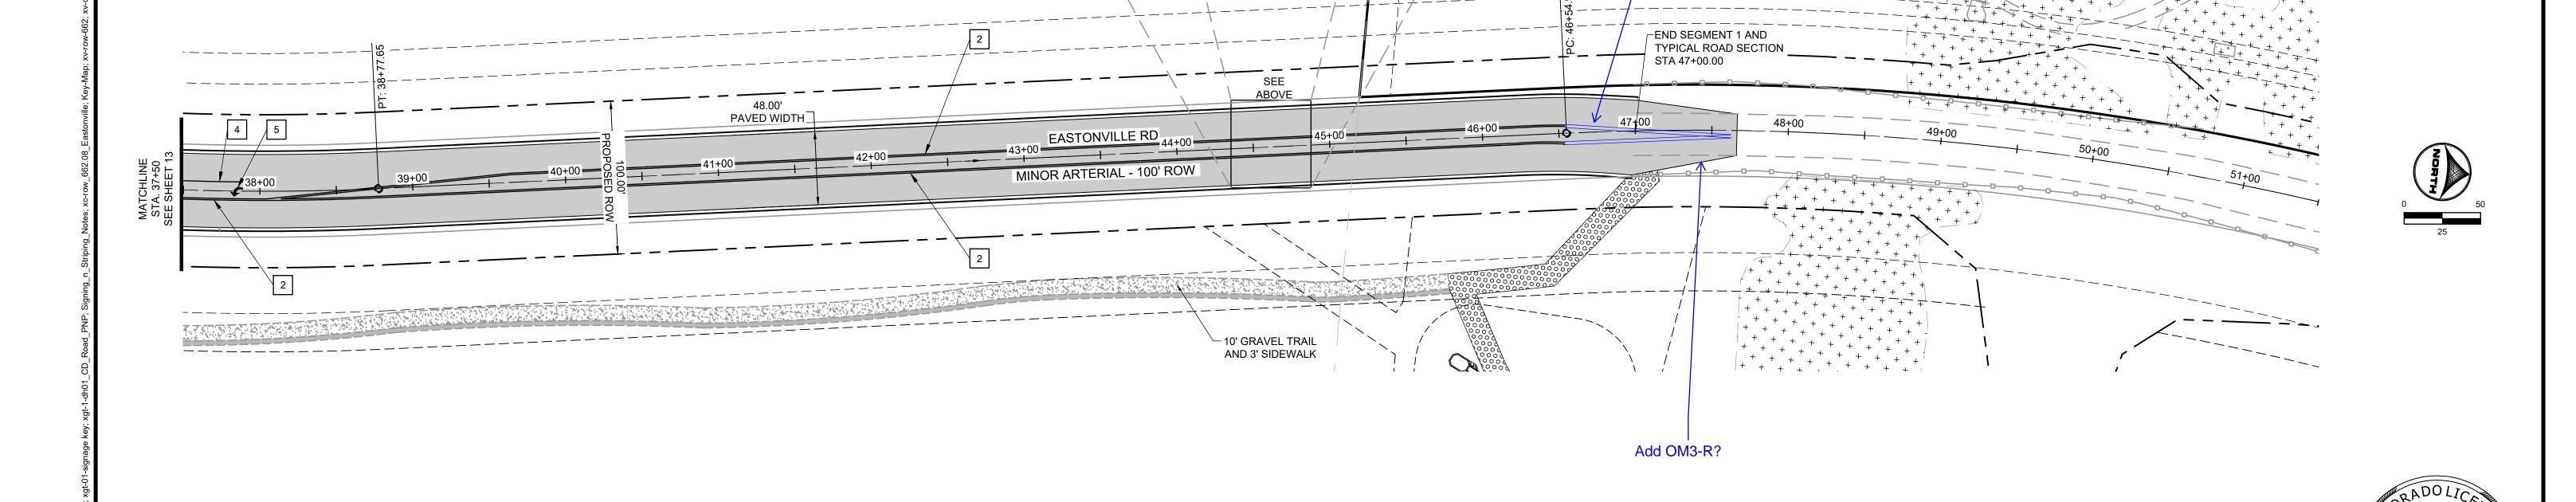

EDARP FILING NO. 2321

BAR IS ONE INCH ON OFFICIAL DRAWINGS. NO. DATE BY REVISION DESCRIPTION DRAWN BY: ACH JOB DATE: 3/19/2024 APPROVED: CPM JOB NUMBER: <u>201662.08</u> IF NOT ONE INCH, CAD DATE: 3/22/2024 ADJUST SCALE ACCORDINGLY. CAD FILE: J:\2020\201662\CAD\Dwgs\C\Eastonville_Road_662.08\Segment_1\CD\Road_CDs\Signage_and_Striping_Plan



HR GREEN - COLORADO SPRINGS
1975 RESEARCH PARKWAY SUITE 230
COLORADO SPRINGS CO 80920
PHONE: 719.300.4140
FAX: 713.965.0044


EASTONVILLE ROAD IMPROVEMENTS DR. HORTON EL PASO COUNTY, COLORADO

temporary striping

R-HORTON [®]	
merica's Builder	

EASTONVILLE ROAD SEGEMENT 1 IMPROVEMENTS SIGNAGE & STRIPING PLAN

SS.2

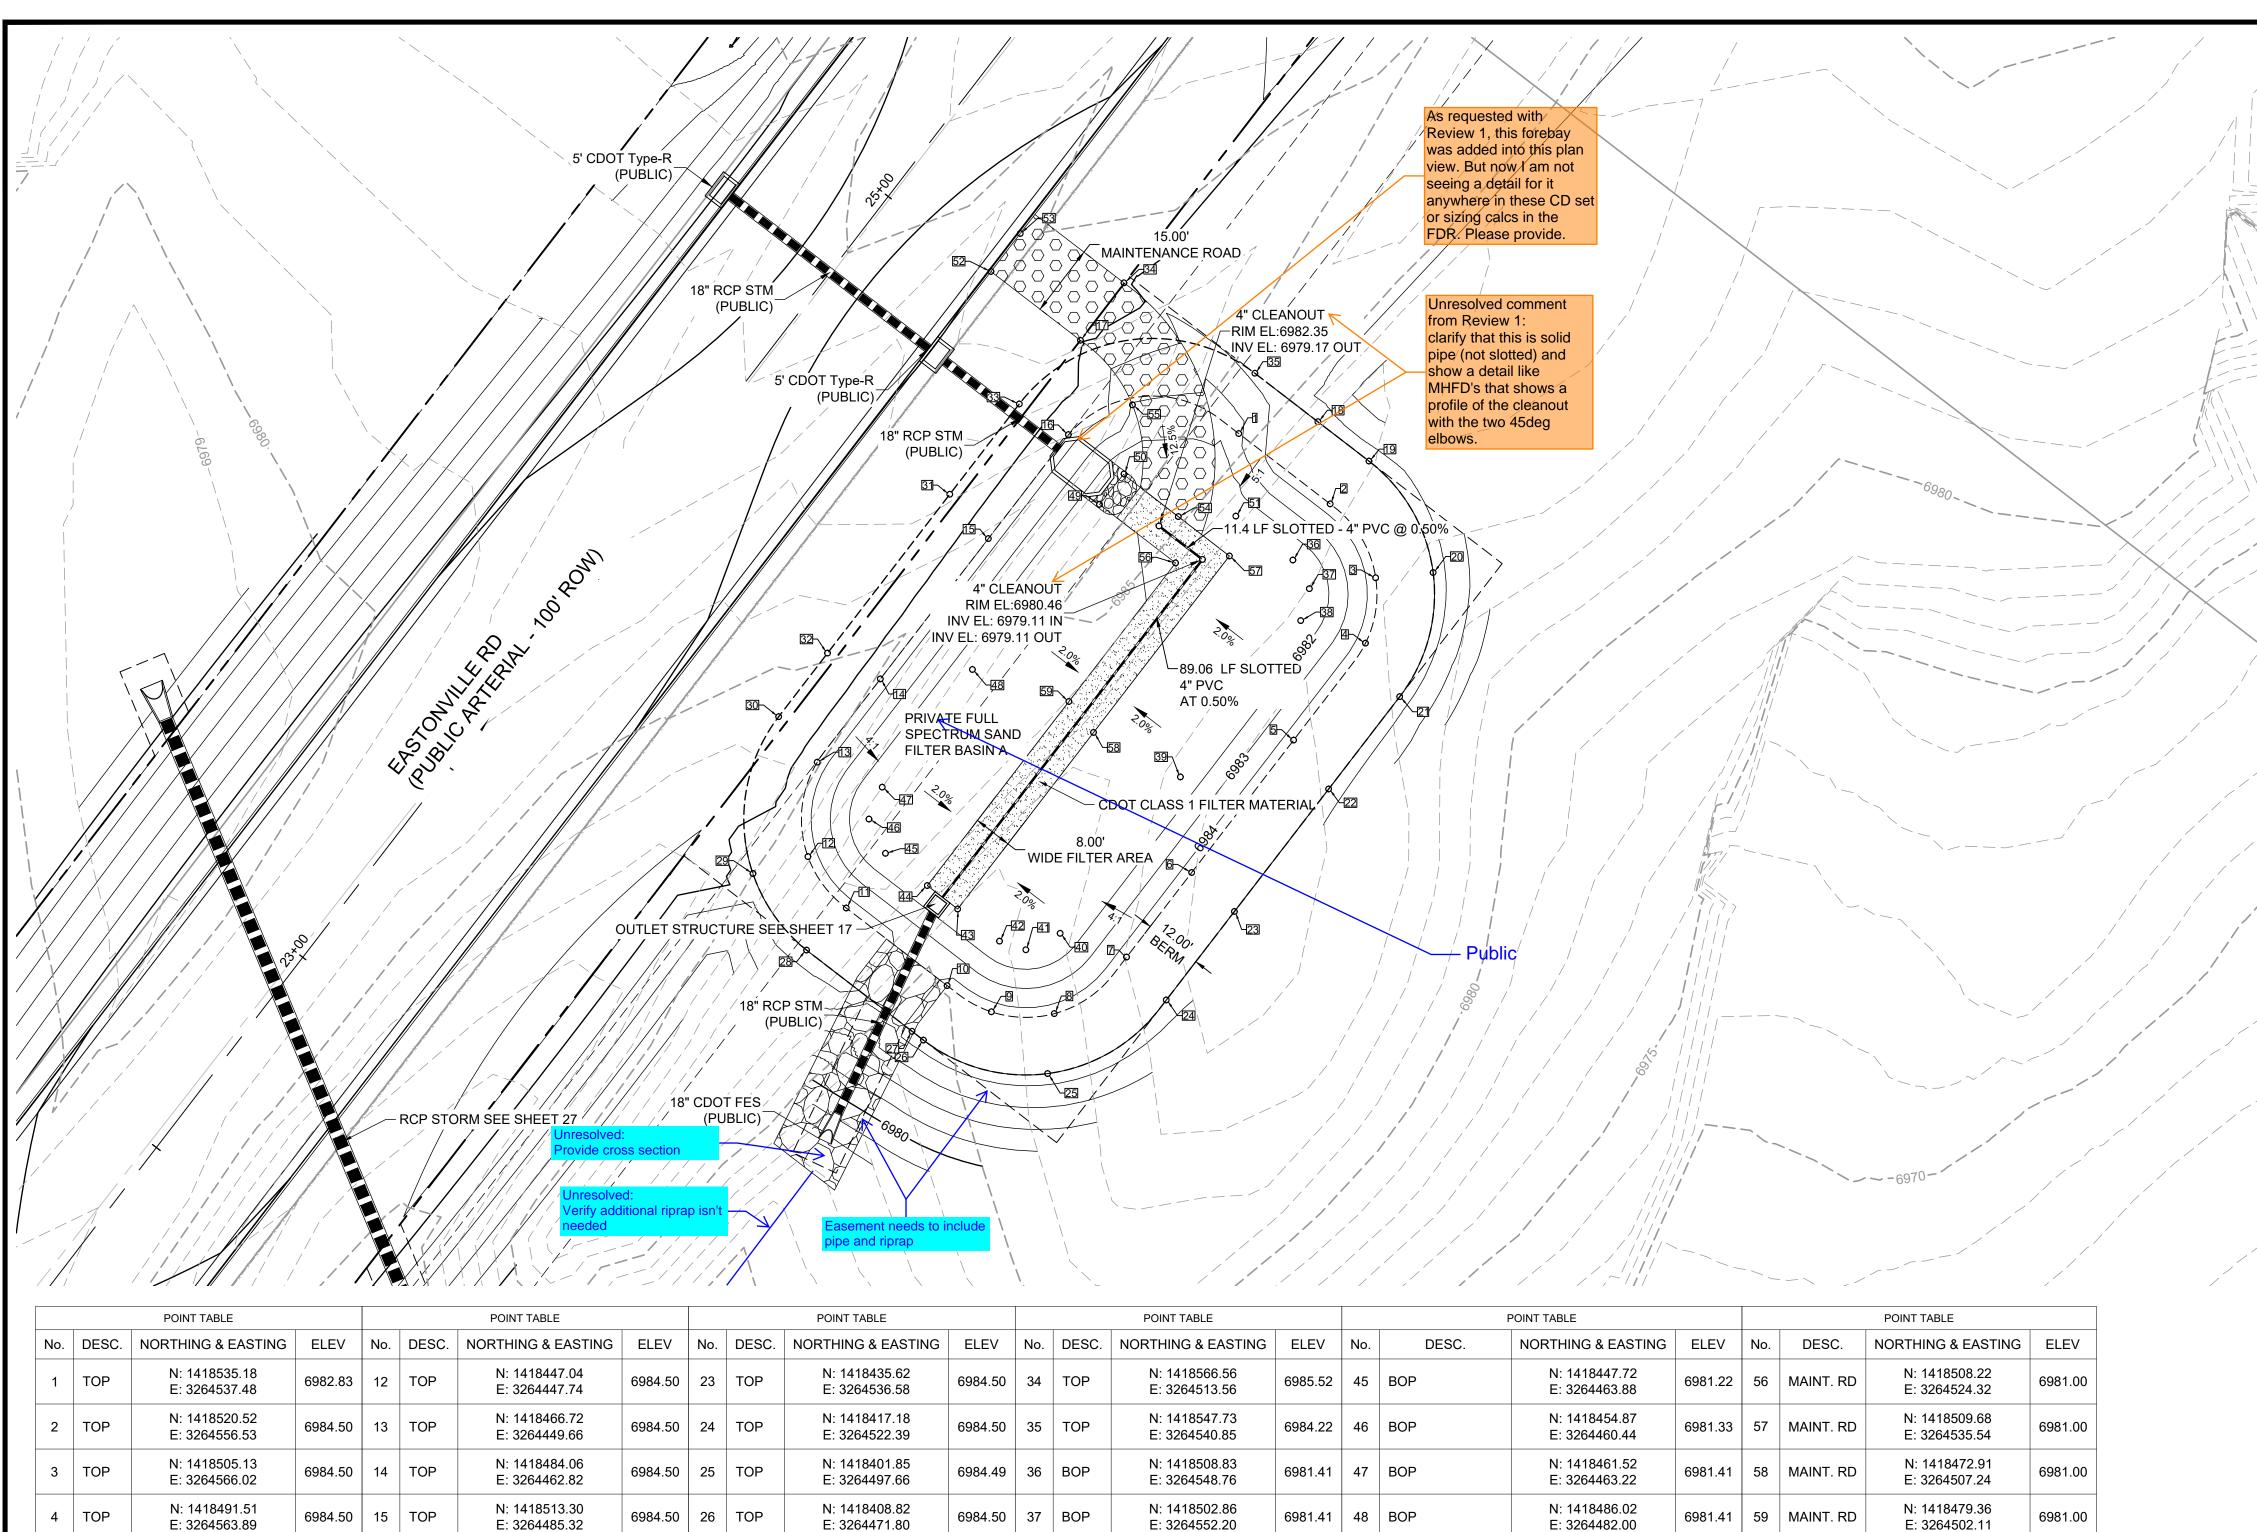



		POINT TABLE			Р	OINT TABLE														
No.	DESC.	NORTHING & EASTING	ELEV	No.	DESC.	NORTHING & EASTING	ELEV	No.	DESC.	NORTHING & EASTING	ELEV	No.	DESC.	NORTHING & EASTING	ELEV	No.	DESC.	NORTHING & EASTING	ELEV	No.
1	TOP	N: 1418535.18 E: 3264537.48	6982.83	12	ТОР	N: 1418447.04 E: 3264447.74	6984.50	23	TOP	N: 1418435.62 E: 3264536.58	6984.50	34	TOP	N: 1418566.56 E: 3264513.56	6985.52	45	ВОР	N: 1418447.72 E: 3264463.88	6981.22	56
2	TOP	N: 1418520.52 E: 3264556.53	6984.50	13	ТОР	N: 1418466.72 E: 3264449.66	6984.50	24	ТОР	N: 1418417.18 E: 3264522.39	6984.50	35	TOP	N: 1418547.73 E: 3264540.85	6984.22	46	ВОР	N: 1418454.87 E: 3264460.44	6981.33	57
3	TOP	N: 1418505.13 E: 3264566.02	6984.50	14	ТОР	N: 1418484.06 E: 3264462.82	6984.50	25	TOP	N: 1418401.85 E: 3264497.66	6984.49	36	ВОР	N: 1418508.83 E: 3264548.76	6981.41	47	ВОР	N: 1418461.52 E: 3264463.22	6981.41	58
4	ТОР	N: 1418491.51 E: 3264563.89	6984.50	15	ТОР	N: 1418513.30 E: 3264485.32	6984.50	26	TOP	N: 1418408.82 E: 3264471.80	6984.50	37	ВОР	N: 1418502.86 E: 3264552.20	6981.41	48	ВОР	N: 1418486.02 E: 3264482.00	6981.41	59
5	ТОР	N: 1418471.31 E: 3264548.91	6984.50	16	ТОР	N: 1418534.96 E: 3264501.99	6984.51	27	TOP	N: 1418410.65 E: 3264469.42	6984.50	38	ВОР	N: 1418496.21 E: 3264550.41	6981.41	49	ВОР	N: 1418520.42 E: 3264508.47	6981.00	
6	ТОР	N: 1418443.72 E: 3264527.68	6984.50	17	ТОР	N: 1418554.61 E: 3264504.50	6985.06	28	TOP	N: 1418427.56 E: 3264447.44	6984.49	39	ВОР	N: 1418463.64 E: 3264525.34	6981.41	50	ВОР	N: 1418526.76 E: 3264513.59	6981.01	1
7	ТОР	N: 1418426.11 E: 3264514.12	6984.50	18	ТОР	N: 1418537.63 E: 3264553.97	6984.50	29	TOP	N: 1418443.52 E: 3264436.28	6984.50	40	ВОР	N: 1418431.07 E: 3264500.27	6981.41	51	ВОР	N: 1418517.98 E: 3264536.88	6981.37	
8	ТОР	N: 1418414.33 E: 3264499.06	6984.50	19	ТОР	N: 1418529.44 E: 3264564.62	6984.50	30	TOP	N: 1418476.20 E: 3264441.63	6985.79	41	ВОР	N: 1418427.64 E: 3264493.13	6981.30	52	BEGIN MAINT. RD	N: 1418568.94 E: 3264485.87	6985.03	
9	ТОР	N: 1418414.71 E: 3264485.96	6984.50	20	ТОР	N: 1418506.22 E: 3264577.98	6984.49	31	TOP	N: 1418522.52 E: 3264477.27	6985.46	42	ВОР	N: 1418429.43 E: 3264487.65	6981.22	53	BEGIN MAINT. RD	N: 1418576.86 E: 3264491.97	6985.07	
10	TOP	N: 1418420.16 E: 3264476.74	6984.50	21	ТОР	N: 1418480.35 E: 3264571.01	6984.50	32	TOP	N: 1418489.44 E: 3264451.82	6985.69	43	ВОР	N: 1418436.14 E: 3264478.93	6981.00	54	MAINT. RD/BP	N: 1418517.87 E: 3264524.89	6981.00	
11	ТОР	N: 1418436.33 E: 3264455.72	6984.50	22	ТОР	N: 1418461.13 E: 3264556.21	6984.50	33	ТОР	N: 1418541.34 E: 3264491.76	6985.43	44	ВОР	N: 1418441.01 E: 3264472.59	6981.00	55	MAINT. RD/BP	N: 1418541.16 E: 3264515.33	6982.94	

- REX ROAD **GRANDVIEW RESERVE FILING 1 KEYMAP**

GRADING NOTES:

- ALL PROPOSED CONTOURS ARE TO FINISHED GRADE.
- EARTHEN CUT AND FILL SLOPES SHALL BE 3:1 MAXIMUM. SLOPES IN EXCESS OF 4:1 AND AREAS OTHERWISE INDICATED BY WITHIN THESE PLANS. SHALL BE COVERED WITH SOIL RETENTION BLANKET OVER 4" MIN. THICKNESS OF TOPSOIL AND SEEDED.
- IF THE PROJECT IS CONSTRUCTED DURING THE SUMMER WHEN SEEDING IS NOT ALLOWED, APPLY 1-1/2 TONS OF CERTIFIED WEED FREE MULCH PER ACRE MECHANICALLY CRIMPED INTO THE SOIL IN COMBINATION WITH AN ORGANIC MULCH TACKIFIER.
- PRIOR TO ANY CONSTRUCTION ACTIVITIES THE PROPOSED SILT FENCE SHOWN ON THE EROSION CONTROL SHEET SHALL BE CONSTRUCTED. THE FENCE SHALL BE REMOVED UPON THE LATER OF STABILIZATION OF THE SITE OR COMPLETION OF CONSTRUCTION.
- TO REDUCE THE POTENTIAL FOR CLOGGING OF DEBRIS GRATES, NO STRAW MULCH SHALL BE USED WITHIN THE EURV OR WQCV OF A DETENTION BASIN. INSTEAD, EROSION CONTROL BLANKETS SHALL BE INSTALLED FOR A WIDTH OF AT LEAST 6 FEET ON EITHER SIDE OF CONCRETE LOW-FLOW CHANNELS. THE BLANKETS SHALL COMPLY WITH THE MATERIALS AND INSTALLATION REQUIREMENTS FOR EROSION CONTROL BLANKETS (STRAW COCONUT OR 100 PERCENT COCONUT.) SITE-SPECIFIC CONDITIONS MAY REQUIRE ADDITIONAL BLANKET OR OTHER EROSION CONTROL MEASURES.

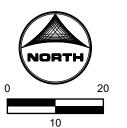

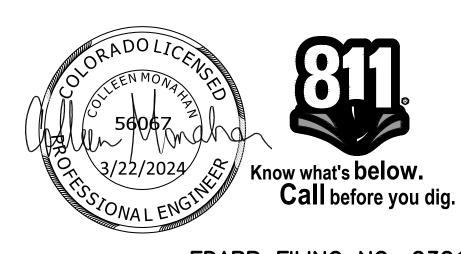

EDARP FILING NO. 2321

BAR IS ONE INCH ON OFFICIAL DRAWINGS. REVISION DESCRIPTION NO. DATE BY JOB DATE: 3/6/2024 DRAWN BY: ACH APPROVED: CPM JOB NUMBER: 201662.08 CAD DATE: 3/22/2024 ADJUST SCALE ACCORDINGLY CAD FILE: J:\2020\201662\CAD\Dwgs\C\Eastonville_Road_662.08\Segment_1\CD\Road_CDs\Sand_Filter_Plans

HR GREEN - COLORADO SPRINGS 1975 RESEARCH PARKWAY SUITE 230 COLORADO SPRINGS CO 80920 HRGreen PHONE: 719.300.4140 FAX: 713.965.0044

EASTONVILLE ROAD IMPROVEMENTS DR. HORTON EL PASO COUNTY, COLORADO


ABBREVIATIONS
TC = TRICKLE CHANNEL

TOP = TOP OF POND SW = SPILLWAY

BP/BOP = BOTTOM OF POND


D·R·HORTON America's Builder


EASTONVILLE ROAD SEGEMENT 1 IMPROVEMENTS SFB A (PUBLIC) GRADING PLAN

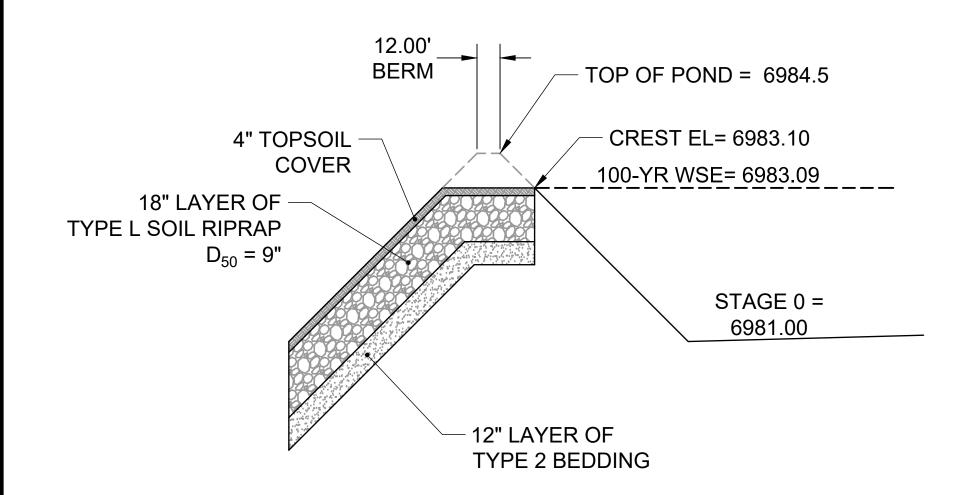

PROFILE VIEW -EMERGENCY OVERFLOW SPILLWAY

SCALE: NTS

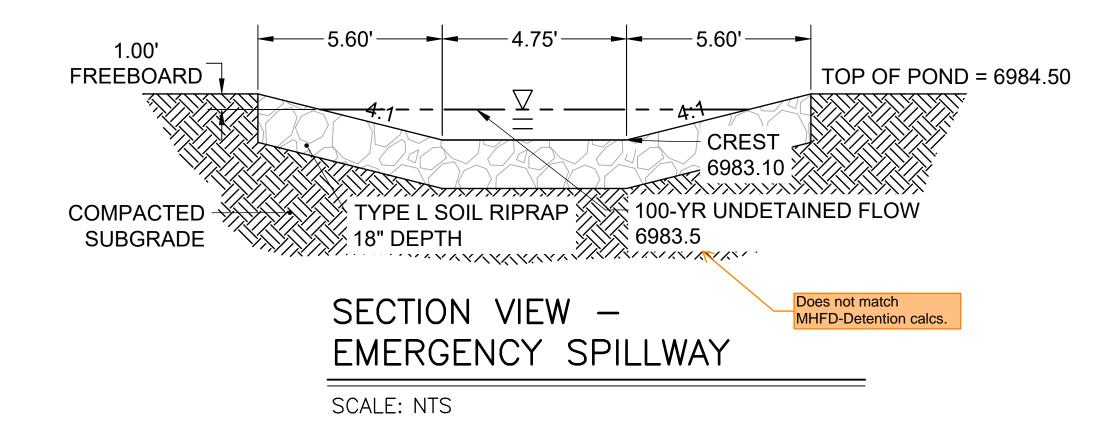

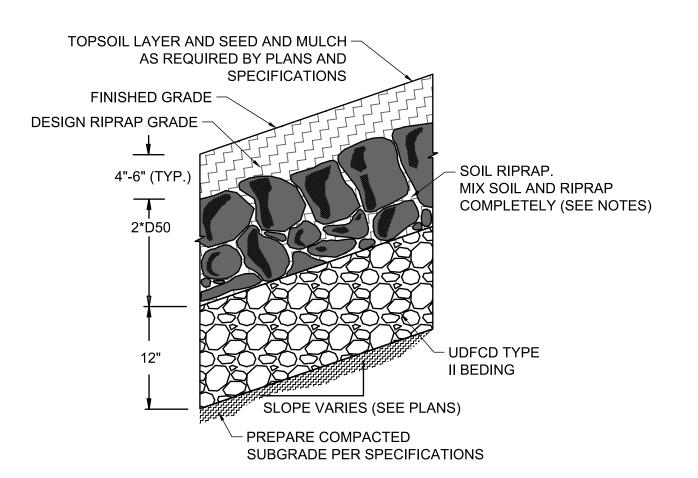


SOIL RIPRAP EMBANKMENT PROTECTION WITH BEDDING TYP. SECTION

N.T.S

TVDE		\Box	PR	Λ
	L	$rac{1}{2}$	ᇊ	Н

INTERMEDIATE	PERCENT		
ROCK DIMENSION	PASSING		
(IN .)	(%)		
15	70-100		
12	50-70		
9	35-50		
3	2-10		


*TYPE L RIPRAP D50=9". D50=MEAN PARTICLE SIZE (INTERMEDIATE DIMENSION) BY WEIGHT

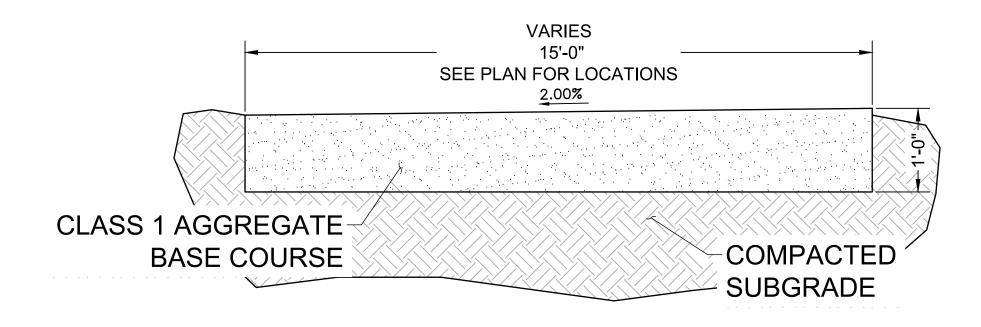

MAINTENANCE ROAD TYPICAL **SECTION SCALE: NTS**



- SOIL RIPRAP DETAILS ARE APPLICABLE TO SLOPED AREAS REFER TO THE SITE PLAN ACTUAL LOCATION AND LIMITS.
- 2. MIX UNIFORMLY 65% RIPRAP BY VOLUME WITH 35% OF APPROVED SOIL BY VOLUME PRIOR TO PLACEMENT.
- 3. PLACE STONE-SOIL MIX TO RESULT IN SECURELY INTERLOCKED ROCK AT THE DESIGN THICKNESS AND GRADE. COMPACT AND LEVEL TO ELIMINATE ALL VOIDS AND ROCKS PROJECTING ABOVE DESIGN RIPRAP TOP GRADE.
- 4. CRIMP OR TACKIFY MULCH OR USE APPROVED HYDROMULCH AS CALLED FOR IN THE PLANS AND SPECIFICATIONS.
- 5. ROCK SHALL BE HARD, DURABLE, ANGULAR IN SHAPE, AND FREE FROM CRACKS, OVERBURDEN, SHALE, AND ORGANIC MATTER.
- 6. NEITHER BREADTH NOR THICKNESS OF A SINGLE STONE SHOULD BE LESS THAN ONE-THIRD ITS LENGTH, AND ROUNDED STONE SHOULD BE AVOIDED.
- 7. THE ROCK SHOULD SUSTAIN A LOSS OF NOT MORE THAN 40% AFTER 500 REVOLUTIONS IN AN ABRASION TEST (LOS ANGELES MACHINEASTM C-535-69) AND SHOULD SUSTAIN A LOSS OF NOT MORE THAN 10% AFTER 12 CYCLES OF FREEZING AND THAWING (AASHTO TEST 103 FOR LEDGE ROCK PROCEDURE A).
- 8. ROCK HAVING A MINIMUM SPECIFIC GRAVITY OF 2.65 IS PREFERRED; HOWEVER, IN NO CASE SHOULD ROCK HAVE A SPECIFIC GRAVITY LESS THAN 2.50.

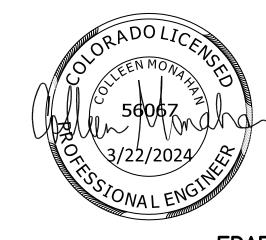



EDARP FILING NO. 2321

BAR IS ONE INCH ON OFFICIAL DRAWINGS. NO. DATE BY REVISION DESCRIPTION DRAWN BY: ACH JOB DATE: 3/6/2024 APPROVED: CPM JOB NUMBER: 201662.08 CAD DATE: 3/22/2024 CAD FILE: J:\2020\201662\CAD\Dwgs\C\Eastonville_Road_662.08\Segment_1\CD\Road_CDs\Sand_Filter_Plans




HR GREEN - COLORADO SPRINGS 1975 RESEARCH PARKWAY SUITE 230 COLORADO SPRINGS CO 80920 HRGreen PHONE: 719.300.4140 FAX: 713.965.0044

EASTONVILLE ROAD IMPROVEMENTS DR. HORTON EL PASO COUNTY, COLORADO

D·R·HORTON' America's Builder

EASTONVILLE ROAD SEGEMENT 1 IMPROVEMENTS SFB A (PUBLIC) DETAILS

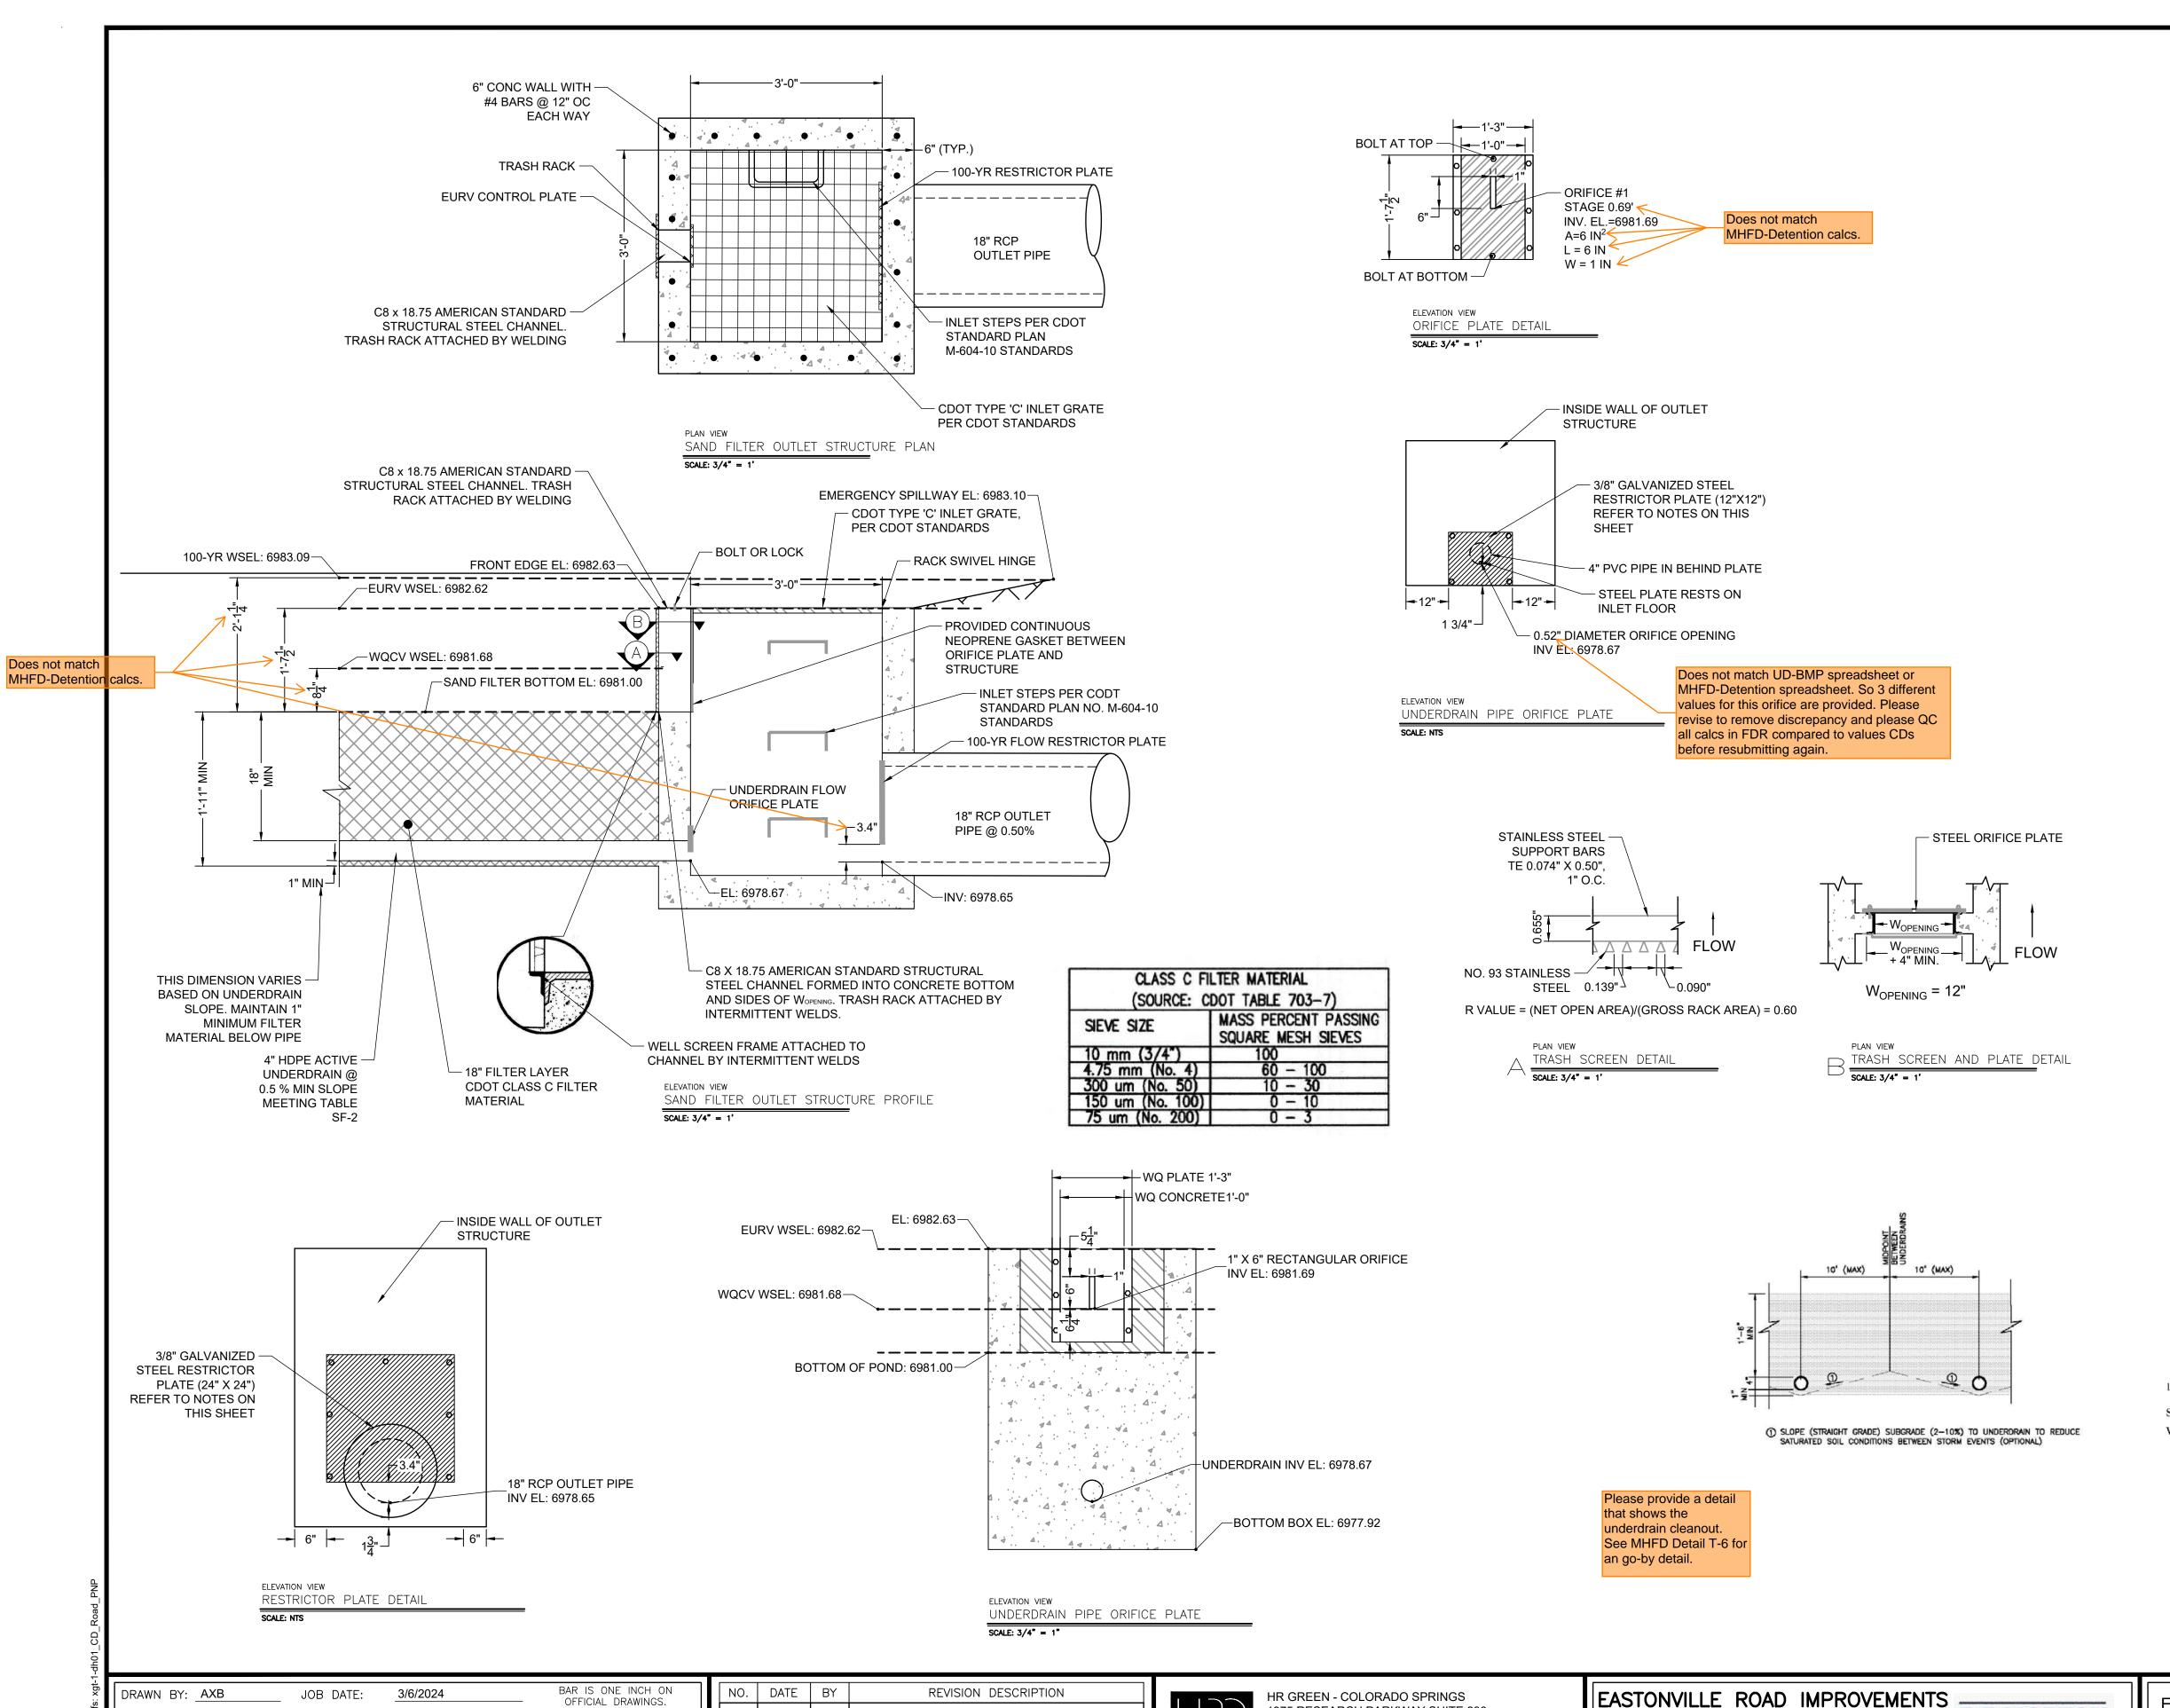

NO. DATE

IF NOT ONE INCH,

DRAWN BY: AXB

APPROVED: CPM

CAD DATE: 3/22/2024

JOB DATE:

3/6/2024

J:\2020\201662\CAD\Dwgs\C\Eastonville_Road_662.08\Segment_1\CD\Road_CDs\Sand_Outle__structure_Details

JOB NUMBER: 201662.08

REVISION DESCRIPTION

HR GREEN - COLORADO SPRINGS

COLORADO SPRINGS CO 80920

PHONE: 719.300.4140

HRGreen FAX: 713.965.0044

1975 RESEARCH PARKWAY SUITE 230

ORIFICE PLATE NOTES:

- 1. PLATE TO BE $\frac{3}{8}$ " THICK GALVANIZED STEEL.
- 2. BOLT PLATE TO CONCRETE 16" O.C. MAX.
- 3. PROVIDE CONTINUOUS NEOPRENE GASKET MATERIAL BETWEEN THE ORIFICE PLATE AND CONCRETE

TRASH SCREEN NOTES:

- 1. WELL-SCREEN TRASH RACKS SHALL BE STAINLESS STEEL AND SHALL BE ATTACHED BY INTERMITTENT WELDS ALONG THE EDGE OF THE MOUNTING FRAME.
- 2. BAR GATE TRASH RACKS SHALL BE ALUMINUM AND SHALL BE BOLTED USING STAINLESS STEEL HARDWARE.
- 3. TRASH RACK OPEN AREAS ARE FOR SPECIFIED TRASH RACK MATERIALS. TOTAL TRASH RACK SIZE MAY NEED TO BE ADJUSTED FOR MATERIALS HAVING DIFFERENT OPEN AREA/GROSS AREA RATIO (R VALUE).
- 4. STRUCTURAL DESIGN OF TRASH RACKS SHALL BE BASED ON FULL HYDROSTATIC HEAD WITH ZERO HEAD DOWNSTREAM OF THE RACK..

RESTRICTOR PLATE NOTES:

- 3" THICK RESTRICTOR PLATE, GALVANIZED STEEL.
- BOLT PLATE TO CONCRETE @ 12" O.C. MAX
- 3. PROVIDE CONTINUOUS NEOPRENE GASKET MATERIAL BETWEEN PLATE AND CONCRETE
- 4. CONTRACTOR SHALL SUBMIT SHOP DRAWINGS FOR ALL PLATES AND GRATING FOR ENGINEER'S APPROVAL PRIOR TO CONSTRUCTION.

WARNING THIS AREA IS A STORMWATER FACILITY AND IS SUBJECT TO PERIODIC FLOODING

POND WARNING SIGN

SCALE: NTS

MINIMUM SIGN AREA = 3 FT^2


SIGNS SHALL BE FABRICATED OF DURABLE MATERIALS, SUCH AS METAL OR PLASTIC, USING RED LETTERING ON A WHITE BACKGROUND

TWO SIGNS, EACH WITH A MINIMUM AREA OF 3 SQUARE FEET, SHALL BE PROVIDED AROUND THE PERIMETER OF ALL DETENTION FACILITIES. THE SIGNS SHALL BE FABRICATED OF DURABLE MATERIALS, SUCH AS METAL OR PLASTIC, USING RED LETTERING ON A WHITE BACKGROUND WITH THE ABOVE MESSAGE

Table SF-2. Dimensions for Slotted Pipe¹

	Pipe Size	Slot Length	Maximum Slot Width	Slot Centers	Open Area (per foot)
	4"	1-1/16"	0.032"	0.413"	1.90 in ²
ſ	6"	1-3/8"	0.032"	0.516"	1.98 in ²


Pipe must conform to requirements of ASTM designation F949. There shall be no evidence of splitting, cracking, or breaking when the pipe is tested per ASTM test method D2412 in accordance with F949 section 7.5 and ASTM F794 section 8.5. Contech A-2000 slotted pipe (or equal).

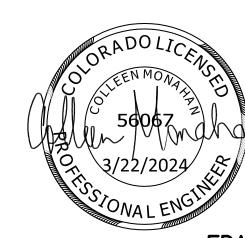





EDARP FILING NO. 2321

SHEET **EASTONVILLE ROAD SEGEMENT 1 IMPROVEMENTS**

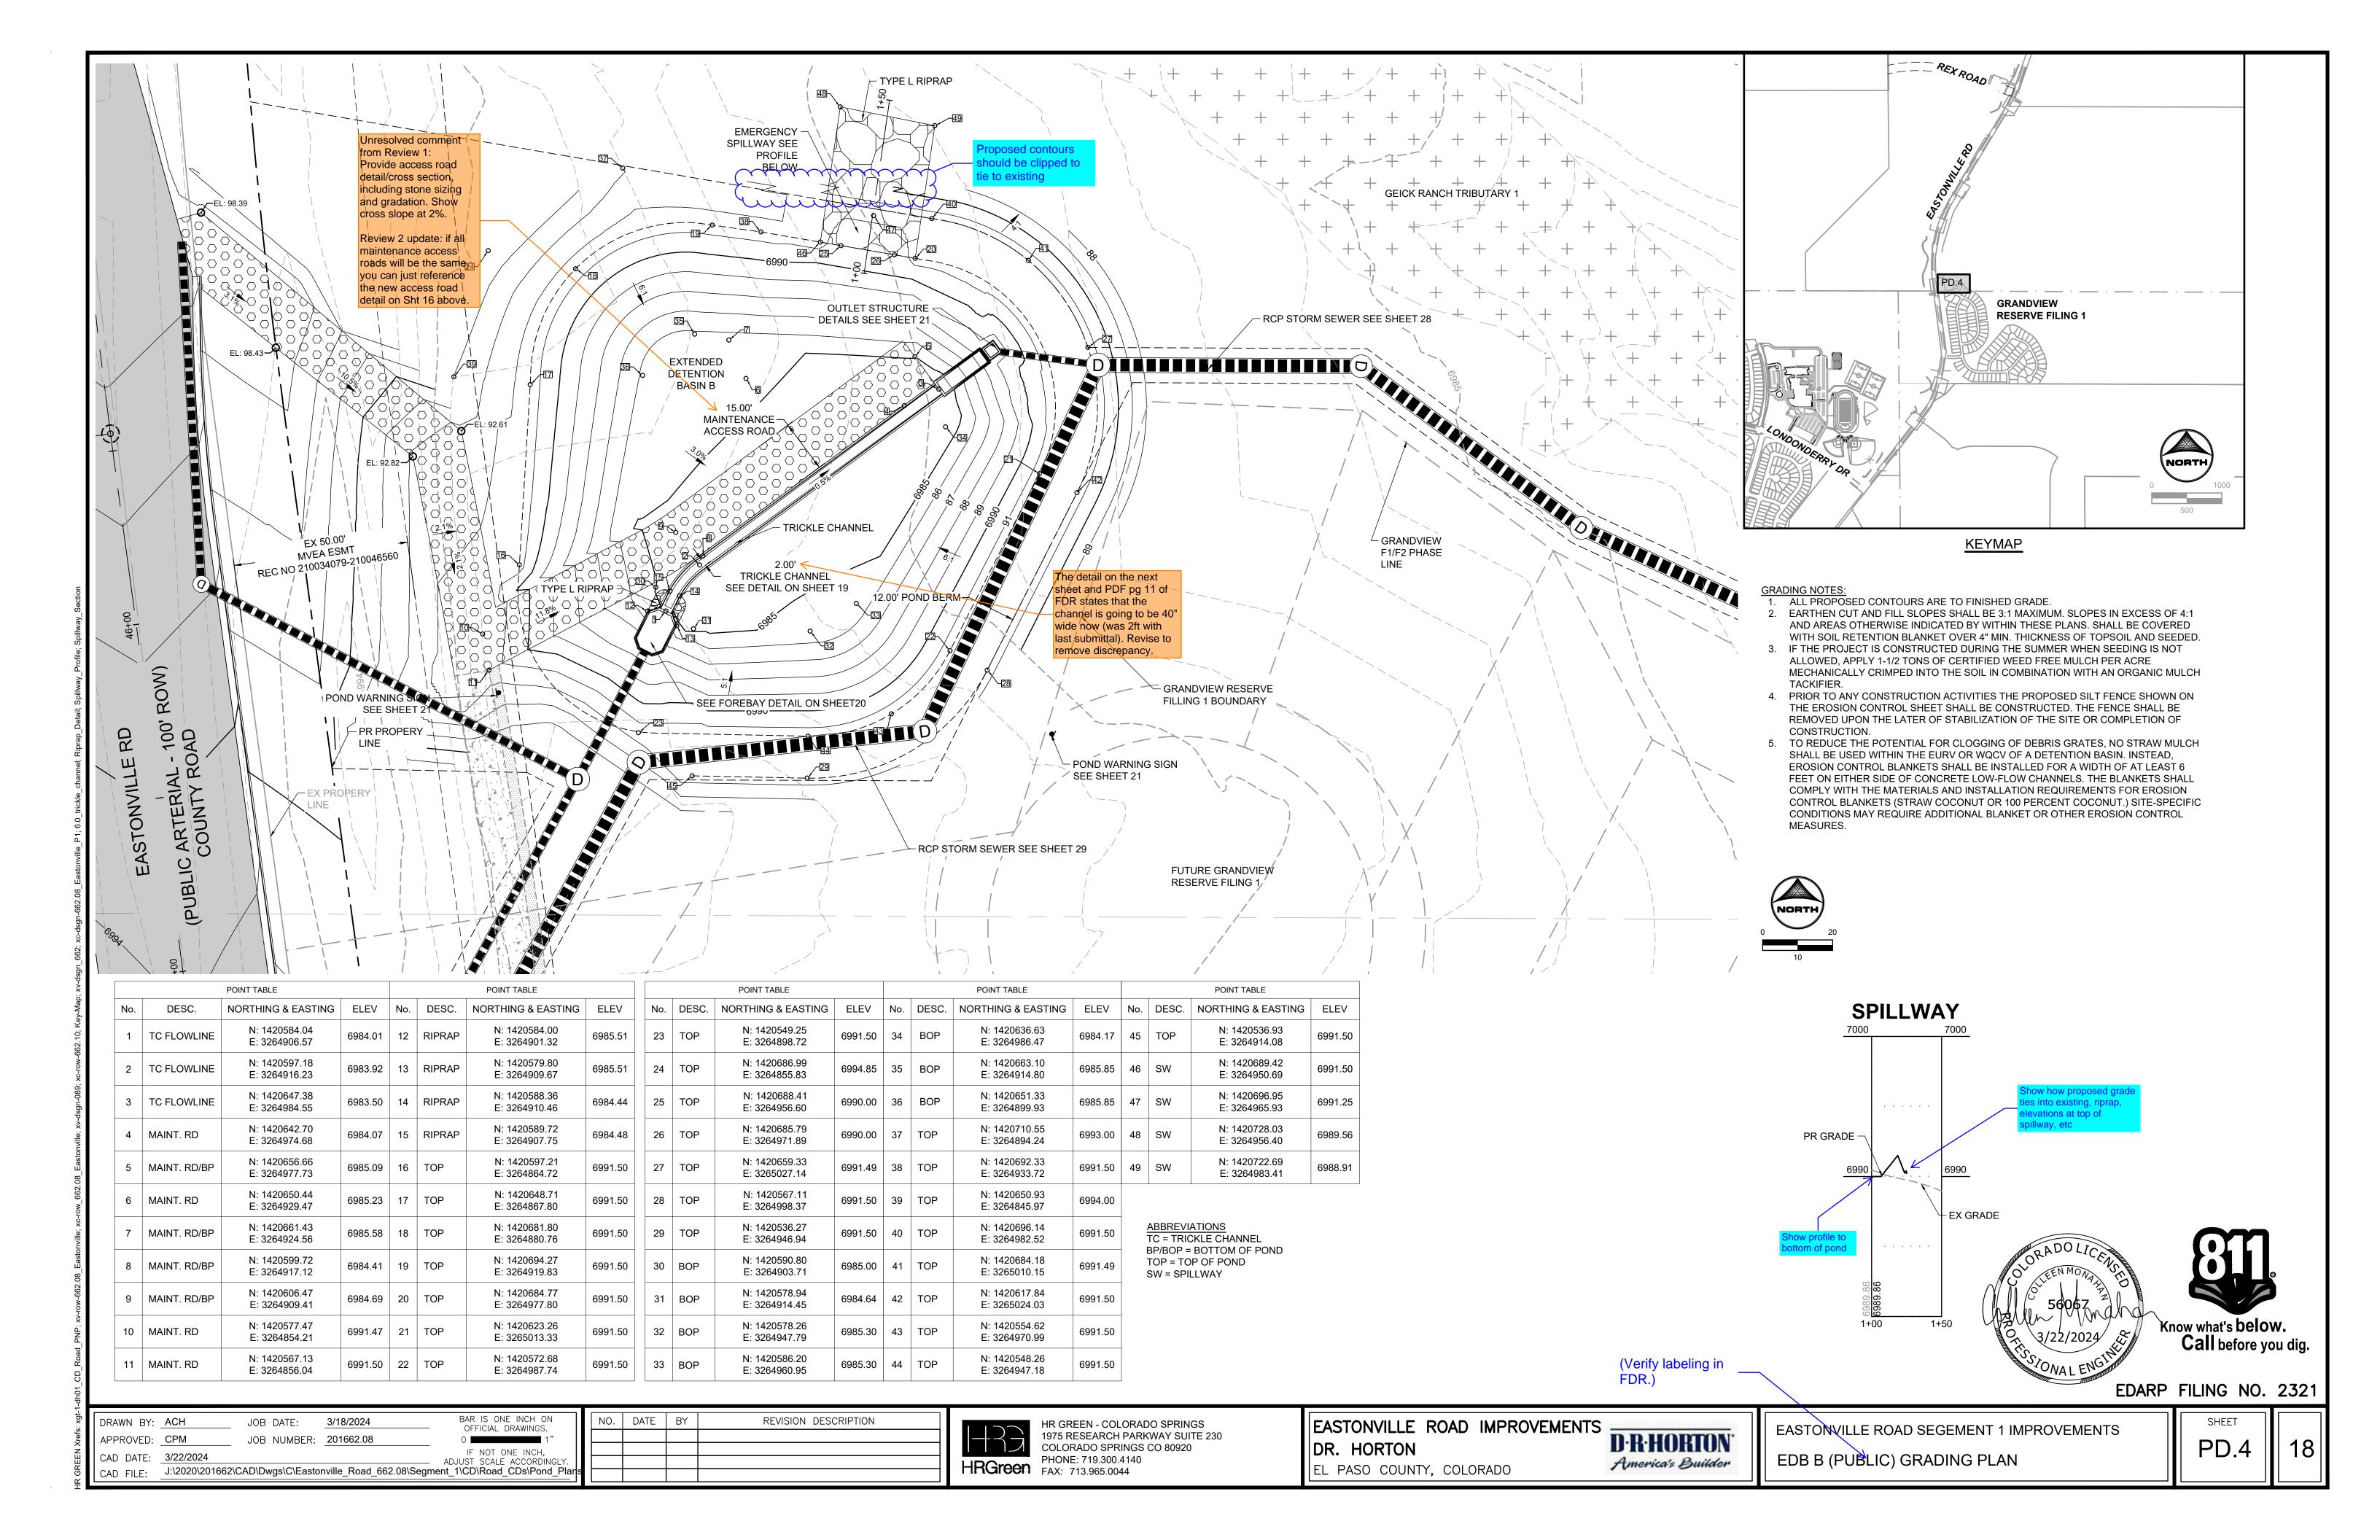

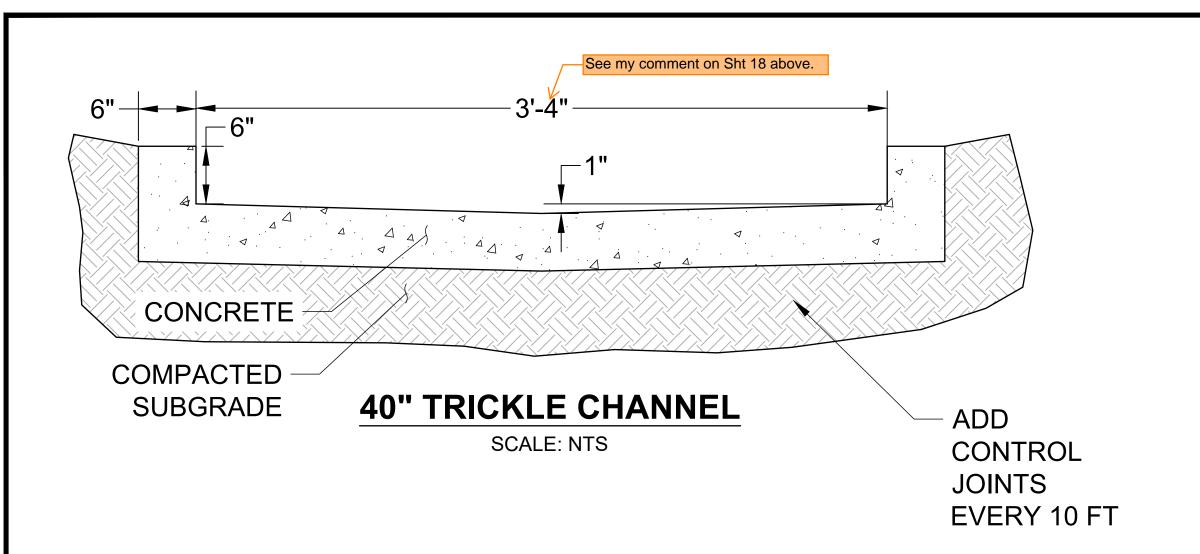

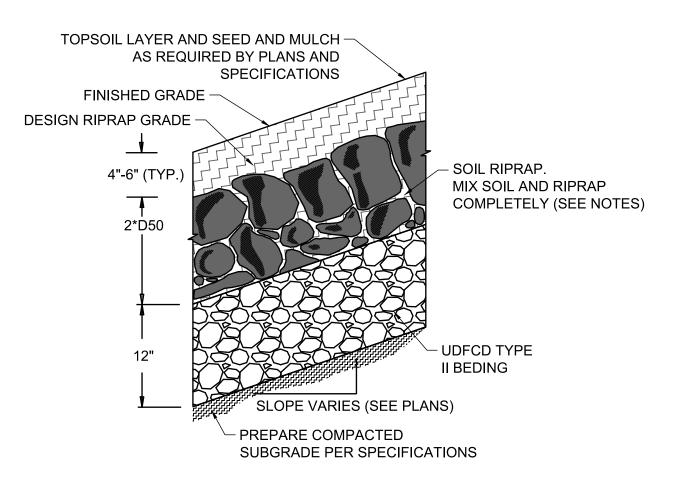

SOIL RIPRAP EMBANKMENT PROTECTION WITH BEDDING TYP. SECTION

N.T.S

TYPE L RIPRAP


INTERMEDIATE	PERCENT			
ROCK DIMENSION	PASSING			
(IN .)	(%)			
15	70-100			
12	50-70			
9	35-50			
3	2-10			

*TYPE L RIPRAP D50=9". D50=MEAN PARTICLE SIZE (INTERMEDIATE DIMENSION) BY WEIGHT

12.00' BERM TOP OF POND = 6991.50 4" TOPSOIL CREST EL= 6990.00 COVER 18" LAYER OF 100-YR WSE= 6986.88 TYPE L SOIL RIPRAP $D_{50} = 9"$ STAGE 0 = 6983.50 12" LAYER OF TYPE 2 BEDDING

PROFILE VIEW -EMERGENCY OVERFLOW SPILLWAY

SCALE: NTS

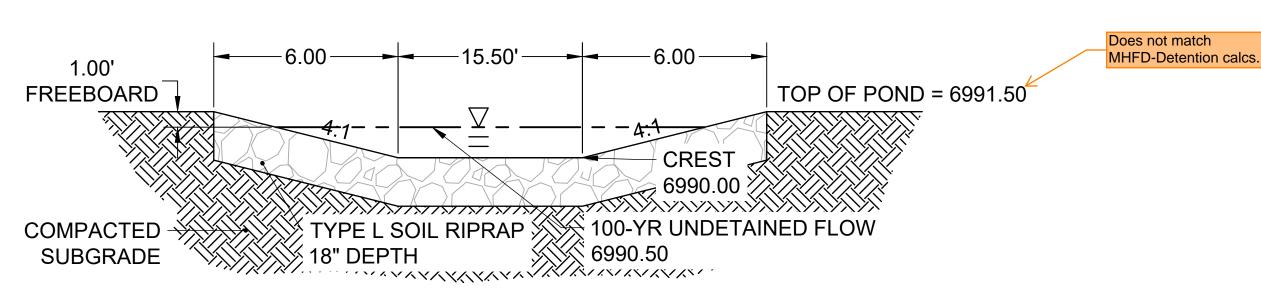

SECTION VIEW -EMERGENCY SPILLWAY

SCALE: NTS

- SOIL RIPRAP DETAILS ARE APPLICABLE TO SLOPED AREAS REFER TO THE SITE PLAN ACTUAL LOCATION AND LIMITS.
- 2. MIX UNIFORMLY 65% RIPRAP BY VOLUME WITH 35% OF APPROVED SOIL BY VOLUME PRIOR TO PLACEMENT.

RIPRAP NOTES.

- 3. PLACE STONE-SOIL MIX TO RESULT IN SECURELY INTERLOCKED ROCK AT THE DESIGN THICKNESS AND GRADE. COMPACT AND LEVEL TO ELIMINATE ALL VOIDS AND ROCKS PROJECTING ABOVE DESIGN RIPRAP TOP GRADE.
- 4. CRIMP OR TACKIFY MULCH OR USE APPROVED HYDROMULCH AS CALLED FOR IN THE PLANS AND SPECIFICATIONS.
- ROCK SHALL BE HARD, DURABLE, ANGULAR IN SHAPE, AND FREE FROM CRACKS, OVERBURDEN, SHALE, AND ORGANIC MATTER.
- 6. NEITHER BREADTH NOR THICKNESS OF A SINGLE STONE SHOULD BE LESS THAN ONE-THIRD ITS LENGTH, AND ROUNDED STONE SHOULD BE AVOIDED.
- 7. THE ROCK SHOULD SUSTAIN A LOSS OF NOT MORE THAN 40% AFTER 500 REVOLUTIONS IN AN ABRASION TEST (LOS ANGELES MACHINEASTM C-535-69) AND SHOULD SUSTAIN A LOSS OF NOT MORE THAN 10% AFTER 12 CYCLES OF FREEZING AND THAWING (AASHTO TEST 103 FOR LEDGE ROCK PROCEDURE A).
- 8. ROCK HAVING A MINIMUM SPECIFIC GRAVITY OF 2.65 IS PREFERRED: HOWEVER, IN NO CASE SHOULD ROCK HAVE A SPECIFIC GRAVITY LESS THAN 2.50.

Know what's below.

EDARP FILING NO. 2321

Call before you dig.

BAR IS ONE INCH ON OFFICIAL DRAWINGS. NO. DATE BY REVISION DESCRIPTION JOB DATE: 3/18/2024 DRAWN BY: ACH APPROVED: CPM JOB NUMBER: 201662.08 CAD DATE: 3/22/2024 CAD FILE: J:\2020\201662\CAD\Dwgs\C\Eastonville_Road_662.08\Segment_1\CD\Road_CDs\Pond_Plars




HR GREEN - COLORADO SPRINGS 1975 RESEARCH PARKWAY SUITE 230 COLORADO SPRINGS CO 80920 HRGreen PHONE: 719.300.4140 FAX: 713.965.0044


EASTONVILLE ROAD IMPROVEMENTS DR. HORTON EL PASO COUNTY, COLORADO


D-R-HORTON America's Builder

EASTONVILLE ROAD SEGEMENT 1 IMPROVEMENTS EDB B (PUBLIC) DETAILS

PD.5

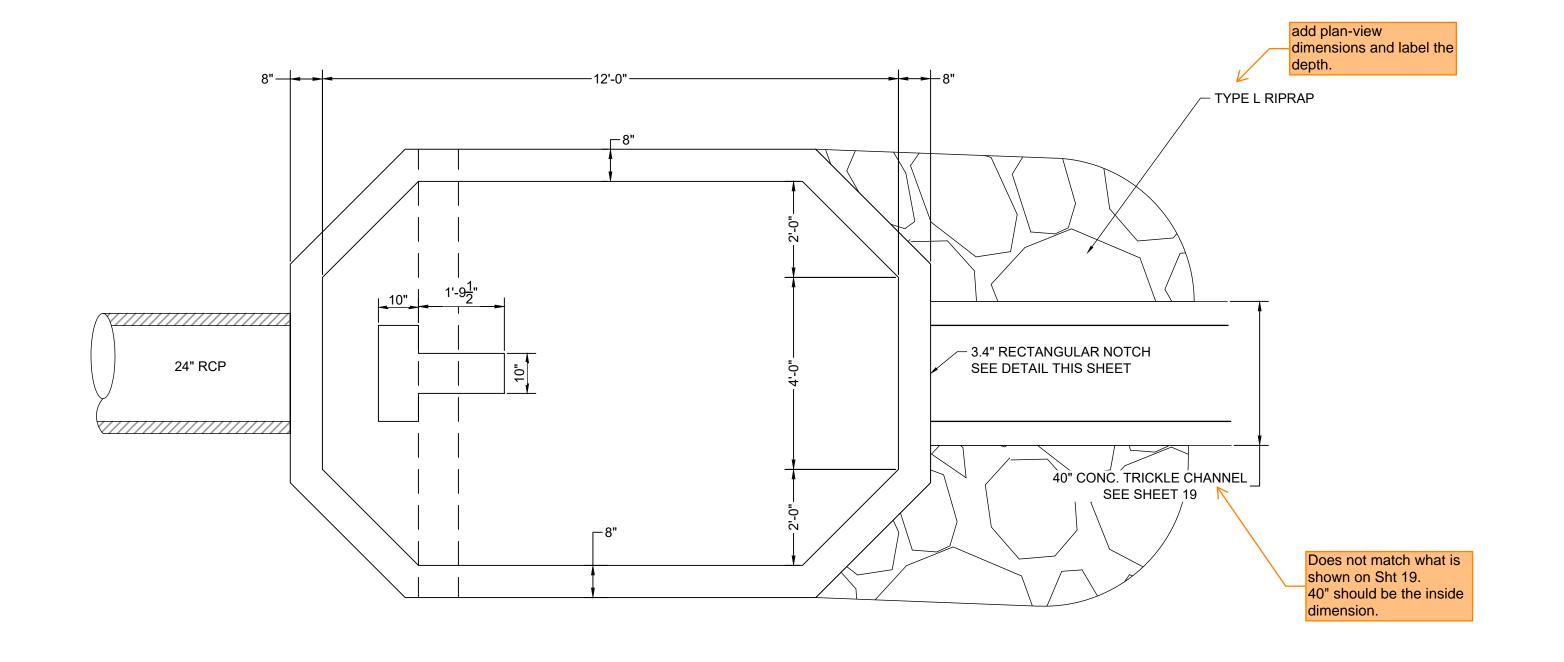


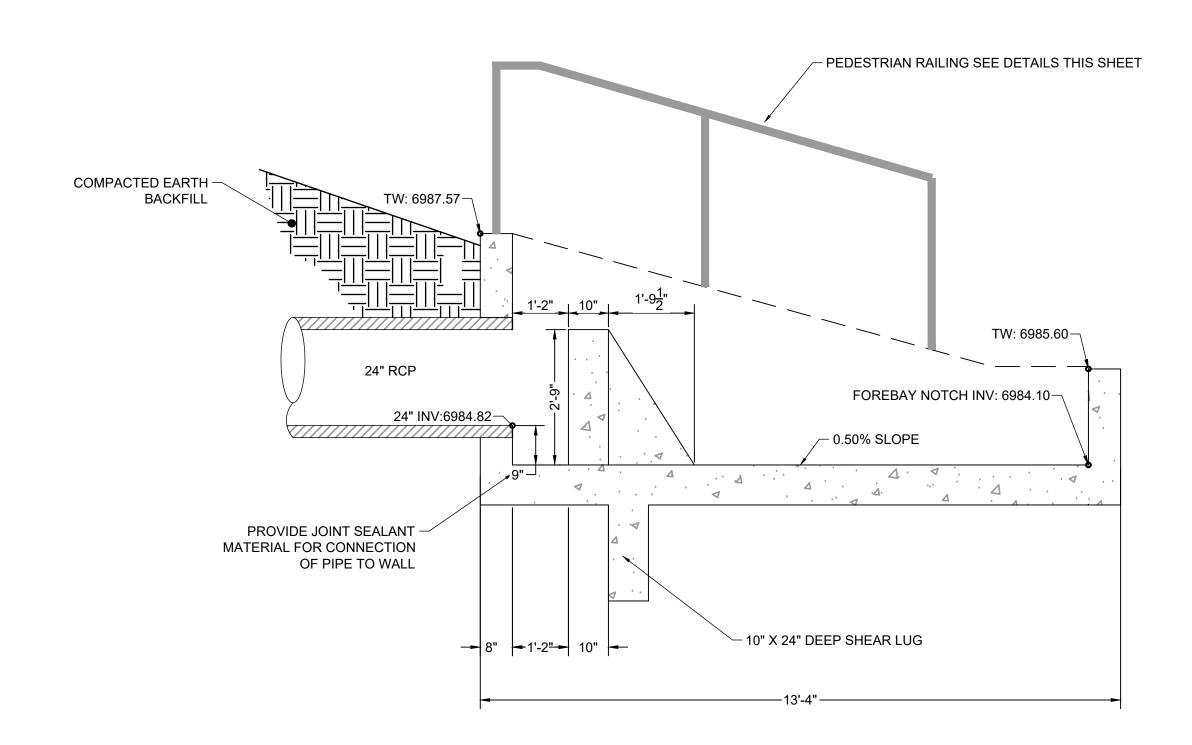

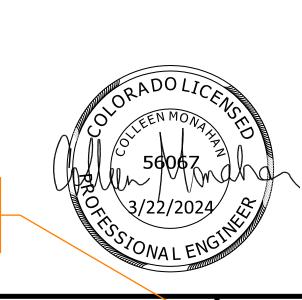


— GUARDRAIL POST — GUARDRAIL BASE PL, 5/16V Q 4"x8"X1/2" (2)-5/8"ø × 6" GALVANIZED EXPANSION ANCHORS ELEVATION VIEW HANDRAIL POST DETAIL

SCALE: NTS

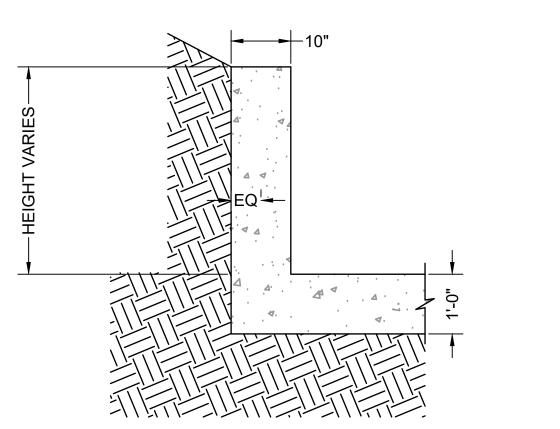


ELEVATION VIEW FOREBAY WINGWALL REINFORCEMENT DETAIL

SCALE: NTS

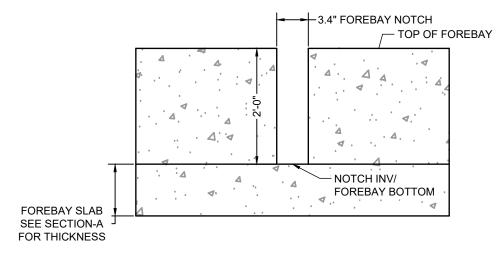

ELEVATION VIEW FOREBAY NOTCH DETAIL

SCALE: NTS

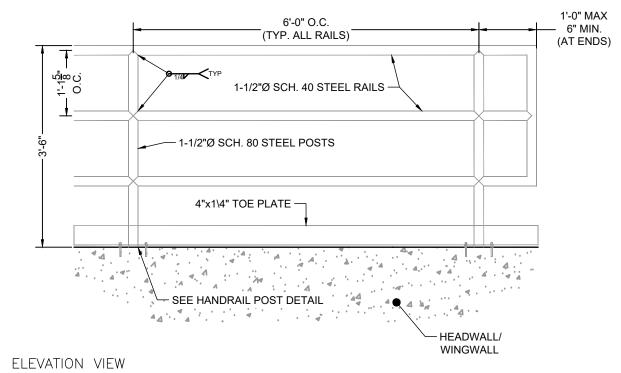

Clarify that these details represent the Interim Condition

2/22/2024	ı w
OR ADOLICE SCHOOL OF THE PROPERTY OF THE PROPE	•

HANDRAIL POST DETAIL

EDARP FILING NO. 2321

BAR IS ONE INCH ON OFFICIAL DRAWINGS. NO. DATE BY REVISION DESCRIPTION 3/6/2024 JOB DATE: DRAWN BY: ACH APPROVED: CMM JOB NUMBER: <u>201662.08</u> IF NOT ONE INCH, CAD DATE: 3/22/2024 ADJUST SCALE ACCORDINGLY. CAD FILE: J:\2020\201662\CAD\Dwgs\C\Eastonville_Road_662.08\Segment_1\CD\Road_CDs\Forebay_Details

811.

Know what's below.
Call before you dig.


HR GREEN - COLORADO SPRINGS 1975 RESEARCH PARKWAY SUITE 230 COLORADO SPRINGS CO 80920 HRGreen PHONE: 719.300.4140 FAX: 713.965.0044


EASTONVILLE ROAD IMPROVEMENTS DR. HORTON EL PASO COUNTY, COLORADO


D·R·HORTON America's Builder

EASTONVILLE ROAD SEGEMENT 1 IMPROVEMENTS EDB B (PUBLIC) FOREBAY DETAILS

SHEET PD.6

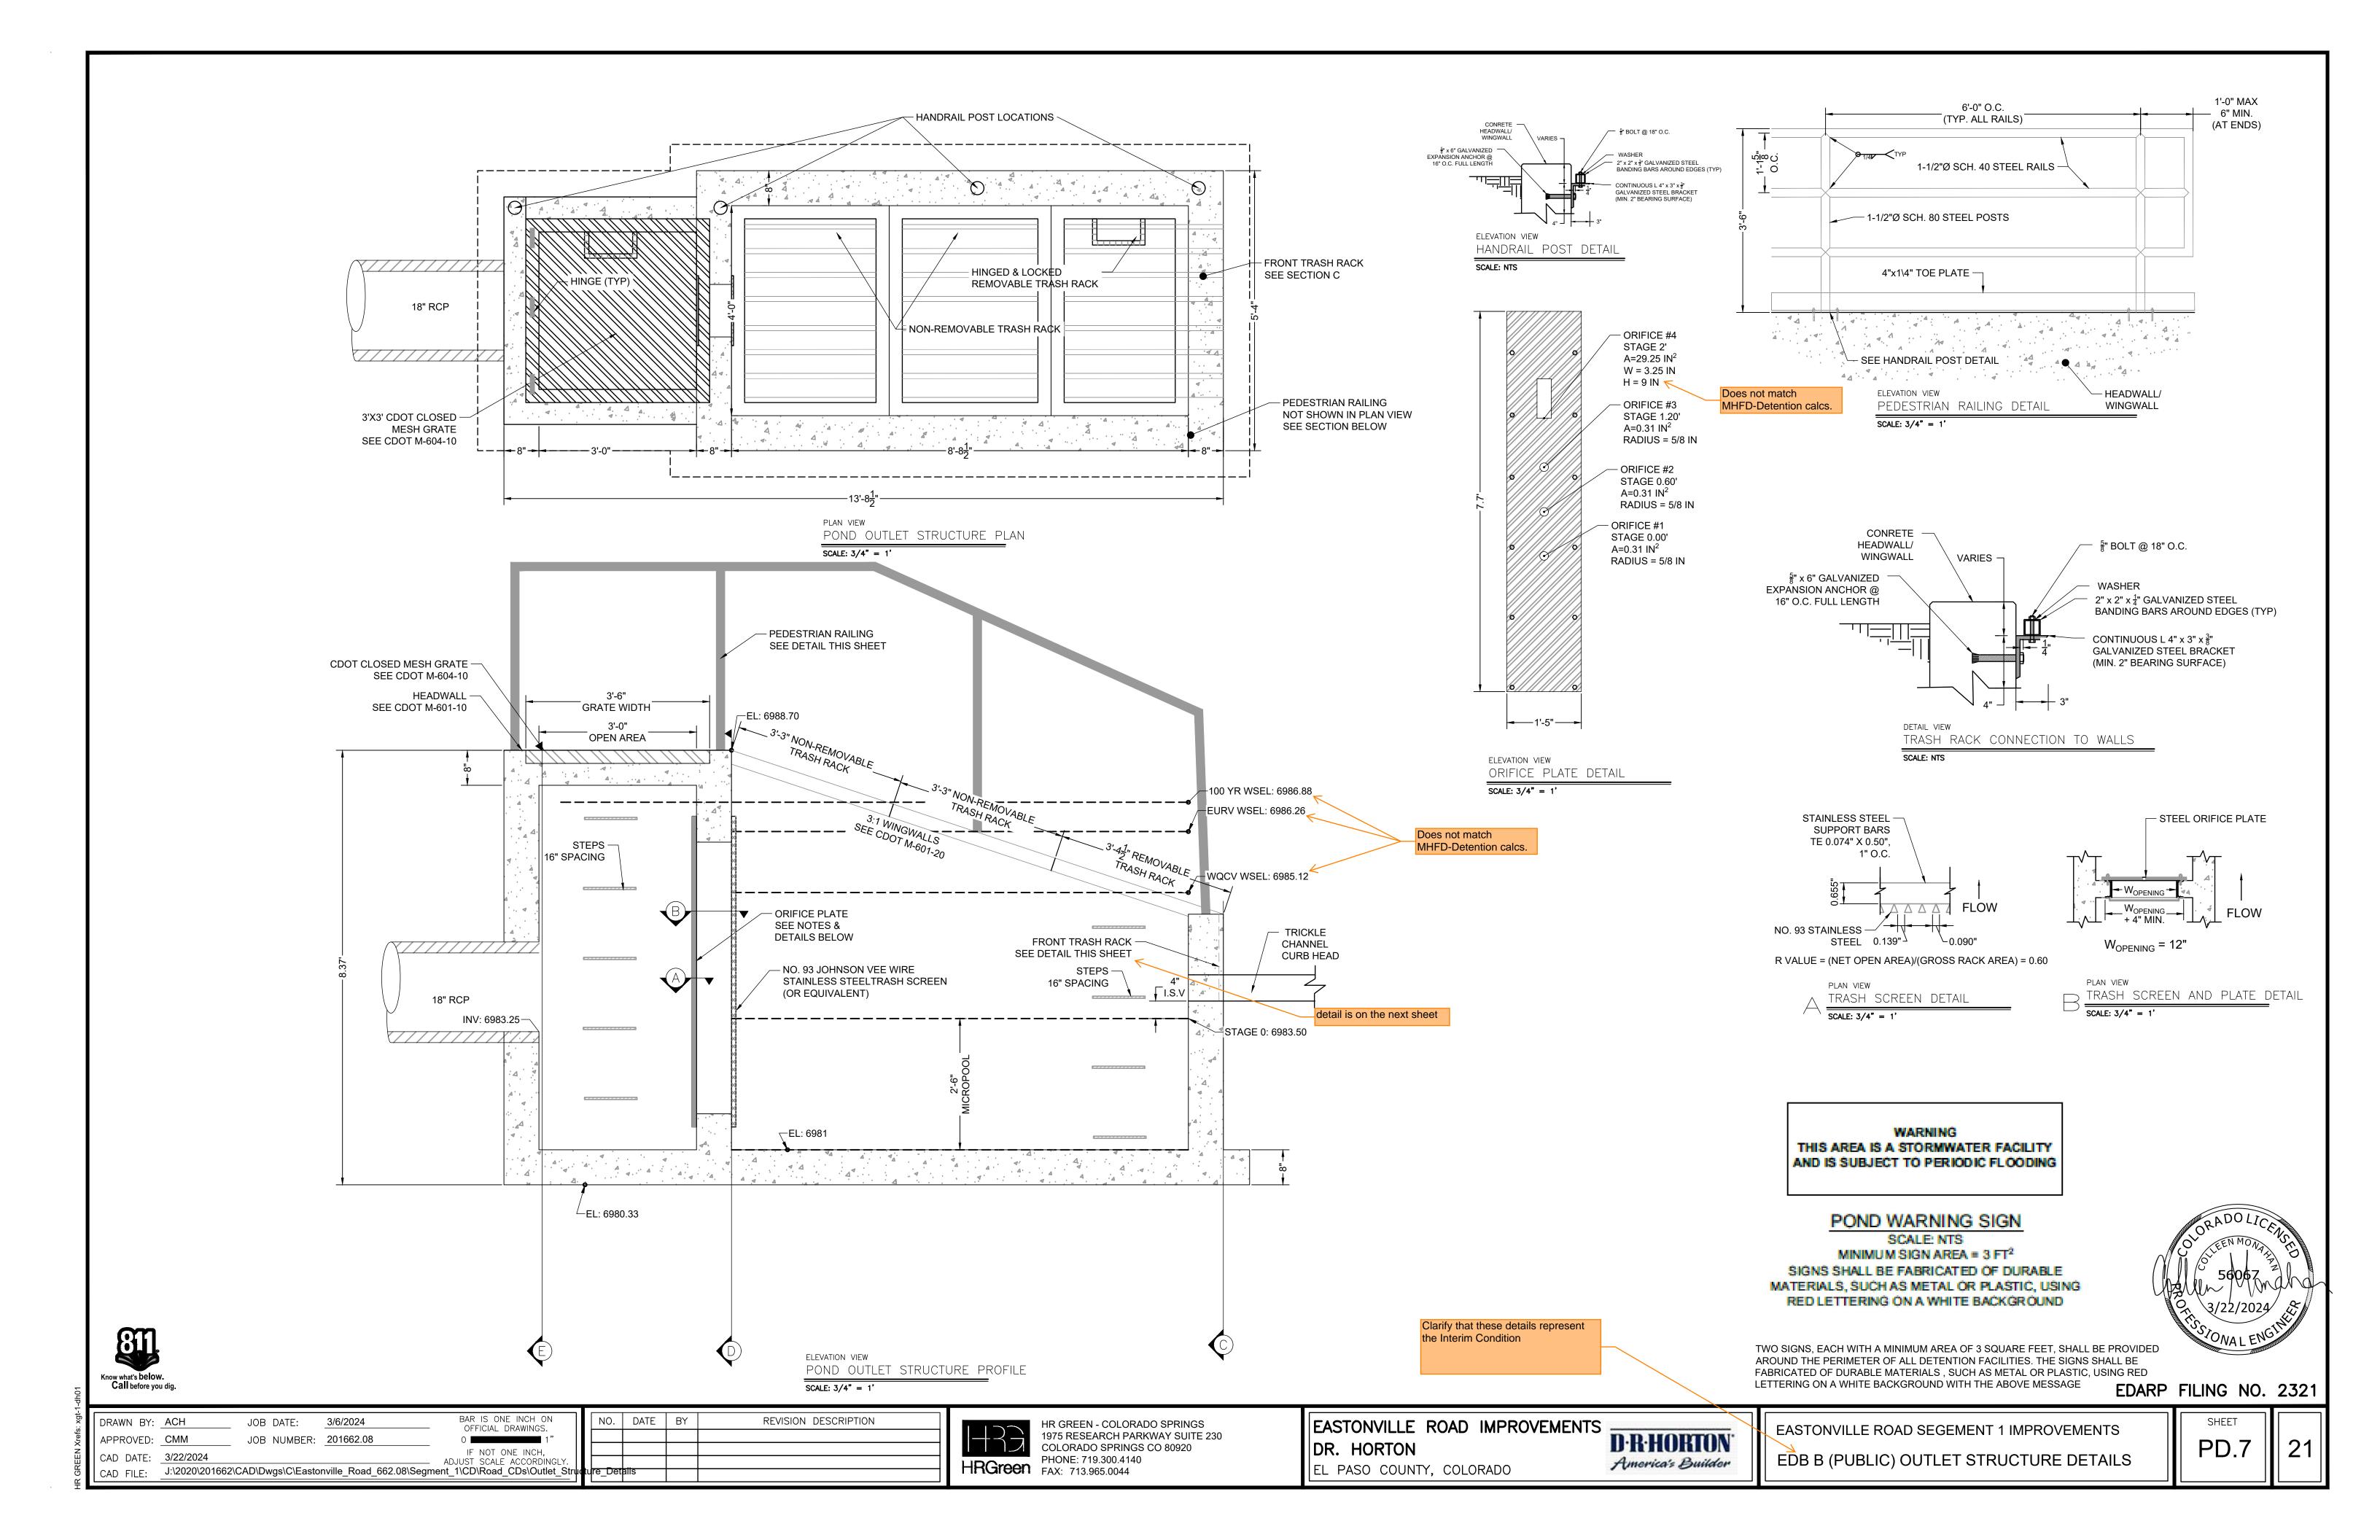


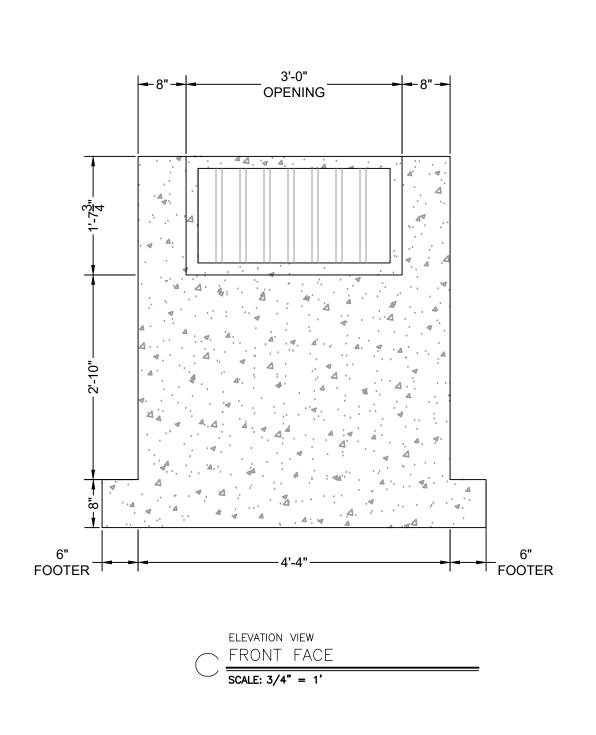

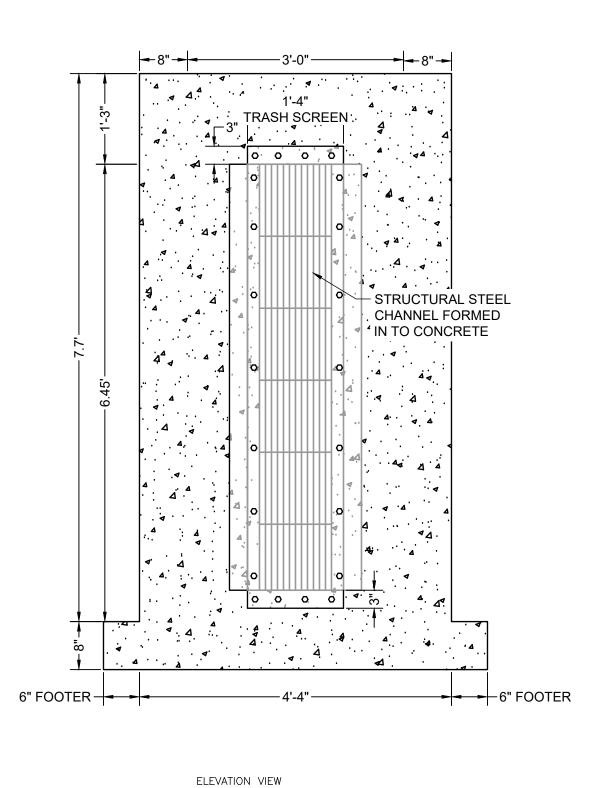

TRASH SCREEN

SCALE: 3/4" = 1'

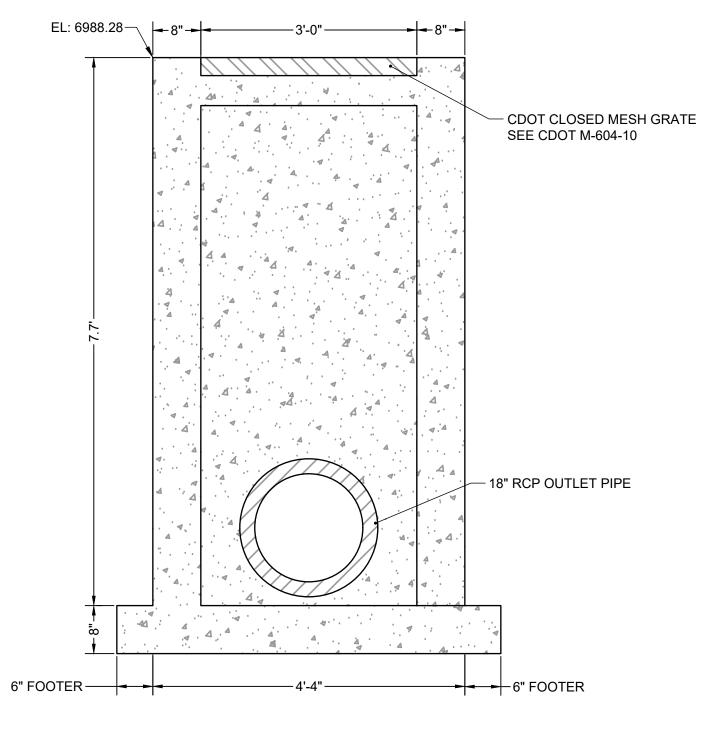

ELEVATION VIEW REAR FACE SCALE: 3/4" = 1'

ORIFICE PLATE NOTES:

- 1. PLATE TO BE $\frac{3}{8}$ " THICK GALVANIZED STEEL.
- 2. BOLT PLATE TO CONCRETE 16" O.C. MAX.
- 3. PROVIDE CONTINUOUS NEOPRENE GASKET MATERIAL BETWEEN THE ORIFICE PLATE AND CONCRETE

TRASH SCREEN NOTES:


- 1. WELL-SCREEN TRASH RACKS SHALL BE STAINLESS STEEL AND SHALL BE ATTACHED BY INTERMITTENT WELDS ALONG THE EDGE OF THE
- 2. BAR GATE TRASH RACKS SHALL BE ALUMINUM AND SHALL BE BOLTED USING STAINLESS STEEL HARDWARE.
- 3. TRASH RACK OPEN AREAS ARE FOR SPECIFIED TRASH RACK MATERIALS. TOTAL TRASH RACK SIZE MAY NEED TO BE ADJUSTED FOR MATERIALS HAVING DIFFERENT OPEN AREA/GROSS AREA RATIO (R VALUE).
- 4. STRUCTURAL DESIGN OF TRASH RACKS SHALL BE BASED ON FULL HYDROSTATIC HEAD WITH ZERO HEAD DOWNSTREAM OF THE RACK.

TRASH RACK NOTES:

- 1. TRASH RACKS SHALL BE $1\frac{1}{4}$ " SCH. 40 STEEL PIPE, GALVANIZED, @ 6" CENTERS. SUPPORT BARS SHALL BE $\frac{1}{4}$ " x 2" STEEL RECTANGULAR BARS, GALVANIZED, @ 36". ALL TRASH RACKS SHALL BE MOUNTED USING STAINLESS STEEL HARDWARE.
- 2. REMOVABLE TRASH RACK SECTIONS SHALL BE MOUNTED USING STAINLESS STEEL HARDWARE AND PROVIDED WITH HINGED & LOCKABLE OR
- BOLTABLE ACCESS PANELS AS SHOWN ON THE PLANS. 3. STEEL TRASH RACKS SHALL BE HOT DIP GALVANIZED AND MAY BE HOT POWDER COATED AFTER GALVANIZING.
- 4. STRUCTURAL STEEL FOR GRATES, ORIFICE PLATES, AND BARS SHALL BE GALVANIZED AND SHALL BE IN ACCORDANCE WITH CDOT STANDARD
- SPECIFICATIONS, SUBSECTION 712.06. 5. CONTRACTOR SHALL SUBMIT SHOP DRAWINGS FOR ALL PLATES AND GRATING FOR ENGINEER'S APPROVAL PRIOR TO CONSTRUCTION.

RESTRICTOR PLATE NOTES:


- 1. $\frac{3}{8}$ " THICK RESTRICTOR PLATE, GALVANIZED STEEL.
- 2. BOLT PLATE TO CONCRETE @ 12" O.C. MAX
- 3. PROVIDE CONTINUOUS NEOPRENE GASKET MATERIAL BETWEEN PLATE AND CONCRETE

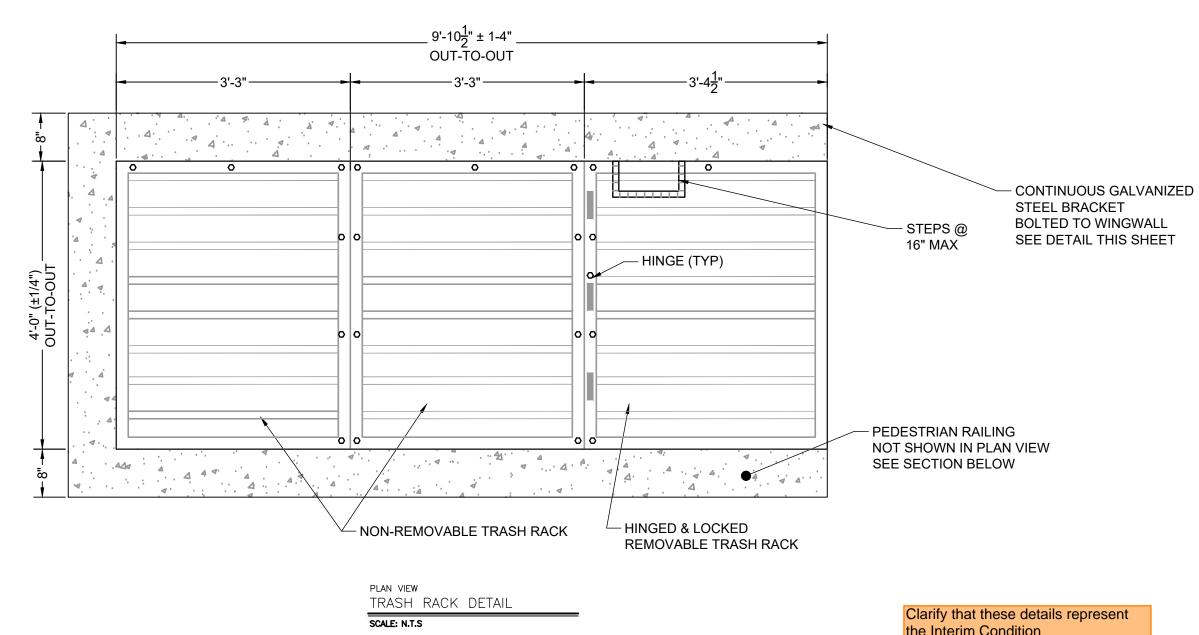

the Interim Condition

EDARP FILING NO. 2321


BAR IS ONE INCH ON OFFICIAL DRAWINGS. NO. DATE BY REVISION DESCRIPTION DRAWN BY: ACH JOB DATE: 3/6/2024 APPROVED: CMM JOB NUMBER: <u>201662.08</u> IF NOT ONE INCH, CAD DATE: 3/22/2024 ADJUST SCALE ACCORDINGLY CAD FILE: J:\2020\201662\CAD\Dwgs\C\Eastonville_Road_662.08\Segment_1\CD\Road_CDs\Outlet_Structure_Details

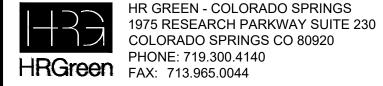


EASTONVILLE ROAD IMPROVEMENTS DR. HORTON EL PASO COUNTY, COLORADO

D·R·HORTON' America's Builder


EAS/TONVILLE ROAD SEGEMENT 1 IMPROVEMENTS EDB B (PUBLIC) OUTLET STRUCTURE DETAILS

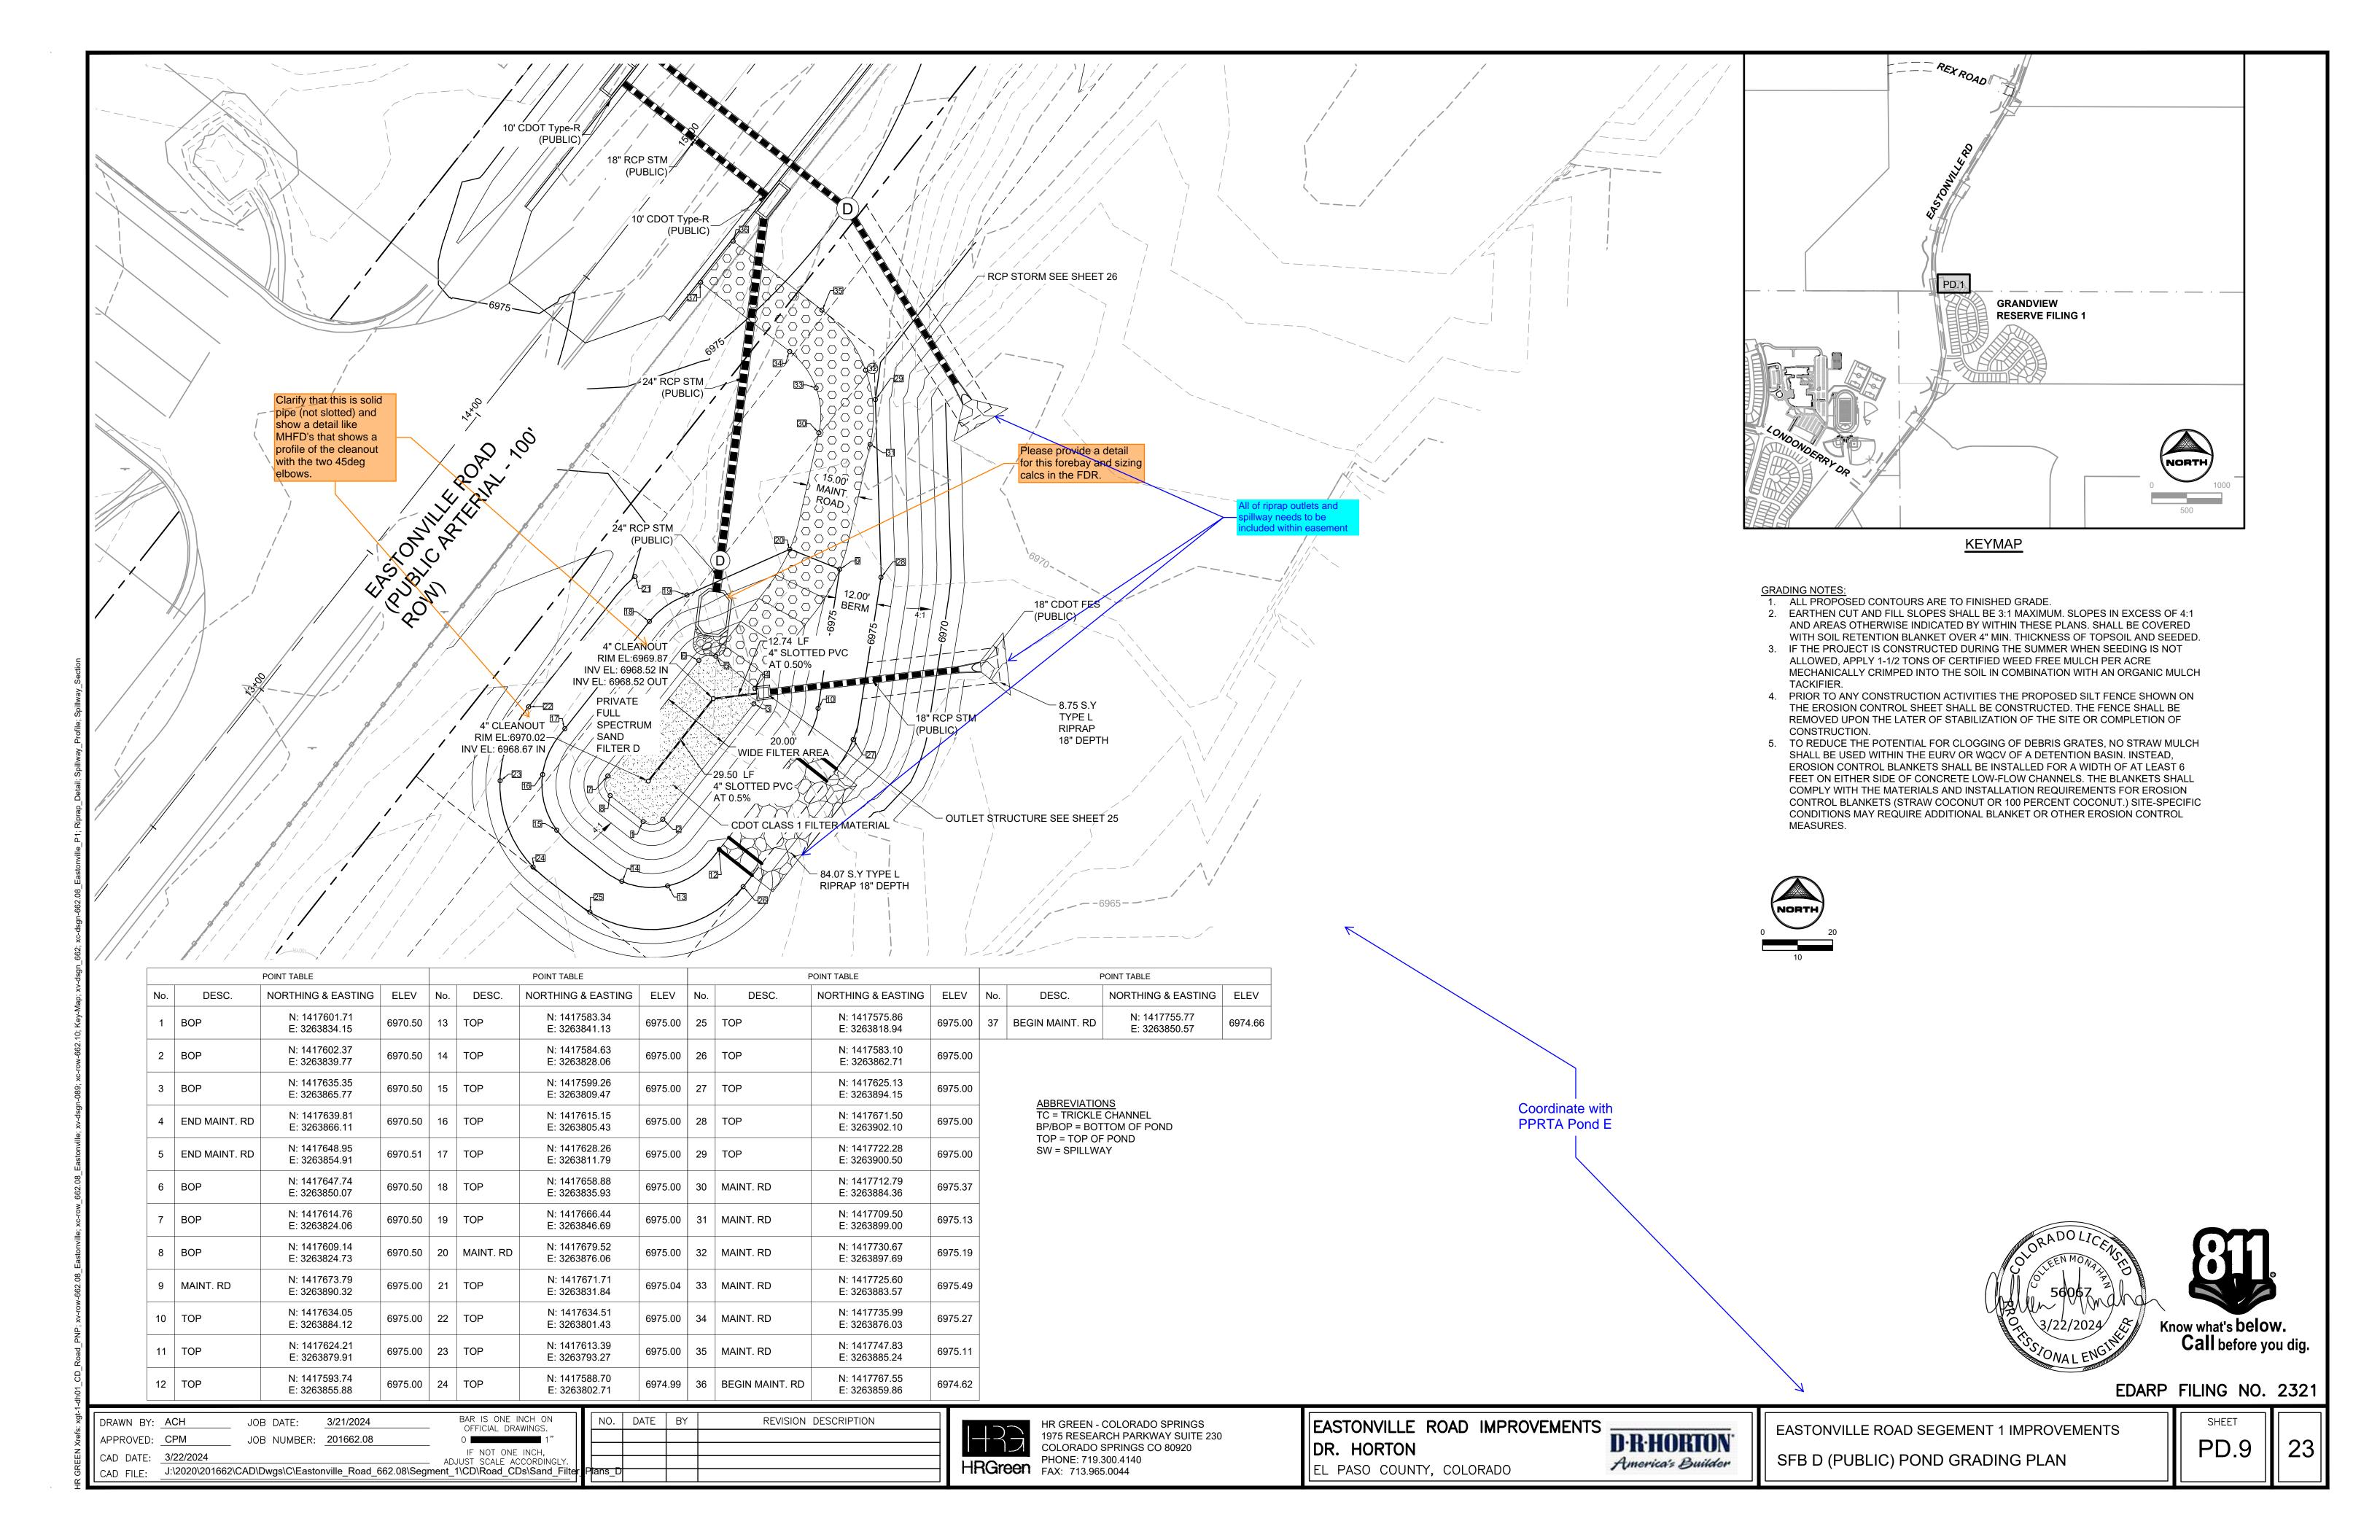

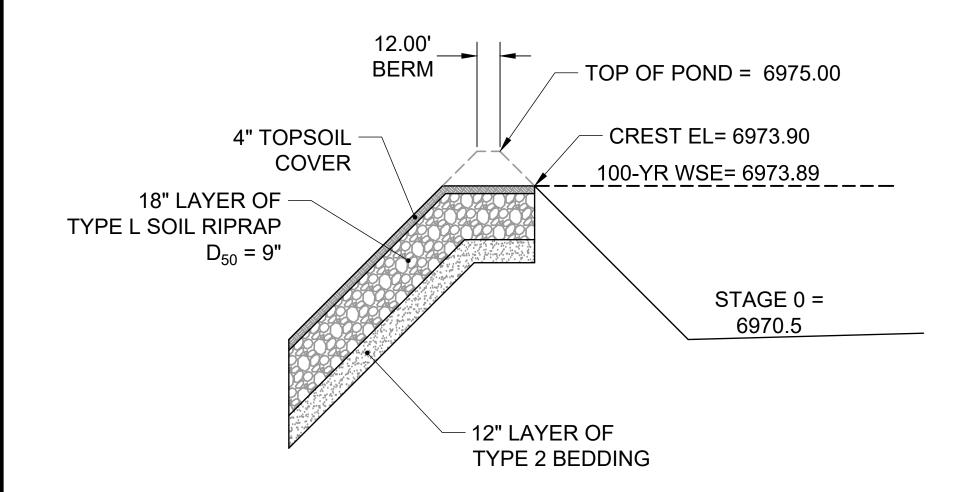


PROFILE VIEW -EMERGENCY OVERFLOW SPILLWAY

SCALE: NTS

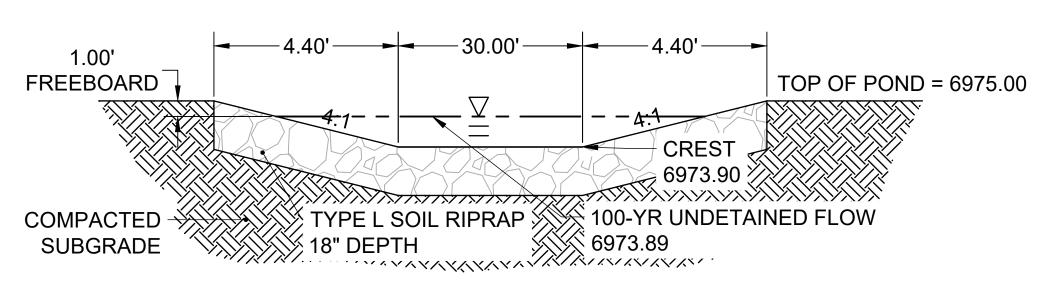

SECTION VIEW -EMERGENCY SPILLWAY

SCALE: NTS

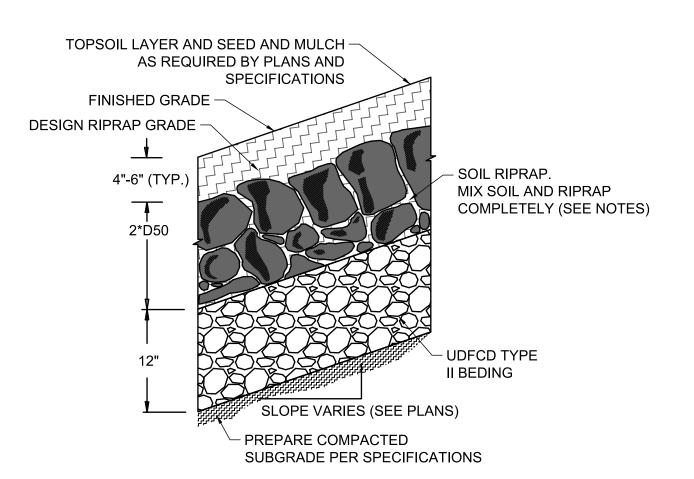

SOIL RIPRAP EMBANKMENT PROTECTION WITH BEDDING TYP. SECTION

N.T.S

TYPE L RIPRAP

INTERMEDIATE	PERCENT		
ROCK DIMENSION	PASSING		
(IN .)	(%)		
15	70-100		
12	50-70		
9	35-50		
3	2-10		

*TYPE L RIPRAP D50=9". D50=MEAN PARTICLE SIZE (INTERMEDIATE DIMENSION) BY WEIGHT

RIPRAP NOTES.

- SOIL RIPRAP DETAILS ARE APPLICABLE TO SLOPED AREAS REFER TO THE SITE PLAN ACTUAL LOCATION AND LIMITS.
- 2. MIX UNIFORMLY 65% RIPRAP BY VOLUME WITH 35% OF APPROVED SOIL BY VOLUME PRIOR TO PLACEMENT.
- 3. PLACE STONE-SOIL MIX TO RESULT IN SECURELY INTERLOCKED ROCK AT THE DESIGN THICKNESS AND GRADE. COMPACT AND LEVEL TO ELIMINATE ALL VOIDS AND ROCKS PROJECTING ABOVE DESIGN RIPRAP TOP GRADE.
- 4. CRIMP OR TACKIFY MULCH OR USE APPROVED HYDROMULCH AS CALLED FOR IN THE PLANS AND SPECIFICATIONS.
- 5. ROCK SHALL BE HARD, DURABLE, ANGULAR IN SHAPE, AND FREE FROM CRACKS, OVERBURDEN, SHALE, AND ORGANIC MATTER.
- 6. NEITHER BREADTH NOR THICKNESS OF A SINGLE STONE SHOULD BE LESS THAN ONE-THIRD ITS LENGTH, AND ROUNDED STONE SHOULD BE AVOIDED.
- 7. THE ROCK SHOULD SUSTAIN A LOSS OF NOT MORE THAN 40% AFTER 500 REVOLUTIONS IN AN ABRASION TEST (LOS ANGELES MACHINEASTM C-535-69) AND SHOULD SUSTAIN A LOSS OF NOT MORE THAN 10% AFTER 12 CYCLES OF FREEZING AND THAWING (AASHTO TEST 103 FOR LEDGE ROCK PROCEDURE A).
- 8. ROCK HAVING A MINIMUM SPECIFIC GRAVITY OF 2.65 IS PREFERRED; HOWEVER, IN NO CASE SHOULD ROCK HAVE A SPECIFIC GRAVITY LESS THAN 2.50.





EDARP FILING NO. 2321

BAR IS ONE INCH ON OFFICIAL DRAWINGS. NO. DATE BY REVISION DESCRIPTION DRAWN BY: ACH JOB DATE: 3/21/2024 APPROVED: CPM JOB NUMBER: 201662.08 CAD DATE: 3/22/2024 CAD FILE: J:\2020\201662\CAD\Dwgs\C\Eastonville_Road_662.08\Segment_1\CD\Road_CDs\Sand_Filter_Plans_D




HR GREEN - COLORADO SPRINGS 1975 RESEARCH PARKWAY SUITE 230 COLORADO SPRINGS CO 80920 HRGreen PHONE: 719.300.4140 FAX: 713.965.0044

EASTONVILLE ROAD IMPROVEMENTS DR. HORTON EL PASO COUNTY, COLORADO



EASTONVILLE ROAD SEGEMENT 1 IMPROVEMENTS SFB D (PUBLIC) POND DETAILS

PD.10 | 24

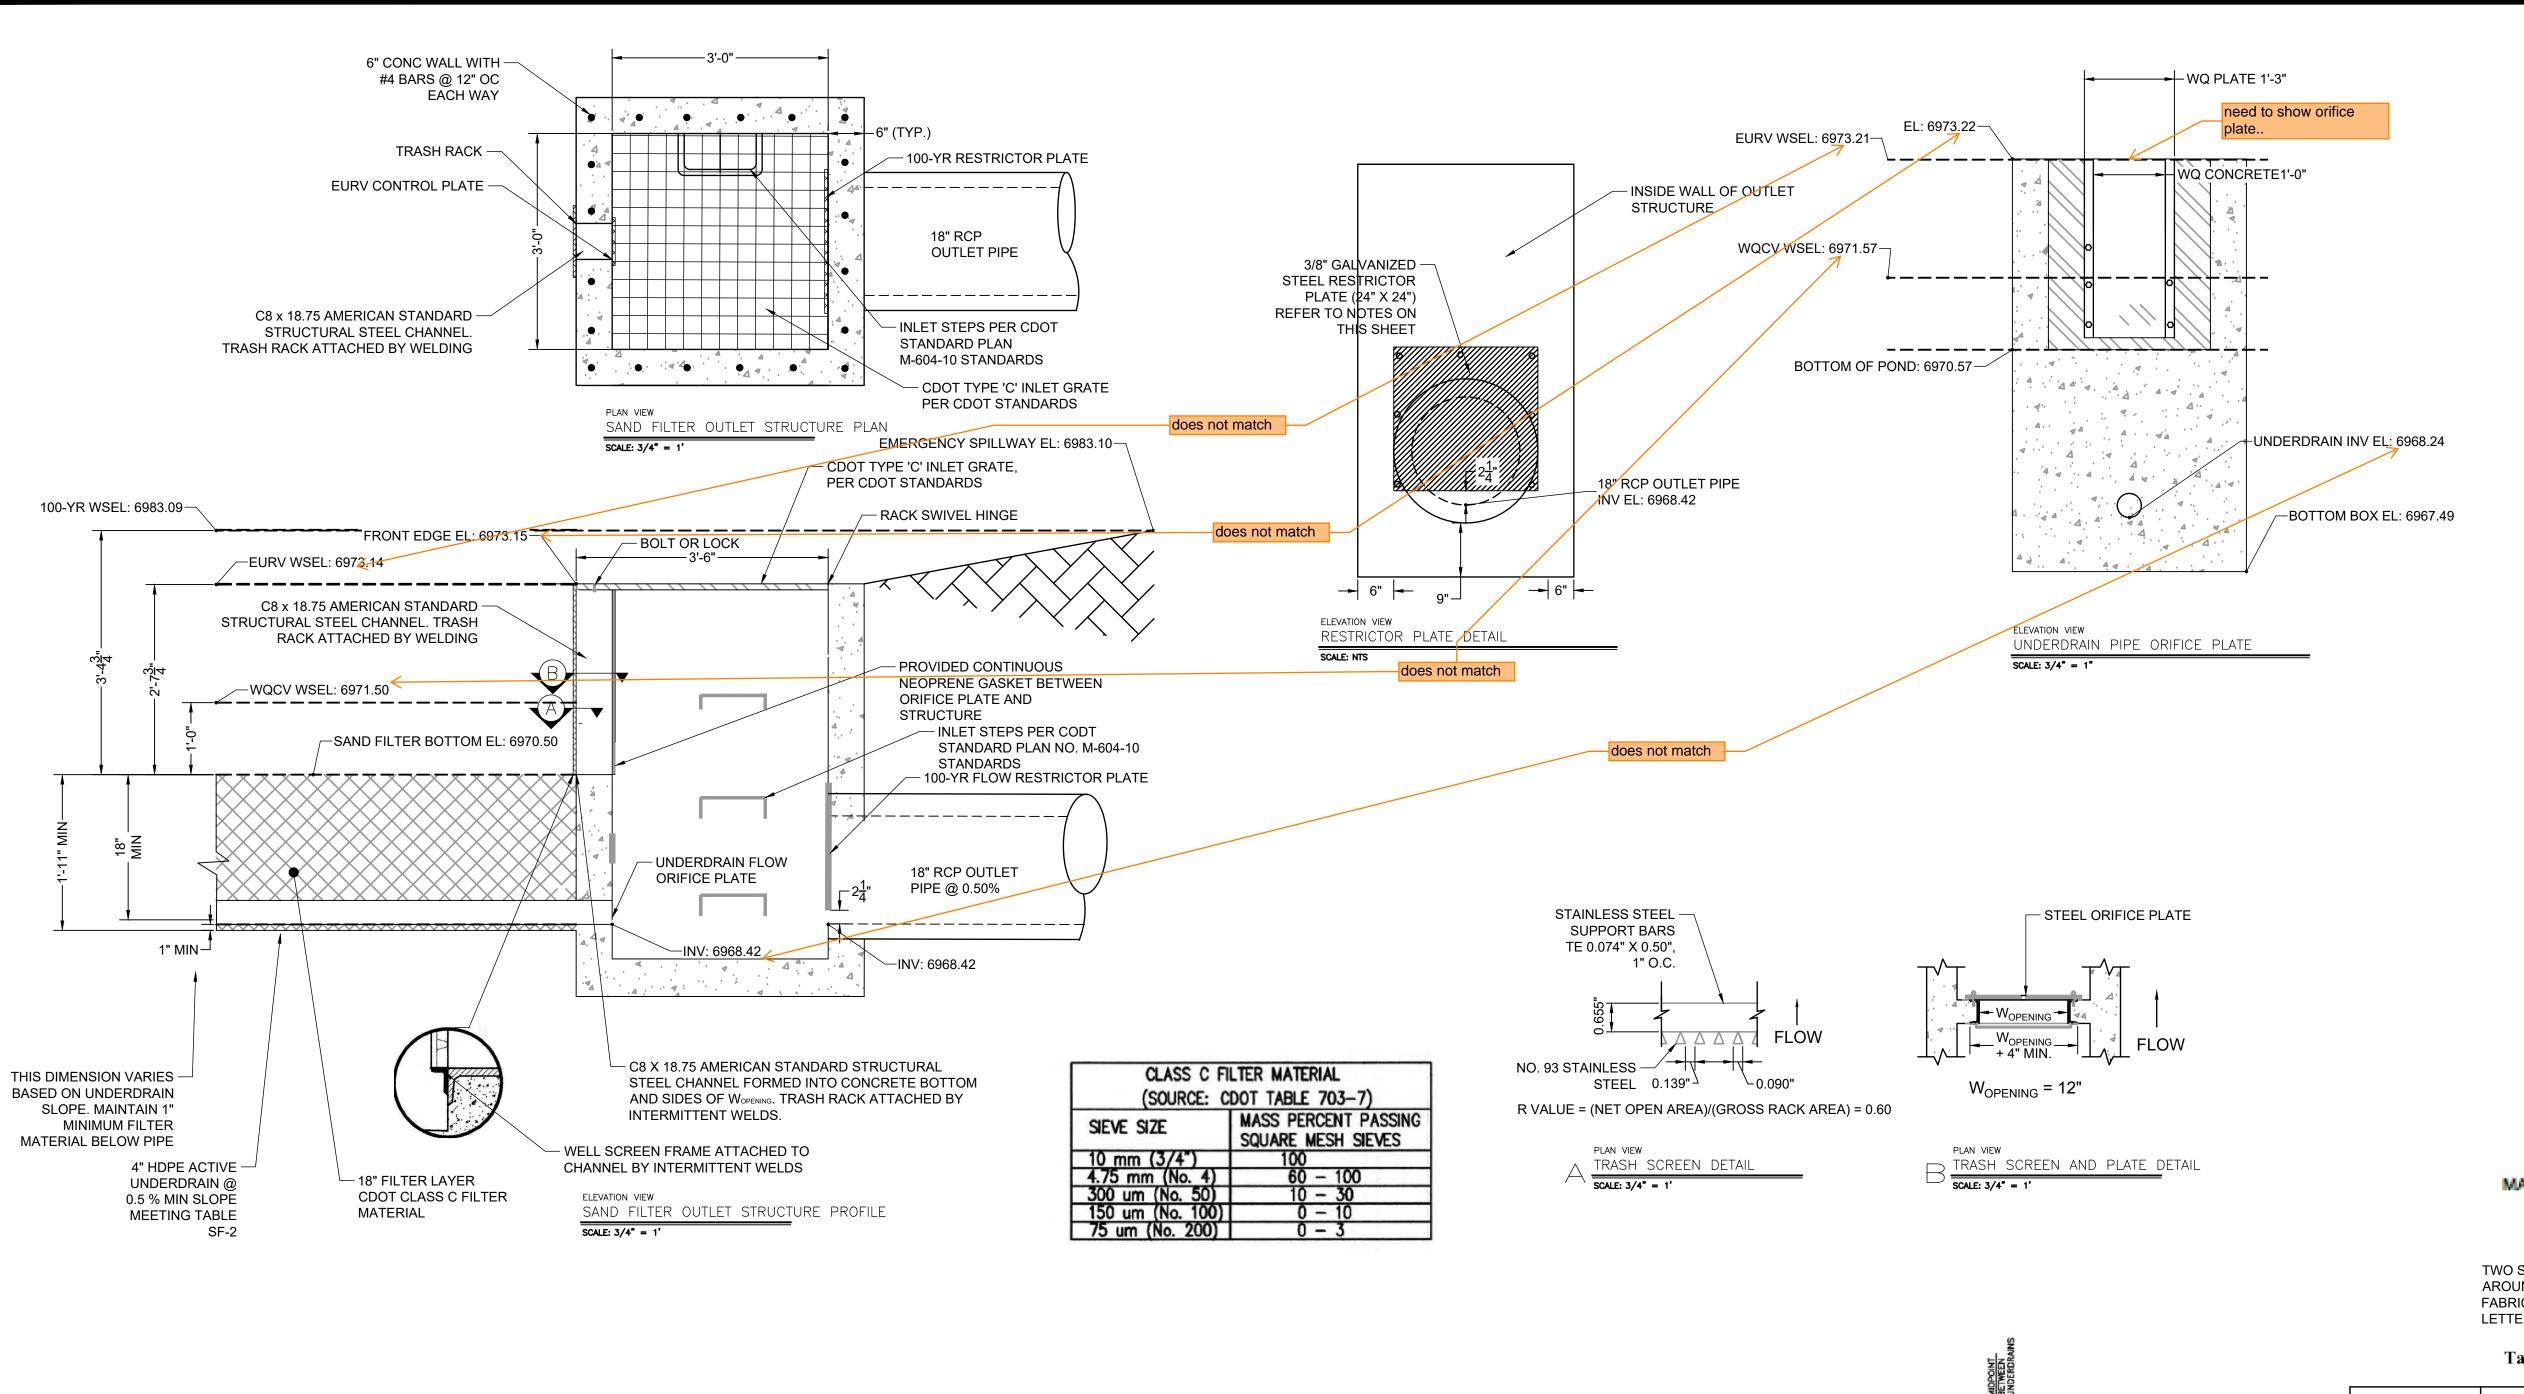

① SLOPE (STRAIGHT GRADE) SUBGRADE (2-10%) TO UNDERDRAIN TO REDUCE SATURATED SOIL CONDITIONS BETWEEN STORM EVENTS (OPTIONAL)

Please provide a detail that shows the underdrain cleanout.
See MHFD Detail T-6 for an go-by detail.

ORIFICE PLATE NOTES:

- 1. PLATE TO BE $\frac{3}{8}$ " THICK GALVANIZED STEEL.
- 2. BOLT PLATE TO CONCRETE 16" O.C. MAX.
- 3. PROVIDE CONTINUOUS NEOPRENE GASKET MATERIAL BETWEEN THE ORIFICE PLATE AND CONCRETE

TRASH SCREEN NOTES:

- 1. WELL-SCREEN TRASH RACKS SHALL BE STAINLESS STEEL AND SHALL BE ATTACHED BY INTERMITTENT WELDS ALONG THE EDGE OF THE MOUNTING FRAME.
- BAR GATE TRASH RACKS SHALL BE ALUMINUM AND SHALL BE BOLTED USING STAINLESS STEEL HARDWARE.
- 3. TRASH RACK OPEN AREAS ARE FOR SPECIFIED TRASH RACK MATERIALS. TOTAL TRASH RACK SIZE MAY NEED TO BE ADJUSTED FOR MATERIALS HAVING DIFFERENT OPEN AREA/GROSS AREA RATIO (R VALUE).
- 4. STRUCTURAL DESIGN OF TRASH RACKS SHALL BE BASED ON FULL HYDROSTATIC HEAD WITH ZERO HEAD DOWNSTREAM OF THE RACK..

RESTRICTOR PLATE NOTES:

- 1. $\frac{3}{8}$ " THICK RESTRICTOR PLATE, GALVANIZED STEEL.
- 2. BOLT PLATE TO CONCRETE @ 12" O.C. MAX
- 3. PROVIDE CONTINUOUS NEOPRENE GASKET MATERIAL BETWEEN PLATE AND CONCRETE
- 4. CONTRACTOR SHALL SUBMIT SHOP DRAWINGS FOR ALL PLATES AND GRATING FOR ENGINEER'S APPROVAL PRIOR TO CONSTRUCTION.

WARNING THIS AREA IS A STORMWATER FACILITY AND IS SUBJECT TO PERIODIC FLOODING

POND WARNING SIGN

SCALE: NTS

MINIMUM SIGN AREA = 3 FT²
SIGNS SHALL BE FABRICATED OF DURABLE

MATERIALS, SUCH AS METAL OR PLASTIC, USING RED LETTERING ON A WHITE BACKGROUND

TWO SIGNS, EACH WITH A MINIMUM AREA OF 3 SQUARE FEET, SHALL BE PROVIDED AROUND THE PERIMETER OF ALL DETENTION FACILITIES. THE SIGNS SHALL BE FABRICATED OF DURABLE MATERIALS, SUCH AS METAL OR PLASTIC, USING RED LETTERING ON A WHITE BACKGROUND WITH THE ABOVE MESSAGE

Table SF-2. Dimensions for Slotted Pipe¹

Pipe Size	Slot Length	Maximum Slot Width	Slot Centers	Open Area (per foot)
4"	1-1/16"	0.032"	0.413"	1.90 in ²
6"	1-3/8"	0.032"	0.516"	1.98 in ²

¹ Pipe must conform to requirements of ASTM designation F949. There shall be no evidence of splitting, cracking, or breaking when the pipe is tested per ASTM test method D2412 in accordance with F949 section 7.5 and ASTM F794 section 8.5. Contech A-2000 slotted pipe (or equal).





EDARP FILING NO. 2321

					_		
AWN BY:	AXB	JOB DATE:	3/14/2024	BAR IS ONE INCH ON OFFICIAL DRAWINGS.		NO.	DATE
PROVED:	СРМ	JOB NUMBER:	201662.08	0 11 1"			
D DATE:	3/22/2024			IF NOT ONE INCH, - ADJUST SCALE ACCORDINGLY.	▋┝		
) FILE:	J:\2020\201662\	CAD\Dwgs\C\Eastor	nville_Road_662.08\Seg	ment_1\CD\Road_CDs\Sand_Outle	<u>_</u> \$	tructur	e_Detai

10" X 10" ORIFICE PLATE

BOLT 2"X11"X3/8" AND 4"X11"X3/8" STEEL

STRIPS TO WALL AS SHOWN TO CREATE

CHANNEL FOR ORIFICE PLATE (TYP.

BOTH SIDES)

ELEVATION VIEW

SCALE: NTS

UNDERDRAIN PIPE ORIFICE PLATE

1433	
HRGreen	

INSIDE WALL OF OUTLET

- 3/8" GALVANIZED STEEL

RESTRICTOR PLATE (12"X12") REFER TO NOTES ON THIS

4" PVC PIPE IN BEHIND PLATE

STEEL PLATE RESTS ON

INLET FLOOR

- 0.83" DIAMETER ORIFICE OPENING

REVISION DESCRIPTION

INV EL: 6968.42

1 3/4"-

UNDERDRAIN PIPE ORIFICE PLATE

ELEVATION VIEW

STRUCTURE

HR GREEN - COLORADO SPRINGS 1975 RESEARCH PARKWAY SUITE 230 COLORADO SPRINGS CO 80920 PHONE: 719.300.4140 FAX: 713.965.0044


EASTONVILLE ROAD IMPROVEMENTS
DR. HORTON
EL PASO COUNTY, COLORADO


D·R·HORTON'
America's Builder


EASTONVILLE ROAD SEGEMENT 1 IMPROVEMENTS


SFB D (PUBLIC) OUTLET STRUCTURE

PD.11

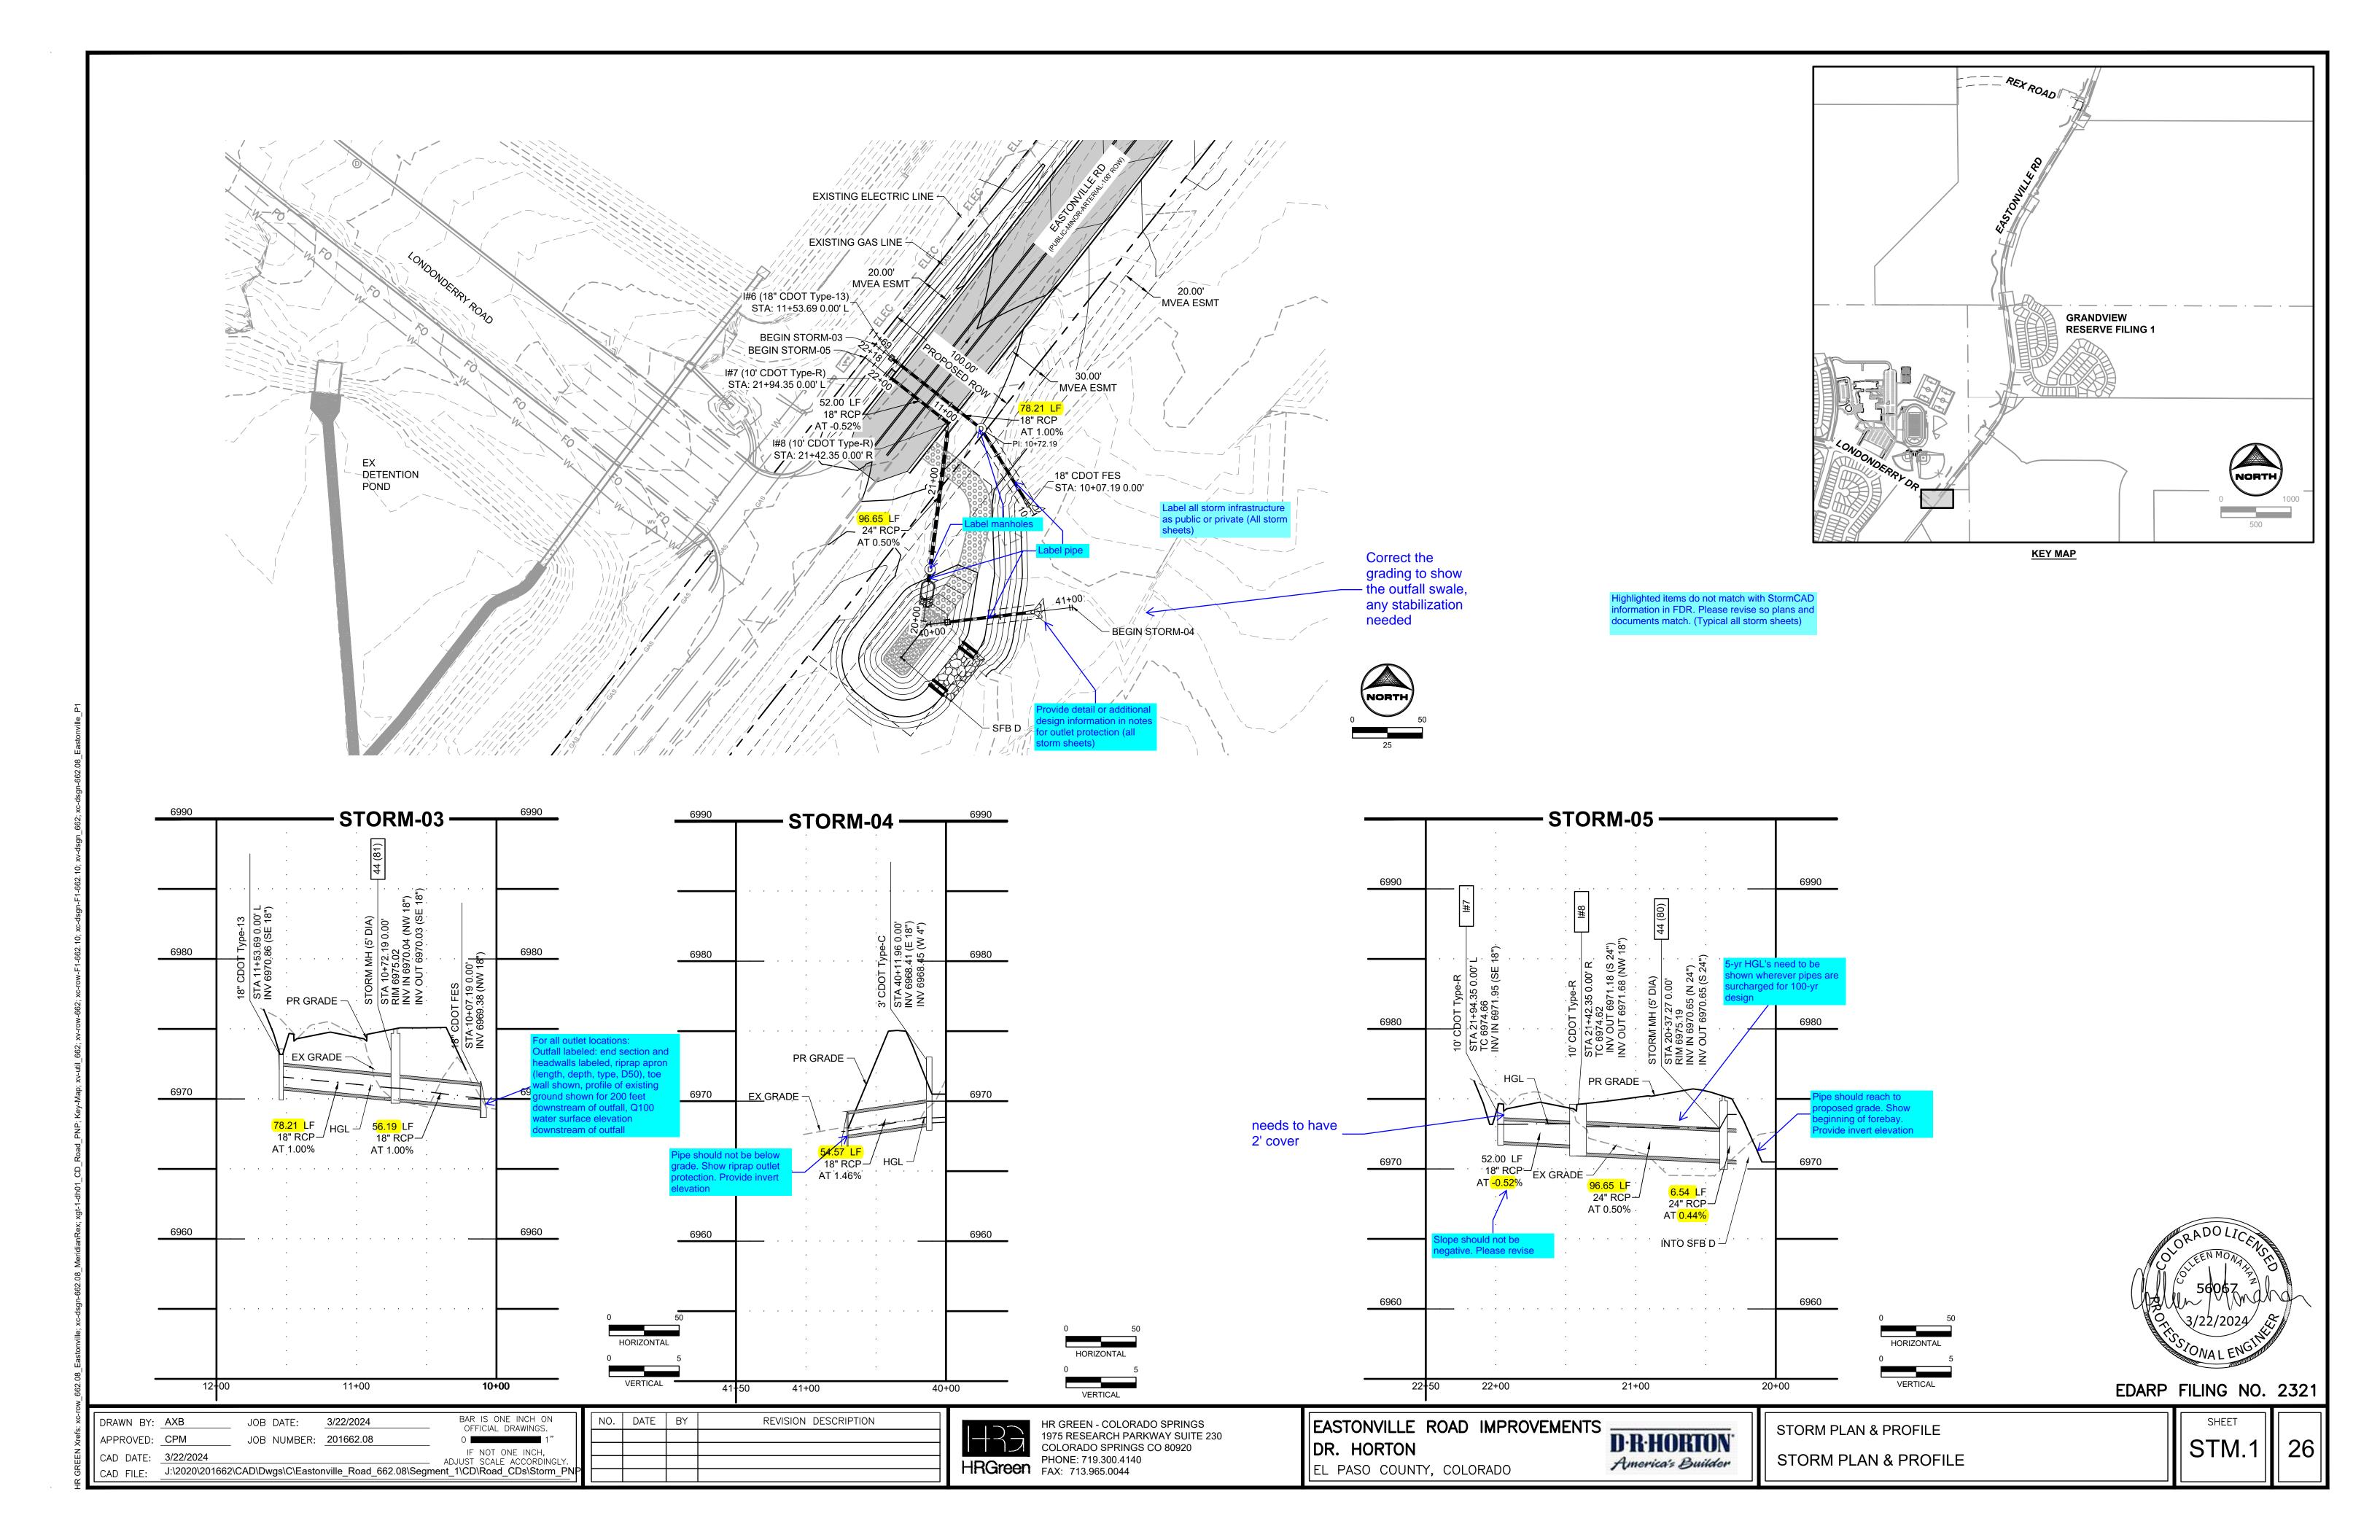


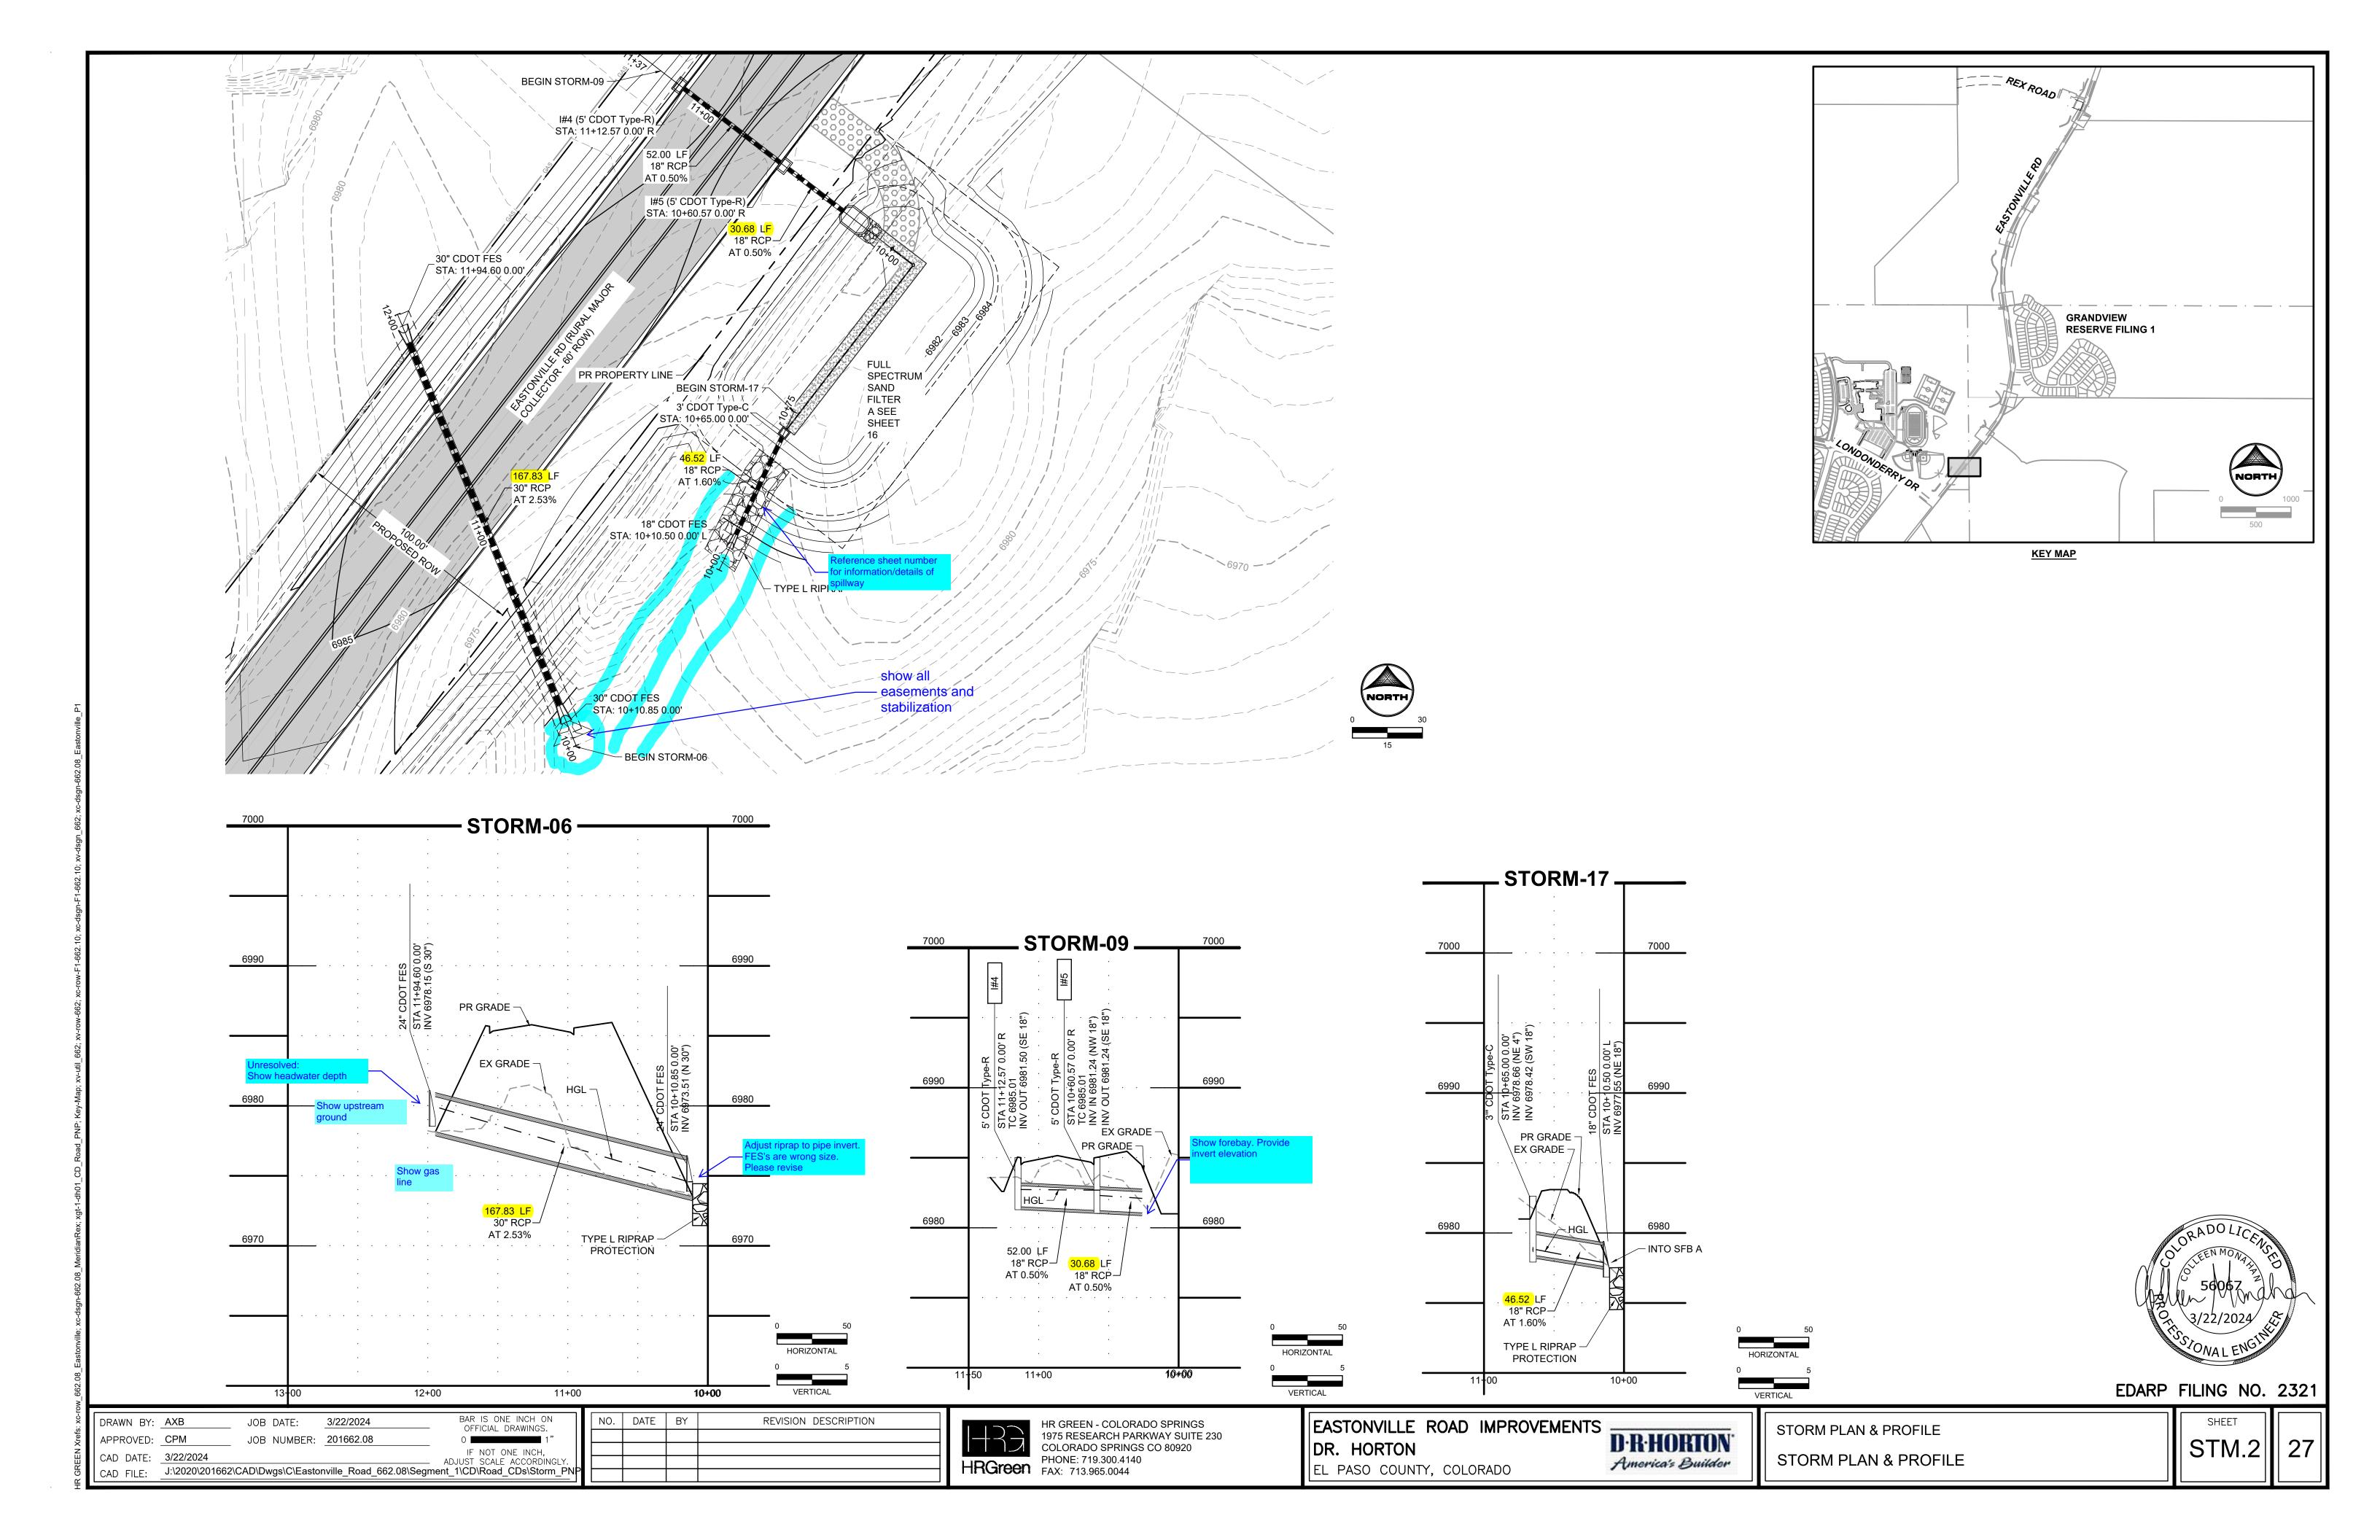


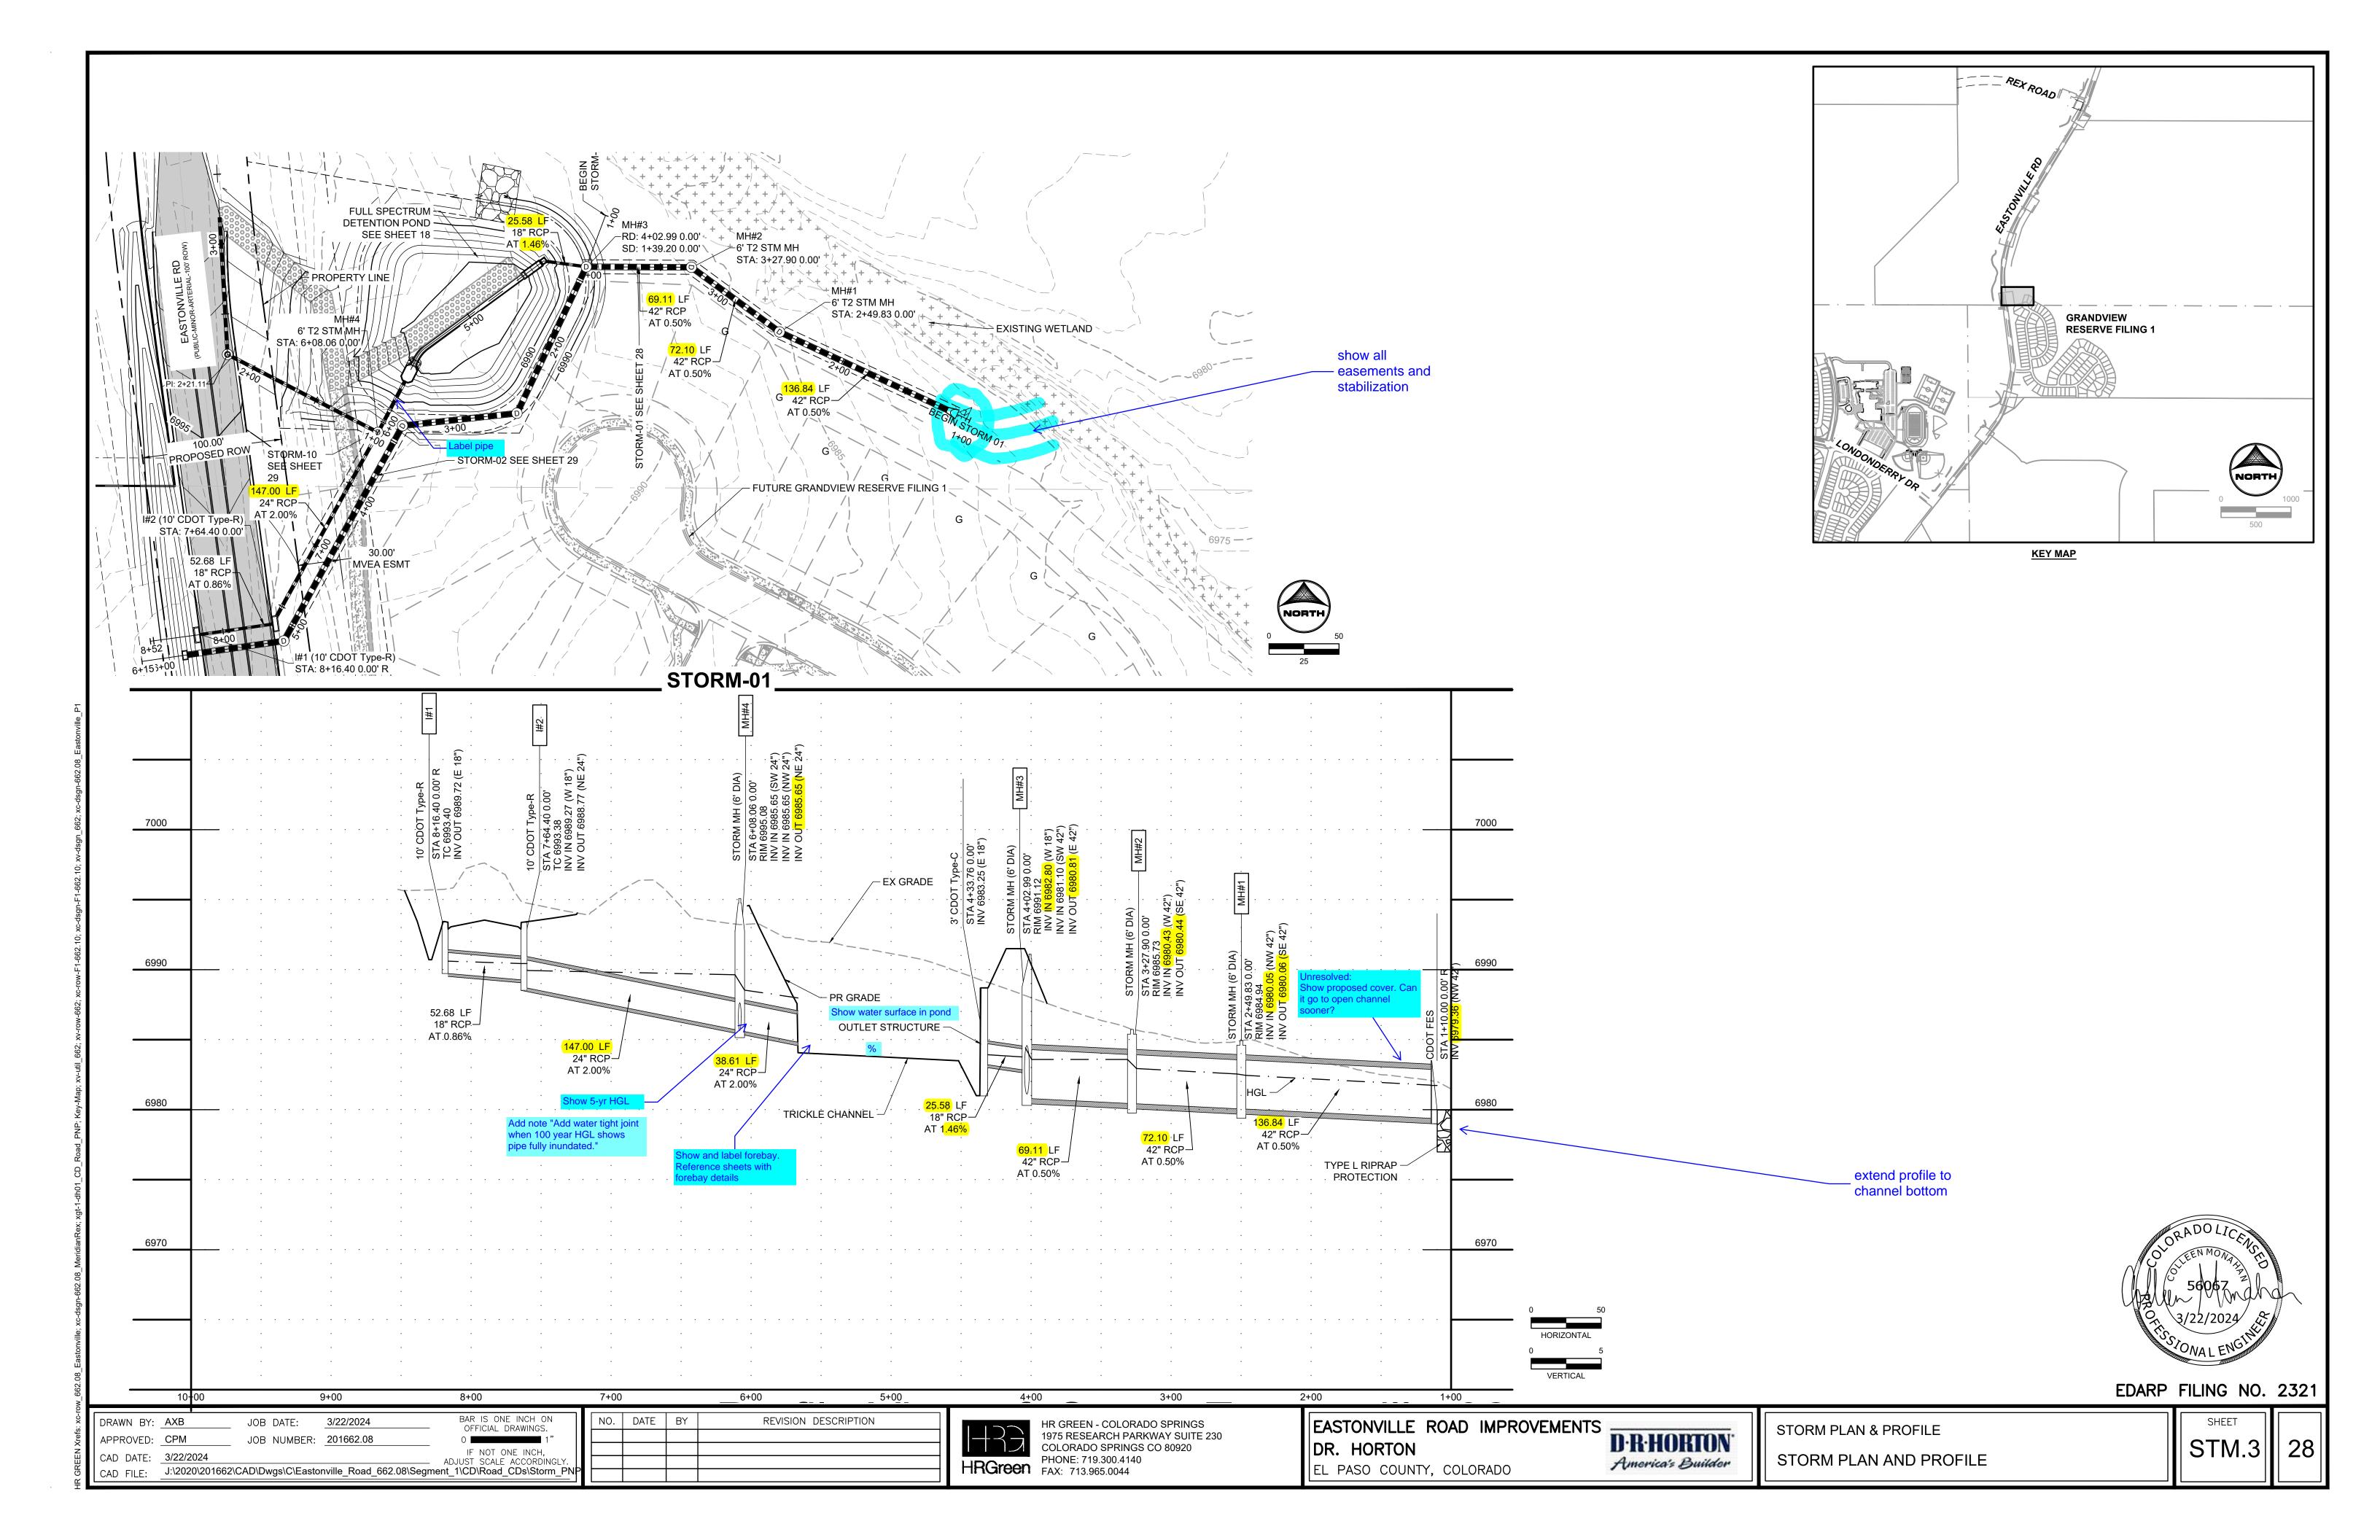

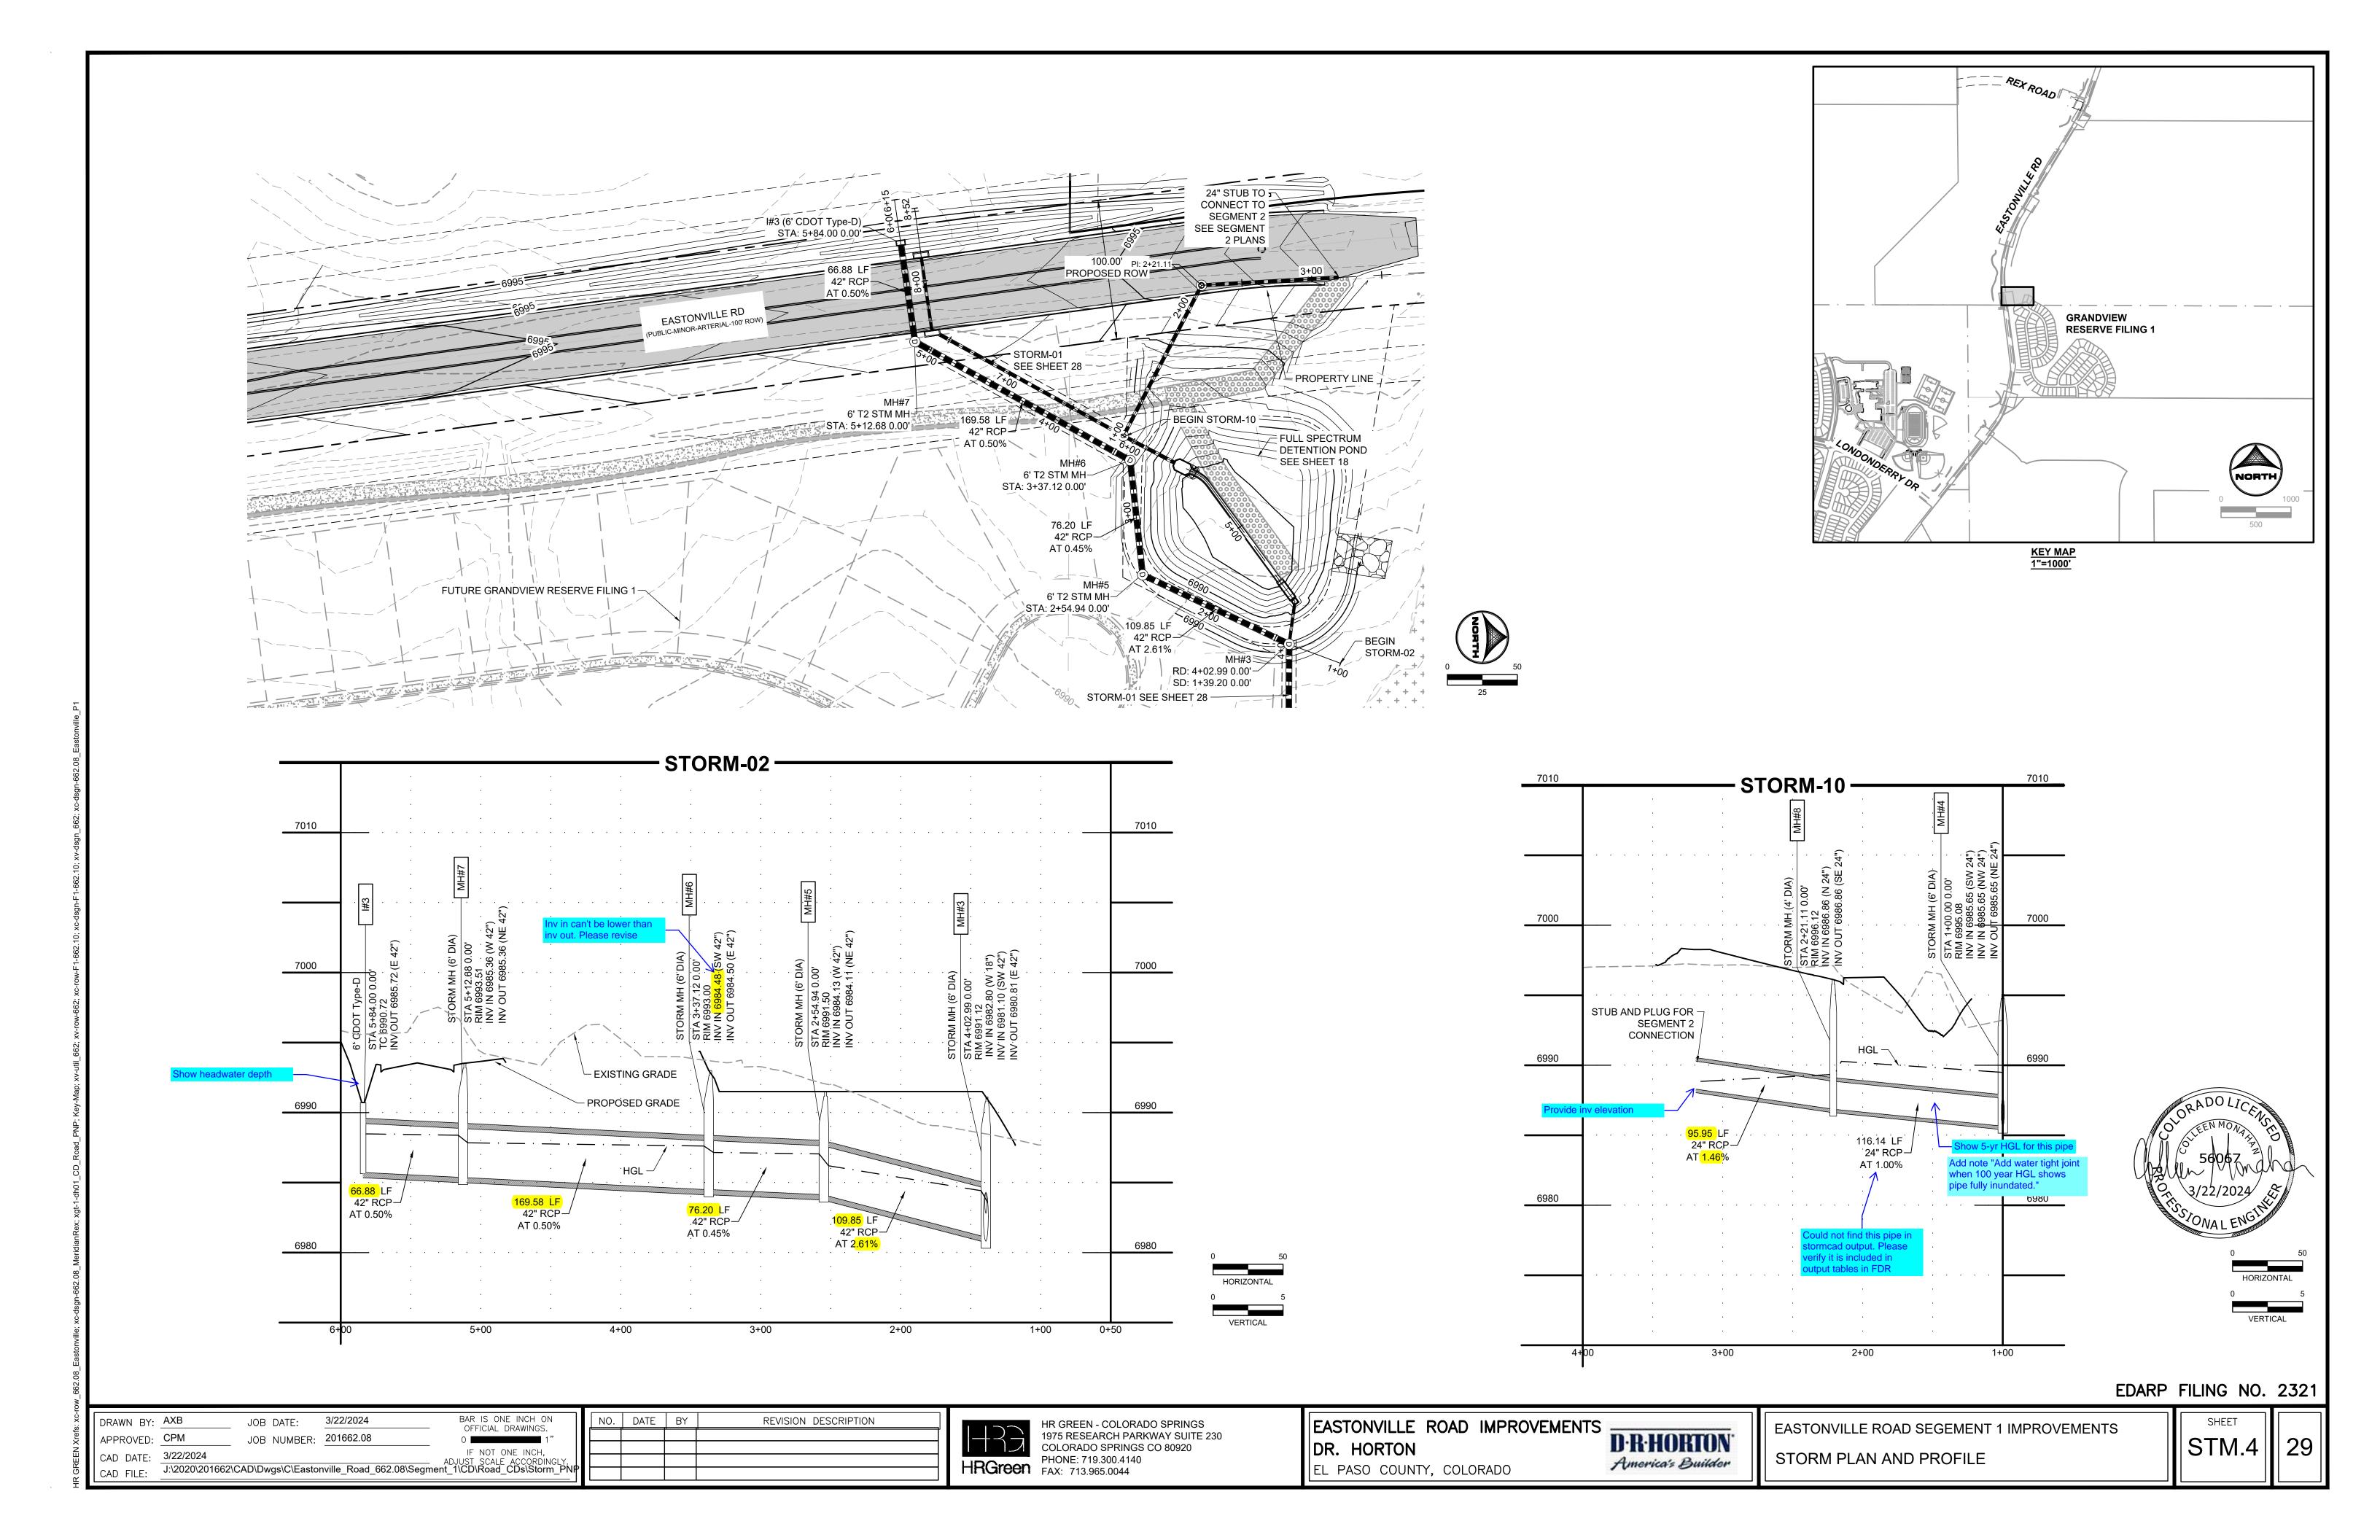


TRUNCATED DOME DETAILS

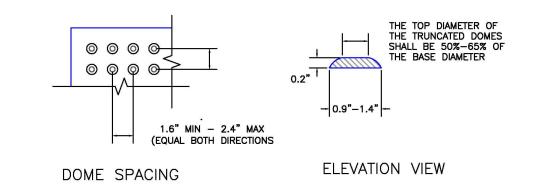

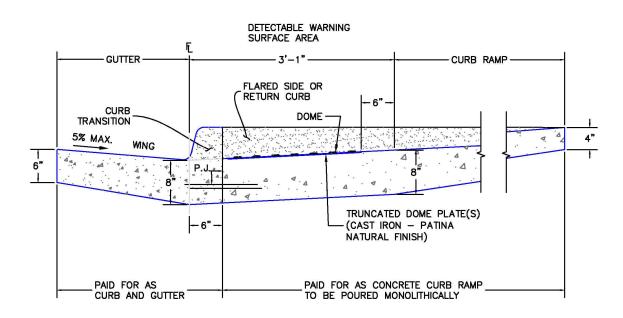


P.J.= PERMISSABLE JOINT WITH EPOXY-COATED DEFORMED NO. 4 BARS CONFORMING TO AASHTO M 284 AT 18 IN. SPACING DETECTABLE WARNING SURFACE DETAILS (SD_2-42) SCALE: NTS

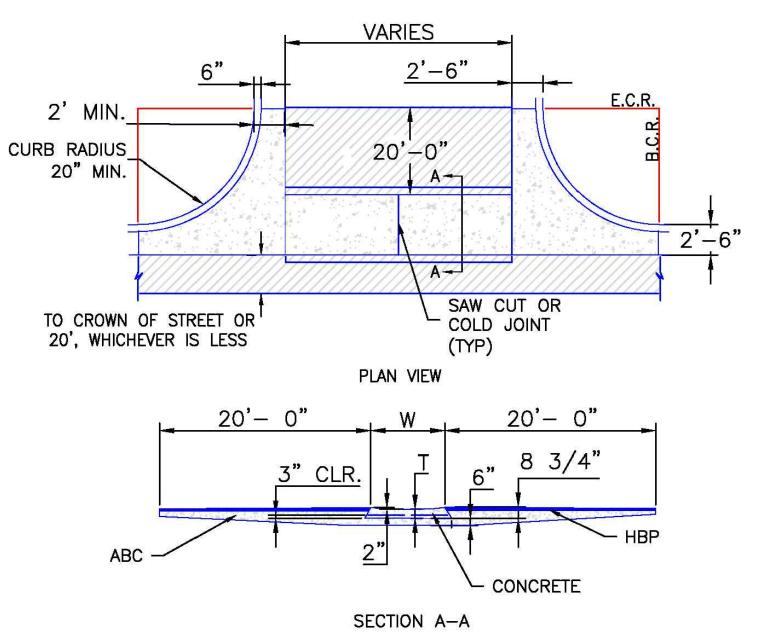


NOTES


- 1. W WIDTH SHALL BE 6' FOR LOCAL, 8' FOR COLLECTORS, AND 10' FOR ARTERIAL ROADS.
- 2. T SQUARED-OFF RETURN TO BE POURED MONOLITHICALLY, 8" PCC FOR LOCAL ROADS, 9" FOR COLLECTORS WITH 6x6 - 4.4 W.W.F. OR #4 REINFORCING BAR @ 18" EACH WAY.
- 3. _____ = 3" MINIMUM ASPHALT DEPTH (2 LIFTS).
- 4. DESIGN TO SPECIFY ELEVATIONS AT PI AND PCR. TYPICAL CROSS PAN LAYOUT DETAIL (SD_2-26) SCALE: NTS

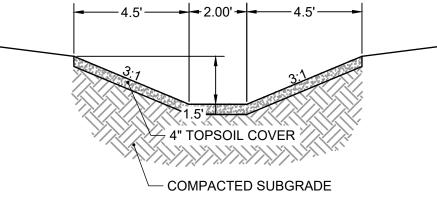


DRAINAGE SWALE 1 SCALE: NTS

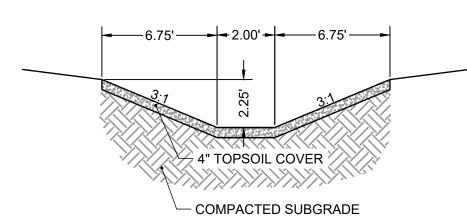

DRAINAGE SWALE 2 SCALE: NTS

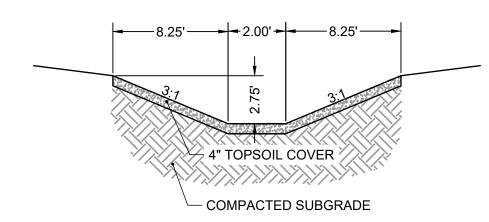

DRAINAGE SWALE 3

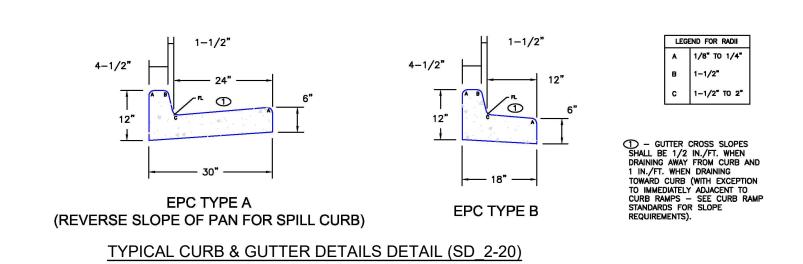

SCALE: NTS



EDARP FILING NO. 2321

BAR IS ONE INCH ON OFFICIAL DRAWINGS. NO. DATE BY REVISION DESCRIPTION JOB DATE: <u>3/6/2024</u> DRAWN BY: ACH APPROVED: CMM JOB NUMBER: <u>201662.08</u> CAD DATE: 3/22/2024 ADJUST SCALE ACCORDINGLY. CAD FILE: J:\2020\201662\CAD\Dwgs\C\Eastonville_Road_662.08\Segment_1\CD\Road_CDs\Cover_N_petalls





HR GREEN - COLORADO SPRINGS 1975 RESEARCH PARKWAY SUITE 230 COLORADO SPRINGS CO 80920 HRGreen PHONE: 719.300.4140 FAX: 713.965.0044


EASTONVILLE ROAD IMPROVEMENTS DR. HORTON EL PASO COUNTY, COLORADO


D·R·HORTON' America's Builder


EASTONVILLE ROAD SEGEMENT 1 IMPROVEMENTS

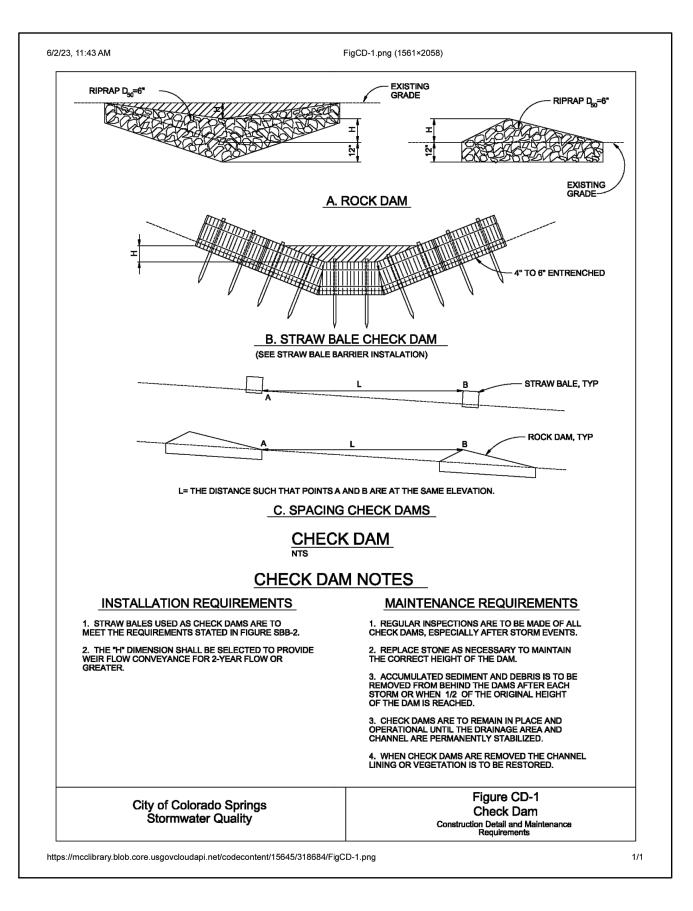


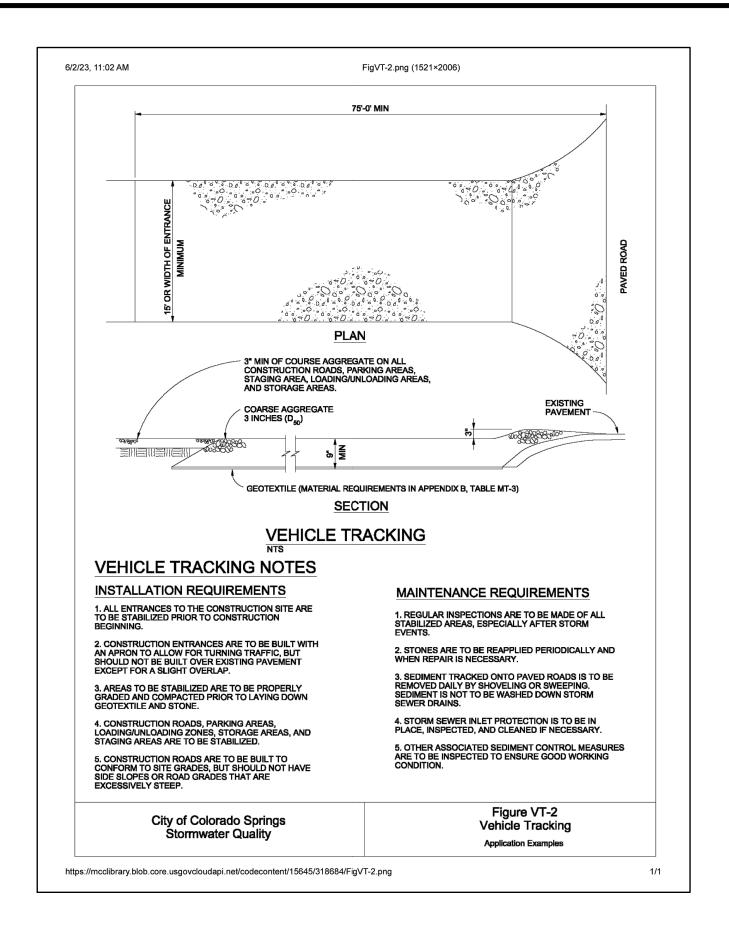


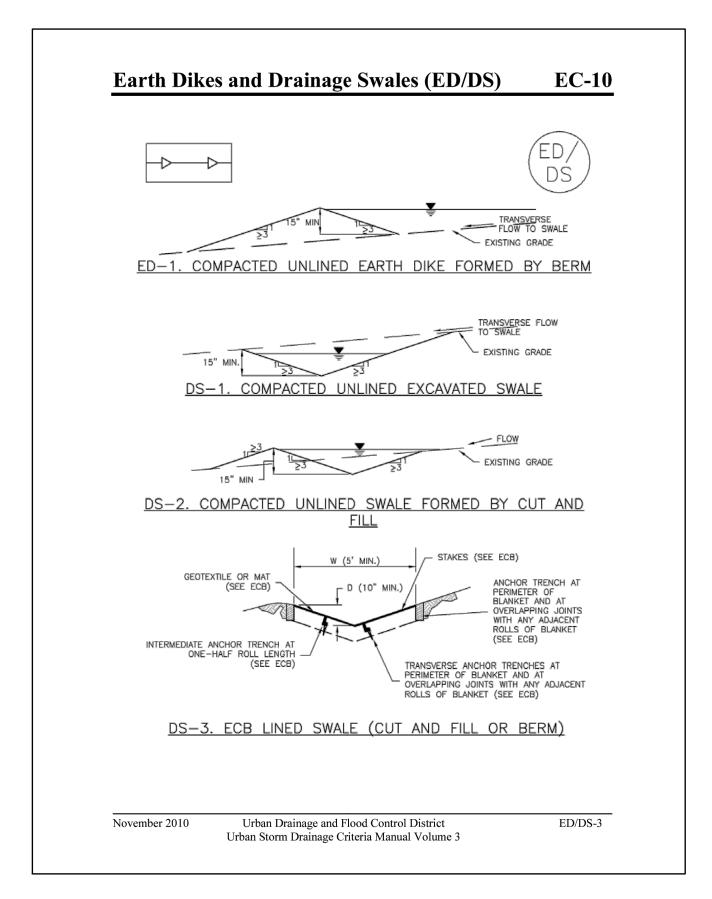


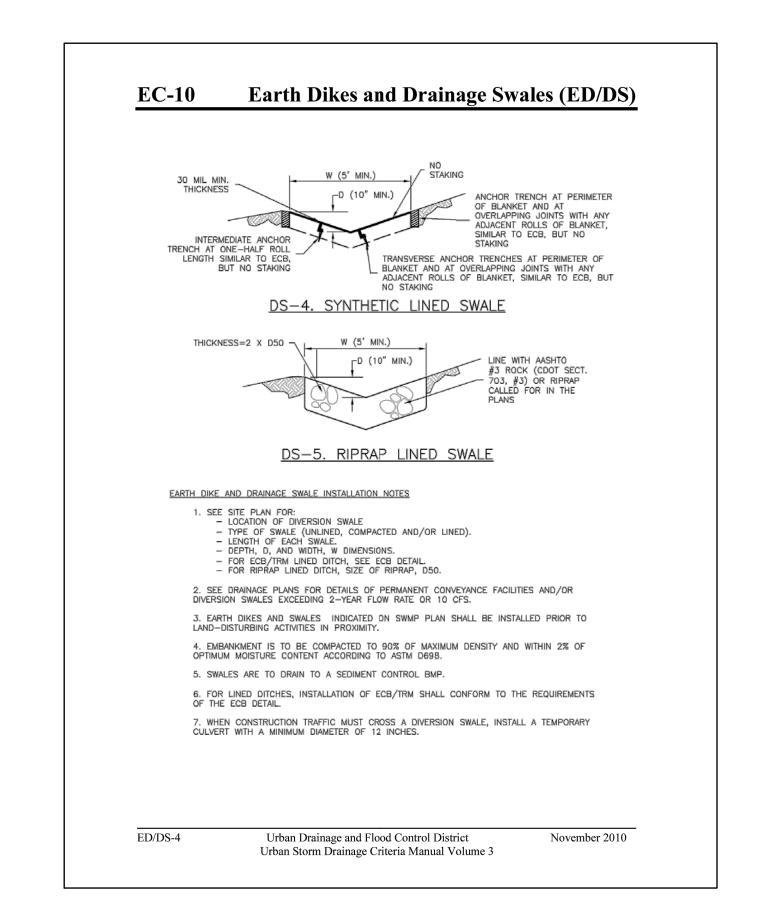

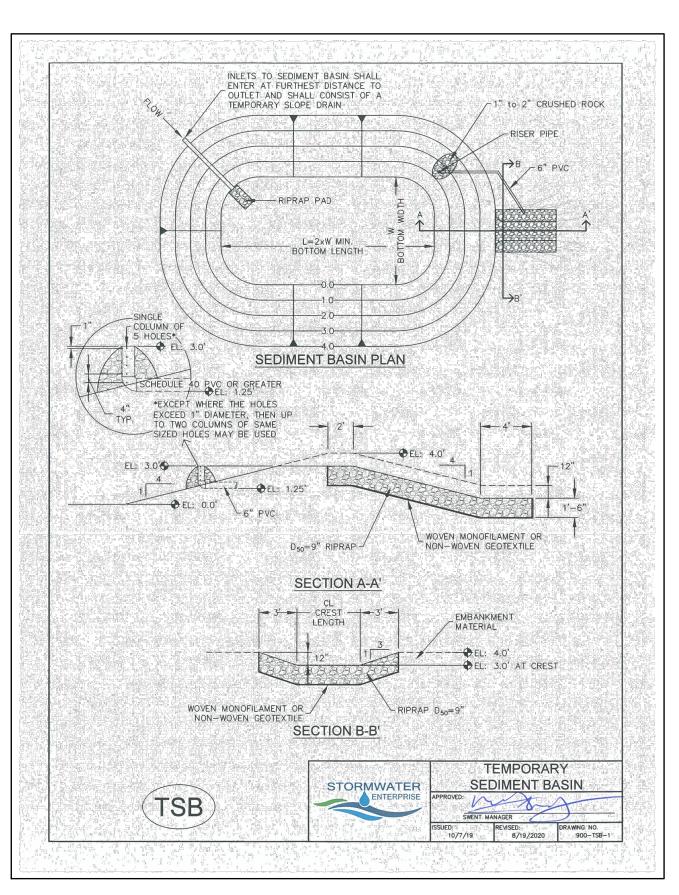

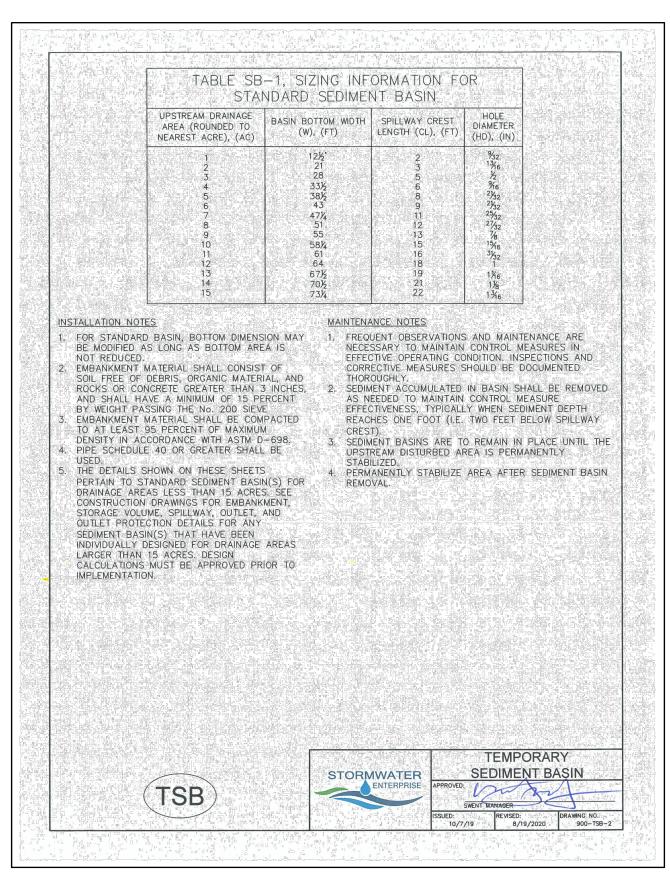

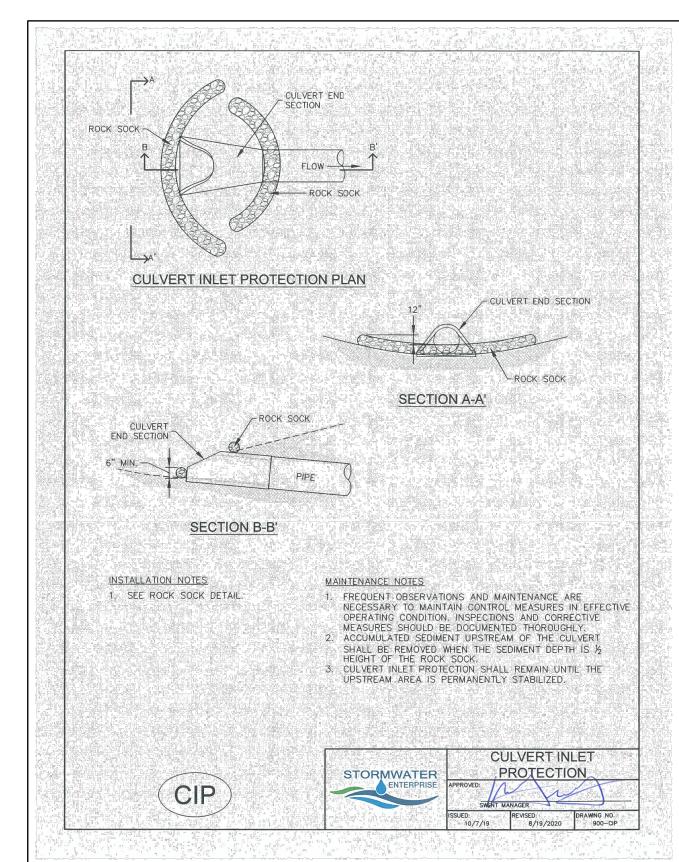

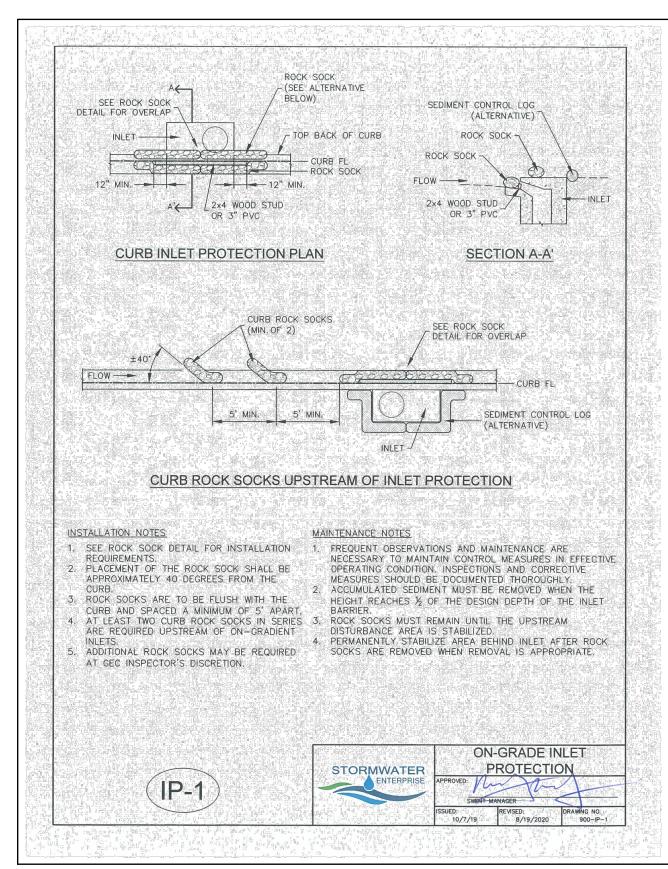

EDARP FILING NO. 2321


BAR IS ONE INCH ON DRAWN BY: ACH JOB DATE: 3/15/2024 OFFICIAL DRAWINGS. APPROVED: CPM JOB NUMBER: 201662.08 IF NOT ONE INCH, CAD DATE: 3/22/2024 ADJUST SCALE ACCORDINGLY CAD FILE: J:\2020\201662\CAD\Dwgs\C\Eastonville_Road_662.08\Segment_1\CD\GEC\GEC_details


NO. | DATE | BY REVISION DESCRIPTION


HR GREEN - COLORADO SPRINGS 1975 RESEARCH PARKWAY SUITE 230 COLORADO SPRINGS CO 80920 PHONE: 719.300.4140 HRGreen FAX: 713.965.0044


EASTONVILLE ROAD IMPROVEMENTS DR. HORTON EL PASO COUNTY, COLORADO


EASTONVILLE ROAD SEGEMENT 1 IMPROVEMENTS

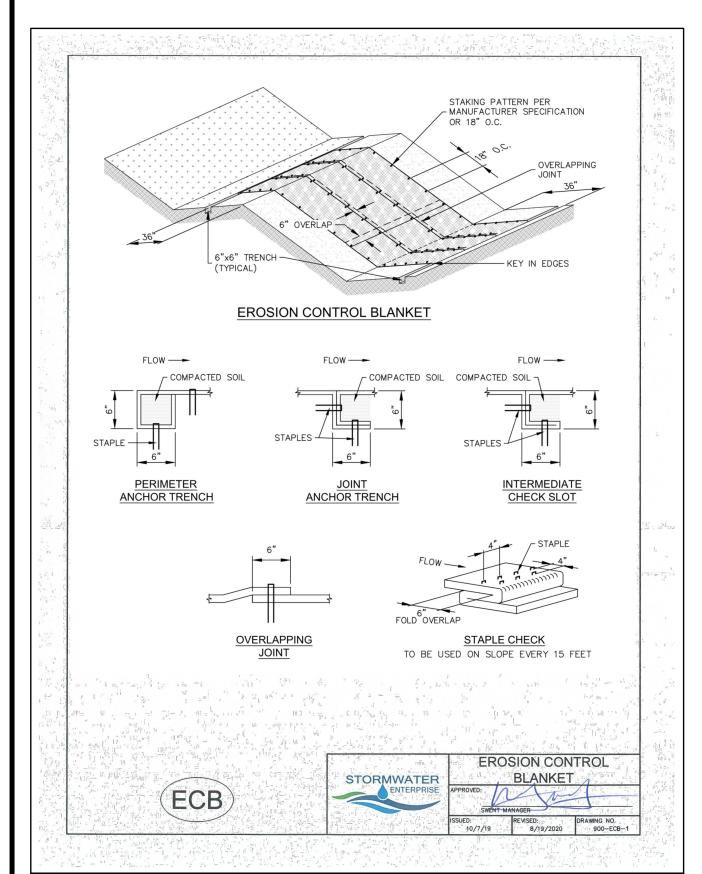


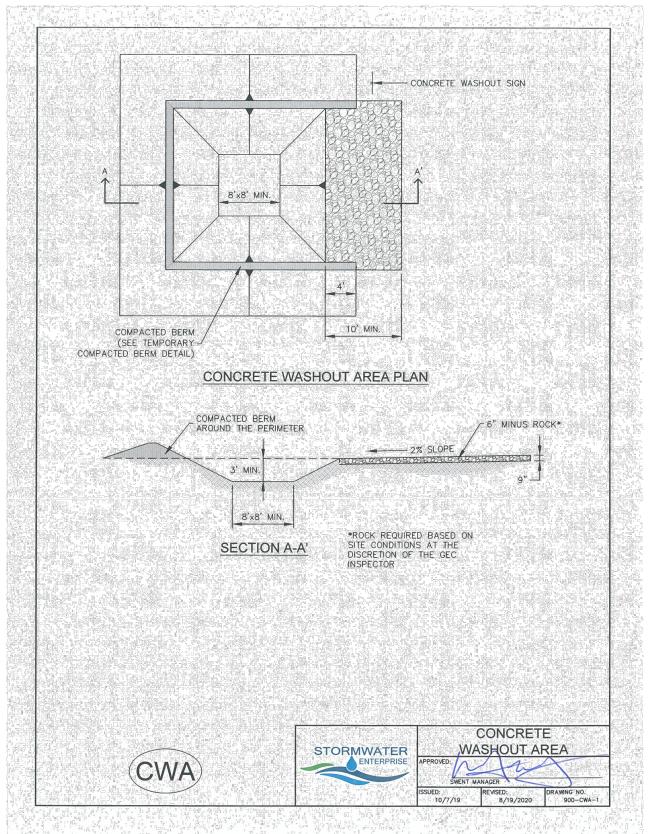


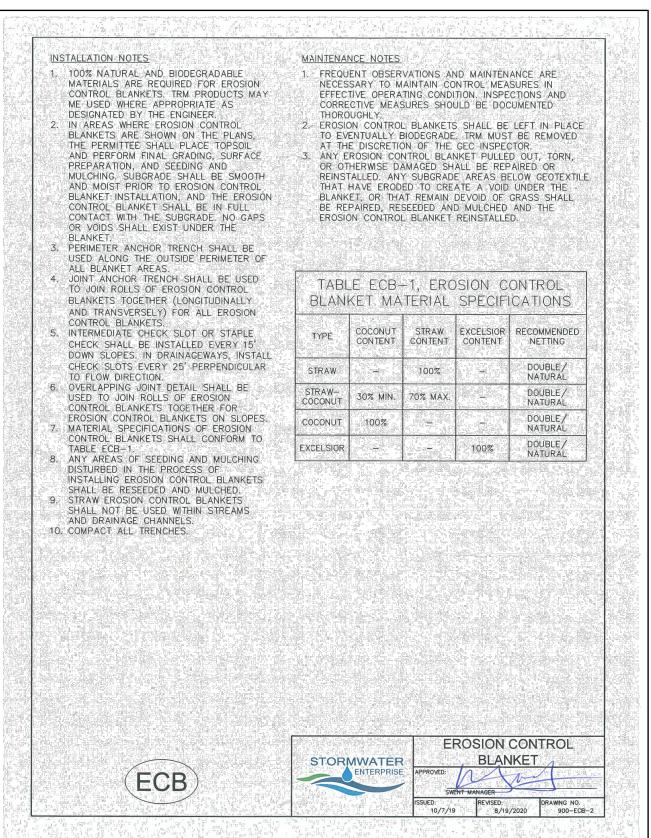


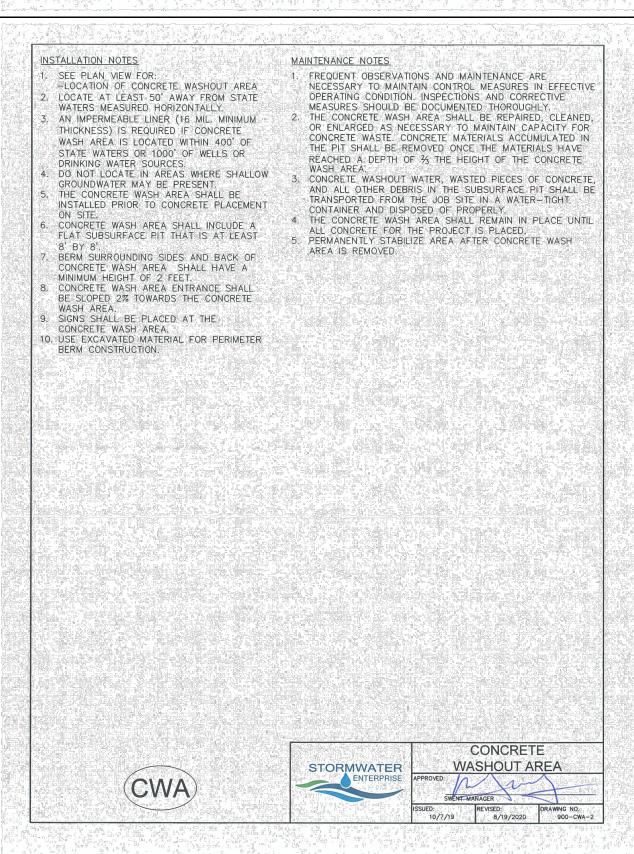

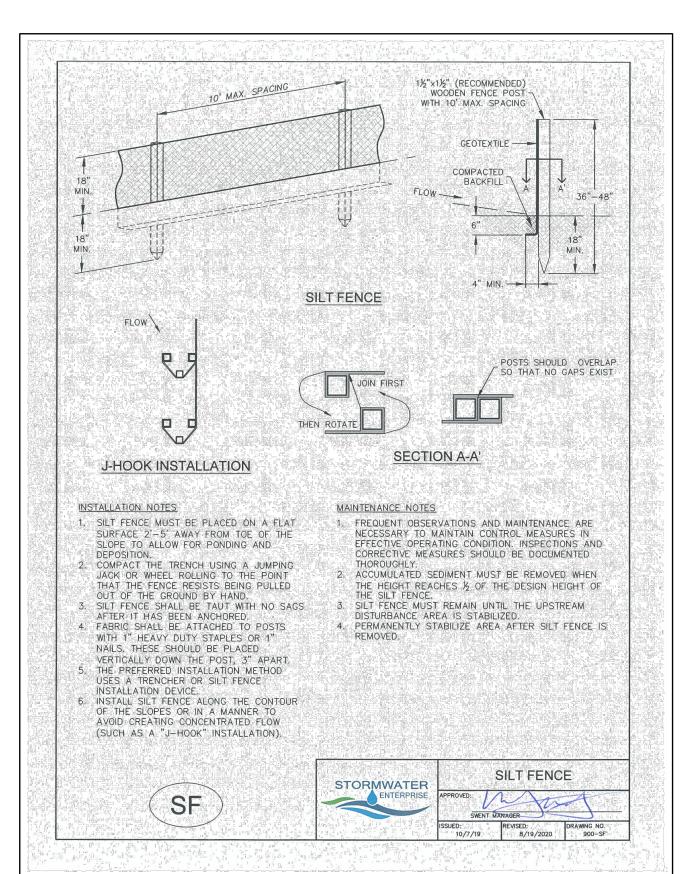

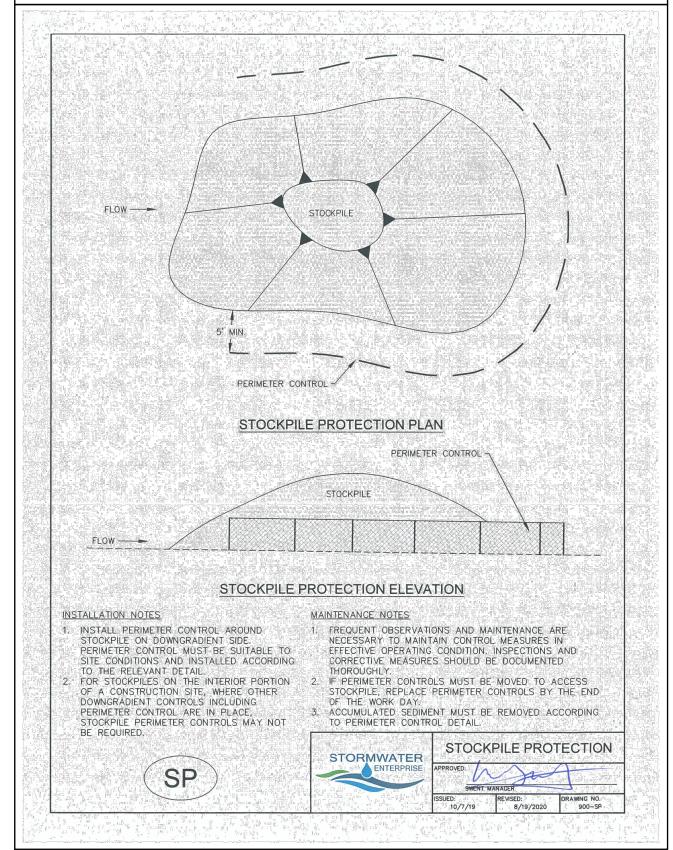

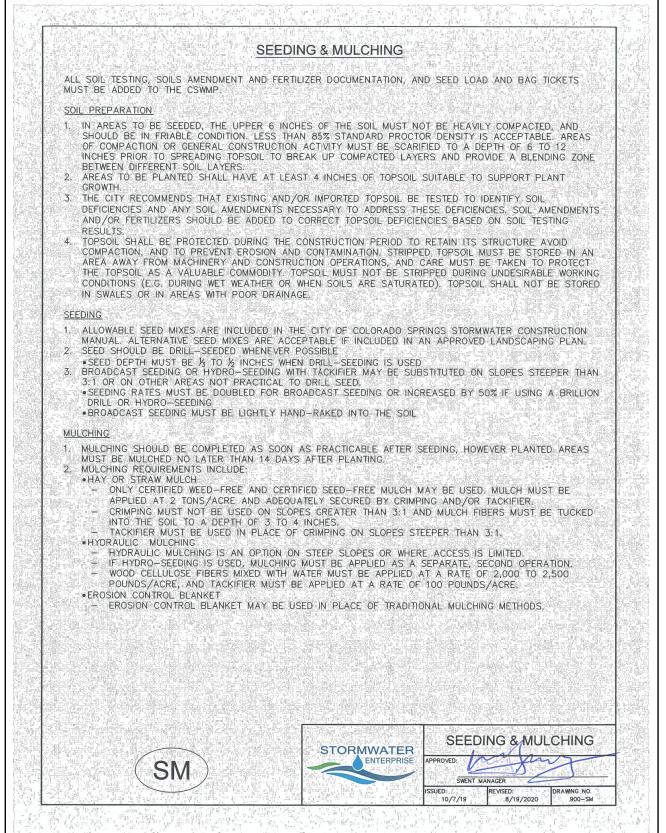

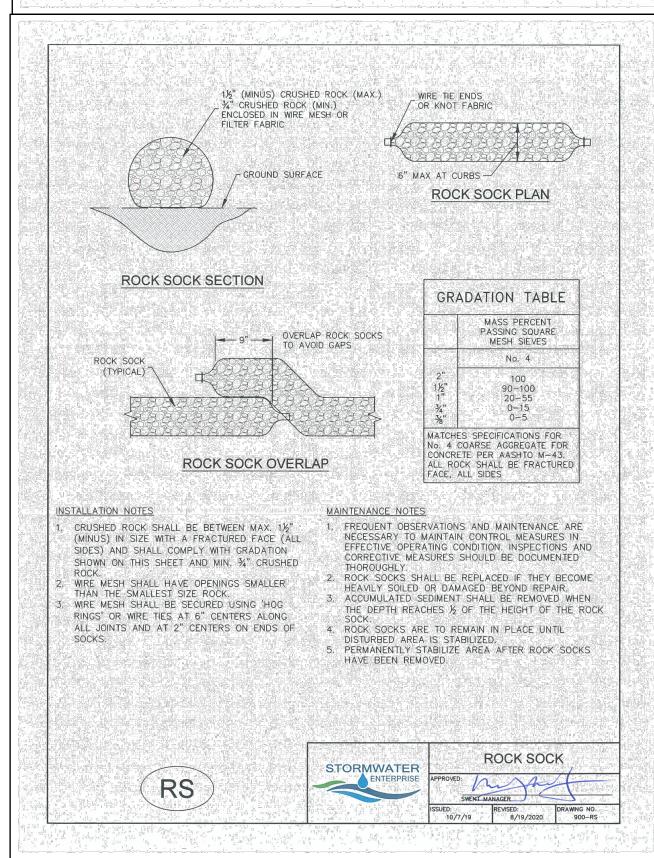

EDARP FILING NO. 2321

BAR IS ONE INCH ON DRAWN BY: ACH JOB DATE: 3/15/2024 OFFICIAL DRAWINGS. JOB NUMBER: 201662.08 APPROVED: CPM IF NOT ONE INCH, CAD DATE: 3/22/2024 ADJUST SCALE ACCORDINGLY CAD FILE: J:\2020\201662\CAD\Dwgs\C\Eastonville_Road_662.08\Segment_1\CD\GEC\GEC_details

NO. | DATE | BY REVISION DESCRIPTION

HRGreen FAX: 713.965.0044

HR GREEN - COLORADO SPRINGS 1975 RESEARCH PARKWAY SUITE 230 COLORADO SPRINGS CO 80920 PHONE: 719.300.4140

EASTONVILLE ROAD IMPROVEMENTS DR. HORTON EL PASO COUNTY, COLORADO

EASTONVILLE ROAD SEGEMENT 1 IMPROVEMENTS **DETAILS**