OWNER/DEVELOPER

MELODY HOMES INC. (D.R. HORTON) 9555 S. KINGSTON CT. SUITE 200 ENGLEWOOD, CO 80112 CONTACT: RILEY HILLEN RHILLEN@DRHORTON.COM

CIVIL ENGINEER

HR GREEN DEVELOPMENT, LLC 1975 RESEARCH PARKWAY SUITE 230 COLORADO SPRINGS, CO 80920 TELE: (719) 394-2433 CONTACT: COLLEEN MONAHAN EMAIL: CMONAHAN@HRGREEN.COM

EL PASO COUNTY - ENGINEERING REVIEW

PLANNING AND DEVELOPMENT
2880 INTERNATIONAL CIRCLE, SUITE 110
COLORADO SPRINGS, CO 80910
TELE: (719) 520-6300
CONTACT: JEFF RICE, P.E. (719) 520-6300
EMAIL: JEFFRICE@ELPASOCO.COM

TRAFFIC ENGINEERING

EL PASO COUNTY DEPARTMENT OF PUBLIC WORKS 3275 AKERS DRIVE COLORADO SPRINGS, CO 80922 TELE: CONTACT: JOSHUA PALMER EMAIL: JOSHUAPALMER@ELPASOCO.COM

APPLICANT

HR GREEN DEVELOPMENT, LLC 1975 RESEARCH PARKWAY SUITE 230 COLORADO SPRINGS, CO 80920 TELE: (719) 394-2433 CONTACT: COLLEEN MONAHAN EMAIL: CMONAHAN@HRGREEN.COM

LANDSCAPE ARCHITECT

HR GREEN DEVELOPMENT, LLC 1975 RESEARCH PARKWAY SUITE 230 COLORADO SPRINGS, CO 80920 TELE: (720) 602-4941 CONTACT: PHIL STUEPFERT EMAIL: PSTUEPFERT@HRGREEN.COM

SURVEYOR EDWARD-JAMES SURVEYING, INC.

1005 ELKTON DRIVE COLORADO SPRINGS, CO 80907 TELE: 719-576-1216

TRAFFIC ENGINEER

LSC TRANSPORTATION CONSULTANTS, INC. 545 EAST PIKES PEAK AVENUE, SUITE 210 COLORADO SPRINGS, CO 80903 TELE: (719) 633-2868 CONTACT: JEFF HODSDON EMAIL: JEFF@LSCTRANS.COM

GEOTECHNICAL ENGINEER

5170 MARK DABLING BLVD COLORADO SPRINGS, CO 80918 TELE: (719) 528-8300 CONTACT: JEFFREY M. JONES P.E.

CTL THOMPSON INC.

WATER & WASTE WATER

GRANDVIEW RESERVE METROPOLITAN DISTRICT 1272 KELLY JOHNSON BLVD SUITE100 TELE: (719) 499-8416 CONTACT: -PAUL HOWARD EMAIL: PAULINFINTY1@MSN.COM

ELECTRIC

MOUNTAIN VIEW ELECTRIC ASSOCIATION, INC. 11140 E. WOODMEN RD FALCON, CO 80831-8127 TELE: (719) 495-2283

NATURAL GAS

BLACK HILLS ENERGY
198 COUNTY LINE RD
PALMER LAKE, CO 80133
TELE: (719) 332-5856
CONTACT: BOB SWATEK

FIRE DEPARTMENT

PEYTON, CO 80831 TELE: (719) 495-4050


FALCON FIRE PROTECTION DISTRICT ADMINISTRATION
7030 OLD MERIDIAN RD

EMAIL: BOB.SWATEK@BLACKHILLSCORP.COM

EMAIL: FALCONFIRE@FALCONFIREPD.ORG

EASTONVILLE ROAD FROM LONDONDERRY DRIVE TO REX ROAD SEGMENT 1 IMPROVEMENTS STATIONING 14+55.00 - 47+00.00

LOCATED IN A PORTION OF SECTION 28, TOWNSHIP 12 SOUTH, RANGE 64 WEST OF THE 6TH PRINCIPAL MERIDIAN COUNTY OF EL PASO, STATE OF COLORADO DECEMBER 2023

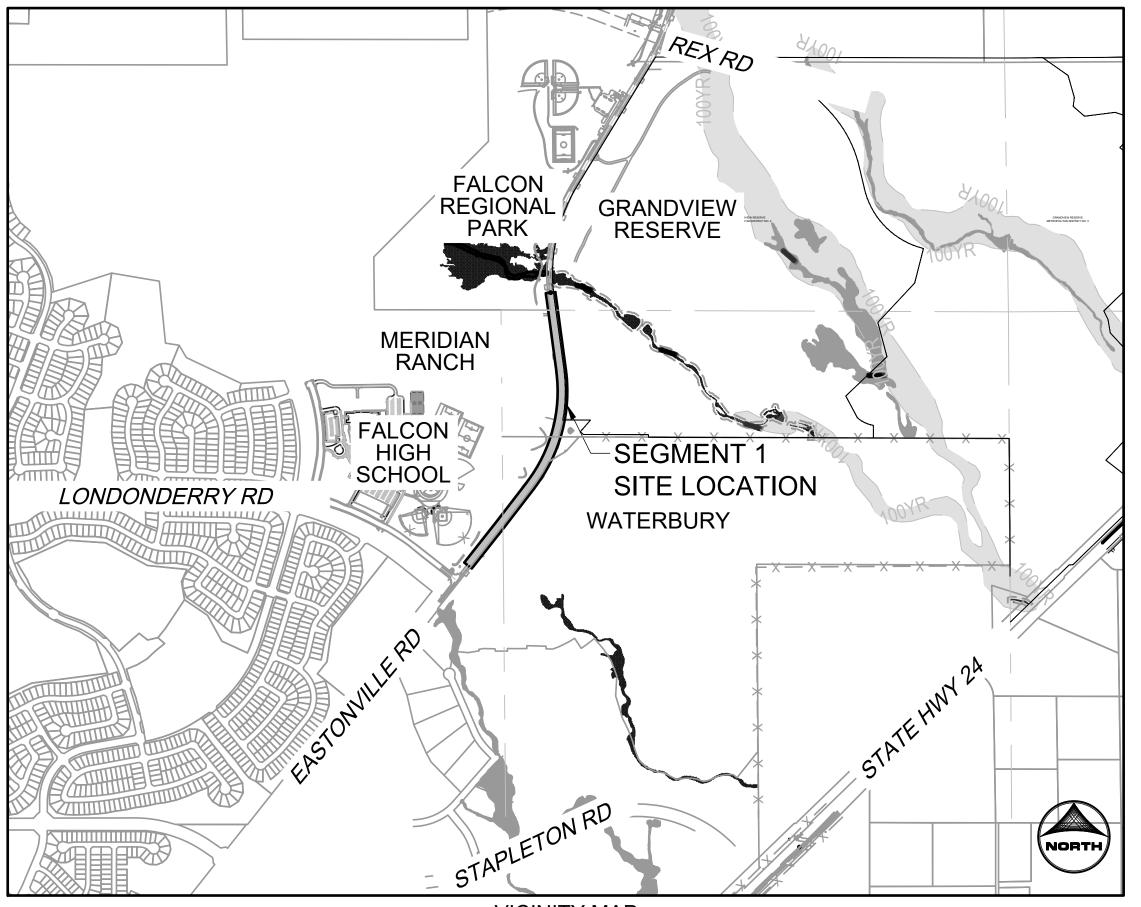

VICINITY MAP

SCALE 1" = 1000'

OVERALL INDEX								
SEGMENT 1 SHEETS 1-27								
SEGMENT 2	SHEETS 28 - XX							

		SHEET INDEX SEGMENT 1								
SHEET NUMBER	Sheet Description	SHEET TITLE								
1	CS.1	COVER								
2	GN.1	NOTES & LEGEND								
3	GN.2	TYPICAL ROAD SECTIONS								
4 - 6	DM.1 - DM.3 DEMOLITION PLAN									
7 - 10	PP.1 - PP.4	PLAN & PROFILE								
11-12	GEC.1-GEC.2	GRADING & EROSION CONTROL PLAN								
13 - 14	SS.1 - SS.2	STRIPING PLAN								
16 - 22	PD.2-PD.8	POND PLANS								
23 - 26	STM.3 - STM.4	STM.3 - STM.4 STORM PLAN & PROFILE								
27	DT.1	DETAILS								

BENCHMARK

THE BENCHMARK FOR THIS TOPOGRAPHICAL MAP IS NGS MONUMENT F24, WITH A PUBLISHED ELEVATION OF 6866.33 FEET. NAV88.

BASIS OF BEARING

THE BASIS OF BEARING IS THE NORTH LINE OF SECTION 28 TOWNSHIP 12 SOUTH, RANGE 64 WEST OF THE 6TH P.M. BEING MONUMENTED AT EACH END BY A 3-1/4" ALUMINUM CAP STAMPED "PS INC LS 30087, ASSUMED TO BEAR S89°47'04", A DISTANCE OF 5.285.07 FFFT

NOTE: CONTRACTOR SHALL PROTECT ALL EXISTING SURVEY MONUMENTATION. CONTRACTOR SHALL HAVE LICENSED SURVEYOR REPLACE ANY DAMAGED OR DISTURBED MONUMENTATION AT THEIR COST.

SURVEYOR TO OBTAIN AUTOCAD FILE FROM ENGINEER AND VERIFY ALL HORIZONTAL CONTROL DIMENSIONING PRIOR TO CONSTRUCTION STAKING. SURVEYOR MUST VERIFY ALL BENCHMARK, BASIS OF BEARING AND DATUM INFORMATION TO ENSURE IMPROVEMENTS WILL BE AT THE SAME HORIZONTAL AND VERTICAL LOCATIONS SHOWN ON THE DESIGN CONSTRUCTION DRAWINGS. PRIOR TO CONSTRUCTION STAKING ANY DISCREPANCY MUST BE REPORTED TO OWNER AND ENGINEER PRIOR TO CONTINUATION OF ANY FURTHER STAKING OR CONSTRUCTION WORK.

EL PASO COUNTY

COUNTY PLAN REVIEW IS PROVIDED ONLY FOR GENERAL CONFORMANCE WITH COUNTY DESIGN CRITERIA. THE COUNTY IS NOT RESPONSIBLE FOR THE ACCURACY AND ADEQUACY OF THE DESIGN, DIMENSIONS, AND/ OR ELEVATIONS WHICH SHALL BE CONFIRMED AT THE JOB SITE. THE COUNTY THROUGH THE APPROVAL OF THIS DOCUMENT ASSUMES NO RESPONSIBILITY FOR COMPLETENESS AND/ OR ACCURACY OF THIS DOCUMENT.

FILED IN ACCORDANCE WITH THE REQUIREMENTS OF THE EL PASO COUNTY LAND DEVELOPMENT CODE, DRAINAGE CRITERIA MANUAL, VOLUMES 1 AND 2, AND ENGINEERING CRITERIA MANUAL AS AMENDED.

IN ACCORDANCE WITH ECM SECTION 1.12, THESE CONSTRUCTION DOCUMENTS WILL BE VALID FOR CONSTRUCTION FOR A PERIOD OF 2 YEARS FROM THE DATE SIGNED BY THE EL PASO COUNTY ENGINEER. IF CONSTRUCTION HAS NOT STARTED WITHIN THOSE 2 YEARS, THE PLANS WILL NEED TO BE RESUBMITTED FOR APPROVAL, INCLUDING PAYMENT OF REVIEW FEES AT THE PLANNING AND COMMUNITY DEVELOPMENT DIRECTORS DISCRETION.

JOSHUA PALMER P.E. COUNTY ENGINEER DATE

OWNER'S STATEMENT

I, THE OWNER/DEVELOPER HAVE READ AND WILL COMPLY WITH THE REQUIREMENTS OF THE GRADING AND EROSION CONTROL PLAN.

ENGINEER'S STATEMENT

THIS GRADING AND EROSION CONTROL PLAN WAS PREPARED UNDER MY DIRECTION AND SUPERVISION AND IS CORRECT TO THE BEST OF MY KNOWLEDGE AND BELIEF. SAID PLAN HAS BEEN PREPARED ACCORDING THE CRITERIA ESTABLISHED BY THE COUNTY FOR GRADING AND EROSION CONTROL PLANS. I ACCEPT RESPONSIBILITY FOR ANY LIABILITY CAUSED BY AN NEGLIGENT ACTS, ERRORS OR OMISSIONS ON MY PART IN PREPARING THIS PLAN.

COLLEEN P. MONAHAN, COLORADO P.E. NO. 0056067 DATE

DISTRICT APPROVALS

THESE DOCUMENTS HAVE BEEN REVIEWED AND APPROVED FOR STORM DRAIN AND ASSOCIATED UTILITY SERVICE CONSTRUCTION.


FOR AND ON BEHALF OF THE GRANDVIEW RESERVE METROPOLITAN DISTRICT



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APPROVED: CMM JOB NUMBER: 201662.08 0 1" 1" IF NOT ONE INCH, ADJUST SCALE ACCORDINGLY.

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HR GREEN - COLORADO SPRINGS 1975 RESEARCH PARKWAY SUITE 230 COLORADO SPRINGS CO 80920 PHONE: 719.300.4140 EASTONVILLE ROAD IMPROVEMENTS
DR. HORTON
EL PASO COUNTY, COLORADO

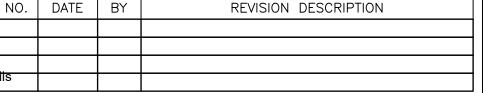

EASTONVILLE ROAD SEGEMENT 1 IMPROVEMENTS
COVER

GENERAL NOTES:

- 1. IT SHALL BE THE RESPONSIBILITY OF THE CONTRACTOR TO VERIFY THE EXISTENCE AND LOCATION OF ALL UNDERGROUND UTILITIES ALONG THE ROUTE OF THE WORK. THE OMISSION FROM OR THE INCLUSION OF UTILITY LOCATIONS ON THE PLANS IS NOT TO BE CONSIDERED AS THE NONEXISTENCE OF OR A DEFINITE LOCATION OF EXISTING UNDERGROUND UTILITIES.
- 2. THE CONTRACTOR WILL TAKE THE NECESSARY PRECAUTIONS TO PROTECT EXISTING UTILITIES FROM DAMAGE DUE TO THIS OPERATION. ANY DAMAGE TO THE UTILITIES WILL BE REPAIRED AT THE CONTRACTOR'S EXPENSE, AND ANY SERVICE DISRUPTION WILL BE SETTLED BY THE CONTRACTOR.
- 3. ADDITIONAL EROSION CONTROL STRUCTURES MAY BE REQUIRED AT THE TIME OF CONSTRUCTION
- 4. ALL BACKFILL, SUB-BASE, AND/OR BASE COURSE (CLASS 6) MATERIAL SHALL BE COMPACTED PER THE SOILS ENGINEER'S RECOMMENDATIONS AND APPROVED BY EL PASO COUNTY PCD.
- 5. ALL STATIONING IS CENTERLINE OF IMPROVEMENTS UNLESS OTHERWISE INDICATED. ALL ELEVATIONS ARE FLOW LINE UNLESS OTHERWISE INDICATED AS TOP BACK OF CURB (TBC),
- ASPHALT (ASP), OR TOP OF INLET OR BOX (TOB). 6. ALL DISTURBED PAVEMENT EDGES SHALL BE CUT TO NEAT LINES. REPAIR SHALL CONFORM TO EPC ECM APPENDIX K - 1.2C
- 7. ALL INTERSECTION ACCESSES TO BE CONSTRUCTED WITH A 25 FOOT SIGHT VISIBILITY TRIANGLES EXCEPT [VOLLMER ROAD, MARKSHEFFEL ROAD, BRAIRGATE PARKWAY] WHICH IS AN ARTERIAL AND A 50 FOOT SIGHT VISIBILITY TRIANGLE IS REQUIRED AND THERE SHALL BE NO OBSTRUCTIONS GREATER THAN 18" IN THIS AREA.
- 8. ALL CULVERTS AND STORM DRAIN PIPES SHALL BE SMOOTH INTERIOR CORRUGATED POLYETHYLENE PIPE (HDPE), REINFORCED CONCRETE PIPE (RCP). ALL CULVERTS SHALL BE PLACED COMPLETE WITH FLARED END SECTIONS. ADEQUACY OF MATERIAL THICKNESS FOR ANY CSP INSTALLED SHALL BE VERIFIED BY OWNER'S GEOTECHNICAL ENGINEER TO SUPPORT MINIMUM 50 YEAR DESIGN LIFE. CULVERTS MUST CONFORM TO EPC ECM SECTION 3.32 -CULVERTS.
- 9. ASPHALT THICKNESS AND BASE COURSE THICKNESS (COMPACTED) FOR ROADS SHALL BE PER DESIGN REPORT BY OWNER'S GEOTECHNICAL ENGINEER. OWNER'S GEOTECHNICAL ENGINEER TO BE ON SITE AT THE TIME OF ROAD CONSTRUCTION TO EVALUATE SOIL CONDITIONS AND DETERMINE IF ADDITIONAL MEASURES ARE NECESSARY TO ASSURE STABILITY OF THE NEW ROADS. PAVEMENT DESIGN SHALL BE APPROVED BY EL PASO COUNTY PLANNING AND COMMUNITY DEVELOPMENT ENGINEERING DIVISION PRIOR TO CONSTRUCTION.

SIGNING AND STRIPING NOTES:

- ALL SIGNS AND PAVEMENT MARKINGS SHALL BE IN COMPLIANCE WITH THE CURRENT MANUAL ON UNIFORM TRAFFIC CONTROL DEVICES (MUTCD).
- REMOVAL OF EXISTING PAVEMENT MARKINGS SHALL BE ACCOMPLISHED BY A METHOD THAT DOES NOT MATERIALLY DAMAGE THE PAVEMENT. THE PAVEMENT MARKINGS SHALL BE REMOVED TO THE EXTENT THAT THEY WILL NOT BE VISIBLE UNDER DAY OR NIGHT CONDITIONS.
- AT NO TIME WILL IT BE ACCEPTABLE TO PAINT OVER EXISTING PAVEMENT MARKINGS. ANY DEVIATION FROM THE STRIPING AND SIGNING PLAN SHALL BE APPROVED BY EL PASO COUNTY PCD.
- EXISTING SIGNS MAY REMAIN OR BE REUSED IF THEY MEET CURRENT EL PASO COUNTY AND MUTCD STANDARDS.
- 5. STREET NAME AND REGULATORY STOP SIGNS SHALL BE ON THE SAME POST AT
- ALL REMOVED SIGNS SHALL BE DISPOSED OF IN A PROPER MANNER BY THE CONTRACTOR.
- ALL STREET NAME SIGNS SHALL HAVE "D" SERIES LETTERS, WITH LOCAL ROADWAY SIGNS BEING 4" UPPER-LOWER CASE LETTERING ON 8" BLANK AND NON-LOCAL ROADWAY SIGNS BEING 6" LETTERING, UPPER-LOWER CASE ON 12" BLANK, WITH A WHITE BORDER THAT IS NOT RECESSED. MULTI-LANE ROADWAYS WITH SPEED LIMITS OF 40 MPH OR HIGHER SHALL HAVE 8" UPPER-LOWER CASE LETTERING ON11- 18" BLANK WITH A WHITE BORDER THAT IS NOT RECESSED. THE WIDTH OF THE NON-RECESSED WHITE BORDERS SHALL MATCH PAGE 255 OF THE 2012 MUTCD "STANDARD HIGHWAY SIGNS"
- ALL TRAFFIC SIGNS SHALL HAVE A MINIMUM HIGH INTENSITY PRISMATIC GRADE SHEETING. ALL LOCAL RESIDENTIAL STREET SIGNS SHALL BE MOUNTED ON A 1.75" X 1.75" SQUARE TUBE SIGN POST AND STUB POST BASE. FOR 13 OTHER APPLICATIONS, REFER TO THE CDOT
- STANDARD S-614-8 REGARDING USE OF THE P2 TUBULAR STEEL POST SLIPBASE DESIGN. 10. ALL SIGNS SHALL BE SINGLE SHEET ALUMINUM WITH 0.100" MINIMUM THICKNESS.
- 11. ALL LIMIT LINES/STOP LINES, CROSSWALK LINES, PAVEMENT LEGENDS, AND ARROWS SHALL BE A MINIMUM 125 MIL THICKNESS PREFORMED THERMOPLASTIC PAVEMENT MARKINGS WITH TAPERED LEADING EDGES PER CDOT STANDARD S-627-1. WORD AND SYMBOL MARKINGS SHALL BE THE NARROW TYPE. STOP BARS SHALL BE 24" IN WIDTH. CROSSWALKS LINES SHALL BE 12" WIDE AND 8' LONG PER CDOT S-627-1.
- 12. ALL LONGITUDINAL LINES SHALL BE A MINIMUM 15MIL THICKNESS EPOXY PAINT. ALL NON-LOCAL RESIDENTIAL ROADWAYS SHALL INCLUDE BOTH RIGHT AND LEFT EDGE LINE STRIPING AND ANY ADDITIONAL STRIPING AS REQUIRED BY CDOT S-627-1.
- 13. THE CONTRACTOR SHALL NOTIFY EL PASO COUNTY PLANNING AND COMMUNITY DEVELOPMENT (719) 520-6819 PRIOR TO AND UPON COMPLETION OF SIGNING AND STRIPING.
- THE CONTRACTOR SHALL OBTAIN A WORK IN THE RIGHT OF WAY PERMIT FROM THE EL PASO COUNTY DPW PRIOR TO ANY SIGNAGE OR STRIPING WORK WITHIN AN EXISTING EL PASO COUNTY ROADWAY.

STANDARD NOTES

FOR EL PASO COUNTY CONSTRUCTION PLANS:

- ALL DRAINAGE AND ROADWAY CONSTRUCTION SHALL MEET THE STANDARDS AND SPECIFICATIONS OF THE CITY OF COLORADO SPRINGS/EL PASO COUNTY DRAINAGE CRITERIA MANUAL, VOLUMES 1 AND 2, AND THE EL PASO COUNTY ENGINEERING CRITERIA MANUAL.
- CONTRACTOR SHALL BE RESPONSIBLE FOR THE NOTIFICATION AND FIELD NOTIFICATION OF ALL EXISTING UTILITIES, WHETHER SHOWN ON THE PLANS OR NOT, BEFORE BEGINNING CONSTRUCTION. LOCATION OF EXISTING UTILITIES SHALL BE VERIFIED BY THE CONTRACTOR PRIOR TO CONSTRUCTION. CALL 811 TO CONTACT THE UTILITY NOTIFICATION CENTER OF
- 3. CONTRACTOR SHALL KEEP A COPY OF THESE APPROVED PLANS, THE GRADING AND EROSION CONTROL PLAN, THE STORMWATER MANAGEMENT PLAN (SWMP), THE SOILS AND GEOTECHNICAL REPORT, AND THE APPROPRIATE DESIGN AND CONSTRUCTION STANDARDS AND SPECIFICATIONS AT THE JOB SITE AT ALL TIMES, INCLUDING THE FOLLOWING:
 - EL PASO COUNTY ENGINEERING CRITERIA MANUAL (ECM)
 - CITY OF COLORADO SPRINGS/EL PASO COUNTY DRAINAGE CRITERIA MANUAL, VOLUMES 1
 - COLORADO DEPARTMENT OF TRANSPORTATION (CDOT) STANDARD SPECIFICATIONS FOR ROAD AND BRIDGE CONSTRUCTION
- CDOT M & S STANDARDS
- 4. NOTWITHSTANDING ANYTHING DEPICTED IN THESE PLANS IN WORDS OR GRAPHIC REPRESENTATION, ALL DESIGN AND CONSTRUCTION RELATED TO ROADS, STORM DRAINAGE AND EROSION CONTROL SHALL CONFORM TO THE STANDARDS AND REQUIREMENTS OF THE MOST RECENT VERSION OF THE RELEVANT ADOPTED EL PASO COUNTY STANDARDS, INCLUDING THE LAND DEVELOPMENT CODE, THE ENGINEERING CRITERIA MANUAL, THE DRAINAGE CRITERIA MANUAL, AND THE DRAINAGE CRITERIA MANUAL VOLUME 2. ANY DEVIATIONS FROM REGULATIONS AND STANDARDS MUST BE REQUESTED, AND APPROVED, IN WRITING. ANY MODIFICATIONS NECESSARY TO MEET CRITERIA AFTER-THE-FACT WILL BE ENTIRELY THE DEVELOPER'S RESPONSIBILITY TO RECTIFY.
- 5. IT IS THE DESIGN ENGINEER'S RESPONSIBILITY TO ACCURATELY SHOW EXISTING CONDITIONS, BOTH ONSITE AND OFFSITE, ON THE CONSTRUCTION PLANS. ANY MODIFICATIONS NECESSARY DUE TO CONFLICTS, OMISSIONS, OR CHANGED CONDITIONS WILL BE ENTIRELY THE DEVELOPER'S RESPONSIBILITY TO RECTIFY.
- CONTRACTOR SHALL SCHEDULE A PRE-CONSTRUCTION MEETING WITH EL PASO COUNTY PCD INSPECTIONS, PRIOR TO STARTING CONSTRUCTION.
- IT IS THE CONTRACTOR'S RESPONSIBILITY TO UNDERSTAND THE REQUIREMENTS OF ALL JURISDICTIONAL AGENCIES AND TO OBTAIN ALL REQUIRED PERMITS, INCLUDING BUT NOT LIMITED TO EL PASO COUNTY EROSION AND STORMWATER QUALITY CONTROL PERMIT (ESQCP), REGIONAL BUILDING FLOODPLAIN DEVELOPMENT PERMIT, U.S. ARMY CORPS OF ENGINEERS-ISSUED 401 AND/OR 404 PERMITS, AND COUNTY AND STATE FUGITIVE DUST PERMITS.
- 8. CONTRACTOR SHALL NOT DEVIATE FROM THE PLANS WITHOUT FIRST OBTAINING WRITTEN APPROVAL FROM THE DESIGN ENGINEER AND PCD. CONTRACTOR SHALL NOTIFY THE DESIGN ENGINEER IMMEDIATELY UPON DISCOVERY OF ANY ERRORS OR INCONSISTENCIES.
- ALL STORM DRAIN PIPE SHALL BE CLASS III RCP UNLESS OTHERWISE NOTED AND APPROVED BY
- 10. CONTRACTOR SHALL COORDINATE GEOTECHNICAL TESTING PER ECM STANDARDS. PAVEMENT DESIGN SHALL BE APPROVED BY EL PASO COUNTY PCD PRIOR TO PLACEMENT OF CURB AND GUTTER AND PAVEMENT.
- 11. ALL CONSTRUCTION TRAFFIC MUST ENTER/EXIT THE SITE AT APPROVED CONSTRUCTION ACCESS
- 12. SIGHT VISIBILITY TRIANGLES AS IDENTIFIED IN THE PLANS SHALL BE PROVIDED AT ALL INTERSECTIONS. OBSTRUCTIONS GREATER THAN 18 INCHES ABOVE FLOWLINE ARE NOT ALLOWED WITHIN SIGHT TRIANGLES.
- 13. SIGNING AND STRIPING SHALL COMPLY WITH EL PASO COUNTY PCD AND MUTCD CRITERIA. [IF APPLICABLE, ADDITIONAL SIGNING AND STRIPING NOTES WILL BE PROVIDED.]
- 14. CONTRACTOR SHALL OBTAIN ANY PERMITS REQUIRED BY EL PASO COUNTY PCD, INCLUDING WORK WITHIN THE RIGHT-OF-WAY AND SPECIAL TRANSPORT PERMITS.
- 15. THE LIMITS OF CONSTRUCTION SHALL REMAIN WITHIN THE PROPERTY LINE UNLESS OTHERWISE NOTED. THE OWNER/DEVELOPER SHALL OBTAIN WRITTEN PERMISSION AND EASEMENTS, WHERE REQUIRED, FROM ADJOINING PROPERTY OWNER(S) PRIOR TO ANY OFF-SITE DISTURBANCE, GRADING, OR CONSTRUCTION

LEGEND

	EXISTING	PROPOSED
MATCH LINE		
PHASE LINE		
SECTION LINE		
PROPERTY BOUNDARY	/	
PROPERTY LINE		
EASEMENT LINE		
RIGHT OF WAY		
CENTERLINE		
CHAIN LINK FENCE		
WOODEN FENCE	—— H —— H —— H ——	—— H ——— H ———— H ————————————————————
SPLIT RAIL FENCE		
GUARDRAIL	·	· —
CABLE TV	TV	TV
U.G. ELECTRIC	— — — UE—	— — — UE—
OVERHEAD ELECTRIC	OE	———— OE ————
FIBER OPTIC	— — — FO—	— — FO—
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CURB & GUTTER		
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100-YR FLOODPLAIN		
FLOODWAY		
TRAIL		
PARK		\ \ \ \ \ \ \ \ \ \ \ \ \ \ \ \ \ \ \
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EXISTING

PROPOSED

CLEAN OUT MANHOLE PLUG	©
WATER FIRE HYDRANT FIRE DEPT. CONNECTION GATE VALVE MANHOLE METER TEE REDUCER	
DRY UTILITIES ELECTRIC METER ELECTRIC PEDESTAL ELECTRICAL CABINET ELECTRIC VAULT FIBER OPTIC PULL BOX FIBER OPTIC MANHOLE FIBER OPTIC PEDESTAL FIBER OPTIC SIGN FIBER OPTIC VAULT	
GAS METER GAS SIGN GAS VAULT TELEPHONE CABINET TELEPHONE MANHOLE TELEPHONE SIGNAL/MAST	

TELEPHONE SIGN

TRANSFORMER

FIBER OPTIC VAULT

LIGHT POLE

TELEPHONE PEDESTAL

STORM SEWER

FLARED END SECTION

SANITARY SEWER

MANHOLE

STORM INLET

EXISTING

PROPOSED

PROC

MISCELLANEOUS

ACCESSIBLE PARKING

SIGN

 \boxtimes

FVL

BOLLLARD

LIST OF ABBREVIATIONS

Δ - DEFLECTION ANGLE

CB - CHORD BEARING

S - SOUTH

EX - EXISTING W/ - WITH

PC - POINT OF CURVATURE/PORTLAND CEMENT

VERT - VERTICAL

FDC - FIRE DEPARTMENT CONNECTION

DR - DRIVE

Ø, DIA - DIAMETER

MIN - MINIMUM

HDPE - HIGH DENSITY POLYETHYLENE

L - LENGTH R - RADIUS

C - CHORD LENGTH

N - NORTH/NORTHING W - WEST

E - EAST/EASTING

DET - DETAIL

WWF - WELDED WIRE FABRIC

OC - ON CENTER

CT - COURT

TYP - TYPICAL **REC - RECEPTION NUMBER**

PT - POINT OF TANGENCY

MAX - MAXIMUM

Know what's below. Call before you dig.

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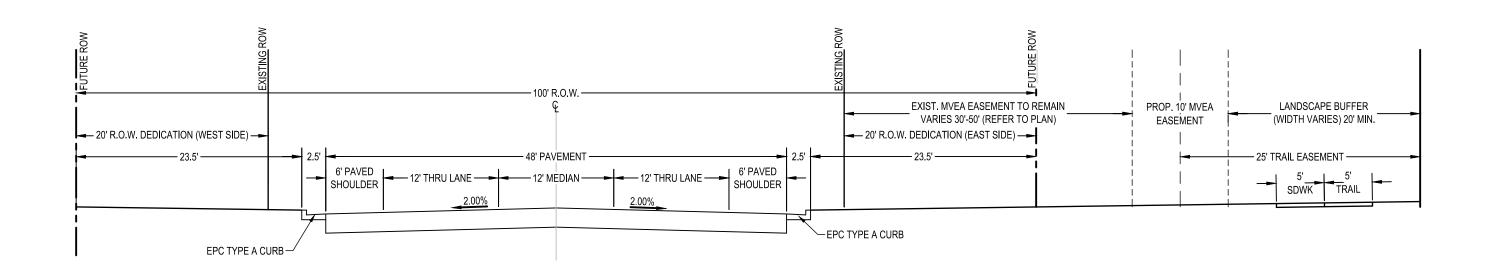


HR GREEN - COLORADO SPRINGS 1975 RESEARCH PARKWAY SUITE 230 COLORADO SPRINGS CO 80920 PHONE: 719.300.4140 HRGreen FAX: 713.965.0044


EL PASO COUNTY, COLORADO



EASTONVILLE ROAD SEGEMENT 1 IMPROVEMENTS **NOTES & LEGEND**





EASTONVILLE RD ULTIMATE CROSS SECTION (MODIFIED MINOR ARTERIAL)

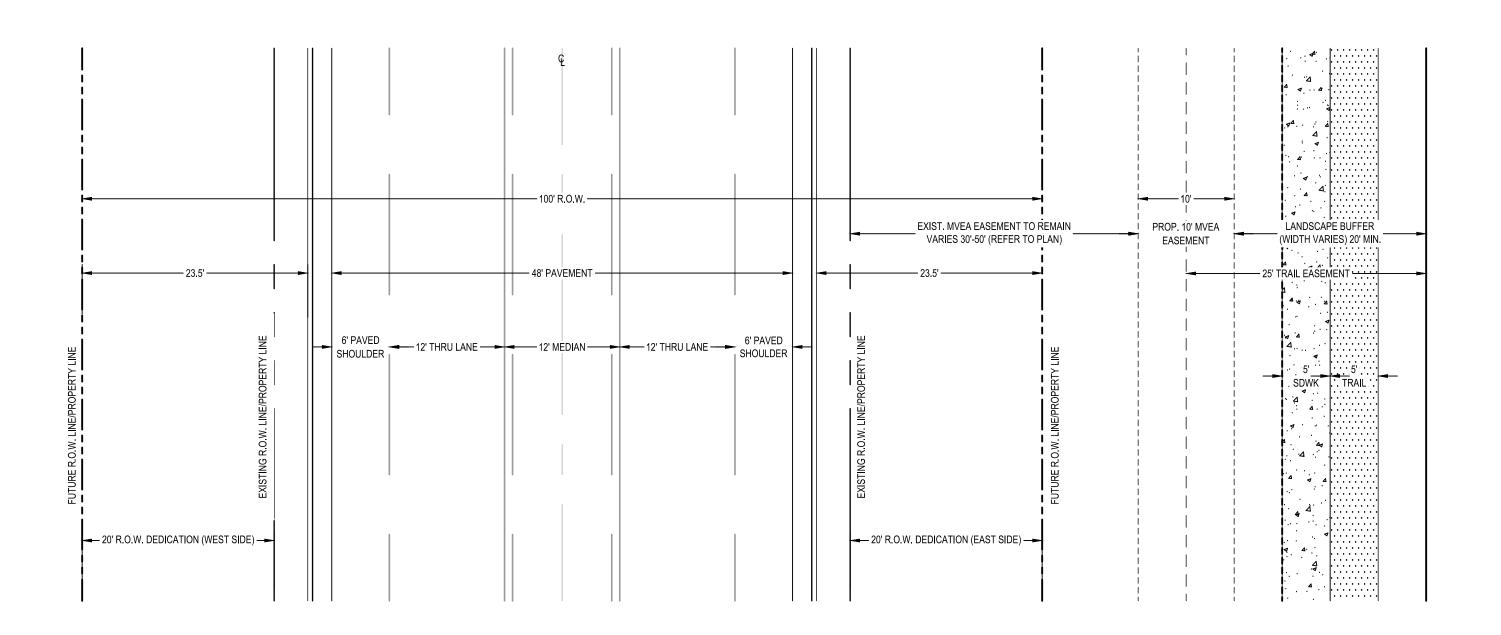


EASTONVILLE RD ULTIMATE CROSS SECTION (MODIFIED MINOR ARTERIAL)

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LEGEND: TEMPORARY PAVEMENT TO BE REMOVED FENCE LINE TO BE REMOVED -__\ ELECTRIC LINE TO BE UNDERGROUNDED PROPOSED ROW

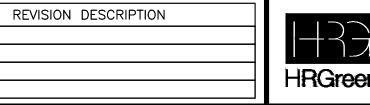
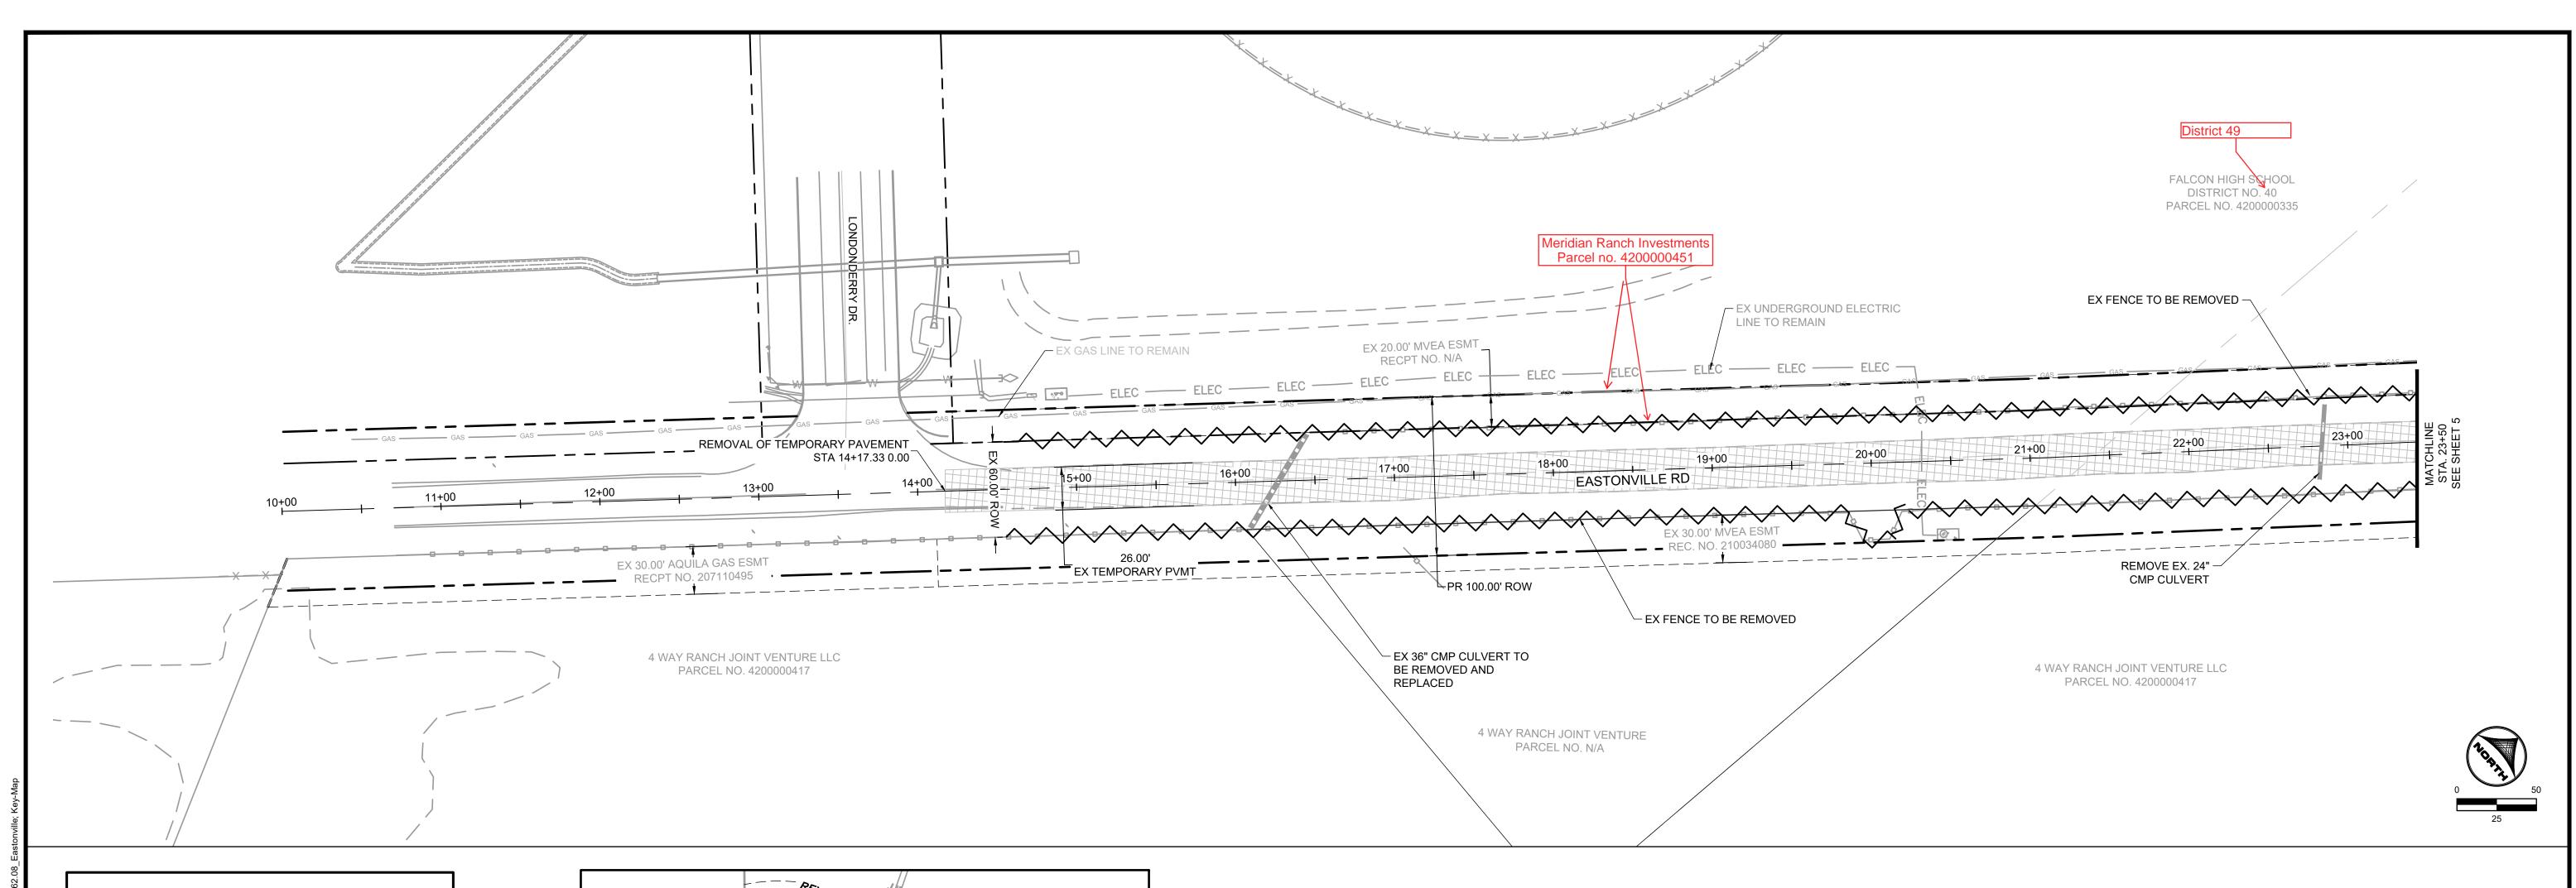
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HR GREEN - COLORADO SPRINGS
1975 RESEARCH PARKWAY SUITE 230
COLORADO SPRINGS CO 80920
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FAX: 713.965.0044


EASTONVILLE ROAD IMPROVEMENTS

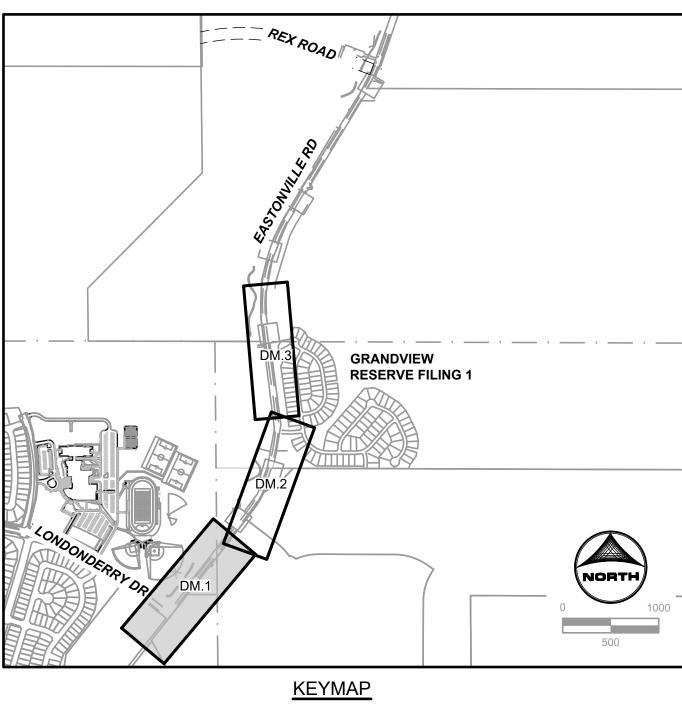D'R'HORTON


America's Builder

EASTONVILLE ROAD SEGEMENT 1 IMPROVEMENTS DEMOLITION PLAN

DM.1

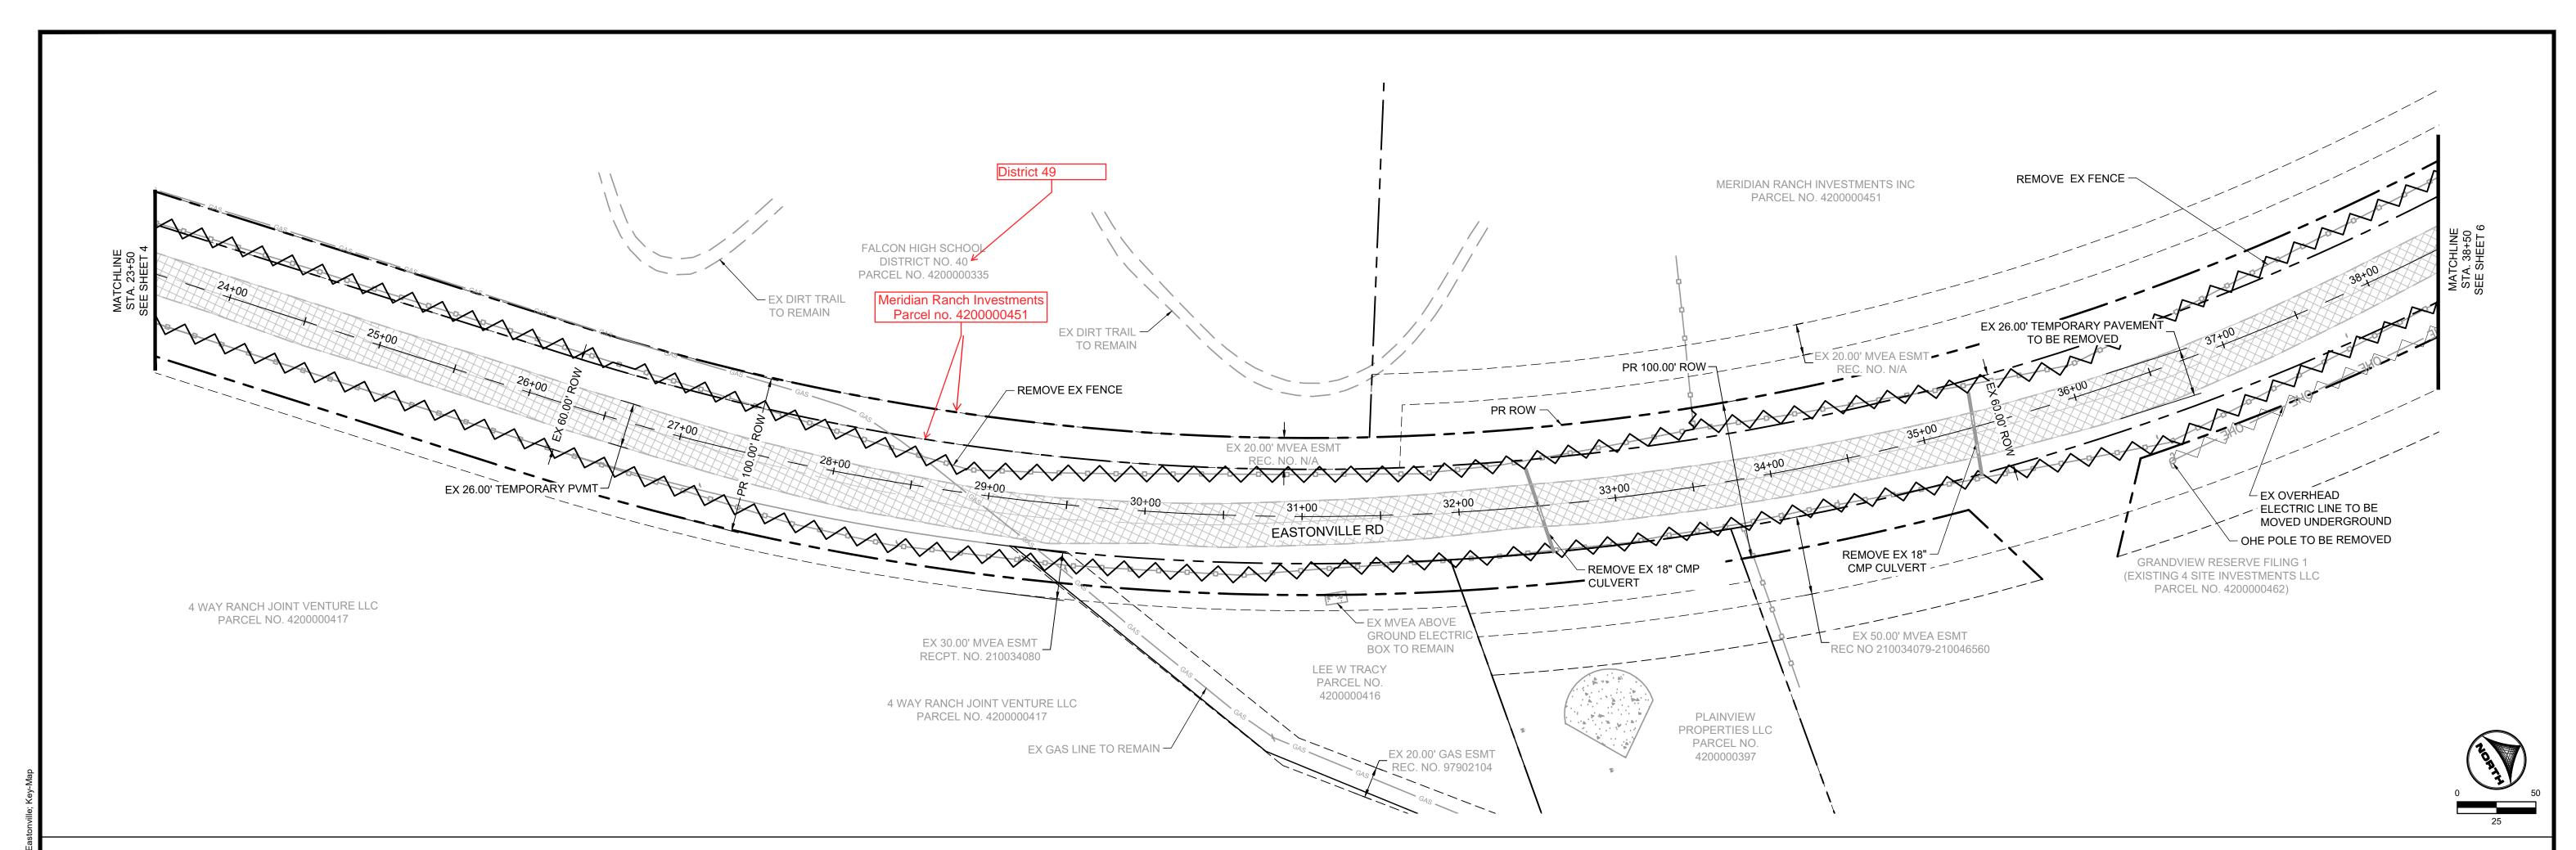

LEGEND: TEMPORARY PAVEMENT TO BE REMOVED FENCE LINE TO BE REMOVED -\\\\\\ ELECTRIC LINE TO BE UNDERGROUNDED

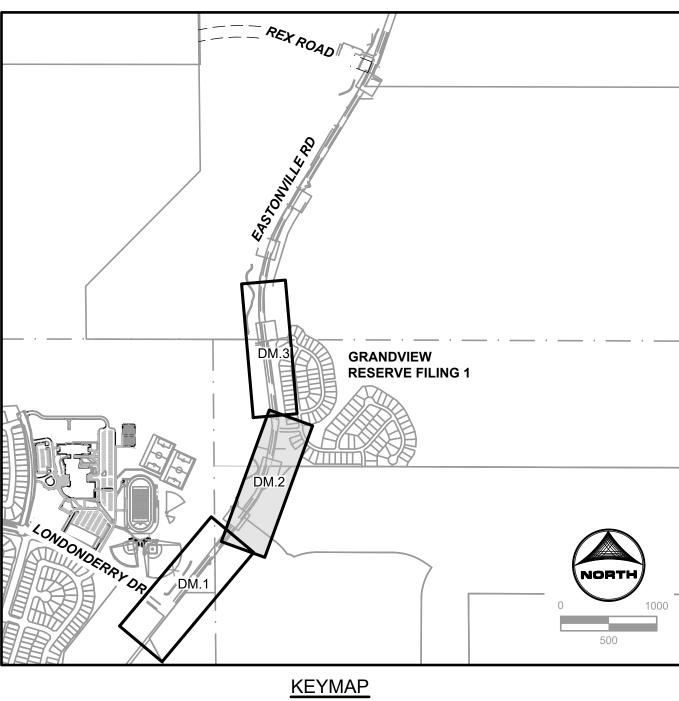

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HR GREEN - COLORADO SPRINGS
1975 RESEARCH PARKWAY SUITE 230
COLORADO SPRINGS CO 80920
PHONE: 719.300.4140
FAX: 713.965.0044


EASTONVILLE ROAD IMPROVEMENTS

D'R'HORTON


America's Builder

EASTONVILLE ROAD SEGEMENT 1 IMPROVEMENTS **DEMOLITION PLAN**

DM.2

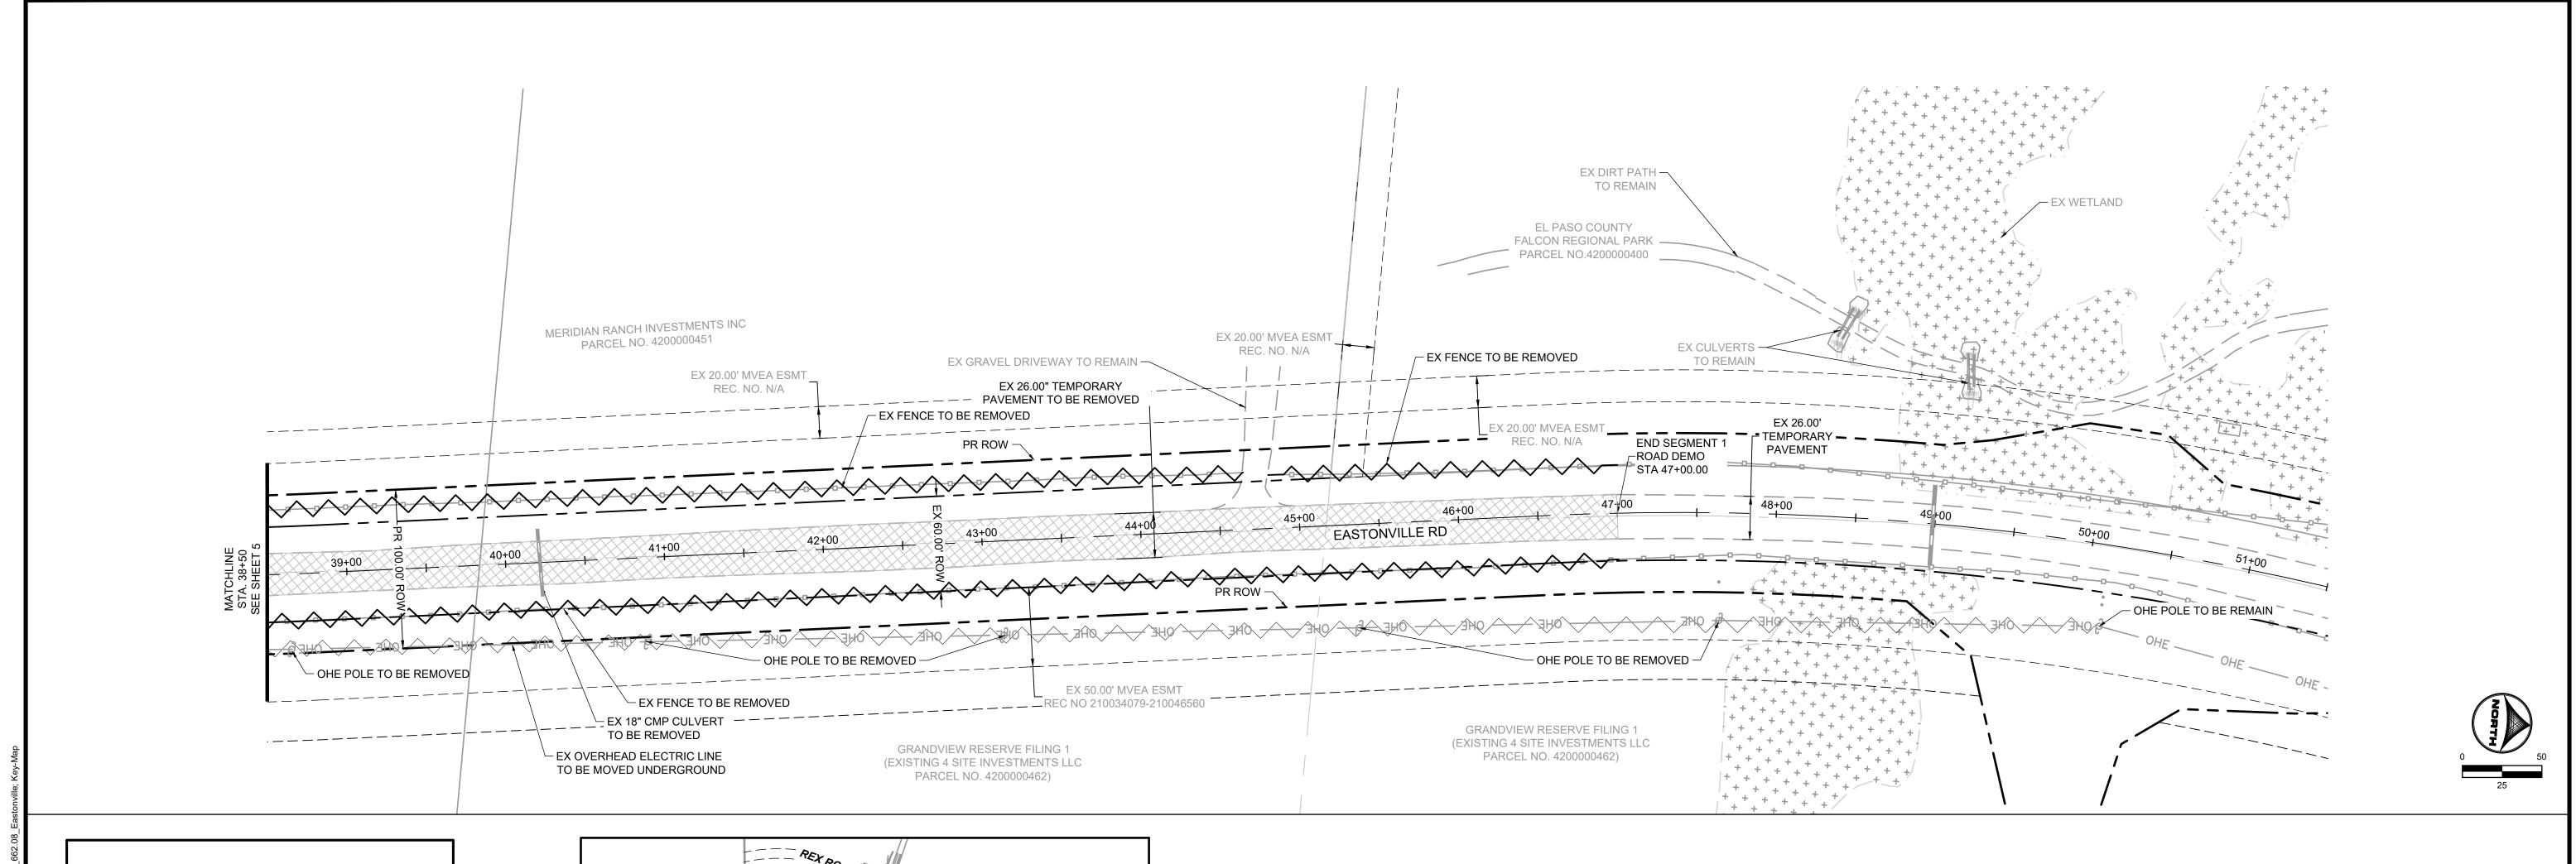

LEGEND: TEMPORARY PAVEMENT TO BE REMOVED -__\ ELECTRIC LINE TO BE UNDERGROUNDED PROPOSED ROW

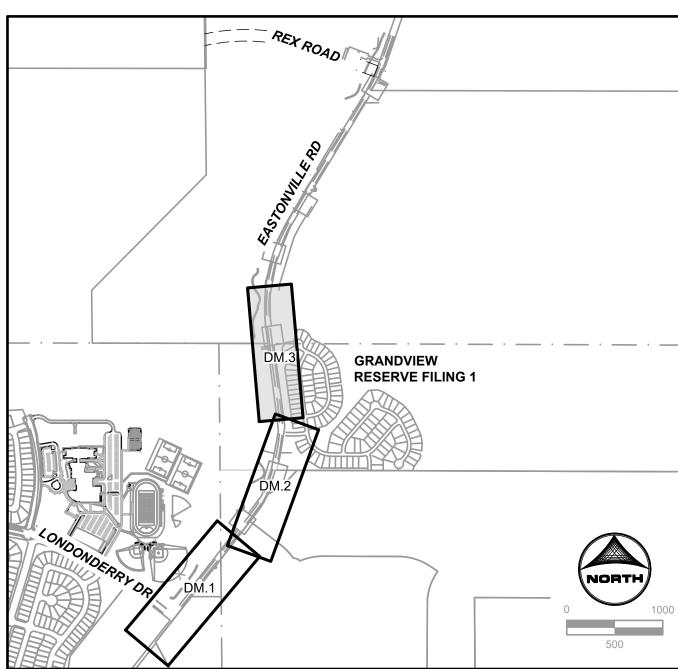

<u>KEYMAP</u>

BAR IS ONE INCH ON OFFICIAL DRAWINGS. NO. DATE BY JOB DATE: <u>1/9/2024</u> REVISION DESCRIPTION DRAWN BY: ACH APPROVED: CPM JOB NUMBER: 201662.08 CAD DATE: 1/12/2024 CAD FILE: J:\2020\201662\CAD\Dwgs\C\Eastonville_Road_662.08\Segment_1\CD\Road_CDs\Demo_Plan



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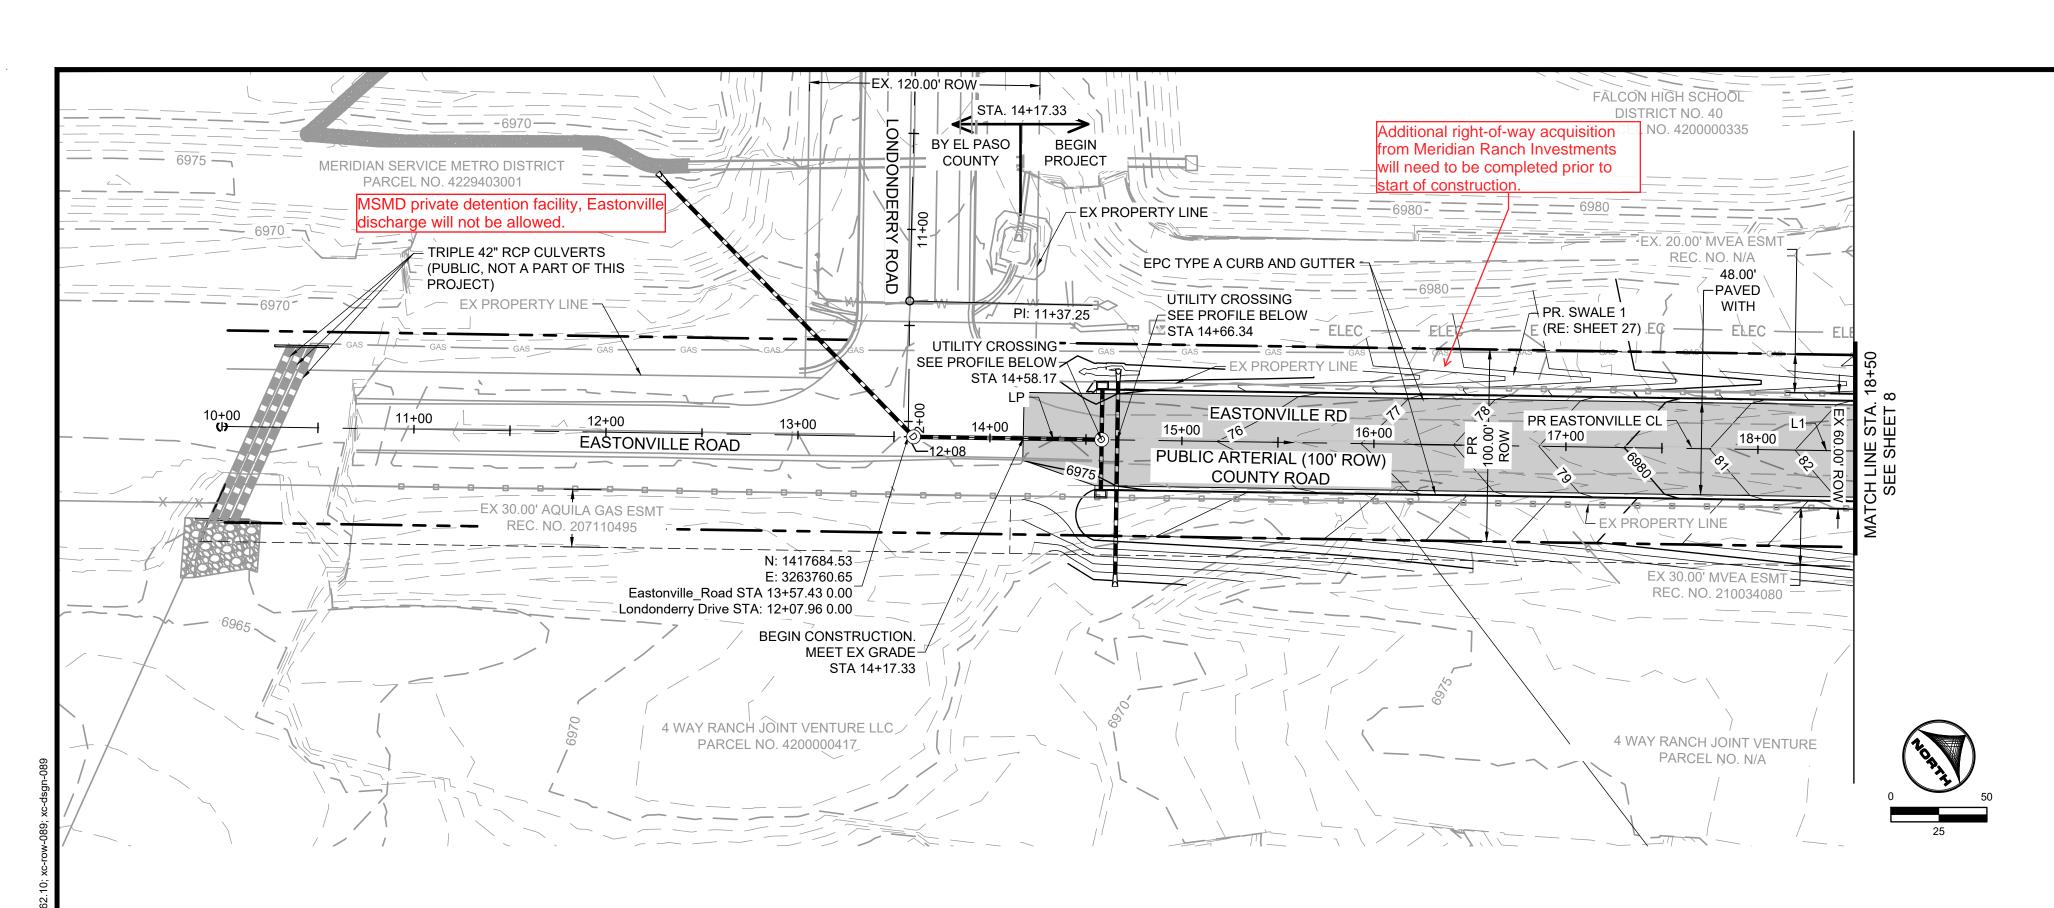
EASTONVILLE ROAD IMPROVEMENTS


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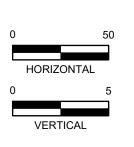
America's Builder


EASTONVILLE ROAD SEGEMENT 1 IMPROVEMENTS DEMOLITION PLAN

DM.3





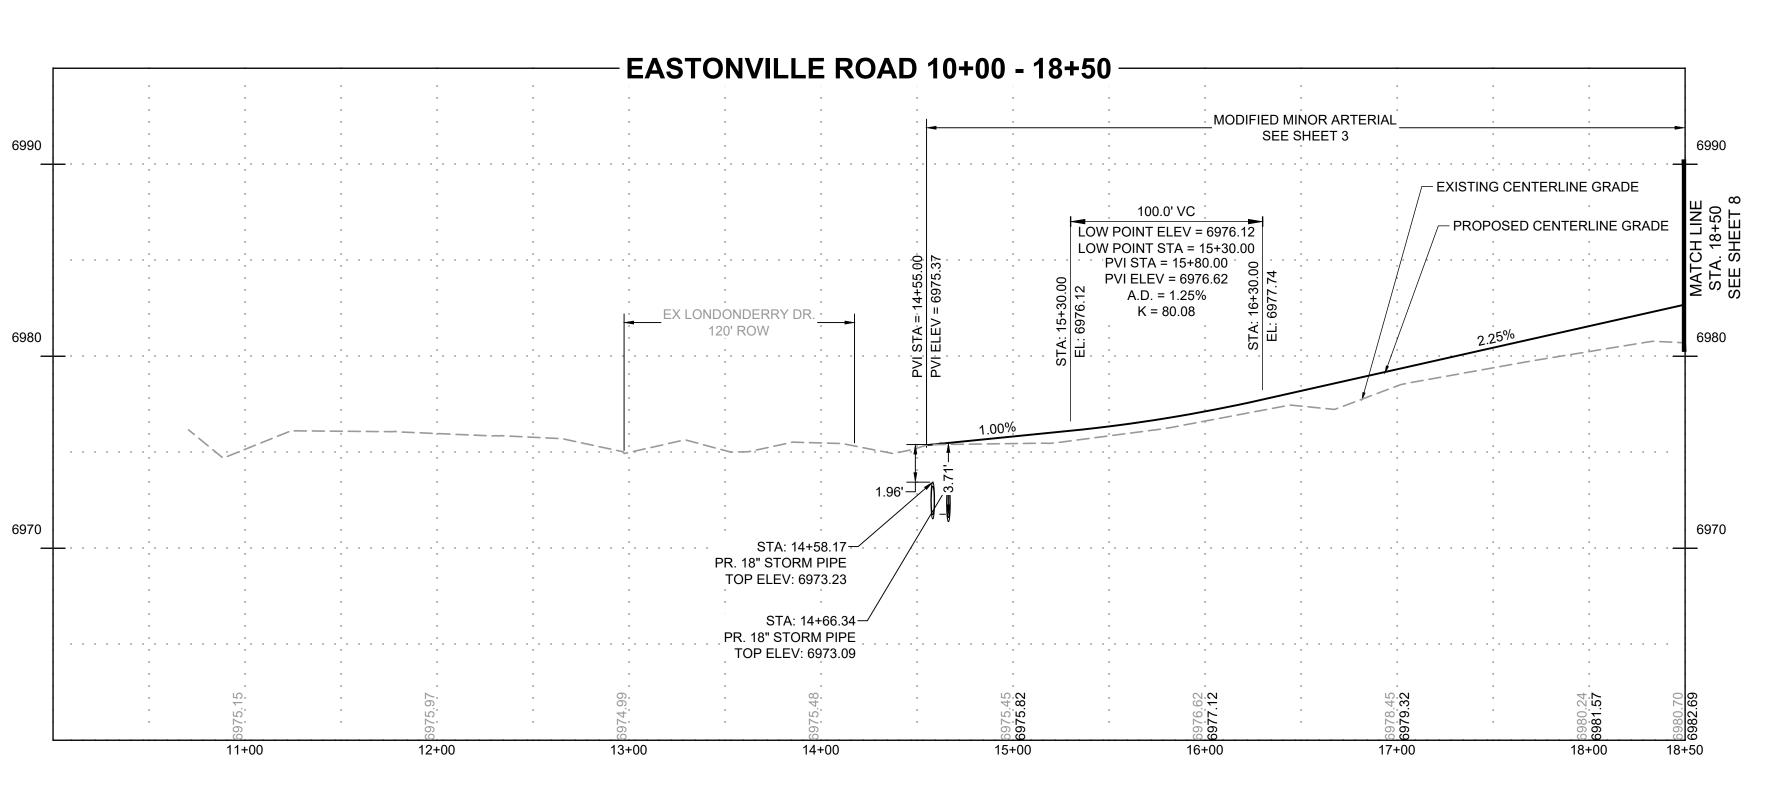

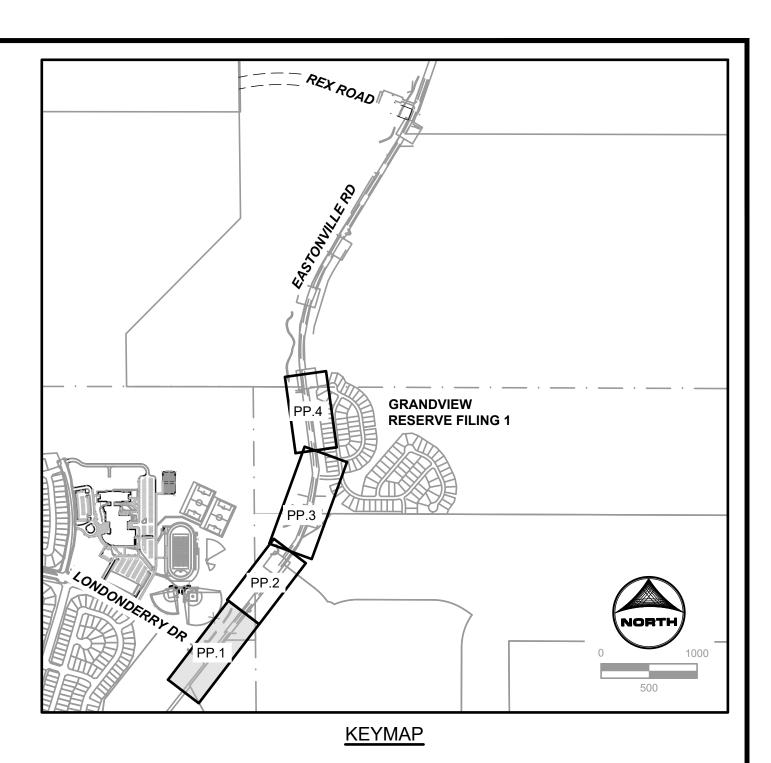

	Line T	able	Curve Table								
Line #	Length	Direction	Curve #	Length	Radius	Delta					
L1	460.78	N 38°15'31" E	C2	45.01	1800.00	1°25'58"					

Know what's below.

Call before you dig.

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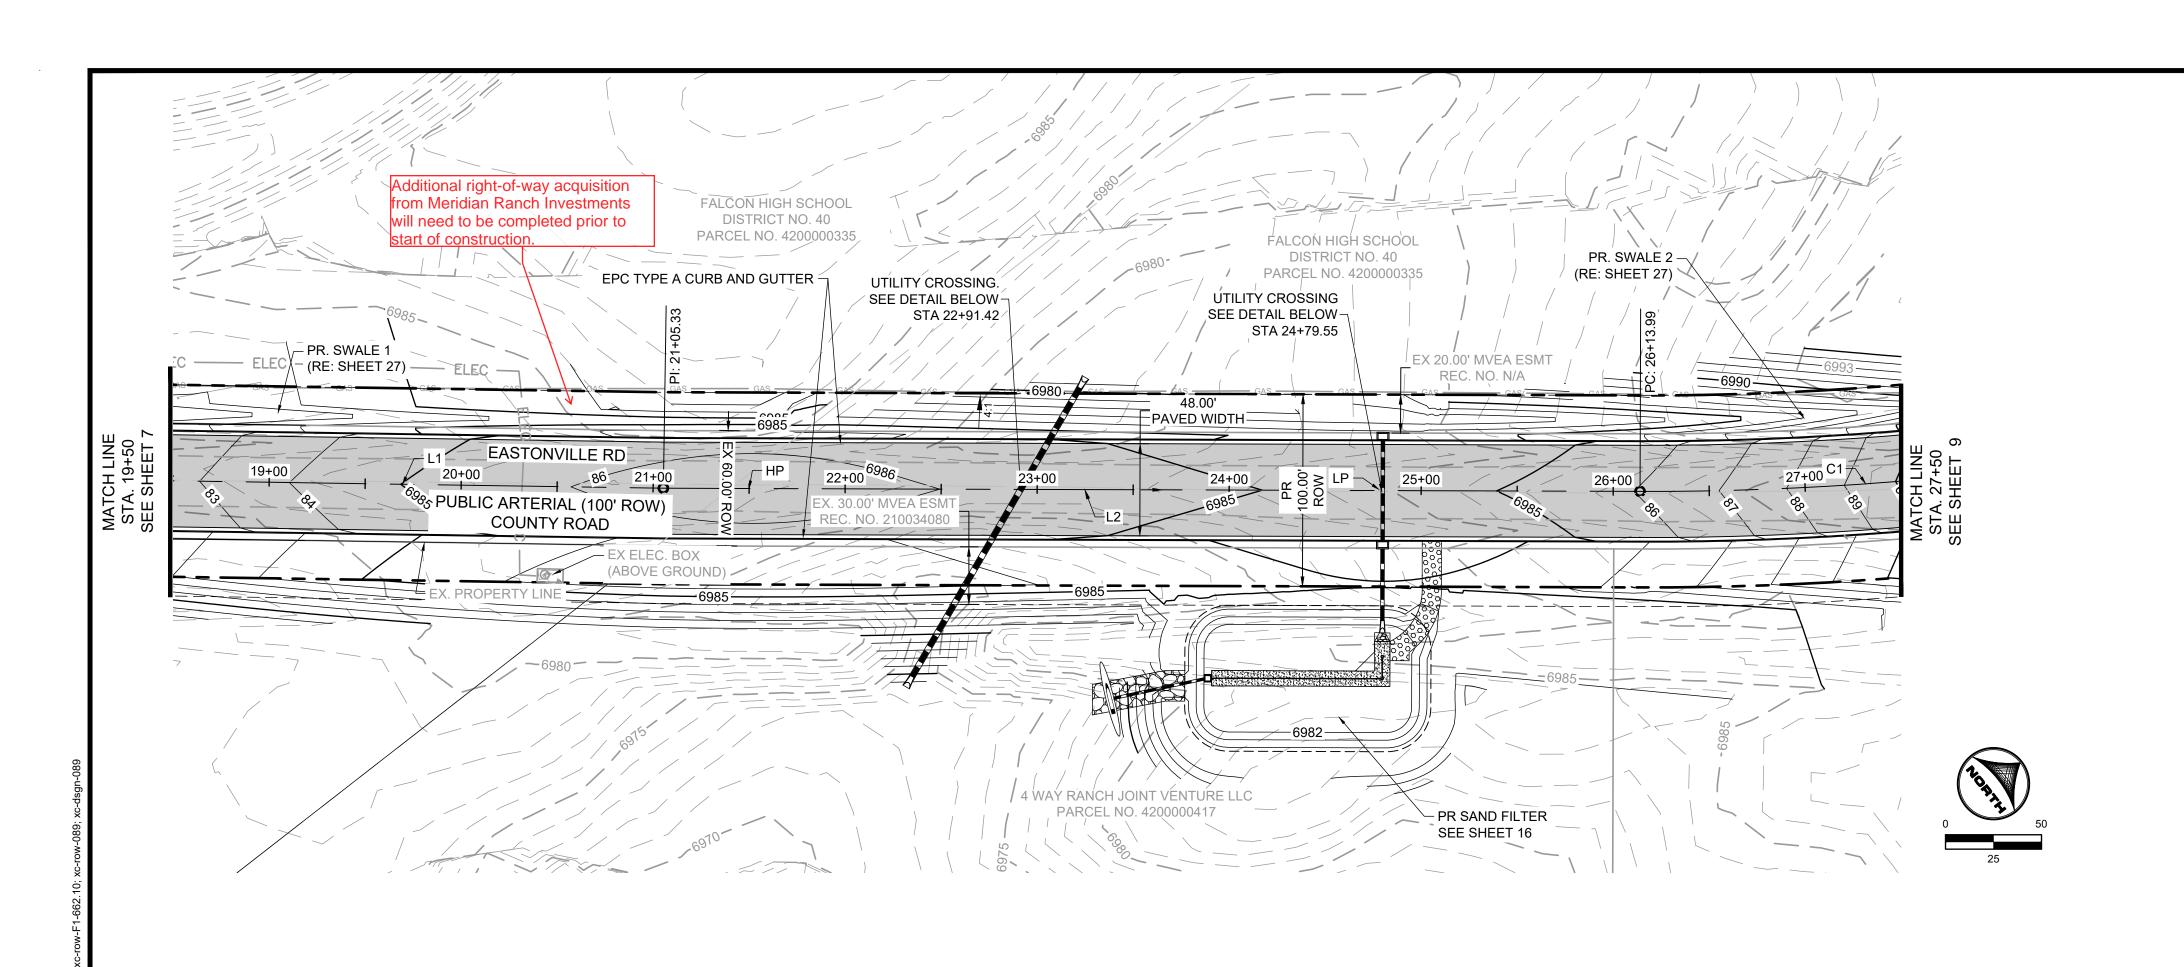



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COLORADO SPRINGS CO 80920
PHONE: 719.300.4140
FAX: 713.965.0044

EASTONVILLE ROAD IMPROVEMENTS DR. HORTON EL PASO COUNTY, COLORADO


EASTONVILLE ROAD SEGEMENT 1 IMPROVEMENTS PLAN & PROFILE


PP.1



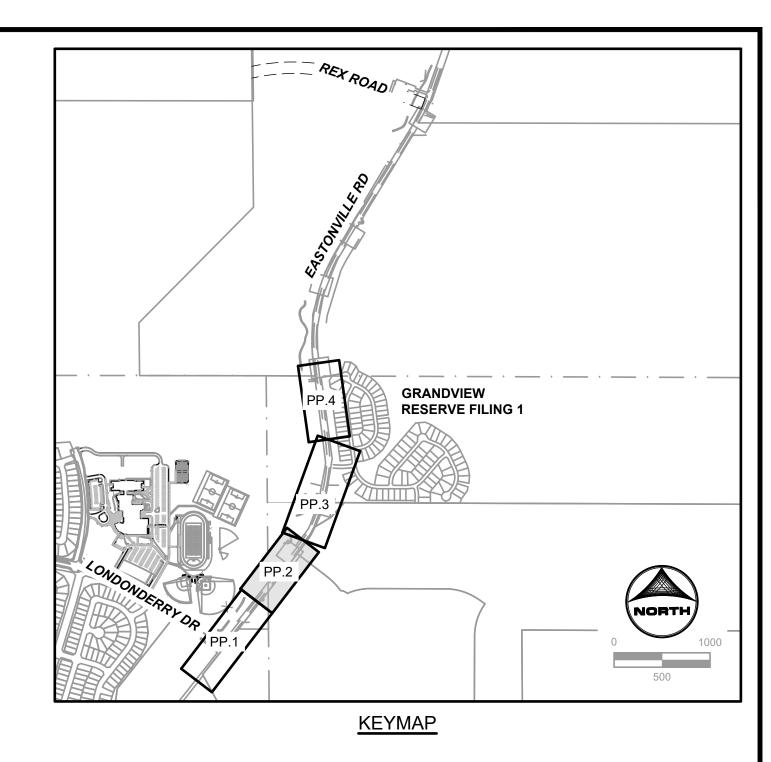

	Line T	able	Curve Table								
Line #	Length	Direction	Curve #	Length	Radius Delta						
L1	460.78	N 38°15'31" E	C1	1263.66	1600.00	45°15'05"					

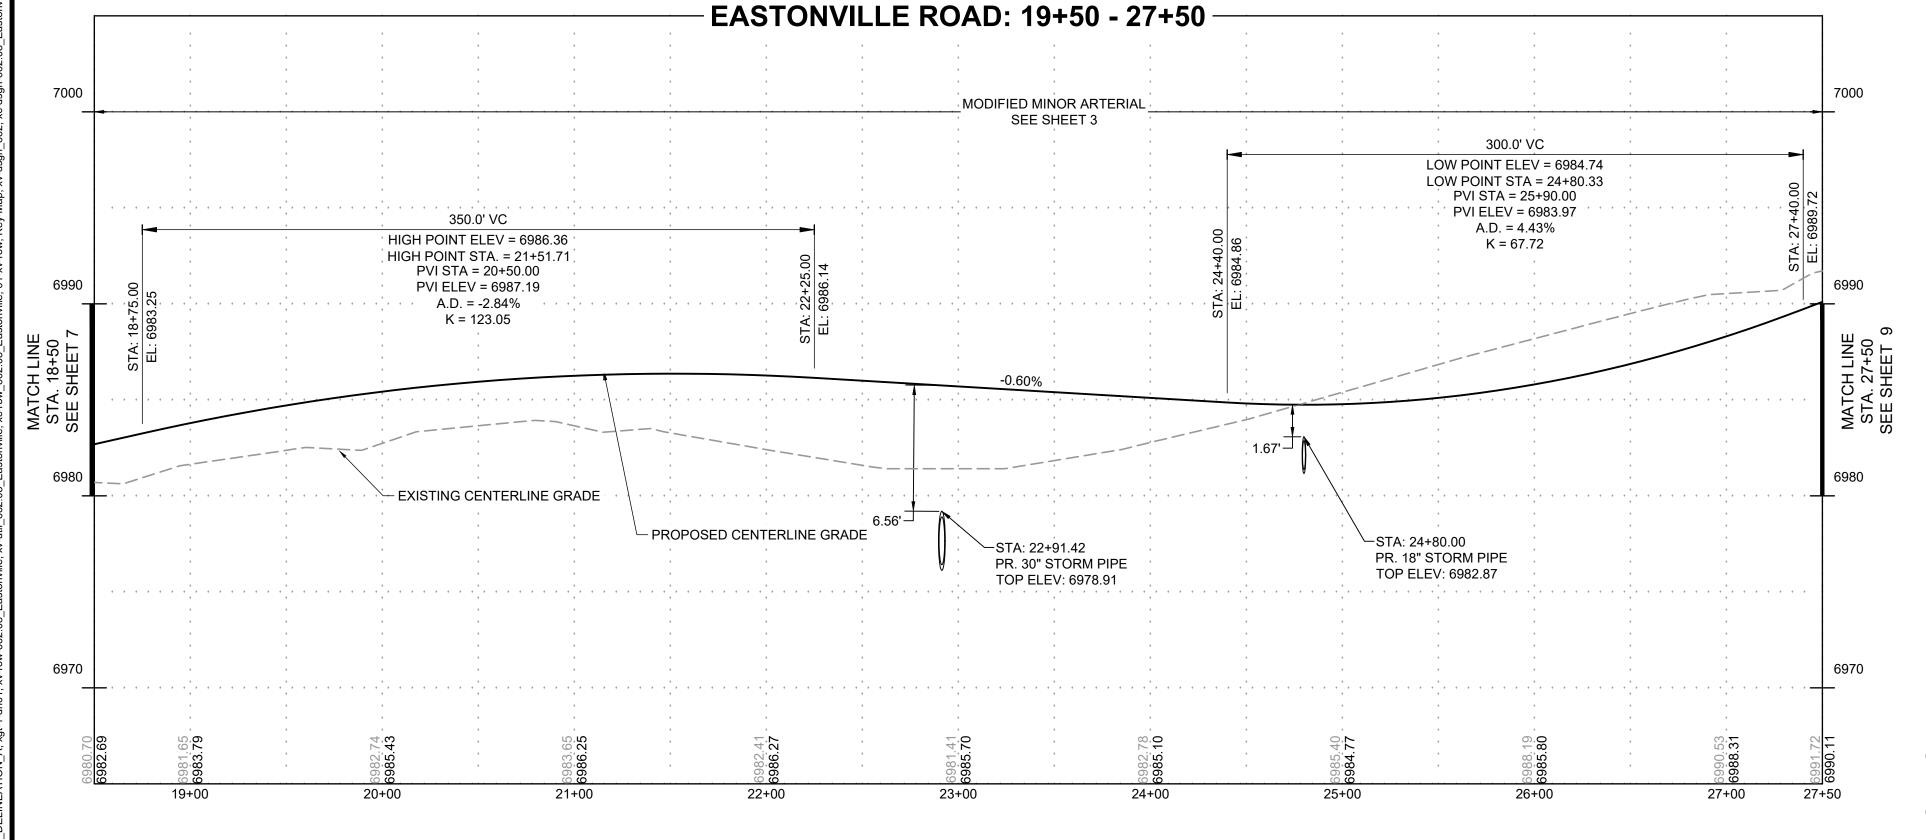

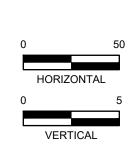

Know what's below.

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	DRAWN BY:	ACH	JOB DATE:	1/12/2024	BAR IS ONE INCH ON OFFICIAL DRAWINGS.		NO.	DATE	BY	REVISION DESCRIPTION
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	CAD DATE:	1/12/2024			IF NOT ONE INCH, ADJUST SCALE ACCORDINGLY.	┫├	\longrightarrow			
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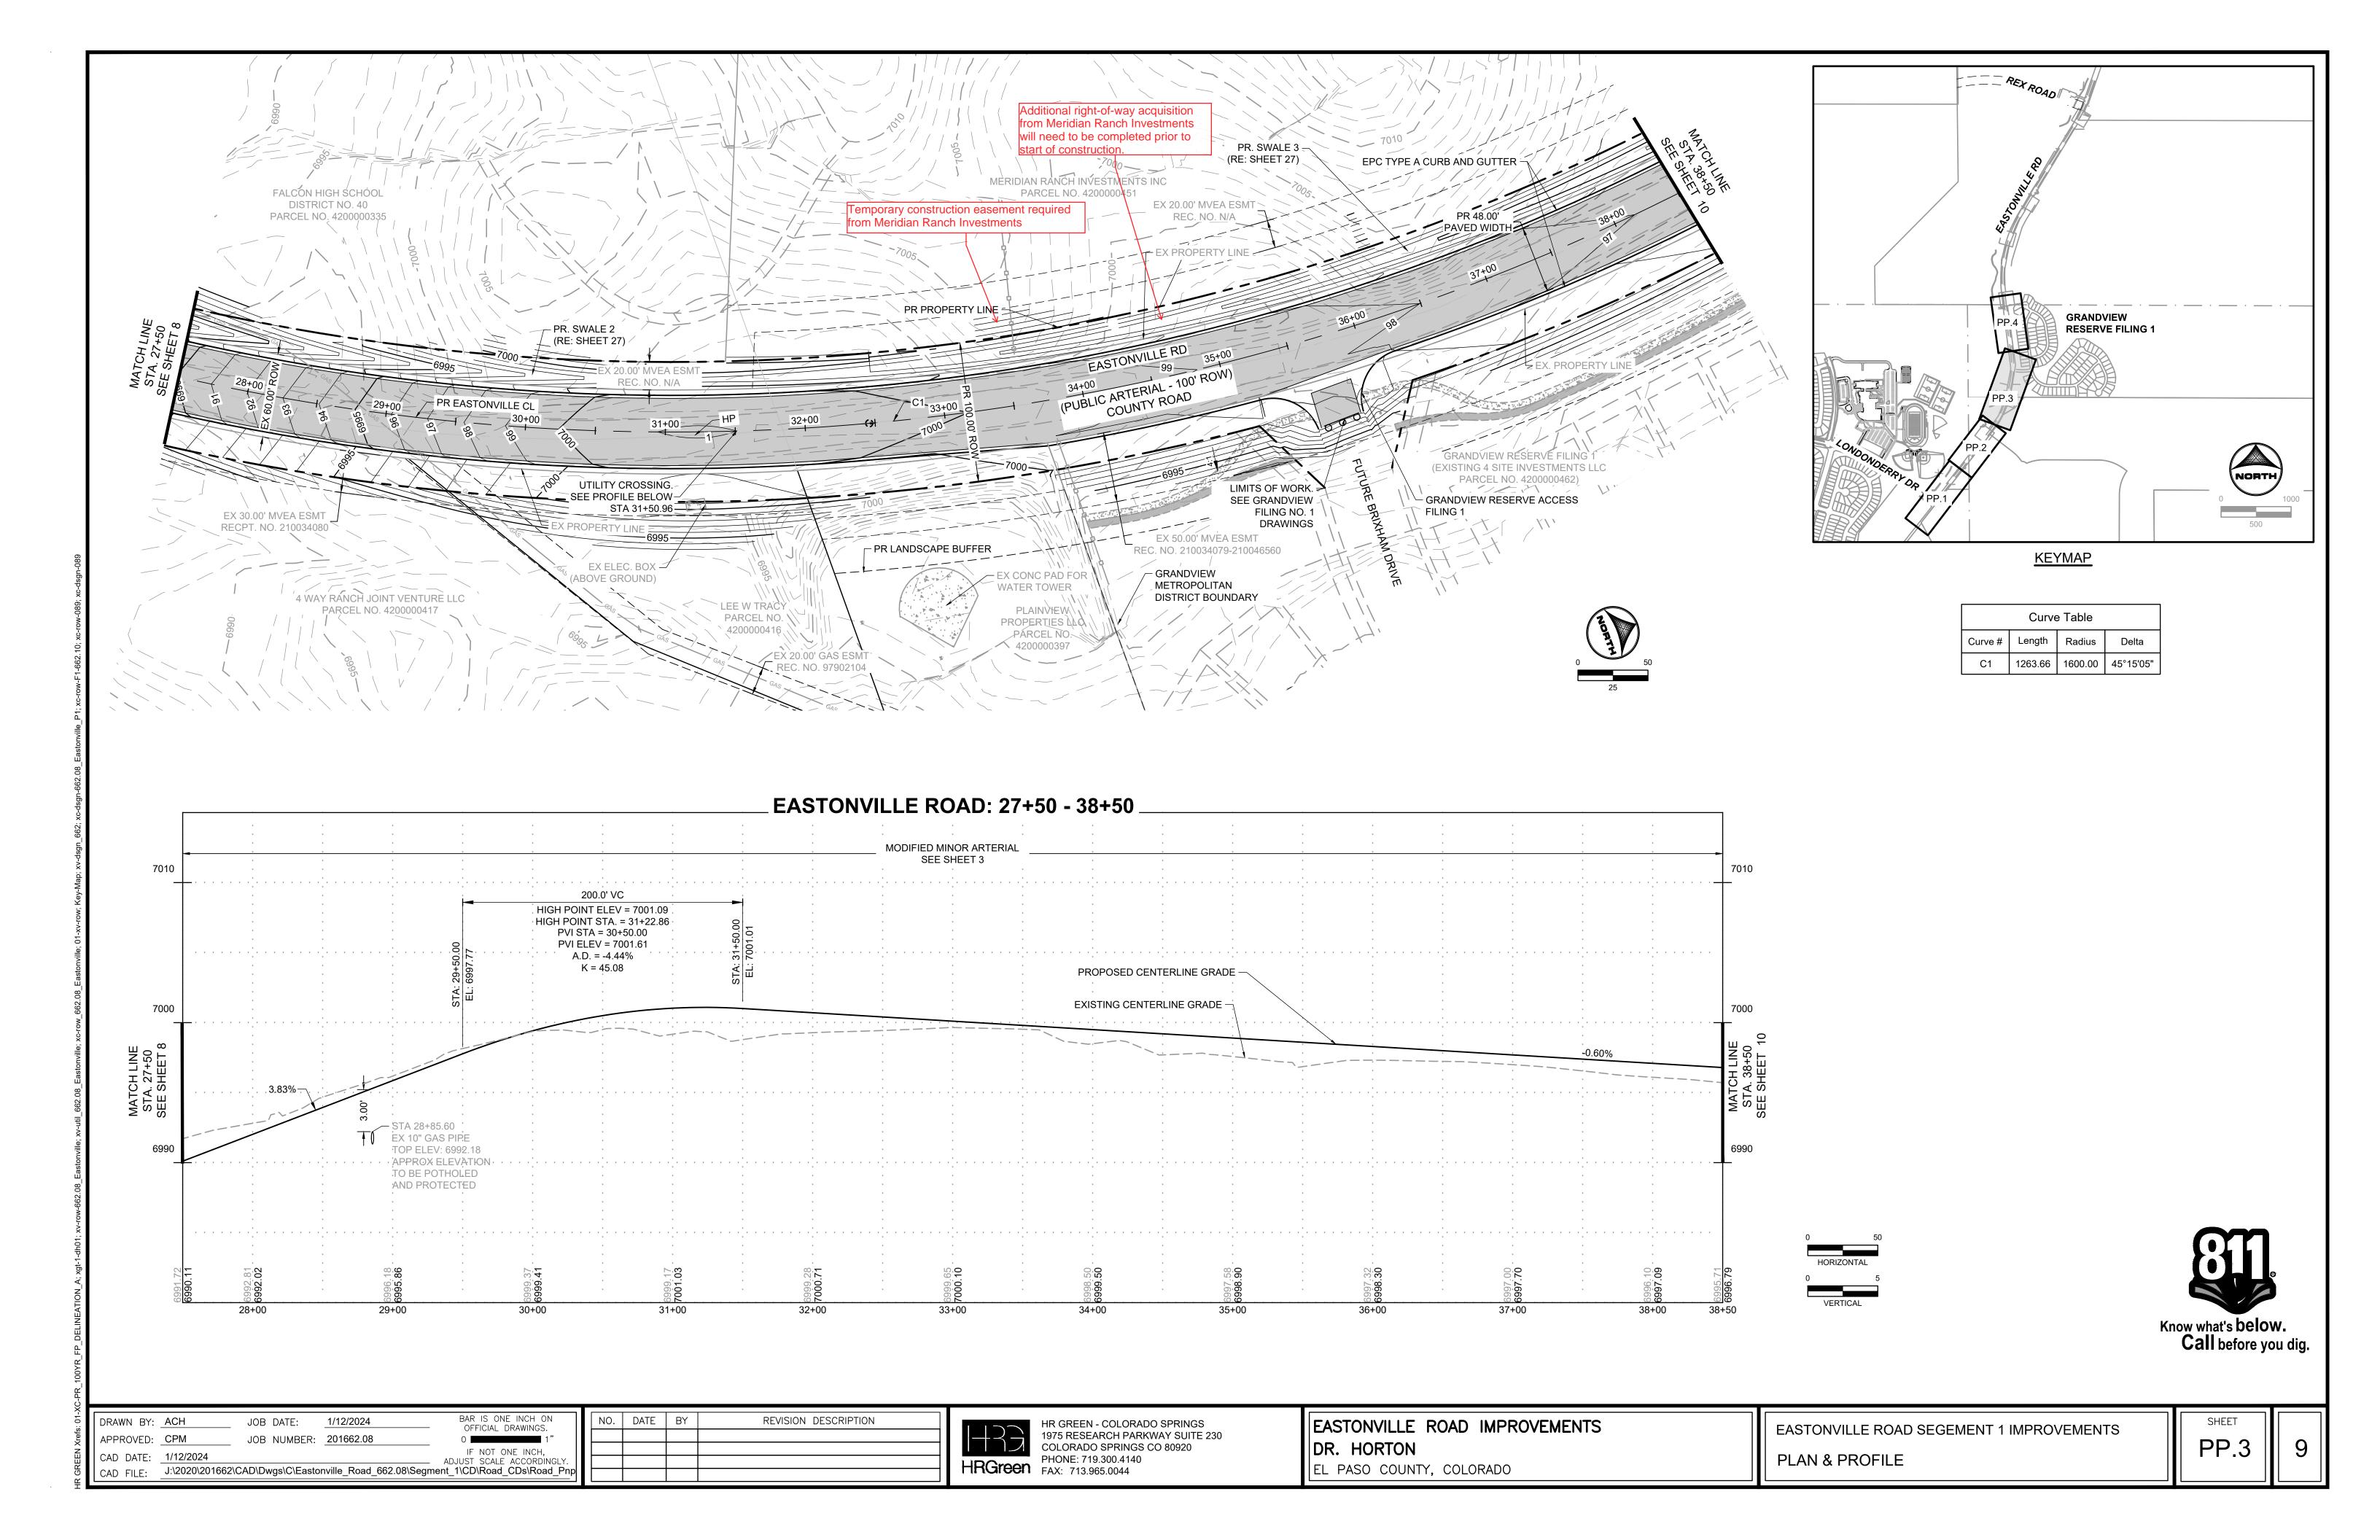



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PHONE: 719.300.4140
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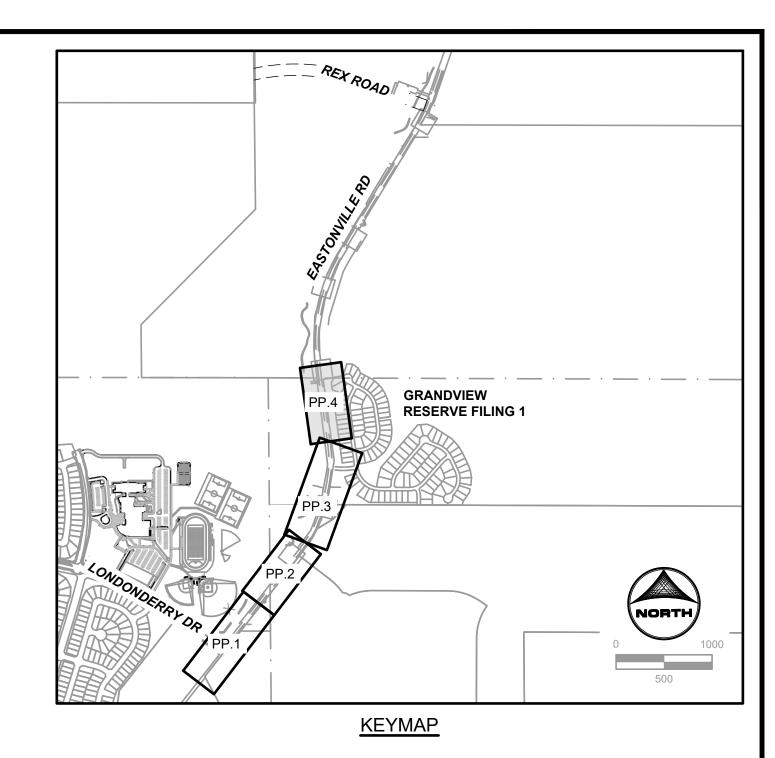
EASTONVILLE ROAD IMPROVEMENTS DR. HORTON EL PASO COUNTY, COLORADO

EASTONVILLE ROAD SEGEMENT 1 IMPROVEMENTS PLAN & PROFILE


PP.2





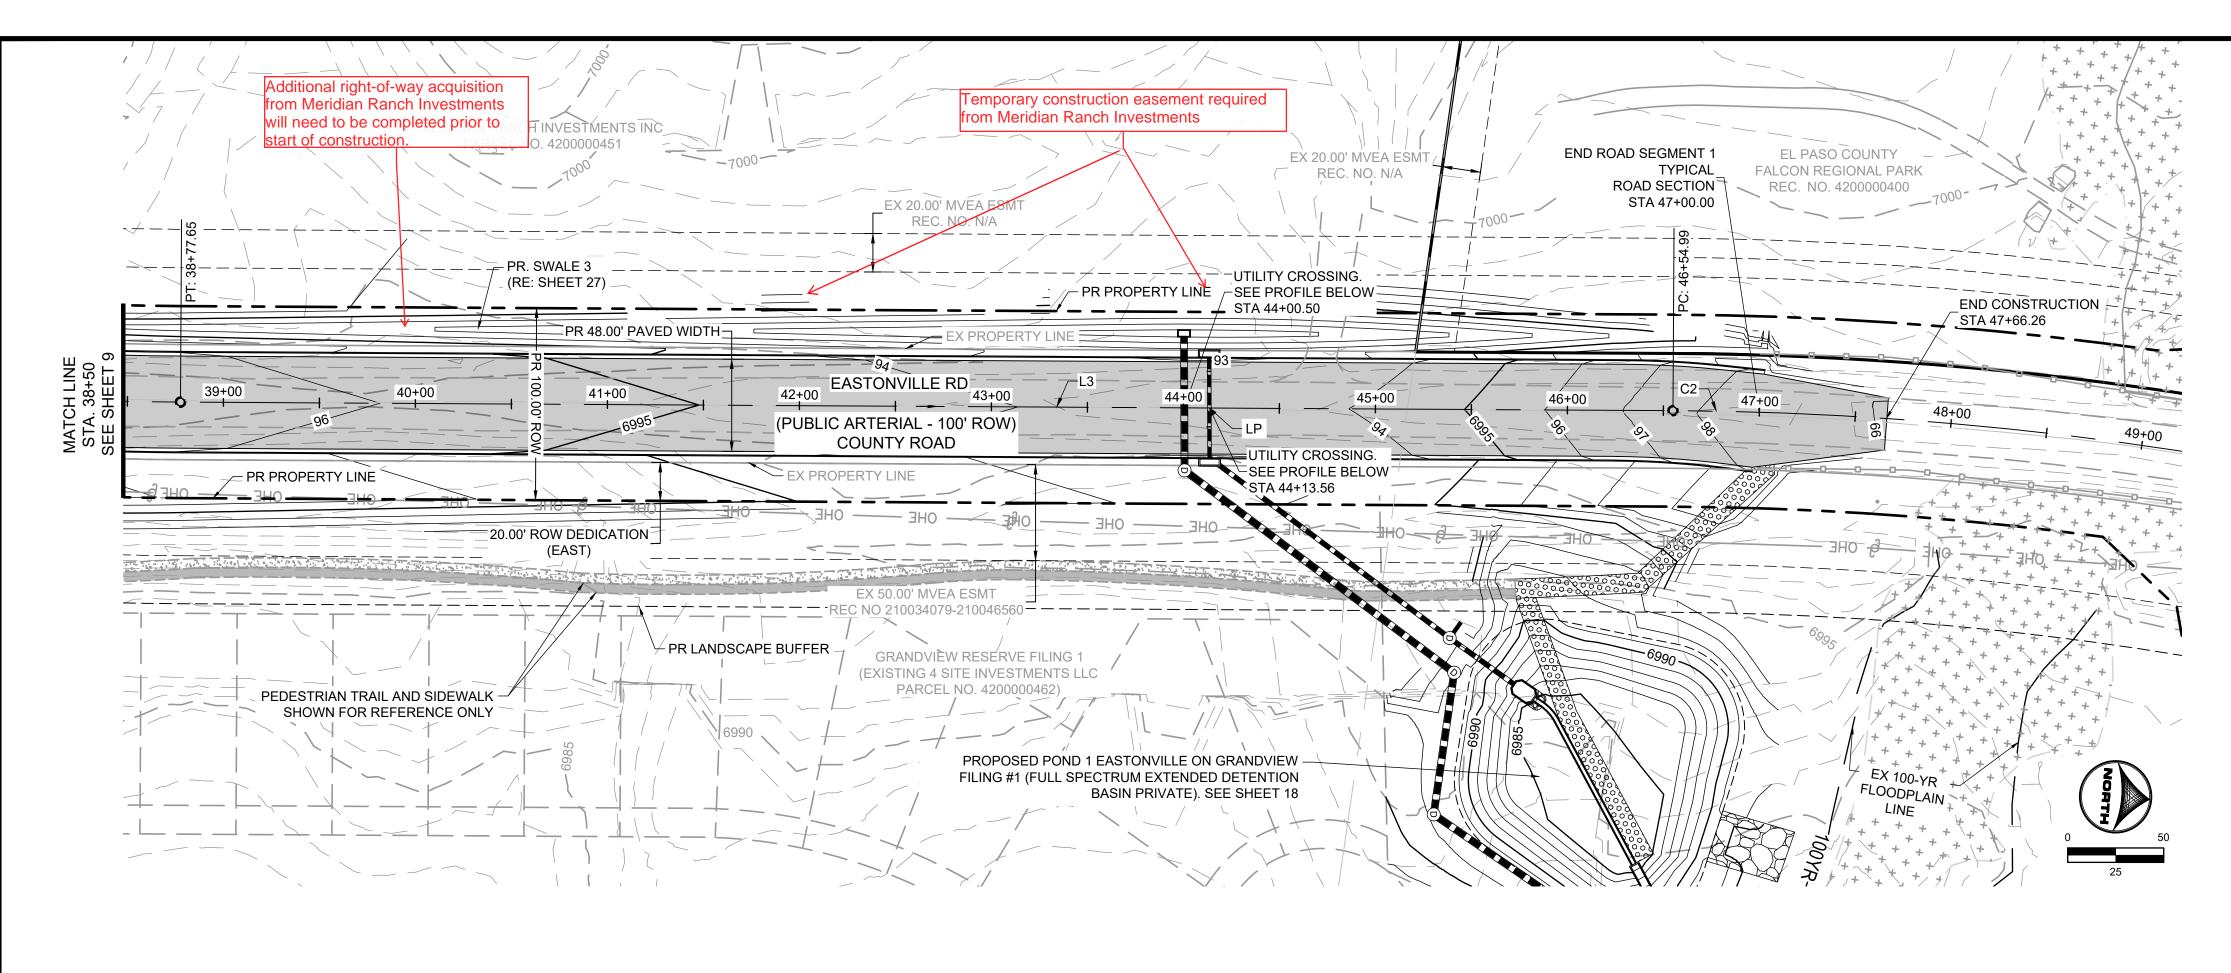

	Line T	able	Curve Table								
Line #	Length	Direction	Curve #	Length	Radius Delta						
L3	777.34	N 7°40'18" W	C2	45.01	1800.00	1°25'58"					

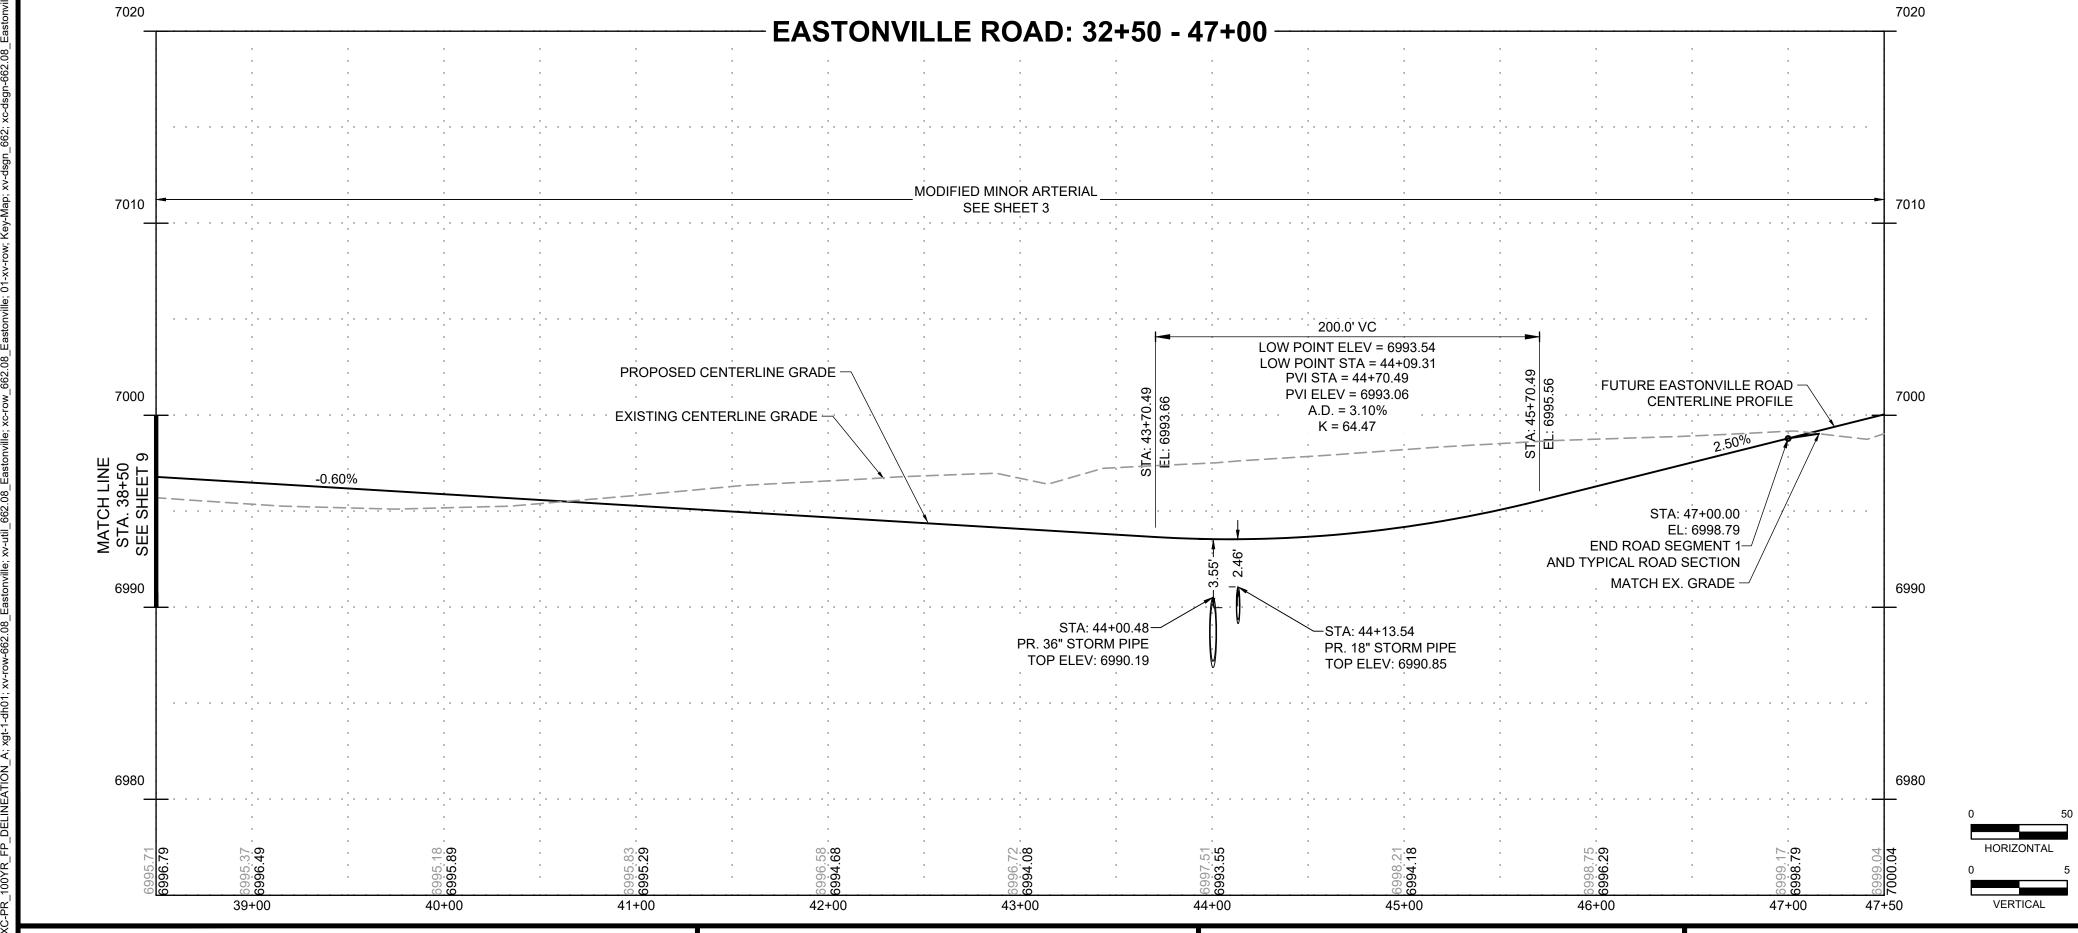




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EASTONVILLE ROAD SEGEMENT 1 IMPROVEMENTS PLAN & PROFILE

PP.4



COLORADO SPRINGS CO 80920

PHONE: 719.300.4140

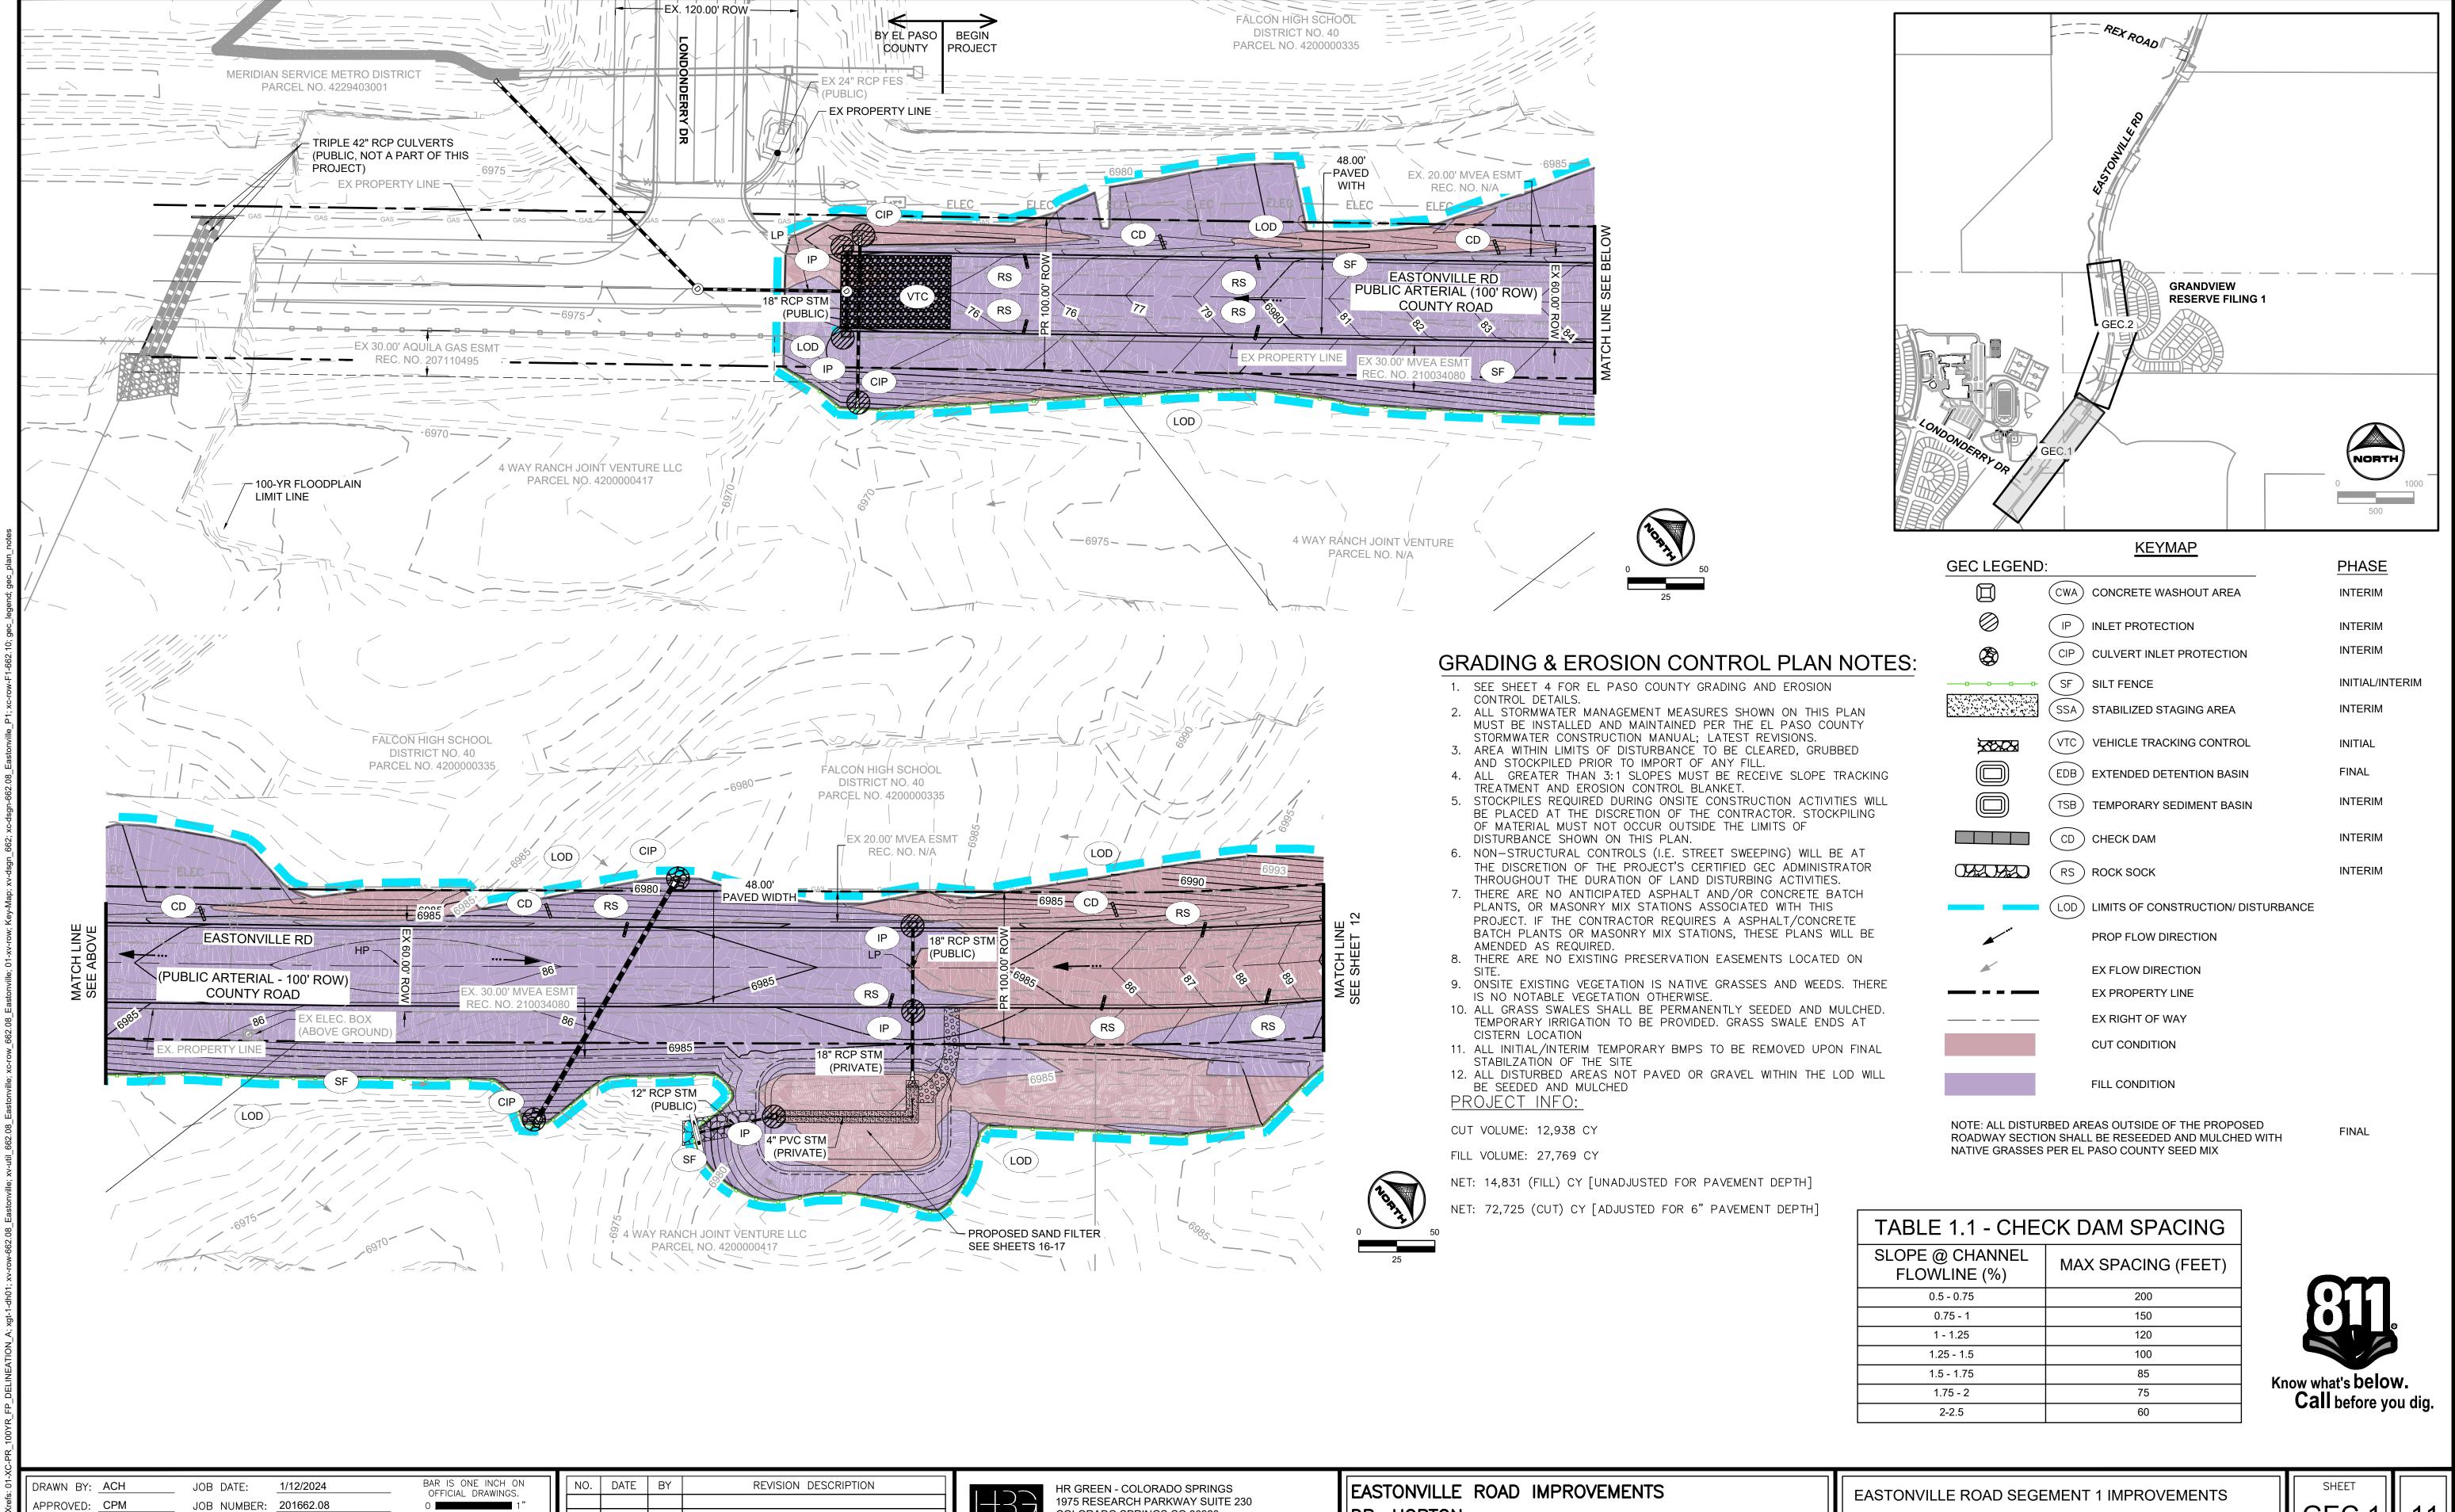HRGreen FAX: 713.965.0044

DR. HORTON

EL PASO COUNTY, COLORADO

APPROVED: CPM

CAD DATE: 1/12/2024


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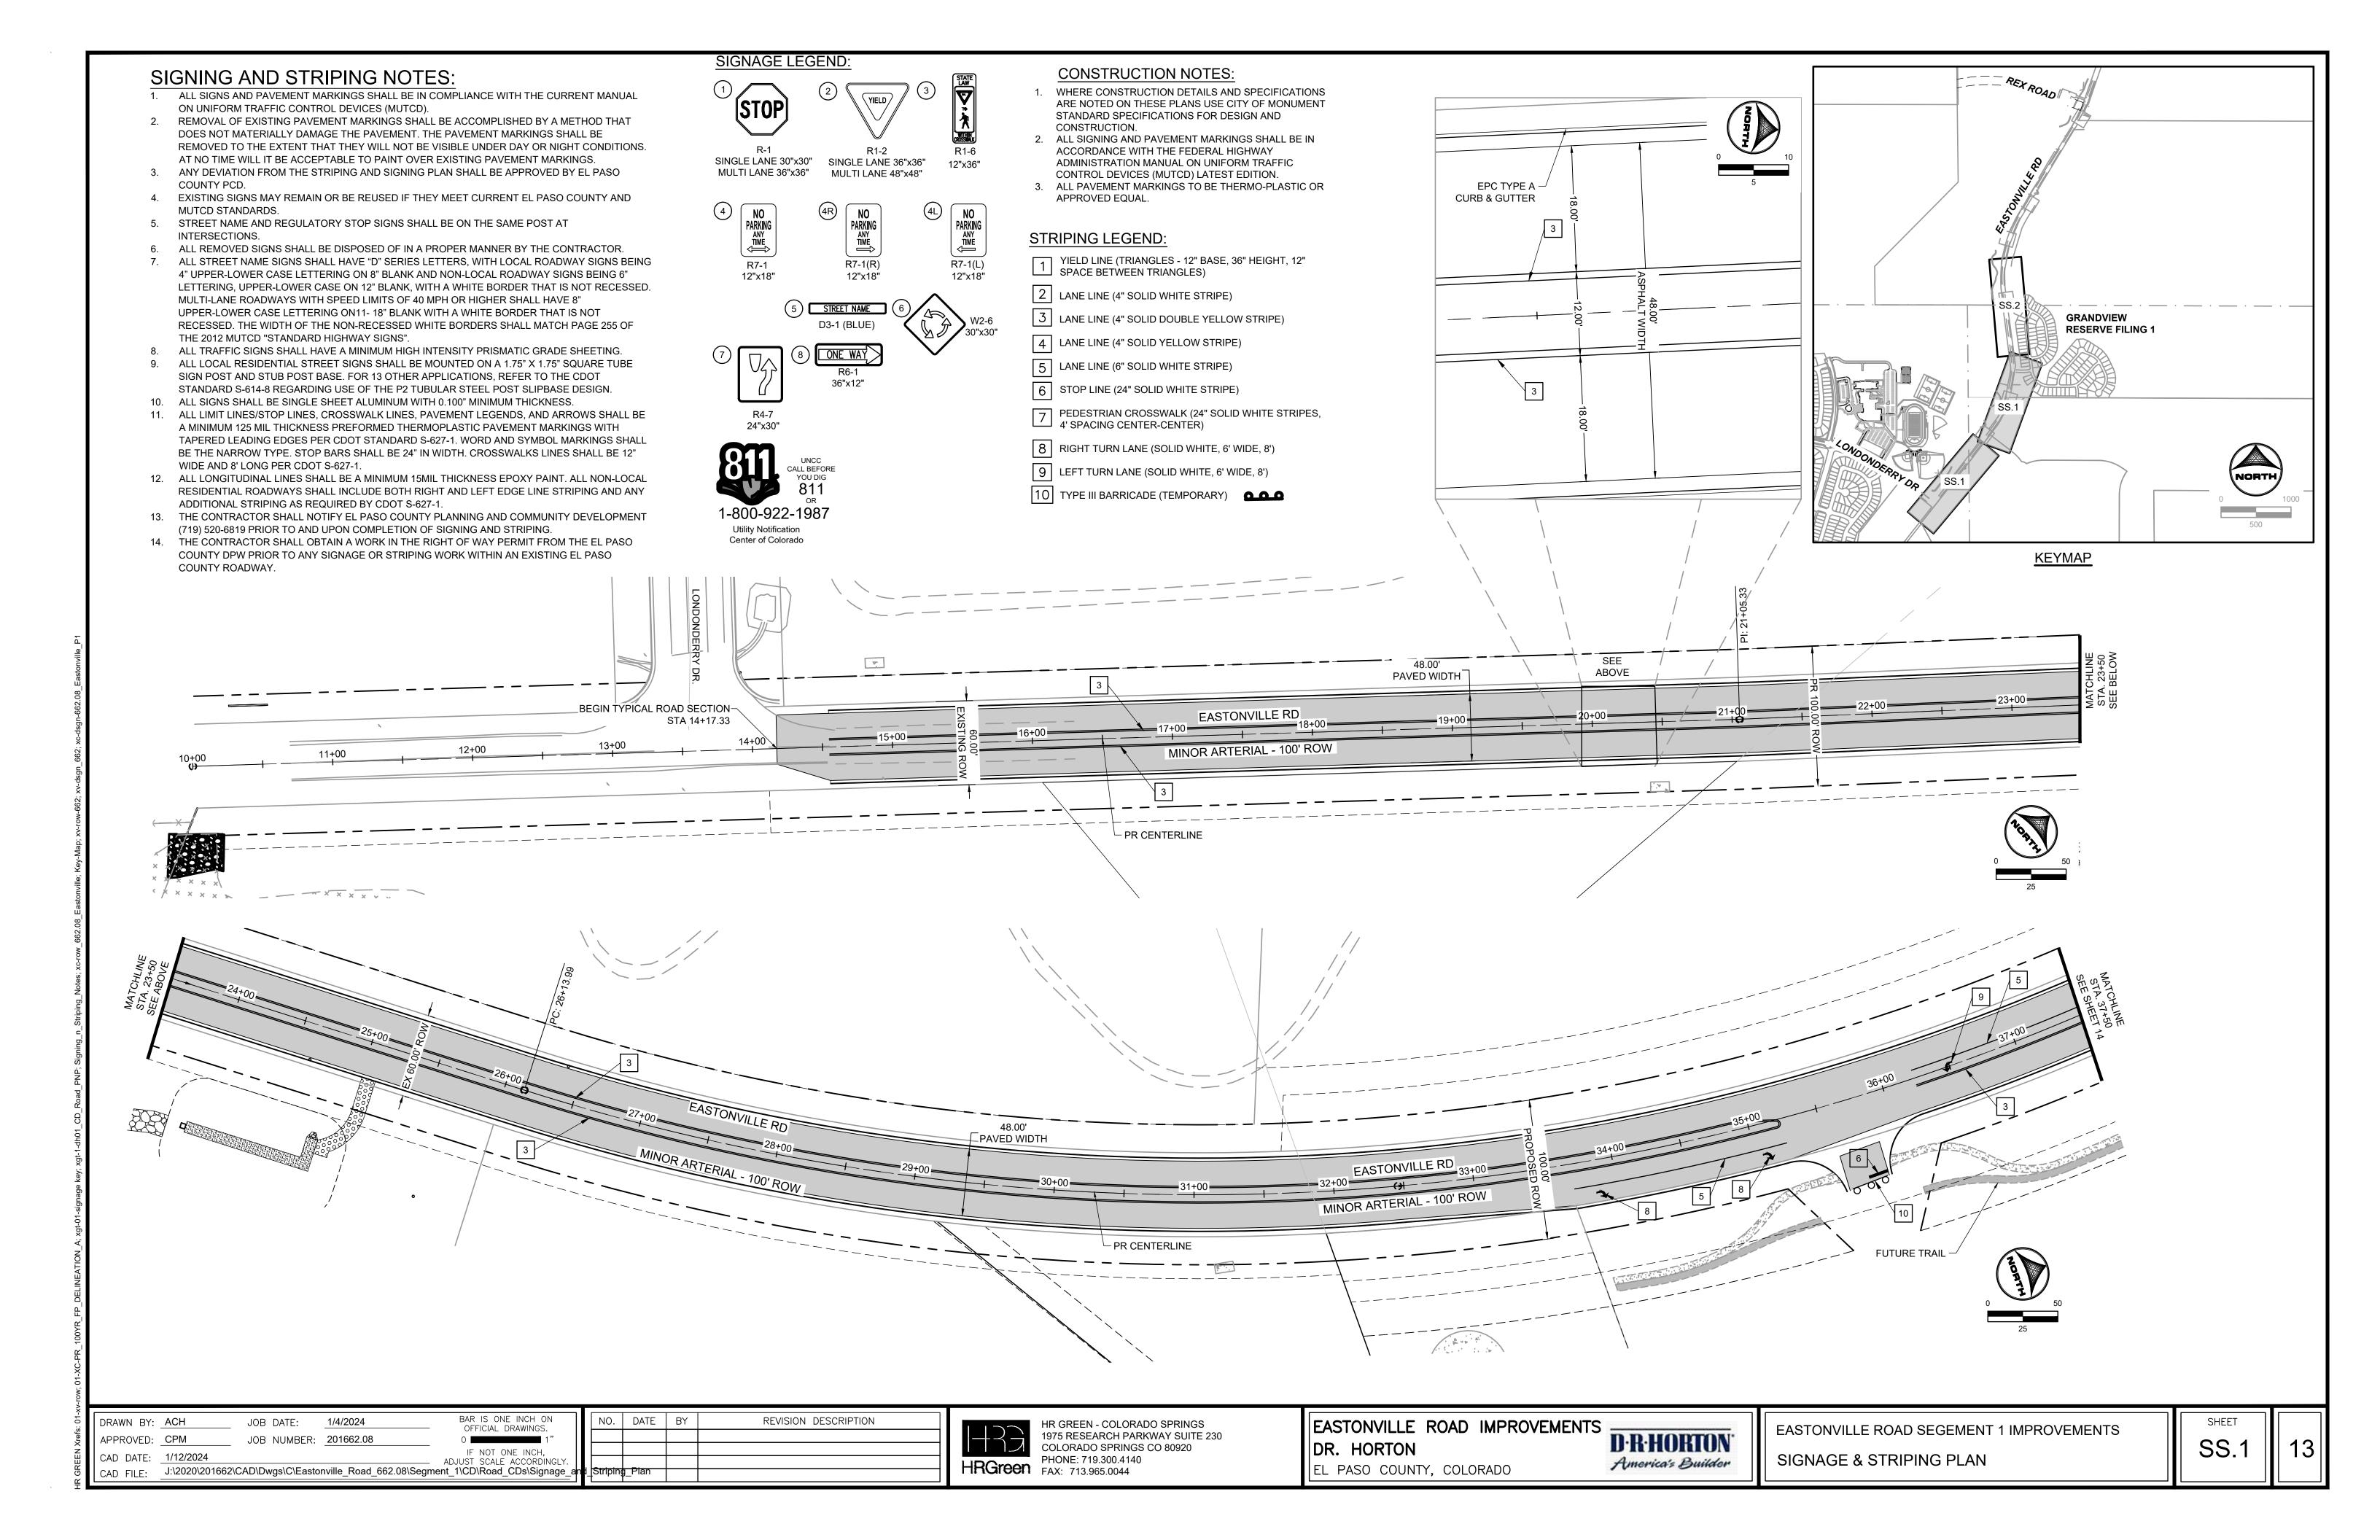
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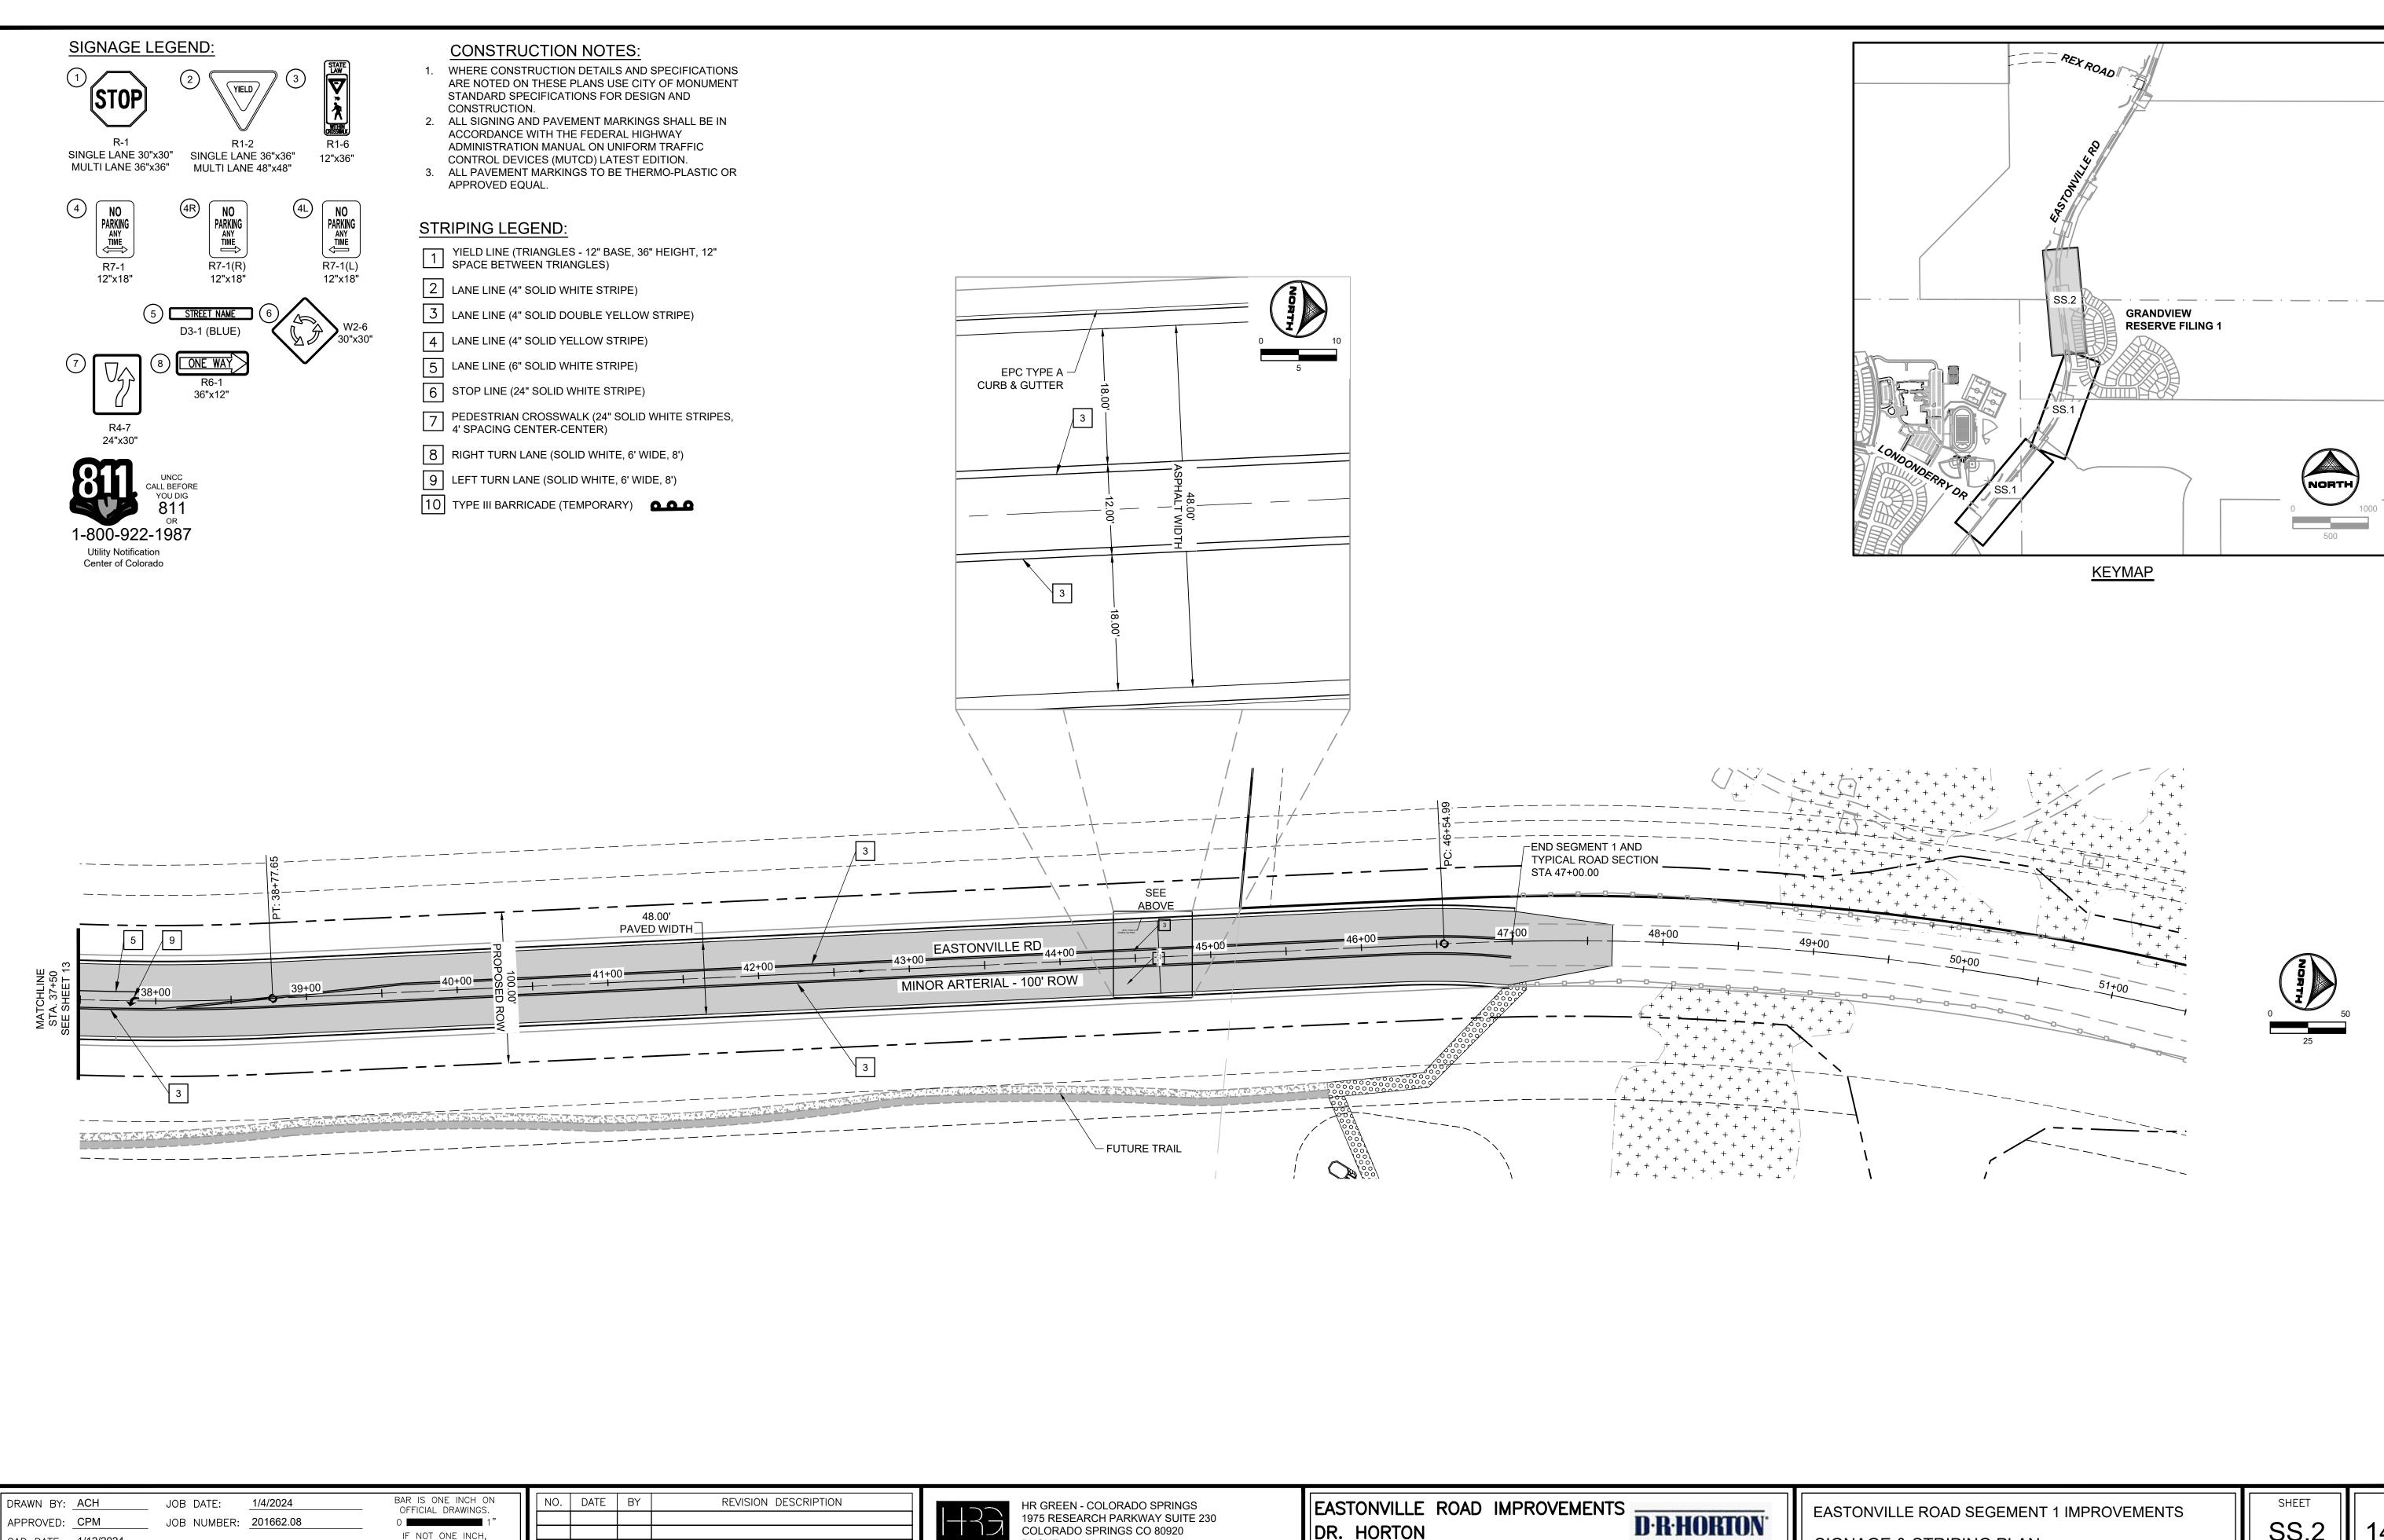
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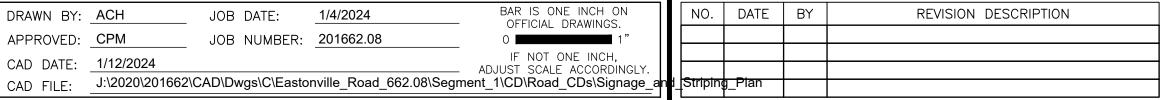
GEC.1

GRADING & EROSION CONTROL PLAN








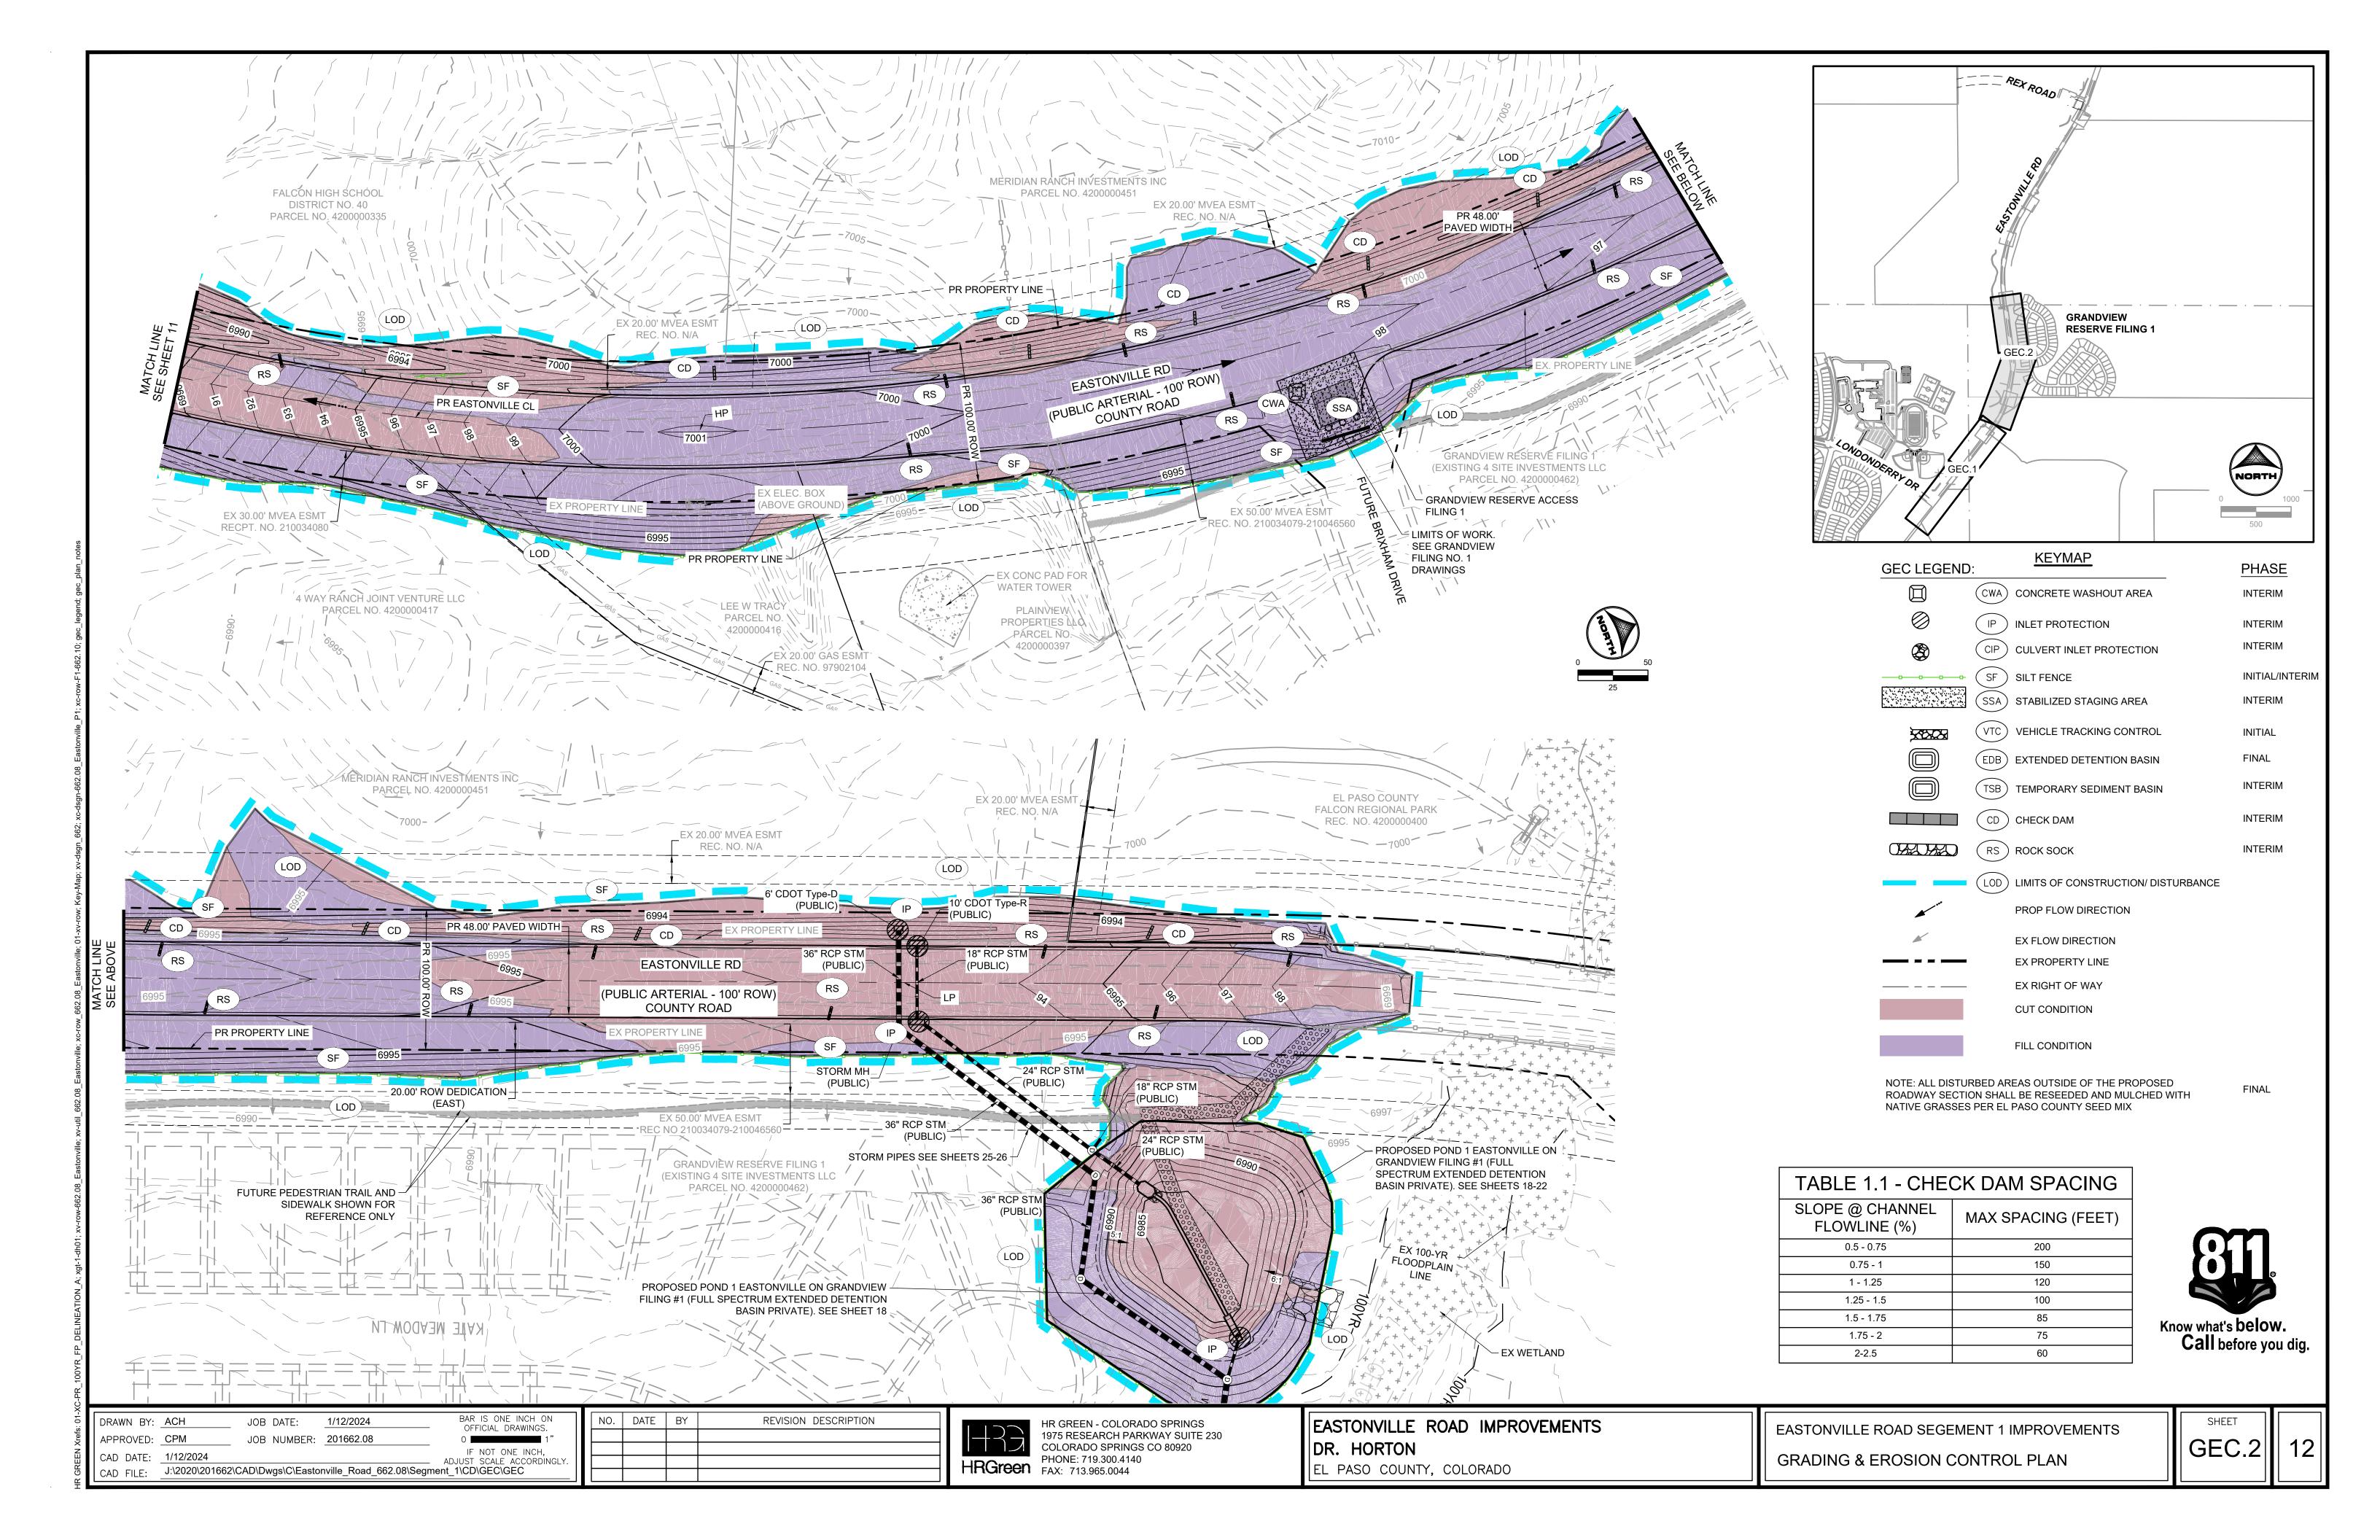



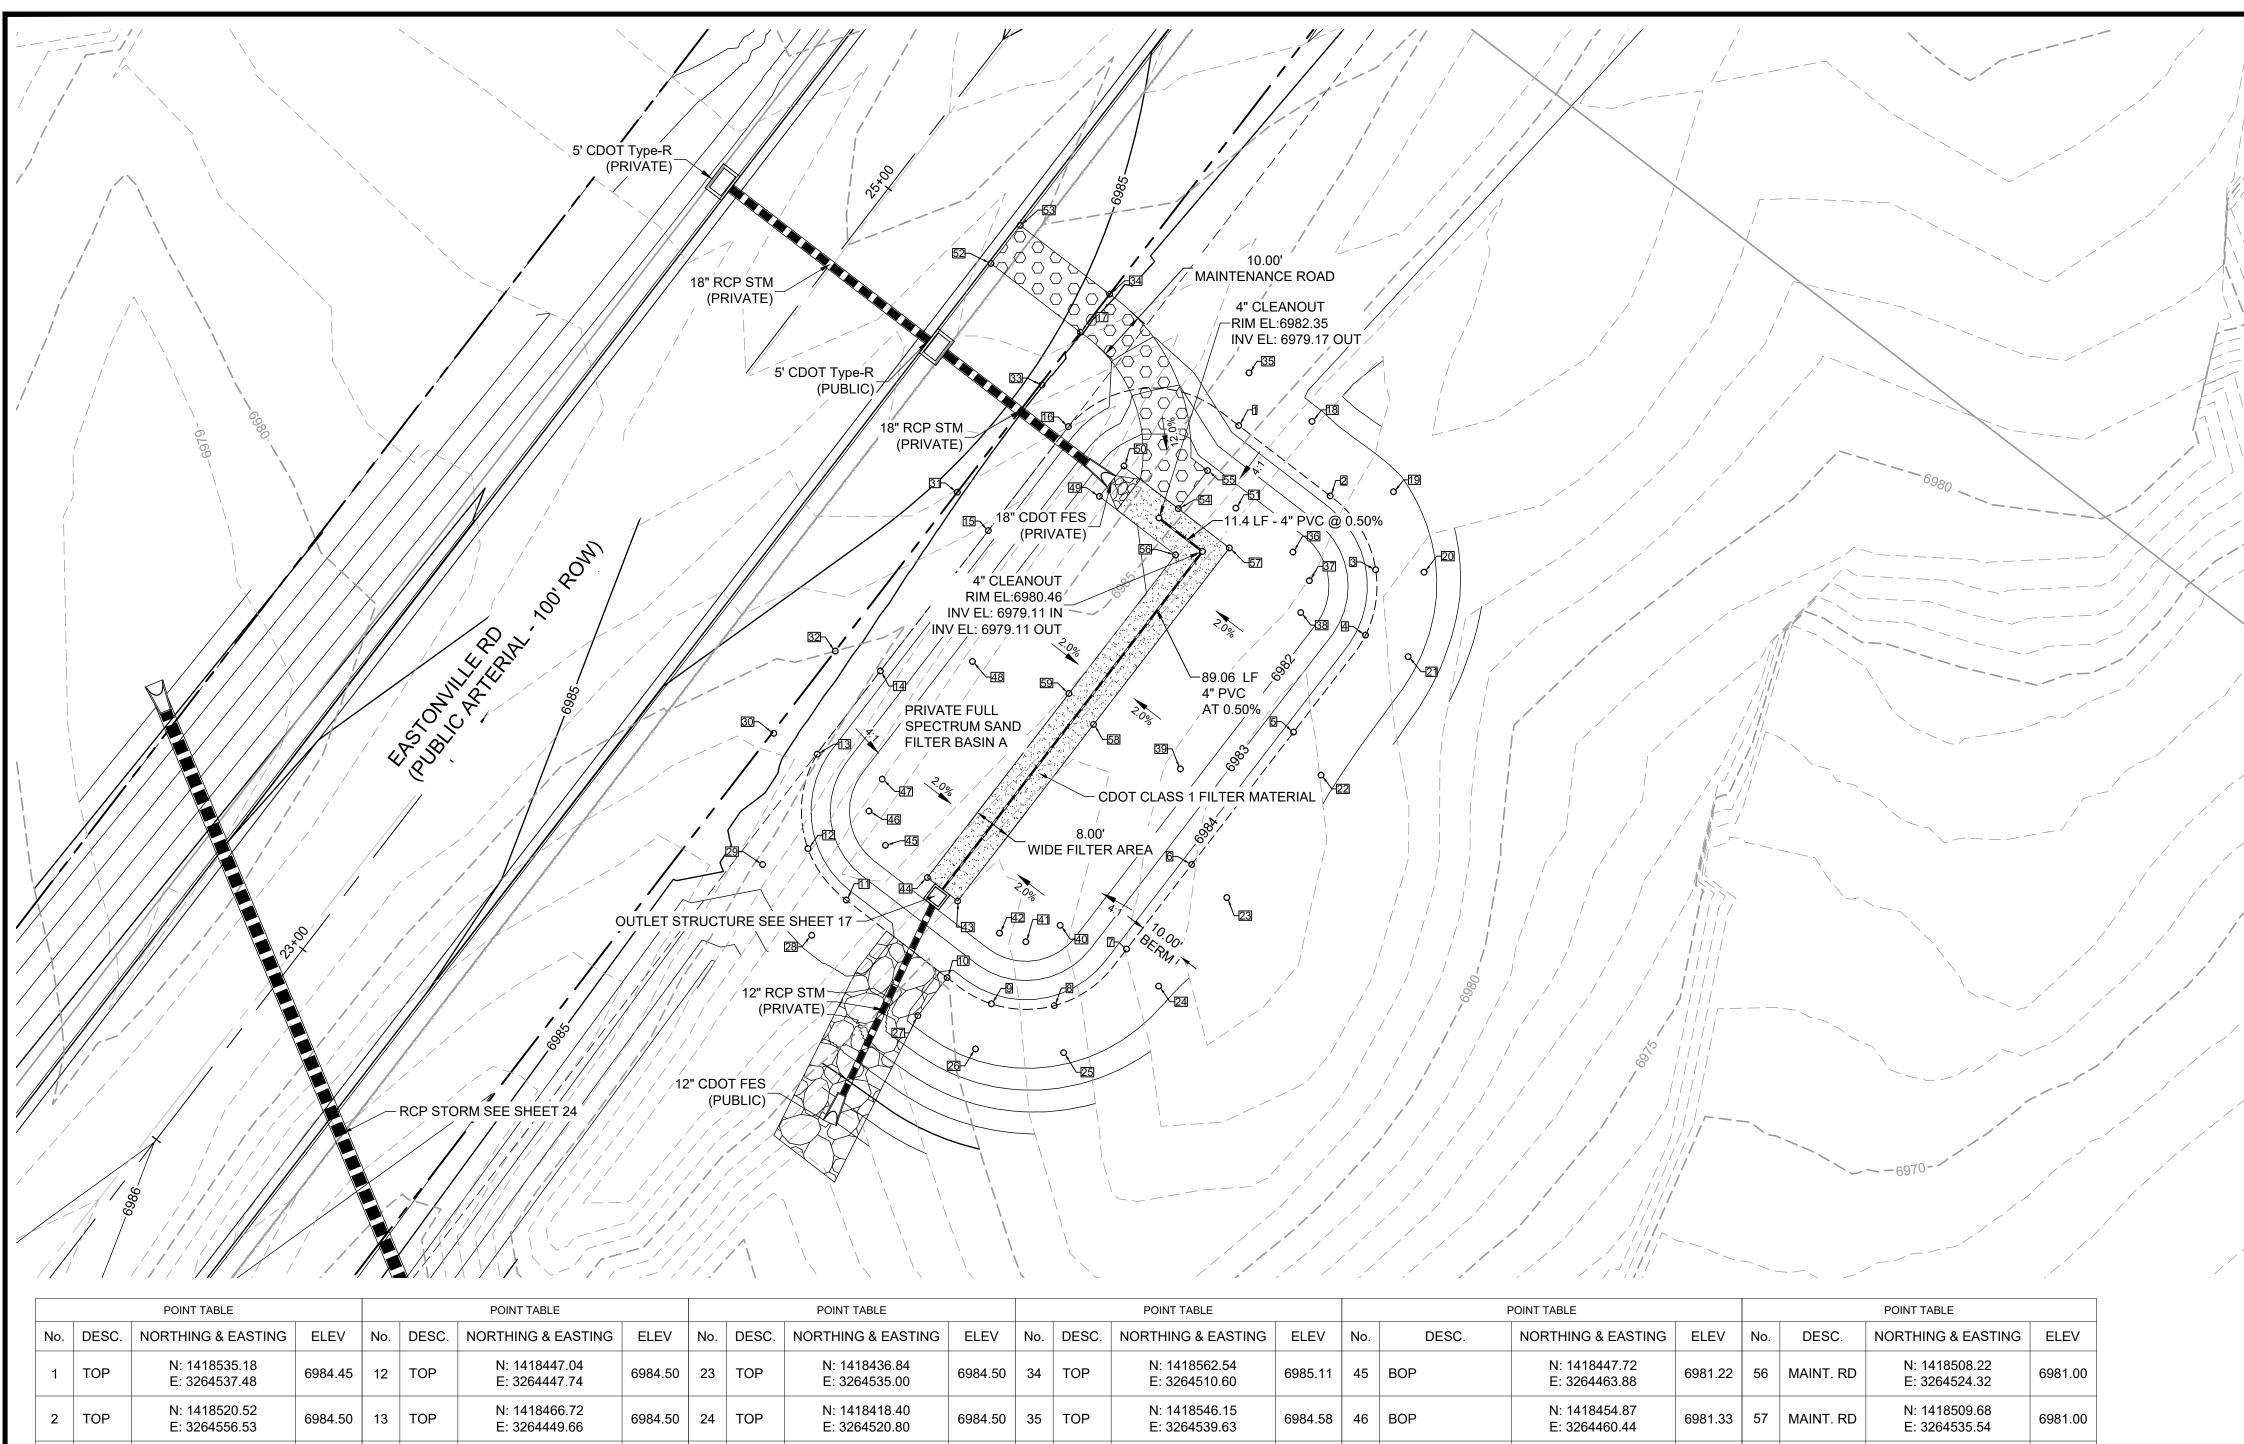

		POINT TABLE		POINT TABLE				POINT TABLE				POINT TABLE				POINT TABLE				
No.	DESC.	NORTHING & EASTING	ELEV	No.	DESC.	NORTHING & EASTING	ELEV	No.	DESC.	NORTHING & EASTING	ELEV	No.	DESC.	NORTHING & EASTING	ELEV	No.	DESC.	NORTHING & EASTING	ELEV	No.
1	TOP	N: 1418535.18 E: 3264537.48	6984.45	12	TOP	N: 1418447.04 E: 3264447.74	6984.50	23	TOP	N: 1418436.84 E: 3264535.00	6984.50	34	ТОР	N: 1418562.54 E: 3264510.60	6985.11	45	ВОР	N: 1418447.72 E: 3264463.88	6981.22	56
2	TOP	N: 1418520.52 E: 3264556.53	6984.50	13	TOP	N: 1418466.72 E: 3264449.66	6984.50	24	ТОР	N: 1418418.40 E: 3264520.80	6984.50	35	ТОР	N: 1418546.15 E: 3264539.63	6984.58	46	ВОР	N: 1418454.87 E: 3264460.44	6981.33	57
3	TOP	N: 1418505.13 E: 3264566.02	6984.50	14	TOP	N: 1418484.06 E: 3264462.82	6984.50	25	TOP	N: 1418404.53 E: 3264501.00	6984.50	36	ВОР	N: 1418508.83 E: 3264548.76	6981.41	47	ВОР	N: 1418461.52 E: 3264463.22	6981.41	58
4	TOP	N: 1418491.51 E: 3264563.89	6984.50	15	TOP	N: 1418513.30 E: 3264485.32	6984.50	26	TOP	N: 1418405.31 E: 3264482.65	6984.50	37	ВОР	N: 1418502.86 E: 3264552.20	6981.41	48	ВОР	N: 1418486.02 E: 3264482.00	6981.41	59
5	TOP	N: 1418471.31 E: 3264548.91	6984.50	16	TOP	N: 1418534.96 E: 3264501.99	6984.50	27	TOP	N: 1418412.24 E: 3264470.64	6984.50	38	ВОР	N: 1418496.21 E: 3264550.41	6981.41	49	ВОР	N: 1418520.42 E: 3264508.47	6981.00	
6	TOP	N: 1418443.72 E: 3264527.68	6984.50	17	TOP	N: 1418554.61 E: 3264504.50	6985.07	28	TOP	N: 1418428.99 E: 3264448.54	6984.46	39	ВОР	N: 1418463.64 E: 3264525.34	6981.41	50	ВОР	N: 1418526.76 E: 3264513.59	6981.01	
7	TOP	N: 1418426.11 E: 3264514.12	6984.50	18	TOP	N: 1418536.05 E: 3264552.75	6984.50	29	TOP	N: 1418443.74 E: 3264438.30	6984.50	40	ВОР	N: 1418431.07 E: 3264500.27	6981.41	51	ВОР	N: 1418517.98 E: 3264536.88	6981.41	
8	TOP	N: 1418414.33 E: 3264499.06	6984.50	19	TOP	N: 1418521.37 E: 3264569.71	6984.50	30	TOP	N: 1418471.06 E: 3264440.62	6985.37	41	ВОР	N: 1418427.64 E: 3264493.13	6981.30	52	BEGIN MAINT. RD	N: 1418568.94 E: 3264485.87	6984.62	
9	TOP	N: 1418414.71 E: 3264485.96	6984.50	20	TOP	N: 1418504.63 E: 3264576.09	6984.50	31	TOP	N: 1418521.30 E: 3264478.86	6985.06	42	ВОР	N: 1418429.43 E: 3264487.65	6981.22	53	BEGIN MAINT. RD	N: 1418576.86 E: 3264491.97	6984.65	
10	TOP	N: 1418420.16 E: 3264476.74	6984.50	21	TOP	N: 1418487.03 E: 3264572.78	6984.50	32	TOP	N: 1418488.20 E: 3264453.43	6985.27	43	ВОР	N: 1418436.14 E: 3264478.93	6981.00	54	MAINT. RD/BP	N: 1418517.87 E: 3264524.89	6981.00	
11	TOP	N: 1418436.33 E: 3264455.72	6984.50	22	TOP	N: 1418462.35 E: 3264554.63	6984.50	33	ТОР	N: 1418543.64 E: 3264496.48	6985.01	44	ВОР	N: 1418441.01 E: 3264472.59	6981.00	55	MAINT. RD/BP	N: 1418525.80 E: 3264530.99	6981.65	

ABBREVIATIONS
TC = TRICKLE CHANNEL BP/BOP = BOTTOM OF POND TOP = TOP OF POND SW = SPILLWAY

MAINT. RD

MAINT. RD

N: 1418472.91


E: 3264507.24

N: 1418479.36

E: 3264502.11

6981.00

6981.00

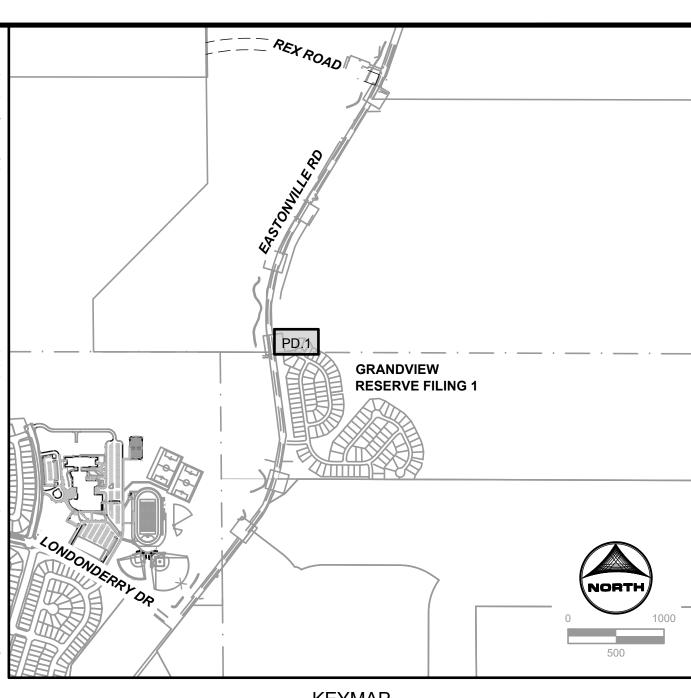

KEYMAP

- GRADING NOTES:

 1. ALL PROPOSED CONTOURS ARE TO FINISHED GRADE.
- EARTHEN CUT AND FILL SLOPES SHALL BE 3:1 MAXIMUM. SLOPES IN EXCESS OF 4:1 AND AREAS OTHERWISE INDICATED BY WITHIN THESE PLANS. SHALL BE COVERED WITH SOIL RETENTION BLANKET OVER 4" MIN. THICKNESS OF TOPSOIL AND SEEDED.
- IF THE PROJECT IS CONSTRUCTED DURING THE SUMMER WHEN SEEDING IS NOT ALLOWED, APPLY 1-1/2 TONS OF CERTIFIED WEED FREE MULCH PER ACRE MECHANICALLY CRIMPED INTO THE SOIL IN COMBINATION WITH AN ORGANIC MULCH TACKIFIER.
- PRIOR TO ANY CONSTRUCTION ACTIVITIES THE PROPOSED SILT FENCE SHOWN ON THE EROSION CONTROL SHEET SHALL BE CONSTRUCTED. THE FENCE SHALL BE REMOVED UPON THE LATER OF STABILIZATION OF THE SITE OR COMPLETION OF CONSTRUCTION.
- TO REDUCE THE POTENTIAL FOR CLOGGING OF DEBRIS GRATES, NO STRAW MULCH SHALL BE USED WITHIN THE EURV OR WQCV OF A DETENTION BASIN. INSTEAD, EROSION CONTROL BLANKETS SHALL BE INSTALLED FOR A WIDTH OF AT LEAST 6 FEET ON EITHER SIDE OF CONCRETE LOW-FLOW CHANNELS. THE BLANKETS SHALL COMPLY WITH THE MATERIALS AND INSTALLATION REQUIREMENTS FOR EROSION CONTROL BLANKETS (STRAW COCONUT OR 100 PERCENT COCONUT.) SITE-SPECIFIC CONDITIONS MAY REQUIRE ADDITIONAL BLANKET OR OTHER EROSION CONTROL MEASURES.



Know what's below.

Call before you dig.

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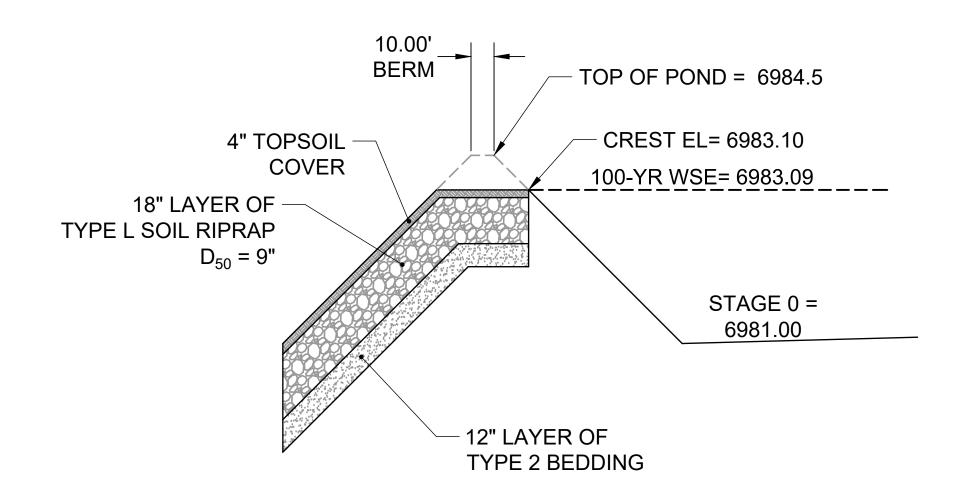
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EASTONVILLE ROAD SEGEMENT 1 IMPROVEMENTS


SAND FILTER GRADING PLAN

SHEET




PROFILE VIEW -EMERGENCY OVERFLOW SPILLWAY

SCALE: NTS

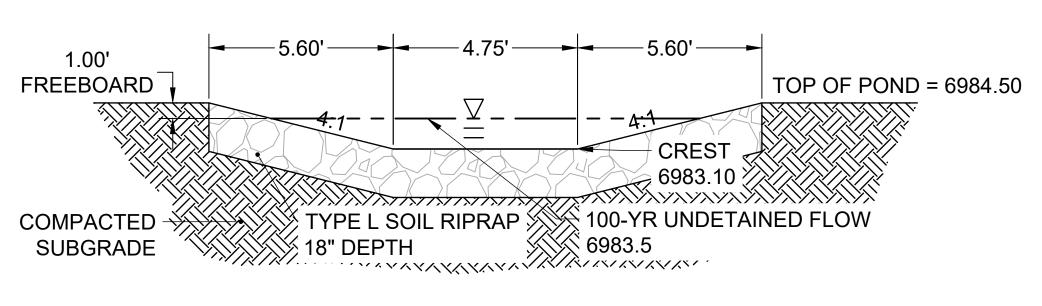

SECTION VIEW -EMERGENCY SPILLWAY

SCALE: NTS

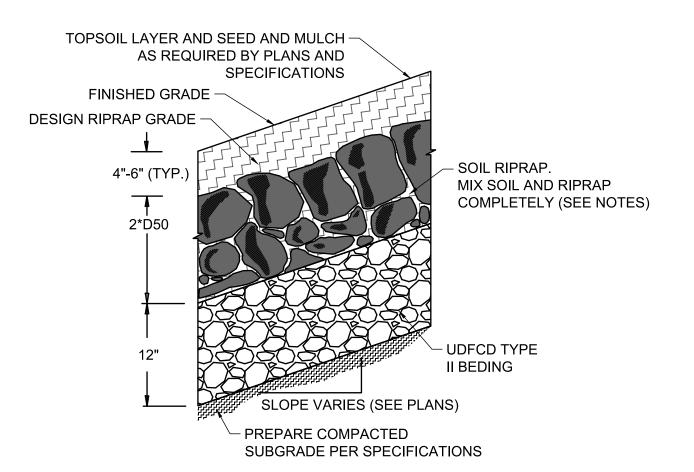

SOIL RIPRAP EMBANKMENT PROTECTION WITH BEDDING TYP. SECTION

N.T.S


TYPE L RIPRAP

INTERMEDIATE	PERCENT
ROCK DIMENSION	PASSING
(IN .)	(%)
15	70-100
12	50-70
9	35-50
3	2-10

*TYPE L RIPRAP D50=9". D50=MEAN PARTICLE SIZE (INTERMEDIATE DIMENSION) BY WEIGHT

RIPRAP NOTES.


- SOIL RIPRAP DETAILS ARE APPLICABLE TO SLOPED AREAS REFER TO THE SITE PLAN ACTUAL LOCATION AND LIMITS.
- 2. MIX UNIFORMLY 65% RIPRAP BY VOLUME WITH 35% OF APPROVED SOIL BY VOLUME PRIOR TO PLACEMENT.
- 3. PLACE STONE-SOIL MIX TO RESULT IN SECURELY INTERLOCKED ROCK AT THE DESIGN THICKNESS AND GRADE. COMPACT AND LEVEL TO ELIMINATE ALL VOIDS AND ROCKS PROJECTING ABOVE DESIGN RIPRAP TOP GRADE.
- 4. CRIMP OR TACKIFY MULCH OR USE APPROVED HYDROMULCH AS CALLED FOR IN THE PLANS AND SPECIFICATIONS.
- 5. ROCK SHALL BE HARD, DURABLE, ANGULAR IN SHAPE, AND FREE FROM CRACKS, OVERBURDEN, SHALE, AND ORGANIC MATTER.
- 6. NEITHER BREADTH NOR THICKNESS OF A SINGLE STONE SHOULD BE LESS THAN ONE-THIRD ITS LENGTH, AND ROUNDED STONE SHOULD BE AVOIDED.
- 7. THE ROCK SHOULD SUSTAIN A LOSS OF NOT MORE THAN 40% AFTER 500 REVOLUTIONS IN AN ABRASION TEST (LOS ANGELES MACHINEASTM C-535-69) AND SHOULD SUSTAIN A LOSS OF NOT MORE THAN 10% AFTER 12 CYCLES OF FREEZING AND THAWING (AASHTO TEST 103 FOR LEDGE ROCK PROCEDURE A).
- 8. ROCK HAVING A MINIMUM SPECIFIC GRAVITY OF 2.65 IS PREFERRED; HOWEVER, IN NO CASE SHOULD ROCK HAVE A SPECIFIC GRAVITY LESS THAN 2.50.

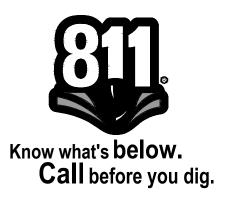

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	DRAWN BY:	ACH	JOB DATE:	1/12/2024	BAR IS ONE INCH ON OFFICIAL DRAWINGS.	NO.	DATE	BY	REVISION DESCRIPTION
	APPROVED:	СРМ	JOB NUMBER:	201662.08	0 11 1"				
	CAD DATE:	1/12/2024			IF NOT ONE INCH, ADJUST SCALE ACCORDINGLY.				
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SAND FILTER DETAILS



ORIFICE PLATE NOTES:

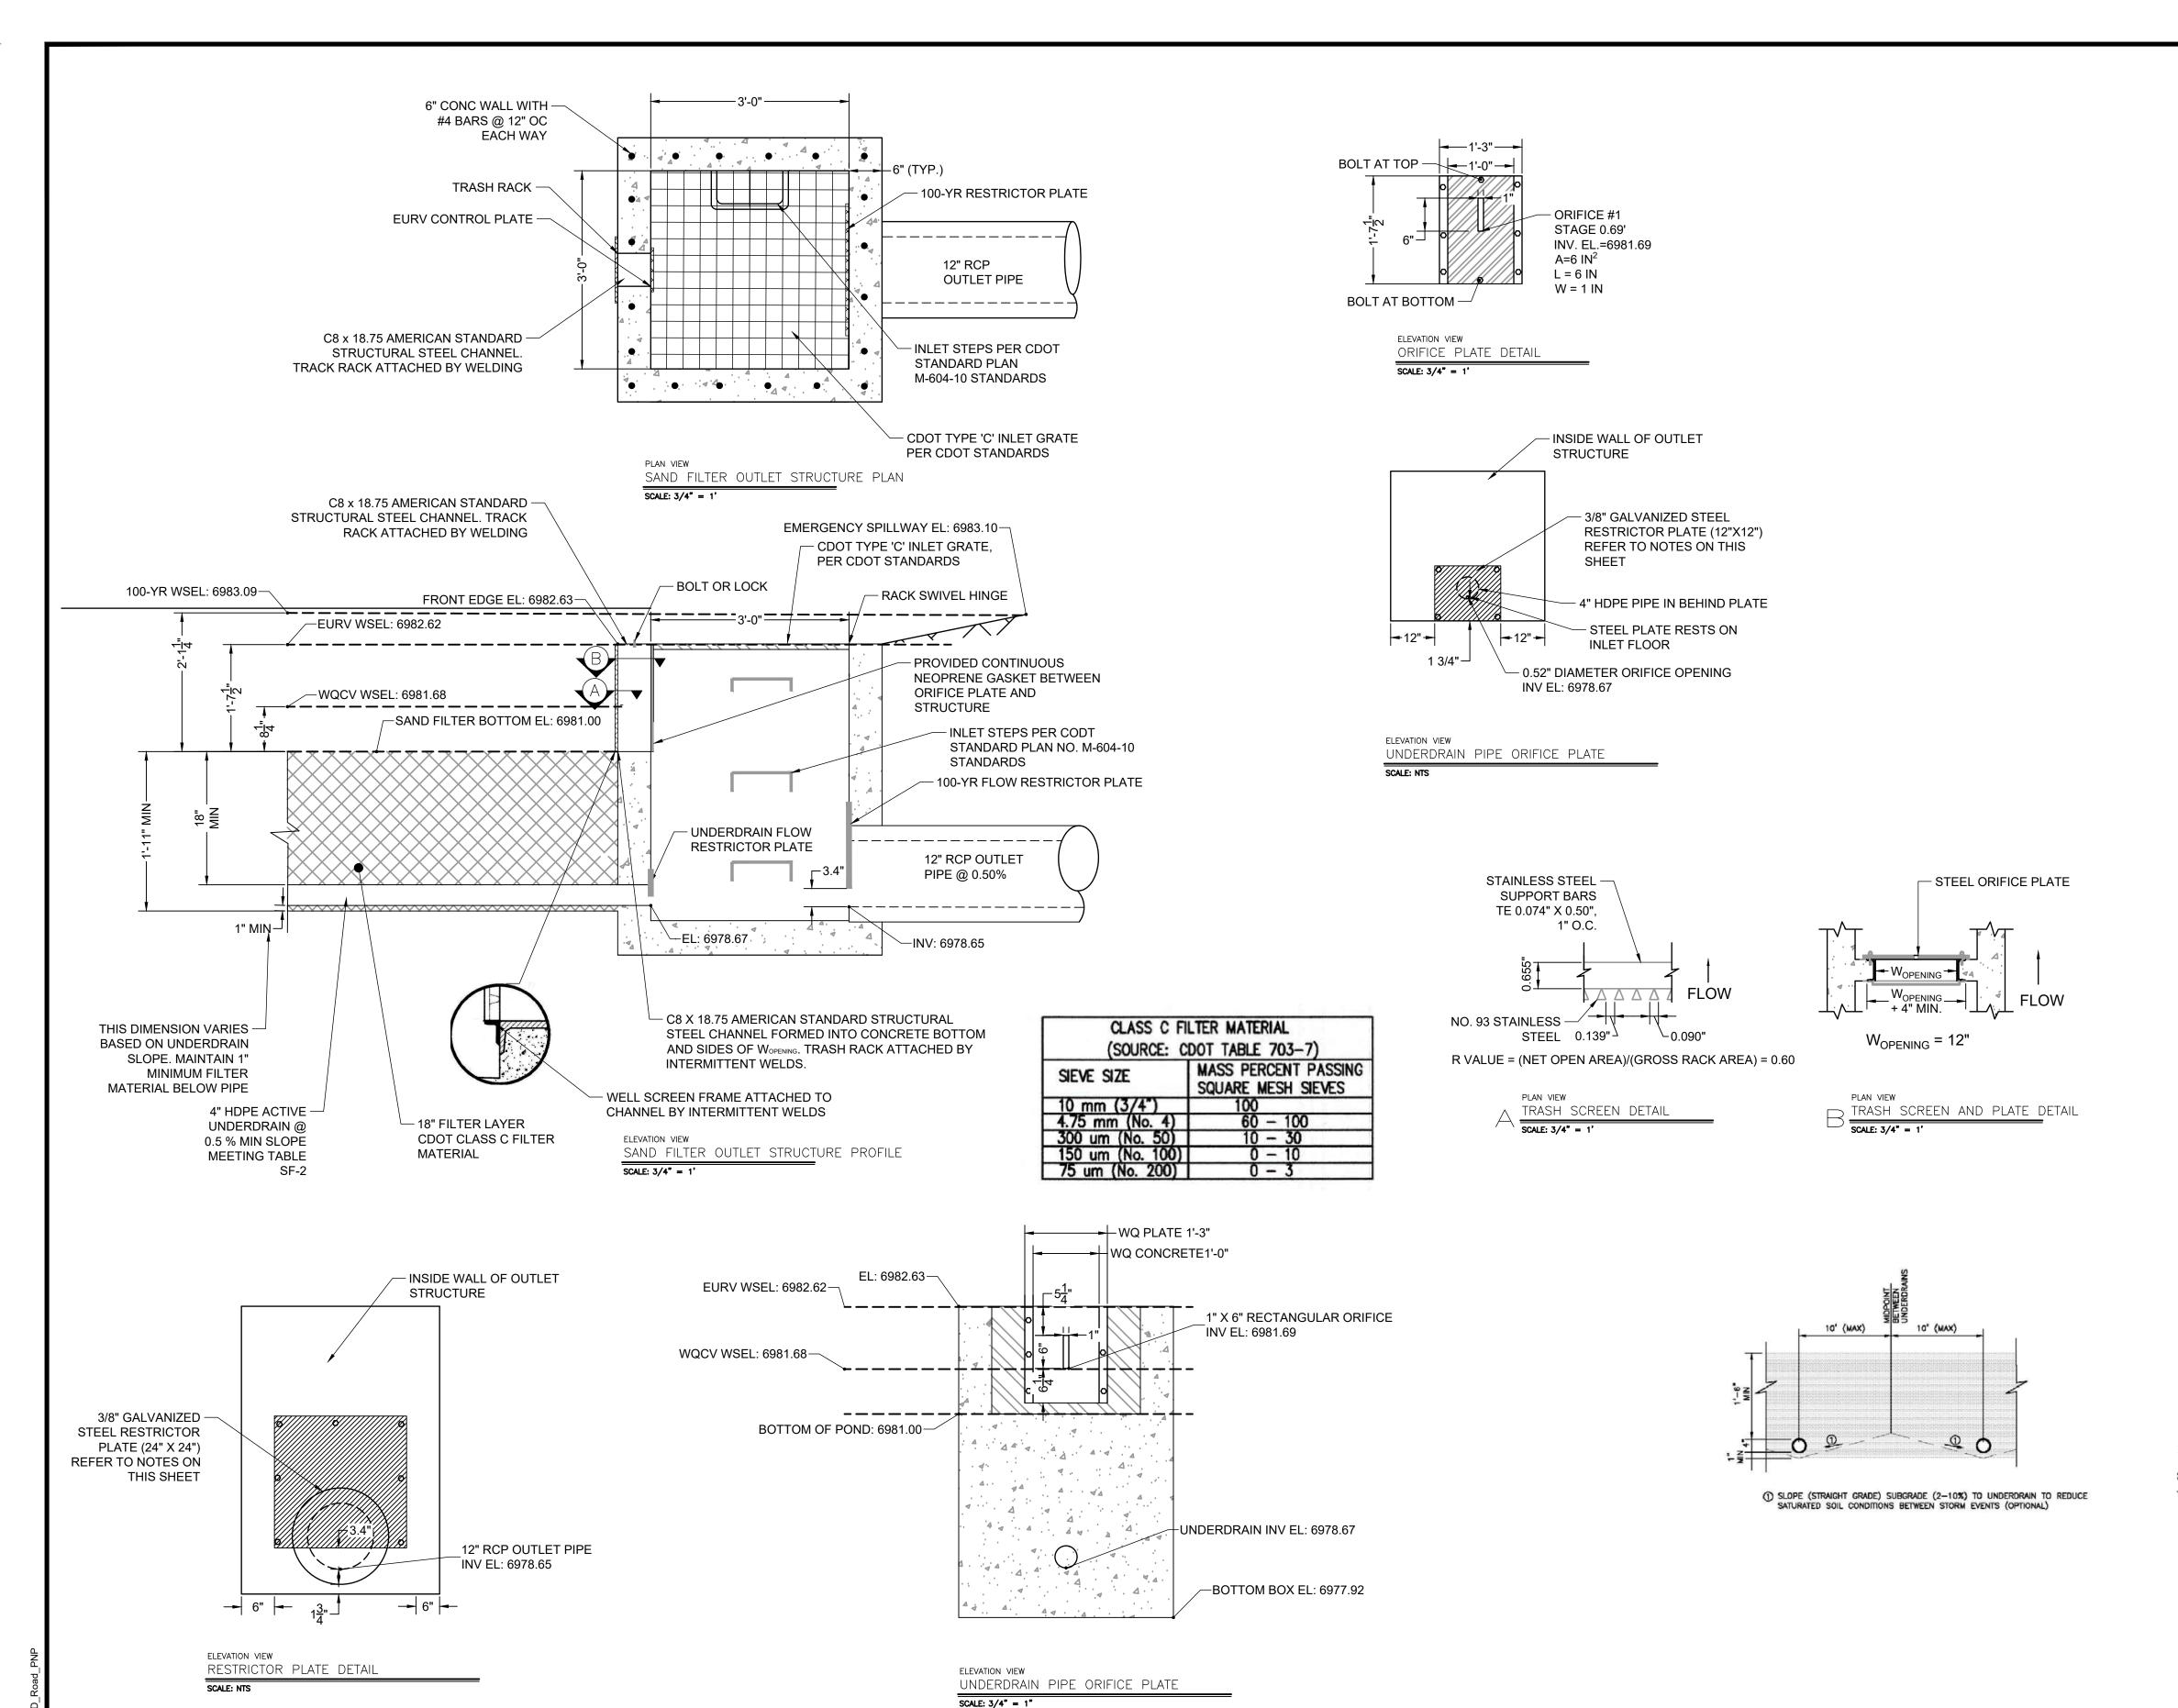- 1. PLATE TO BE \(\frac{3}{8}\)" THICK GALVANIZED STEEL.
- 2. BOLT PLATE TO CONCRETE 16" O.C. MAX.
- 3. PROVIDE CONTINUOUS NEOPRENE GASKET MATERIAL BETWEEN THE ORIFICE PLATE AND CONCRETE

TRASH SCREEN NOTES:

- 1. WELL-SCREEN TRASH RACKS SHALL BE STAINLESS STEEL AND SHALL BE ATTACHED BY INTERMITTENT WELDS ALONG THE EDGE OF THE MOUNTING FRAME.
- 2. BAR GATE TRASH RACKS SHALL BE ALUMINUM AND SHALL BE BOLTED USING STAINLESS STEEL HARDWARE.
- 3. TRASH RACK OPEN AREAS ARE FOR SPECIFIED TRASH RACK MATERIALS. TOTAL TRASH RACK SIZE MAY NEED TO BE ADJUSTED FOR MATERIALS HAVING DIFFERENT OPEN AREA/GROSS AREA RATIO (R VALUE).
- 4. STRUCTURAL DESIGN OF TRASH RACKS SHALL BE BASED ON FULL HYDROSTATIC HEAD WITH ZERO HEAD DOWNSTREAM OF THE RACK..

RESTRICTOR PLATE NOTES:

- 3" THICK RESTRICTOR PLATE, GALVANIZED STEEL.
- BOLT PLATE TO CONCRETE @ 12" O.C. MAX
- 3. PROVIDE CONTINUOUS NEOPRENE GASKET MATERIAL
- BETWEEN PLATE AND CONCRETE 4. CONTRACTOR SHALL SUBMIT SHOP DRAWINGS FOR ALL PLATES AND GRATING FOR ENGINEER'S APPROVAL PRIOR TO CONSTRUCTION.

WARNING THIS AREA IS A STORMWATER FACILITY AND IS SUBJECT TO PERIODIC FLOODING

POND WARNING SIGN

SCALE: NTS

MINIMUM SIGN AREA = 3 FT^2

SIGNS SHALL BE FABRICATED OF DURABLE MATERIALS, SUCH AS METAL OR PLASTIC, USING RED LETTERING ON A WHITE BACKGROUND

TWO SIGNS. EACH WITH A MINIMUM AREA OF 3 SQUARE FEET. SHALL BE PROVIDED AROUND THE PERIMETER OF ALL DETENTION FACILITIES. THE SIGNS SHALL BE FABRICATED OF DURABLE MATERIALS, SUCH AS METAL OR PLASTIC, USING RED LETTERING ON A WHITE BACKGROUND WITH THE ABOVE MESSAGE

Table SF-2. Dimensions for Slotted Pipe¹

Pipe Size	Slot Length	Maximum Slot Width	Slot Centers	Open Area (per foot)
4"	1-1/16"	0.032"	0.413"	1.90 in ²
6"	1-3/8"	0.032"	0.516"	1.98 in ²

¹ Pipe must conform to requirements of ASTM designation F949. There shall be no evidence of splitting, cracking, or breaking when the pipe is tested per ASTM test method D2412 in accordance with F949 section 7.5 and ASTM F794 section 8.5. Contech A-2000 slotted pipe (or equal).



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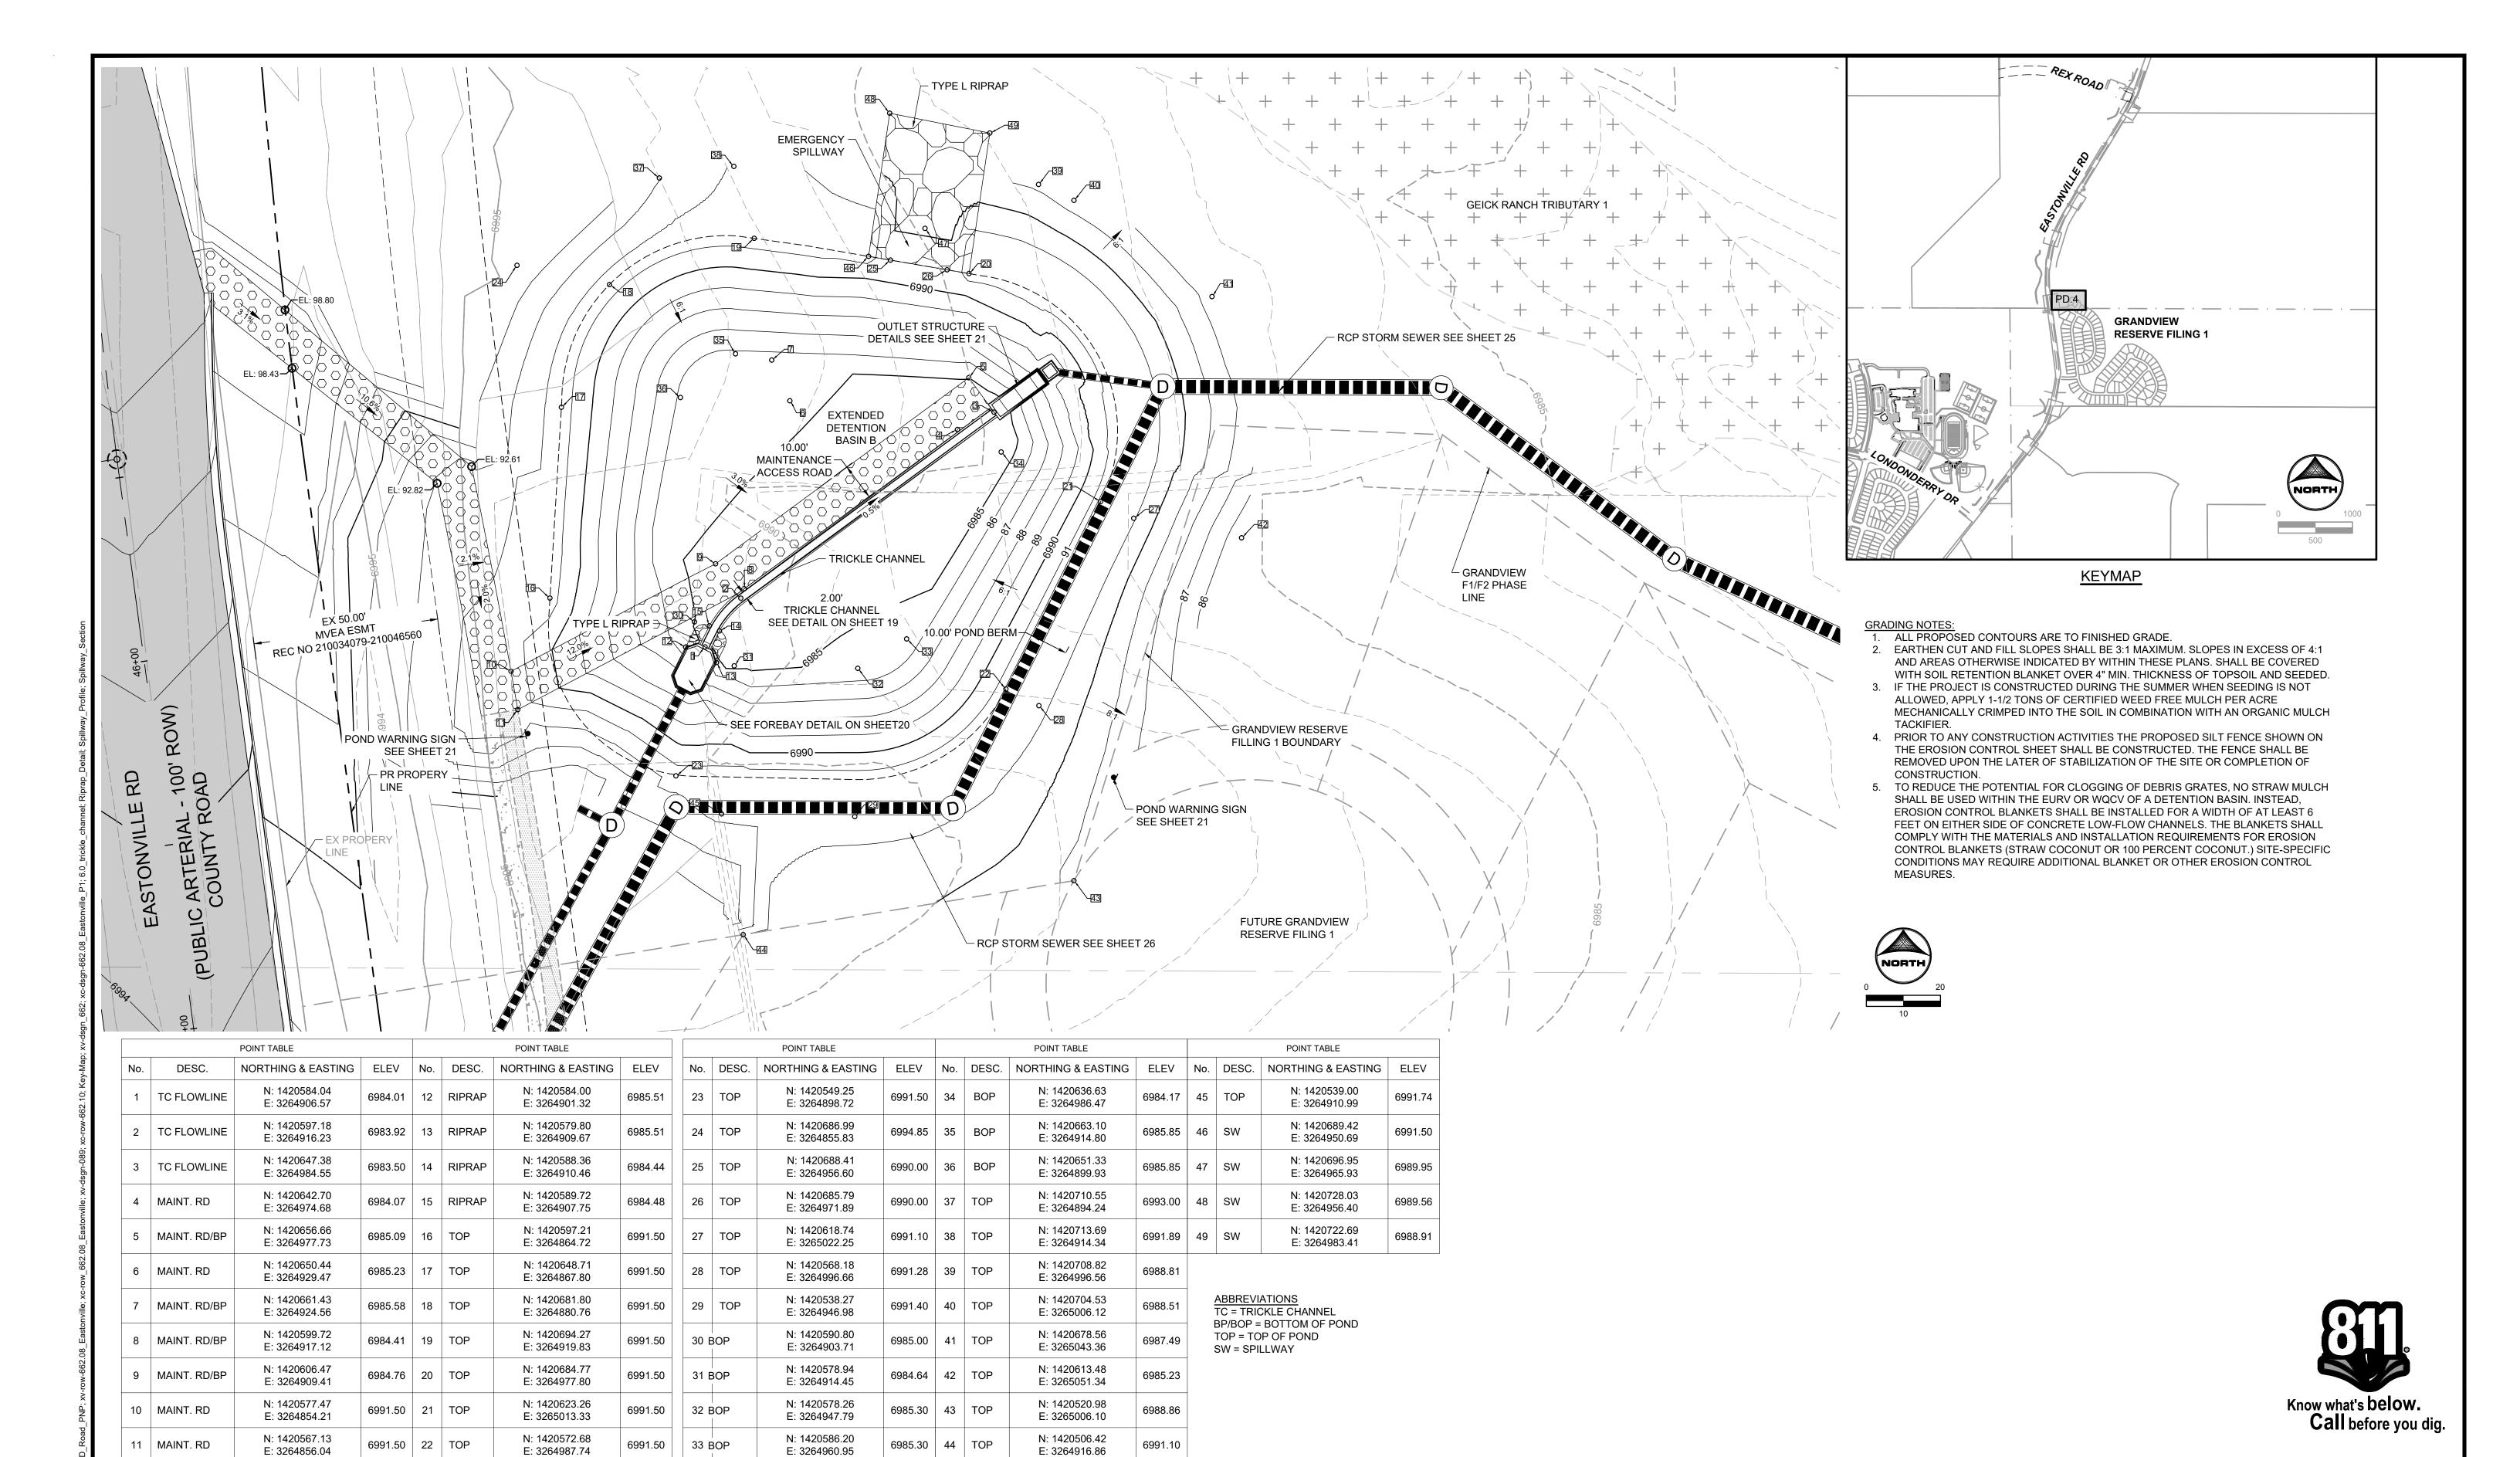
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EASTONVILLE ROAD SEGEMENT 1 IMPROVEMENTS

SAND FILTER OUTLET STRUCTURE

SHEET



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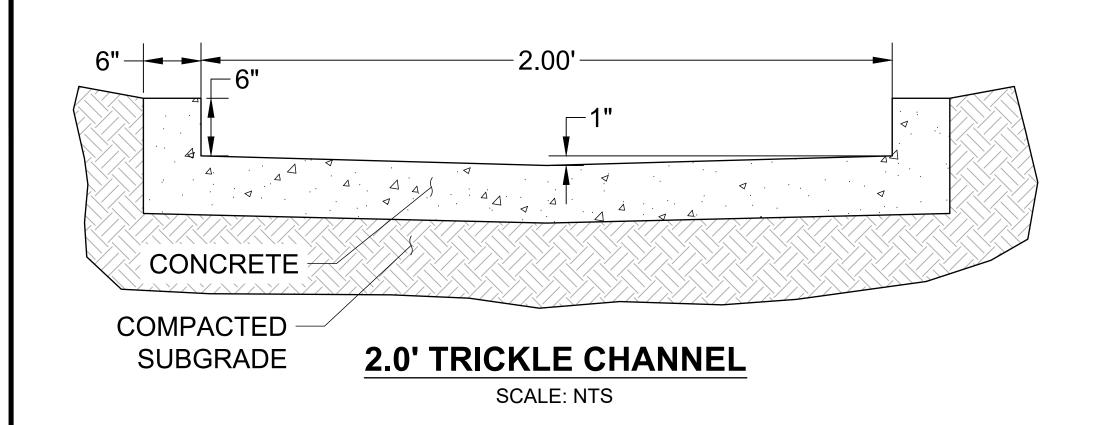
EASTONVILLE ROAD IMPROVEMENTS DR. HORTON EL PASO COUNTY, COLORADO


D·R·HORTON America's Builder

EASTONVILLE ROAD SEGEMENT 1 IMPROVEMENTS POND GRADING PLAN

SHEET

18



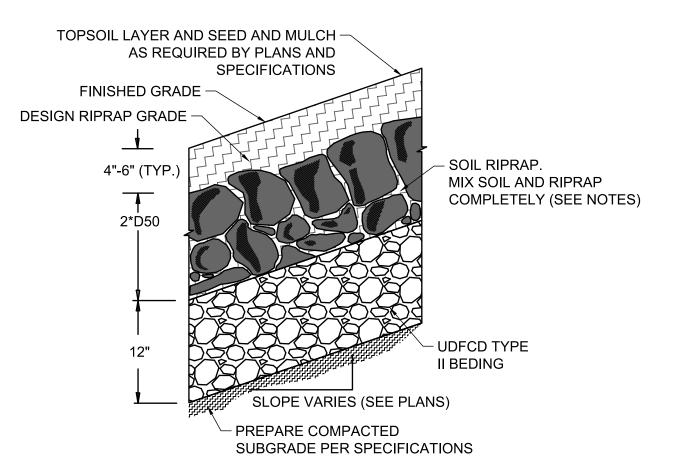


SOIL RIPRAP EMBANKMENT PROTECTION WITH BEDDING TYP. SECTION

N.T.S

TYPE L RIPRAP


INTERMEDIATE	PERCENT
ROCK DIMENSION	PASSING
(IN .)	(%)
15	70-100
12	50-70
9	35-50
3	2-10

*TYPE L RIPRAP D50=9". D50=MEAN PARTICLE SIZE (INTERMEDIATE DIMENSION) BY WEIGHT

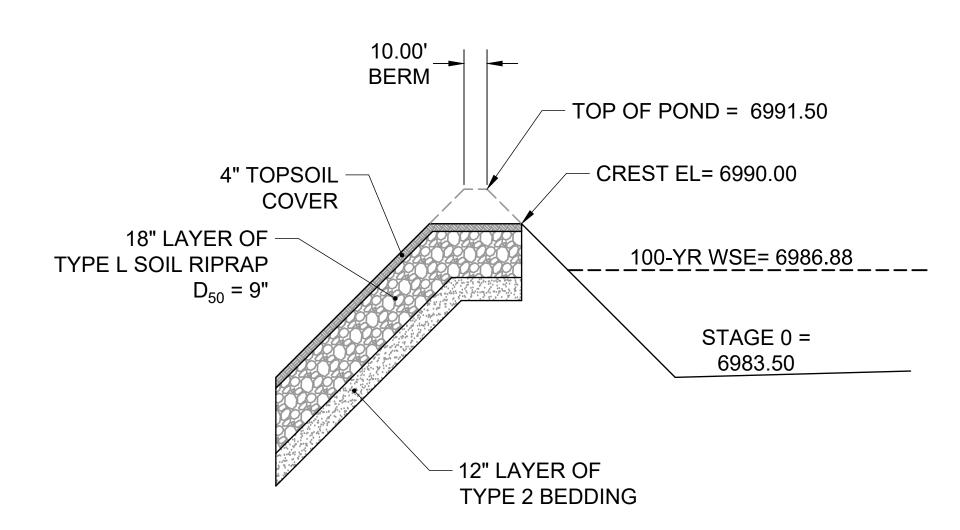

PROFILE VIEW -EMERGENCY OVERFLOW SPILLWAY

SCALE: NTS

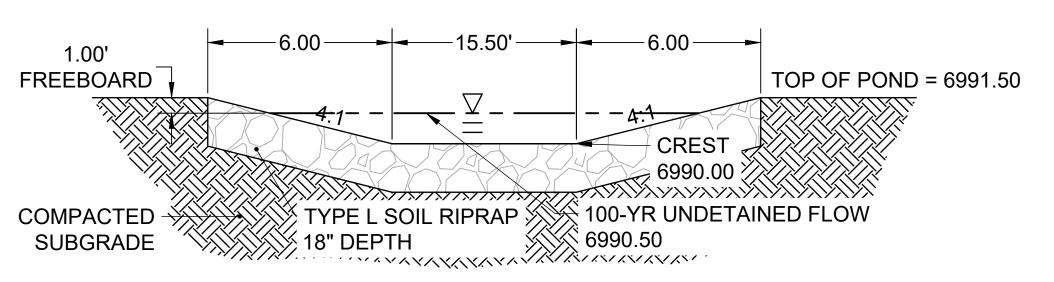

SECTION VIEW -EMERGENCY SPILLWAY

SCALE: NTS

Know what's below. Call before you dig.

BAR IS ONE INCH ON OFFICIAL DRAWINGS. NO. DATE BY REVISION DESCRIPTION DRAWN BY: ACH JOB DATE: 1/12/2024 APPROVED: CPM JOB NUMBER: 201662.08 CAD DATE: 1/12/2024 CAD FILE: J:\2020\201662\CAD\Dwgs\C\Eastonville_Road_662.08\Segment_1\CD\Road_CDs\Pond_Plars



HR GREEN - COLORADO SPRINGS 1975 RESEARCH PARKWAY SUITE 230 COLORADO SPRINGS CO 80920 HRGreen PHONE: 719.300.4140 FAX: 713.965.0044

EASTONVILLE ROAD IMPROVEMENTS DR. HORTON EL PASO COUNTY, COLORADO



RIPRAP NOTES.

AVOIDED.

THAN 2.50.

EASTONVILLE ROAD SEGEMENT 1 IMPROVEMENTS POND DETAILS

PD.5

SOIL RIPRAP DETAILS ARE APPLICABLE TO SLOPED AREAS REFER TO THE

THE DESIGN THICKNESS AND GRADE. COMPACT AND LEVEL TO ELIMINATE ALL VOIDS AND ROCKS PROJECTING ABOVE DESIGN RIPRAP TOP GRADE.

5. ROCK SHALL BE HARD, DURABLE, ANGULAR IN SHAPE, AND FREE

LESS THAN ONE-THIRD ITS LENGTH, AND ROUNDED STONE SHOULD BE

500 REVOLUTIONS IN AN ABRASION TEST (LOS ANGELES MACHINEASTM C-535-69) AND SHOULD SUSTAIN A LOSS OF NOT MORE THAN 10%

AFTER 12 CYCLES OF FREEZING AND THAWING (AASHTO TEST 103 FOR

HOWEVER, IN NO CASE SHOULD ROCK HAVE A SPECIFIC GRAVITY LESS

3. PLACE STONE-SOIL MIX TO RESULT IN SECURELY INTERLOCKED ROCK AT

4. CRIMP OR TACKIFY MULCH OR USE APPROVED HYDROMULCH AS CALLED

2. MIX UNIFORMLY 65% RIPRAP BY VOLUME WITH 35% OF APPROVED

FROM CRACKS, OVERBURDEN, SHALE, AND ORGANIC MATTER.

6. NEITHER BREADTH NOR THICKNESS OF A SINGLE STONE SHOULD BE

7. THE ROCK SHOULD SUSTAIN A LOSS OF NOT MORE THAN 40% AFTER


8. ROCK HAVING A MINIMUM SPECIFIC GRAVITY OF 2.65 IS PREFERRED;


SITE PLAN ACTUAL LOCATION AND LIMITS.

SOIL BY VOLUME PRIOR TO PLACEMENT.

FOR IN THE PLANS AND SPECIFICATIONS.

LEDGE ROCK PROCEDURE A).

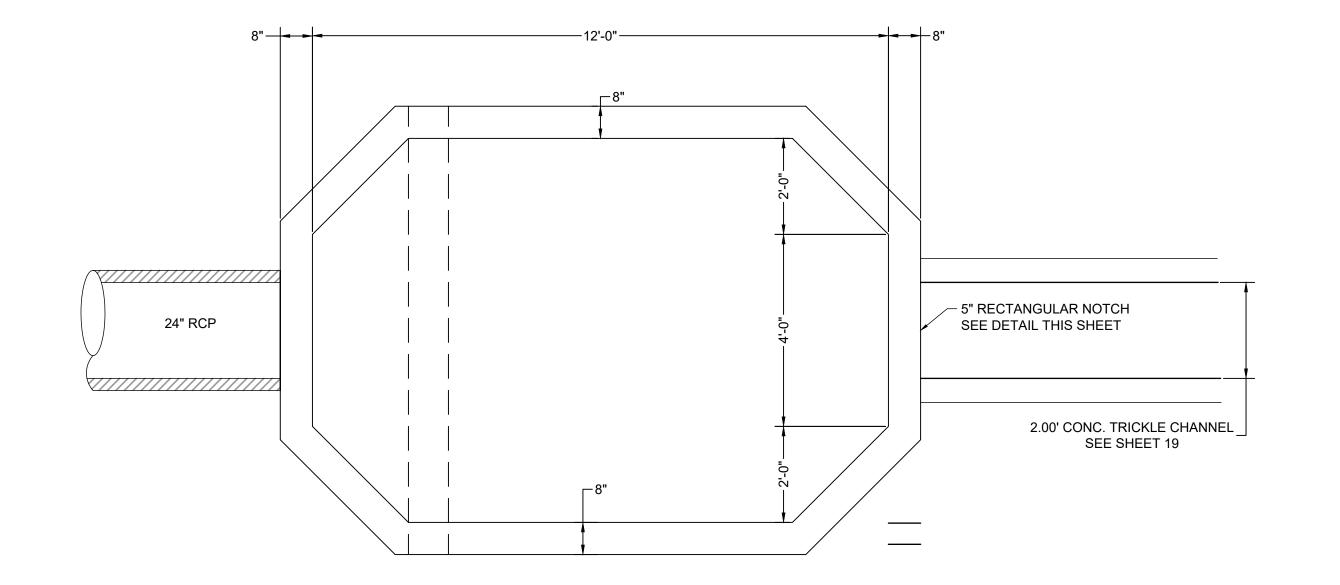

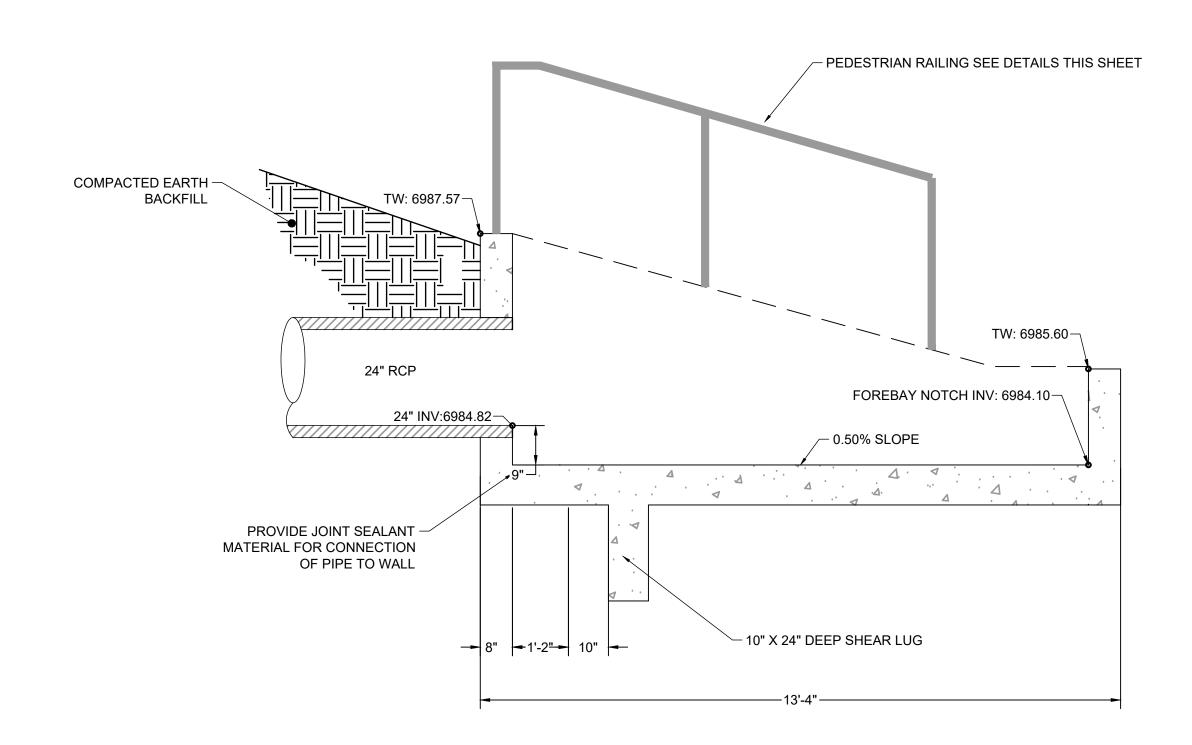



				5.5.10.005.000	l				
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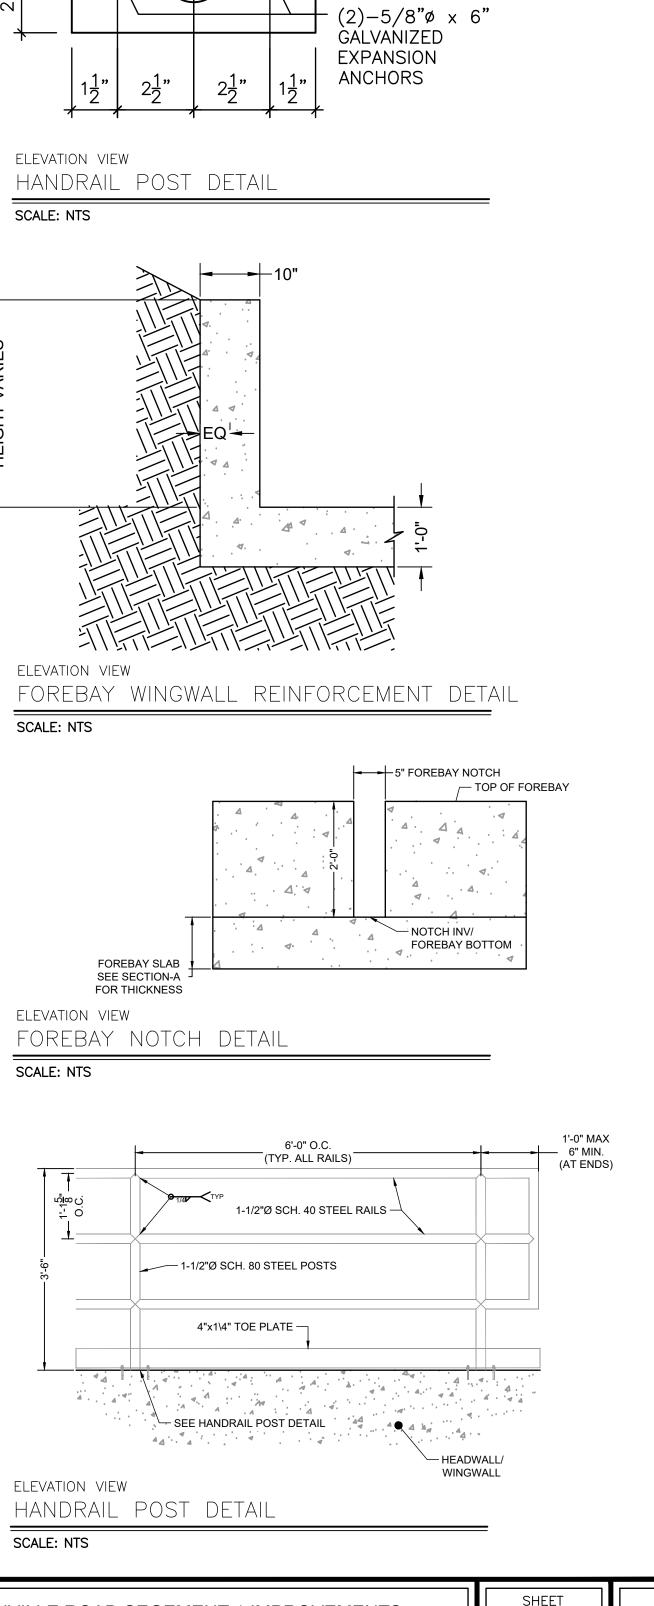
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1975 RESEARCH PARKWAY SUITE 230
COLORADO SPRINGS CO 80920
PHONE: 719.300.4140
FAX: 713.965.0044

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EASTONVILLE ROAD SEGEMENT 1 IMPROVEMENTS FOREBAY DETAILS

SHEET PD.6





— GUARDRAIL POST


5/16V Q

— GUARDRAIL BASE PL,

4"x8"X1/2"

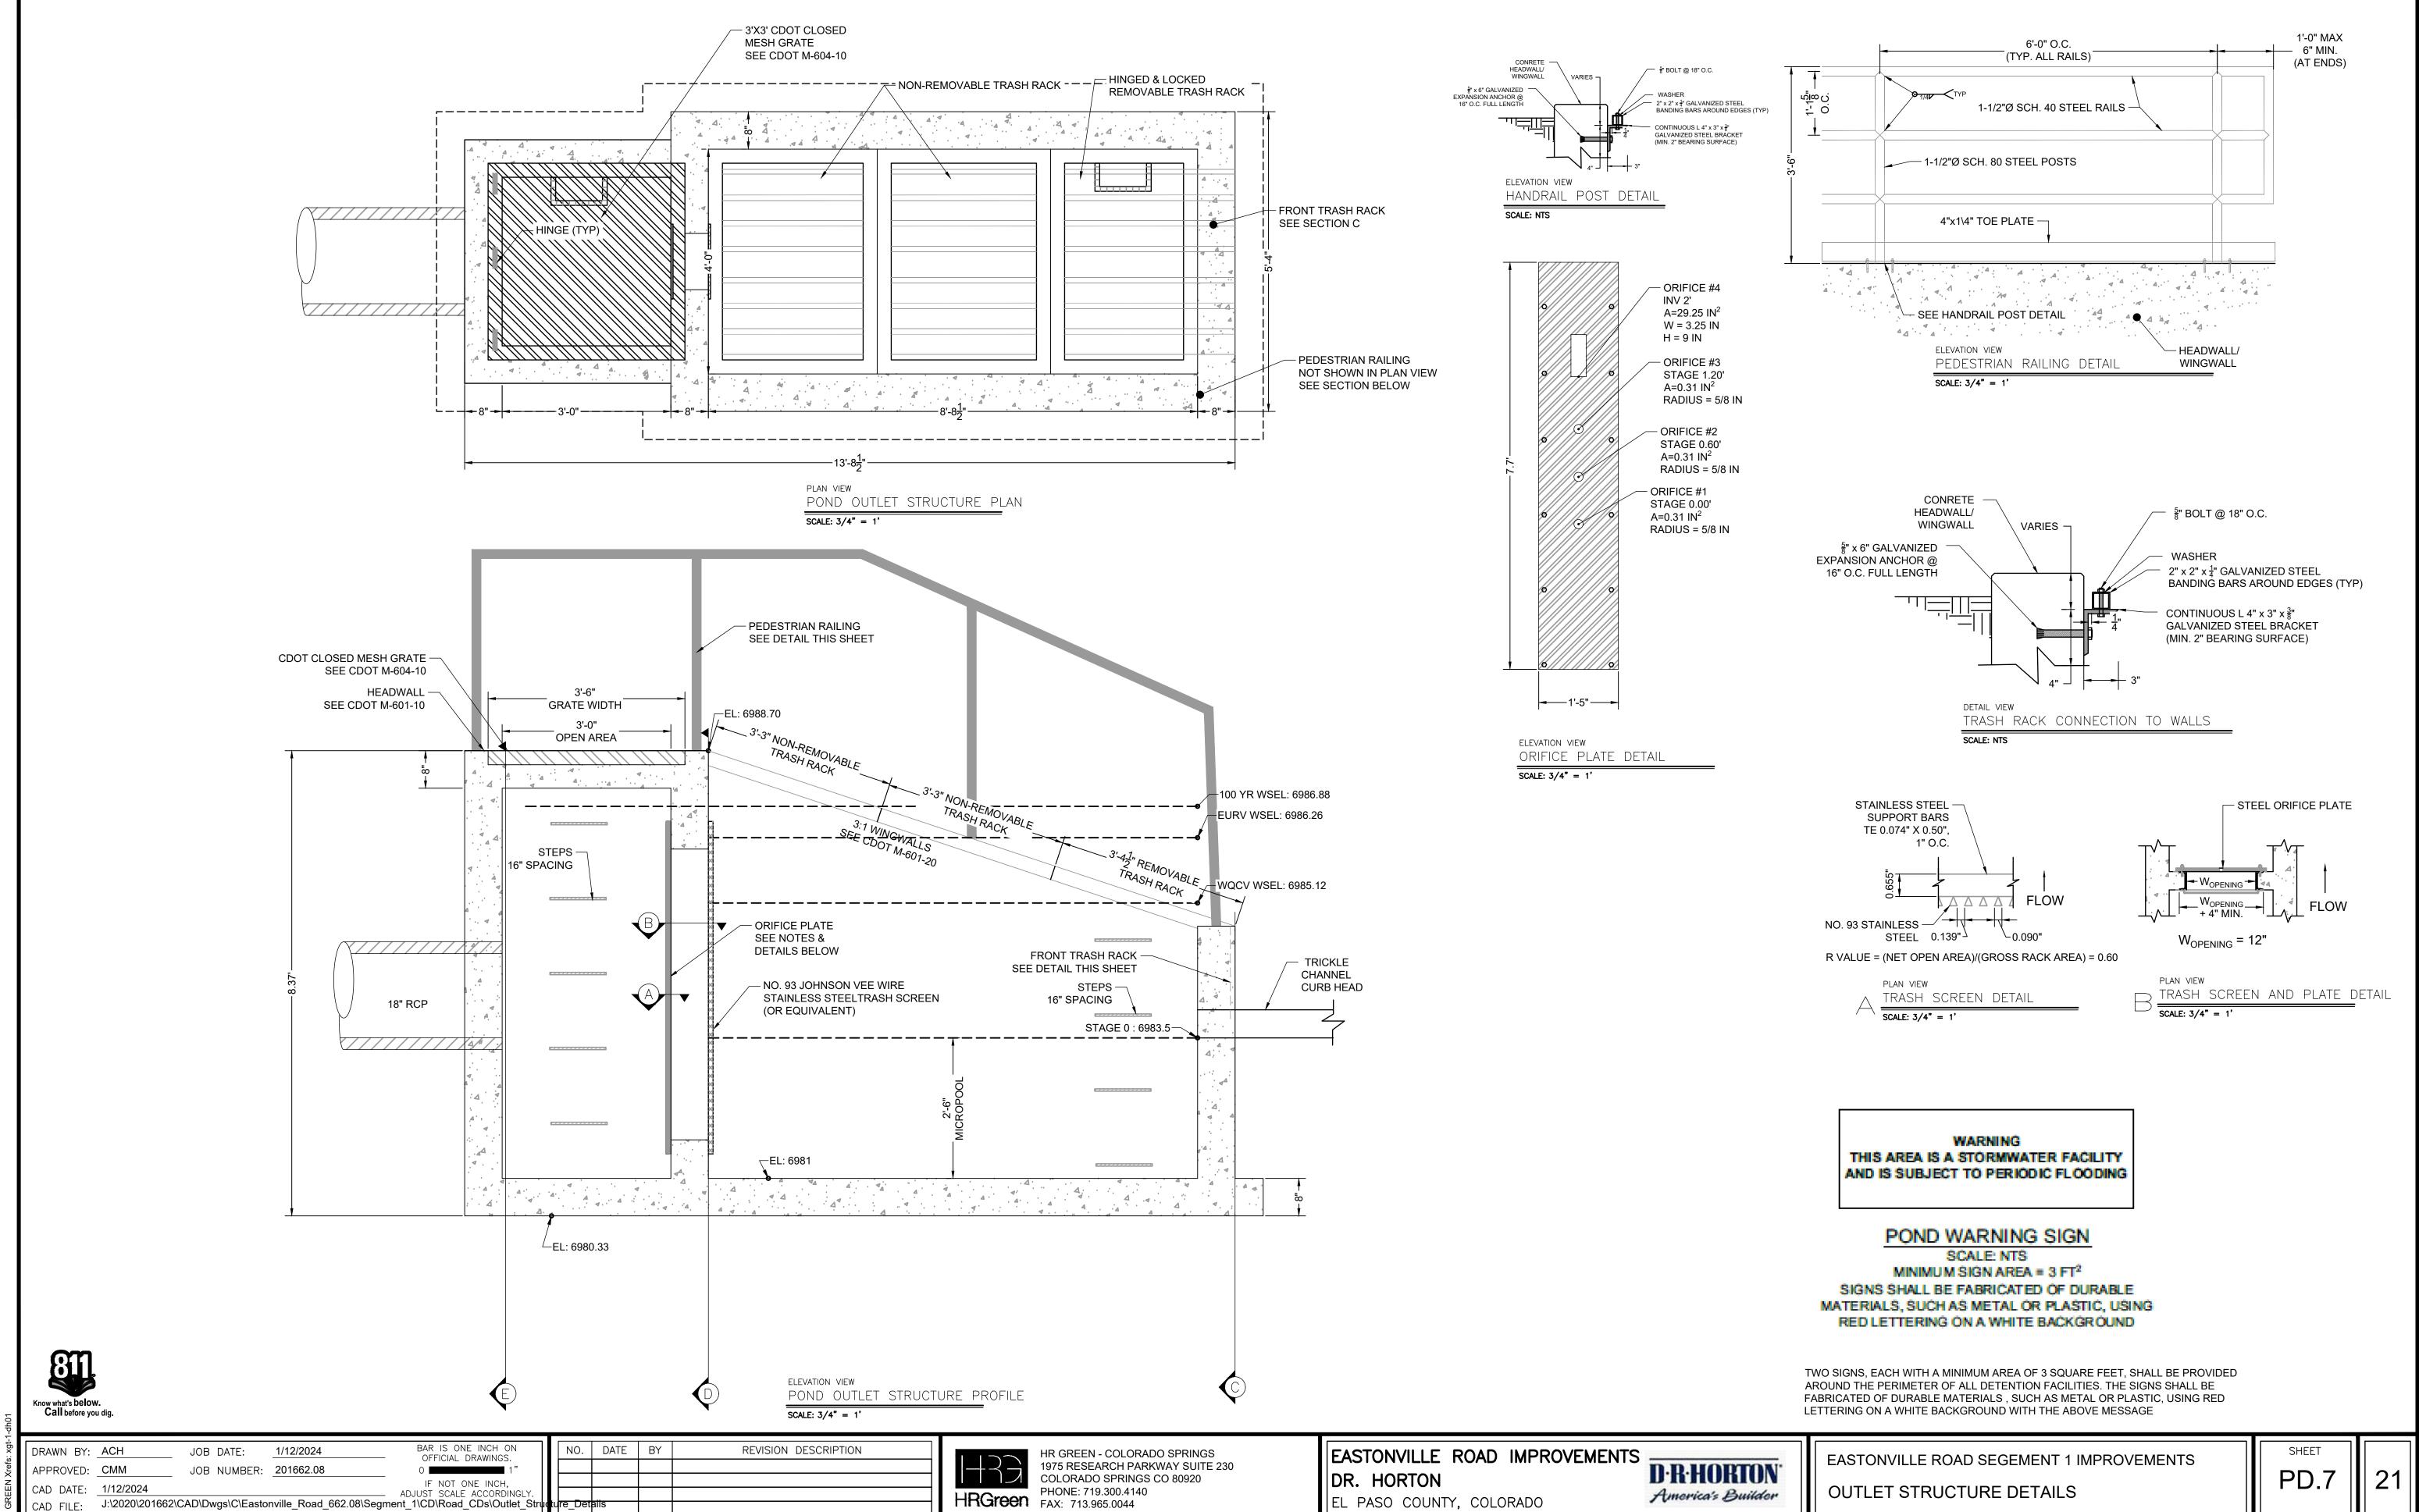

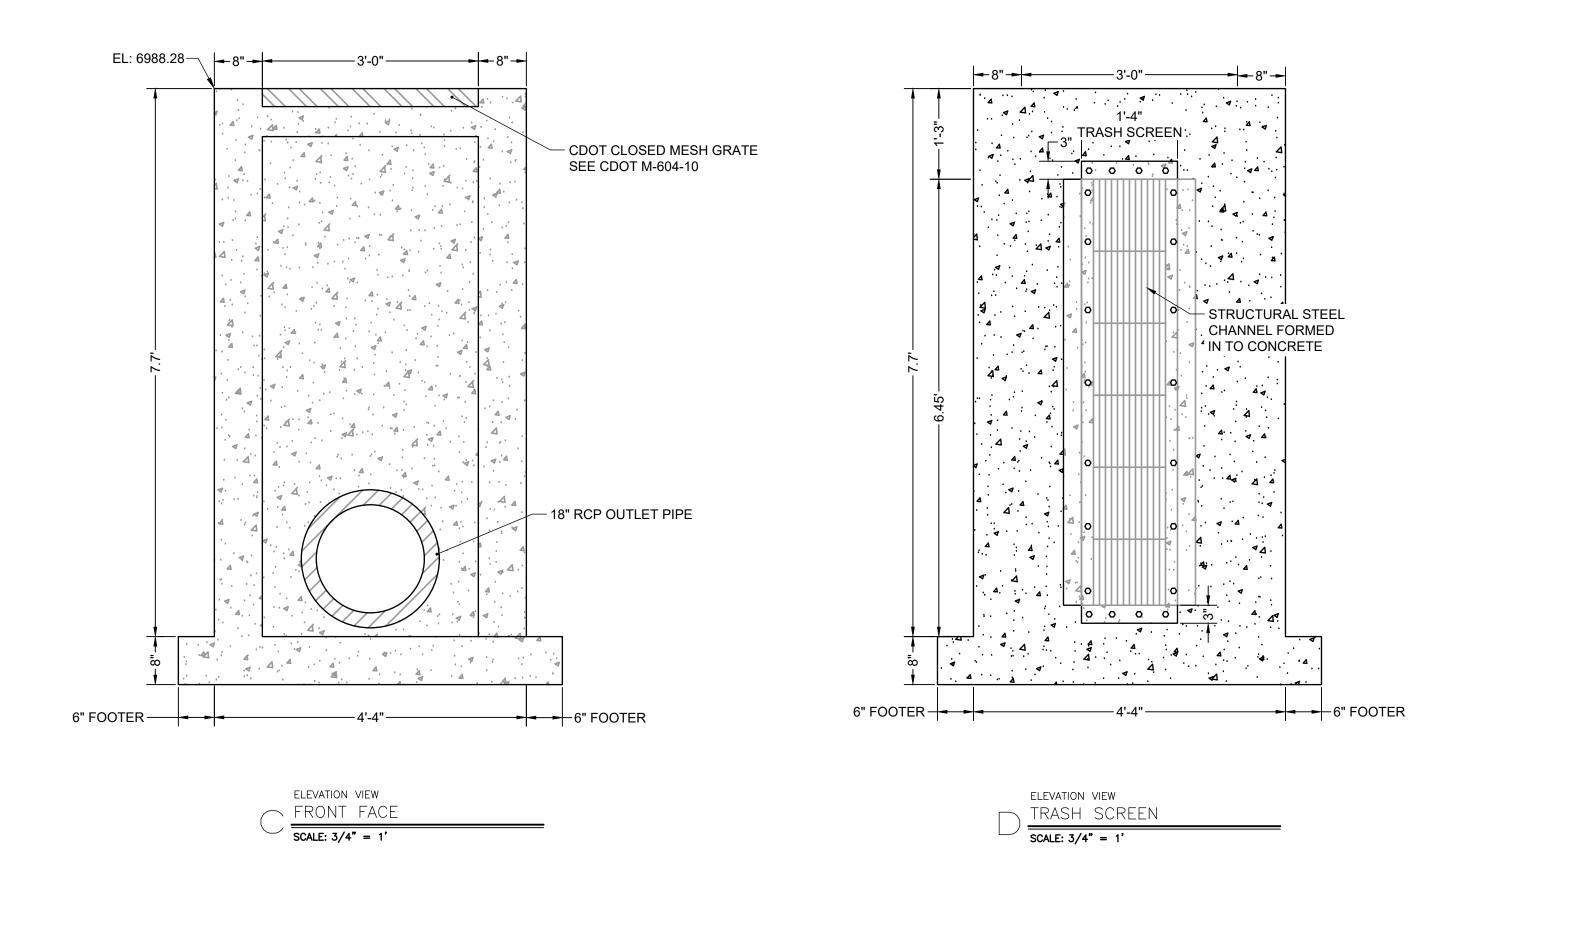

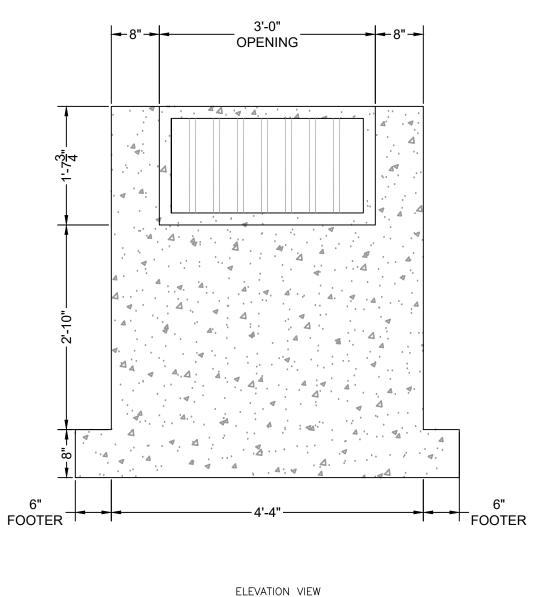

REAR FACE SCALE: 3/4" = 1'

ORIFICE PLATE NOTES:

- 1. PLATE TO BE $\frac{3}{8}$ " THICK GALVANIZED STEEL..
- 2. BOLT PLATE TO CONCRETE 16" O.C. MAX.
- 3. PROVIDE CONTINUOUS NEOPRENE GASKET MATERIAL BETWEEN THE ORIFICE PLATE AND CONCRETE

TRASH SCREEN NOTES:


- 1. WELL-SCREEN TRASH RACKS SHALL BE STAINLESS STEEL AND SHALL BE ATTACHED BY INTERMITTENT WELDS ALONG THE EDGE OF THE
- 2. BAR GATE TRASH RACKS SHALL BE ALUMINUM AND SHALL BE BOLTED USING STAINLESS STEEL HARDWARE.
- 3. TRASH RACK OPEN AREAS ARE FOR SPECIFIED TRASH RACK MATERIALS. TOTAL TRASH RACK SIZE MAY NEED TO BE ADJUSTED FOR MATERIALS HAVING DIFFERENT OPEN AREA/GROSS AREA RATIO (R VALUE).
- 4. STRUCTURAL DESIGN OF TRASH RACKS SHALL BE BASED ON FULL HYDROSTATIC HEAD WITH ZERO HEAD DOWNSTREAM OF THE RACK.

TRASH RACK NOTES:


- 1. TRASH RACKS SHALL BE $1\frac{1}{4}$ " SCH. 40 STEEL PIPE, GALVANIZED, @ 6" CENTERS. SUPPORT BARS SHALL BE $\frac{1}{4}$ " x 2" STEEL RECTANGULAR BARS, GALVANIZED, @ 36". ALL TRASH RACKS SHALL BE MOUNTED USING STAINLESS STEEL HARDWARE.
- 2. REMOVABLE TRASH RACK SECTIONS SHALL BE MOUNTED USING STAINLESS STEEL HARDWARE AND PROVIDED WITH HINGED & LOCKABLE OR
- BOLTABLE ACCESS PANELS AS SHOWN ON THE PLANS.
- 3. STEEL TRASH RACKS SHALL BE HOT DIP GALVANIZED AND MAY BE HOT POWDER COATED AFTER GALVANIZING. 4. STRUCTURAL STEEL FOR GRATES, ORIFICE PLATES, AND BARS SHALL BE GALVANIZED AND SHALL BE IN ACCORDANCE WITH CDOT STANDARD
- 5. CONTRACTOR SHALL SUBMIT SHOP DRAWINGS FOR ALL PLATES AND GRATING FOR ENGINEER'S APPROVAL PRIOR TO CONSTRUCTION.

RESTRICTOR PLATE NOTES:

- 1. $\frac{3}{8}$ " THICK RESTRICTOR PLATE, GALVANIZED STEEL.
- 2. BOLT PLATE TO CONCRETE @ 12" O.C. MAX
- 3. PROVIDE CONTINUOUS NEOPRENE GASKET MATERIAL BETWEEN PLATE AND CONCRETE

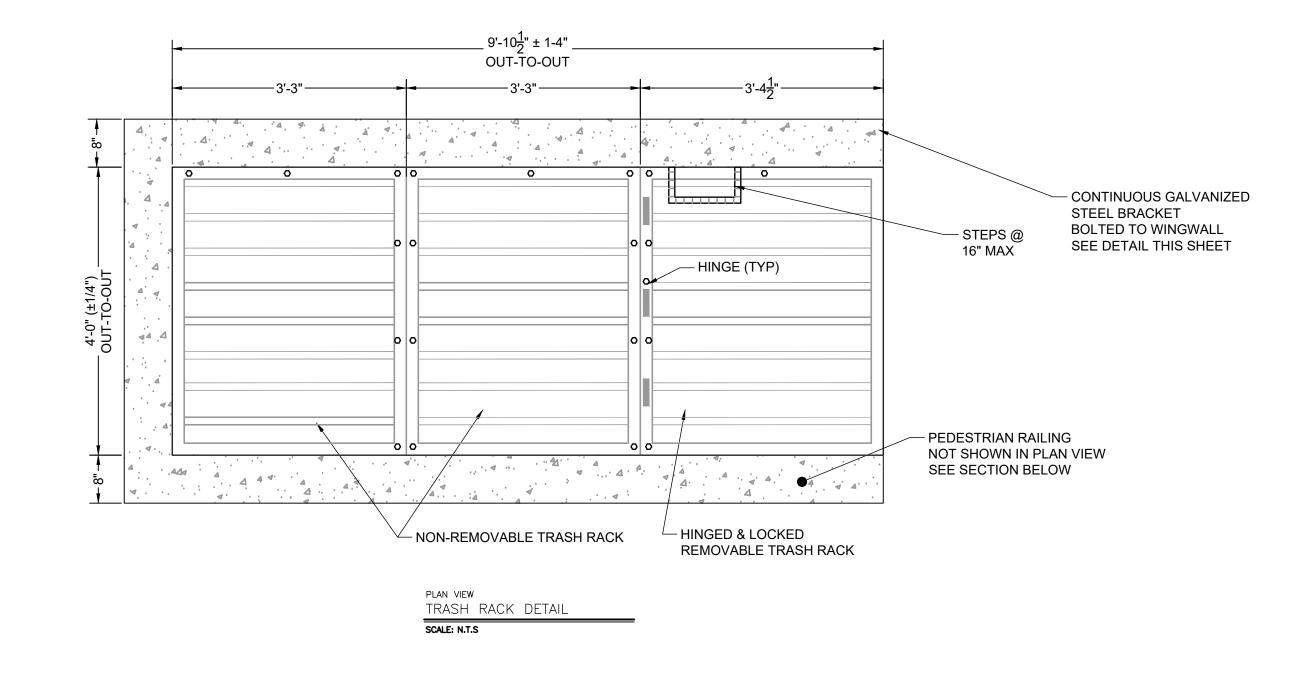



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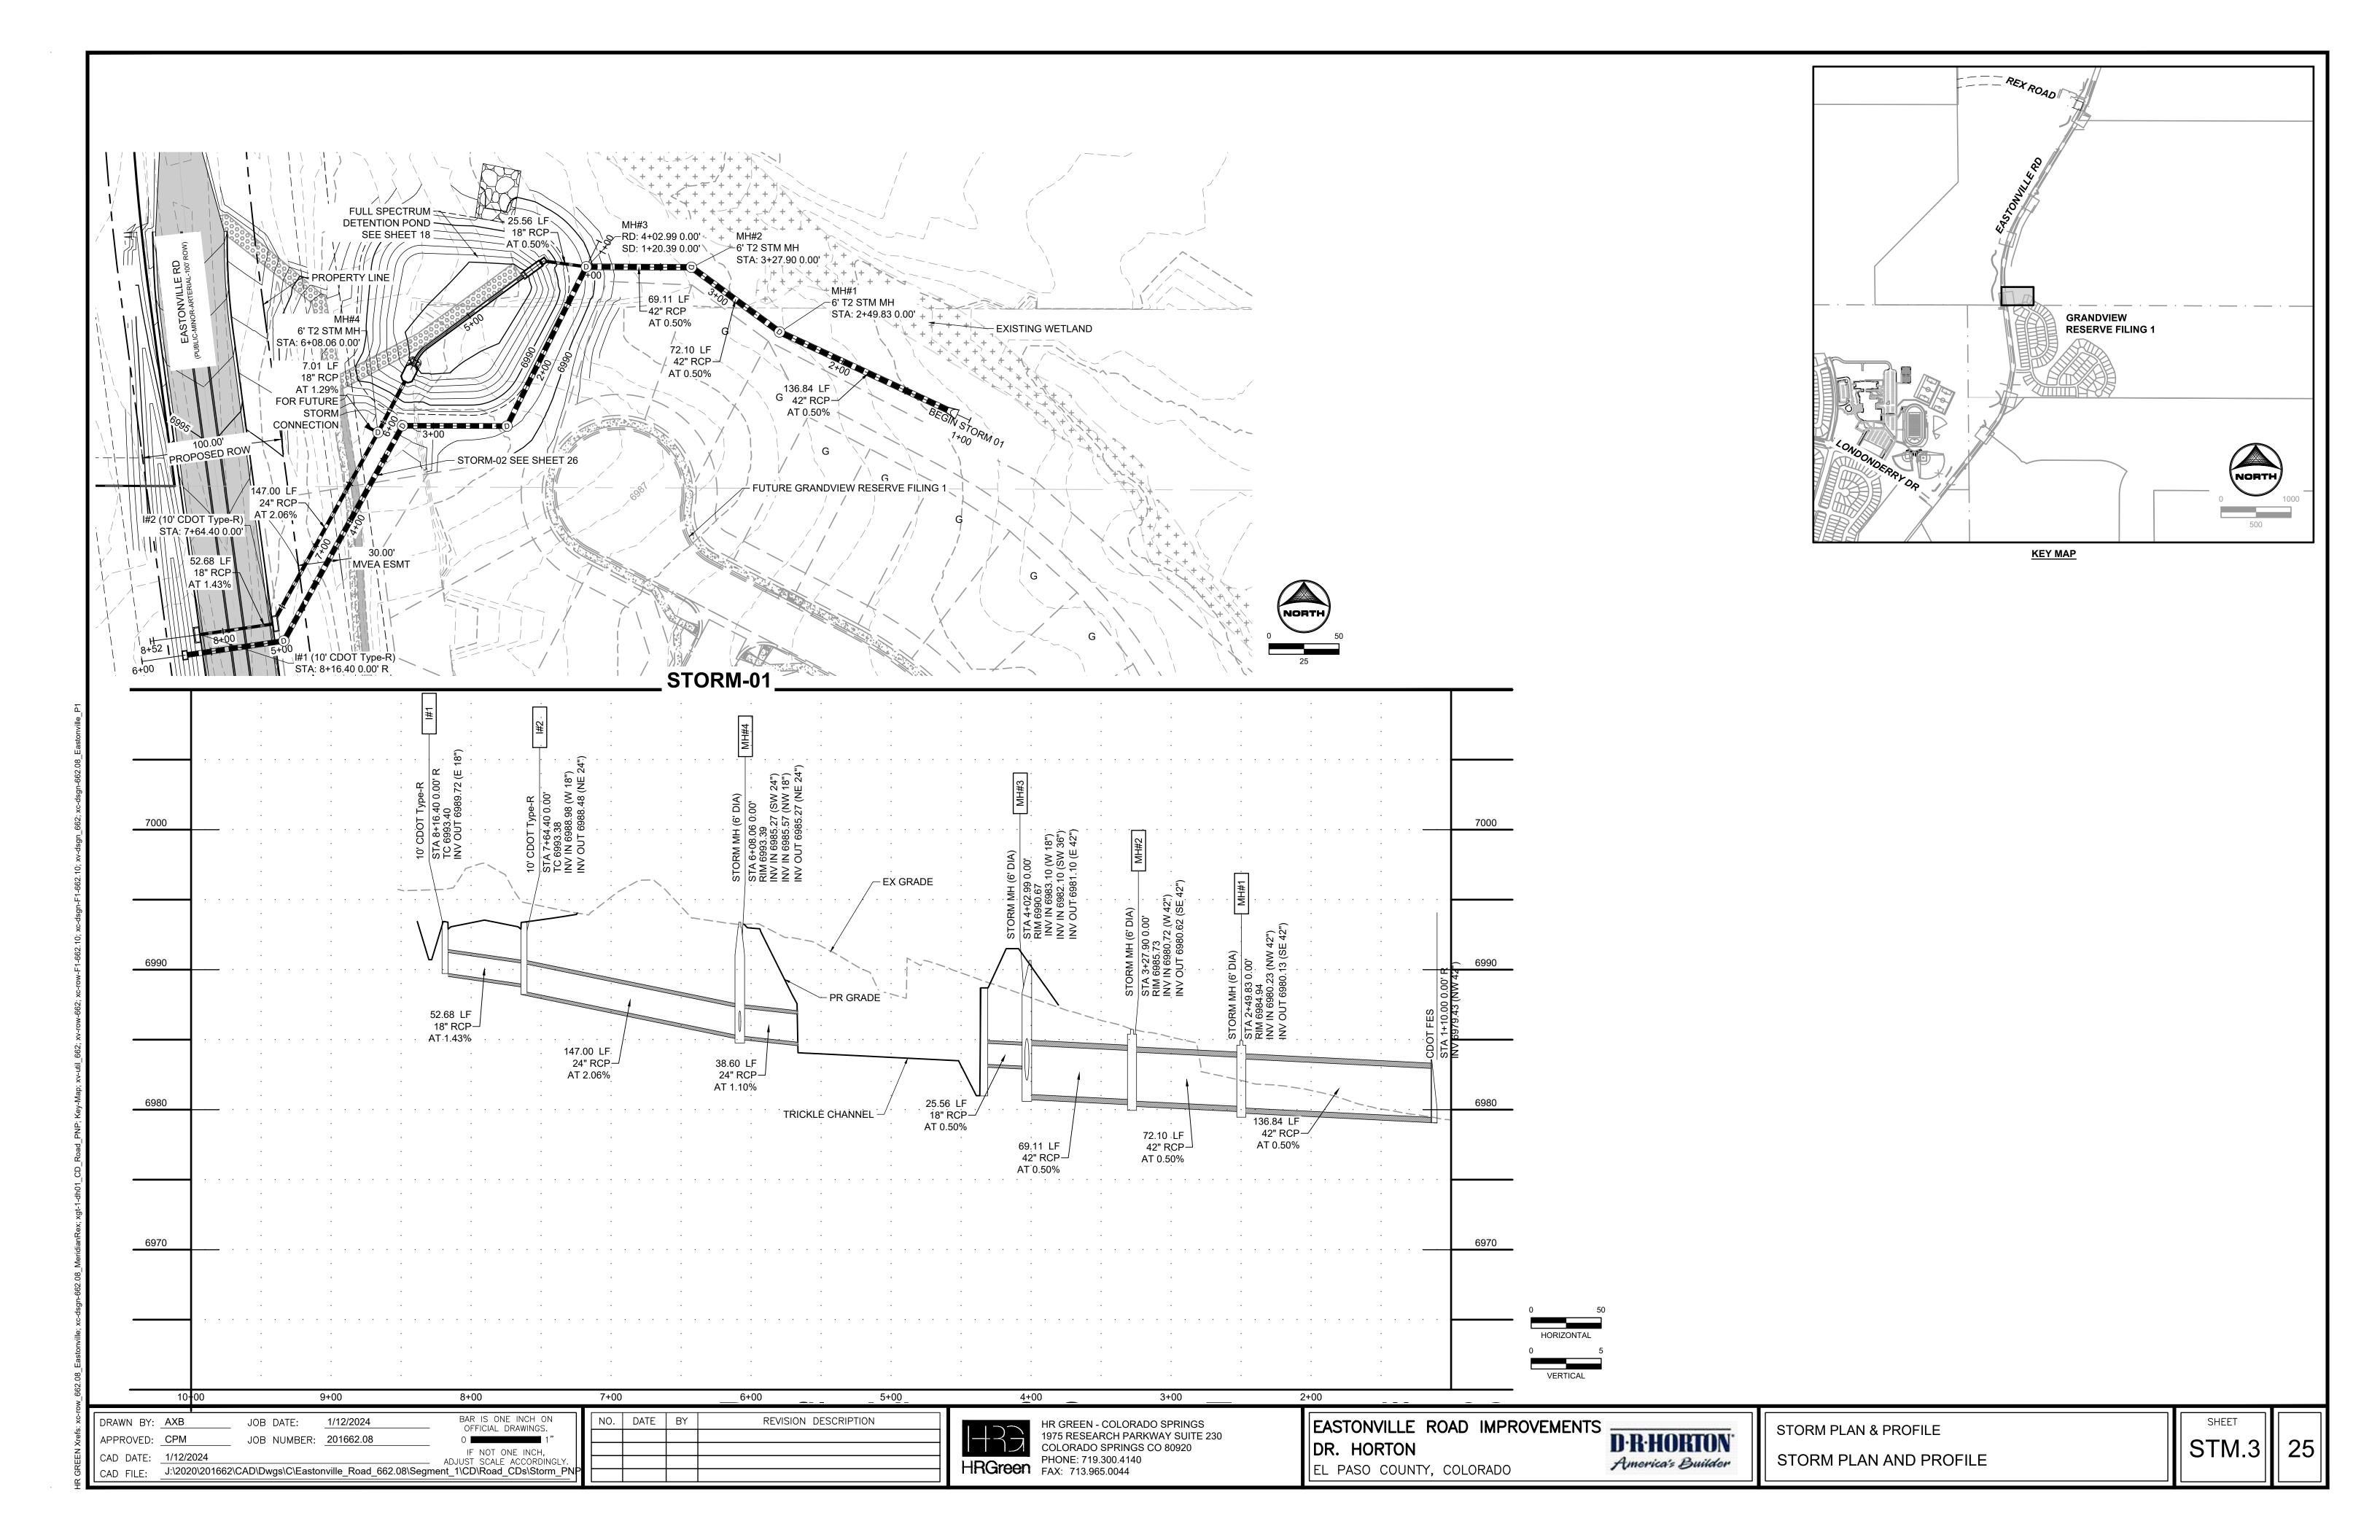


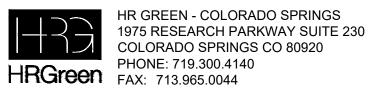



EASTONVILLE ROAD SEGEMENT 1 IMPROVEMENTS
OUTLET STRUCTURE DETAILS




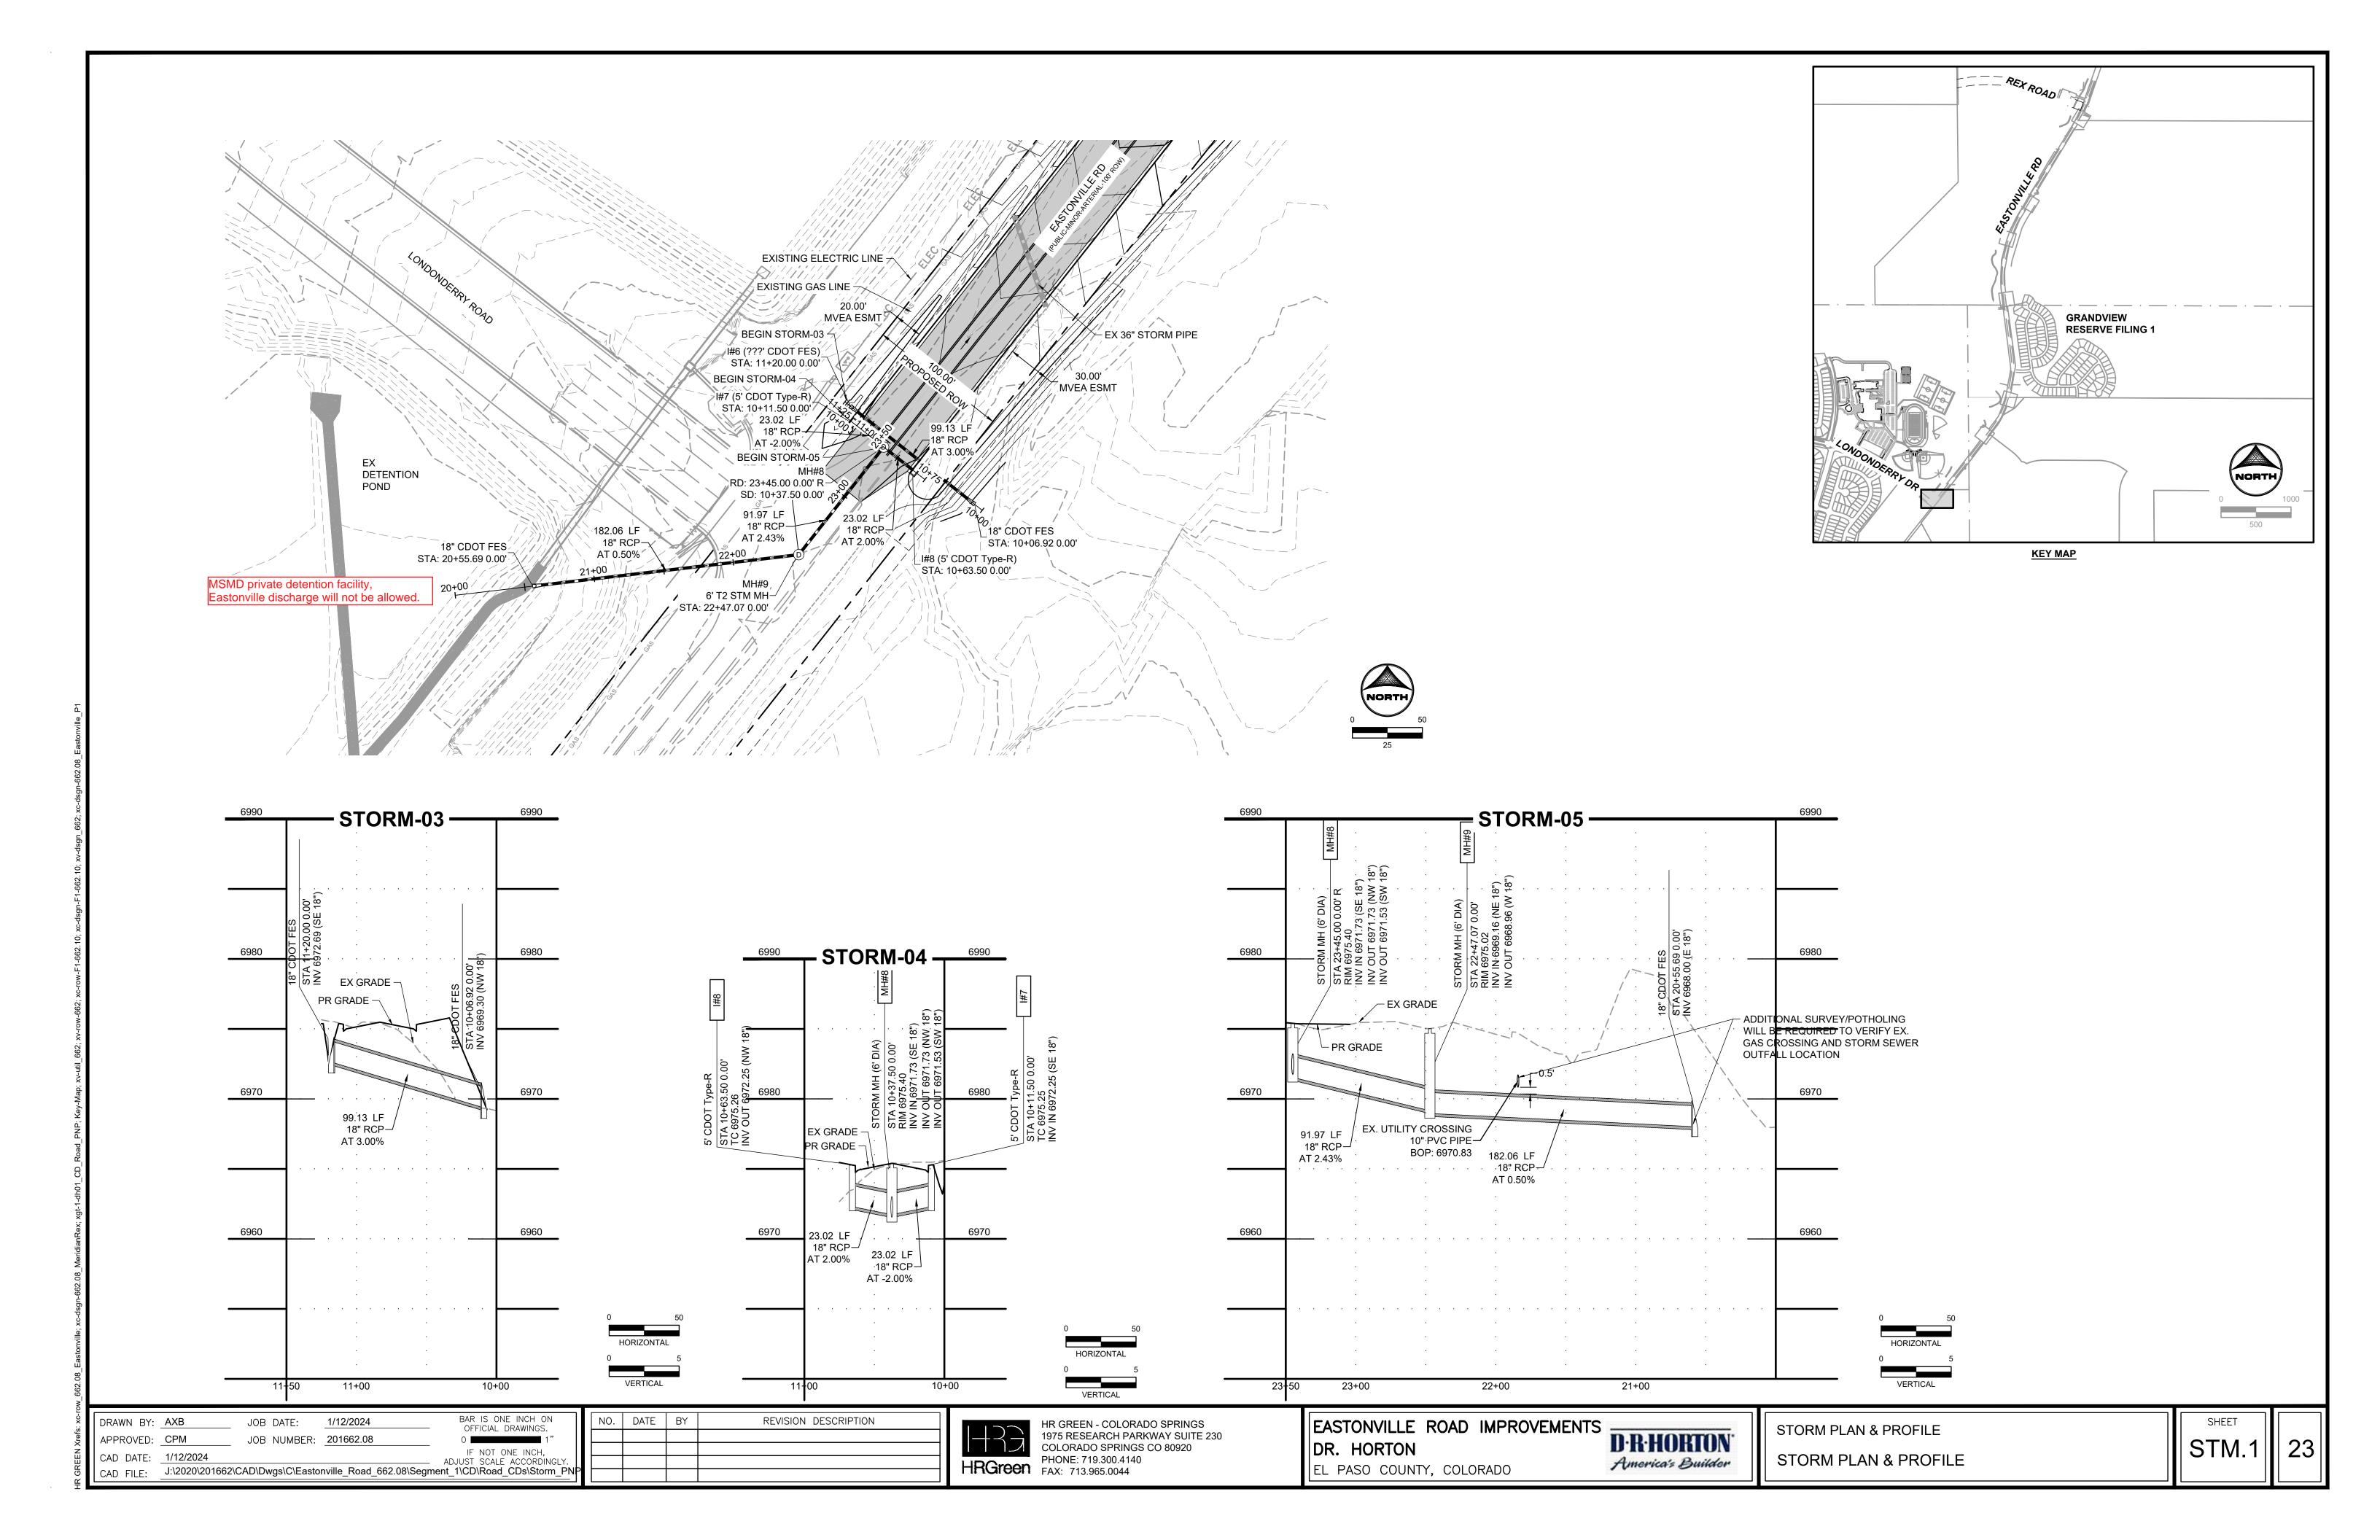


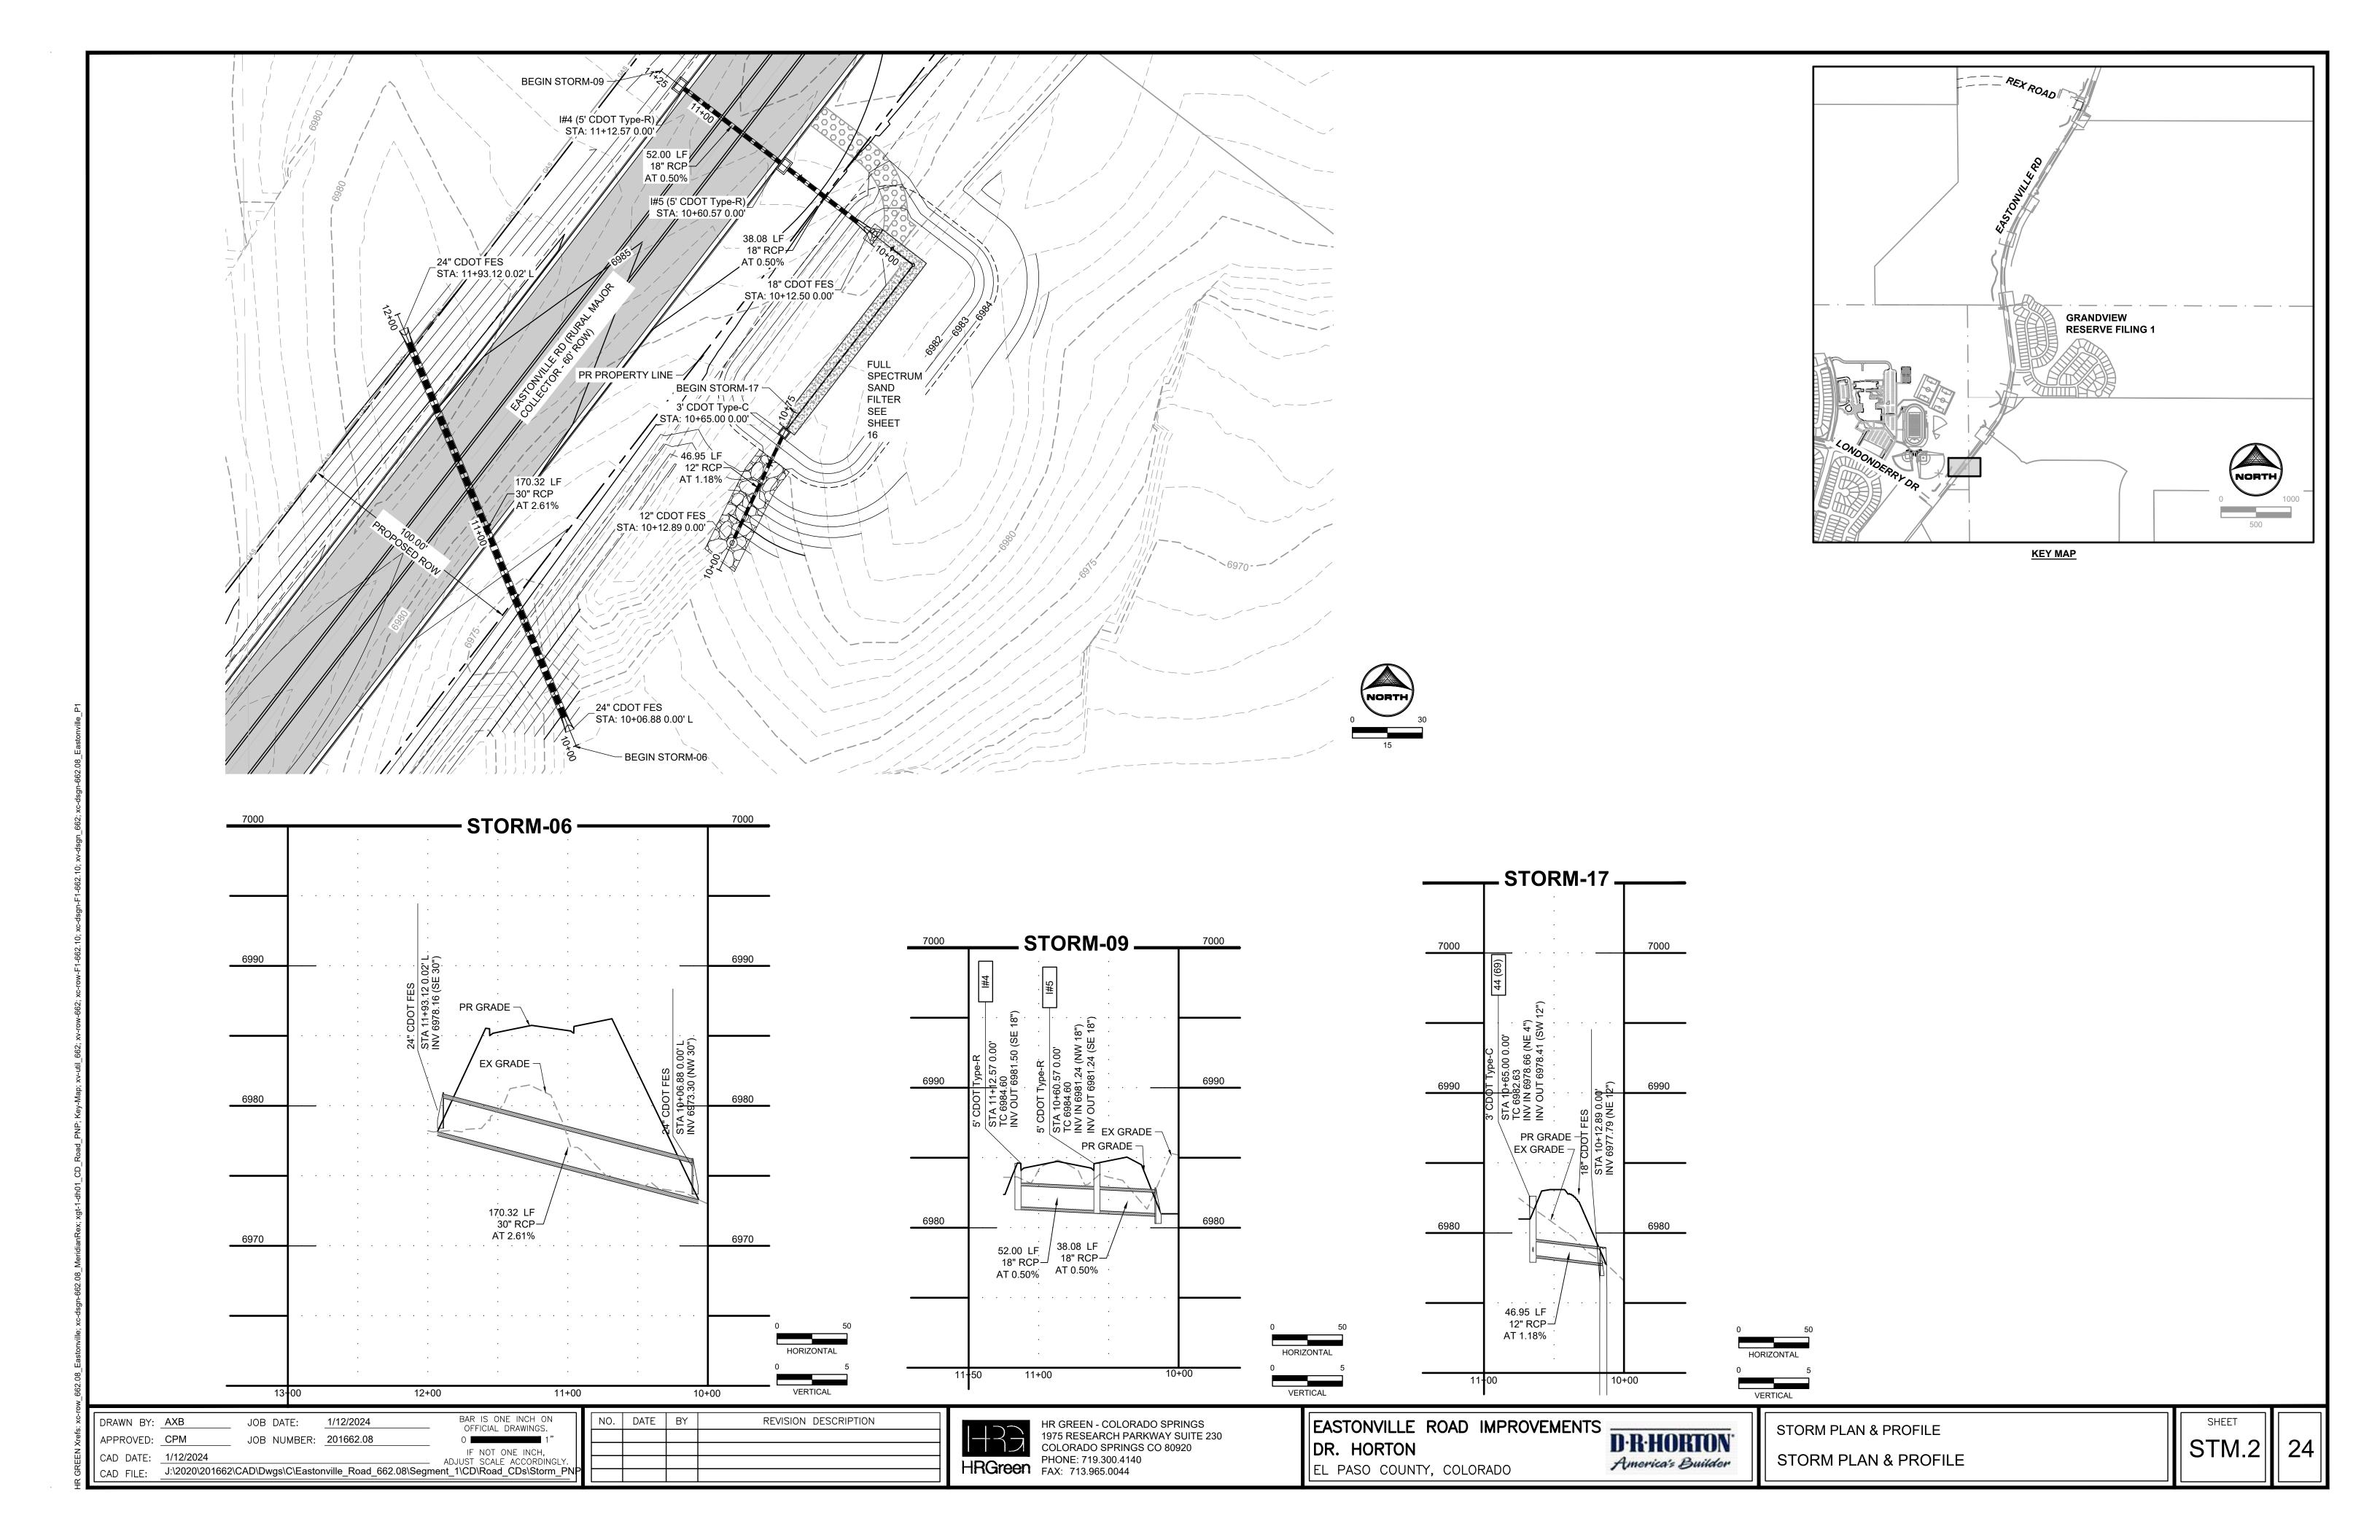

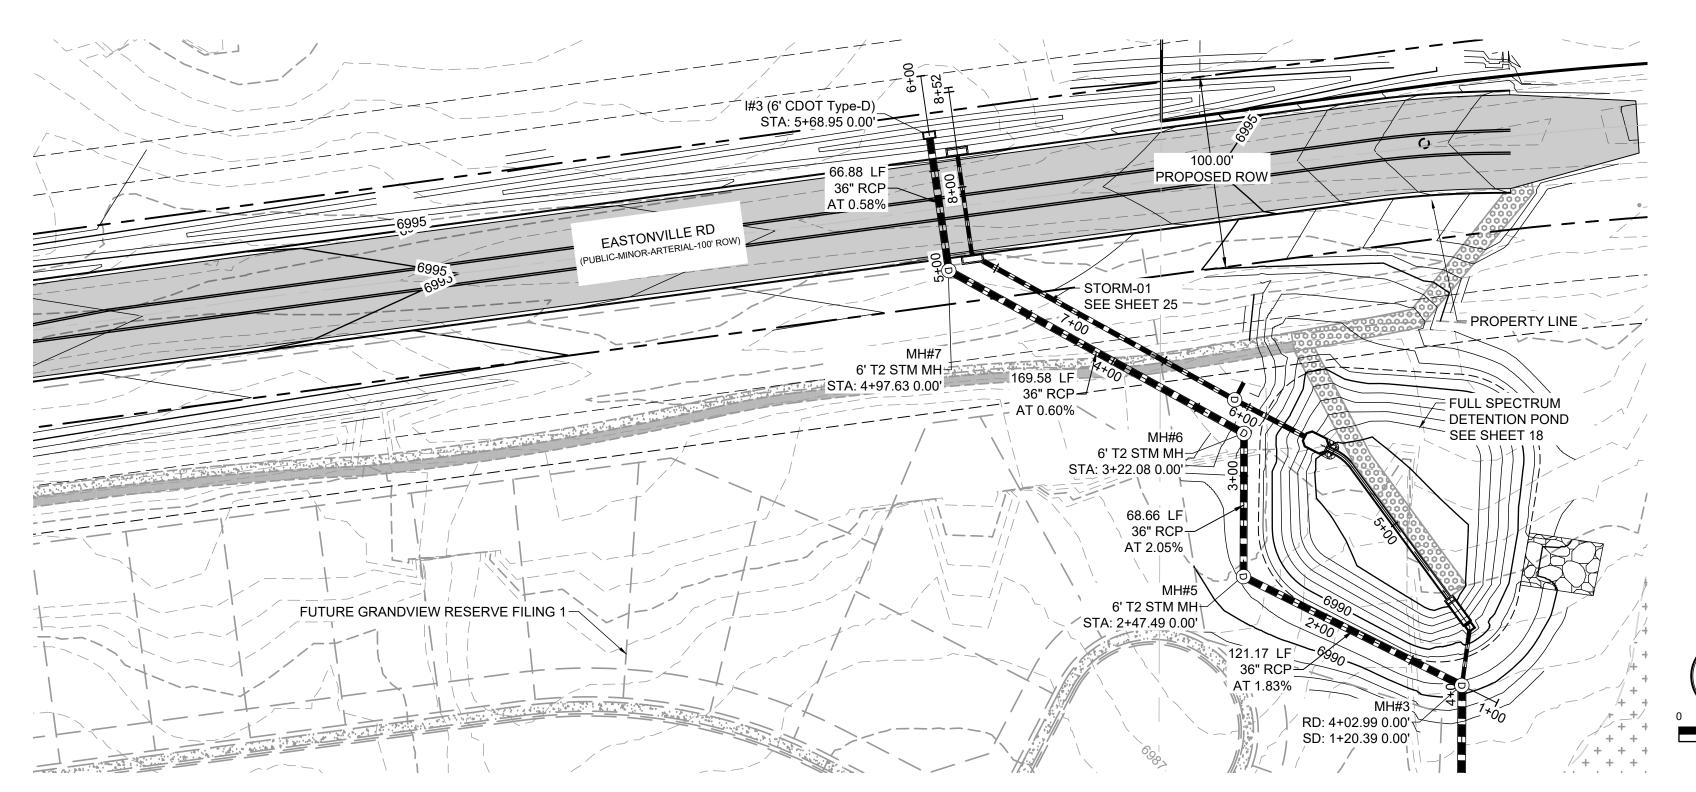

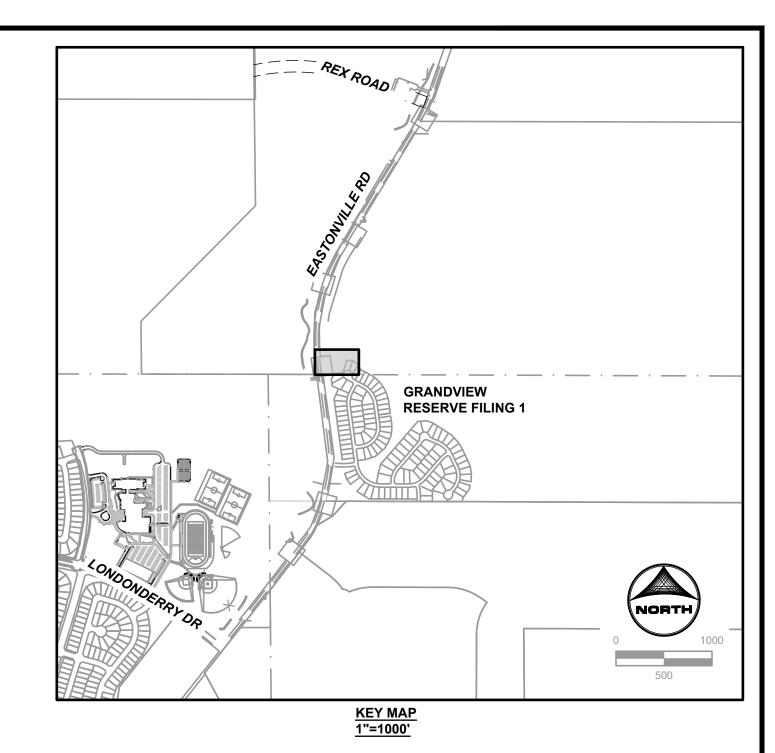

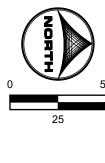

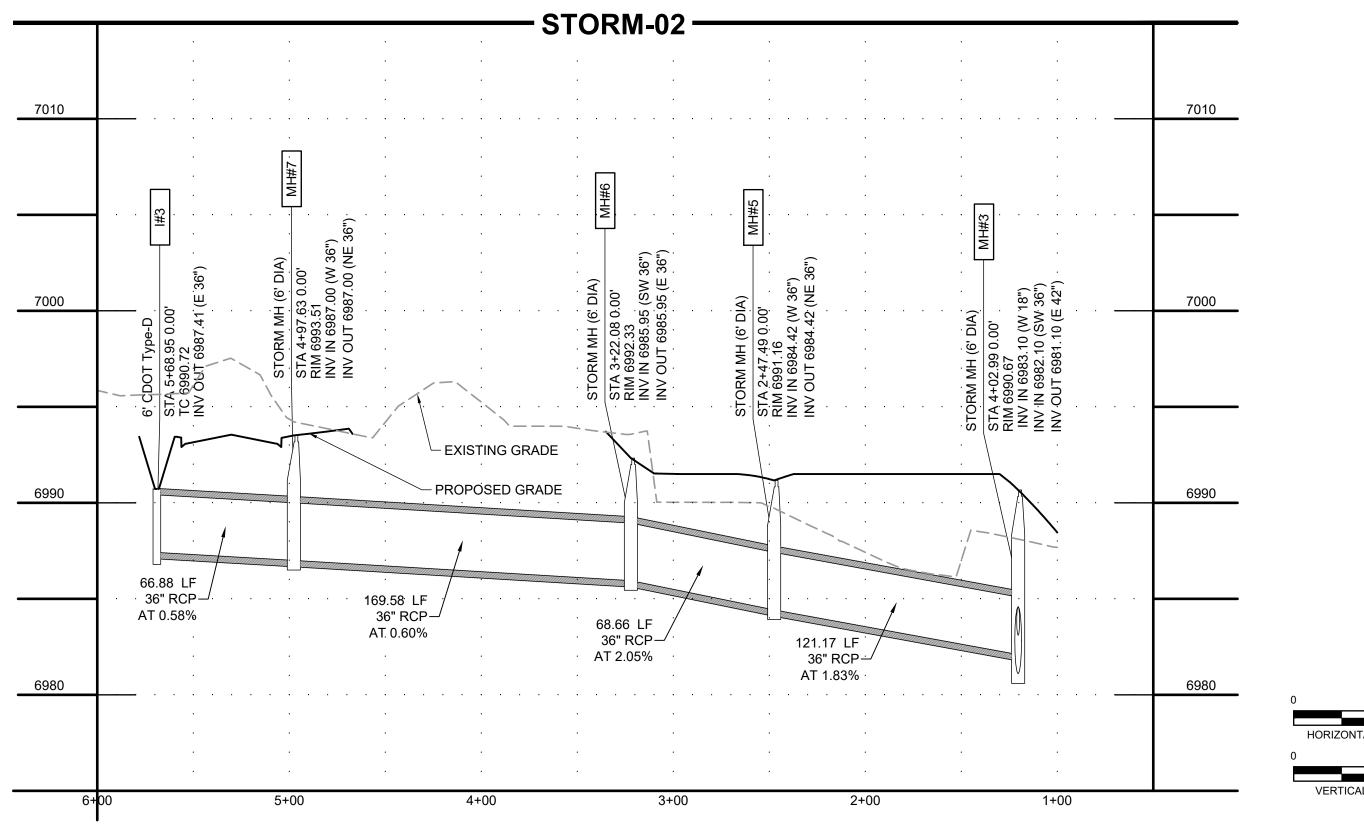

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COLORADO SPRINGS CO 80920
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EASTONVILLE ROAD IMPROVEMENTS


D'R'HORTON


America's Builder

EASTONVILLE ROAD SEGEMENT 1 IMPROVEMENTS STORM PLAN AND PROFILE


|STM.4|**|**|26|

TRUNCATED DOME DETAILS

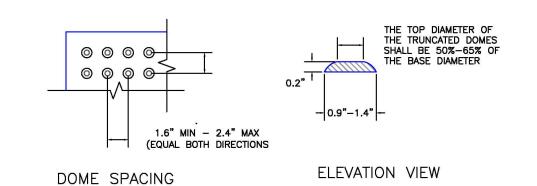

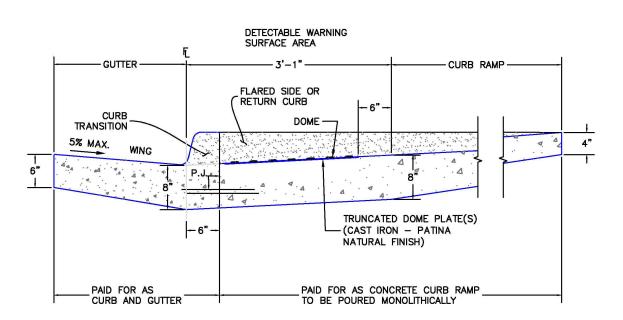

P.J.= PERMISSABLE JOINT WITH EPOXY-COATED DEFORMED NO. 4 BARS CONFORMING TO AASHTO M 284 AT 18 IN. SPACING DETECTABLE WARNING SURFACE DETAILS (SD_2-42) SCALE: NTS

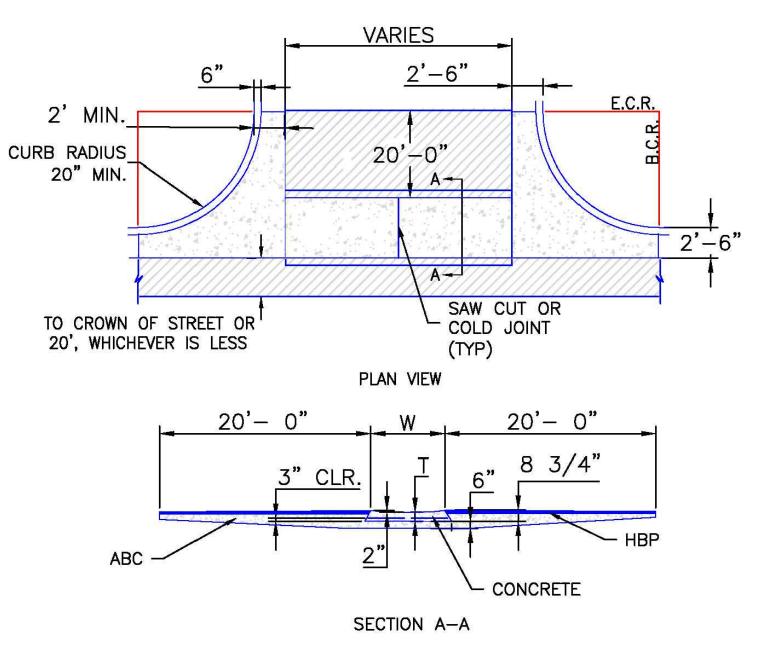


NOTES

1. W - WIDTH SHALL BE 6' FOR LOCAL, 8' FOR COLLECTORS, AND 10' FOR ARTERIAL ROADS.


2. T - SQUARED-OFF RETURN TO BE POURED MONOLITHICALLY, 8" PCC FOR LOCAL ROADS, 9" FOR COLLECTORS WITH 6x6 - 4.4 W.W.F. OR #4 REINFORCING BAR @ 18" EACH WAY.

3. _____ = 3" MINIMUM ASPHALT DEPTH (2 LIFTS).


4. DESIGN TO SPECIFY ELEVATIONS AT PI AND PCR. TYPICAL CROSS PAN LAYOUT DETAIL (SD_2-26) SCALE: NTS

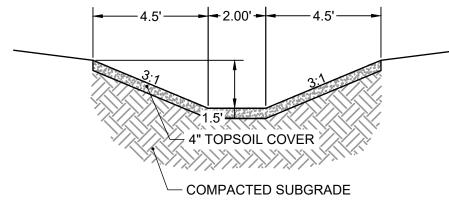


DRAINAGE SWALE 1 SCALE: NTS

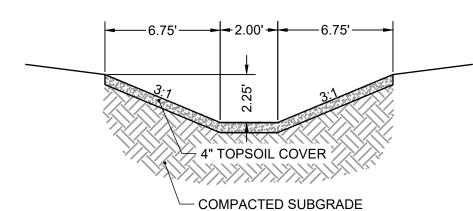

DRAINAGE SWALE 2 SCALE: NTS

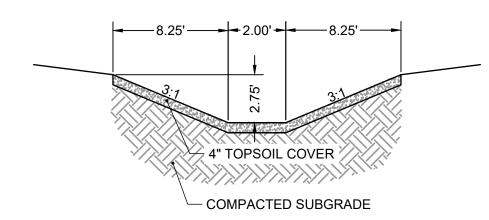

DRAINAGE SWALE 3

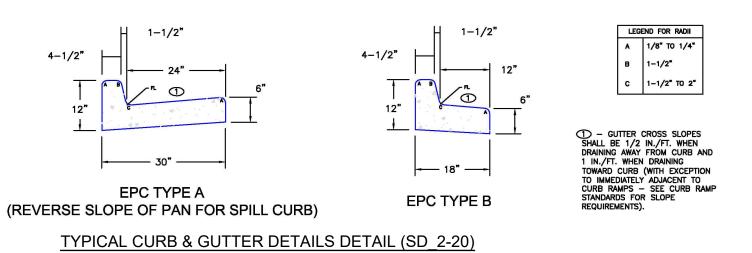

SCALE: NTS



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EASTONVILLE ROAD IMPROVEMENTS DR. HORTON EL PASO COUNTY, COLORADO

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EASTONVILLE ROAD SEGEMENT 1 IMPROVEMENTS DETAILS

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EXHIBIT B

LEGAL DESCRIPTION:

A PARCEL OF LAND LOCATED IN SECTIONS 28 AND 29 IN TOWNSHIP 12 SOUTH, RANGE 64 WEST OF THE 6TH PRINCIPAL MERIDIAN, MORE PARTICULARLY DESCRIBED AS FOLLOWS:

COMMENCING AT THE NORTHEAST CORNER OF SAID SECTION 29; THENCE S89°17'55"E, 490.90 FEET TO THE TRUE POINT OF BEGINNING

- 1. THENCE S89°17'55"E, 20.19 FEET TO A POINT ON THE WESTERLY RIGHT OF WAY LINE OF EASTONVILLE ROAD; THE FOLLOWING FOUR COURSES ARE ON THE WESTERLY RIGHT OF WAY LINE OF EASTONVILLE ROAD:
- 2. THENCE SOUTHERLY ALONG SAID WESTERLY RIGHT OF WAY LINE S07°10'13"E, 643.20 FEET TO A CURVE TO THE RIGHT;
- 3. THENCE ON THE ARC OF SAID CURVE, HAVING A RADIUS OF 1570.00 FEET, A DELTA ANGLE OF 45°15'21", AN ARC LENGTH OF 1240.09 FEET, WHOSE LONG CHORD BEARS S15°26'34"W, A DISTANCE OF 1208.10 FEET;
- 4. THENCE S38°03'54"W, 508.39 FEET;
- 5. THENCE S38°44'41"W, 681.86 FEET TO A POINT ON THE NORTHERLY RIGHT OF WAY LINE OF LONDONDERRY DRIVE RECORDED WITH RECEPTION NO. 208113430 IN THE RECORDS OF EL PASO COUNTY;
- 6. THENCE N51°15'19"W, 20.00 FEET ALONG SAID RIGHT OF WAY;
- 7. THENCE N38°44'41"E, 681.74 FEET;
- 8. THENCE N38°03'54"E, 508.27 FEET TO A CURVE TO THE LEFT;
- 9. THENCE ON THE ARC OF SAID CURVE, HAVING A RADIUS OF 1550.00 FEET, A DELTA ANGLE OF 45°15'22", AN ARC LENGTH OF 1224.29 FEET, WHOSE LONG CHORD BEARS N15°26'34"E, A DISTANCE OF 1191.71 FEET;
- 10. THENCE NO7°10'13"W, 645.97 FEET TO THE TRUE POINT OF BEGINNING;

THE ABOVE PARCEL CONTAINS A TOTAL OF 1.408 ACRES, MORE OR LESS.

BEARINGS ARE BASED ON THE SOUTH LINE OF THE SW ¼ OF SECTION 29, TOWNSHIP 12 SOUTH, RANGE 64 WEST OF THE 6TH P.M., ASSUMED TO BEAR S89°25'42"E FROM THE SOUTHWEST CORNER OF SAID SECTION 29 (A STONE W/SCRIBED "X") TO THE SOUTH QUARTER CORNER OF SAID SECTION 29 (3.25" ALUM. CAP LS #30087).

SCALE:

DATE: AUG 2022

DRAWN: TAK

CHECK: RG

MERIDIAN RANCH FALCON, COLORADO