
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REVISED

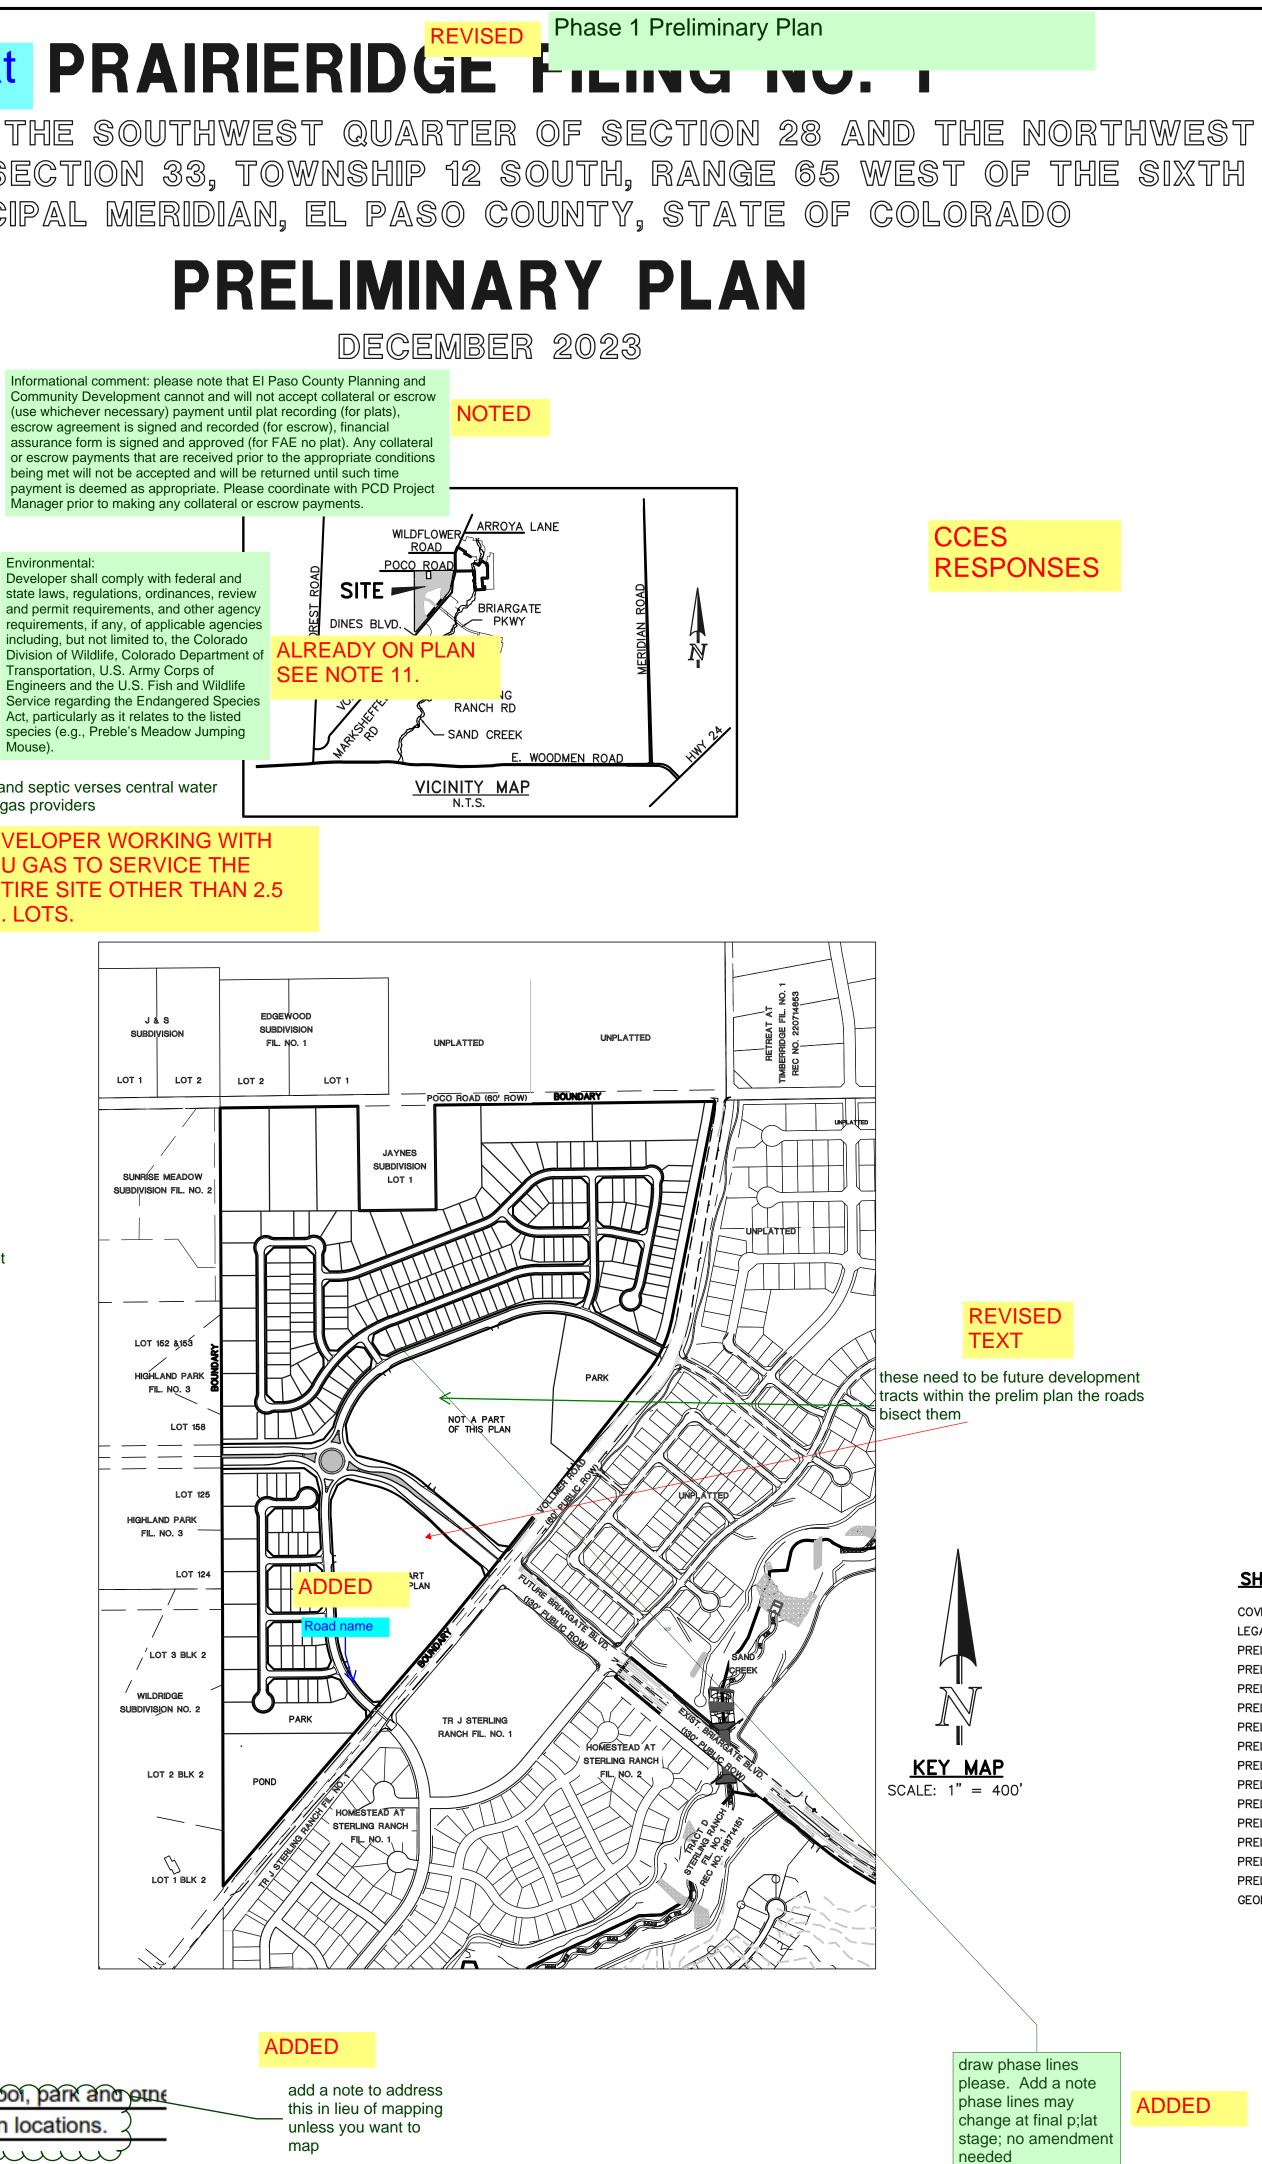



TAX ID NUMBERS:		PORTION	I OF 52280-00-0	24 & 5228	30-00-025				
TOTAL AREA:		108.89	ACRES						
DEVELOPMENT SCHEDU	LE	FALL 20	024 / <mark>SKP-22</mark>	2-005	REVISE	ED			
SKETCH PLAN:		SKP 22-	-225						
CURRENT ZONING: PROPOSED ZONING:		RR-5 RS-600	0, RR-2.5, & RR-	-0.5				REVIS	ED
CURRENT USE: PROPOSED USE:			TURE GRAZING/VA			attache	ed and o	or	
PROPOSED GROSS DEN PROPOSED NET DENSI			/AC (217 LOTS/1 /AC (217 LOTS/6			detatch	ned		
LANDSCAPE SETBACKS VOLLMER ROAD: BRIARGATE PKWY		50 FT B 25 FT B					s" numl er phase	ber of e/density	
ZONE DIMENSI	ONAL STAN	DARDS							D
	MAX. BUILDING	MAX. LOT	MIN. LOT WIDTH	FRONT BUILDING	SIDE BUILDING	REAR	NG		

25'

25'

25'

25'

25'

25'

5'

15'

10'

RR-2.5	2.5 ACRES	30'	NONE
RR-0.5	21,780 SF	30'	NONE

RS-6000 6,000 SF 30'

RR-0.5 21,780 SF 30'

LAND USE DATA TABLE		
LAND USE	ACRES	% OF LAND
SINGLE FAMILY LOTS	67.92	62.4%
ROAD ROW	22.43	20.6%
PARKS	8.65	7.9%
OPEN SPACE/BUFFER TRACTS	3.66	3.4%
DRAINAGE/DETENTION	6.23	5.7%
TOTAL	108.89	100%

40%/45% 50'

200'

100'

PROJECT	TEAM

APPLICANT/CIVIL CONSULTANT:

LANDSCAPE CONSULTANT:

LANDSCAPE CONSULTANT:

OWNER:

CLASSIC SRJ LAND, LLC 2138 FLYING HORSE CLUB DR. COLORADO SPRINGS, CO 80921 (719) 592–9333 MR. LOREN MORELAND


CLASSIC CONSULTING 619 N. CASCADE AVE. SUITE 200 COLORADO SPRINGS, CO 80903 (719) 785–2802 MR. MARC A. WHORTON, P.E.

REVISED NES 619 N. CASCADE AVE. SUITE 200 COLORADO SPRINGS, CO 80903 (719) 471-0073 Does she work at ≻MS. JENNIFER SHAGIN, ASLA NES still? mmm ALL AMERICAN 1925 AEROPLAZA DRIVE COLORADO SPRINGS, CO 80916 (719) 637–0313

SHEET INDEX:

COVER SHEET LEGAL BOUNDARY & ADJACENT OWNERS EXHIBIT PRELIMINARY PLAN PRELIMINARY PLAN PRELIMINARY PLAN PRELIMINARY PLAN PRELIMINARY PLAN PRELIMINARY PLAN PRELIMINARY GRADING & UTILITY PLAN PRELIMINARY LANDSCAPE PLANS & DETAILS GEOLOGIC CONSTRAINTS EXHIBIT

MR. MIKE BERTA REVISED SHEET 1 OF 28 SHEET 2 OF 28 SHEET 3 OF 28 SHEET 4 OF 28 SHEET 5 OF 28 SHEET 6 OF 28 SHEET 7 OF 28 SHEET 8 OF 28 SHEET 9 OF 28 S SHEET 10 OF 28 SHEET 11 OF 28 SHEET 12 OF 28 SHEET 13 OF 28 SHEET 14 OF 28 SHEETS 15-27 OF 28 SHEET 28 OF 28 REVISED PCD NO. SP-23-009 PRAIRIERIDGE FILING NO. 1

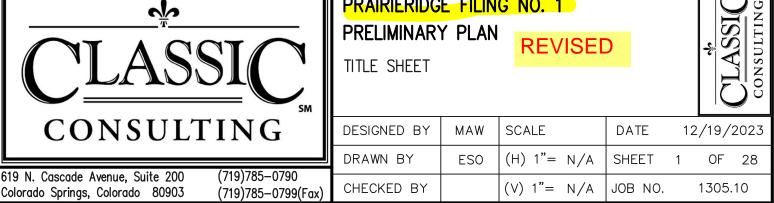

LEGAL DESCRIPTION:

A PARCEL OF LAND BEING LOCATED IN A PORTION OF THE SOUTH HALF OF SECTION 28 AND THE NORTHWEST QUARTER OF SECTION 33, TOWNSHIP 12 SOUTH, RANGE 65 WEST OF THE SIXTH PRINCIPAL MERIDIAN, EL PASO COUNTY, COLORADO, BEING ALSO A PORTION OF LAND SURVEY PLAT RECORDED UNDER RECEPTION NO. 211900027, BEING MORE PARTICULARLY DESCRIBED AS FOLLOWS:

BASIS OF BEARINGS: THE SOUTH LINE OF THE SOUTHEAST QUARTER OF THE NORTHEAST QUARTER OF SECTION 28, TOWNSHIP 12 SOUTH, RANGE 65 WEST OF THE SIXTH PRINCIPAL MERIDIAN, BEING MONUMENTED AT THE WEST END WHICH IS THE SOUTHWEST CORNER OF THE SOUTHEAST QUARTER OF THE NORTHEAST QUARTER OF SAID SECTION 28 BY A 3-1/4" ALUMINUM SURVEYORS CAP STAMPED "ESI PLS 10376, 2006" AND AT THE EAST END, WHICH IS A 30' WITNESS CORNER TO THE EAST OF THE EAST QUARTER CORNER OF SAID SECTION 28, BY A 3-1/4" ALUMINUM SURVEYORS CAP STAMPED "ESI 10376, 2006", IS ASSUMED TO BEAR N89°08°28"E, A DISTANCE OF 1326.68 FEET.

COMMENCING AT THE CENTER-EAST 1/16 CORNER OF SAID SECTION 28, TOWNSHIP 12 SOUTH, RANGE 65 WEST OF THE SIXTH PRINCIPAL MERIDIAN, EL PASO COUNTY, COLORADO;

THENCE S83°37'56"W, A DISTANCE OF 62.10 FEET TO A POINT ON THE NORTH LINE OF THE SOUTH HALF OF SECTION 28 SAID POINT BEING THE NORTHEASTERLY CORNER OF LAND SURVEY PLAT RECORDED UNDER RECEPTION NO. 211900027 SAID POINT BEING ALSO IN THE WESTERLY RIGHT OF WAY LINE OF VOLLMER ROAD AND BEING THE POINT OF **BEGINNING**:

THENCE ON SAID WESTERLY RIGHT OF WAY LINE THE FOLLOWING FOUR (4) COURSES:

1. THENCE S09°36'29"W, A DISTANCE OF 114.58 FEET

- 2. THENCE S11°14'07"W, A DISTANCE OF 1052.73 FEET;
- 3. THENCE ON THE ARC OF A CURVE TO THE RIGHT WHOSE CENTER BEARS N78°41'41"W, HAVING A DELTA OF 27°06'29", A RADIUS OF 603.83 FEET AND A DISTANCE OF 285.69 FEET;

4. THENCE S38°19'09"W, A DISTANCE OF 612.03 FEET:

THENCE N51°40'51"W, A DISTANCE OF 164.68 FEET;

THENCE N02°32'52"E, A DISTANCE OF 287.73 FEET;

THENCE N09°57'35"E, A DISTANCE OF 387.95 FEET TO A POINT ON CURVE;

THENCE ON THE ARC OF A CURVE TO THE LEFT WHOSE CENTER BEARS S09°57'35"W, HAVING A DELTA OF 31°02'16", A RADIUS OF 535.00 FEET, AND A DISTANCE OF 289.82 FEET;

THENCE S68°55'19"W, A DISTANCE OF 583.95 FEET;

THENCE ON A CURVE TO THE LEFT, HAVING A DELTA OF 51°38'50", A RADIUS OF 535.00 FEET, AND A DISTANCE OF 482.26;
THENCE S6°41'04"E, A DISTANCE OF 85.77 FEET;
THENCE S33°40'16"E, A DISTANCE OF 83.58 FEET;
THENCE S75°49'05"E, A DISTANCE OF 133.78 FEET;
THENCE ON A CURVE TO THE RIGHT, HAVING A DELTA OF 25°22'53", A RADIUS OF 550.00 FEET, AND A DISTANCE OF 243.64 FEET;
THENCE S50°26'12"E, A DISTANCE OF 510.67 FEET;
THENCE S81°43'37"E, A DISTANCE OF 57.76 FEET TO A POINT ON THE WESTERLY RIGHT OF WAY LINE OF SAID VOLLMER ROAD;
THENCE S38°19'09"W, ON SAID WESTERLY RIGHT OF WAY LINE, A DISTANCE OF 202.05 FEET;
THENCE N19°48'18"W, A DISTANCE OF 58.88 FEET;

THENCE N50°26'12"W, A DISTANCE OF 209.25 FEET;

THENCE N45°44'11"W, A DISTANCE OF 146.44 FEET;

THENCE N50°26'12"W, A DISTANCE OF 158.55 FEET;

THENCE ON A CURVE TO THE LEFT, HAVING A DELTA OF 25°22'53", A RADIUS OF 420.00 FEET, AND A DISTANCE OF 186.05 FEET; THENCE N75°49'05"W, A DISTANCE OF 151.10 FEET; THENCE S56°42'05"W, A DISTANCE OF 60.49 FEET;

THENCE S24°11'13"W, A DISTANCE OF 81.84 FEET;

THENCE ON THE ARC OF A CURVE TO THE LEFT WHOSE CENTER BEARS S85°25'43"E, HAVING A DELTA OF 07°35'39", A RADIUS OF 770.00 FEET, AND A DISTANCE OF 102.06 FEET; THENCE S03°01'22"E, A DISTANCE OF 571.21 FEET;

THENCE ON A CURVE TO THE LEFT, HAVING A DELTA OF 46°22'30", A RADIUS OF 535.00 FEET, AND A DISTANCE OF 433.03 FEET;

THENCE S49°23'52"E, A DISTANCE OF 6.63 FEET;

THENCE N85°36'08"E, A DISTANCE OF 42.43 FEET TO A POINT ON THE WESTERLY RIGHT OF WAY LINE OF SAID VOLLMER ROAD; THENCE S40°36'08"W, ON SAID WESTERLY RIGHT OF WAY LINE, A DISTANCE OF 1,266.97 FEET TO A POINT ON THE WEST

LINE OF THE EAST HALF OF THE NORTHWEST QUARTER OF SAID SECTION 33; THENCE N00°07'28"W, ON SAID WEST LINE, A DISTANCE OF 1,440.85 FEET TO A POINT ON THE WEST LINE OF THE EAST HALF OF THE SOUTHWEST QUARTER OF SAID SECTION 28;

THENCE N00°16'33"W, ON SAID WEST LINE, A DISTANCE OF 2,611.38 FEET TO A POINT ON THE NORTH LINE OF THE SOUTH HALF OF SECTION 28;

THENCE N89°13'54"E, ON SAID NORTH LINE, A DISTANCE OF 717.48 FEET TO THE EXTERIOR BOUNDARY OF LOT 1 OF JAYNES SUBDIVISION RECORDED IN PLAT BOOK X-3 AT PAGE 96;

THENCE ON THE SAID EXTERIOR BOUNDARY THE FOLLOWING THREE (3) COURSES:

1. THENCE S00°46'12"E, A DISTANCE OF 544.44 FEET;

2. THENCE N89°13'29"E, A DISTANCE OF 400.05 FEET;


3. THENCE N00°46'54"W, A DISTANCE OF 544.39 FEET TO A POINT OF SAID NORTH LINE;

THENCE N89°13'54"E, A DISTANCE OF 1,457.61 FEET TO THE POINT OF BEGINNING.

THE DESCRIPTION ABOVE PRODUCES A CALCULATED AREA OF 4,743,462 SQUARE FEET, (108.894 ACRES) OF LAND MORE OR LESS.


PRAIRIERIDGE FILING NO. 1


A PORTION OF THE SOUTHWEST QUARTER OF SECTION 28 AND THE NORTHWEST QUARTER OF SECTION 33, TOWNSHIP 12 SOUTH, RANGE 65 WEST OF THE SIXTH PRINCIPAL MERIDIAN, EL PASO COUNTY, STATE OF COLORADO

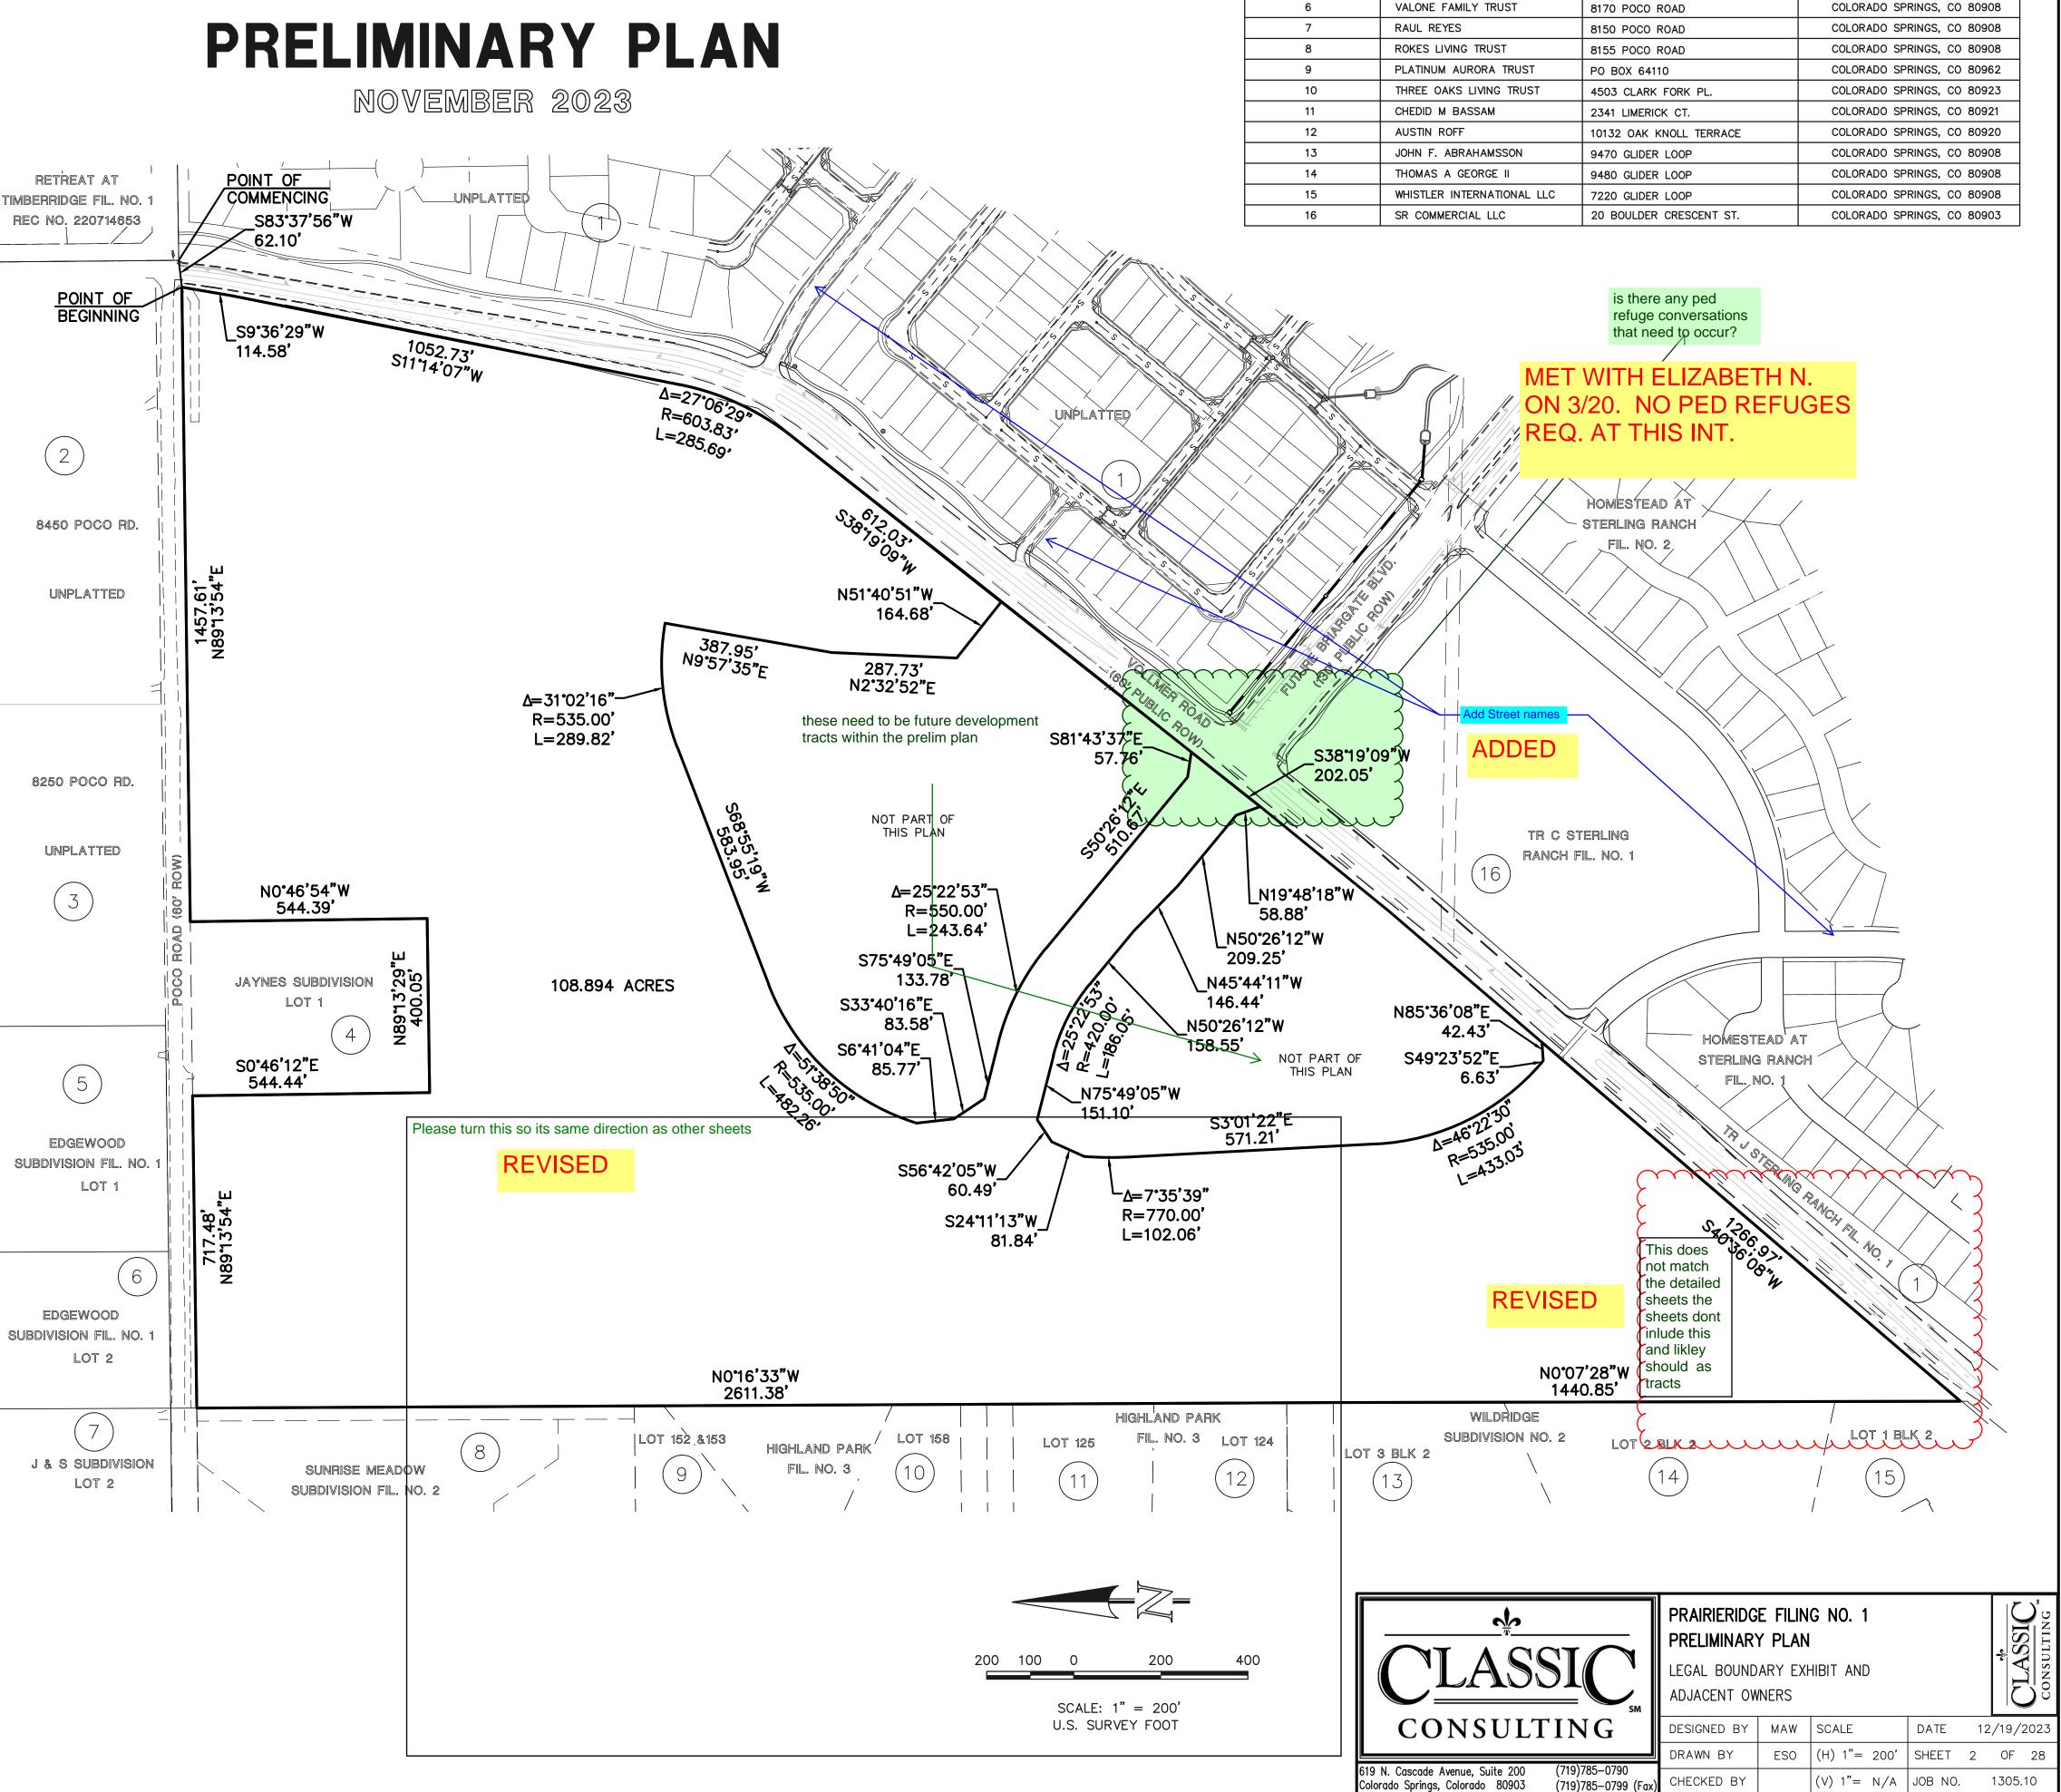

ADJACENT OWNERS

ADJACENT OWNER	NAME	MAILING ADDRESS	CITY STATE ZIP
1	SR LAND LLC	20 BOULDER CRESCENT ST STE. 102	COLORADO SPRINGS, CO 80903
2	AMELIA SNYDER	8450 POCO ROAD	COLORADO SPRINGS, CO 80908
3	MCCALL TERRILL J	8250 POCO ROAD	COLORADO SPRINGS, CO 80908
4	DANIEL W. SMITH	8225 POCO ROAD	COLORADO SPRINGS, CO 80908
5	KENNETH L. YODER	8190 POCO ROAD	COLORADO SPRINGS, CO 80908
6	VALONE FAMILY TRUST	8170 POCO ROAD	COLORADO SPRINGS, CO 80908
7	RAUL REYES	8150 POCO ROAD	COLORADO SPRINGS, CO 80908
8	ROKES LIVING TRUST	8155 POCO ROAD	COLORADO SPRINGS, CO 80908
9	PLATINUM AURORA TRUST	PO BOX 64110	COLORADO SPRINGS, CO 80962
10	THREE OAKS LIVING TRUST	4503 CLARK FORK PL.	COLORADO SPRINGS, CO 80923
11	CHEDID M BASSAM	2341 LIMERICK CT.	COLORADO SPRINGS, CO 80921
12	AUSTIN ROFF	10132 OAK KNOLL TERRACE	COLORADO SPRINGS, CO 80920
13	JOHN F. ABRAHAMSSON	9470 GLIDER LOOP	COLORADO SPRINGS, CO 80908
14	THOMAS A GEORGE II	9480 GLIDER LOOP	COLORADO SPRINGS, CO 80908
15	WHISTLER INTERNATIONAL LLC	7220 GLIDER LOOP	COLORADO SPRINGS, CO 80908
16	SR COMMERCIAL LLC	20 BOULDER CRESCENT ST.	COLORADO SPRINGS, CO 80903

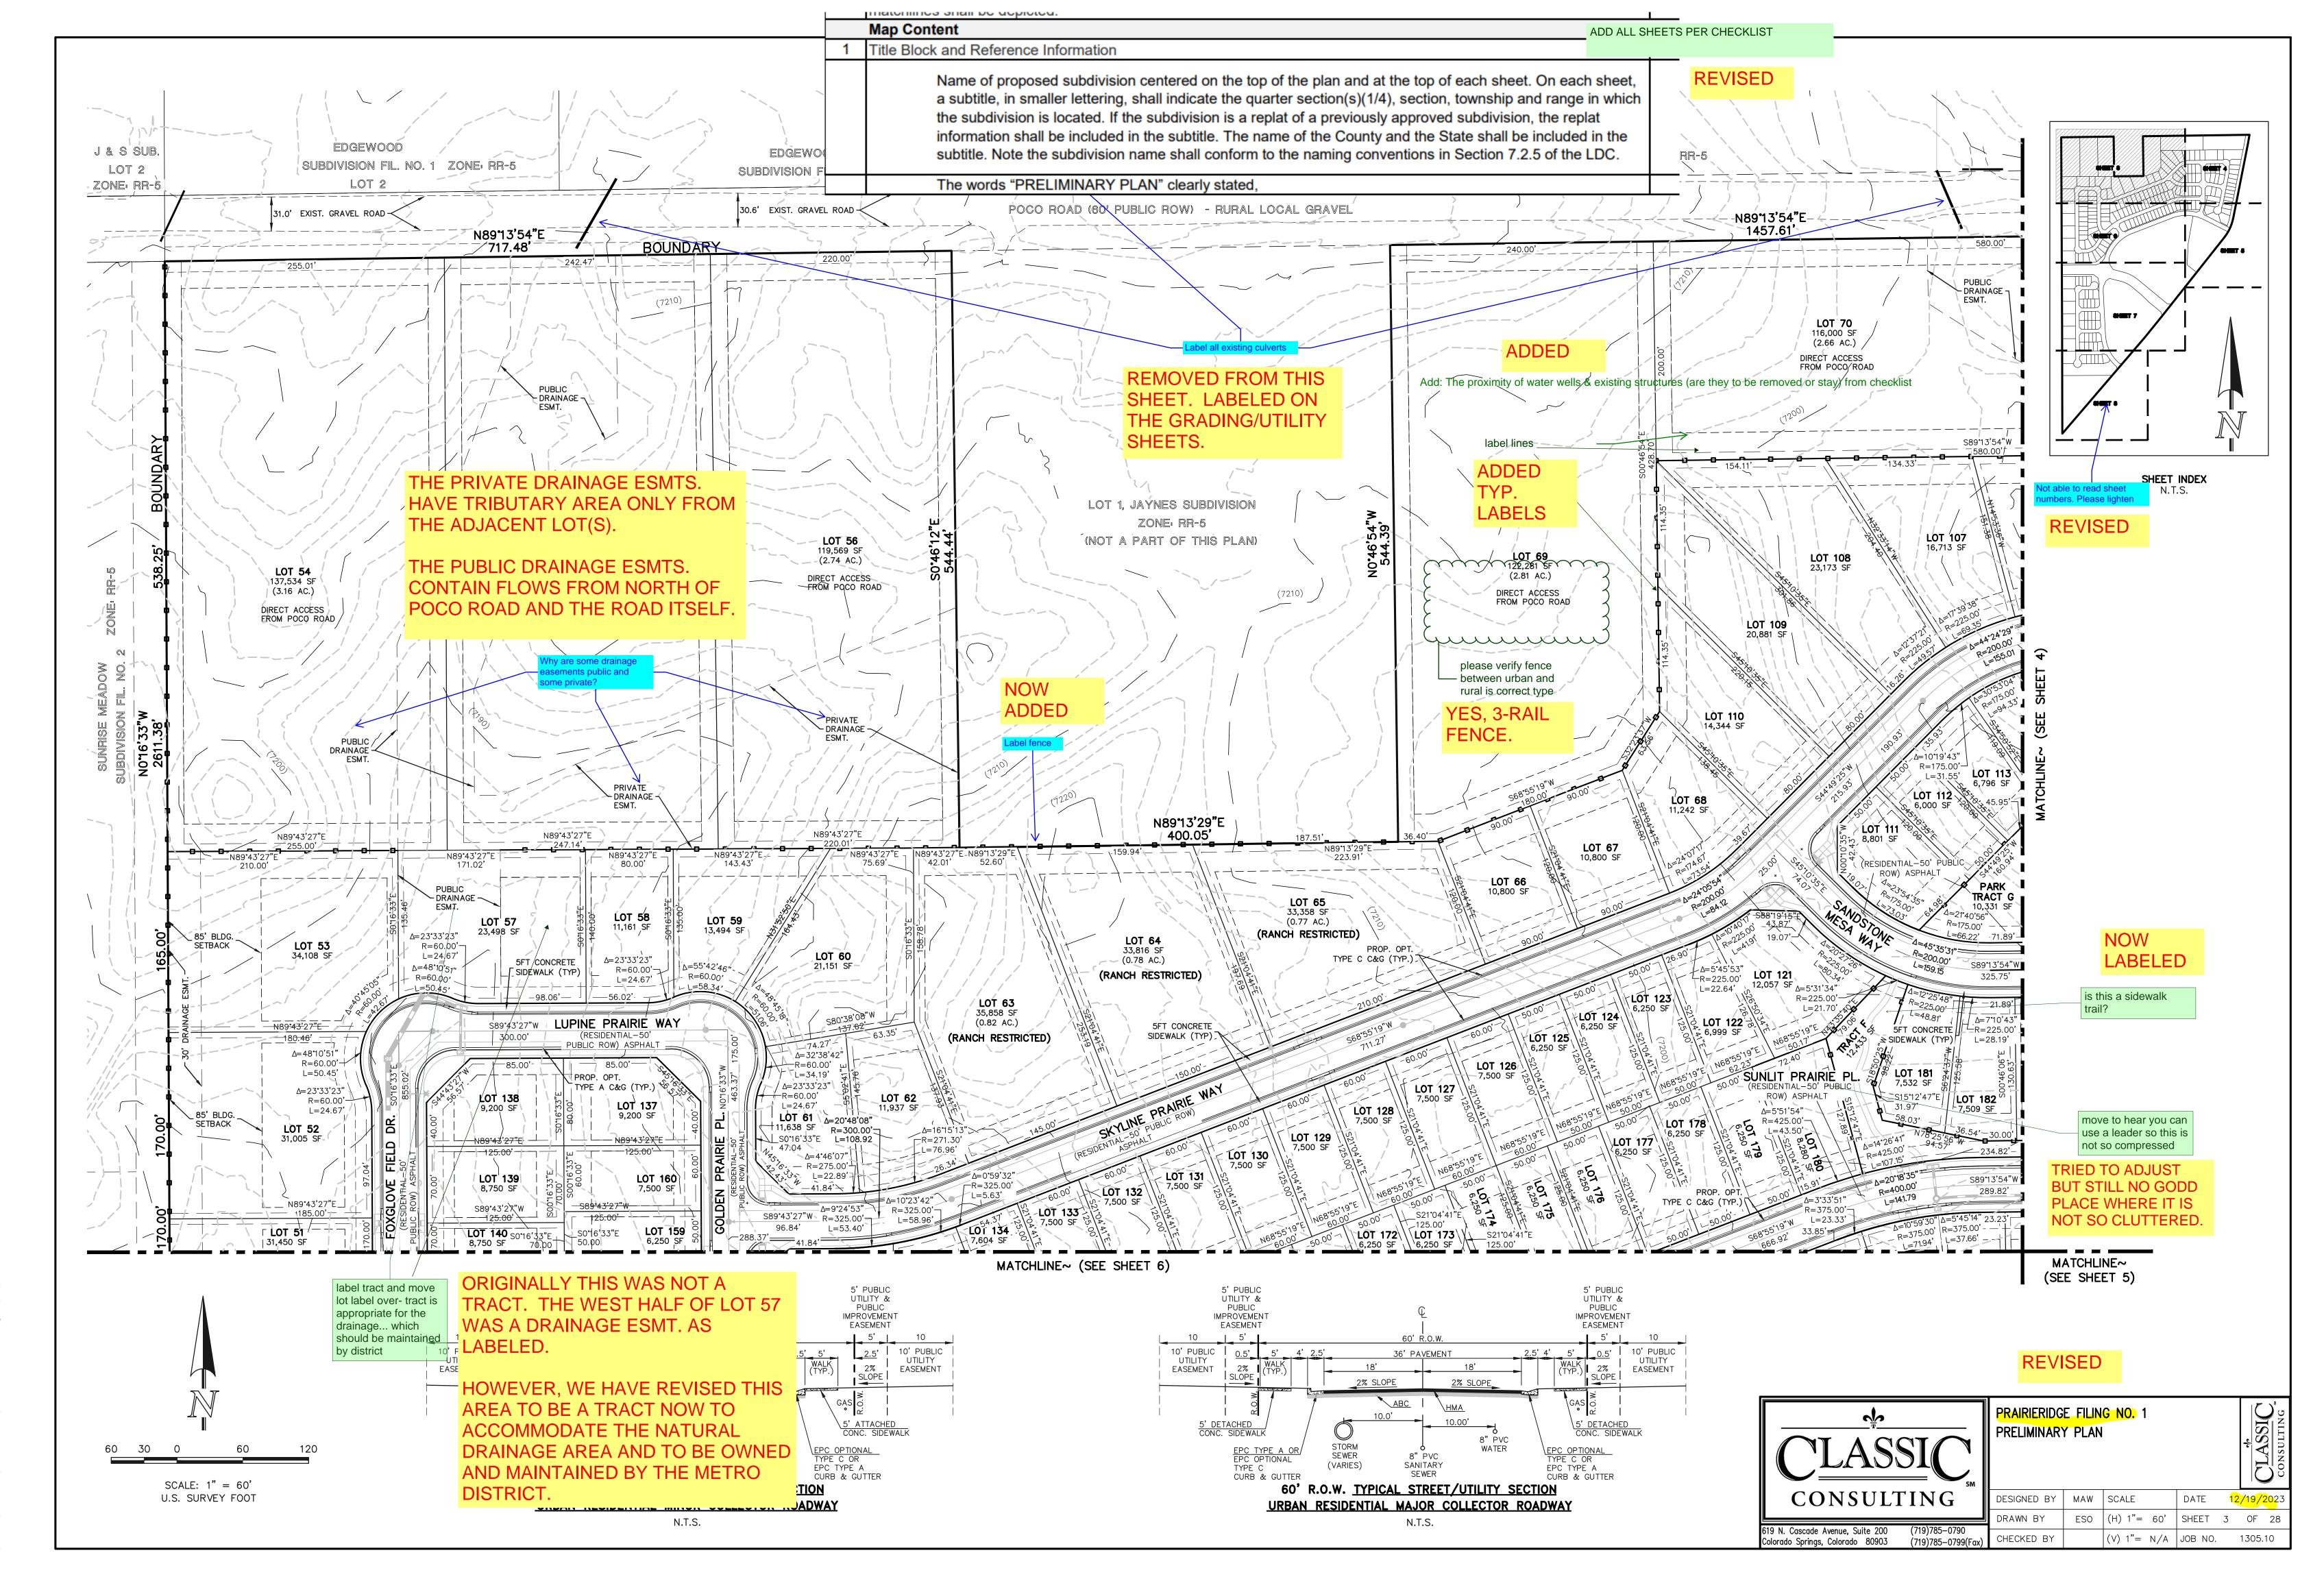

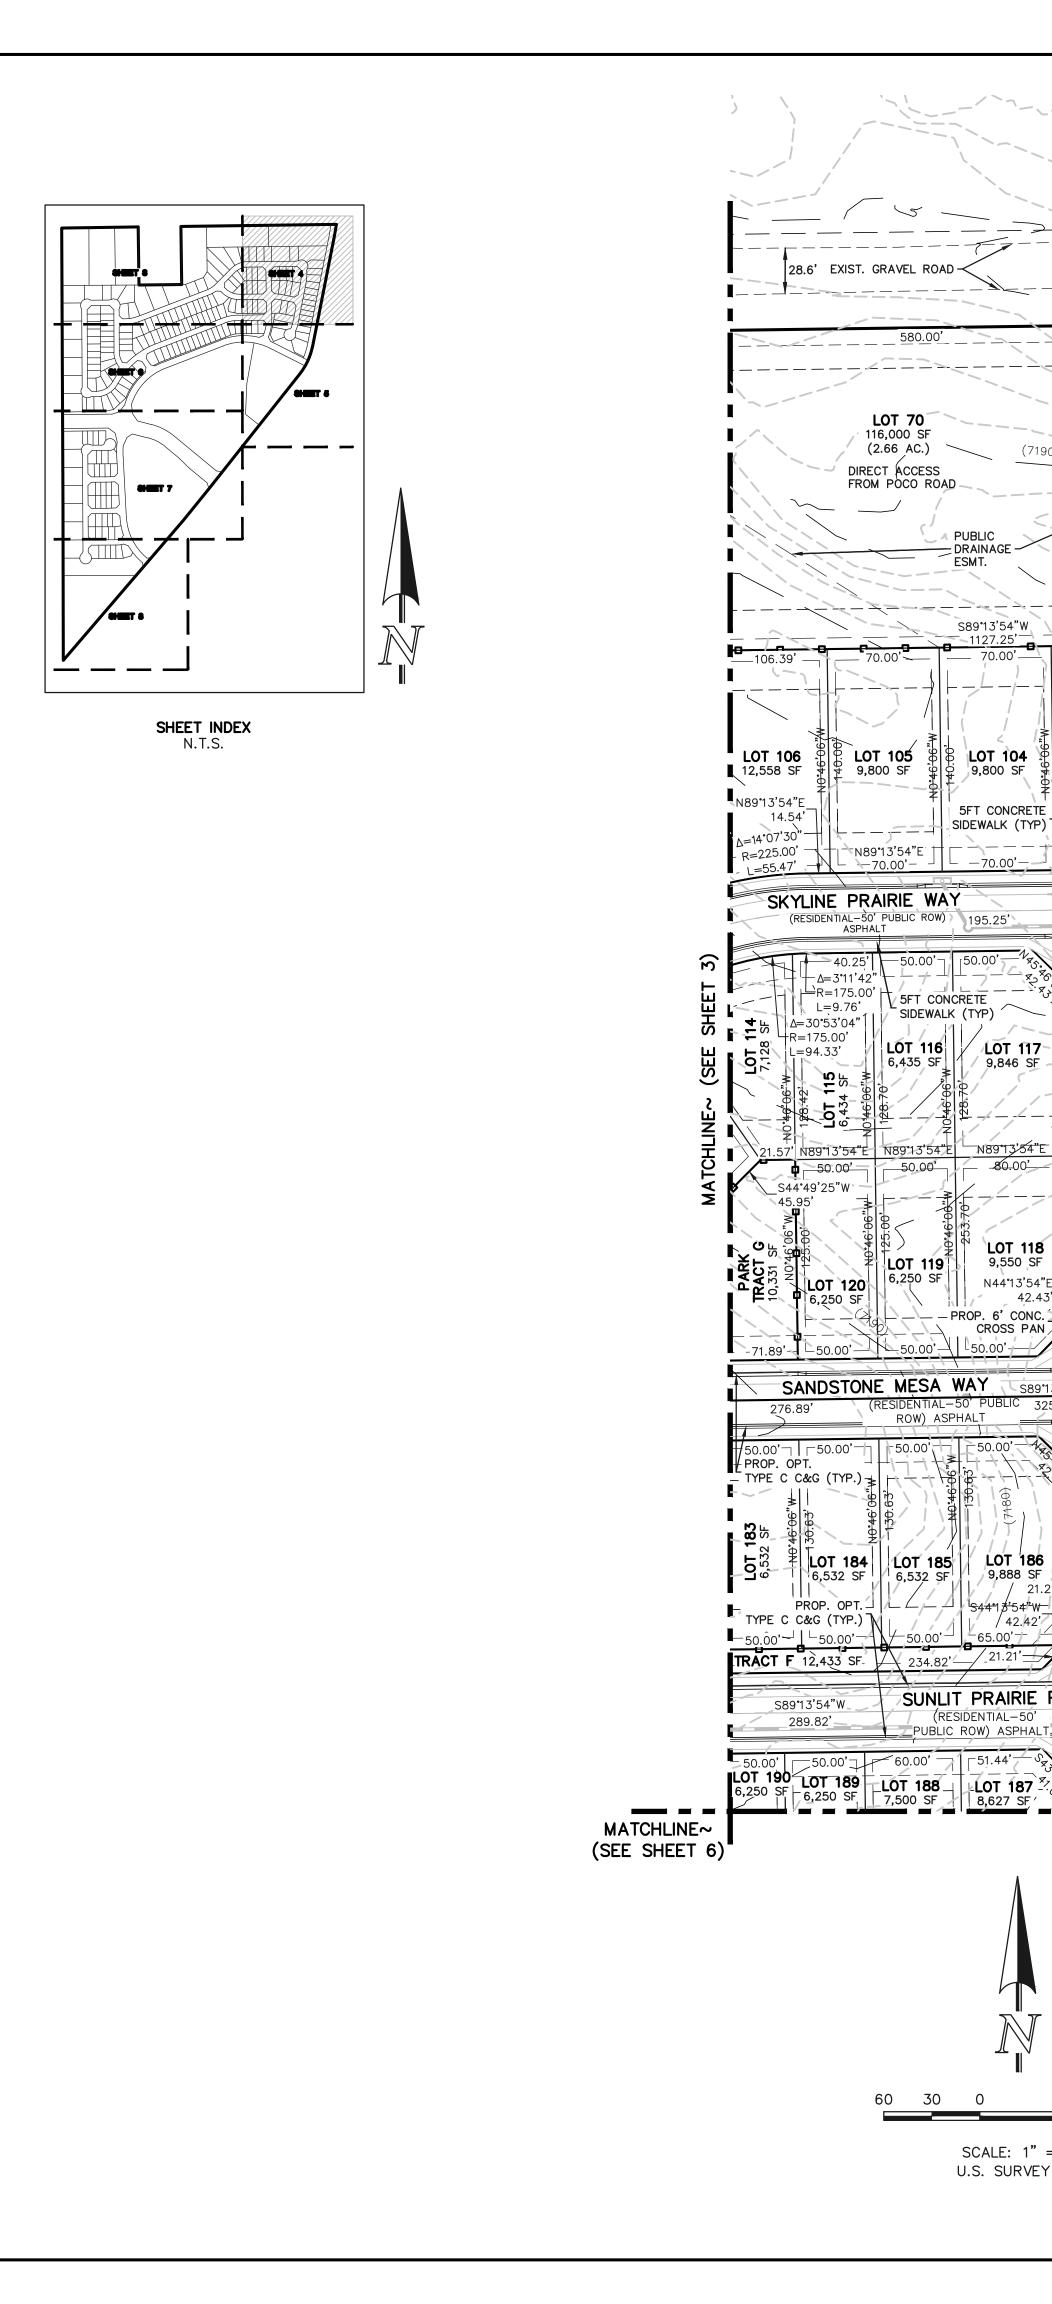



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PUBLIC

ESMT.

1 50.00



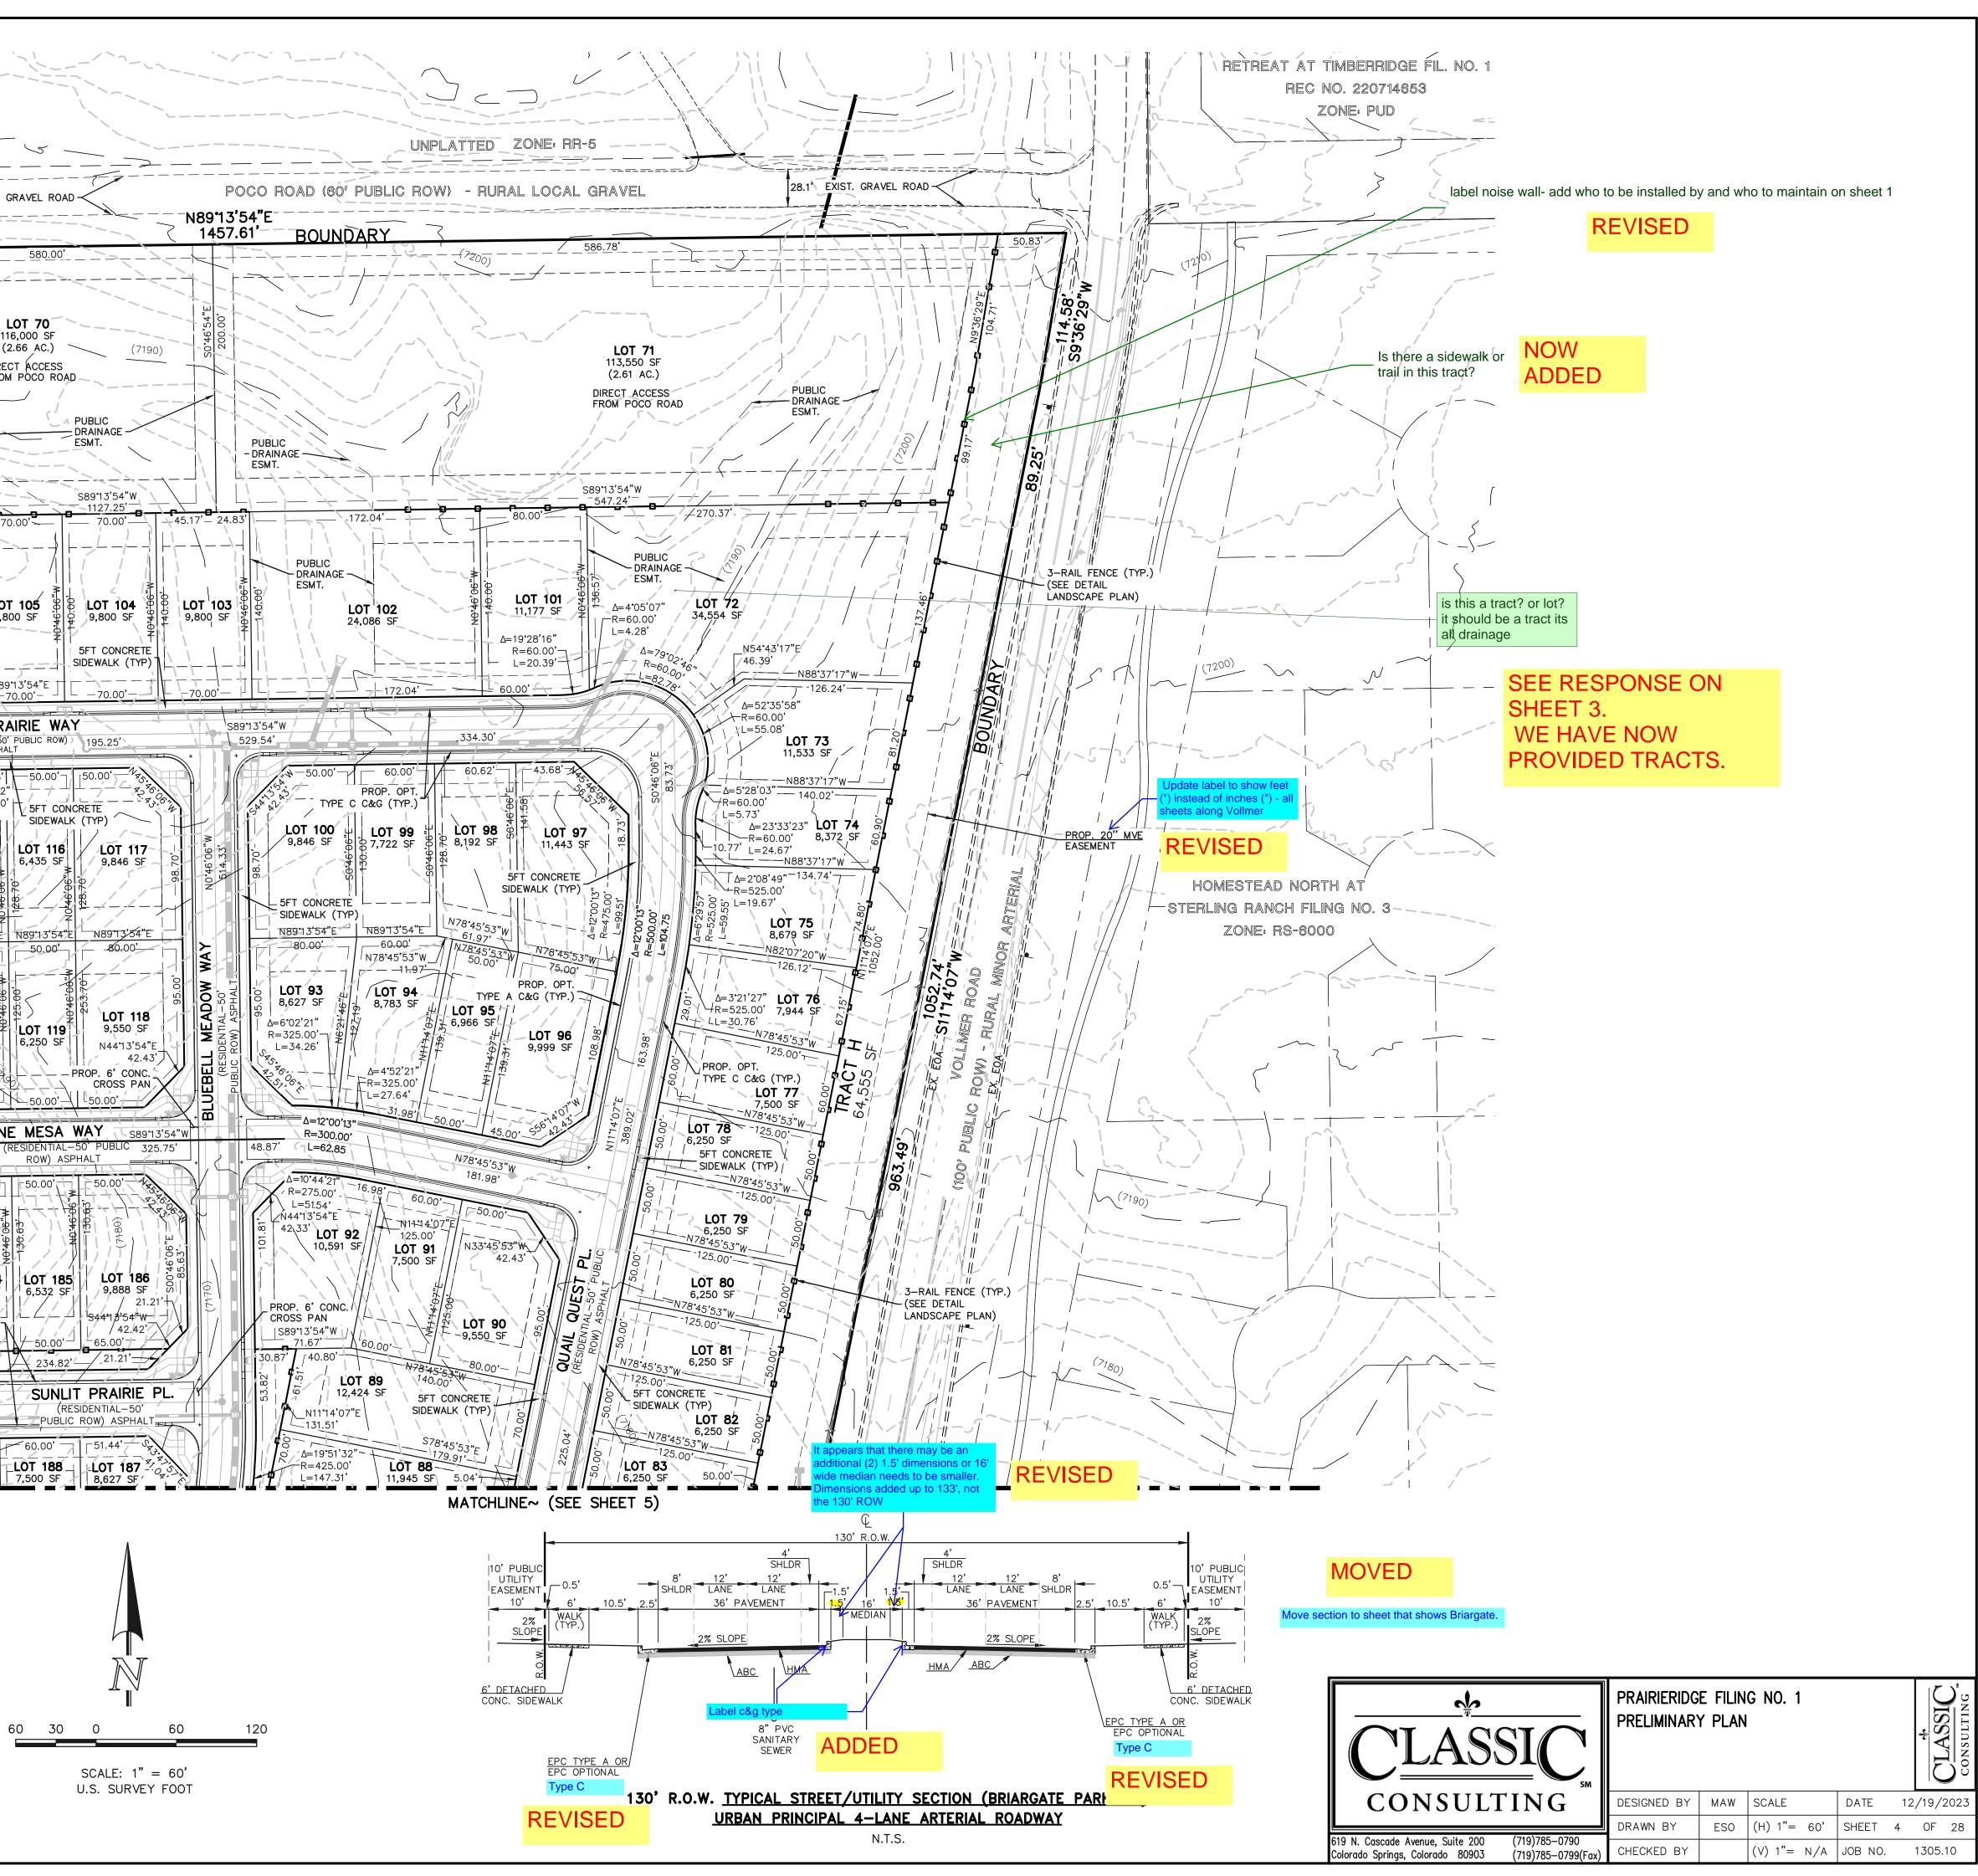


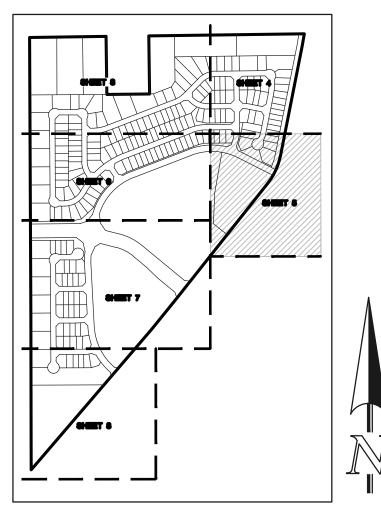SHEET INDEX N.T.S.

REVISED

we cant leave off sliver of land less than 35 acres it would be an illegal parcel. add this to be FUTURE DEVELOPMENT tract or Park


ADDED

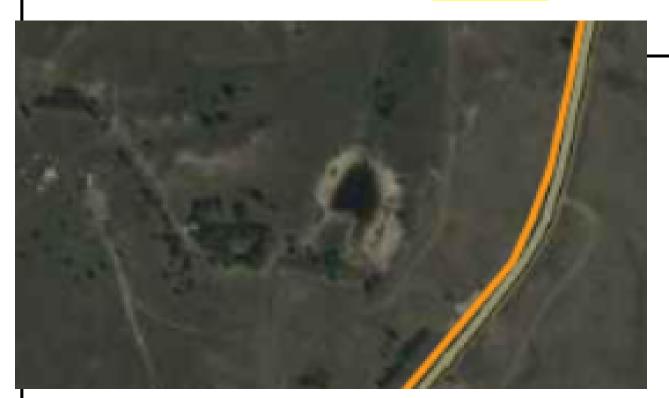


laterals, Add labels per

checklist -state to remain or be removed; these are natural features - should they be preserved per Code Chapter 8; and per SKP process

REVISED

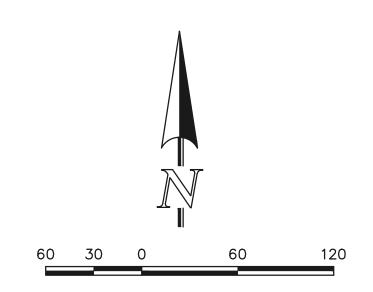

SCALE: 1" = 60' U.S. SURVEY FOOT

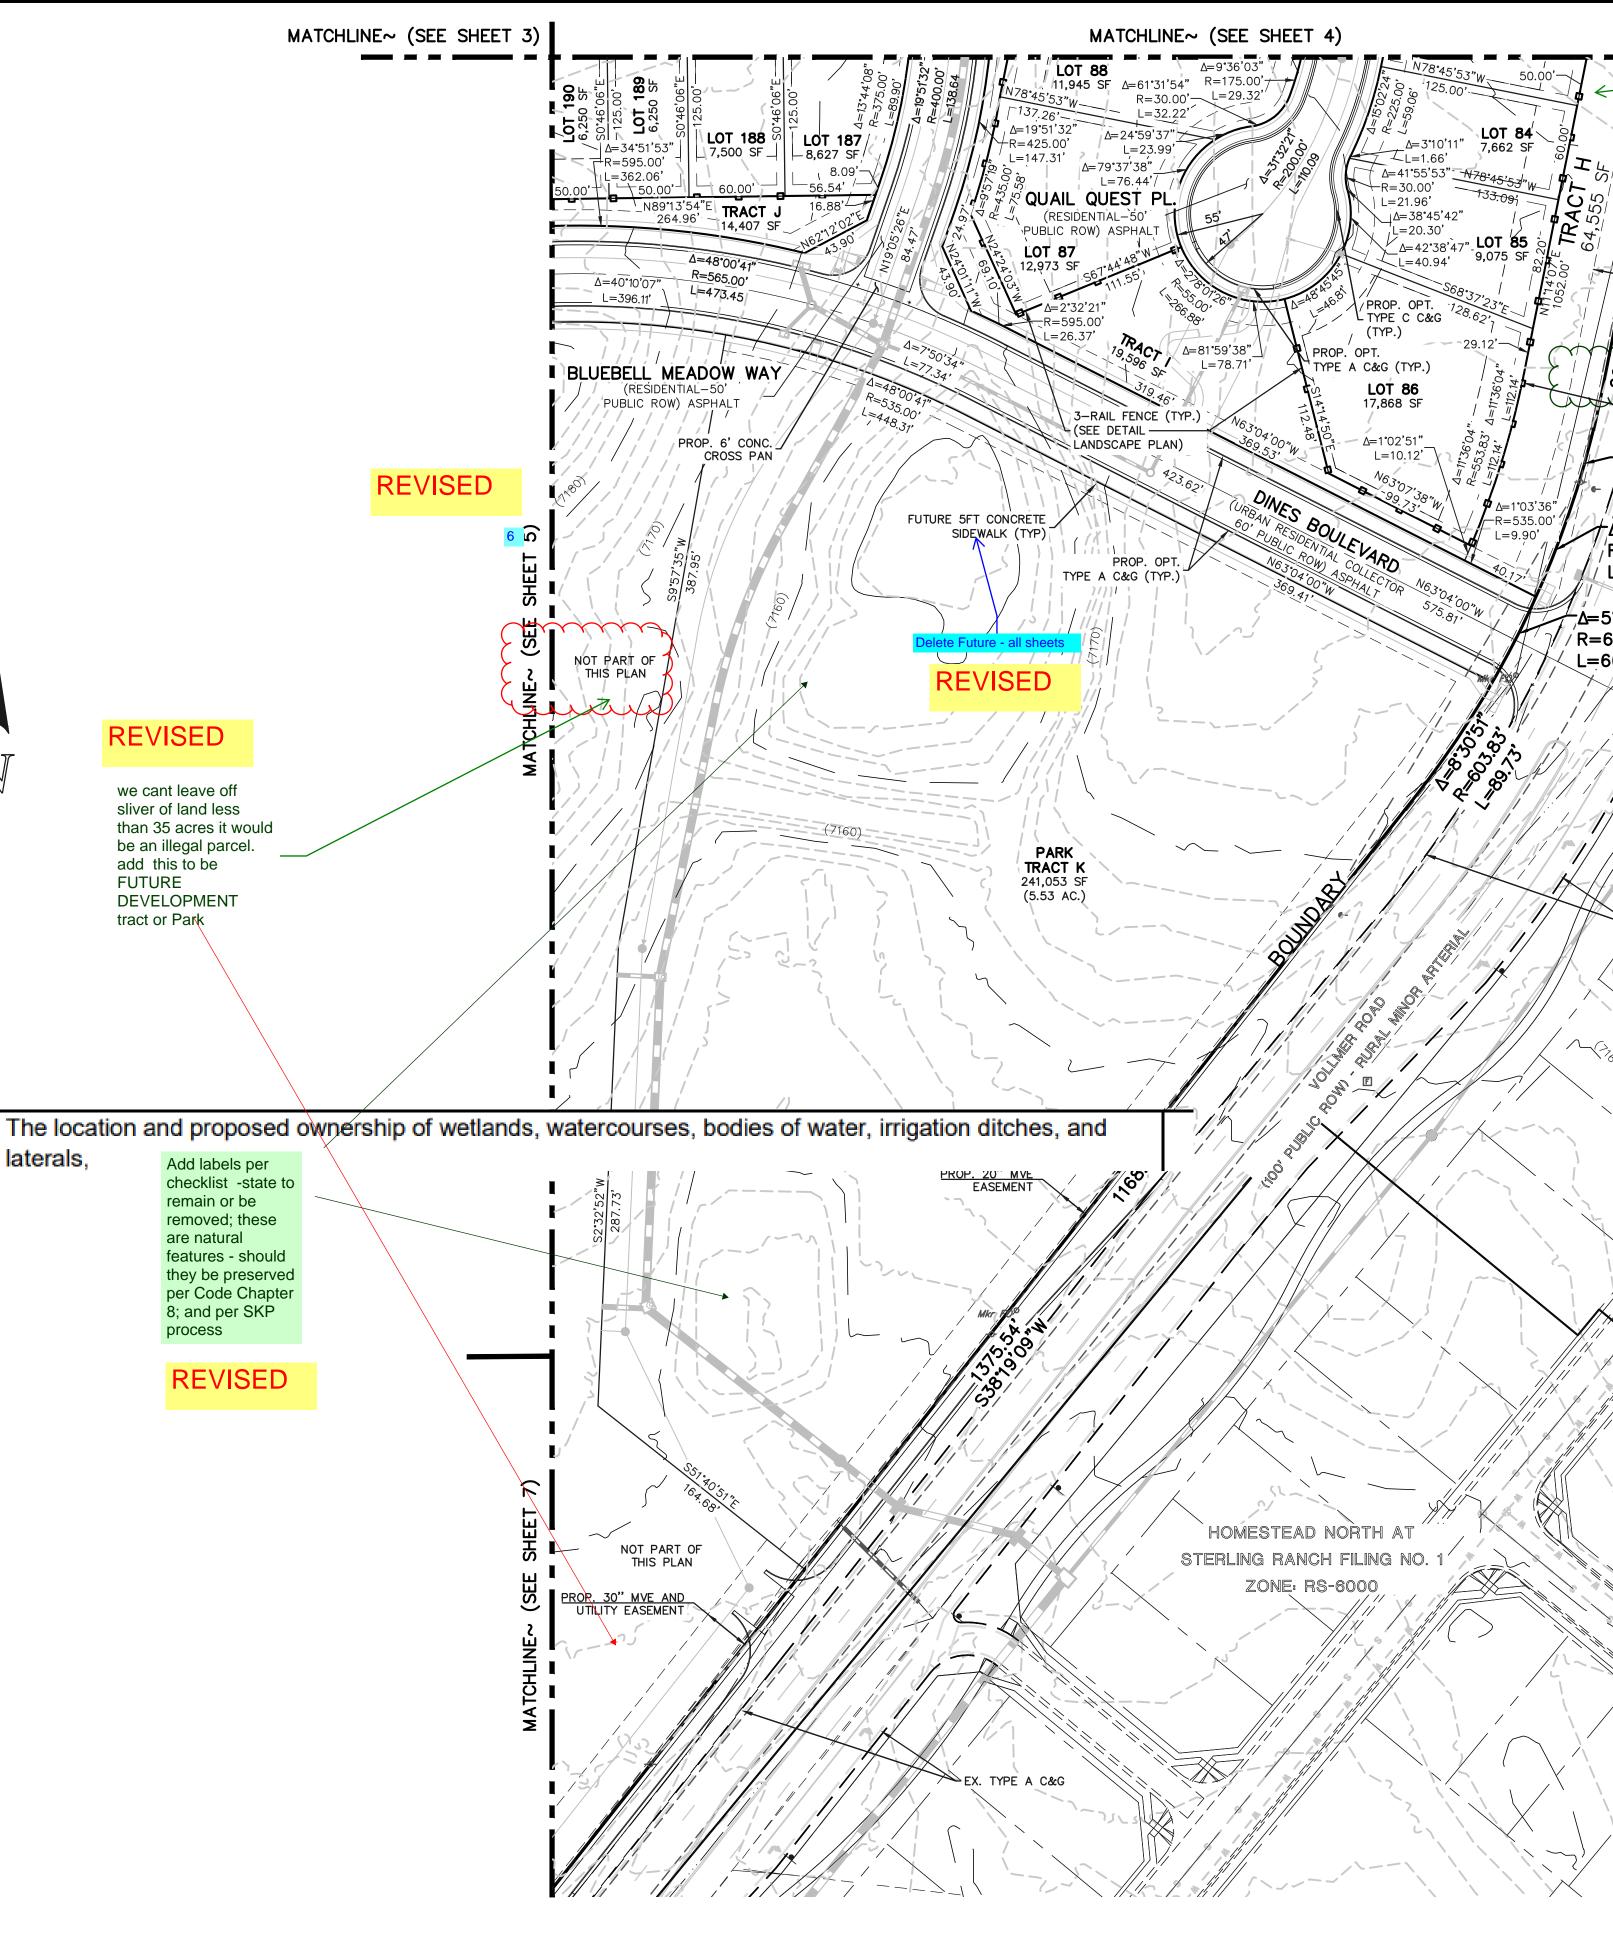

label noise wa	all- add who to be installed by and who to maintain on sheet 1	
0252.73 14.07		
	REVISED	
	Fix cut off text	
PROP. 20" MVE STERLING RANCE		
5 ZONE: R 50 50 50 50 50 50 50 50 50 50		
σ 3- (SEE DETAIL LANDSCAPE PLAN)		
-Δ=12.53.54"	is there a trail or sidewalk in this tract?	
R=603.83' / /L=135.93'	ADDED	
Δ=27°06'29" / // · · · · · · · · · · · · · · · · ·		
L=285.68'		
03.83' 00.02' UNPLATTED (7170)		
152.1g·		
EXIST. DINES (50' ROW)		
SO BOW		
EX. TYPE A C&G		
HOMESTEAD NORTH AT		
STERLING RANCH FILING NO. 2 ZONE: RS-6000		
	PRAIRIERIDGE FILING NO. 1	
CLASSI	PRELIMINARY PLAN	<u>LASSIC</u>
CONSULTIN		
	NG DESIGNED BY MAW SCALE DATE	12/19/2023

619 N. Cascade Avenue, Suite 200

Colorado Springs, Colorado 80903


(719)785–0790


(719)785-0799(Fax)


CHECKED BY

DRAWN BY ESO (H) 1"= 60' SHEET 5 OF 28


(V) 1"= N/A JOB NO. 1305.10

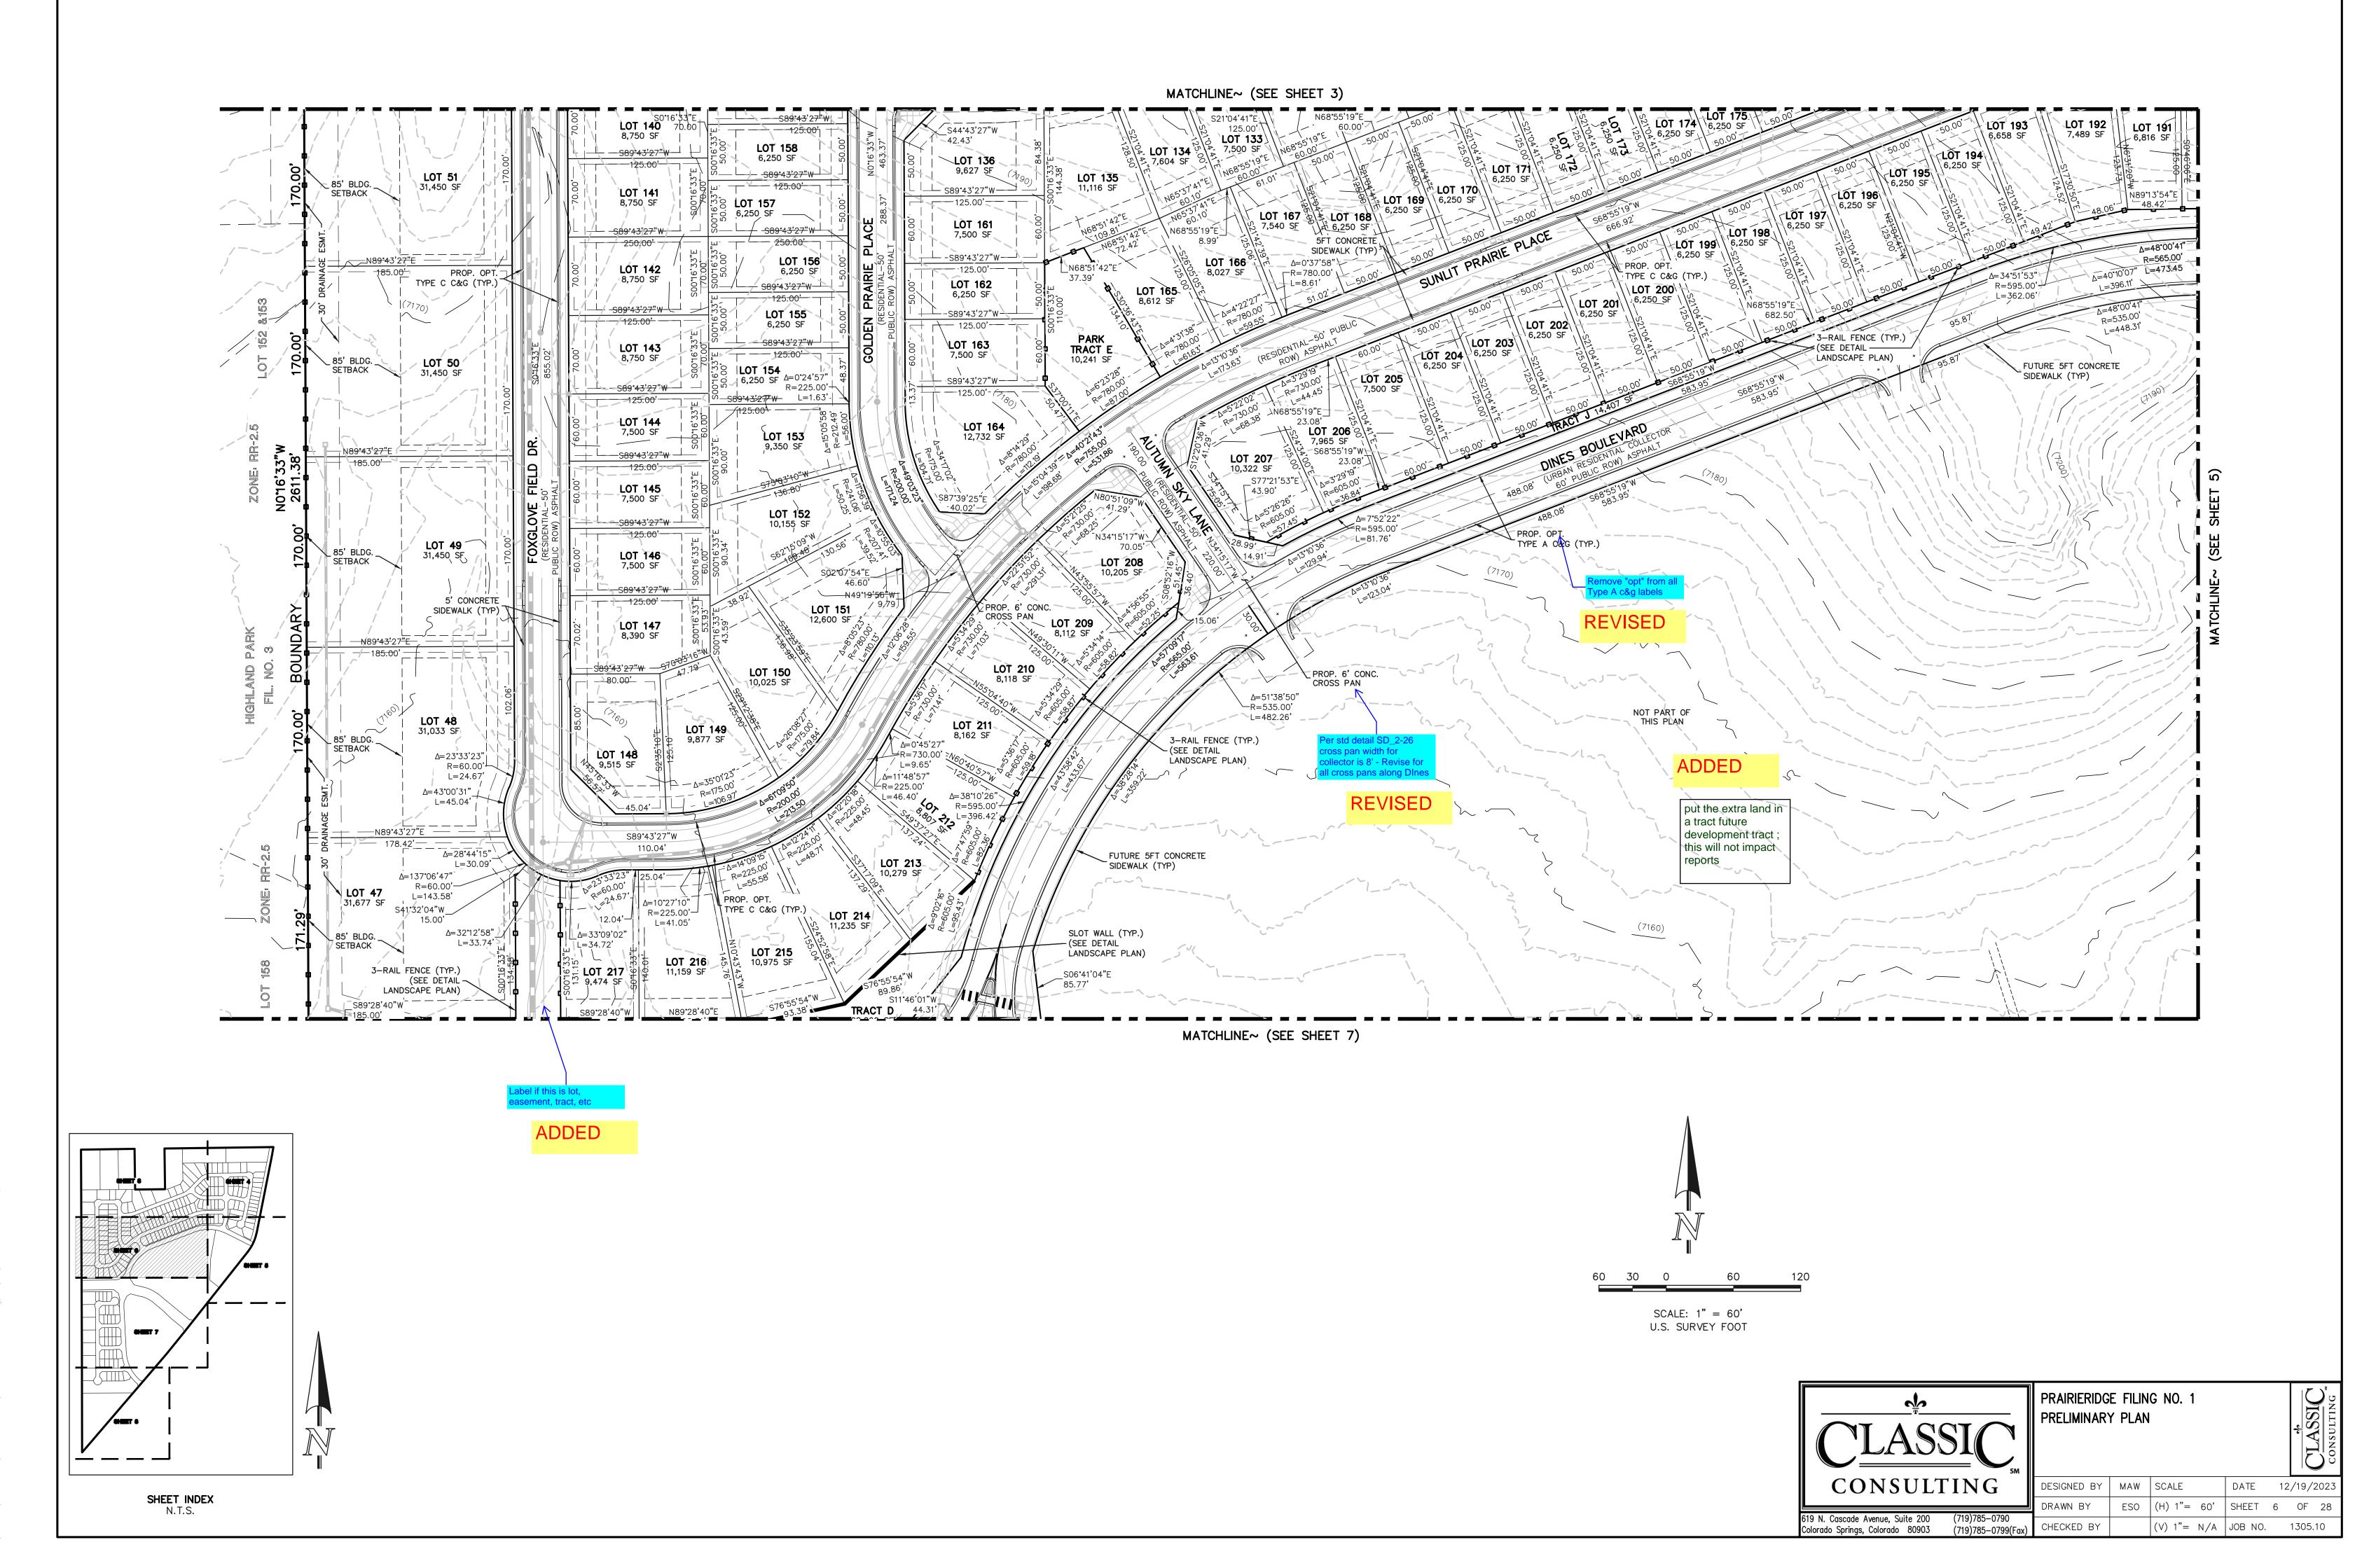

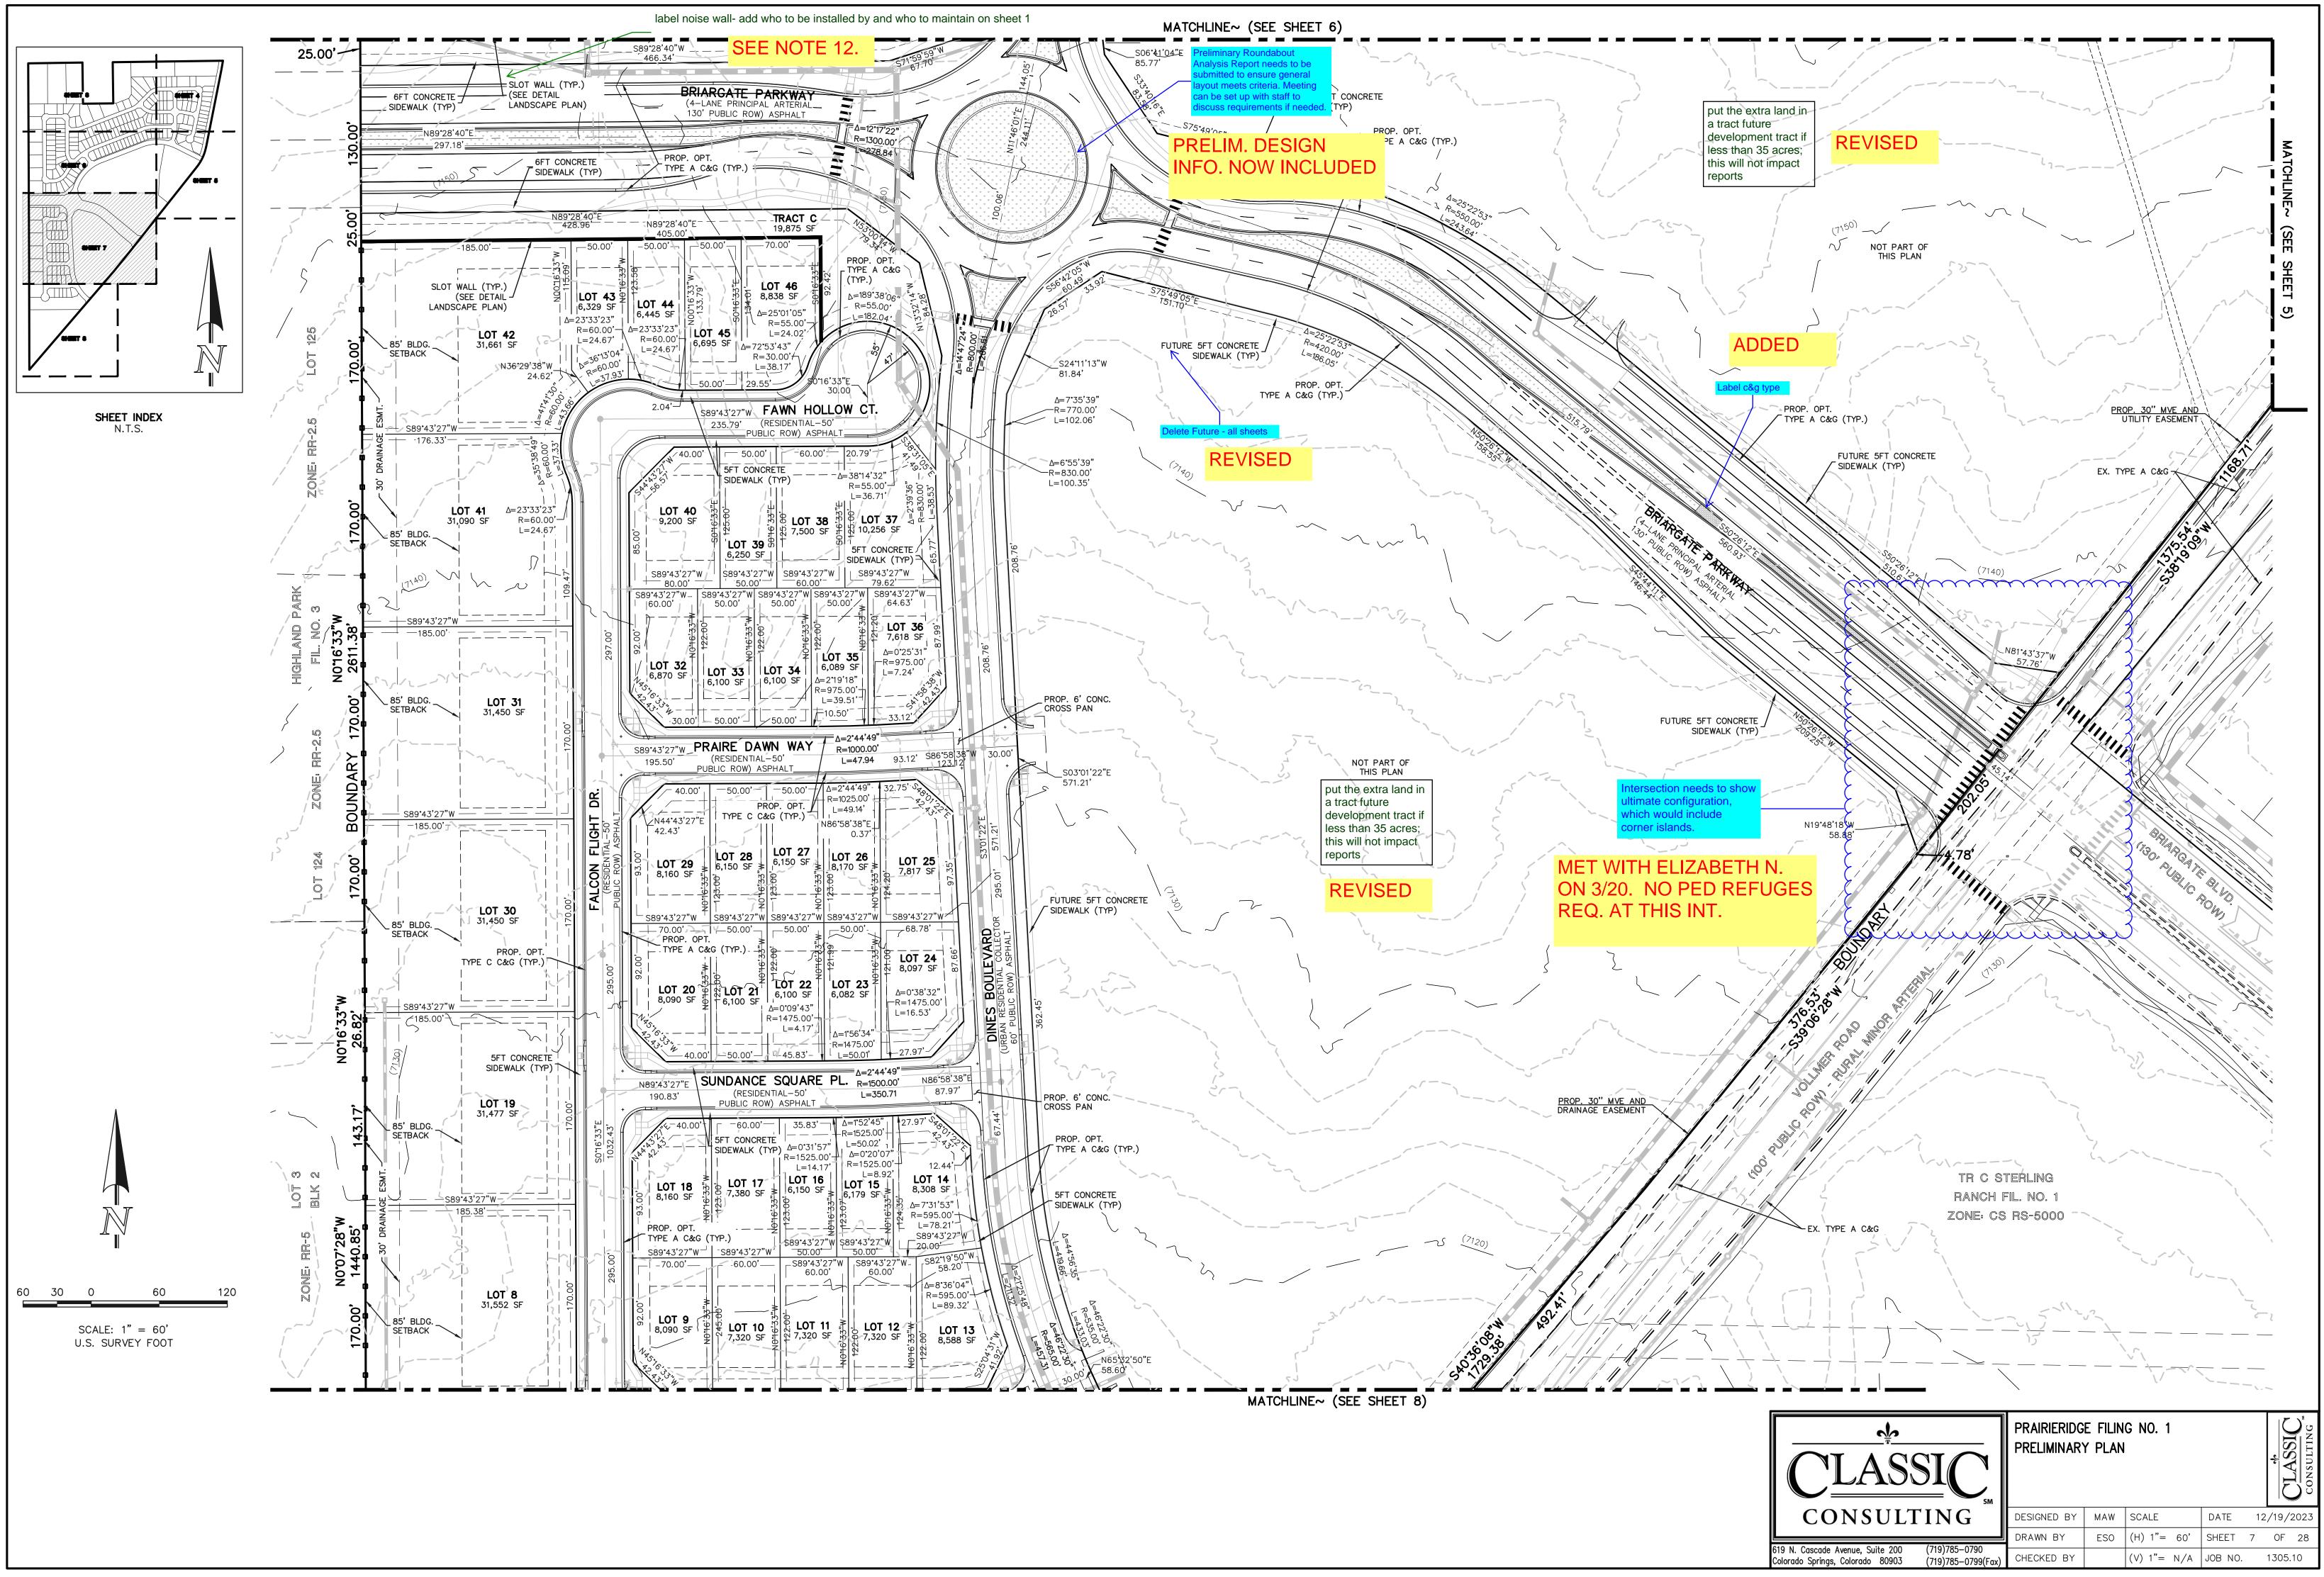


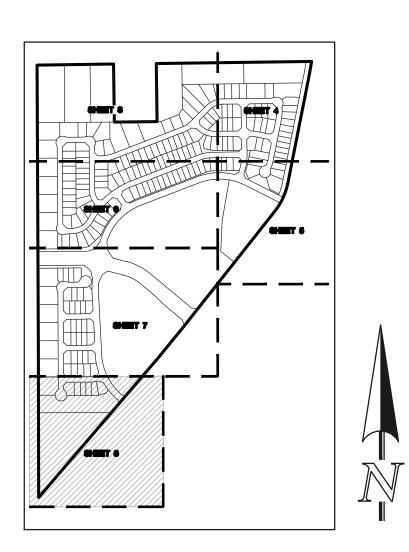



SHEET INDEX N.T.S.

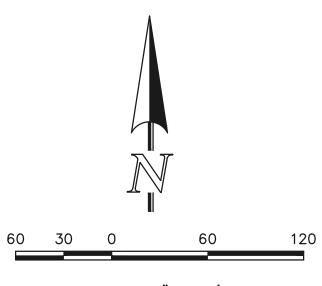


SCALE: 1" = 60' U.S. SURVEY FOOT

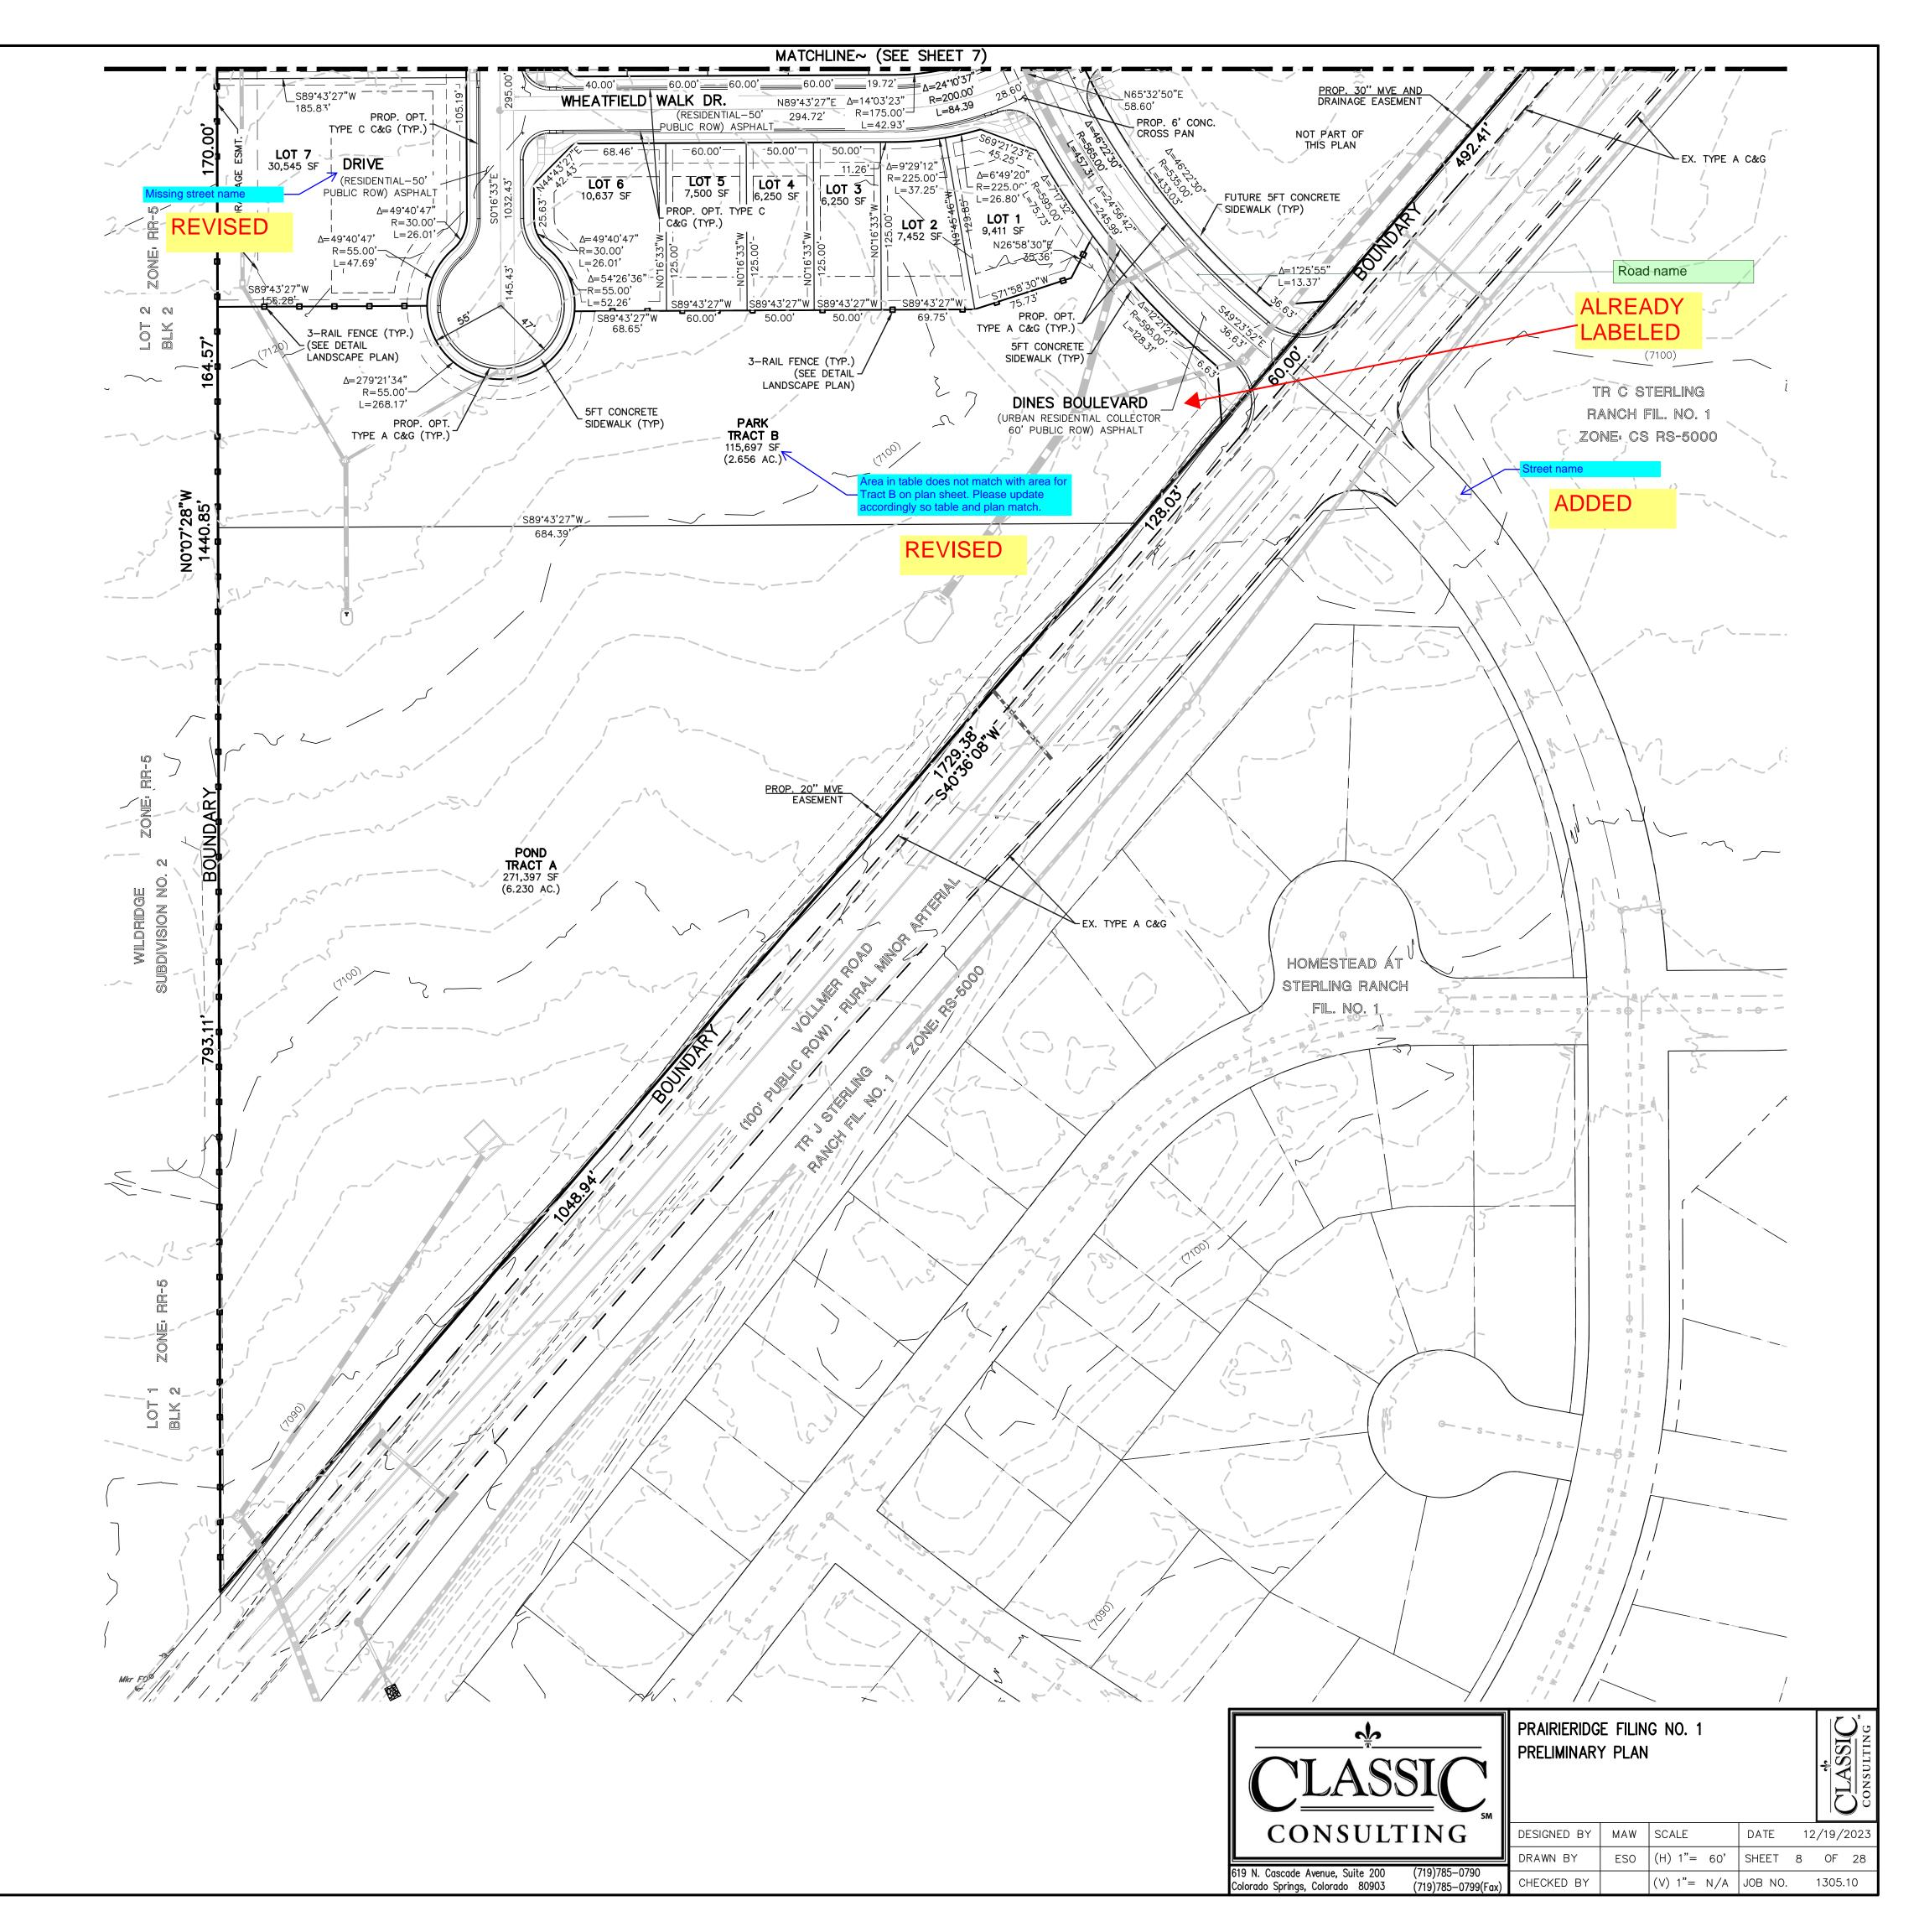

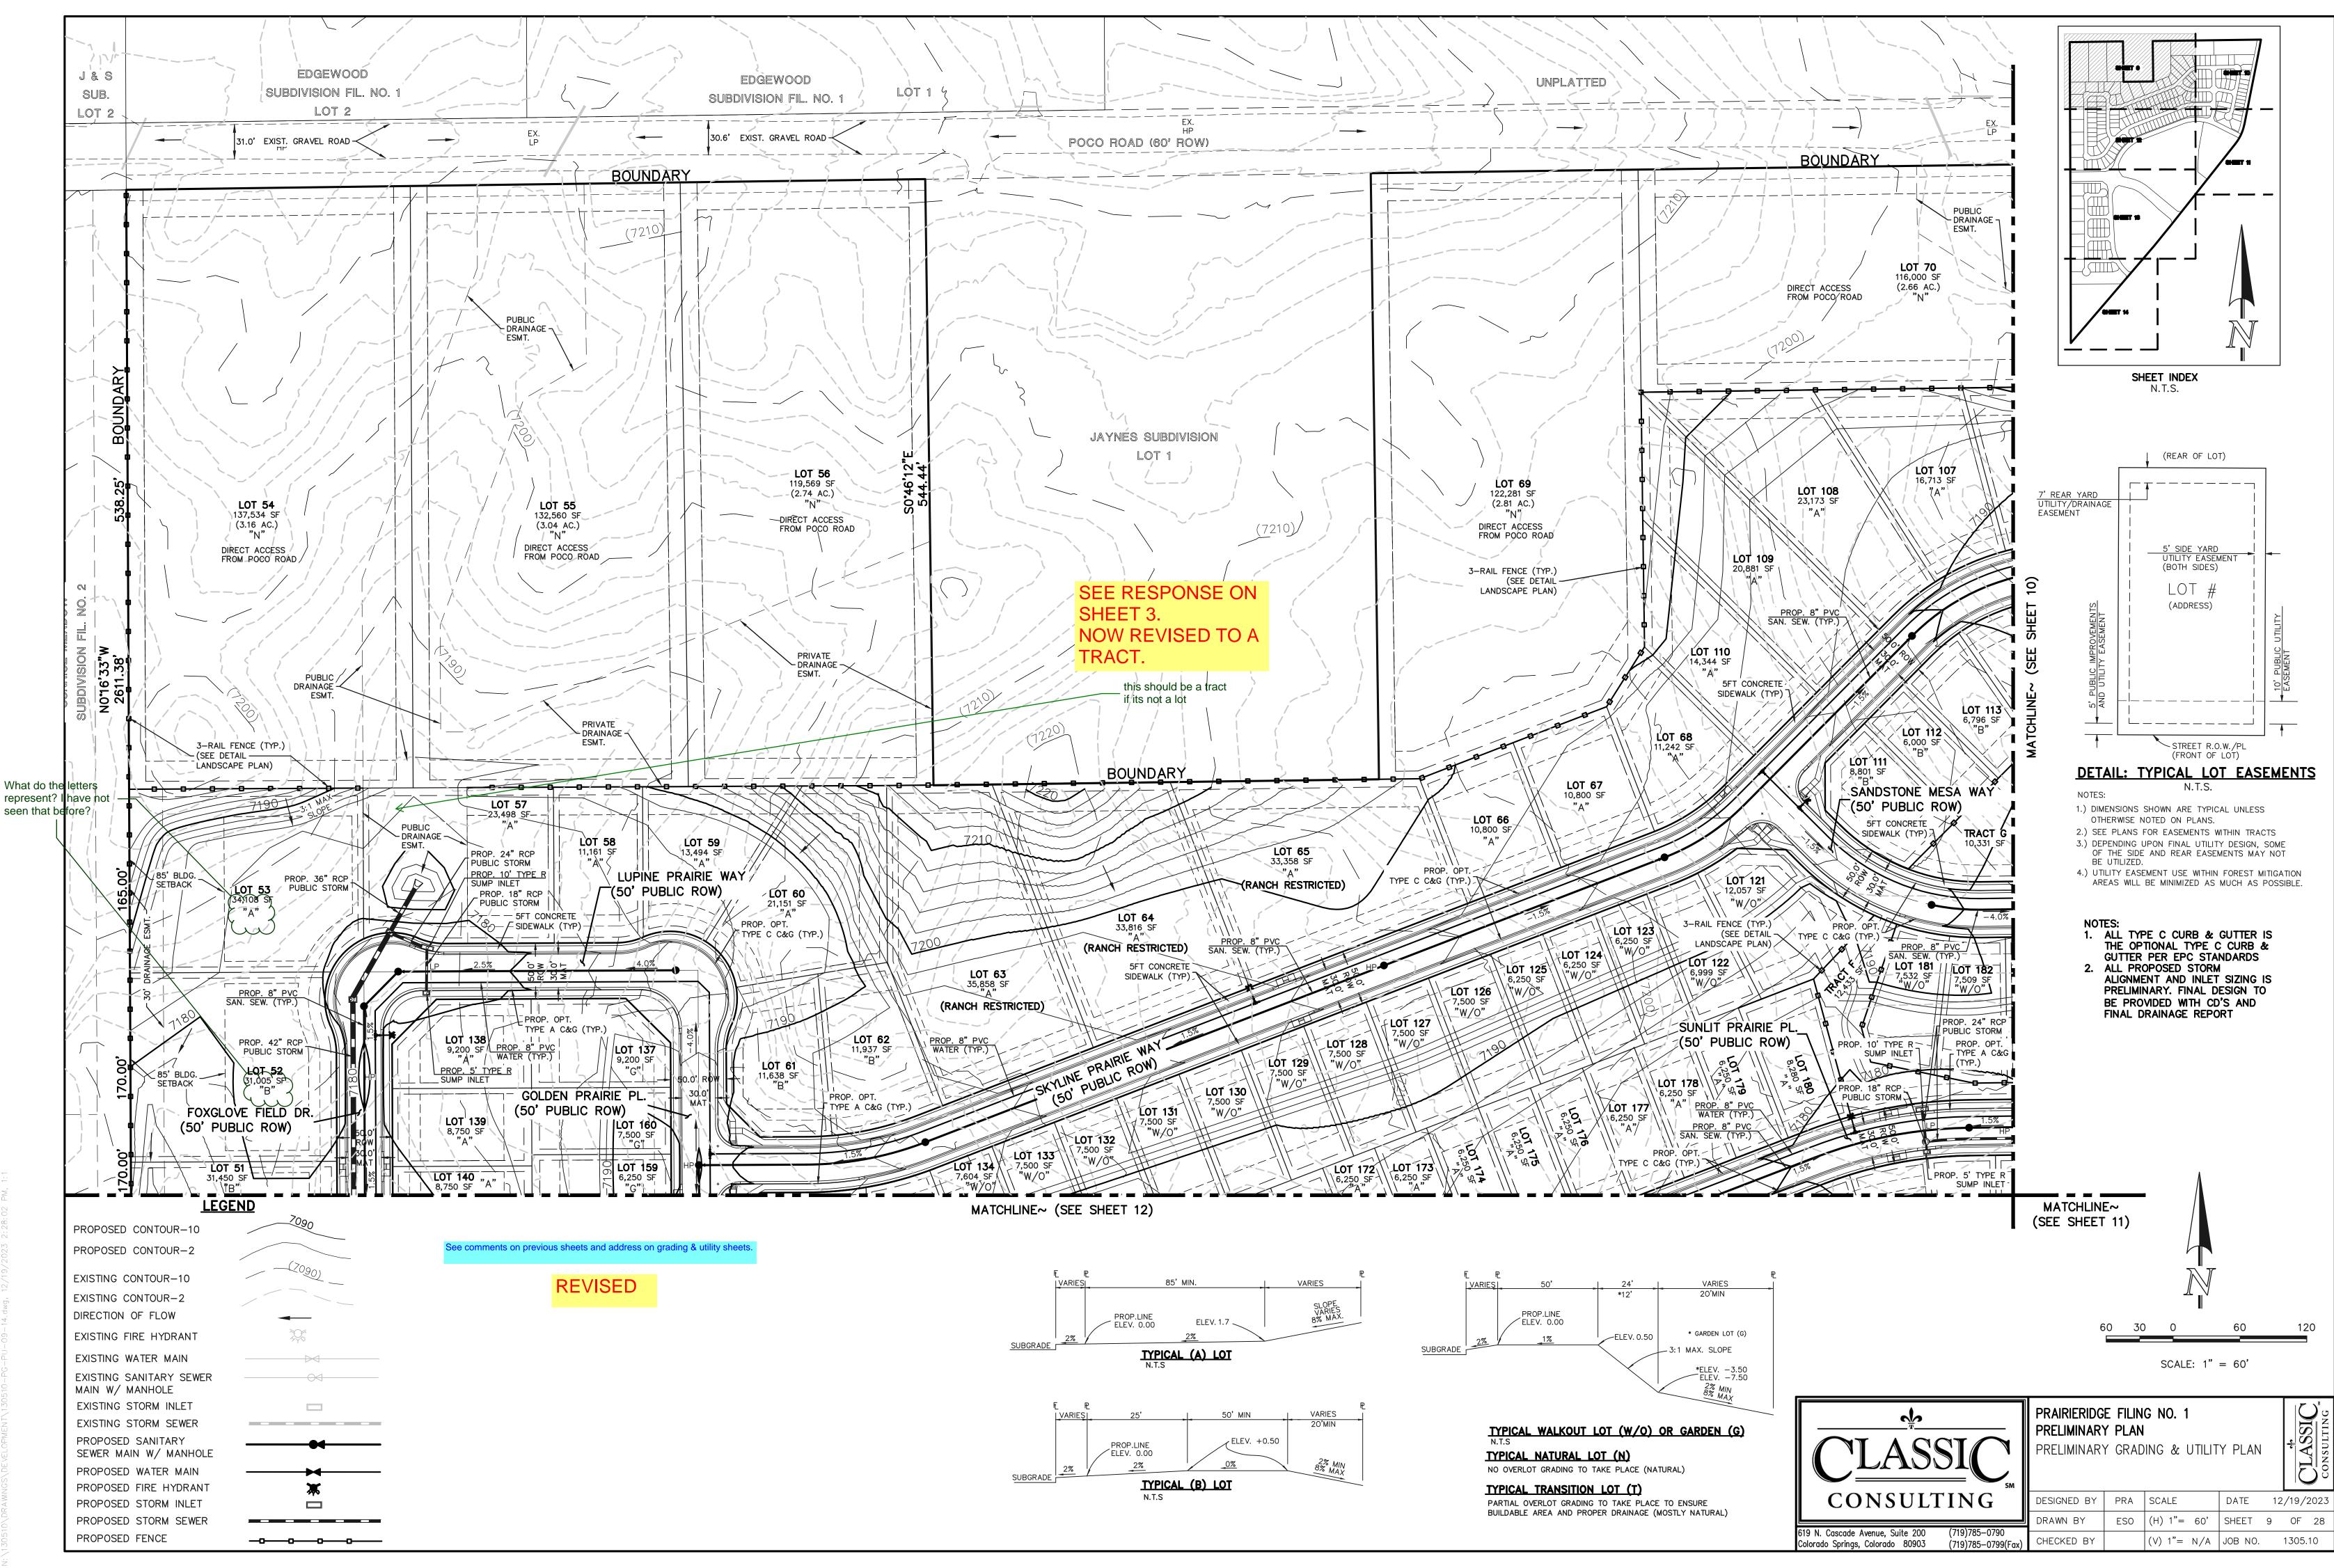

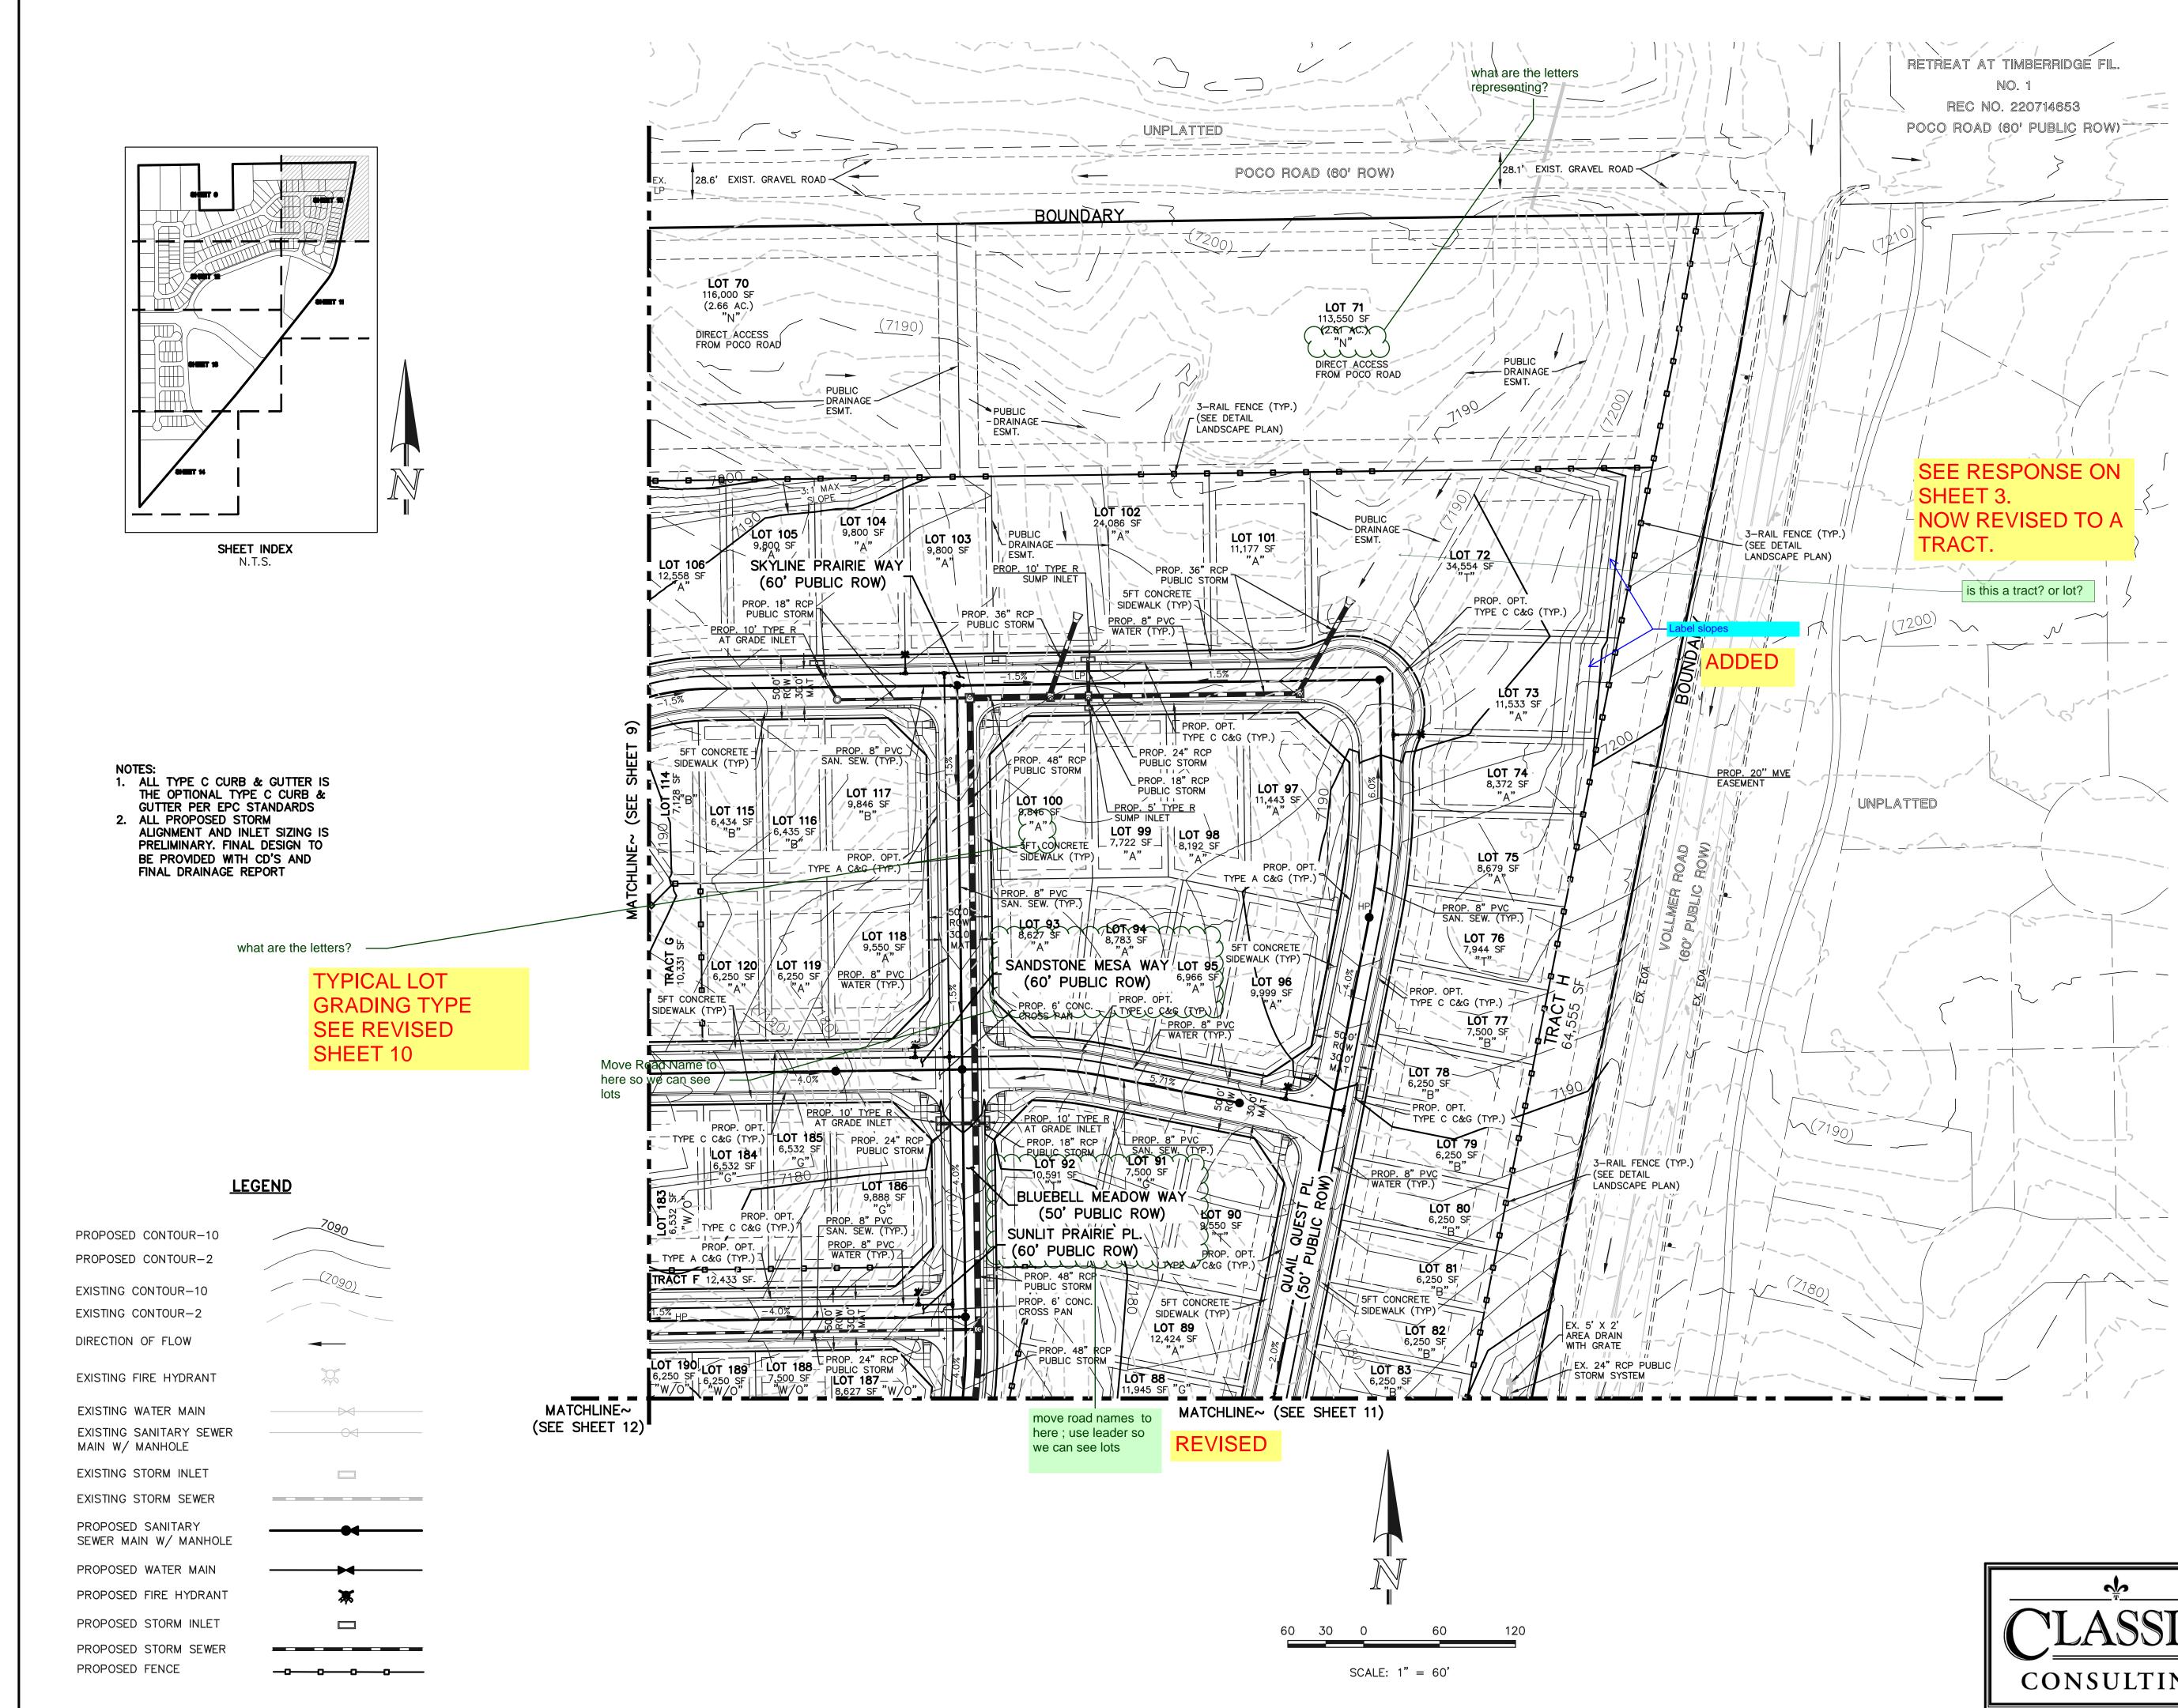


CLASSIC.	PRAIRIERIDG PRELIMINAR PRELIMINAR	r plan		Y PLAN	<u>CLASSIC</u> consulting
CONSULTING	DESIGNED BY	PRA	SCALE	DATE 12	2/19/2023
	DRAWN BY	ESO	(H) 1"= 60'	SHEET 10	OF 28
619 N. Cascade Avenue, Suite 200 (719)785–0790 Colorado Springs, Colorado 80903 (719)785–0799(Fax)	CHECKED BY		(V) 1"= N/A	JOB NO.	1305.10

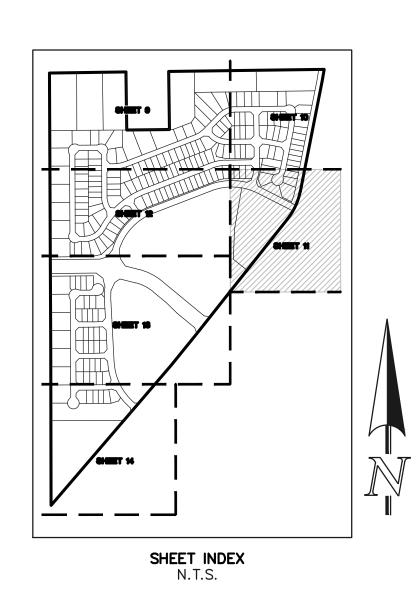

<u>LEGEND</u>

	7090
PROPOSED CONTOUR-10	
PROPOSED CONTOUR-2	
EXISTING CONTOUR-10	
EXISTING CONTOUR-2	
DIRECTION OF FLOW	-
EXISTING FIRE HYDRANT	
EXISTING WATER MAIN	
EXISTING SANITARY SEWER MAIN W/ MANHOLE	
EXISTING STORM INLET	
EXISTING STORM SEWER	
PROPOSED SANITARY SEWER MAIN W/ MANHOLE	
PROPOSED WATER MAIN	→
PROPOSED FIRE HYDRANT	*
PROPOSED STORM INLET	
PROPOSED STORM SEWER	
PROPOSED FENCE	-000

- NOTES:
 ALL TYPE C CURB & GUTTER IS THE OPTIONAL TYPE C CURB & GUTTER PER EPC STANDARDS
 ALL PROPOSED STORM ALIGNMENT AND INLET SIZING IS PRELIMINARY. FINAL DESIGN TO DE DROMOED WITH OD'S AND BE PROVIDED WITH CD'S AND FINAL DRAINAGE REPORT

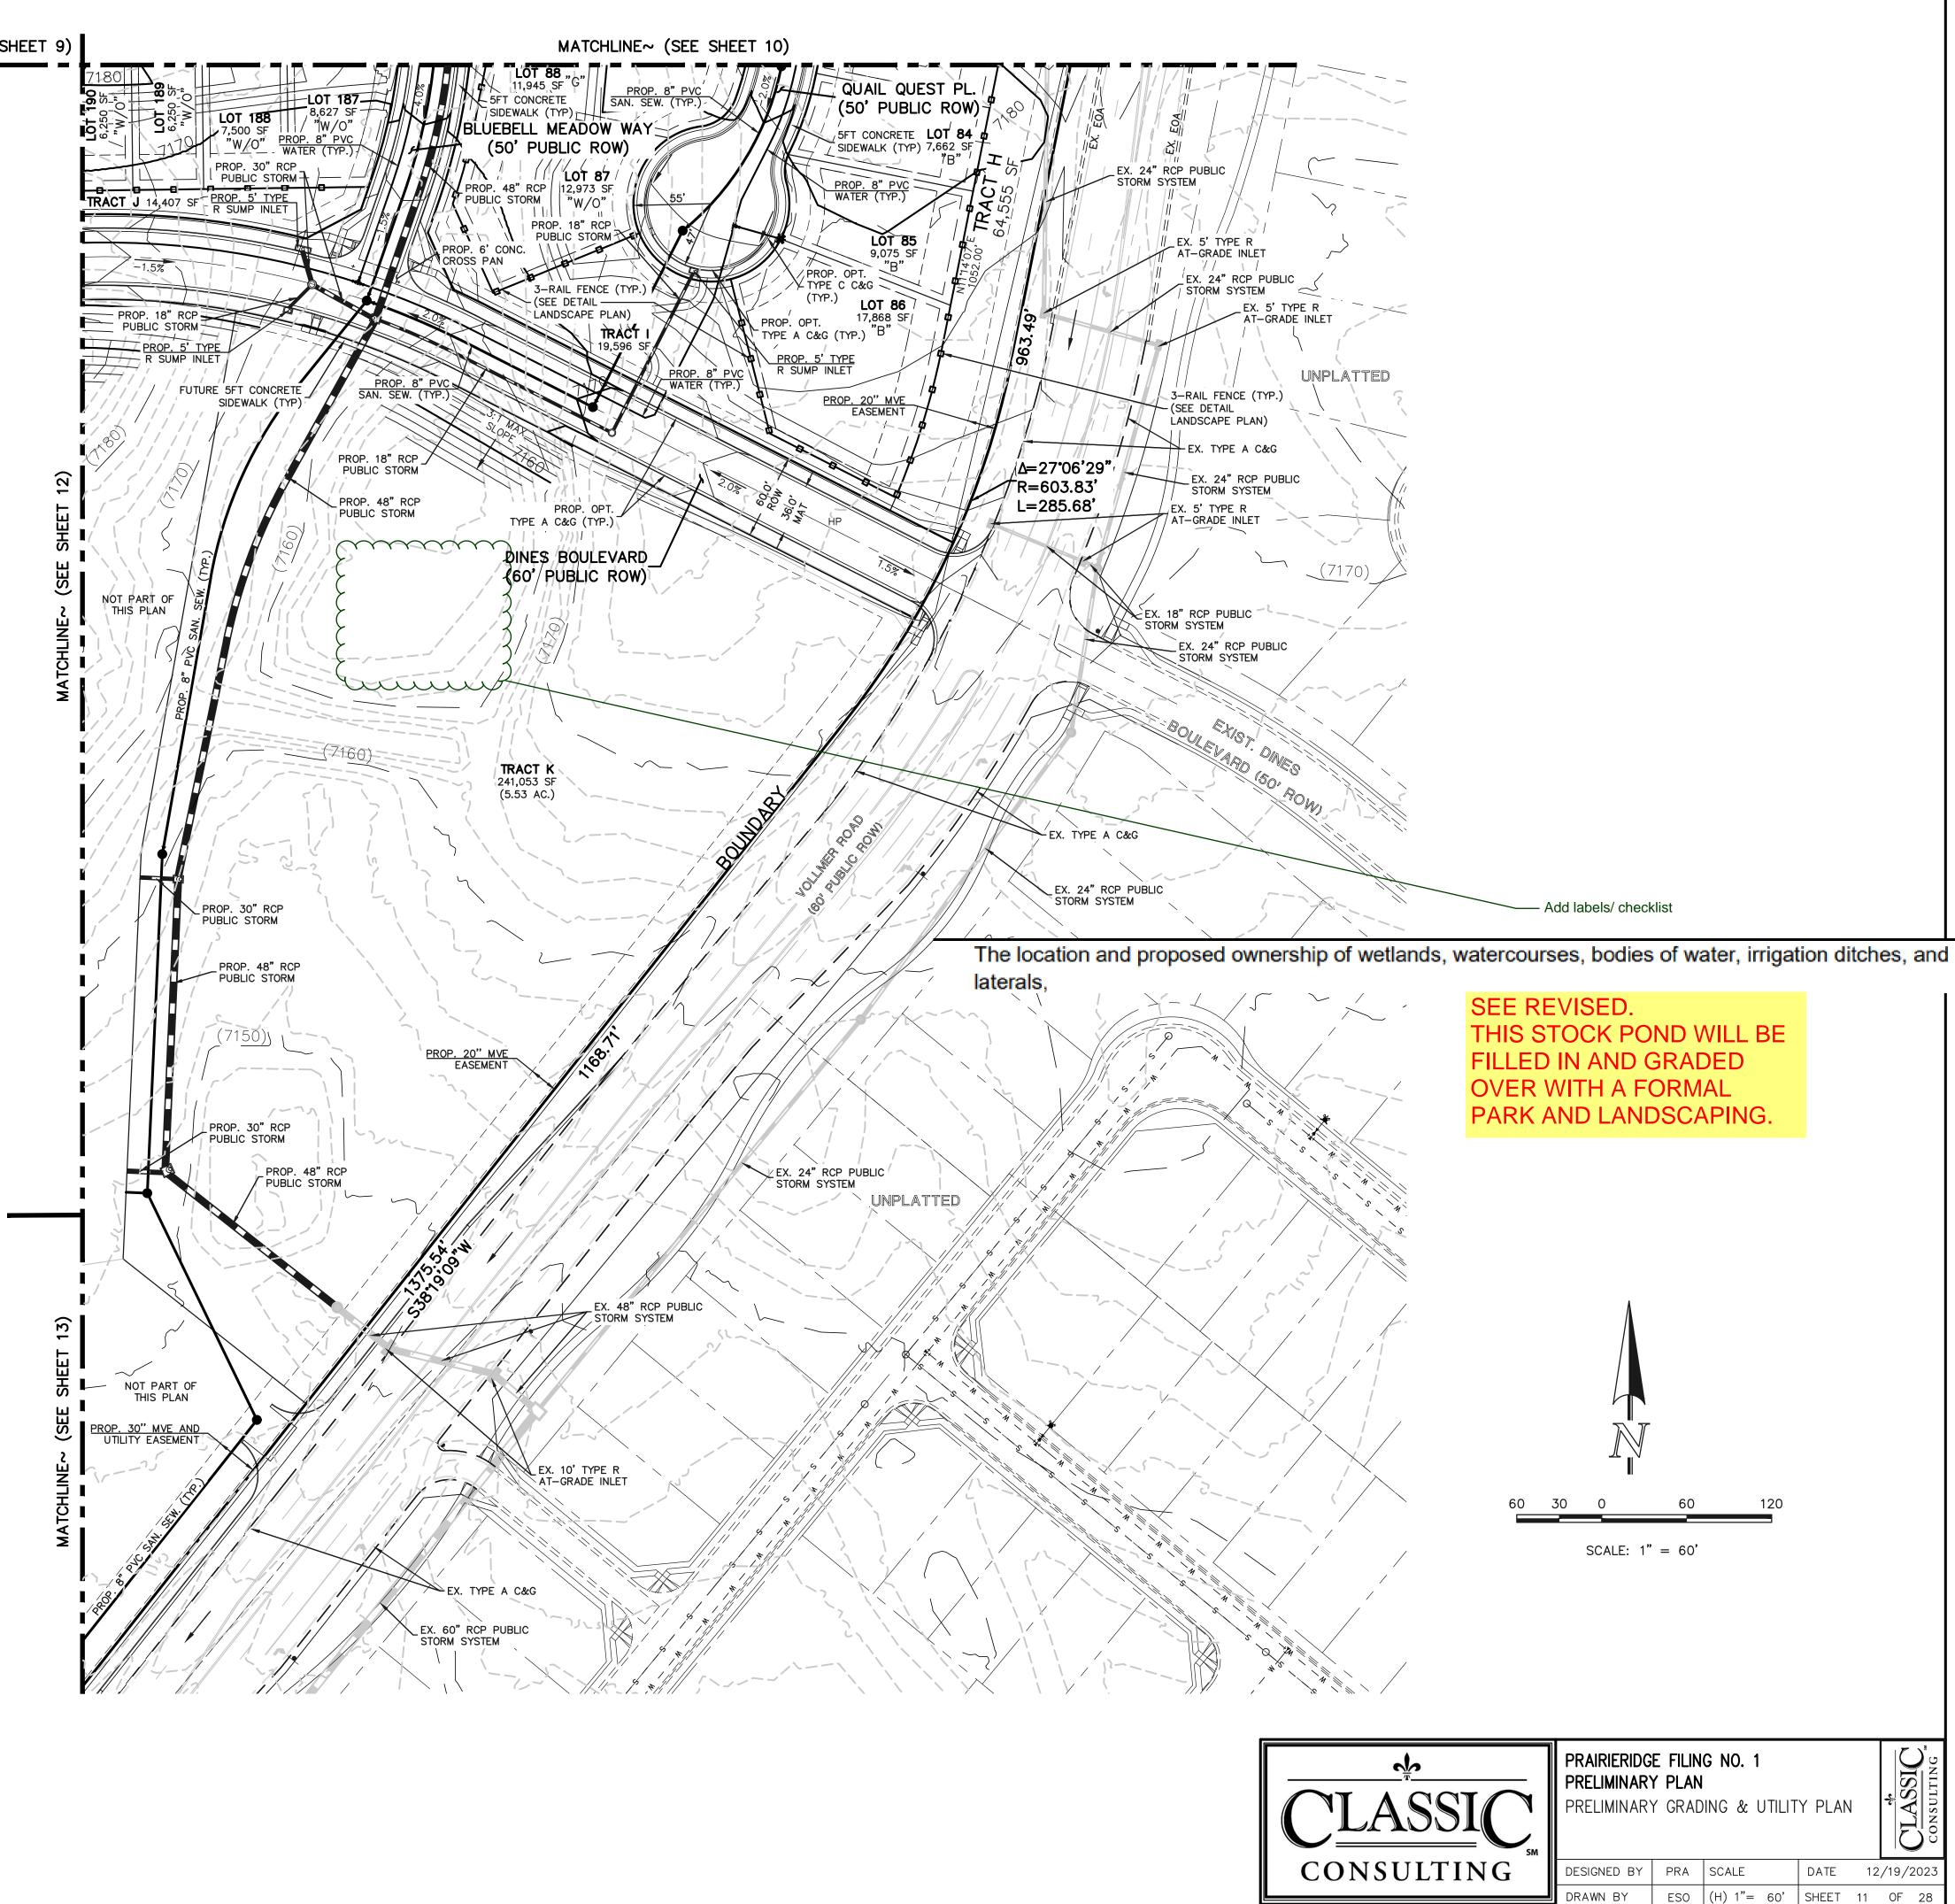

619 N. Cascade Avenue, Suite 200


Colorado Springs, Colorado 80903

(719)785–0790

(719)785-0799(Fax)

CHECKED BY

(V) 1"= N/A JOB NO. 1305.10

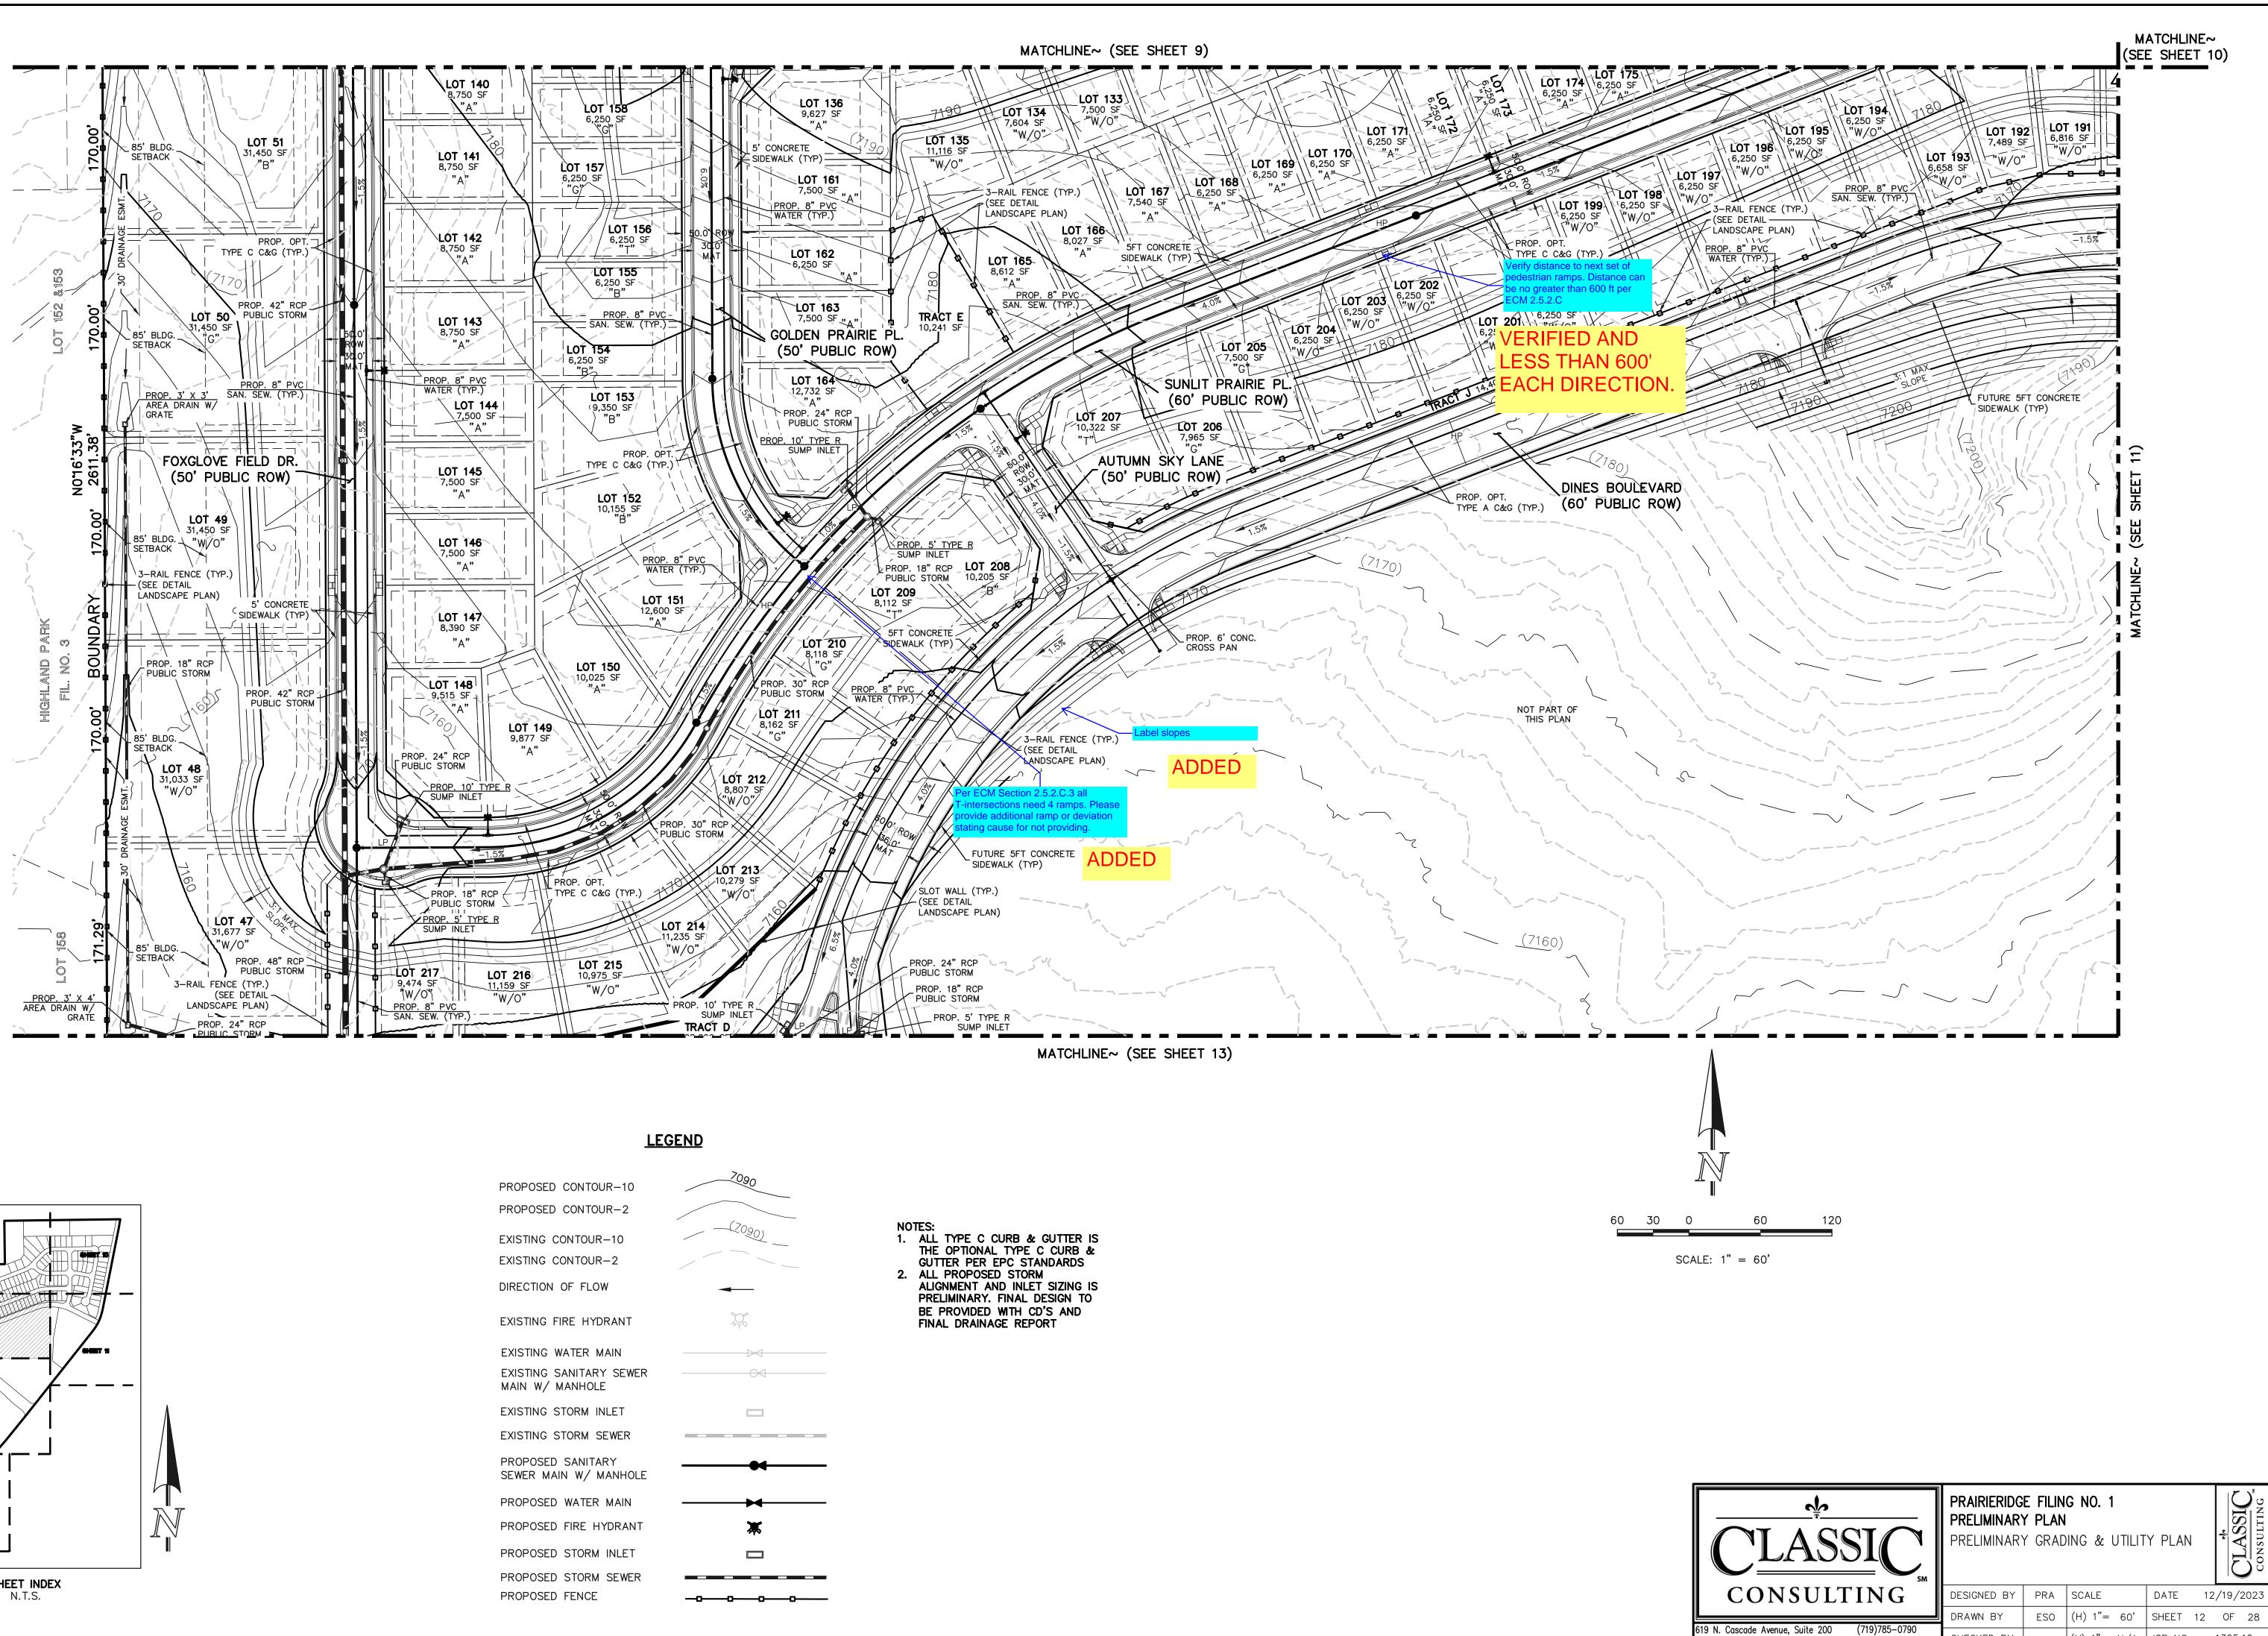



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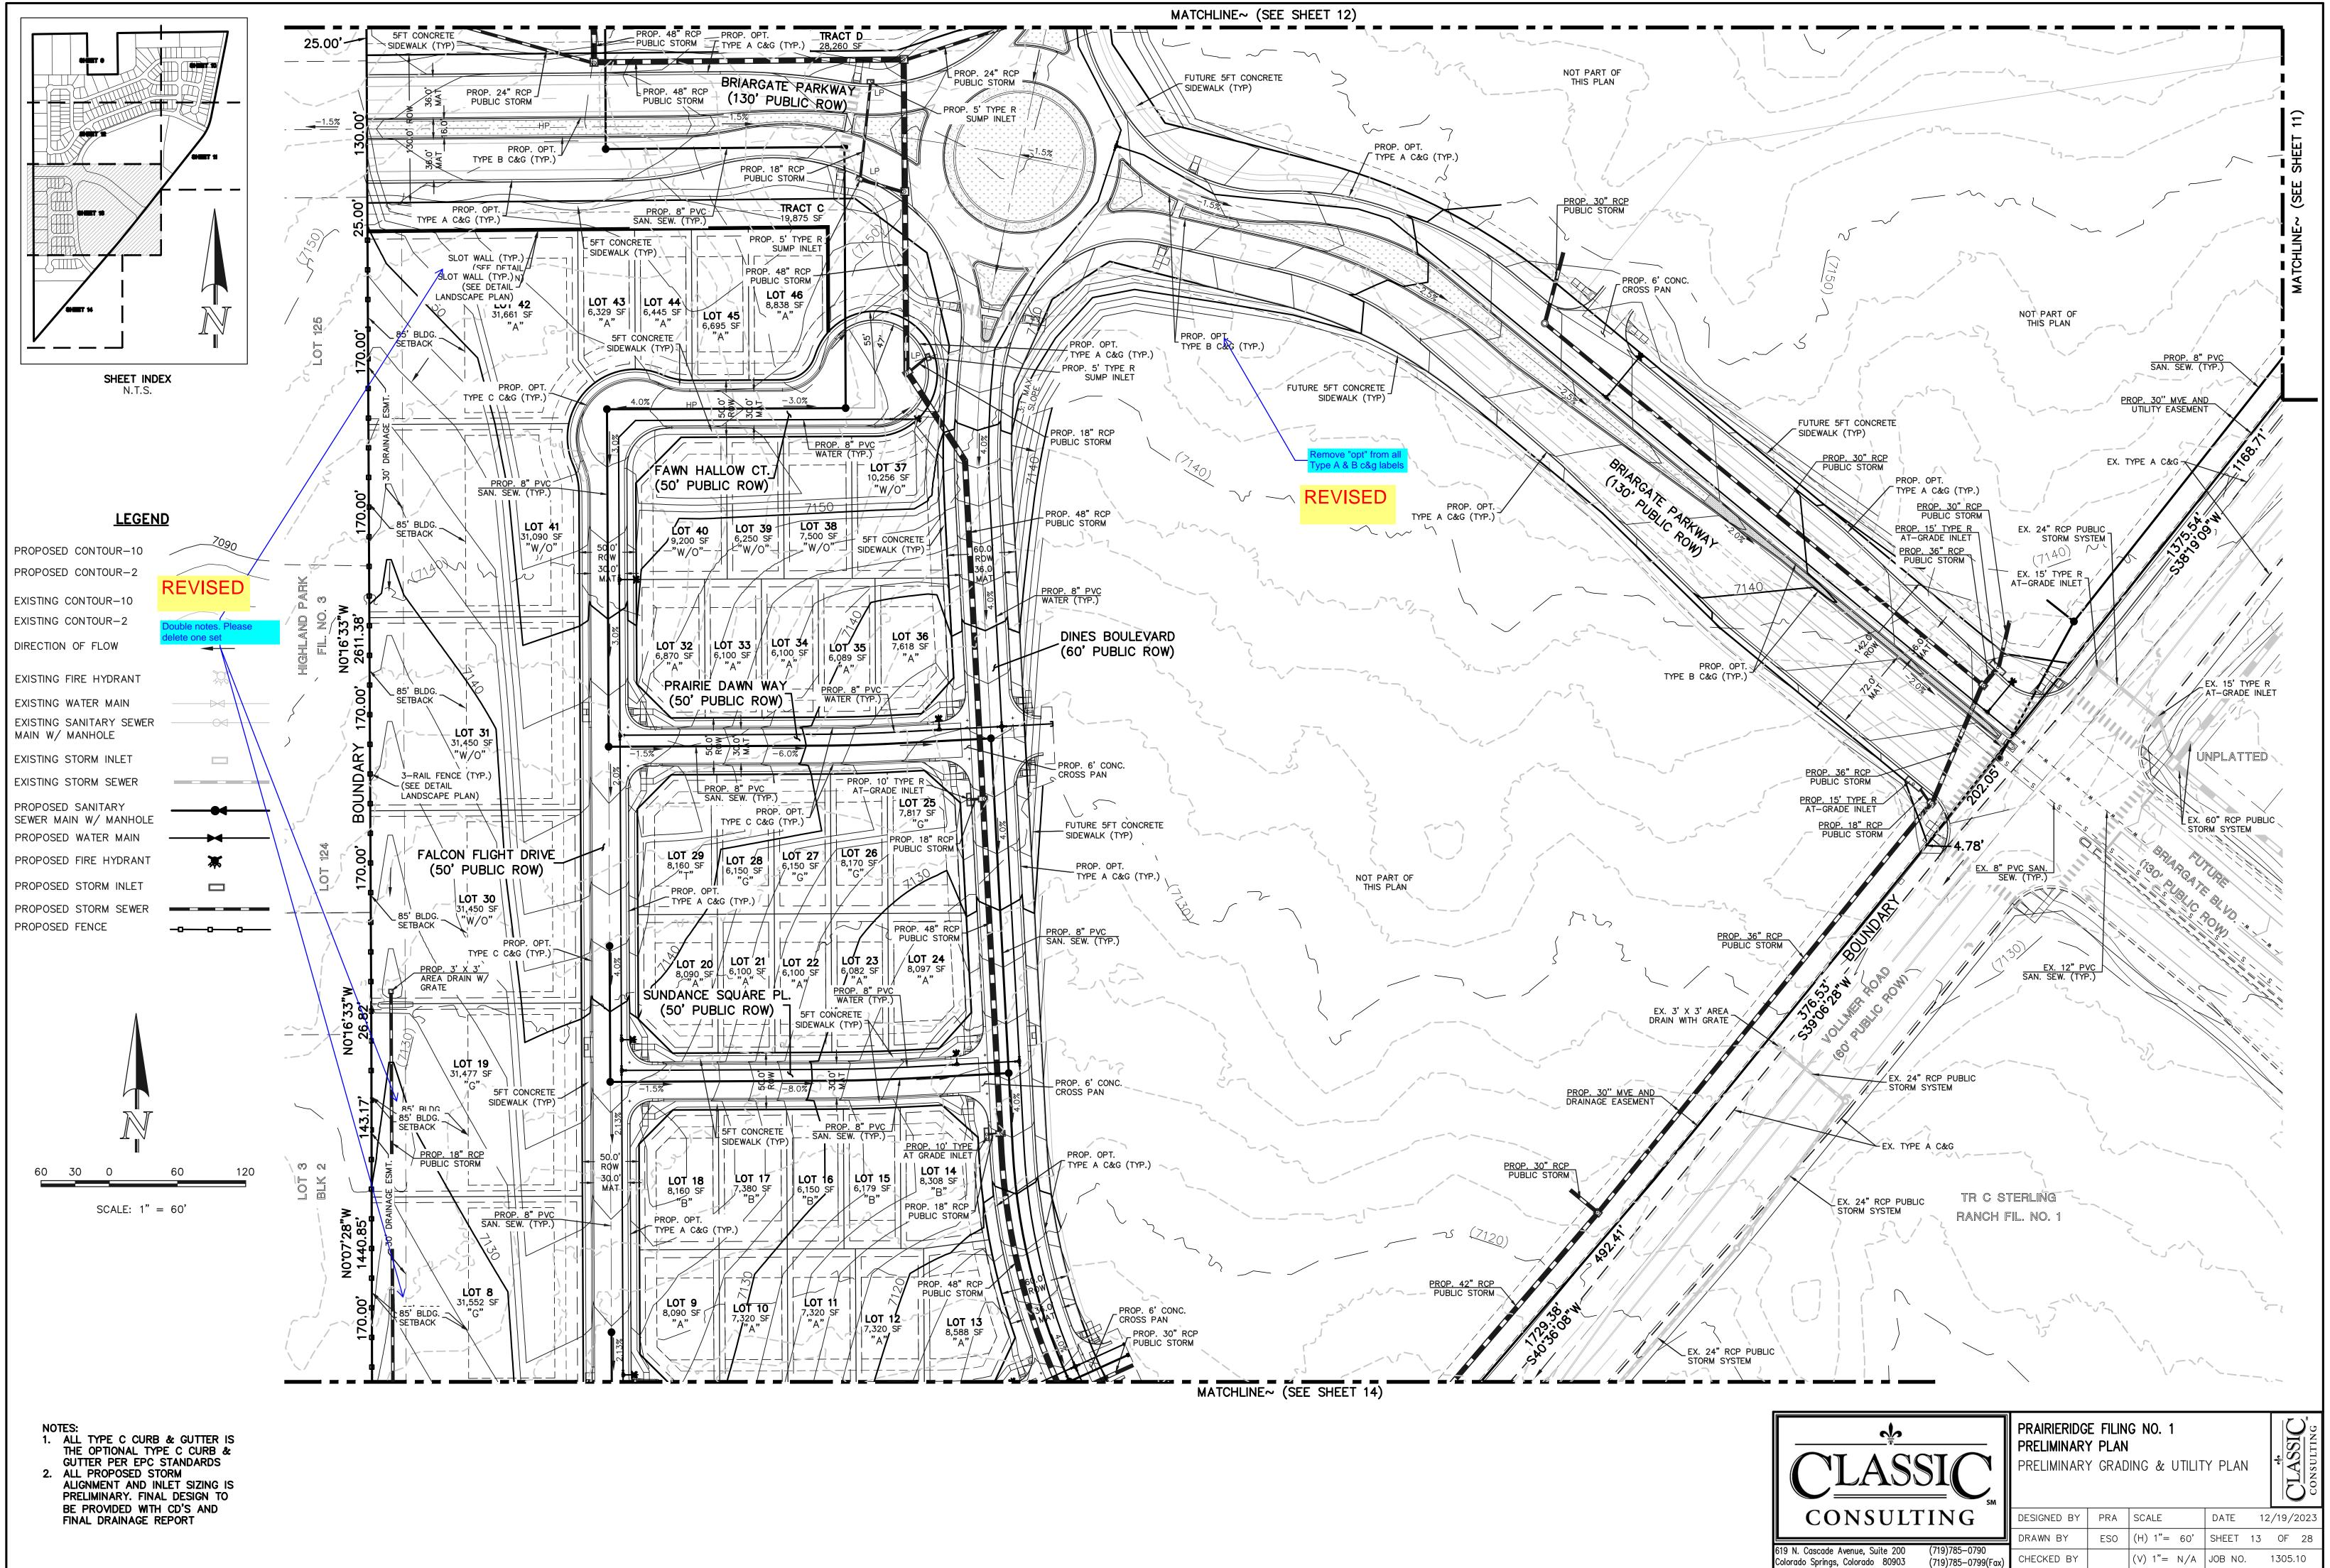
(719)785-0799(Fax)


Colorado Springs, Colorado 80903

(V) 1"= N/A JOB NO. 1305.10



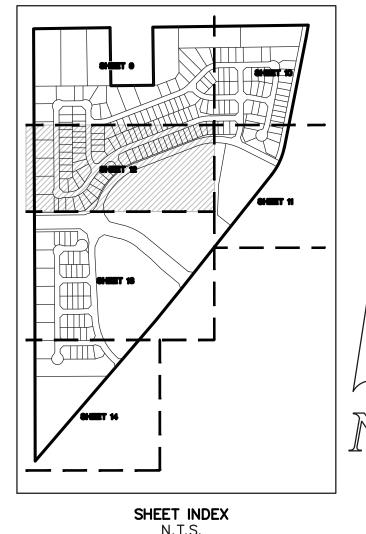

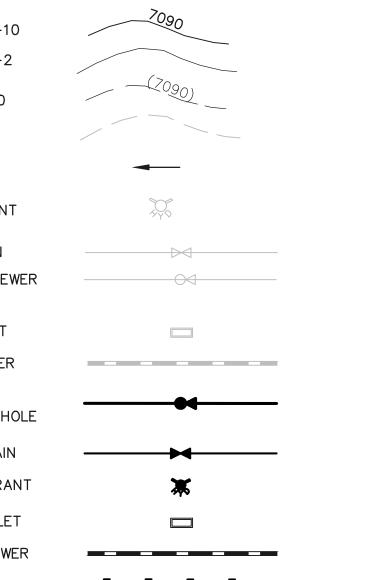

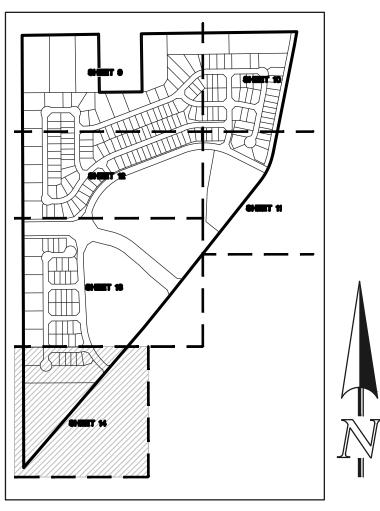

SHEET INDEX N.T.S.

NOTES:

1. ALL TYPE C CURB & GUTTER IS THE OPTIONAL TYPE C CURB & GUTTER PER EPC STANDARDS 2. ALL PROPOSED STORM ALIGNMENT AND INLET SIZING IS

PRELIMINARY. FINAL DESIGN TO BE PROVIDED WITH CD'S AND FINAL DRAINAGE REPORT


<u>LEGEND</u>

PROPOSED CONTOUR-10	7090
PROPOSED CONTOUR-2	
EXISTING CONTOUR-10	(2090)
EXISTING CONTOUR-2	
DIRECTION OF FLOW	-
EXISTING FIRE HYDRANT	
EXISTING WATER MAIN	
EXISTING SANITARY SEWER MAIN W/ MANHOLE	
EXISTING STORM INLET	
EXISTING STORM SEWER	
PROPOSED SANITARY SEWER MAIN W/ MANHOLE	
PROPOSED WATER MAIN	—
PROPOSED FIRE HYDRANT	*
PROPOSED STORM INLET	
PROPOSED STORM SEWER	
PROPOSED FENCE	-000

Show	location	of spillwa
Show	location	of spillwa

1~

ADDED ~

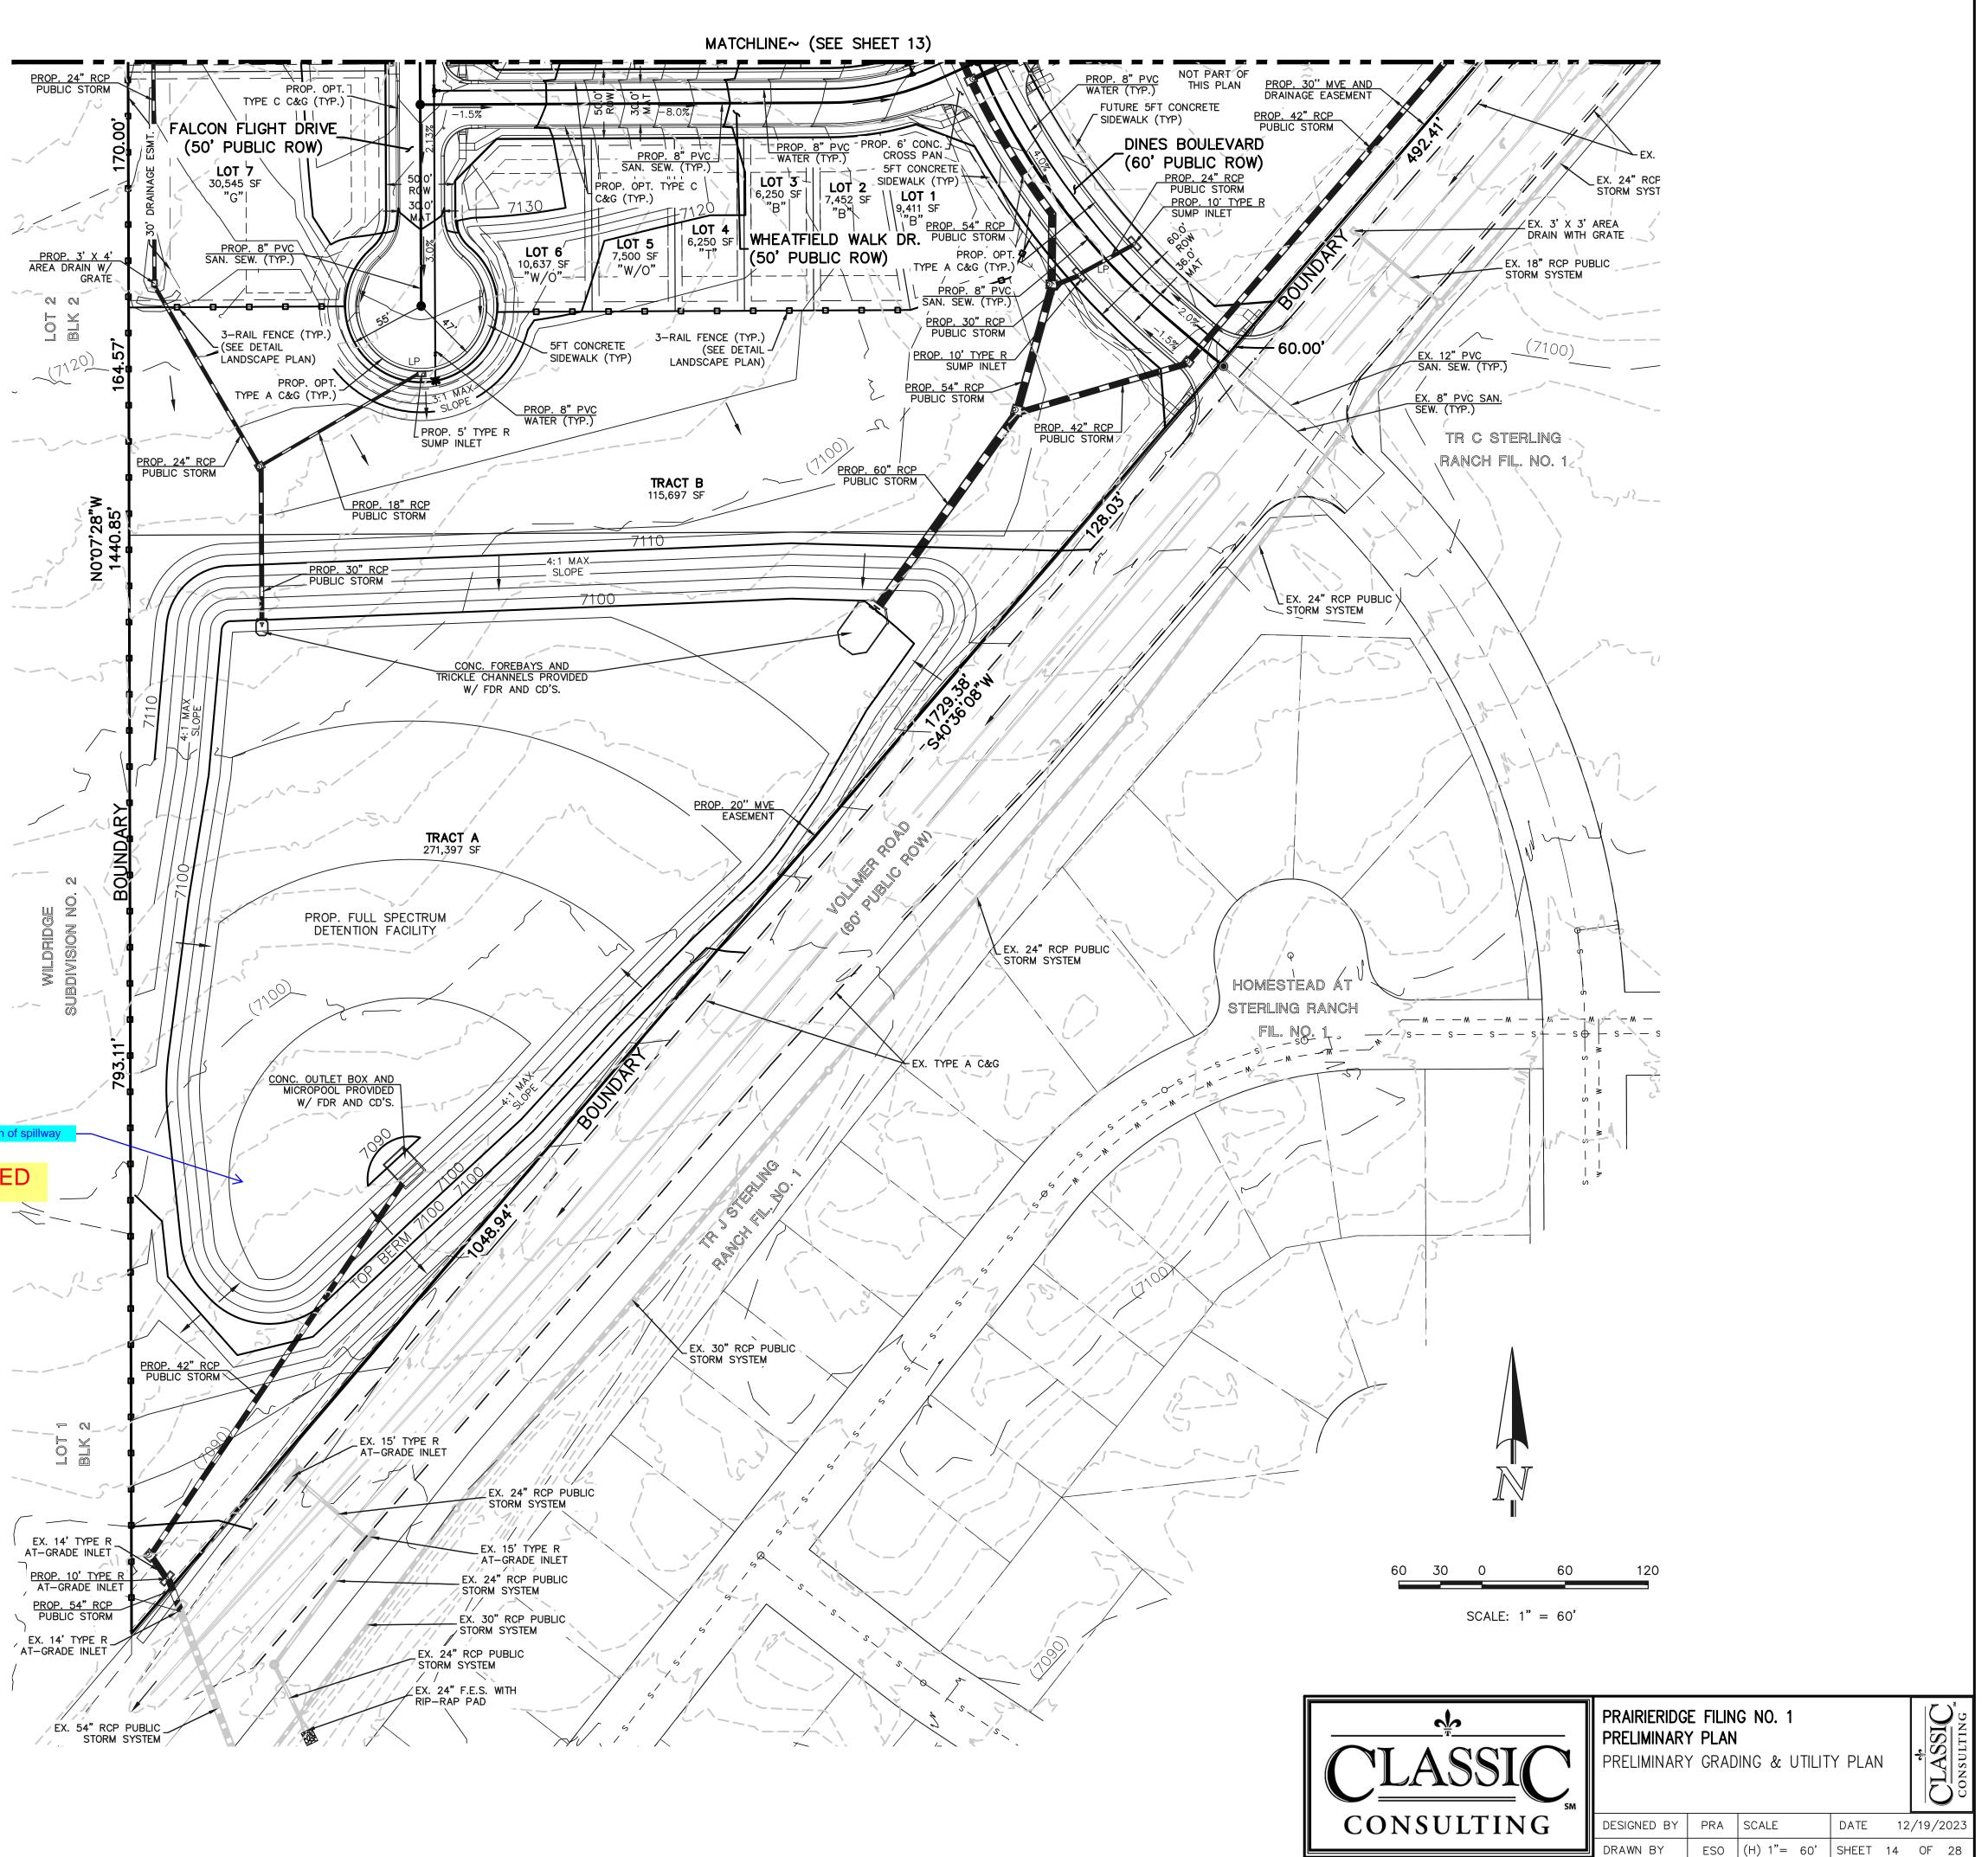

(719)785–0790

(719)785-0799(Fax)

CHECKED BY

(V) 1"= N/A JOB NO. 1305.10

619 N. Cascade Avenue, Suite 200

Colorado Springs, Colorado 80903

	Map Content						
1 Title Block and Reference Information							
	Name of proposed subdivision centered on the top of the plan and a subtitle, in smaller lettering, shall indicate the quarter section(s) the subdivision is located. If the subdivision is a replat of a previou information shall be included in the subtitle. The name of the Coursubtitle. Note the subdivision name shall conform to the naming c						
	The words "PRELIMINARY PLAN" clearly stated,						
Name, address and telephone number of the owner of reco							
	Date of preparation, date of survey (if applicable), north arrow, wr right hand corner of each sheet,						



- PLANT ABBREVIATION - SITE CATEGORY ABBREVIATION - (15-ABMLS) TREE CALLOUT

/- 12-JUAM SHRUB & ORN. GRASS CALLOUT

PLANT QUANTITY

PLANT AND TREE WARRANTY NOTE

ALL STOCK IS WARRANTED TO BE TRUE TO NAME. IF ANY STOCK PROVES TO BE OTHERWISE, SELLER WILL NOT BE LIABLE FOR ANY AMOUNT GREATER THAN ORIGINAL PURCHASE PRICE. THIS WARRANTY IS MADE EXPRESSLY IN LIEU OF ANY AND ALL OTHER WARRANTIES, EXPRESSED OR FIT FOR ANY PARTICULAR PURPOSE EXCEPT EXPRESSLY PROVIDED FOR. LIABILITY OF SELLER IS LIMITED TO REPLACEMENT OF ANY GOODS WHICH DO NOT CONFIRM TO WARRANTIES.

WINTER WATERING IS TO BE DONE AFTER MOISTURE CHECKS HAVE BEEN COMPLETED OF ALL PLANTS AND TREES. WARRANTY DOES NOT COVER PLANTS AND TREES DUE TO LACK OF WATER.

WARRANTY IS GOOD FOR ONE GROWING SEASON (APPROXIMATELY SIX MONTHS). PLANTS PURCHASED AFTER JULY 1ST ARE WARRANTED UNTIL MAY 1ST. PLANTS PURCHASED JANUARY 1ST THROUGH JULY 2ND ARE WARRANTED UNTIL NOVEMBER 30TH. SOME PLANTS CARRY NO WARRANTY, (TURF INCLUDED) SUCH AS ANNUALS, PERENNIALS, ROSES, ARBORVITAE, AND A FEW OTHER VARIETIES. INSTALLATION IS NOT COVERED UNDER WARRANTY.

LANDSCAPE IRRIGATION NOTE

ALL NON-IRRIGATED SEED CARRIES NO WARRANTY.

LANDSCAPE TO BE IRRIGATED WITH A PROGRAMMABLE IRRIGATION CONTROLLER. TREES, SHRUBS, ORNAMENTAL GRASSES, AND PERENNIALS TO BE DRIP IRRIGATED WHEN LOCATED IN ROCK OR WOOD MULCH AREAS. TURF OR IRRIGATED SEED AREAS TO BE SPRAY IRRIGATED WITH POP UP SPRAY OR ROTOR HEADS.

	TITLE BLOCK	
)(1/4), section ously approve unty and the	of each sheet. On each sheet, n, township and range in which ed subdivision, the replat State shall be included in the in Section 7.2.5 of the LDC.	
cated in the lo	ower right hand corner,	
ritten and gra	aphic scale located in the lower	

PLANT SYMBOL KEY

- DECIDUOUS TREE • - ORNAMENTAL TREE • - EVERGREEN TREE Mun – DECIDUOUS SHRUBS - EVERGREEN SHRUBS - ORNAMENTAL GRASSES 00 - PERENNIALS 2000

UTILITY NOTE

CALL 1-800-922-1987 FOR UTILITY LOCATIONS TO VERIFY LOCATION AND DEPTH OF ALL UNDERGROUND UTILITIES PRIOR TO START OF WORK. KEEP TREES 10' FROM GAS MAINS & 15' FROM SEWER AND WATER MAIN LINES. KEEP TREES 6' MINIMUM DISTANCE FROM ANY OTHER UTILITIES. RESOLVE ANY TREE / UTILITY CONFLICTS SHOWN ON PLANS IN THE FIELD. CONTACT LANDSCAPE ARCHITECT FOR RECOMMENDATIONS IF NEEDED. PROVIDE CLEARANCE OF ALL PLANT MATERIALS AT ELECTRIC VAULTS AND TRANSFORMERS (REFER TO COLORADO SPRINGS UTILITIES

CONSTRUCTION STANDARD DRAWING 18-302 FOR SPECIFIC CLEARANCE REQUIREMENTS). KEEP ALL SHRUBS 3' CLEAR OF ALL FIRE HYDRANTS AT MATURE SIZE.

SITE CONDITIONS NOTE


THE LANDSCAPE IS SUBJECT TO CHANGE BASED ON SITE GRADING, DRAINAGE, CONFIGURATION, AND SIZE. ANY ADJUSTMENTS WILL BE MADE DURING LANDSCAPE CONSTRUCTION. PLANT MATERIAL SYMBOLS ARE SHOWN AT MATURE WIDTH.

LANDSCAPE REQUIREMENTS								
LANDSCAPE SE	LANDSCAPE SETBACKS (LS)							
Street Name / Boundary	Street Classification	Width (ft.) Req. / Prov	Linear . Footage	Tree Req. / Ft.	Tree Req. /Prov.			
	Minor Arterial (North side) Major Arterial (South side) Major Arteria		1,304' 429' 466'	1/25 1/20 1/20	52.2 / 52 21.5 / 22 23.3 / 23			
Shrub Substitutions	Ornamental grass	Setback	Perc	ent Ground				
Req. / Prov.	Req. / Prov.	Abbr.	Plan	e Cov. Req./Pro				
0/0	0/0 LS	6	75% / 75%	6				
0/0	0/0 LS	5	75% / 75%	6				
0 / 0	0/0 LS	6	75% / 75%	6				

IRRIGATION SYSTEM DESCRIPTION

The irrigation system to be an underground system with a spray or rotor system for turf or seeded areas. Shrub areas to be surface drip irrigated to irrigate all plant material. Irrigation system to be drainable for winter freeze protection. Irrigation to run off of a programmable irrigation controller.


L A N D S C A P E S LANDSCAPE ARCHITECTURE & IRRIGATION DESIGN RESIDENTIAL & COMMERCIAL LANDSCAPE INSTALLATION 1925 AEROPLAZA DRIVE COLORADO SPRINGS CO 80916
CRIPTION
SIC.

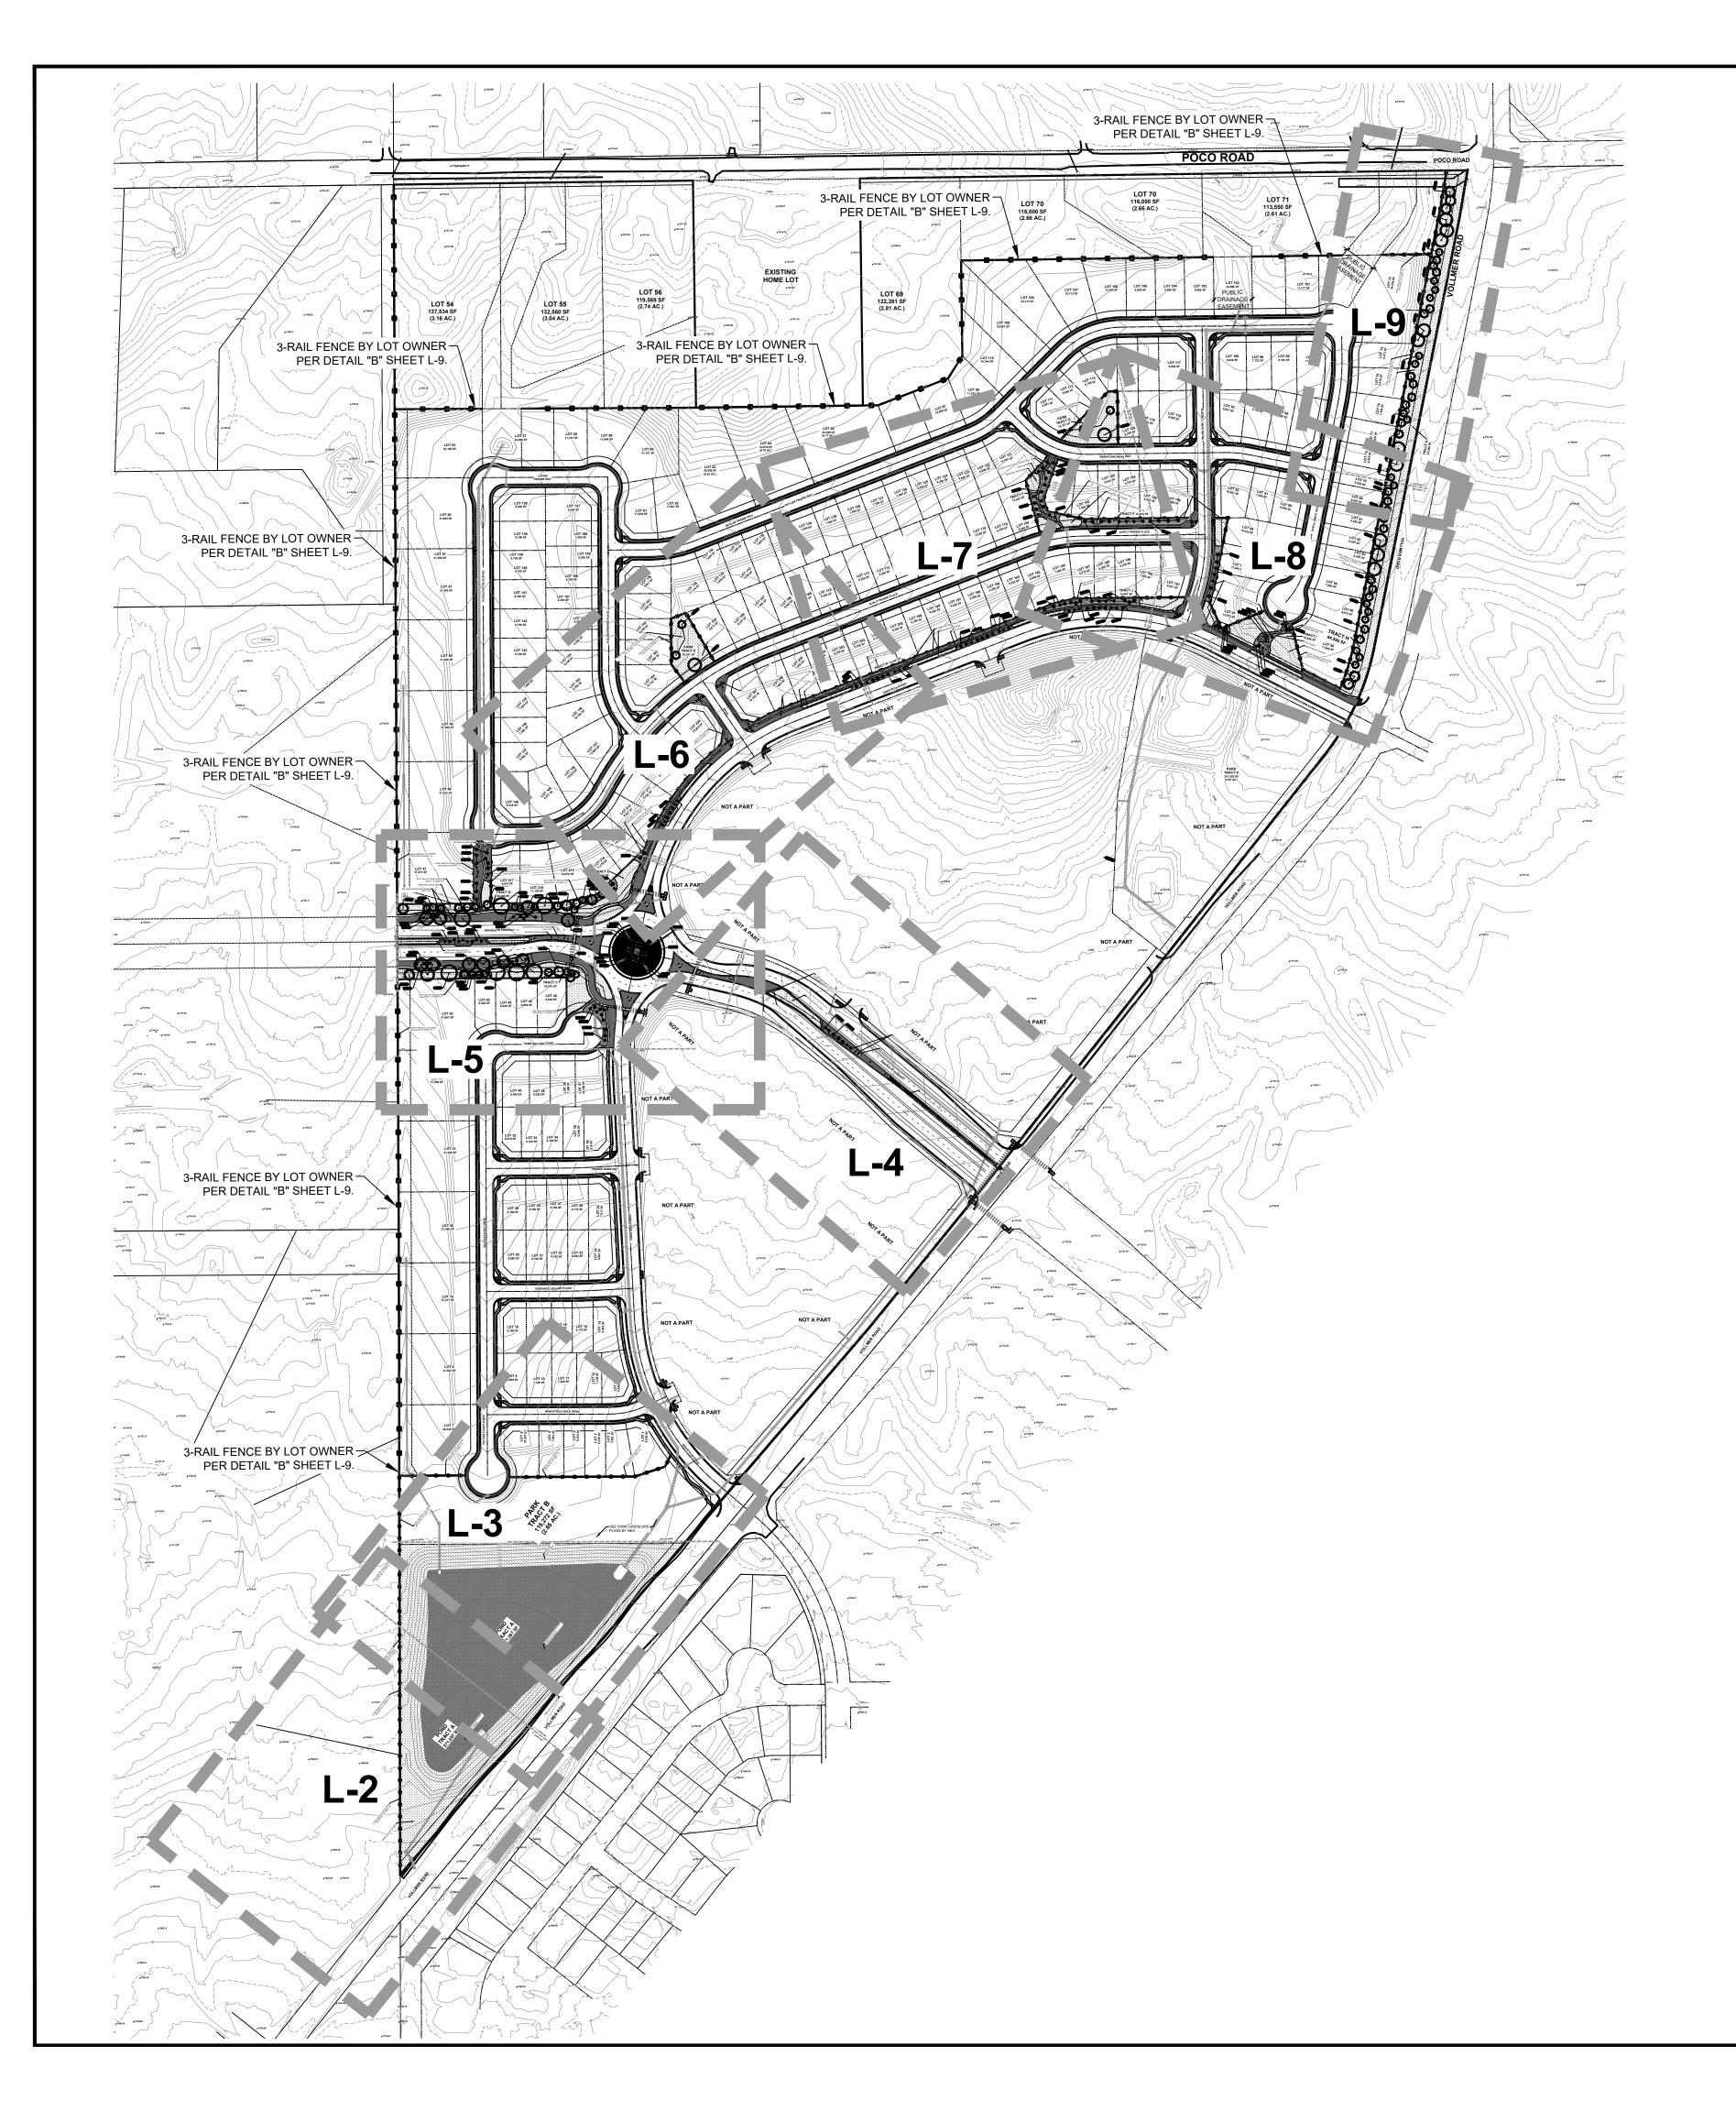

PLANTING LEGEND

ABBR.	QTY.	BOTANICAL NAME
DECID	UOUS	TREES
ABM	23	Acer x freemanii 'Autumn Blaze'
MSS	32	Malus 'Spring Snow'
TAL	7	Tilla americana
EVERG	REEN	TREES
PIP	11	Picea pungens
PON	33	Pinus ponderosa
DECID	uous	SHRUBS
ARB	27	Aronia melancarpa
BRG	23	Berberis thunbergii 'Rose Glow'
PBS	6	Prunus Besseyi 'Pawnee Buttes'
POG	42	Potentilla fruticosa 'Gold finger'
SPG	15	Spiraea x bumalda 'Goldmound'
EVERG	REEN	SHRUBS
JBJ	64	Juniperus Sabina
JCS	15	Juniperous chinensis 'Spartan'
PGS	7	Picea pungens 'Glauca Globosa'
ORNAN	MENTA	L GRASSES
PSR	14	Panicum virgatum 'Rebraun'

GROUNDCOVER LEGI DESCRIPTION SYMBOL STEEL EDGING

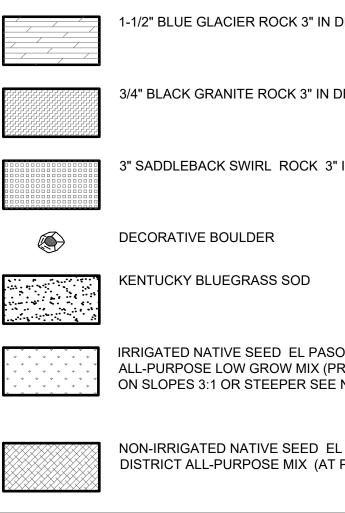

NOT TO SCALE

North


SHEET # L-1 © 2023 BY SUNFLOWER LANDSCAPES•ALL RIGHTS RESERVED


GEND	
	QUANTITY
	TBD LF
I DEPTH WITH WEED FABRIC	41,148 SF
DEPTH WITH WEED FABRIC	10,286 SF
3" IN DEPTH WITH WEED FABRIC	32,729 SF
	43 TOTAL
	6,790 SF
SO COUNTY CONVERSATION DISTRICT PROVIDE EROSION CONTROL BLANKETS E NOTES).	269,620 SF
EL PASO COUNTY CONVERSATION T POND BOTTOM).	145,550 SF


X=Xeric plant, R=Rabbit Resistant, DE=Deer Resistant, F=Firewise plant Z=Zone, K=Altitude, Water Use inch / year. D=Dry (13-20"), A=Adaptable (18-28") S=Steady (23-38"), W=Wet (36"+) SIG=Signature plant (City of Colorado Springs)									
COMMON NAME	SIZE	NOTES							
Maple, Autumn Blaze Crabapple,Spring Snow Linden, American	1-1/2" 1-1/2" 1-1/2"	F,Z=4, 8.5K,S,SIG							
Spruce, Colorado Blue Pine, Ponderosa	6' 6'	R,DE,Z=3, 10K,S,SIG R,DE,Z=3, 9.5K,D,SIG							
Chokeberrry, Black Barberry, Rosy Glow Western Sandcherry 'Pawnee Buttes' Potentilla, Gold finger Spirea, Goldmound	5 Gal 5 Gal 5 Gal 5 Gal 5 Gal	R,DE,Z=4, 7K,A,SIG F,Z=3, 9.5K,A,SIG R,DE,F,Z=2, 10K,S,SIG							
Juniper, Buffalo Juniper, Spartan Spruce, Globe Blue	5 Gal 5 Gal 5 Gal								
Switch grass 'Rebraun'	1 Gal	R,DE,Z=5, 7K,D,SIG							


Notes Key:


SUNFLOWER	LANDSCAPES LANDSCAPE ARCHITECTURE & IRRIGATION DESIGN RESIDENTIAL & COMMERCIAL LANDSCAPE INSTALLATION 1925 AEROPLAZA DRIVE COLORADO SPRINGS CO 80916
	UCTION
CLAS COMMUN	SIC ITIES
PRAIRIE RIDGE FILING 1 VOLLMER ROAD AND BRIARGATE PARKWAY COLORADO SPRINGS, CO	
SHEET 16 C JOB NUMBER 2720-11 DATE 12/7/2023 DRAWN BY MB	

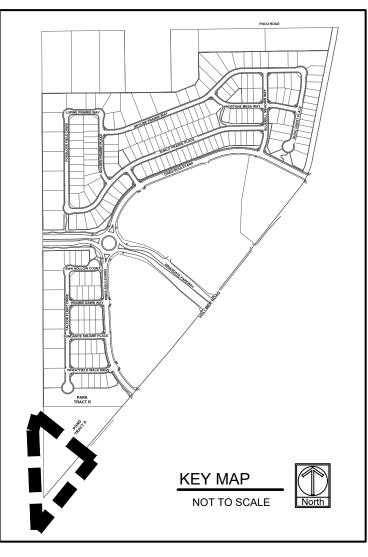


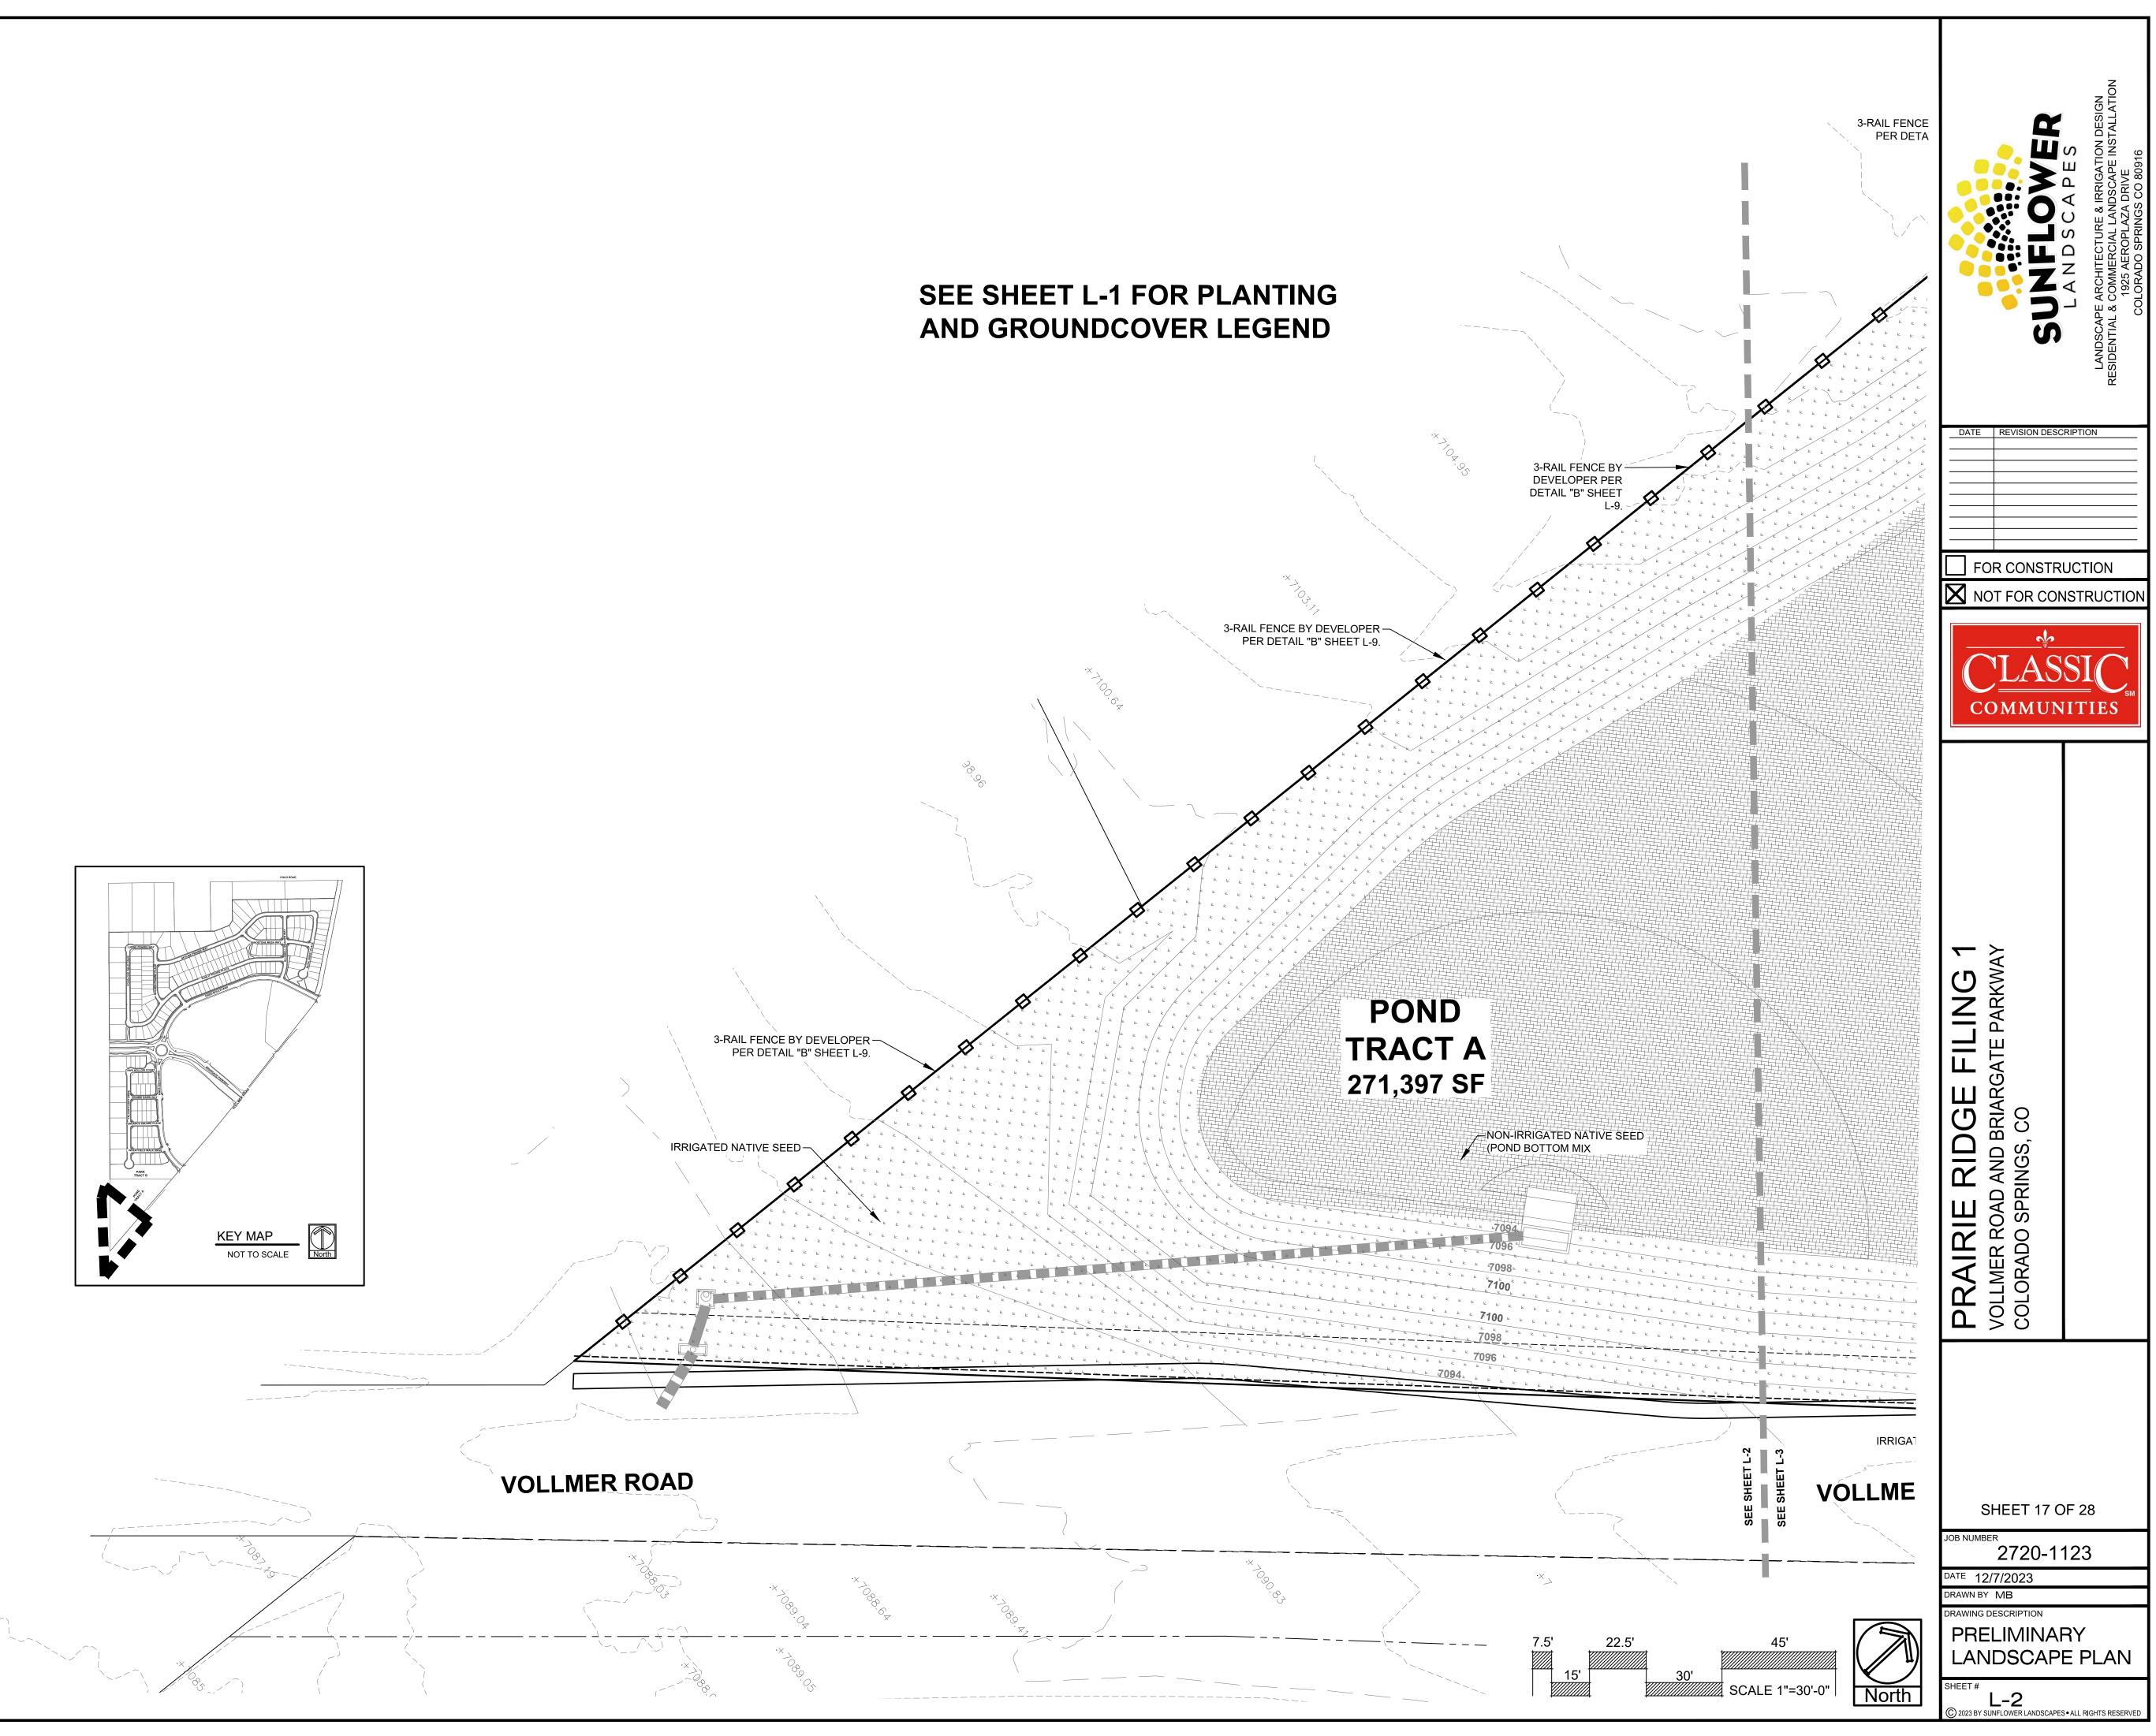


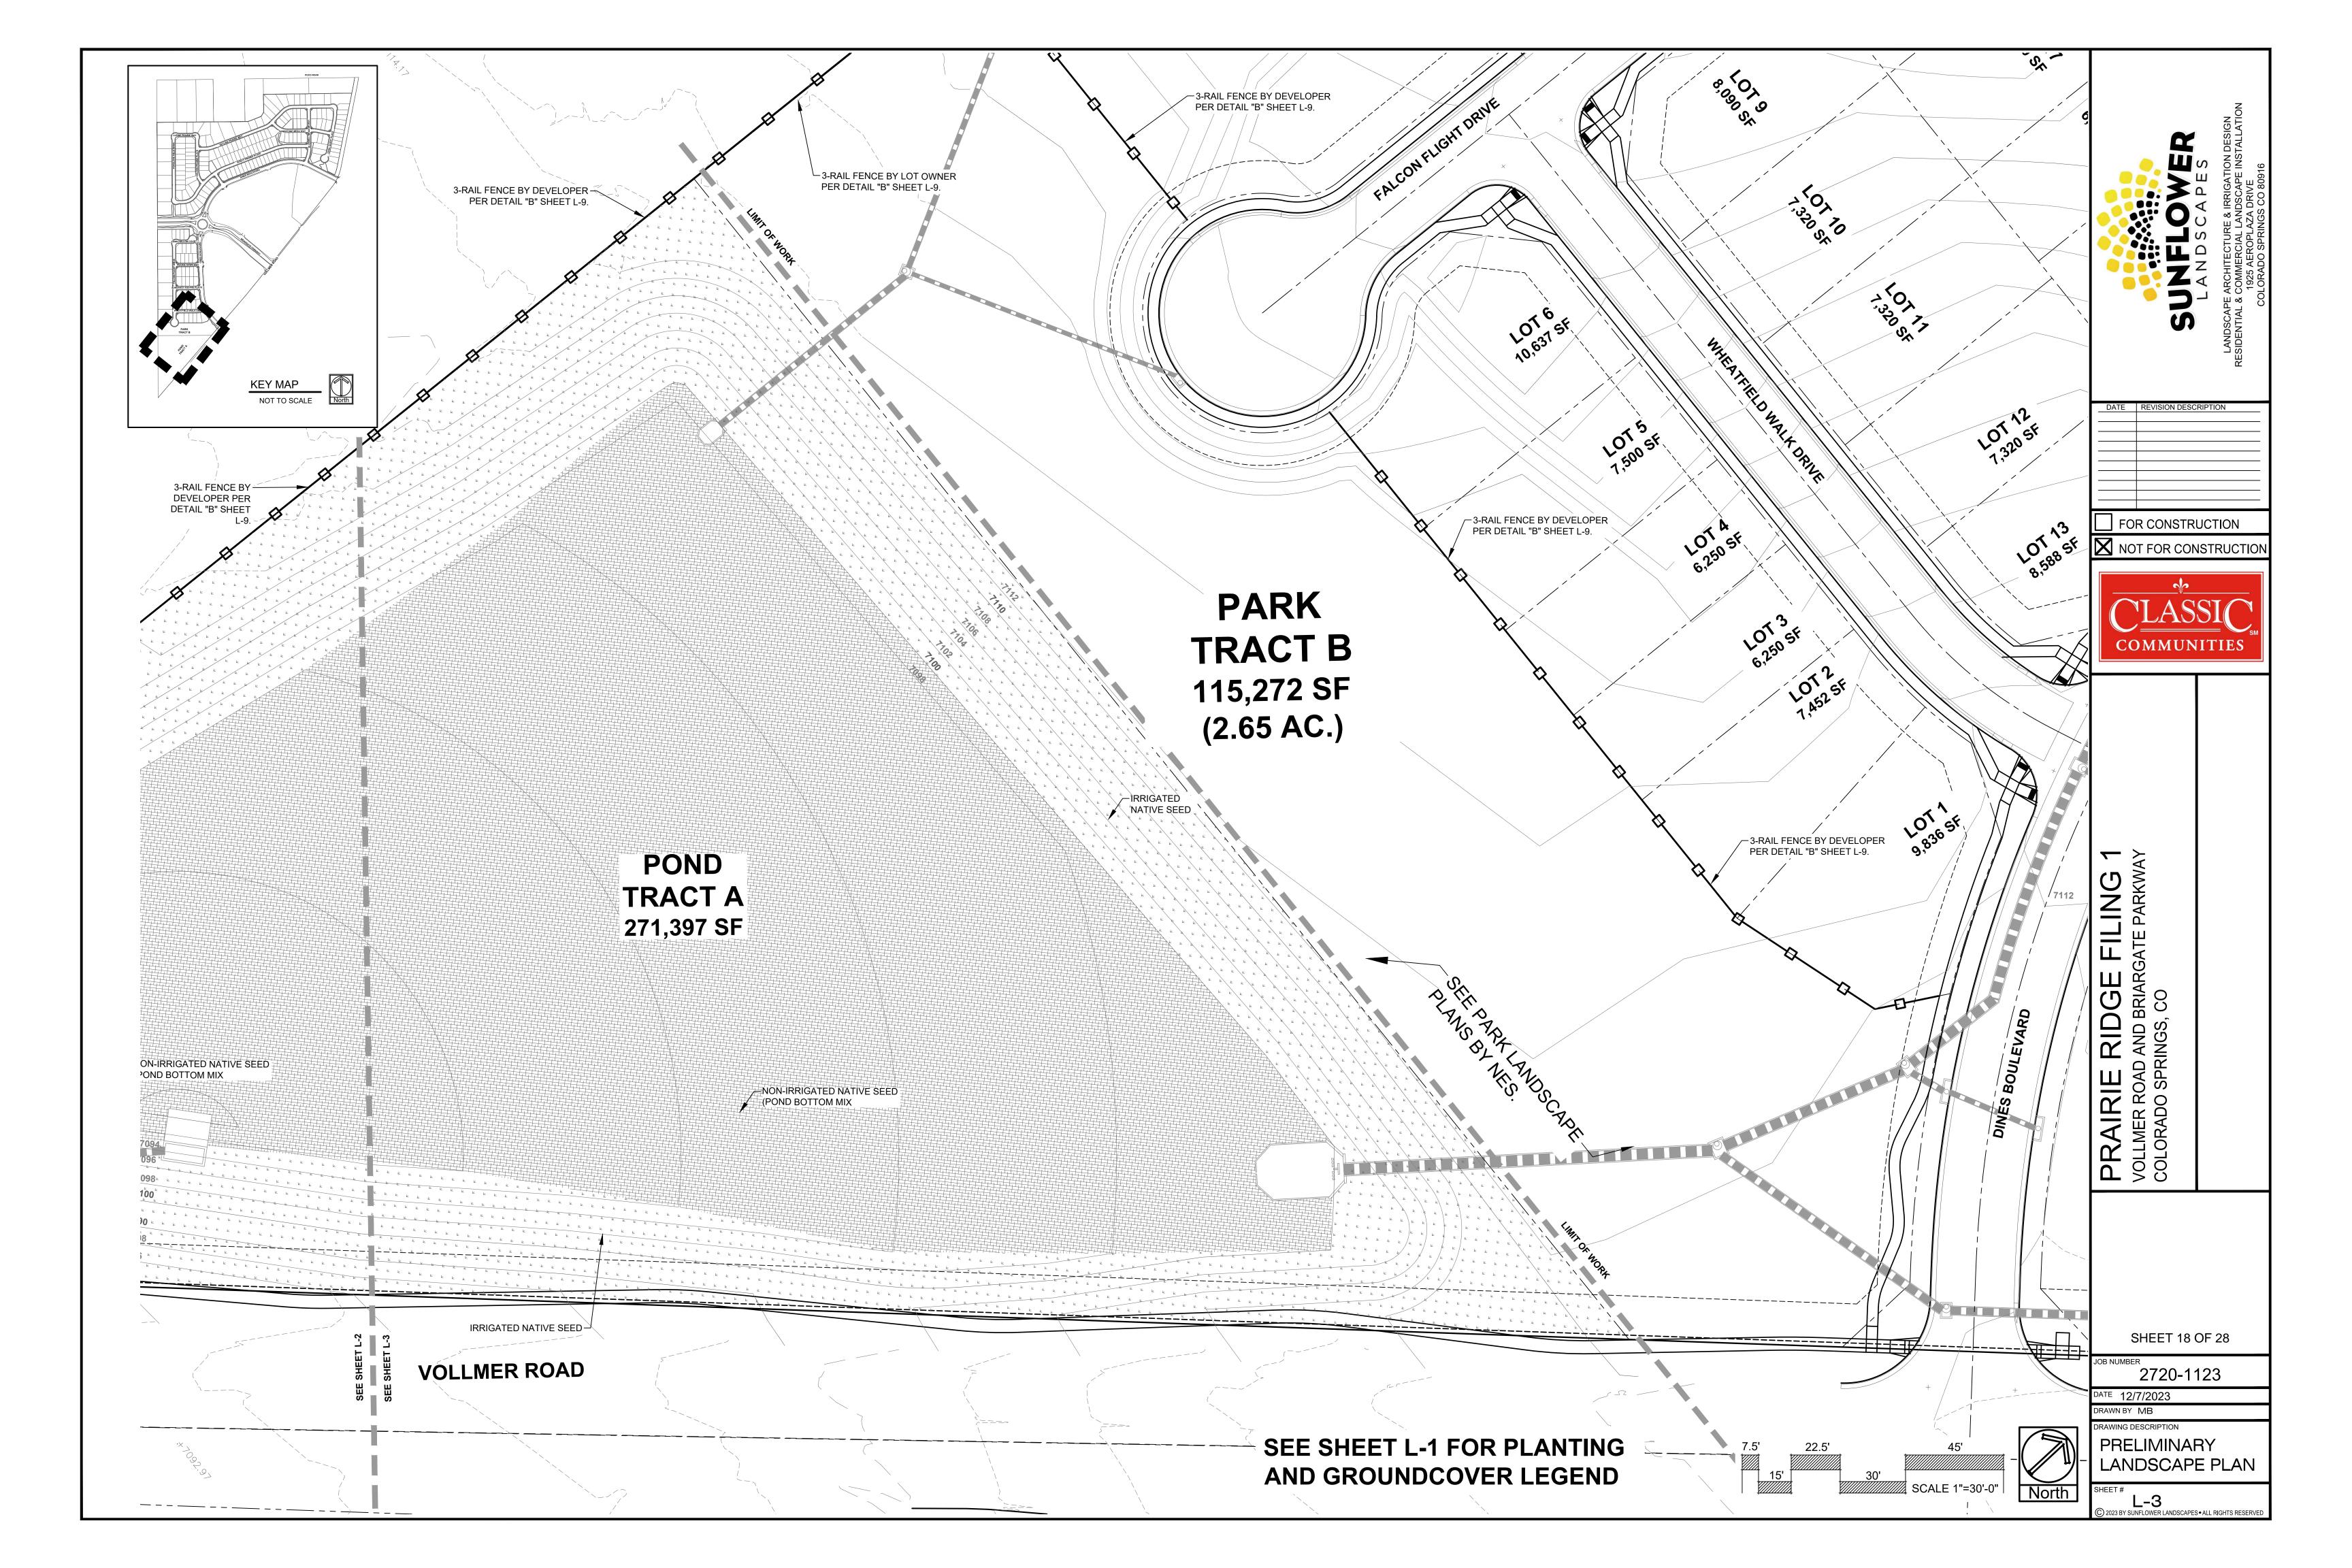


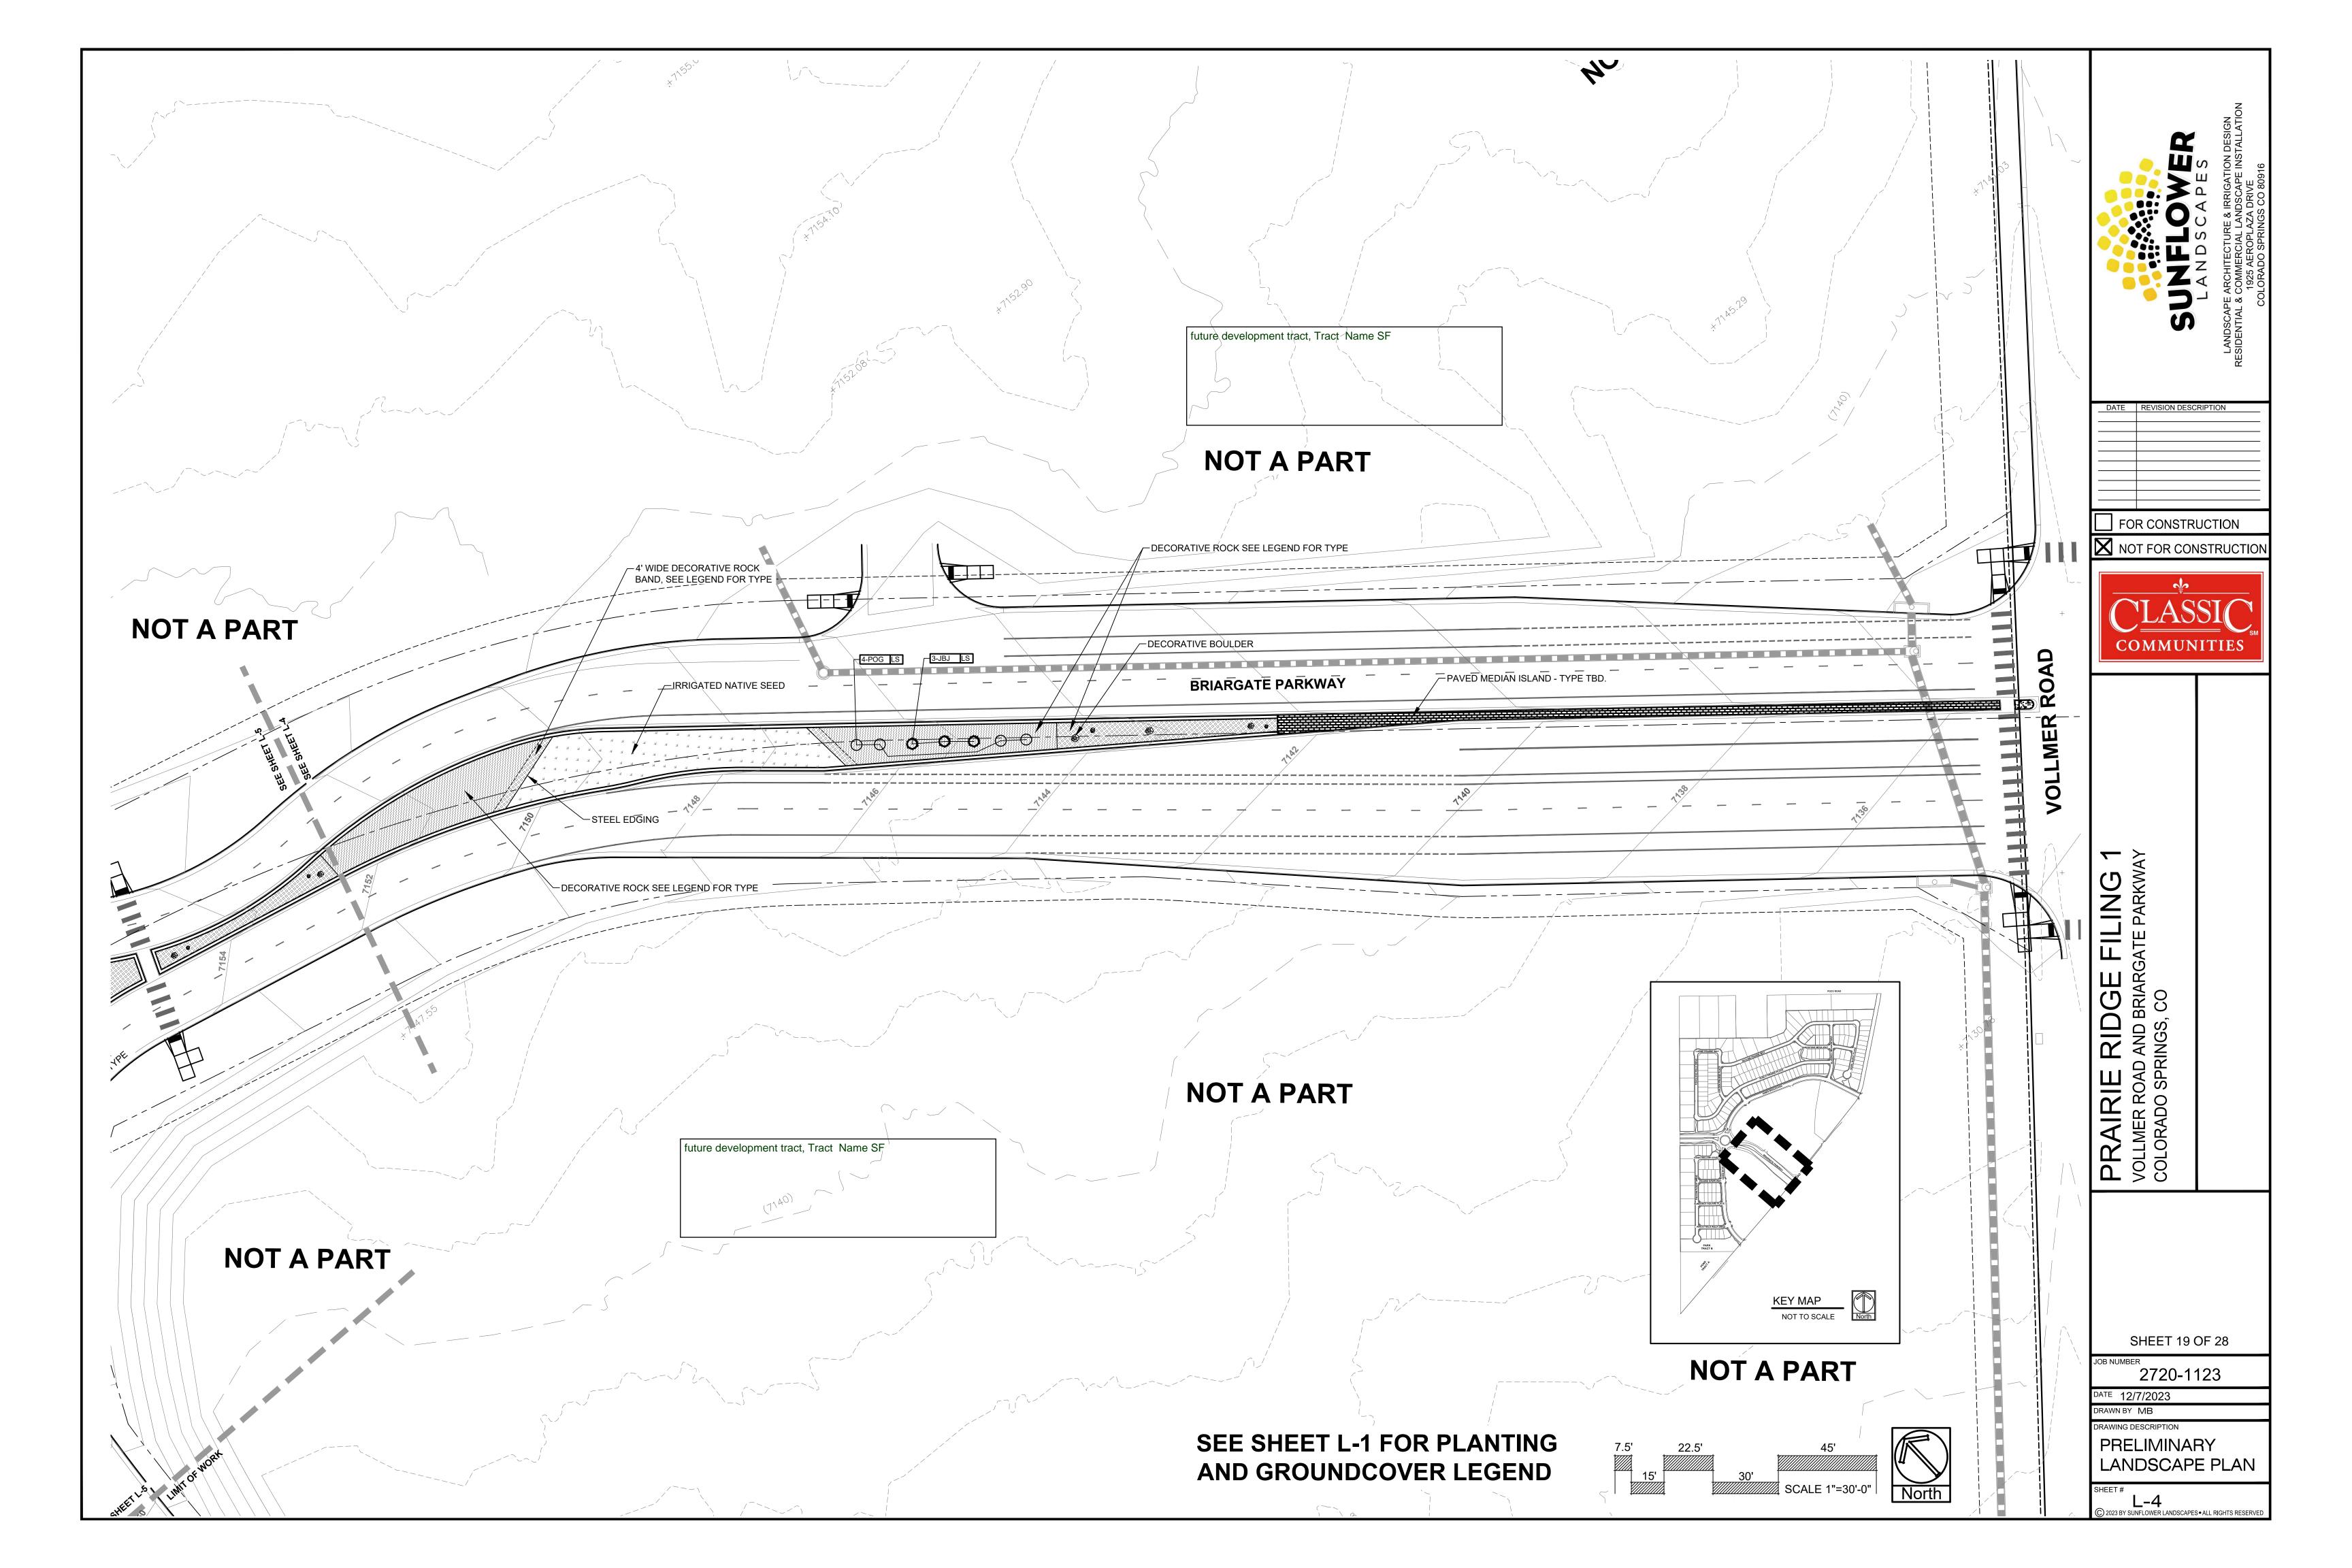


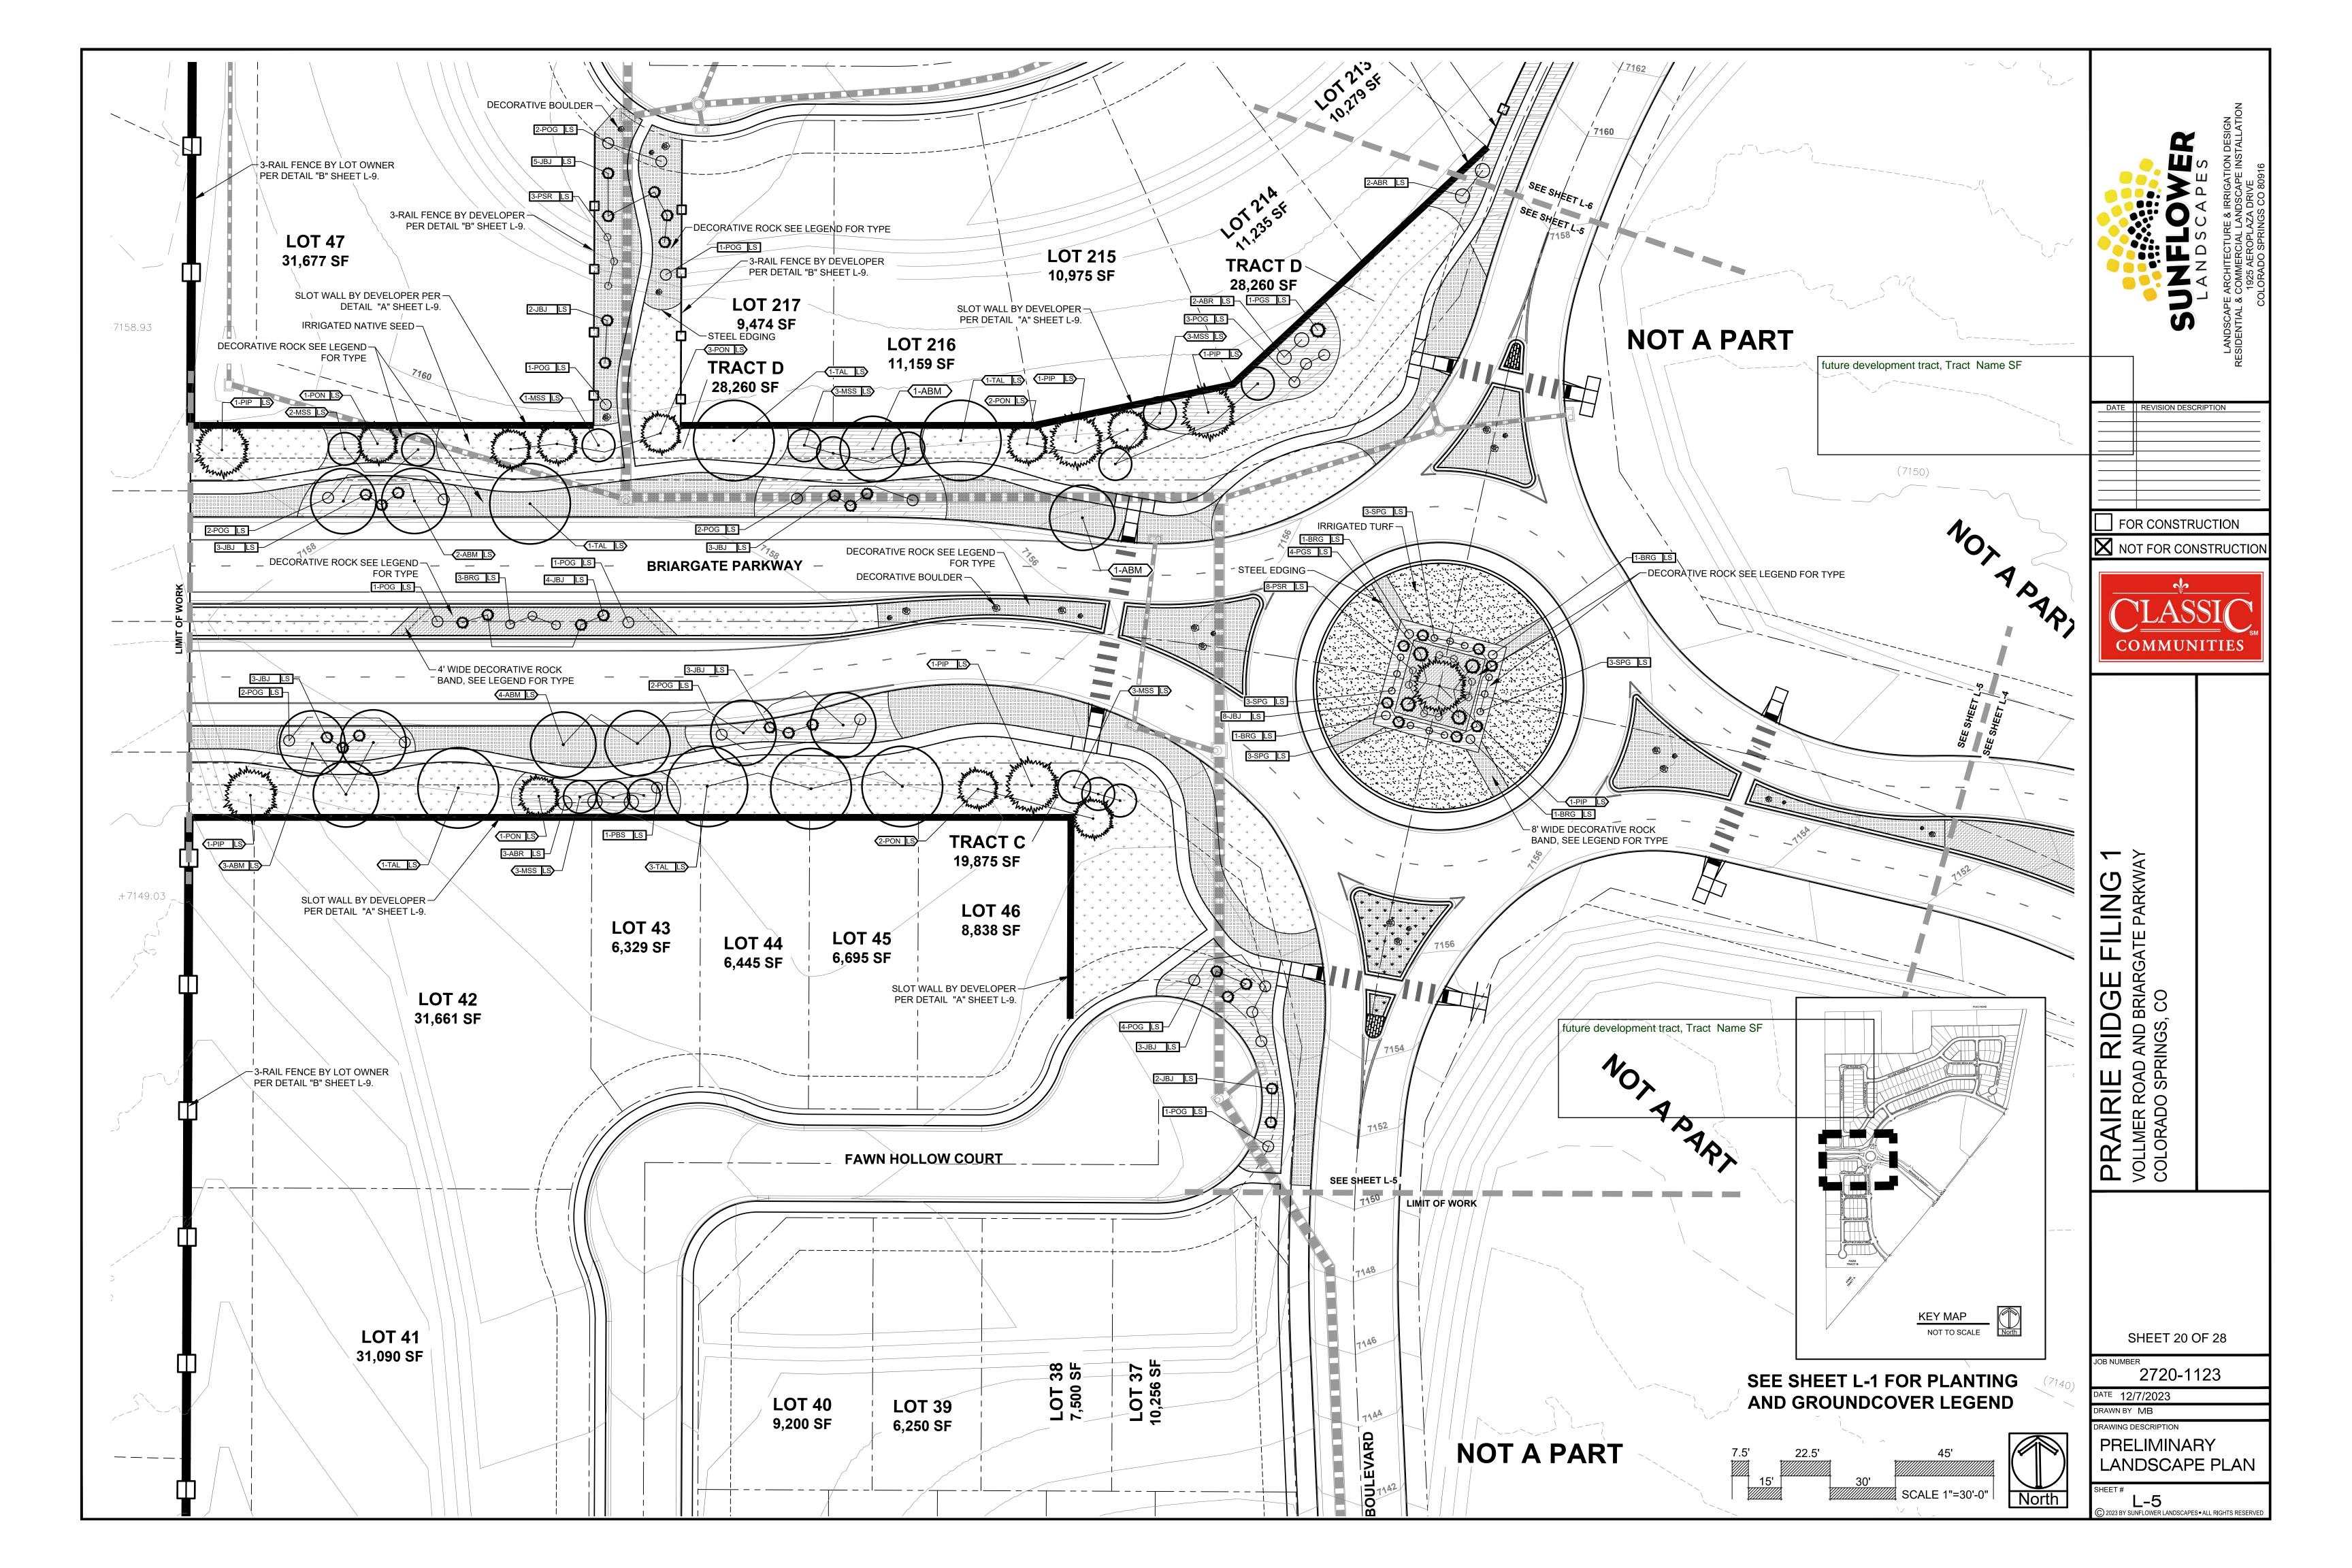


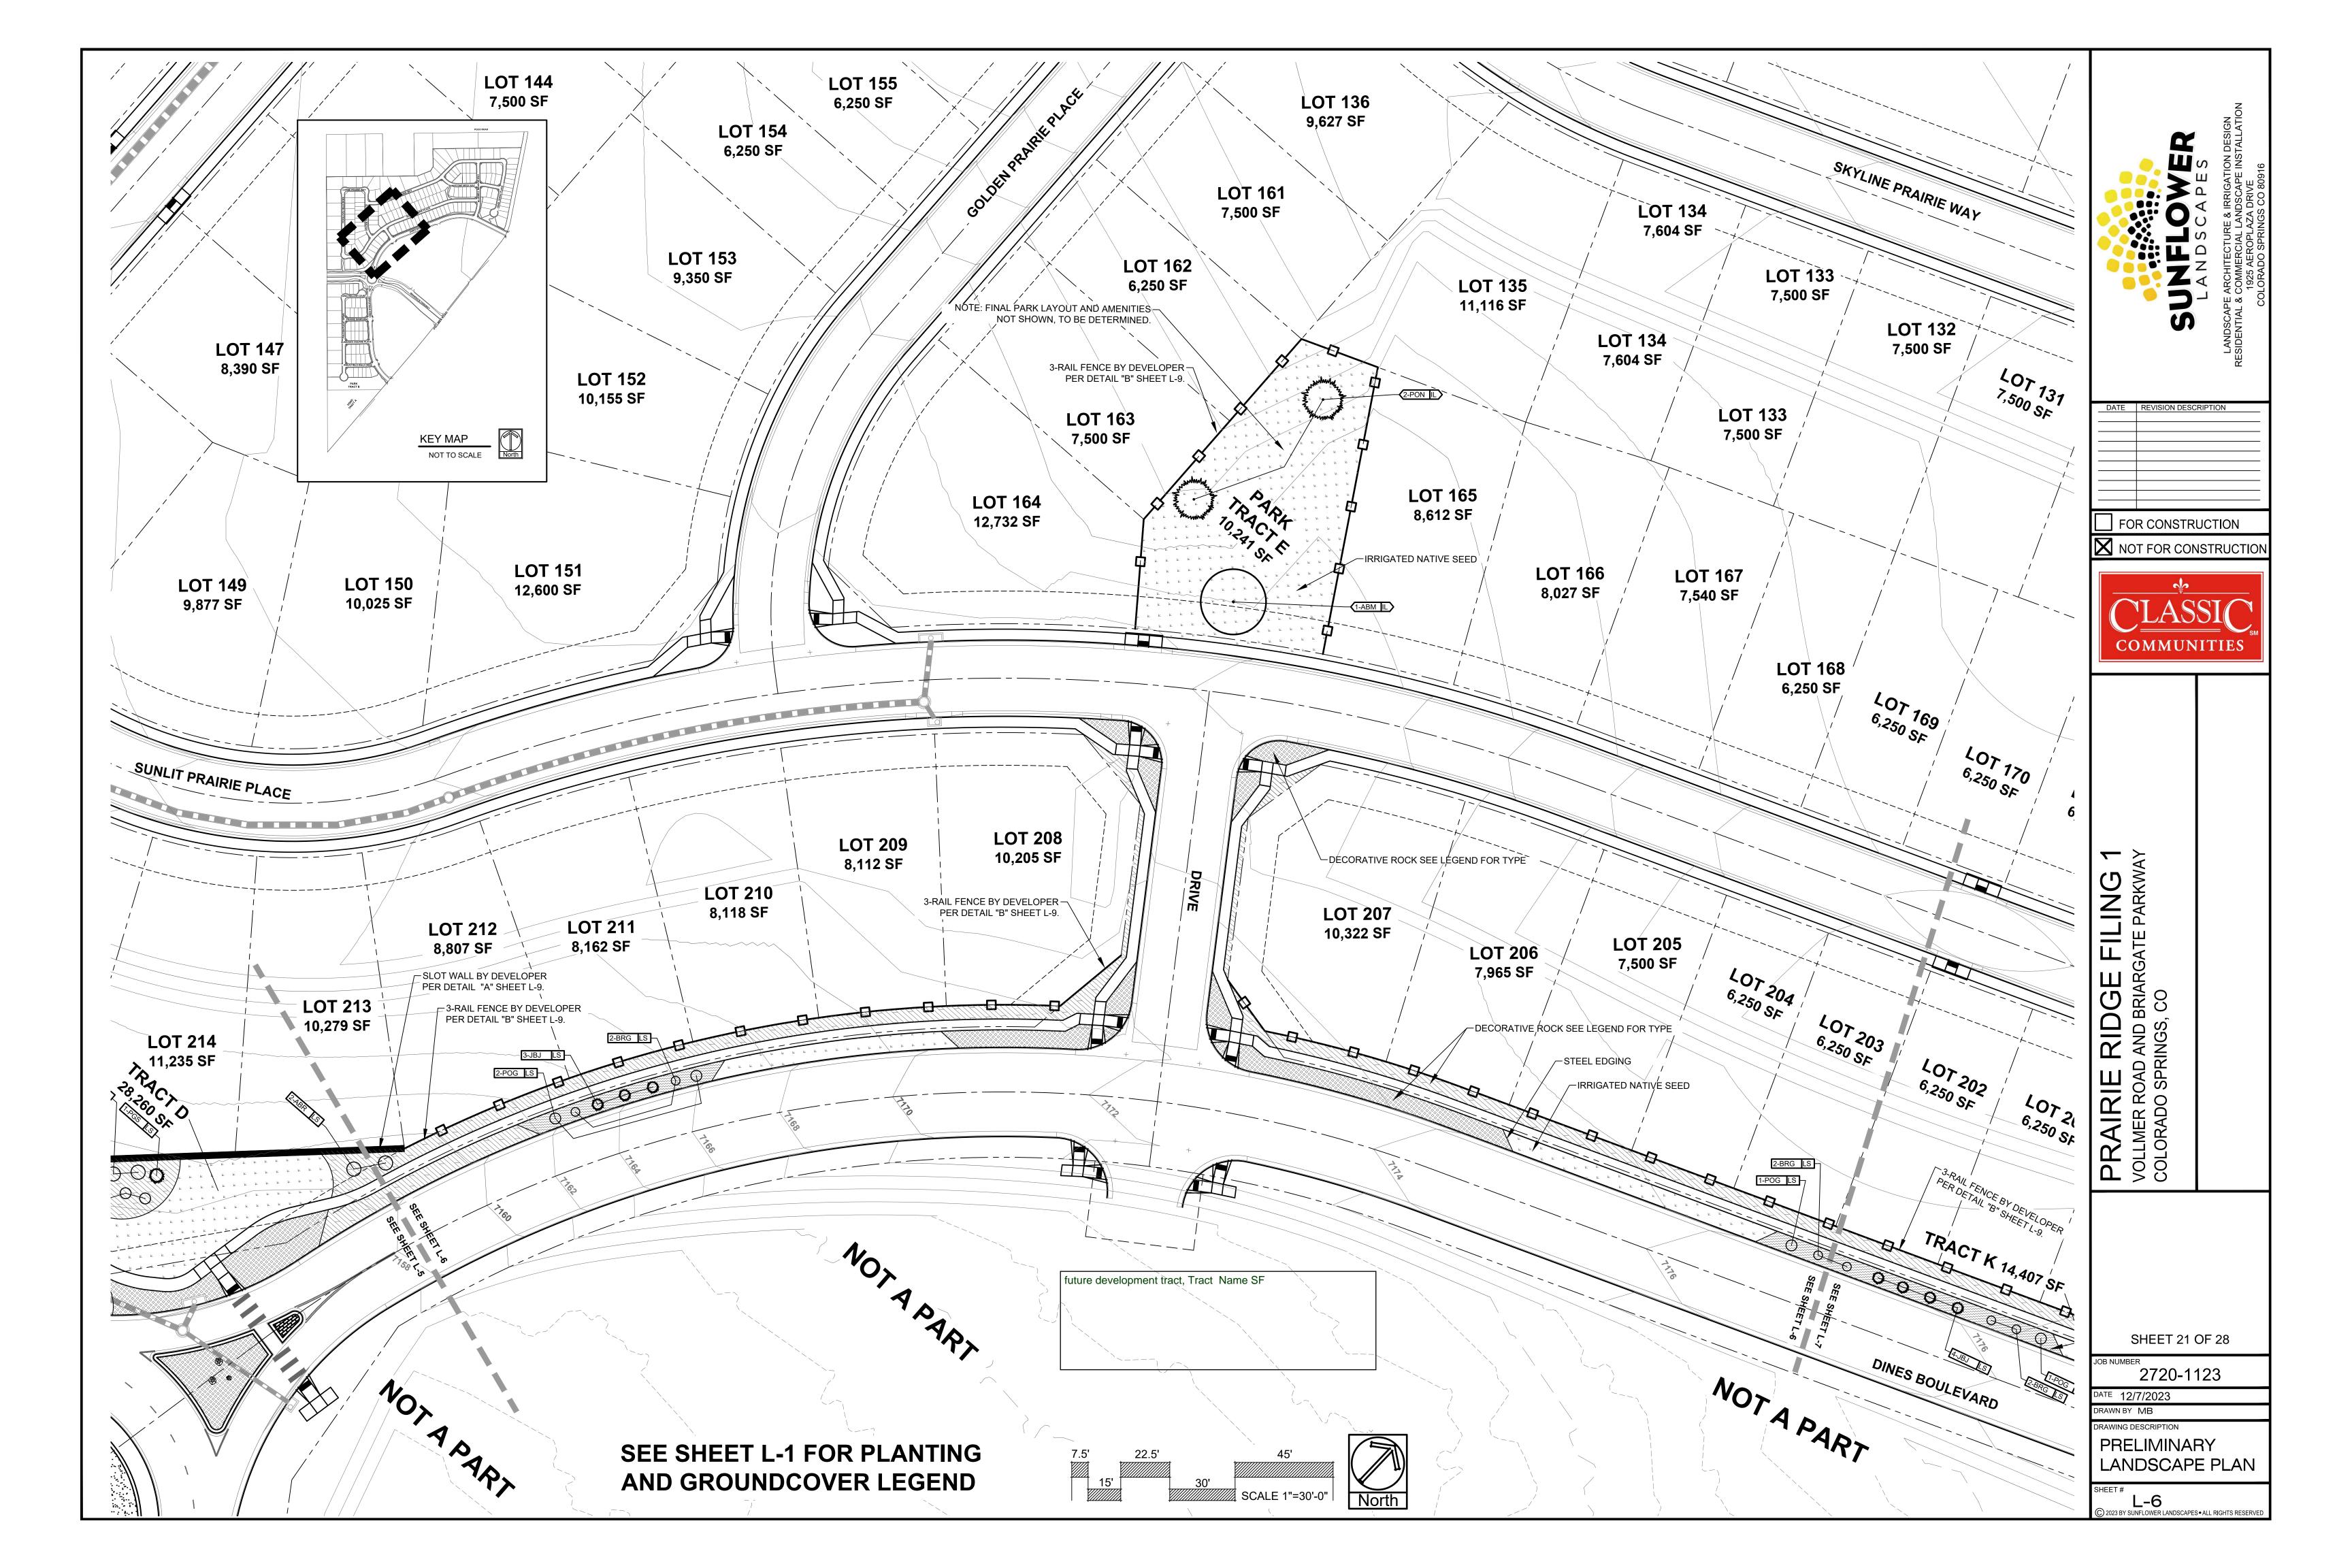


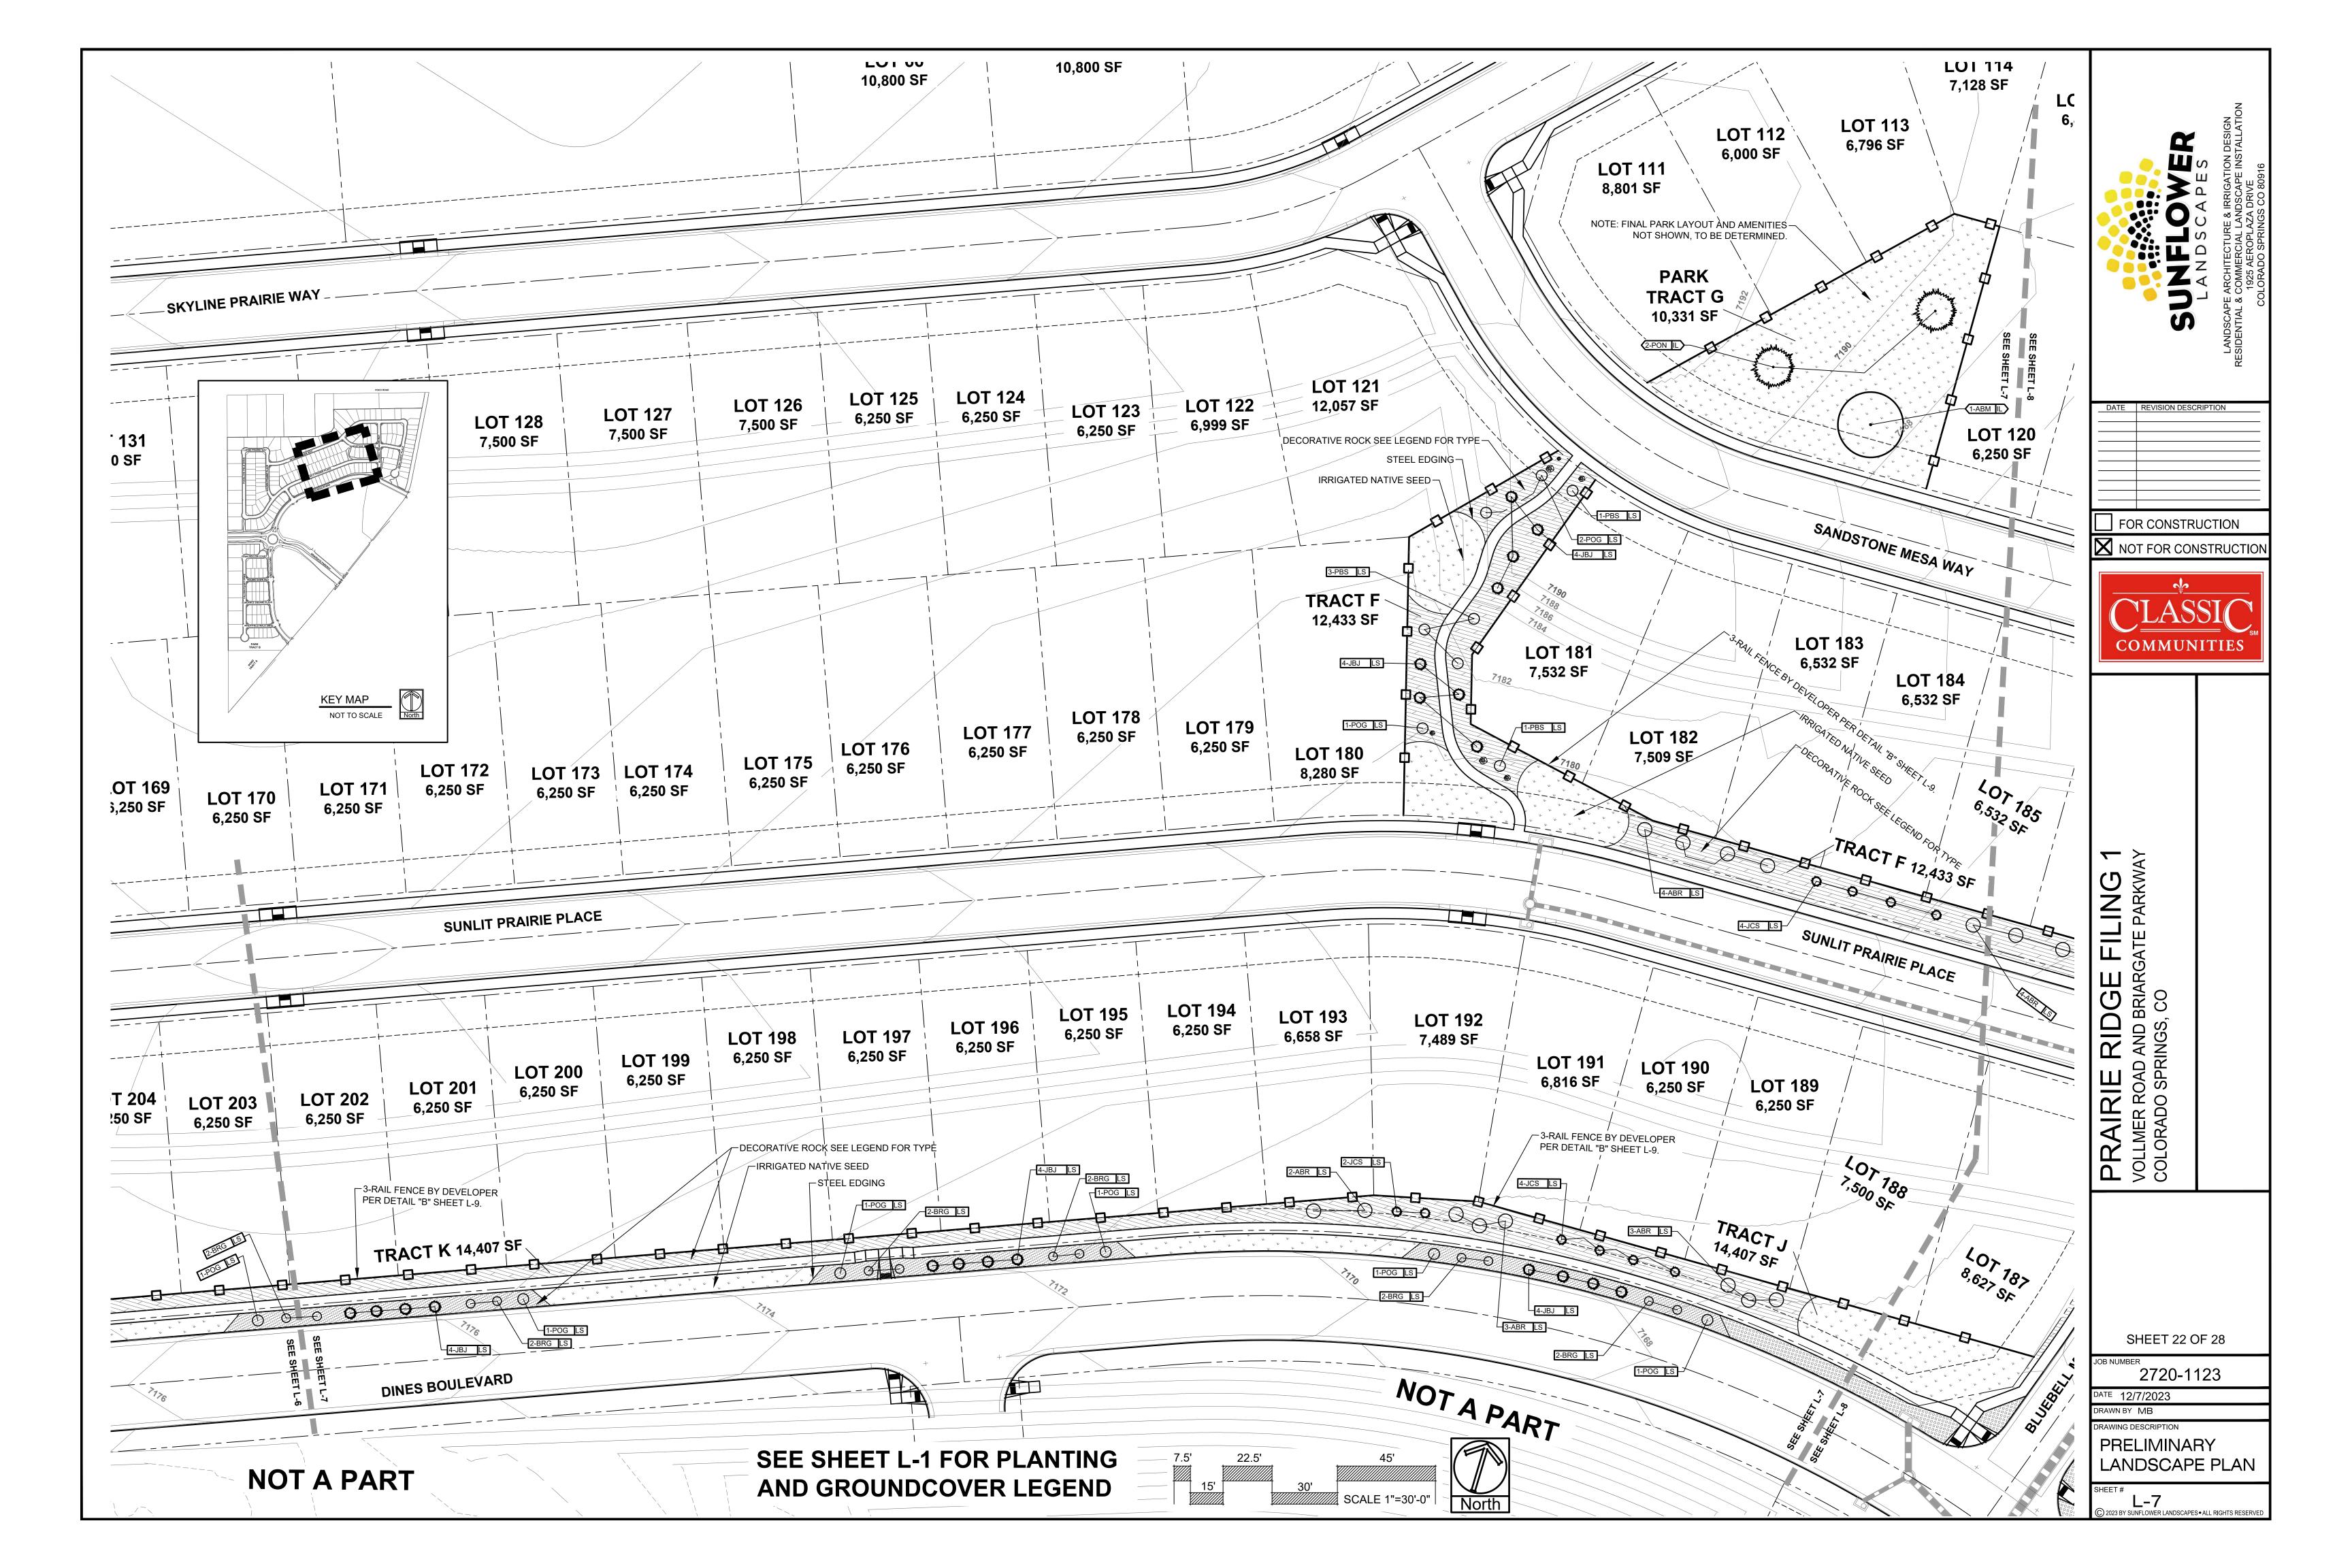

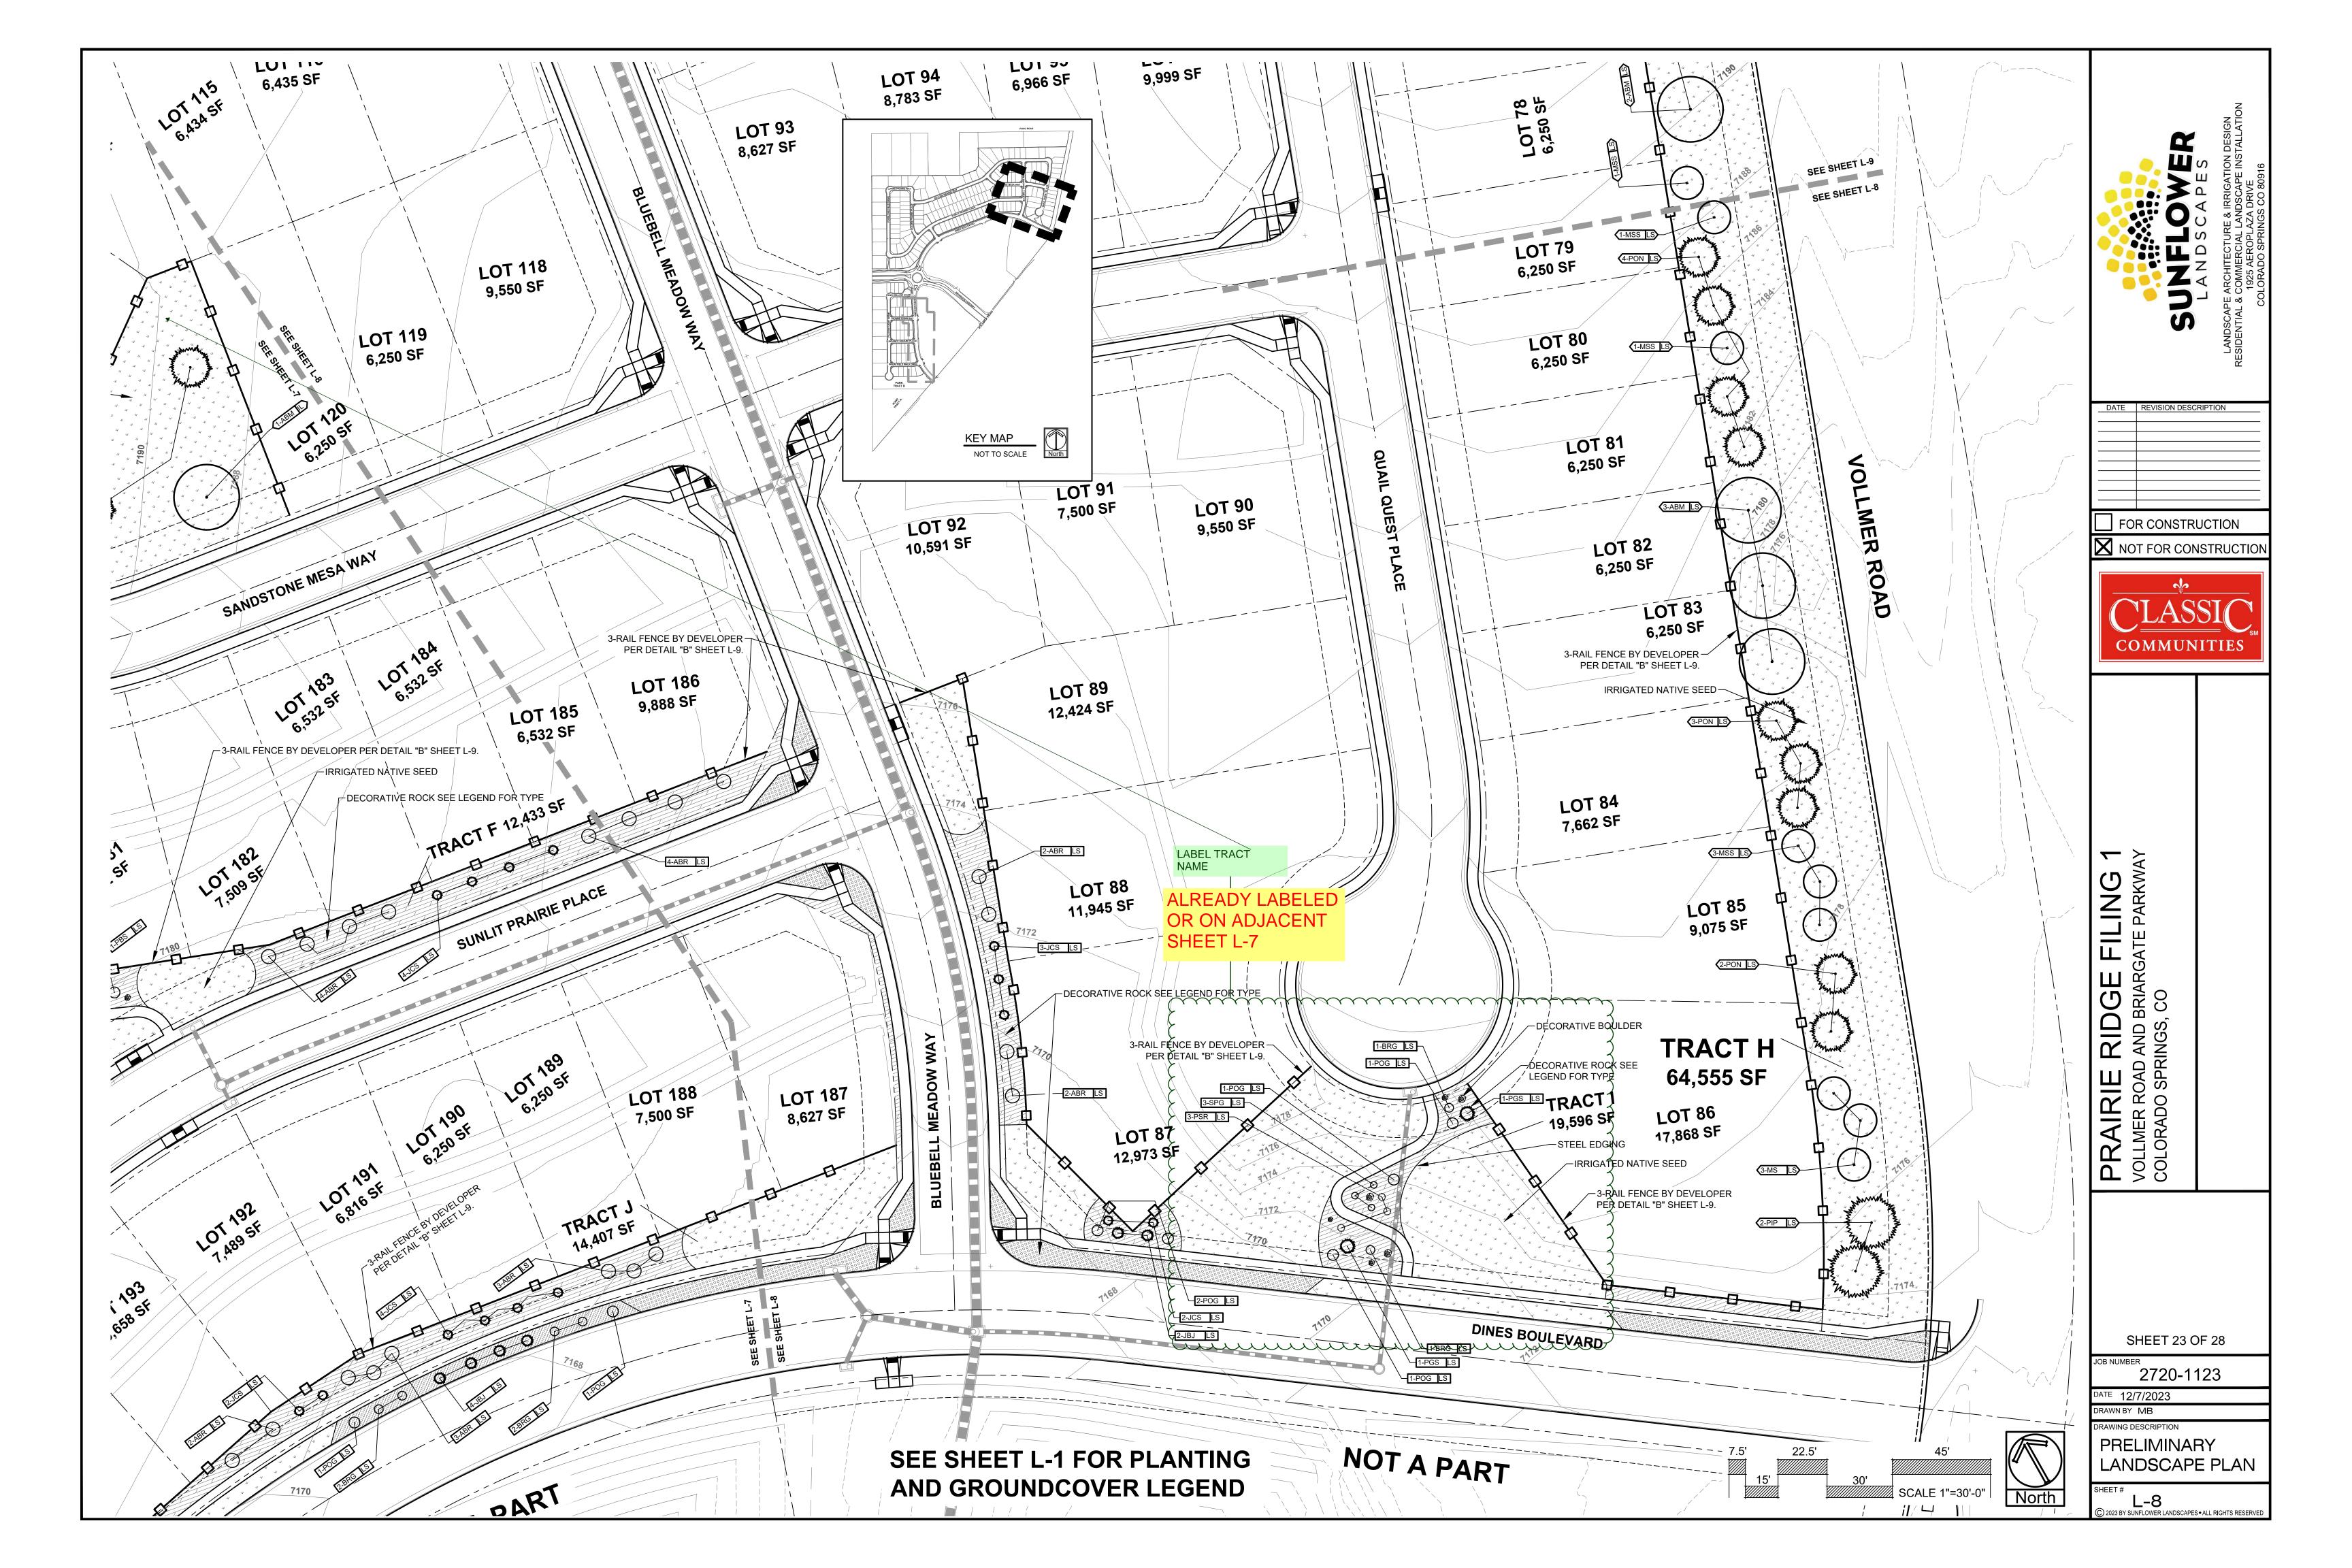

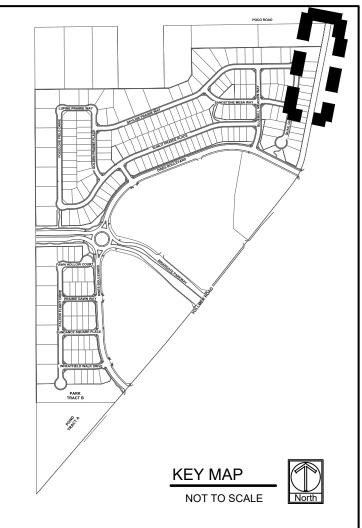

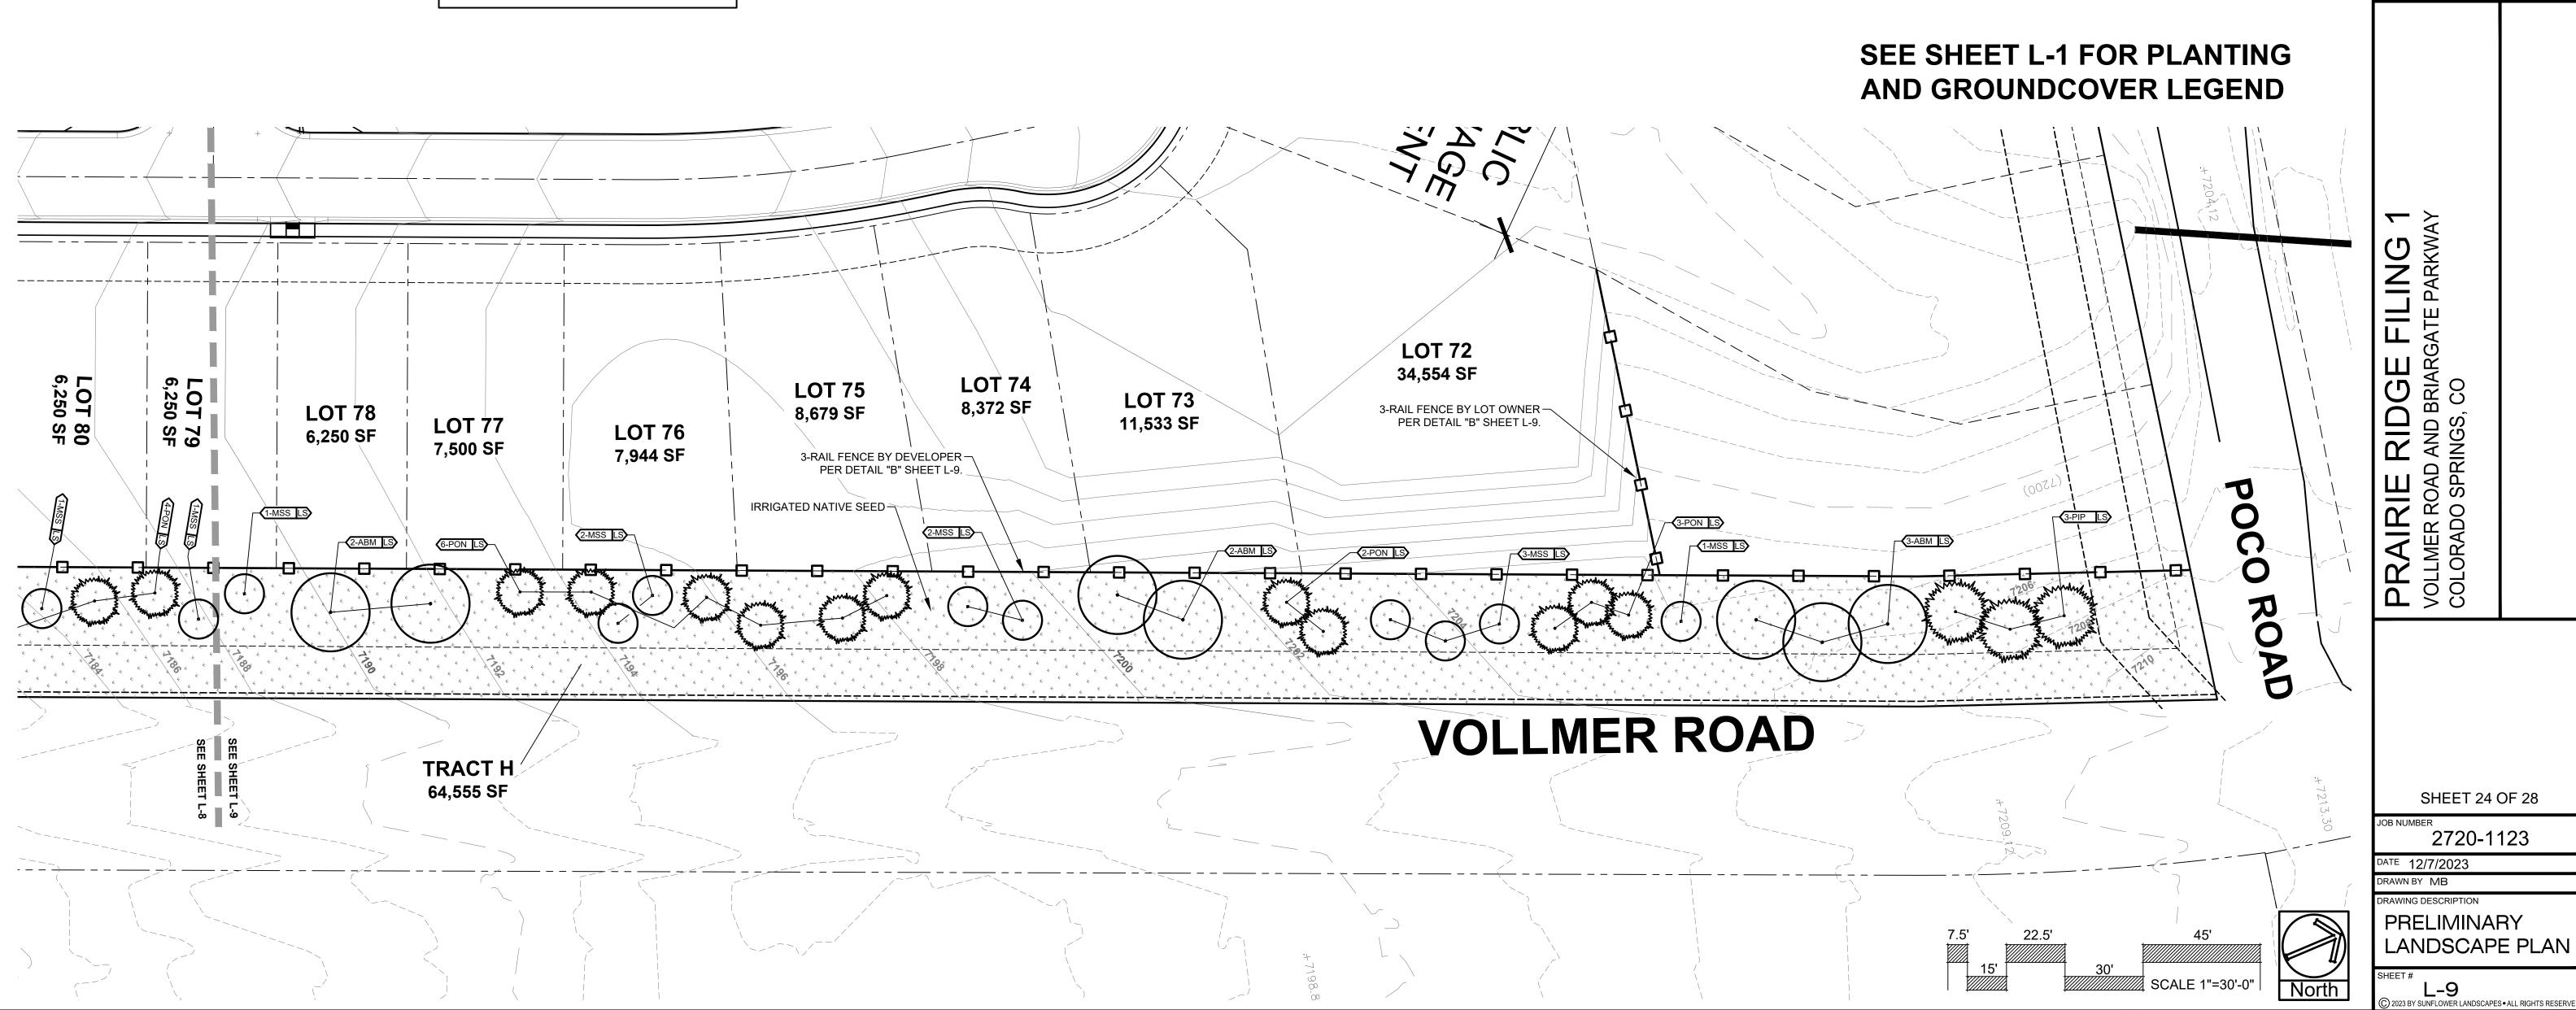

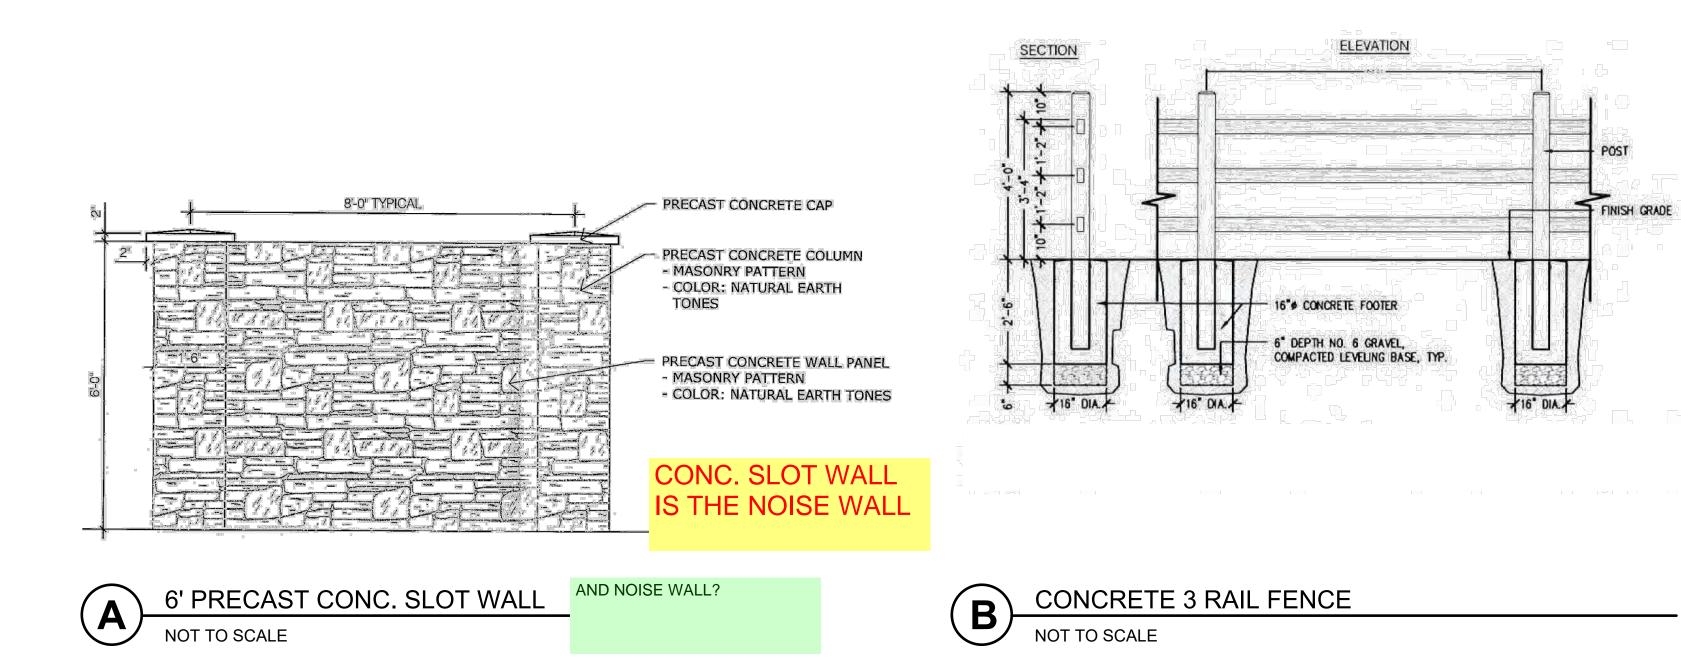

* NOTE SEE OVERALL SHEET L-1 FOR CALLOUTS FOR FENCES OR WALLS NOT SHOWN ON 30 SCALE SHEETS.


(n)

DATE REVISION DESCRIPTION

FOR CONSTRUCTION

NOT FOR CONSTRUCTIO

COMMUNITIES

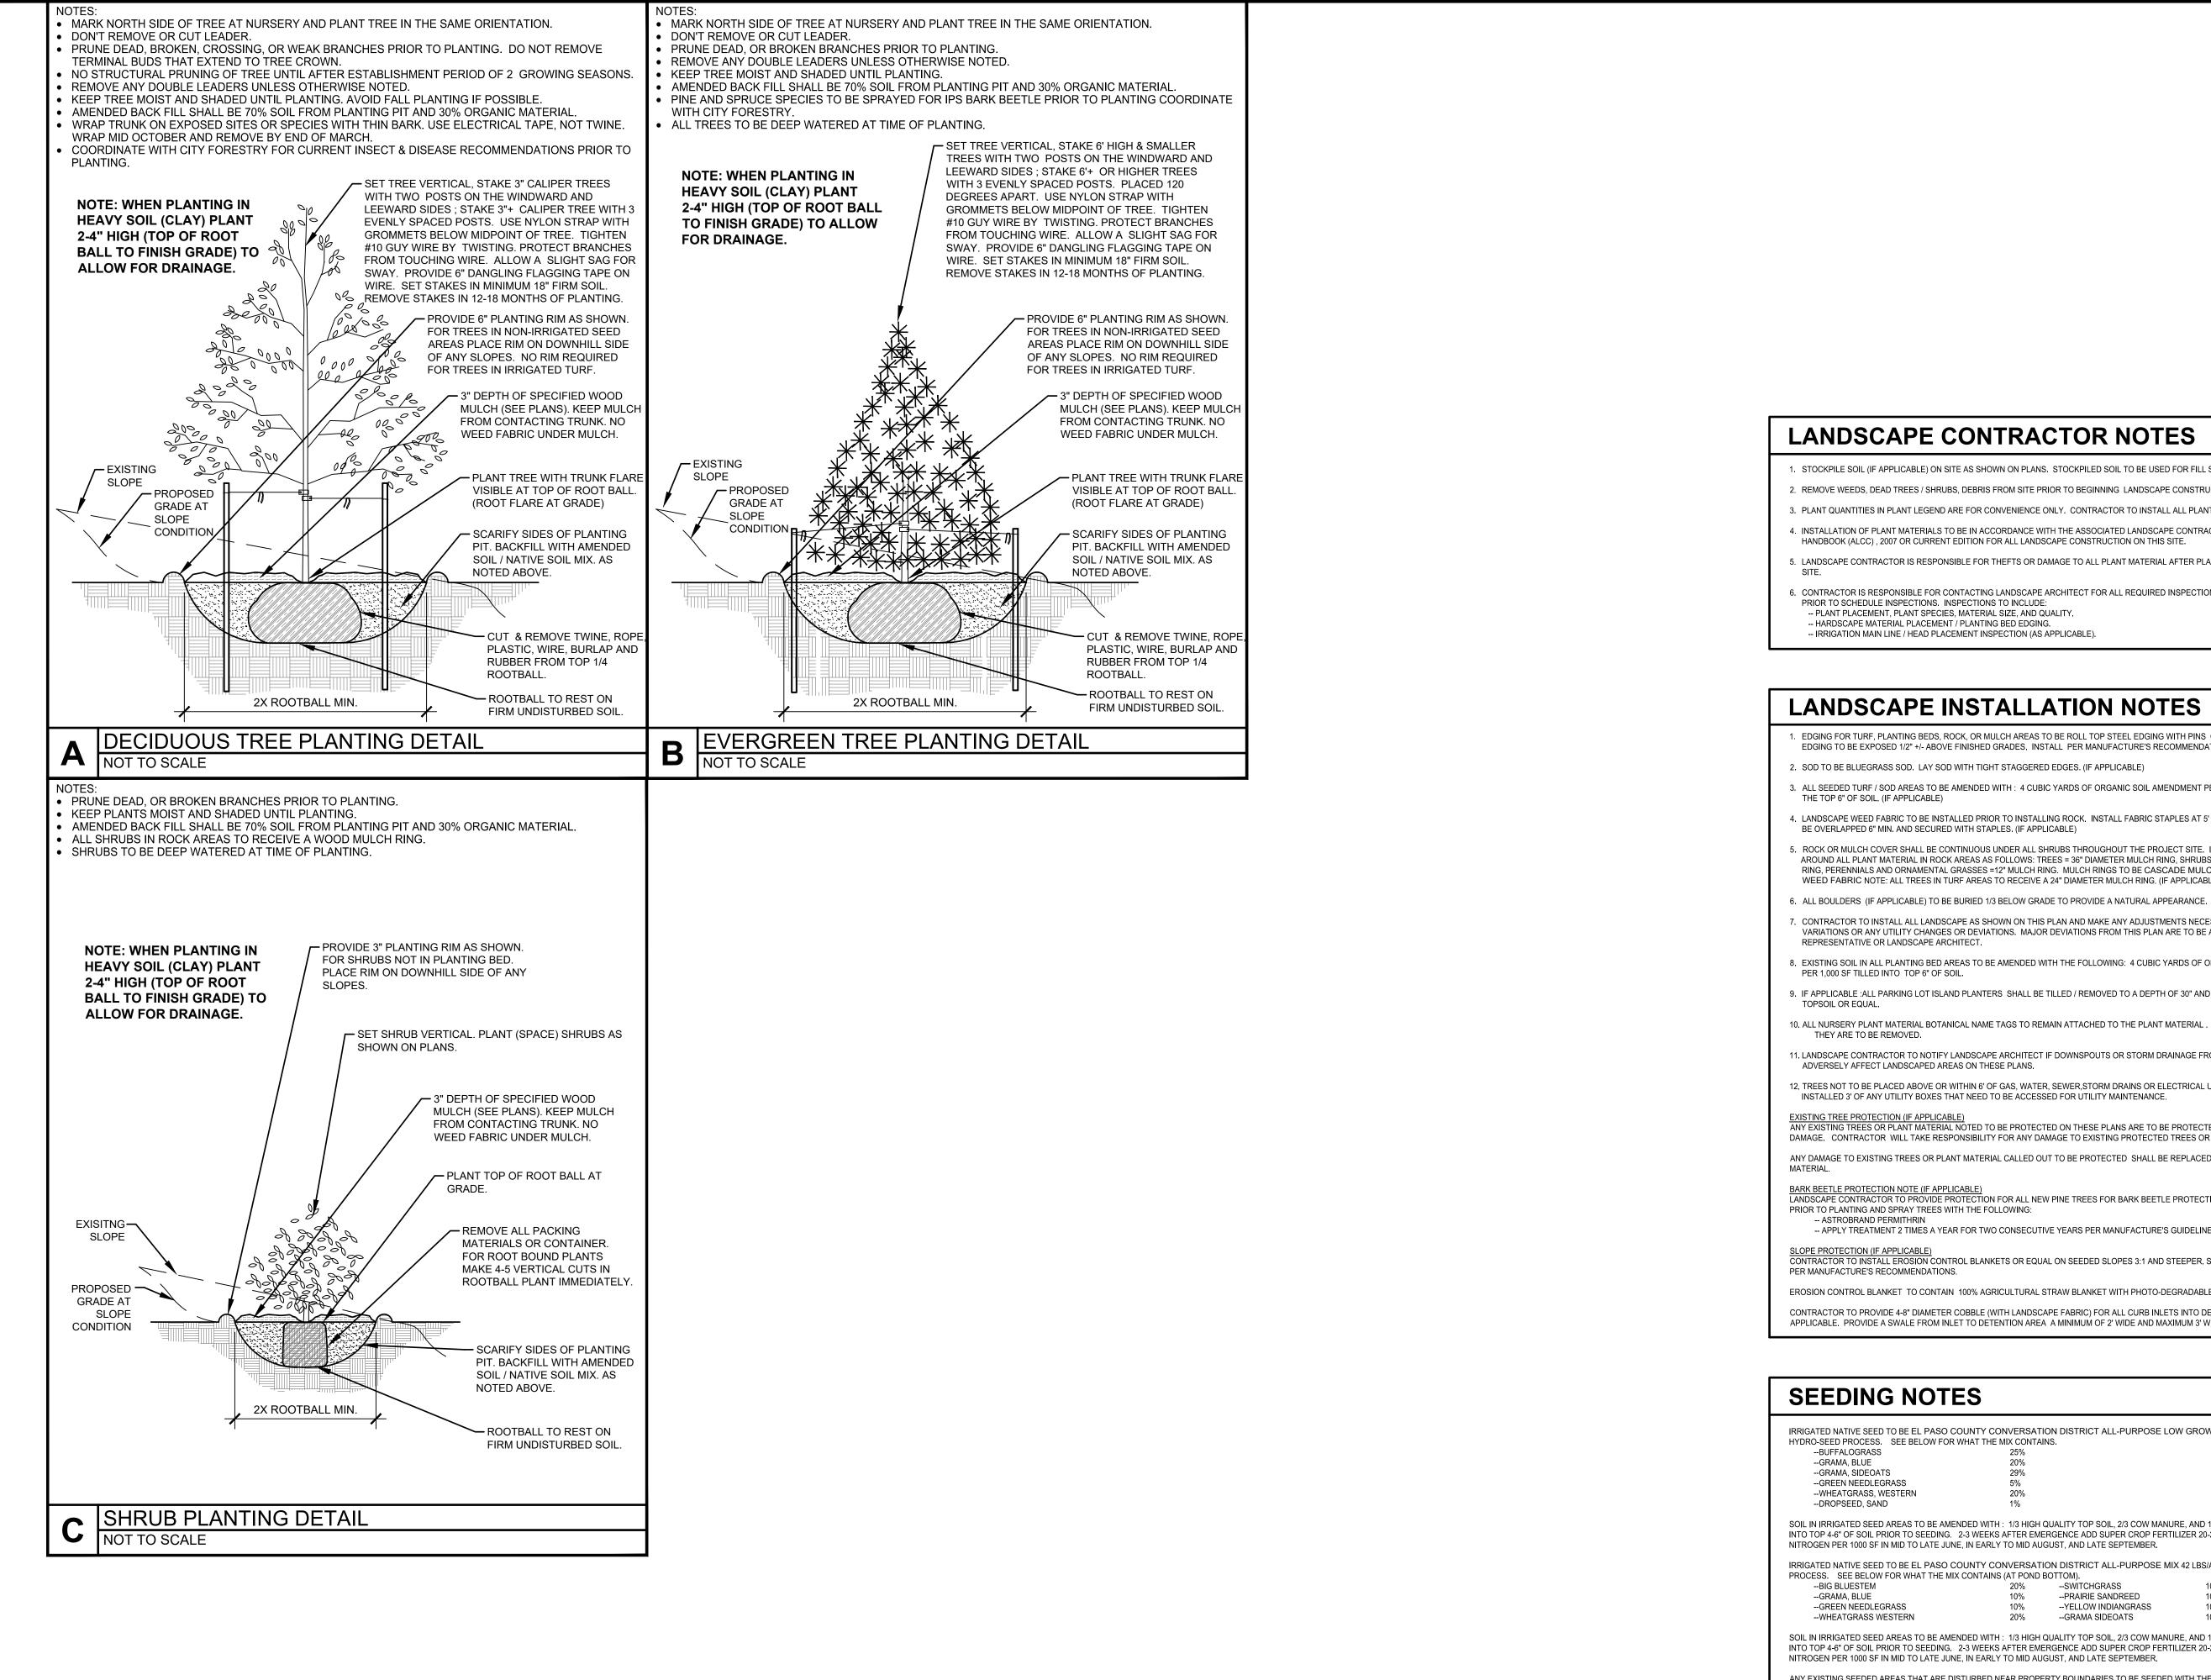

SEEDING

TOPSOIL OR EQUAL.

IRRIGATED NATIVE SEED HYDRO-SEED PROCESS --BUFFALOGRASS --GRAMA, BLUE --GRAMA, SIDEOA --GREEN NEEDLEC --WHEATGRASS, V --DROPSEED, SAN SOIL IN IRRIGATED SEED INTO TOP 4-6" OF SOIL PI NITROGEN PER 1000 SF I

IRRIGATED NATIVE SEED PROCESS. SEE BELOW --BIG BLUESTEM --GRAMA BLUE --GREEN NEEDLE --WHEATGRASS V SOIL IN IRRIGATED SEED

INTO TOP 4-6" OF SOIL PI NITROGEN PER 1000 SF ANY EXISTING SEEDED HYDRO-MULCH. ANY BARE AREAS LARGE

LANDSCAPE CONTRACTOR NOTES

1. STOCKPILE SOIL (IF APPLICABLE) ON SITE AS SHOWN ON PLANS. STOCKPILED SOIL TO BE USED FOR FILL SOIL FOR LANDSCAPE AREAS AS NEEDED 2. REMOVE WEEDS, DEAD TREES / SHRUBS, DEBRIS FROM SITE PRIOR TO BEGINNING LANDSCAPE CONSTRUCTION.

3. PLANT QUANTITIES IN PLANT LEGEND ARE FOR CONVENIENCE ONLY. CONTRACTOR TO INSTALL ALL PLANT MATERIAL PER PLANS.

4. INSTALLATION OF PLANT MATERIALS TO BE IN ACCORDANCE WITH THE ASSOCIATED LANDSCAPE CONTRACTORS OF COLORADO HANDBOOK (ALCC), 2007 OR CURRENT EDITION FOR ALL LANDSCAPE CONSTRUCTION ON THIS SITE.

E. LANDSCAPE CONTRACTOR IS RESPONSIBLE FOR THEFTS OR DAMAGE TO ALL PLANT MATERIAL AFTER PLANT MATERIAL IS DELIVERED TO THE JOB

6. CONTRACTOR IS RESPONSIBLE FOR CONTACTING LANDSCAPE ARCHITECT FOR ALL REQUIRED INSPECTIONS. PROVIDE 48 HOURS MINIMUM NOTICE PRIOR TO SCHEDULE INSPECTIONS. INSPECTIONS TO INCLUDE: -- PLANT PLACEMENT, PLANT SPECIES, MATERIAL SIZE, AND QUALITY.

-- HARDSCAPE MATERIAL PLACEMENT / PLANTING BED EDGING. -- IRRIGATION MAIN LINE / HEAD PLACEMENT INSPECTION (AS APPLICABLE).

LANDSCAPE INSTALLATION NOTES

EDGING FOR TURF, PLANTING BEDS, ROCK, OR MULCH AREAS TO BE ROLL TOP STEEL EDGING WITH PINS OR APPROVED EQUAL. EDGING TO BE EXPOSED 1/2" +/- ABOVE FINISHED GRADES. INSTALL PER MANUFACTURE'S RECOMMENDATIONS.

2. SOD TO BE BLUEGRASS SOD. LAY SOD WITH TIGHT STAGGERED EDGES. (IF APPLICABLE)

3. ALL SEEDED TURF / SOD AREAS TO BE AMENDED WITH : 4 CUBIC YARDS OF ORGANIC SOIL AMENDMENT PER 1,000 SF TILLED INTO THE TOP 6" OF SOIL. (IF APPLICABLE)

4. LANDSCAPE WEED FABRIC TO BE INSTALLED PRIOR TO INSTALLING ROCK. INSTALL FABRIC STAPLES AT 5' O.C. SEAMS IN FABRIC TO BE OVERLAPPED 6" MIN, AND SECURED WITH STAPLES, (IF APPLICABLE)

. ROCK OR MULCH COVER SHALL BE CONTINUOUS UNDER ALL SHRUBS THROUGHOUT THE PROJECT SITE. INSTALL A MULCH RING AROUND ALL PLANT MATERIAL IN ROCK AREAS AS FOLLOWS: TREES = 36" DIAMETER MULCH RING, SHRUBS = 18" DIAMETER MULCH RING. PERENNIALS AND ORNAMENTAL GRASSES =12" MULCH RING. MULCH RINGS TO BE CASCADE MULCH 3" IN DEPTH WITH NO WEED FABRIC NOTE: ALL TREES IN TURF AREAS TO RECEIVE A 24" DIAMETER MULCH RING. (IF APPLICABLE)

7. CONTRACTOR TO INSTALL ALL LANDSCAPE AS SHOWN ON THIS PLAN AND MAKE ANY ADJUSTMENTS NECESSARY DUE TO FIELD VARIATIONS OR ANY UTILITY CHANGES OR DEVIATIONS. MAJOR DEVIATIONS FROM THIS PLAN ARE TO BE APPROVED BY OWNER'S REPRESENTATIVE OR LANDSCAPE ARCHITECT.

8. EXISTING SOIL IN ALL PLANTING BED AREAS TO BE AMENDED WITH THE FOLLOWING: 4 CUBIC YARDS OF ORGANIC SOIL AMENDMENT PER 1,000 SF TILLED INTO TOP 6" OF SOIL.

9. IF APPLICABLE :ALL PARKING LOT ISLAND PLANTERS SHALL BE TILLED / REMOVED TO A DEPTH OF 30" AND REPLACED WITH GRADE 'B'

10. ALL NURSERY PLANT MATERIAL BOTANICAL NAME TAGS TO REMAIN ATTACHED TO THE PLANT MATERIAL . AFTER FINAL INSPECTION

THEY ARE TO BE REMOVED. 11. LANDSCAPE CONTRACTOR TO NOTIFY LANDSCAPE ARCHITECT IF DOWNSPOUTS OR STORM DRAINAGE FROM ADJACENT LOTS WILL

ADVERSELY AFFECT LANDSCAPED AREAS ON THESE PLANS, 12. TREES NOT TO BE PLACED ABOVE OR WITHIN 6' OF GAS, WATER, SEWER, STORM DRAINS OR ELECTRICAL UTILITIES. PLANTS NOT TO BE INSTALLED 3' OF ANY UTILITY BOXES THAT NEED TO BE ACCESSED FOR UTILITY MAINTENANCE.

EXISTING TREE PROTECTION (IF APPLICABLE) ANY EXISTING TREES OR PLANT MATERIAL NOTED TO BE PROTECTED ON THESE PLANS ARE TO BE PROTECTED FROM CONSTRUCTION

DAMAGE. CONTRACTOR WILL TAKE RESPONSIBILITY FOR ANY DAMAGE TO EXISTING PROTECTED TREES OR LANDSCAPE. ANY DAMAGE TO EXISTING TREES OR PLANT MATERIAL CALLED OUT TO BE PROTECTED SHALL BE REPLACED WITH EQUIVALENT PLANT

BARK BEETLE PROTECTION NOTE (IF APPLICABLE) LANDSCAPE CONTRACTOR TO PROVIDE PROTECTION FOR ALL NEW PINE TREES FOR BARK BEETLE PROTECTION . INSPECT ALL PINE TREES PRIOR TO PLANTING AND SPRAY TREES WITH THE FOLLOWING: -- ASTROBRAND PERMITHRIN -- APPLY TREATMENT 2 TIMES A YEAR FOR TWO CONSECUTIVE YEARS PER MANUFACTURE'S GUIDELINES

SLOPE PROTECTION (IF APPLICABLE) CONTRACTOR TO INSTALL EROSION CONTROL BLANKETS OR EQUAL ON SEEDED SLOPES 3:1 AND STEEPER, SECURE BLANKETS TO SLOPE PER MANUFACTURE'S RECOMMENDATIONS.


EROSION CONTROL BLANKET TO CONTAIN 100% AGRICULTURAL STRAW BLANKET WITH PHOTO-DEGRADABLE NETTING ON BOTH SIDES.

CONTRACTOR TO PROVIDE 4-8" DIAMETER COBBLE (WITH LANDSCAPE FABRIC) FOR ALL CURB INLETS INTO DETENTION AREAS IF APPLICABLE. PROVIDE A SWALE FROM INLET TO DETENTION AREA A MINIMUM OF 2' WIDE AND MAXIMUM 3' WIDE. (IF APPLICABLE)

G NOTES				
D TO BE EL PASO COUNTY CON SEE BELOW FOR WHAT THE M S TS GRASS WESTERN ID			LOW GROW MIX 42 LBS/ACR	E USING A ONE STEP
D AREAS TO BE AMENDED WITH : RIOR TO SEEDING. 2-3 WEEKS A IN MID TO LATE JUNE, IN EARLY '	FTER EMER	GENCE ADD SUPER CROP FEF		
D TO BE EL PASO COUNTY COM			MIX 42 LBS/ACRE USING A ON	E STEP HYDRO-SEED
GRASS	20% 10% 10%	SWITCHGRASS PRAIRIE SANDREED	10% 10% 10%	
VESTERN	20%	GRAMA SIDEOATS	10%	
D AREAS TO BE AMENDED WITH : RIOR TO SEEDING. 2-3 WEEKS A IN MID TO LATE JUNE, IN EARLY ⁻	FTER EMER	GENCE ADD SUPER CROP FEF		
AREAS THAT ARE DISTURBED NE	AR PROPERI	TY BOUNDARIES TO BE SEEDE	D WITH THE ALL PURPOSE MI	X USING A ONE STEP
ER THAN A SQUARE FOOT AFTEF	R SEED GERM	IINATION TO BE SEEDED TO F	ILL IN SUCH AREAS.	

SURFLOVER LANDSCAPES	LANDSCAPE ARCHITECTURE & IRRIGATION DESIGN RESIDENTIAL & COMMERCIAL LANDSCAPE INSTALLATION 1925 AEROPLAZA DRIVE COLORADO SPRINGS CO 80916
NOT FOR CONST	
PRAIRIE RIDGE FILING 1 VOLLMER ROAD AND BRIARGATE PARKWAY COLORADO SPRINGS, CO	
SHEET 25 OF	28
JOB NUMBER 2720-1123 DATE 12/7/2023 DRAWN BY MB	3
DRAWING DESCRIPTION PLANTING DE & NOTES SHEET # L-10	TAILS

KEY MAP

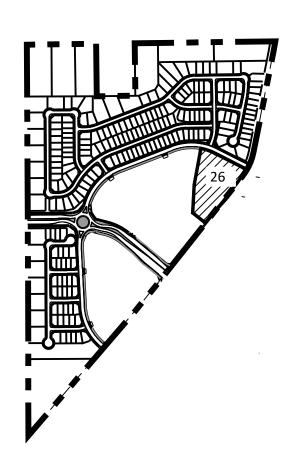

PLANT SCHEDULE

SYMBOL	CODE	QTY	BOTANICAL / COMMON NAME	HEIGHT		SIZE	COND	
EVERGREE	EN TREES	5						
	Pni	15	Pinus nigra / Austrian Black Pine	60`	40`	6`HT	B&B	
ORNAMEN	ORNAMENTAL TREES							
	Ms	12	Malus x `Spring Snow` / Spring Snow Crab Apple	25`	25`	1.5" Cal.	B&B	

GROUND COVER LEGEND






AS DISCUSSED UPON DEVELOPMENT THERE WILL NOT BE ANY WATER IN THIS STOCK POND. IT WILL BE CONVERTED TO A FORMAL PARK WITH LANDSCAPING.

190.27


WE ARE HOWEVER SAVING THE FEW TREES WITH RAPTOR NESTS IN THEM.

Preservation of pond and rapture nest trees was agreed at SKP hearing; please label trees that are to be protected and pond;

update letter of intent

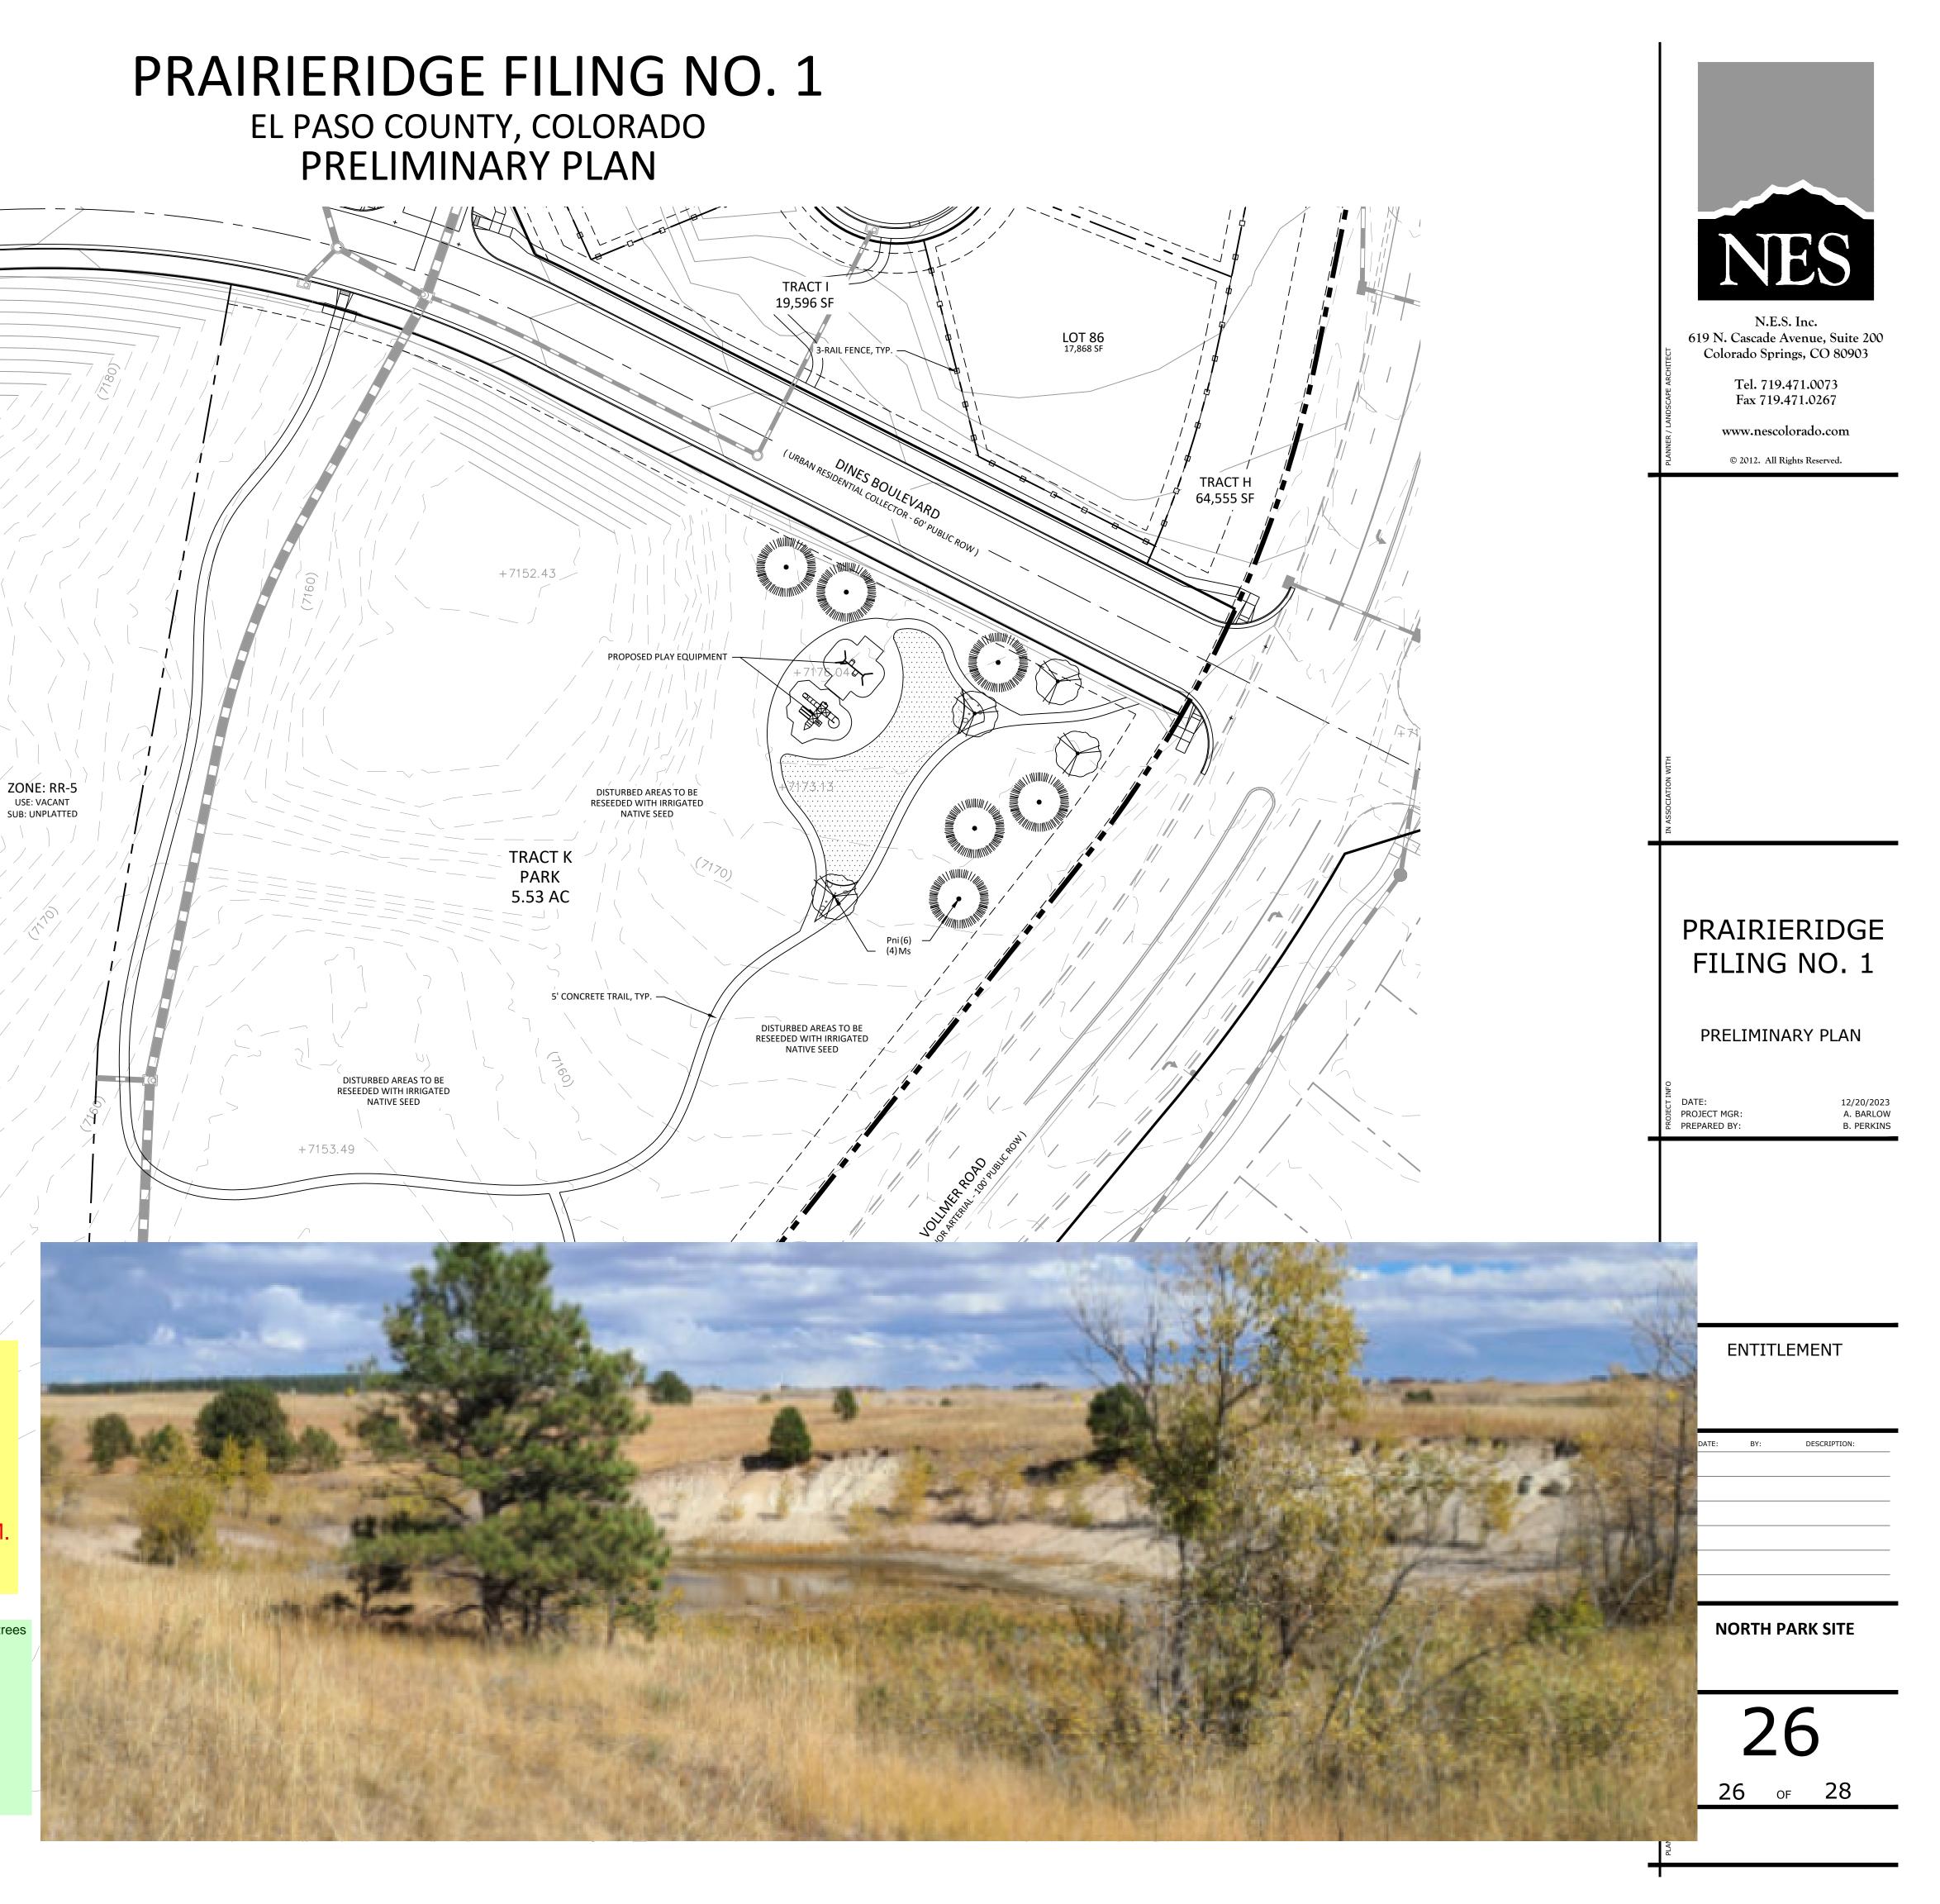


KEY MAP

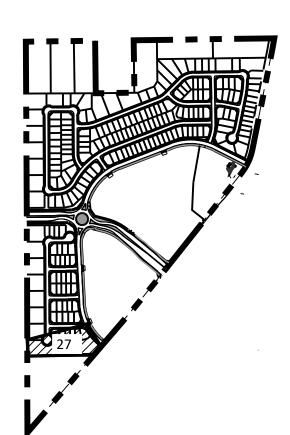


PLANT	SCHE	DUL	E						
SYMBOL	CODE	QTY	BOTANICAL / COMMON NAME	HEIGHT		SIZE	COND		
	EN TREES	<u>9</u> 15	Pinus nigra / Austrian Black Pine	60`	40`	6` HT	B&B	NO. 2	
	NTAL TRE	12	Malus x `Spring Snow` / Spring Snow Crab Apple	25`	25`	1.5" Cal.	B&B	ZONE: RR-5 USE: RESIDENTIAL ILDRIDGE SUBDIVISION NO. 2	

GROUND COVER LEGEND



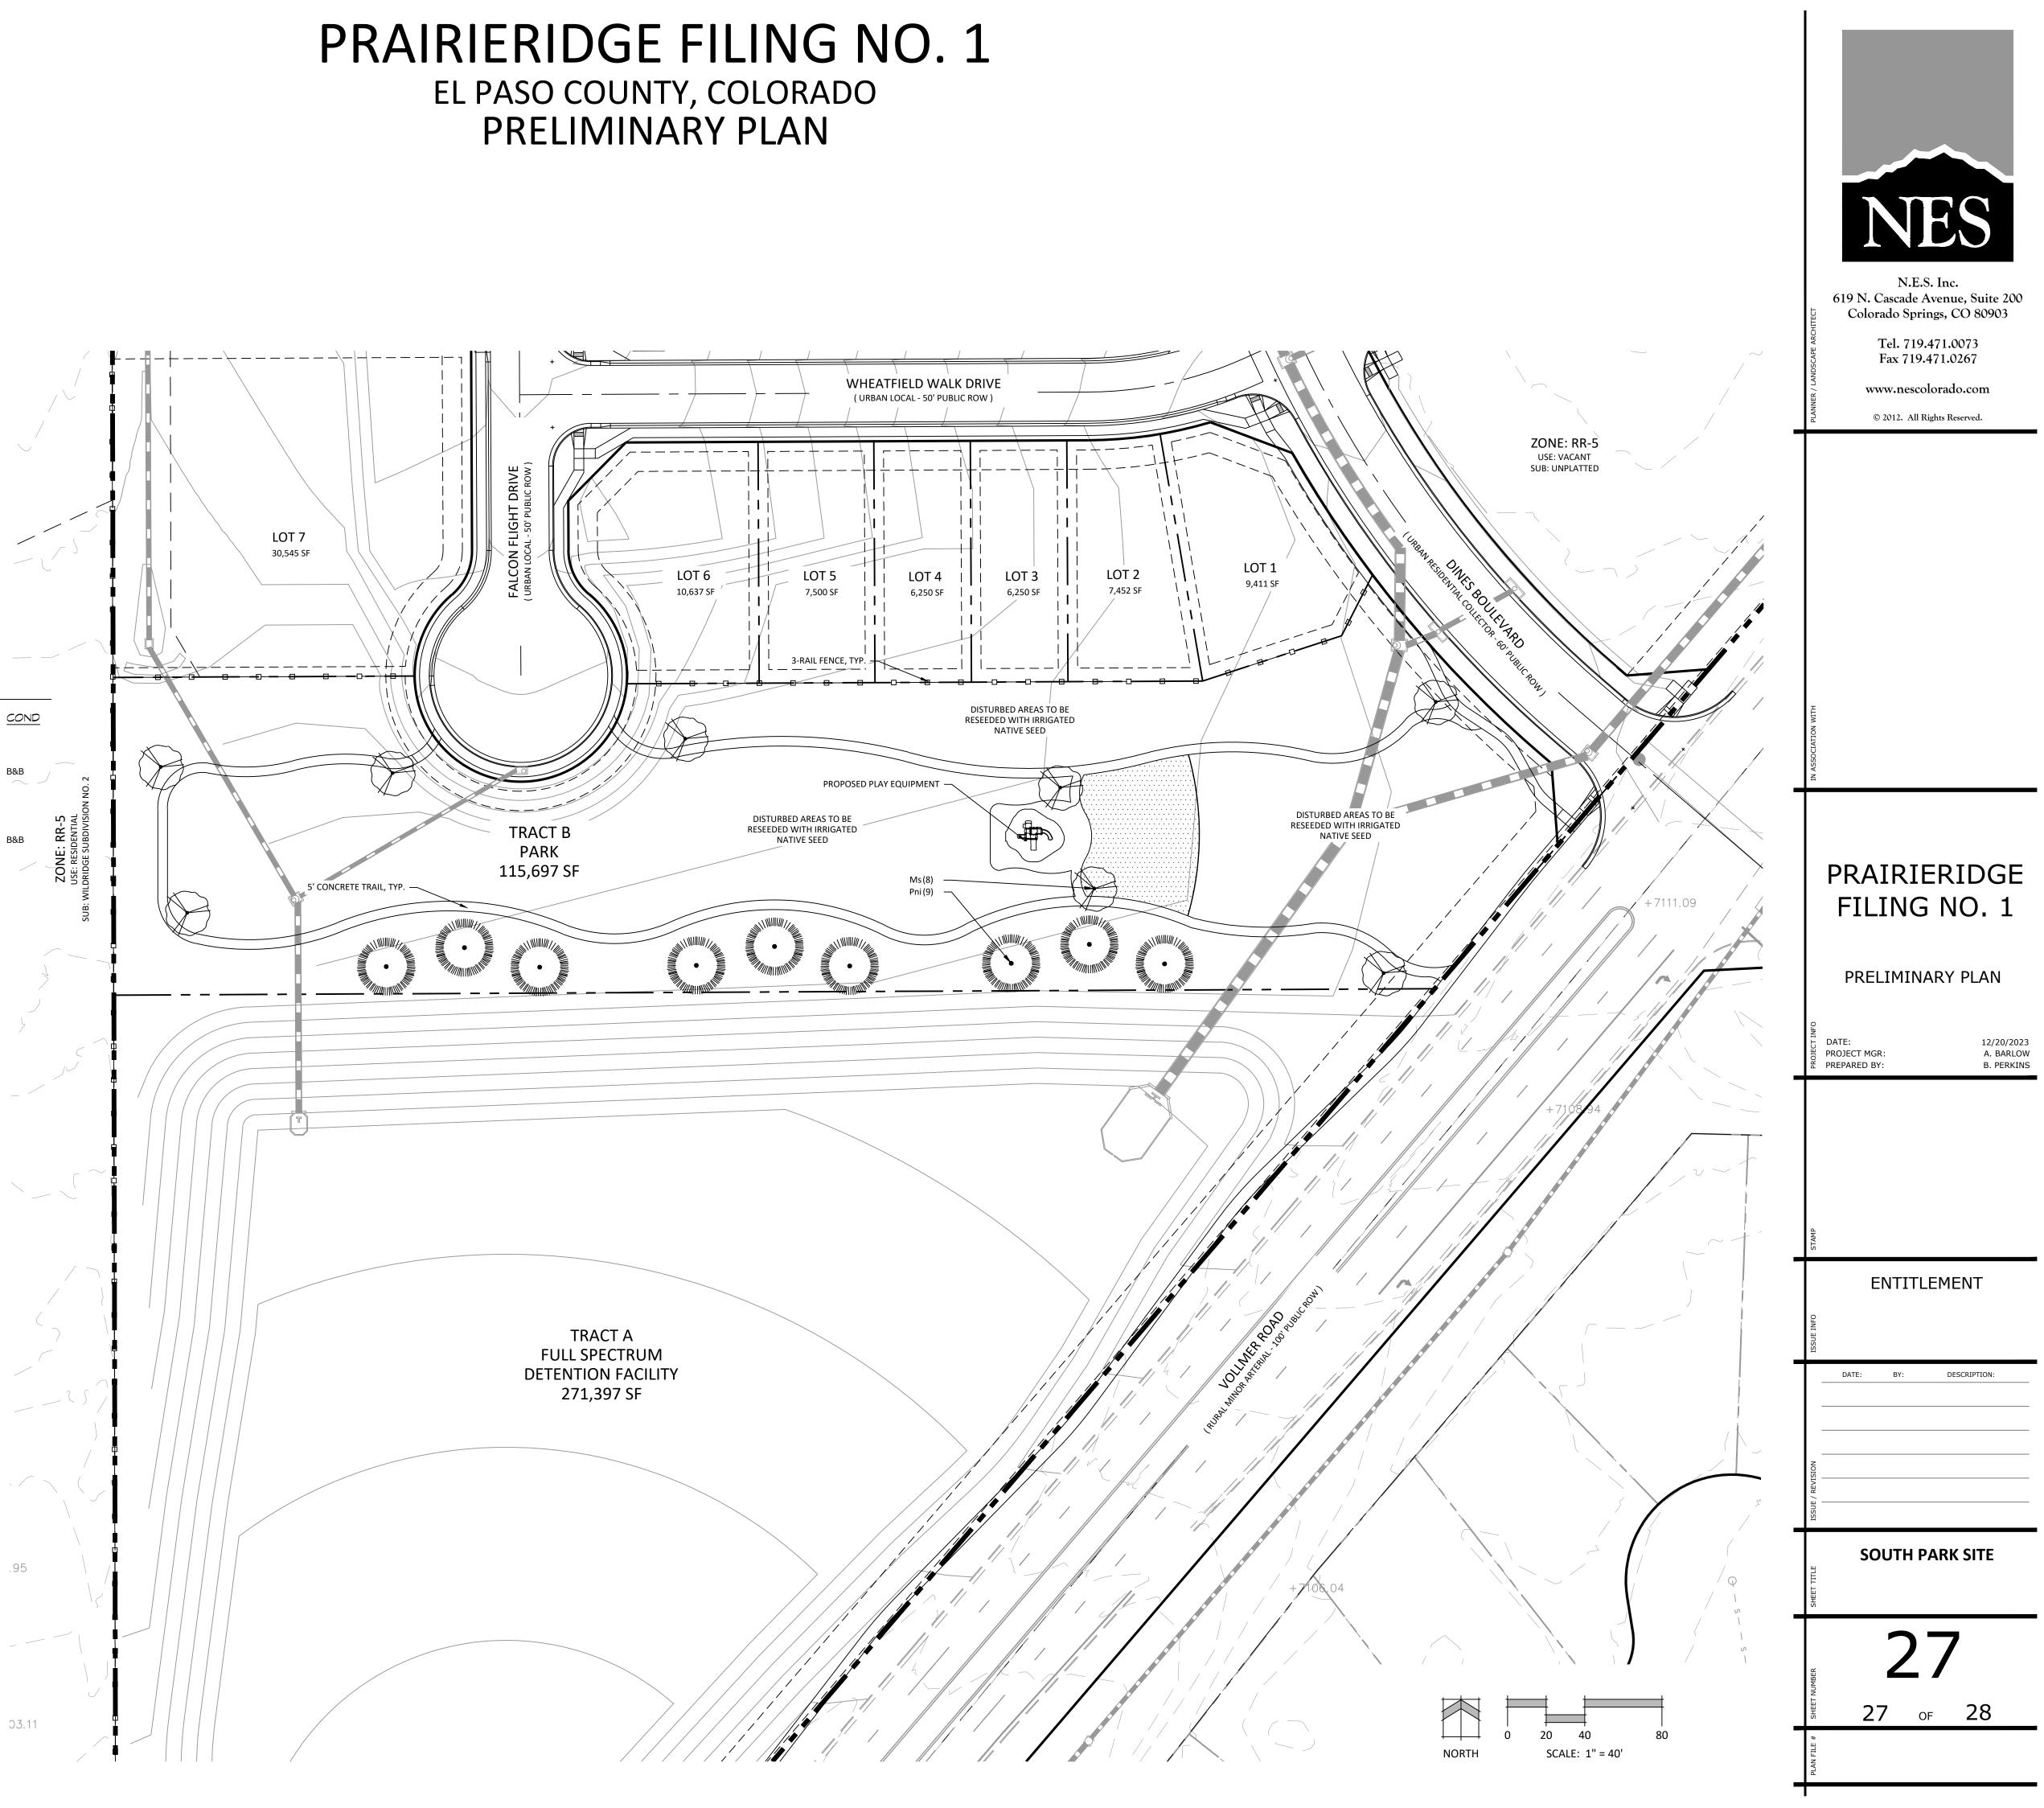

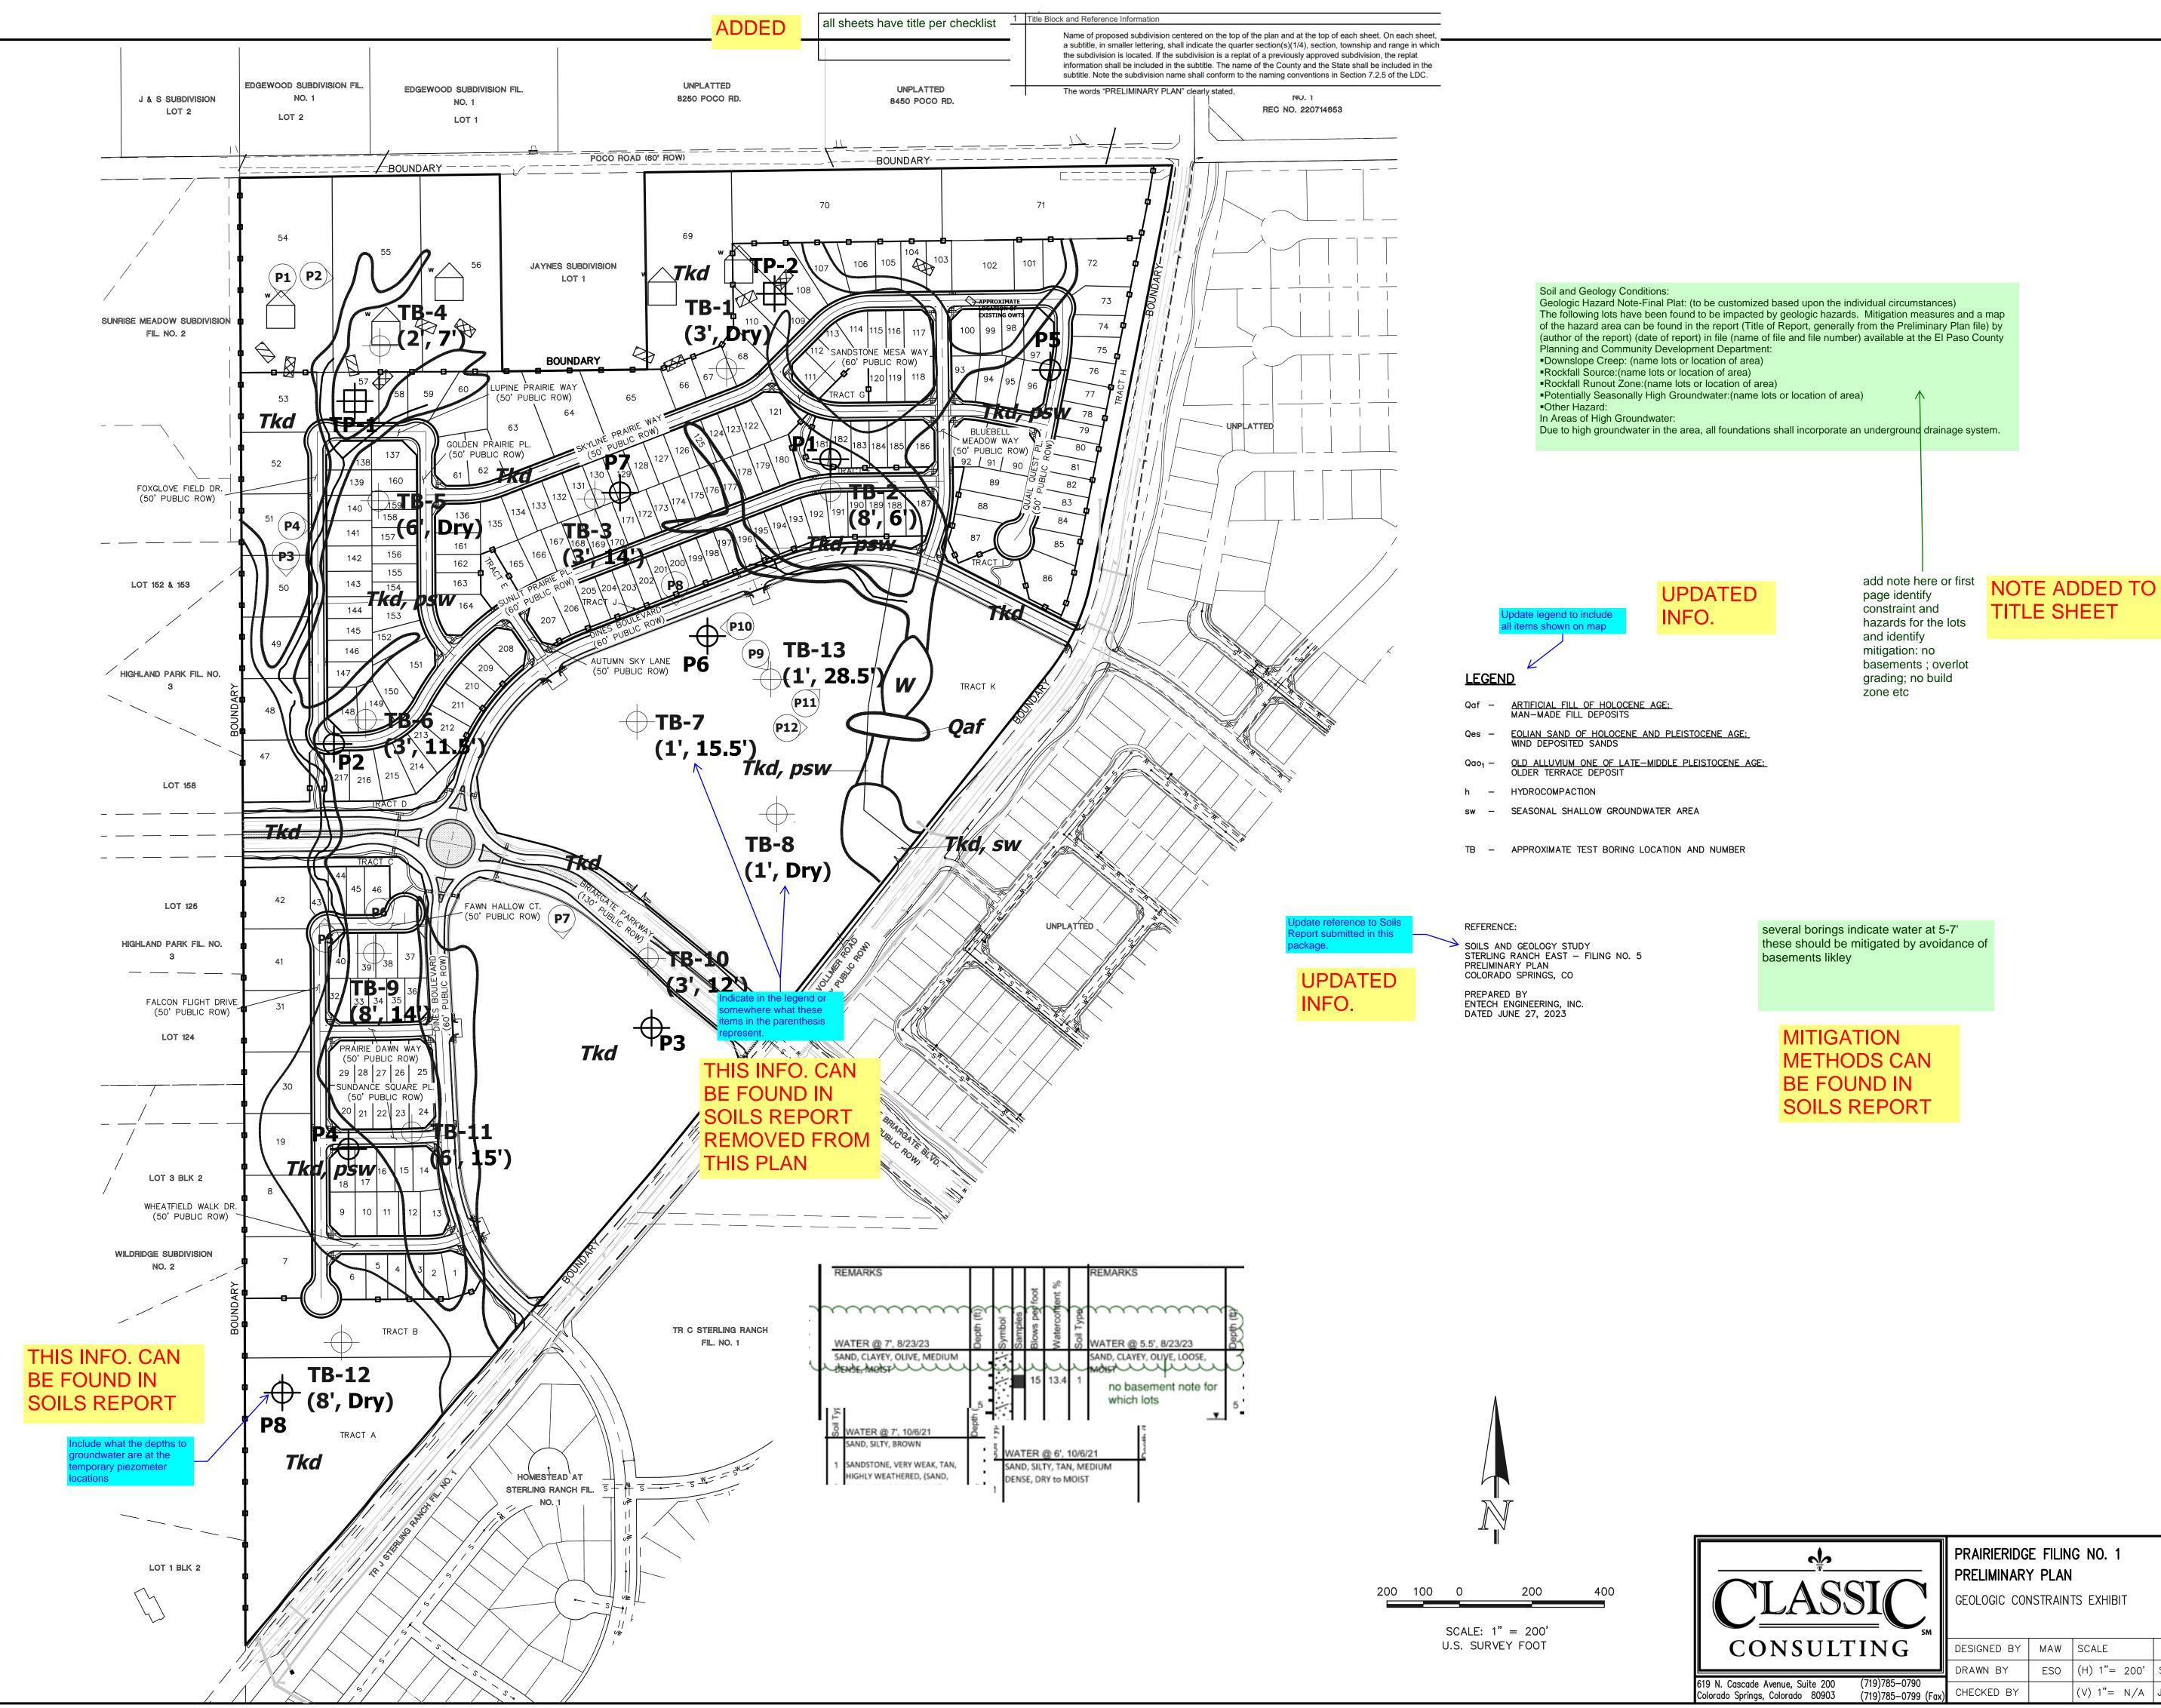

200	400
200'	

PRAIRIERIDGE FILING NO. 1 GEOLOGIC CONSTRAINTS EXHIBIT



SIVI					
	DESIGNED BY	MAW	SCALE	DATE	12/19/2023
	DRAWN BY	ESO	(H) 1"= 200'	SHEET 2	:8 OF 28
(Fax)	CHECKED BY		(V) 1"= N/A	JOB NO.	1305.10