WRITTEN DIMENSIONS ON THESE DRAWINGS SHALL HAVE PRECEDENCE OVER SCALED DIMENSIONS. THE ARCHITECT HAS DRAWN THESE PLANS TO COMPLY WITH THE OWNER / BUILDERS REQUESTS. THE CONTRACTOR / HOMEOWNER SHALL VERIFY ALL DIMENSIONS (INCL. R/O'S) AND CONDITIONS ON THE JOB. THE ARCHITECT SHALL BE CONSULTED FOR CLARIFICATION IF SITE CONDITIONS ARE ENCOUNTERED THAT ARE DIFFERENT THAN SHOWN, IF DISCREPANCIES ARE FOUND IN THE PLANS OR NOTES, OR IF A QUESTION ARISES OVER THE INTENT OF THE PLANS OR NOTES.

FOR ANY CHANGES MADE ON THE JOB NOT INCLUDED IN THESE PLANS; THE CONTRACTOR / HOMEOWNER SHALL NOTIFY ARCHITECT PRIOR TO CHANGES BEING MADE. CONTRACTOR OR HOMEOWNER ARE RESPONSIBLE FOR ANY CHANGES MADE.

MISCELLANEOUS NOTES:

- EACH BEDROOM TO HAVE A MINIMUM WINDOW OPENING OF 5.7 SQ. FT. WITH A MINIMUM WIDTH OF 20 IN. AND A SILL LESS THAN 44 IN. ABOVE FF.
- ALL GLAZING WITHIN 18 IN. OF FF. AND OR WITHIN 24 IN. OF ANY DOOR ARE TO HAVE SAFETY GLAZING. ALL GLAZING WITHIN 60 IN. OF TUB OR SHOWER FLOOR, 60 IN. OF A STAIR LANDING OR GREATER THAN 9 SQ. FT. SHALL HAVE SAFETY GLAZING.
- BATHROOMS, UTILITY ROOMS AND RANGE HOODS ARE TO BE VENTED TO THE OUTSIDE WITH A FAN CAPABLE OF PRODUCING A MINIMUM OF 5 AIR EXCHANGES PER HOUR.
- ATTIC VENTILATION SHALL BE A MINIMUM OF 1/150 OF ATTIC SQUARE FOOTAGE.
- ELECTRICAL RECEPTACLES OR CIRCUITS IN BATHROOMS, KITCHENS AND GARAGES SHALL BE G.F.C.I. PROTECTED PER NATIONAL ELECTRICAL CODE REQUIREMENTS
- ELECTRICAL RECEPTACLES OR CIRCUITS IN BEDROOMS SHALL BE A.F.C.I. PROTECTED PER NATIONAL ELECTRICAL CODE REQUIREMENTS.
- ALL LOCATIONS OF ELECTRICAL FIXTURES AND SWITCHES TO BE VERIFIED BY CONTRACTOR / HOMEOWNER.

NAILING GUIDELINES


HD HANGERS

ROOF, FLOOR & WALL SHEETING JOIST HANGERS

8d 6" O.C. ON EDGES 12" O.C. IN FIELD 1 ½" TECO NAIL OR EQUIV.
1 ½" MIN. SDS SCREWS

| WALL LOAD | 16 PSF |
|-------------------------|---------|
| ROOF DEAD LOAD | 15 PSF |
| ROOF LIVE LOAD | 20 PSF |
| ULTIMATE VIND VELOCISTY | 130 MPI |
| EXPOSURE | C |
| | |

| CODE ANALYSIS | |
|-------------------------------|----------|
| IRC | 2021 |
| OCCUPANCY | U |
| SNOW LOAD | |
| GROUND | 43 PSF |
| FLAT ROOF | 30 PSF |
| WIND SPEED | 130 MPH |
| EXPOSURE | C |
| CONCRETE COMPRESSIVE STRENGTH | 3500 PSI |
| STEEL REINFORCING | |
| YIELD STRENGTH | 60 KSI |

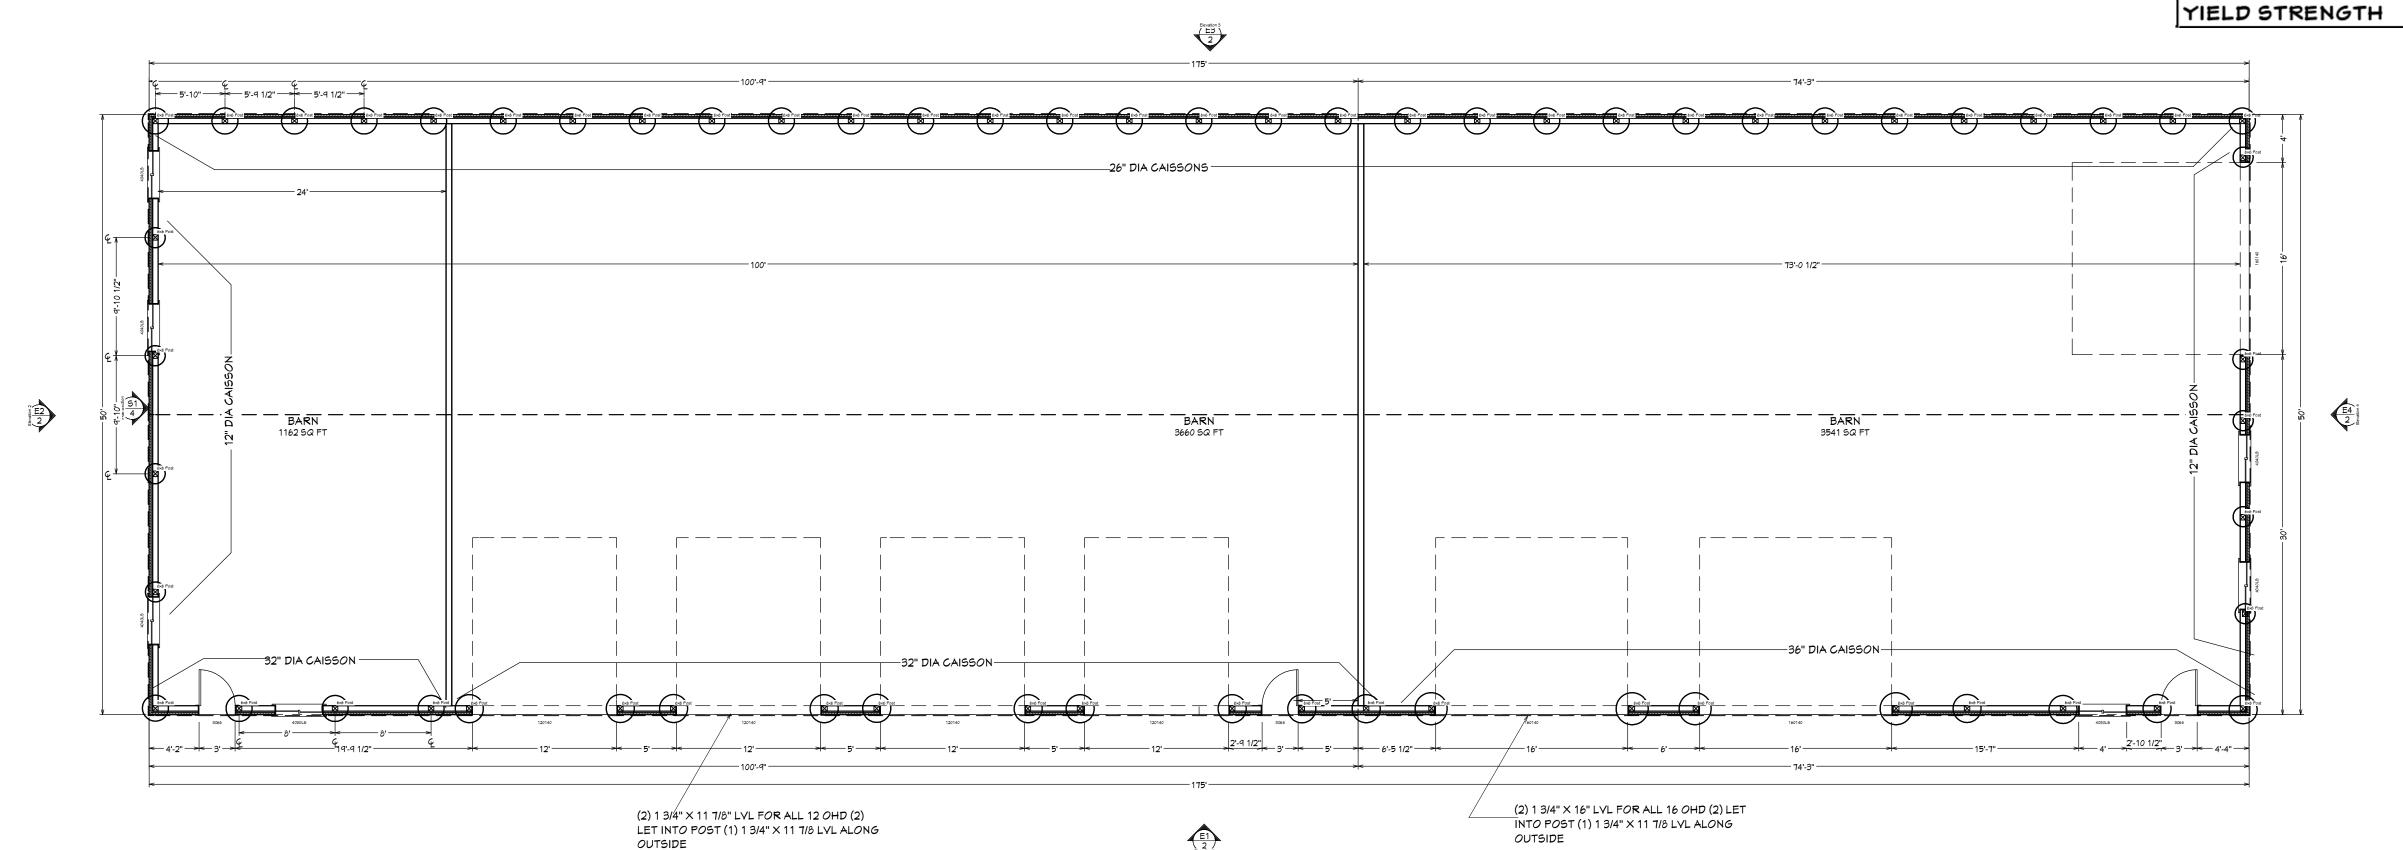



DL ENGINEERING, INC. 4100 M. JEMELL AVE SUITE 200 LAKEMOOD, CO 80232

DRAWING BY
LMER HORNER ARCHITECTURAL DRAFTII
8015 S. CULEBRA PEAK
LITTLETON, CO 80127
720-486-6120

THE HOMESTEAD GROUP INC.

2855 E. LAS VEGAS AVE

COLORADO SPRINGS, CO., 80906

DATE:


9/13/2023

DRAWN BY:

SHEET:

49552 EXP 10/31/23 NOEL S.

1 of 4

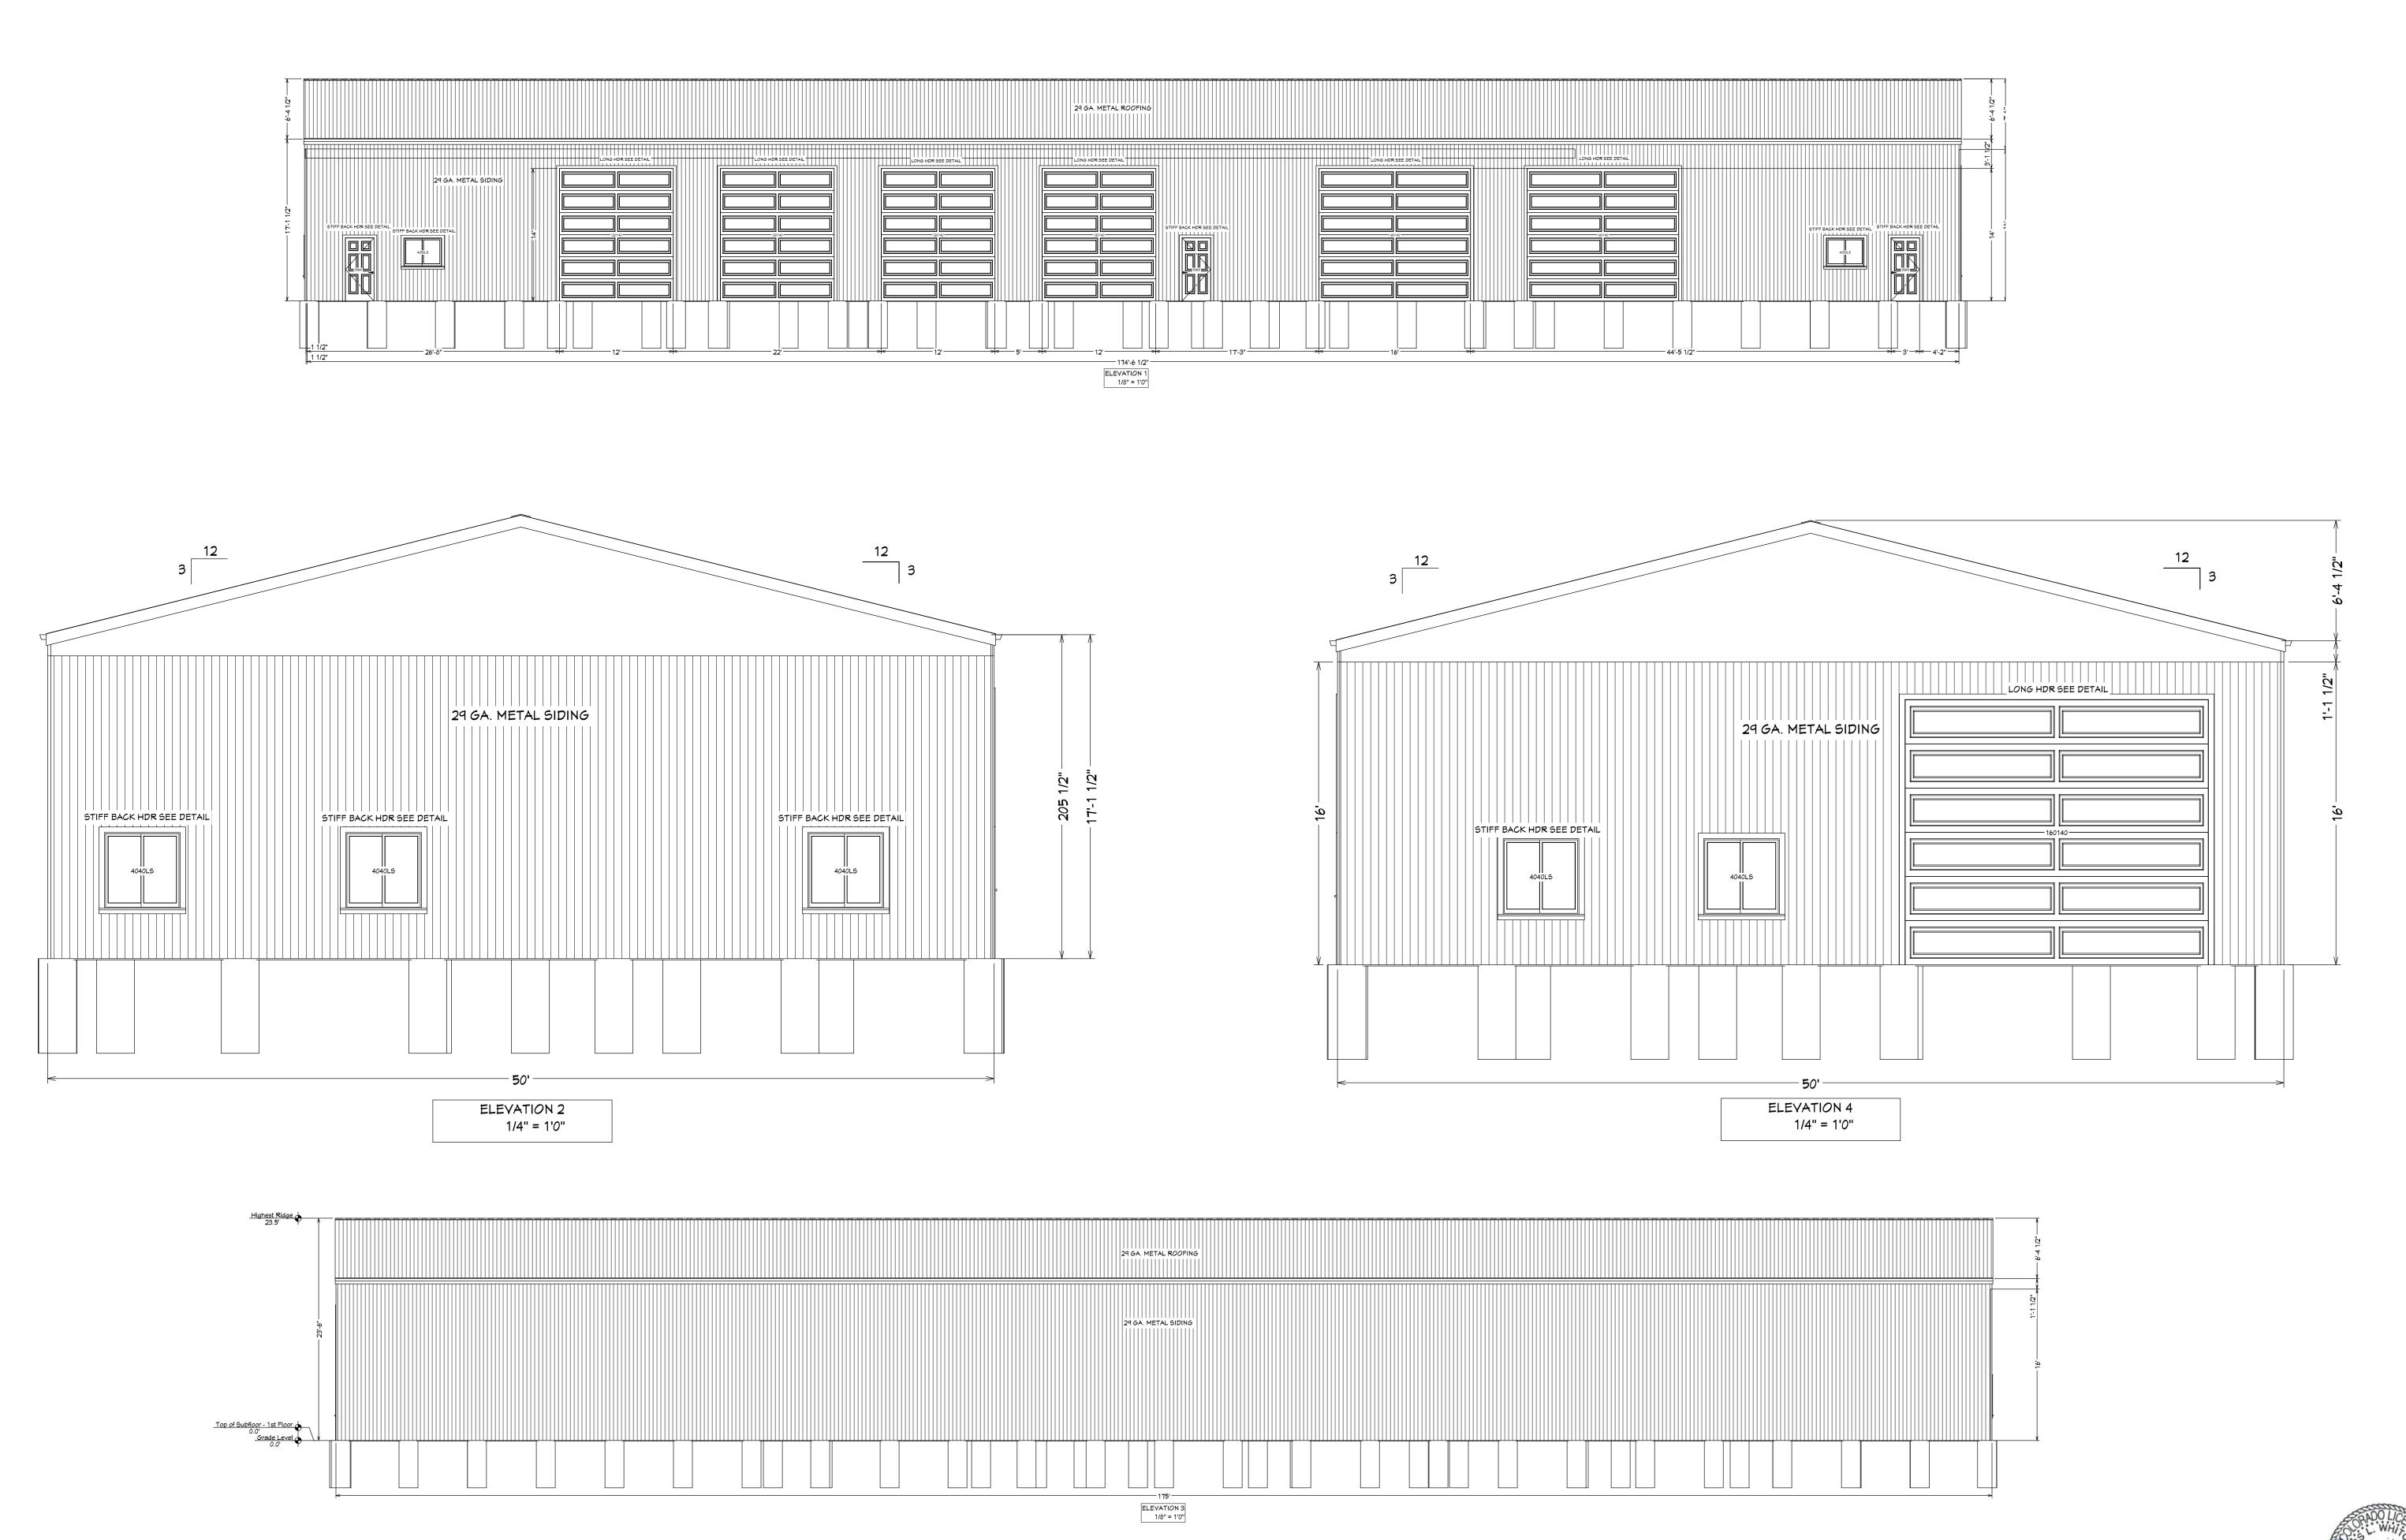



DATE:

9/13/2023

DRAWN BY:

NOEL S.

2 of 4

DRAWING BY
ELMER HORNER ARCHITECTURAL D
8015 S. CULEBRA PEAK
LITTLETON, CO 80127
720-486-6120

DL ENGINEERING, INC. 4100 M. JEMELL AVE SUITE 200 LAKEMOOD, CO 80232

 $_{=}$ PRE MFG TRUSSES 4' O.C. 2 imes 4 PURLINS 24" O.C.

- 4'-2" - 3' - 4' - 4' - 10'-3" - 2'-2 1/2"

PRE MFG TRUSSES 4' O.C. 2 X 4 PURLINS 24" O.C.

ROOF FRAMING PLAN 1/8" = 1'0"



DATE:

9/13/2023


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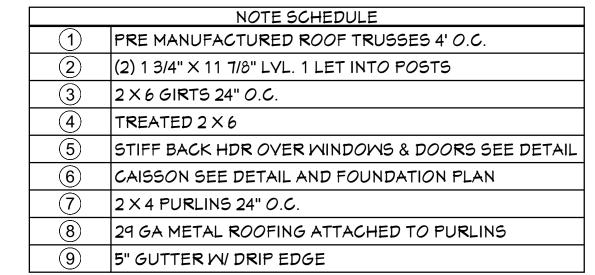
NOEL S.


3 of 4

DRAWING BY
R HORNER ARCHITECTURAL D
8015 S. CULEBRA PEAK
LITTLETON, CO 80127
720-486-6120


DL ENGINEERING, INC. 4100 M. JEMELL AVE SUITE 200 LAKEMOOD, CO 80232 80232 TING




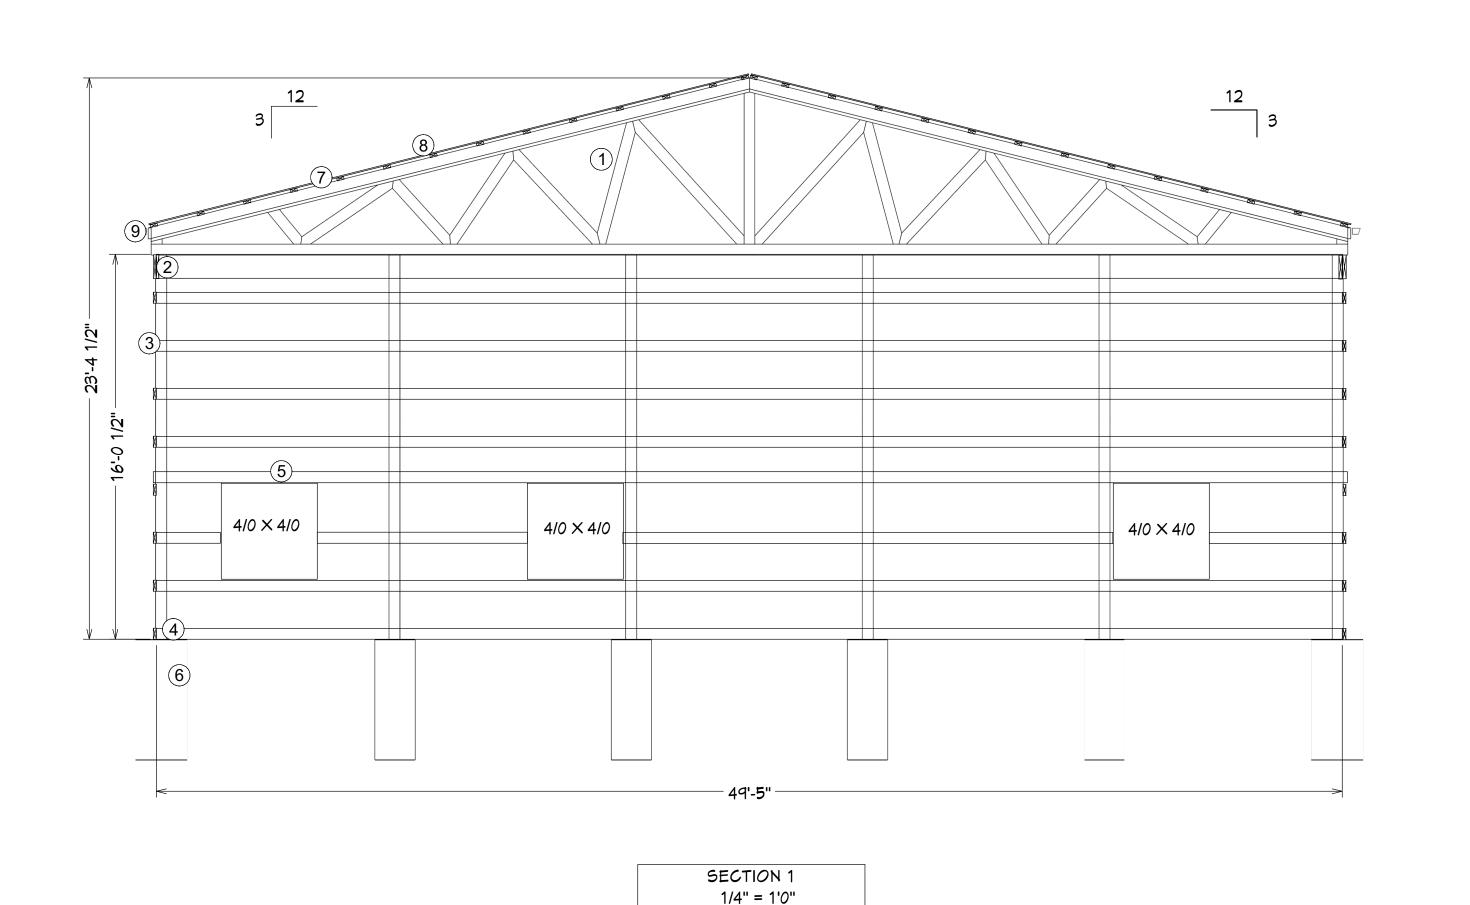


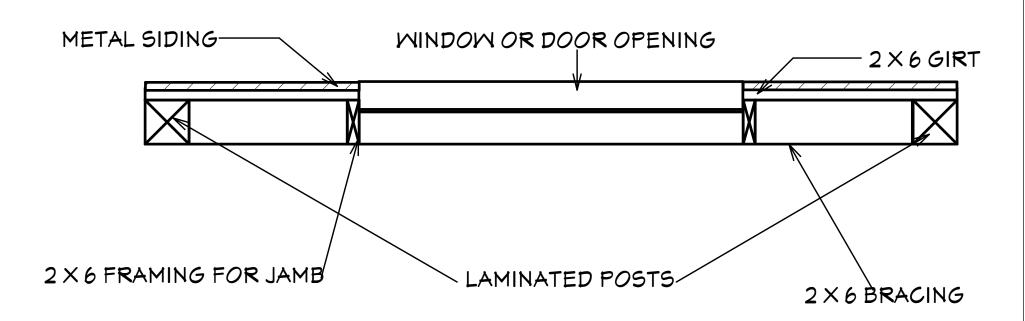



JAMB DETAIL 1" = 1'0"

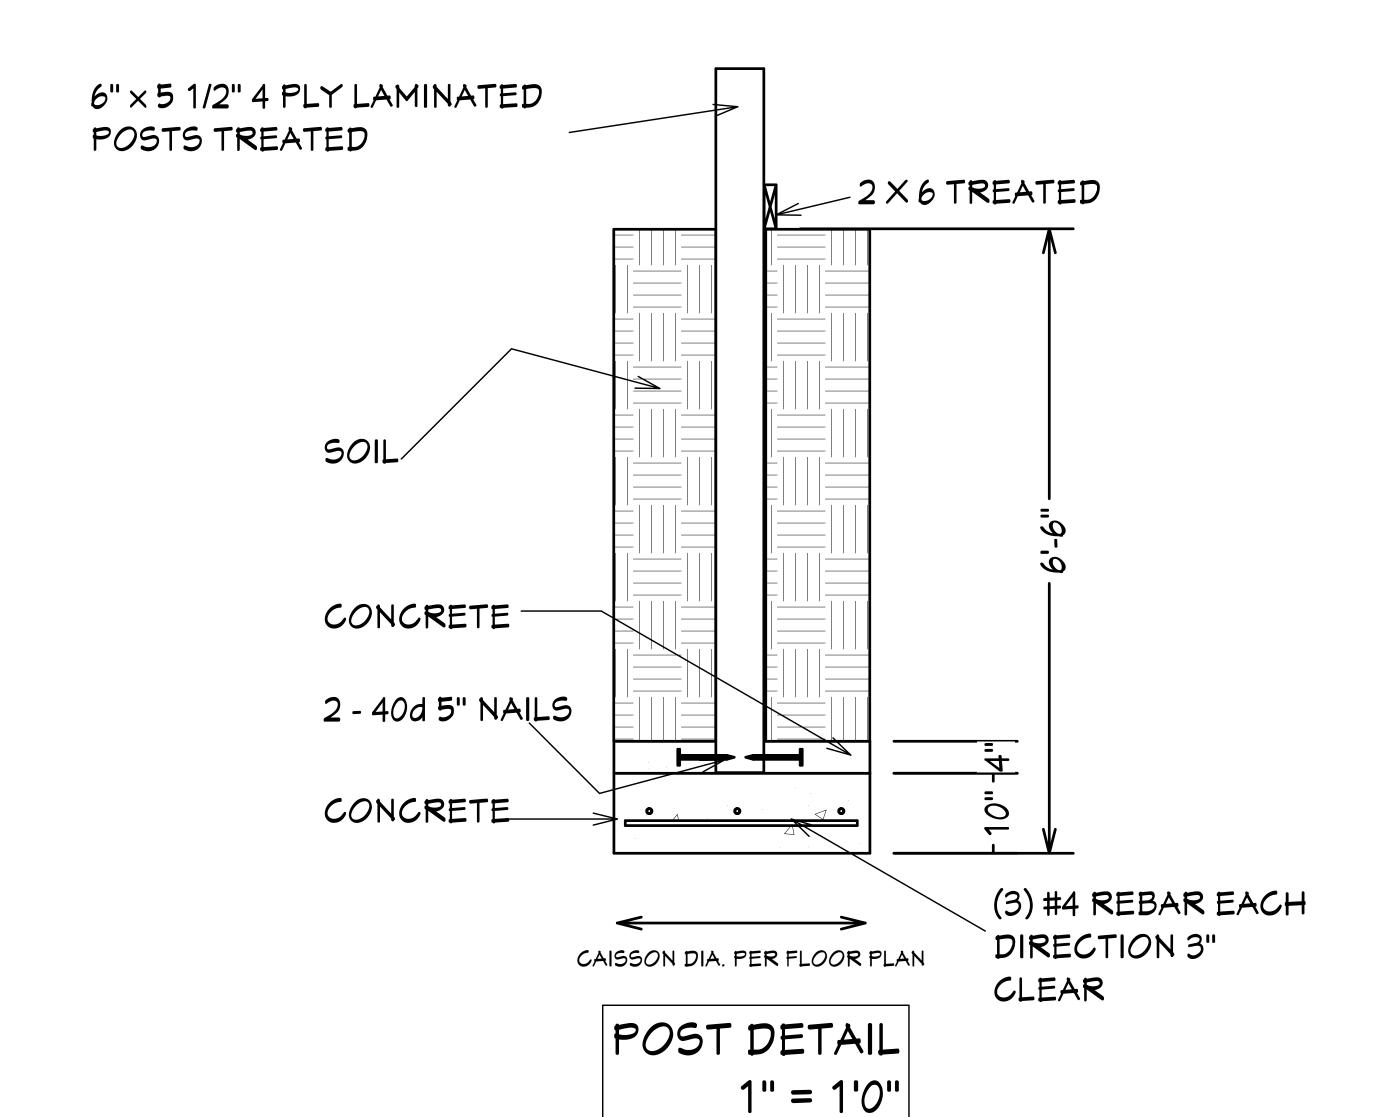

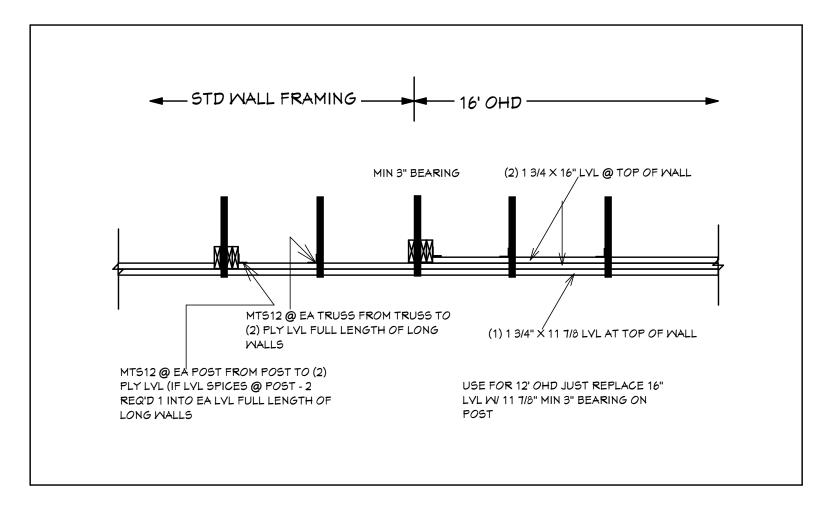

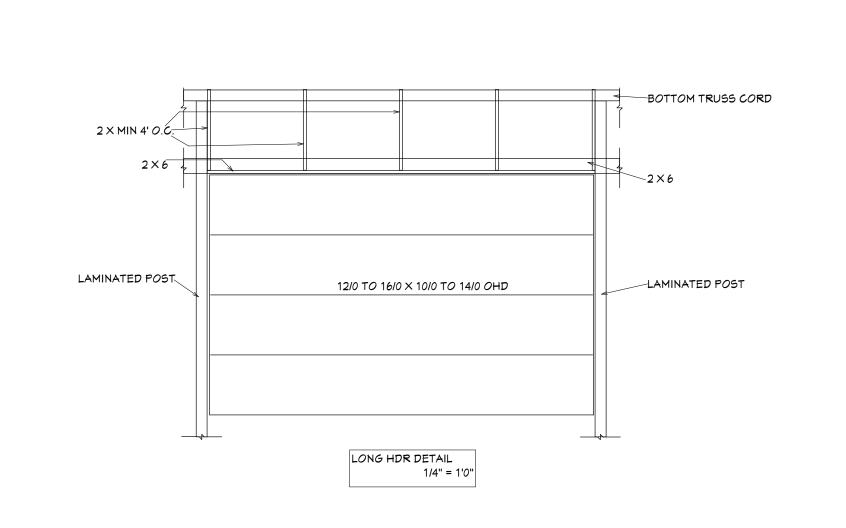

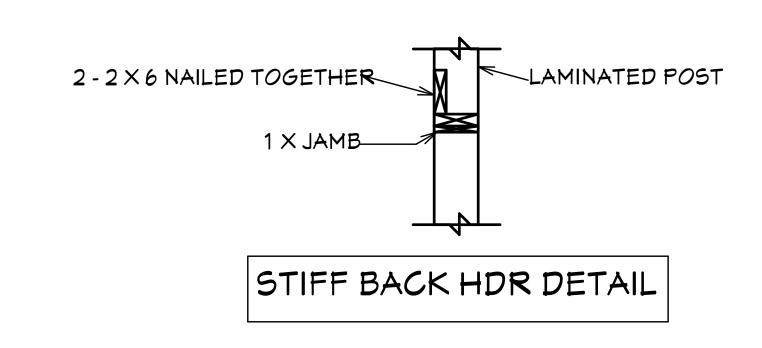

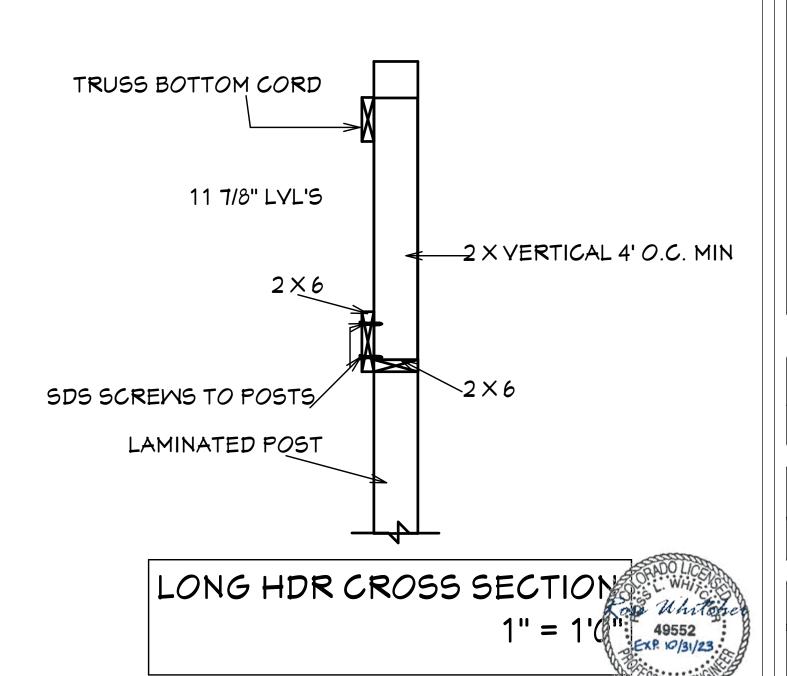

DL ENGINEERING, INC 4100 M. JEMELL AVE SUITE 200

DRAWING BY
MER HORNER ARCHITECTURAL DRAFT
8015 S. CULEBRA PEAK
LITTLETON, CO 80127

THE HOMESTEAD GROUP INC.

2855 E. LAS VEGAS AVE

DATE:

9/13/2023

DRAWN BY:

SHEET:

4 of 4