Call before you dig.

Know what's below.

INDEX OF SHEETS SHEET No. TITLE SHEET GN01 KEY MAP GN02 03 **GENERAL NOTES GRADING & EROSION CONTROL PLAN** 04-09 GEC01-GEC06 ECN01-ECN02 **DETAILS** 10-11

HAY CREEK VALLEY

EL PASO COUNTY, COLORADO

FINAL GRADING & EROSION CONTROL PLANS

SEPTEMBER 2023

EPC STORMWATER REVIEW COMMENTS IN ORANGE BOXES WITH BLACK TEXT

AGENCY CONTACT INFO

VIEW HOMES, INC. OWNER/DEVELOPER

> 555 MIDDLE CREEK PARKWAY, SUITE 500 COLORADO SPRINGS, CO 80921 TIM BUSCHAR, (719)-382-9433

CIVIL ENGINEER MATRIX DESIGN GROUP

> 2435 RESEARCH PARKWAY, SUITE 300 COLORADO SPRINGS, CO 80920

(719)-575-0100

MOUNTAIN VIEW ELECTRIC ASSOCIATION **ELECTRIC**

> 15706 JACKSON CREEK PARKWAY, SUITE 100 MONUMENT, CO 80132

GINA PERRY, (719) 494-2636

GAS **BLACK HILLS ENERGY**

105 S VICTORIA AVENUE **PUEBLO, CO 81003** (800) 303-0752

ENGINEERING EL PASO COUNTY PUBLIC WORKS DEPARTMENT

3275 AKERS DRIVE

COLORADO SPRINGS, CO 80922

(719) 520-6460

EL PASO COUNTY PUBLIC WORKS DEPARTMENT TRAFFIC

3275 AKERS DRIVE

COLORADO SPRINGS, CO 80922 (719) 520-6460

DRAINAGE EL PASO COUNTY PUBLIC WORKS DEPARTMENT

3275 AKERS DRIVE

COLORADO SPRINGS, CO 80922

(719) 520-6460


MONUMENT FIRE DISTRICT FIRE DEPARTMENT

16055 OLD FOREST POINT, SUITE 102 MONUMENT, CO 80132

(719)-484-0911



SITE MAP 1" = 500'

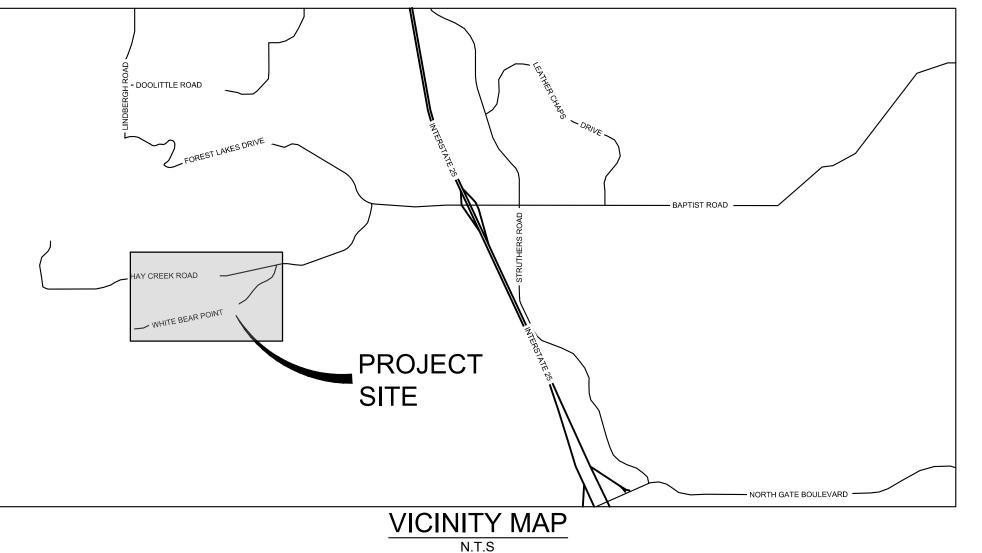

OWNER/DEVELOPER'S STATEMENT:

UNDERGROUND UTILITIES.

I, THE OWNER/DEVELOPER HAVE READ AND WILL COMPLY WITH THE REQUIREMENTS OF THE GRADING AND EROSION CONTROL PLAN.

UTILITIES ARE SHOWN IN AN APPROXIMATE WAY ONLY. THE

EXISTING UTILITIES BEFORE COMMENCING WORK. THE

CONTRACTOR SHALL DETERMINE THE EXACT LOCATION OF ALL

CONTRACTOR SHALL BE FULLY RESPONSIBLE FOR ANY AND ALL

LOCATE AND PRESERVE ANY AND ALL ABOVE GROUND AND

DAMAGES WHICH MIGHT BE CAUSED BY HIS FAILURE TO EXACTLY

TIM BUSCHAR, (719)-382-9433 VIEW HOMES, INC. 555 MIDDLE CREEK PARKWAY, SUITE 500 COLORADO SPRINGS, CO 80921

DESIGN ENGINEER'S STATEMENT

THIS GRADING AND EROSION CONTROL PLAN WAS PREPARED UNDER MY DIRECTION AND SUPERVISION AND IS CORRECT TO THE BEST OF MY KNOWLEDGE AND BELIEF. SAID PLAN HAS BEEN PREPARED ACCORDING TO THE CRITERIA ESTABLISHED BY THE COUNTY FOR GRADING AND EROSION CONTROL PLANS. I ACCEPT RESPONSIBILITY FOR ANY LIABILITY CAUSED BY ANY NEGLIGENT ACTS, ERRORS OR OMISSIONS ON MY PART IN PREPARING THIS PLAN.

DATE:

JEFFREY A. ODOR, PE #39265 FOR AND ON BEHALF OF MATRIX DESIGN GROUP, INC.

EL PASO COUNTY:

COUNTY PLAN REVIEW IS PROVIDED ONLY FOR GENERAL CONFORMANCE WITH COUNTY DESIGN CRITERIA. THE COUNTY IS NOT RESPONSIBLE FOR THE ACCURACY AND ADEQUACY OF THE DESIGN, DIMENSIONS, AND/OR ELEVATIONS WHICH SHALL BE CONFIRMED AT THE JOB SITE. THE COUNTY THROUGH THE APPROVAL OF THIS DOCUMENT ASSUMES NO RESPONSIBILITY FOR COMPLETENESS AND/OR ACCURACY OF THIS DOCUMENT.

FILED IN ACCORDANCE WITH THE REQUIREMENTS OF THE EL PASO COUNTY LAND DEVELOPMENT CODE, DRAINAGE CRITERIA MANUAL VOLUMES 1 AND 2, AND ENGINEERING CRITERIA MANUAL, AS AMENDED.

IN ACCORDANCE WITH ECM SECTION 1.12, THESE CONSTRUCTION DOCUMENTS WILL BE VALID FOR CONSTRUCTION FOR A PERIOD OF 2 YEARS FROM THE DATE SIGNED BY THE EL PASO COUNTY ENGINEER. IF CONSTRUCTION HAS NOT STARTED WITHIN THOSE 2 YEARS, THE PLANS WILL NEED TO BE RESUBMITTED FOR APPROVAL, INCLUDING PAYMENT OF REVIEW FEES AT THE PLANNING AND COMMUNITY DEVELOPMENT DIRECTOR'S DISCRETION.

JOSHUA PALMER, P.E. COUNTY ENGINEER / ECM ADMINISTRATOR

ADDRESSED

EPC's EDARP File Number: SF2324

REFERENCE DRAWINGS					S
X-TITLE-CD X-886-PR-SITE FEMA_XS X-886.066-EX-MAP-1 164022-01 Hay Creek Road BNI X-886-ALTA-SURVEY Hay Creek BFEs	No.	DATE	DESCRIPTION	BY	
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SHEET KEY

PROJECT ELEVATIONS ARE NAVD 88 ELEVATIONS BASED ON AN OPUS DERIVED ELEVATION ON CONTROL POINT 10, A NO. 5 REBAR HAVING AN ELEVATION OF 5769.92.

THE SOUTH LINE OF THE NORTHWEST QUARTER OF SECTION 22, TOWNSHIP 15 SOUTH, RANGE 65 WEST OF THE 6TH PRINCIPAL MERIDIAN, COUNTY OF EL PASO, STATE OF COLORADO, BEING MONUMENTED ON THE EASTERLY END BY A 2-12" ALUMINUM CAP STAMPED "NOLTE PLS25955 C1/4 S22 T15S, R65W 1999, "AND THE WESTERLY END BY A2-1/2" ALUMINUM CAP STAMPED "SSS PLS 16154 1/4 S21 S22 T15S, R65W 2000, "BEING ASSUMED TO BEAR S89°54'42"W, A DISTANCE OF 2,627.78 FEET.

Excellence by Design

PRELIMINARY THIS DRAWING HAS NOT BEEN APPROVED BY GOVERNING AGENCIES AND IS SUBJECT TO CHANGE


HAY CREEK VALLEY

EL PASO COUNTY, COLORADO FINAL GRADING & EROSION CONTROL PLANS

SCALE SEPTEMBER 2023 DRAWING No. DESIGNED BY: DATE ISSUED: CVW HORIZ. DRAWN BY: TS01 01 OF 11 PROJECT No. 22.886.076 CHECKED BY:

TITLE SHEET

FOR AND ON BEHALF OF MATRIX DESIGN GROUP, INC.

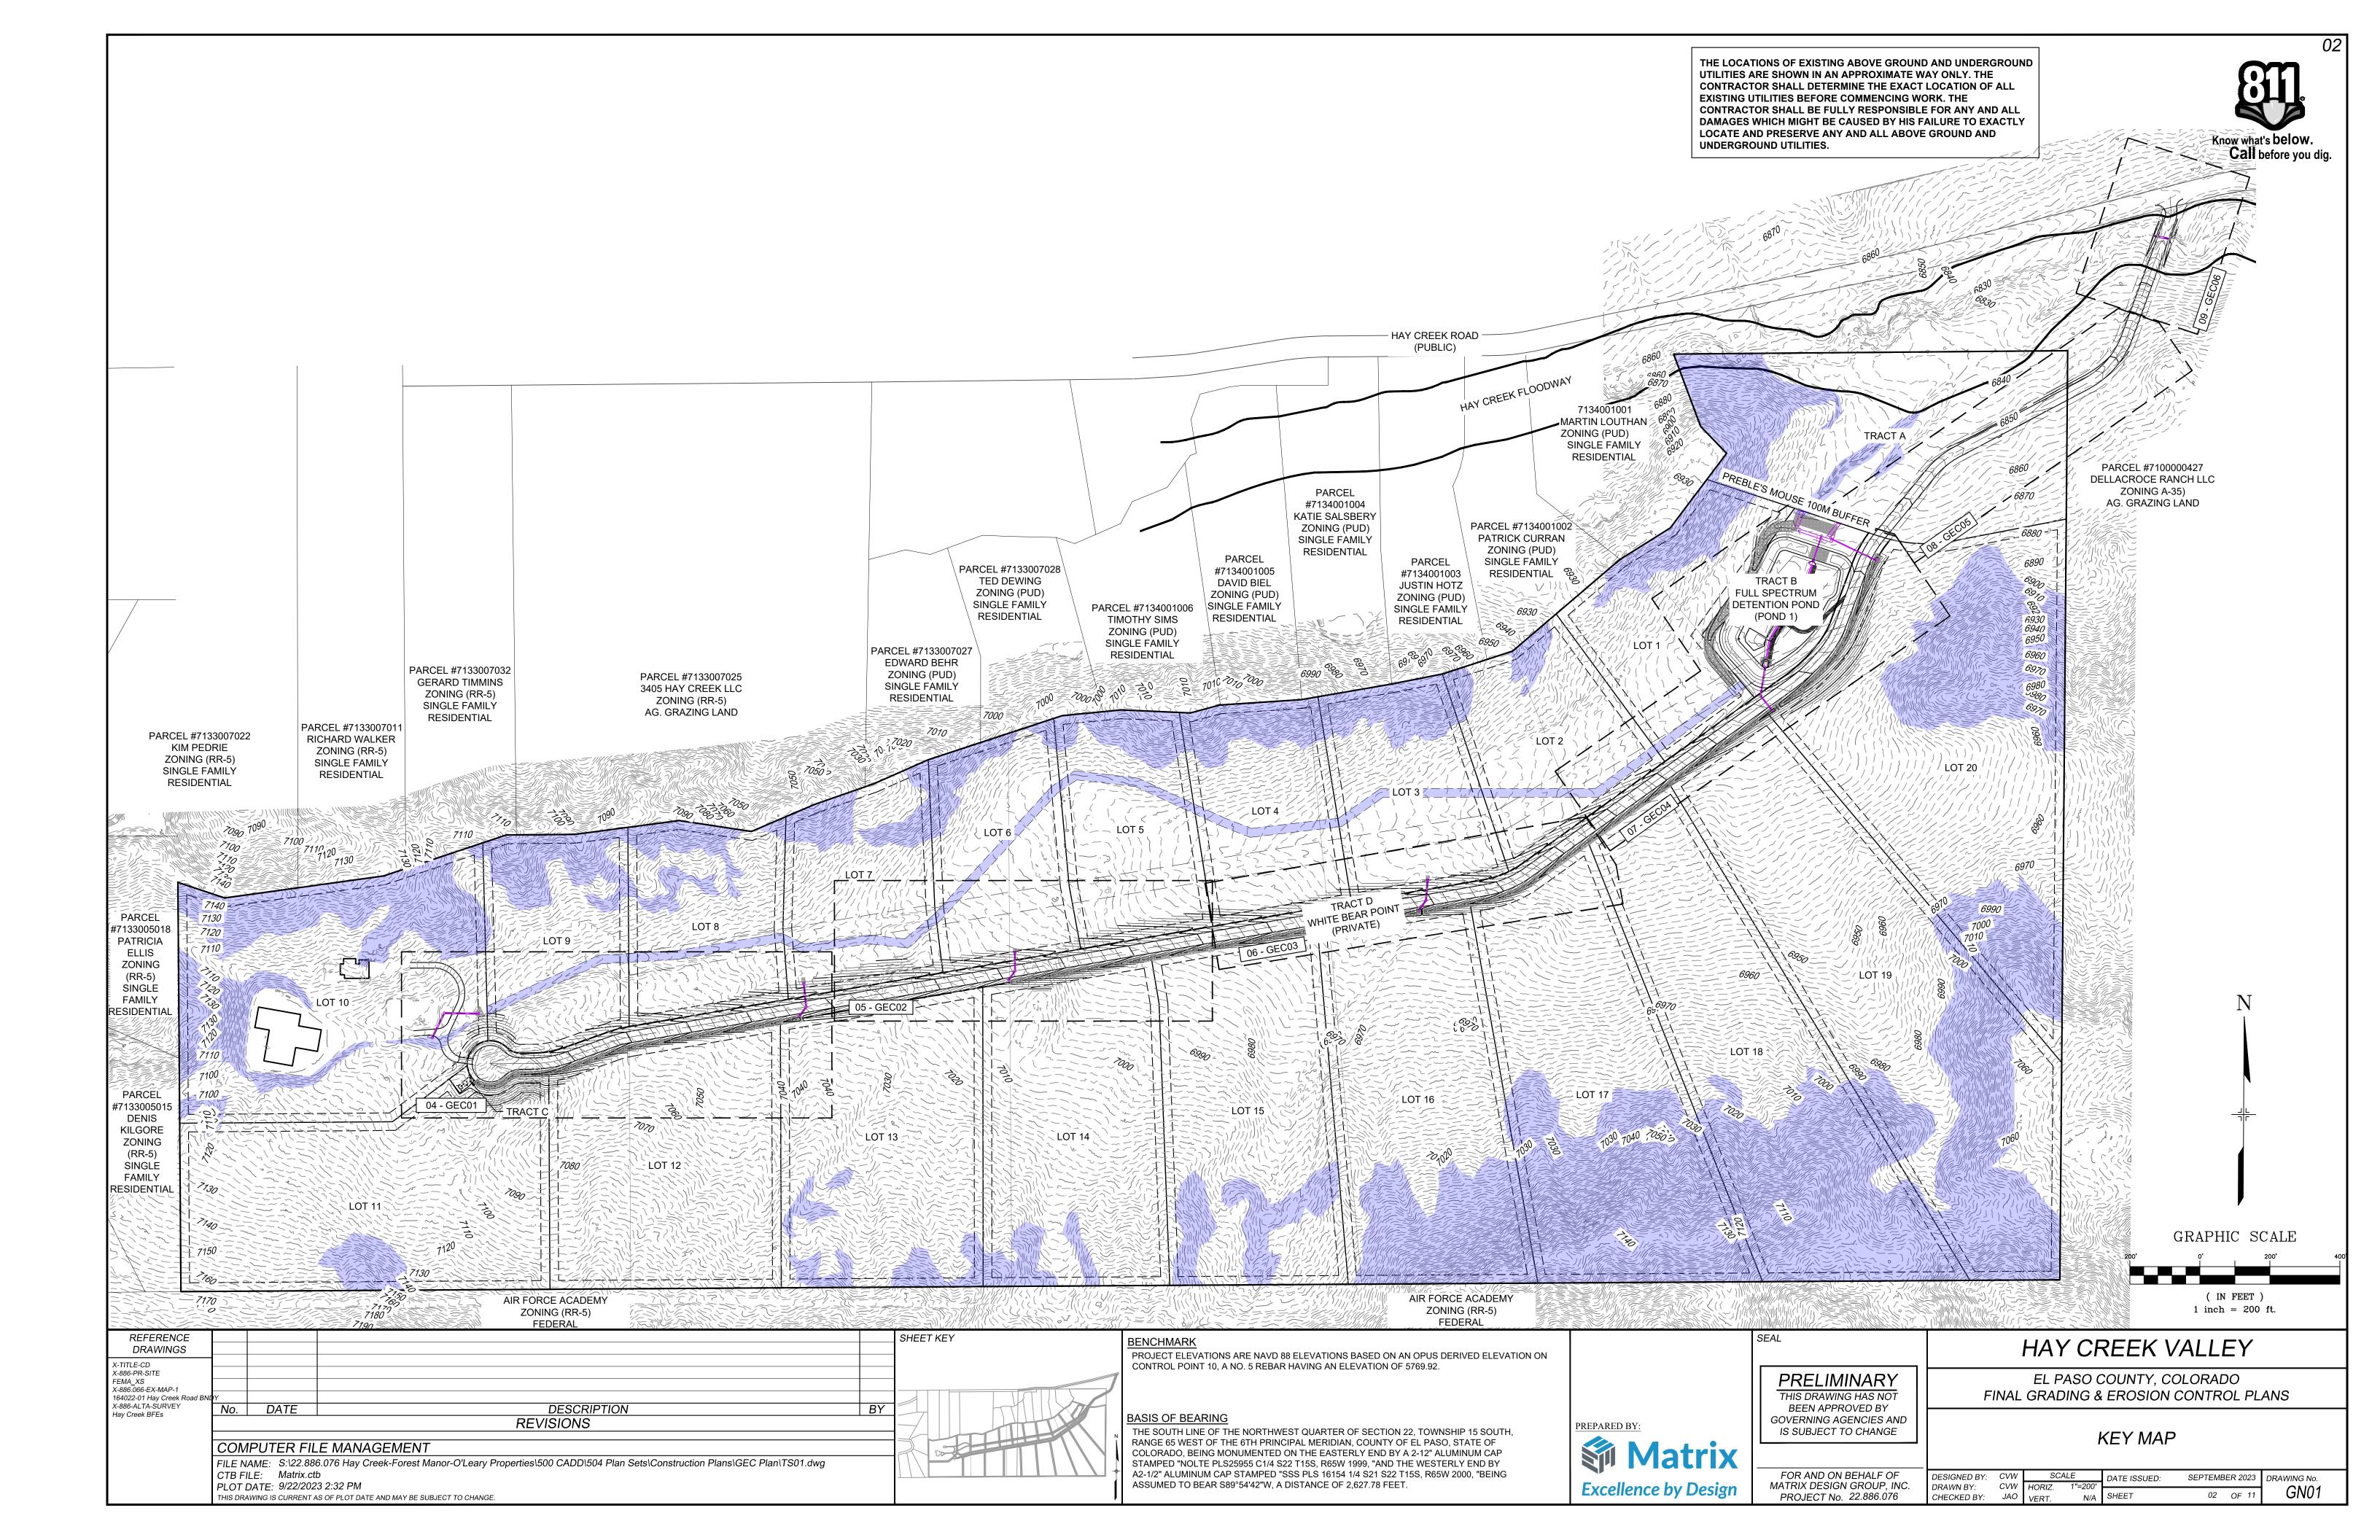

- NOTWITHSTANDING ANYTHING DEPICTED IN THESE PLANS IN WORDS OR GRAPHIC REPRESENTATION, ALL DESIGN AND CONSTRUCTION RELATED TO ROADS, STORM DRAINAGE AND EROSION CONTROL SHALL CONFORM TO THE STANDARDS AND REQUIREMENTS OF THE MOST RECENT VERSION OF THE RELEVANT ADOPTED EL PASO COUNTY 13. CONCRETE WASH WATER SHALL BE CONTAINED AND DISPOSED OF IN STANDARDS, INCLUDING THE LAND DEVELOPMENT CODE, THE ENGINEERING CRITERIA MANUAL. THE DRAINAGE CRITERIA MANUAL AND THE DRAINAGE CRITERIA MANUAL VOLUME 2. ANY DEVIATIONS FROM REGULATIONS AND STANDARDS MUST BE REQUESTED, AND APPROVED. IN WRITING.
- A SEPARATE STORMWATER MANAGEMENT PLAN (SMWP) FOR THIS QUALITY CONTROL PERMIT (ESQCP) ISSUED PRIOR TO COMMENCING CONSTRUCTION. MANAGEMENT OF THE SWMP DURING CONSTRUCTION IS THE RESPONSIBILITY OF THE DESIGNATED QUALIFIED STORMWATER MANAGER OR CERTIFIED EROSION CONTROL INSPECTOR. THE SWMP SHALL BE LOCATED ON SITE AT ALL TIMES DURING CONSTRUCTION 15. EROSION CONTROL BLANKETING OR OTHER PROTECTIVE COVERING AND SHALL BE KEPT UP TO DATE WITH WORK PROGRESS AND CHANGES IN THE FIELD.
- ONCE THE ESQCP IS APPROVED AND A "NOTICE TO PROCEED" HAS BEEN ISSUED, THE CONTRACTOR MAY INSTALL THE INITIAL STAGE EROSION AND SEDIMENT CONTROL MEASURES AS INDICATED ON THE APPROVED GEC. A PRECONSTRUCTION MEETING BETWEEN THE CONTRACTOR, ENGINEER, AND EL PASO COUNTY WILL BE HELD PRIOR TO ANY CONSTRUCTION. IT IS THE RESPONSIBILITY OF THE APPLICANT TO COORDINATE THE MEETING TIME AND PLACE WITH COUNTY STAFF.
- CONTROL MEASURES MUST BE INSTALLED PRIOR TO COMMENCEMENT OF ACTIVITIES THAT COULD CONTRIBUTE POLLUTANTS TO STORMWATER. CONTROL MEASURES FOR ALL SLOPES, CHANNELS, DITCHES, AND DISTURBED LAND AREAS SHALL BE INSTALLED IMMEDIATELY UPON COMPLETION OF THE DISTURBANCE.
- ALL TEMPORARY SEDIMENT AND EROSION CONTROL MEASURES SHALL BE MAINTAINED AND REMAIN IN EFFECTIVE OPERATING CONDITION UNTIL PERMANENT SOIL EROSION CONTROL MEASURES ARE IMPLEMENTED AND FINAL STABILIZATION IS ESTABLISHED. ALL 19. THE OWNER/DEVELOPER SHALL BE RESPONSIBLE FOR THE REMOVAL PERSONS ENGAGED IN LAND DISTURBANCE ACTIVITIES SHALL ASSESS THE ADEQUACY OF CONTROL MEASURES AT THE SITE AND IDENTIFY IF CHANGES TO THOSE CONTROL MEASURES ARE NEEDED TO ENSURE THE CONTINUED EFFECTIVE PERFORMANCE OF THE CONTROL MEASURES. ALL CHANGES TO TEMPORARY SEDIMENT AND EROSION CONTROL MEASURES MUST BE INCORPORATED INTO THE 20. THE QUANTITY OF MATERIALS STORED ON THE PROJECT SITE SHALL BE STORMWATER MANAGEMENT PLAN.
- TEMPORARY STABILIZATION SHALL BE IMPLEMENTED ON DISTURBED AREAS AND STOCKPILES WHERE GROUND DISTURBING CONSTRUCTION ACTIVITY HAS PERMANENTLY CEASED OR TEMPORARILY CEASED FOR LONGER THAN 14 DAYS.
- FINAL STABILIZATION MUST BE IMPLEMENTED AT ALL APPLICABLE CONSTRUCTION SITES. FINAL STABILIZATION IS ACHIEVED WHEN ALL GROUND DISTURBING ACTIVITIES ARE COMPLETE AND ALL DISTURBED AREAS EITHER HAVE A UNIFORM VEGETATIVE COVER WITH INDIVIDUAL PLANT DENSITY OF 70 PERCENT OF PRE-DISTURBANCE LEVELS ESTABLISHED OR EQUIVALENT PERMANENT ALTERNATIVE STABILIZATION METHOD IS IMPLEMENTED. ALL TEMPORARY SEDIMENT 22. BULK STORAGE OF ALLOWED PETROLEUM PRODUCTS OR OTHER AND EROSION CONTROL MEASURES SHALL BE REMOVED UPON FINAL STABILIZATION AND BEFORE PERMIT CLOSURE.
- ALL PERMANENT STORMWATER MANAGEMENT FACILITIES SHALL BE INSTALLED AS DESIGNED IN THE APPROVED PLANS. ANY PROPOSED CHANGES THAT EFFECT THE DESIGN OR FUNCTION OF PERMANENT STORMWATER MANAGEMENT STRUCTURES MUST BE APPROVED BY 23. NO PERSON SHALL CAUSE THE IMPEDIMENT OF STORMWATER FLOW IN THE ECM ADMINISTRATOR PRIOR TO IMPLEMENTATION.
- 10. EARTH DISTURBANCES SHALL BE CONDUCTED IN SUCH A MANNER SO RESULTING SEDIMENTATION. ALL DISTURBANCES SHALL BE DESIGNED, CONSTRUCTED, AND COMPLETED SO THAT THE EXPOSED AREA OF ANY DISTURBED LAND SHALL BE LIMITED TO THE SHORTEST PRACTICAL PERIOD OF TIME. PRE-EXISTING VEGETATION SHALL BE PROTECTED AND MAINTAINED WITHIN 50 HORIZONTAL FEET OF A WATERS OF THE STATE UNLESS SHOWN TO BE INFEASIBLE AND SPECIFICALLY REQUESTED AND APPROVED.
- 11. COMPACTION OF SOIL MUST BE PREVENTED IN AREAS DESIGNATED FOR INFILTRATION CONTROL MEASURES OR WHERE FINAL STABILIZATION WILL BE ACHIEVED BY VEGETATIVE COVER. AREAS

COMPUTER FILE MANAGEMENT

No. DATE

REFERENCE

DRAWINGS

164022-01 Hay Creek Road Bl X-886-ALTA-SURVEY

X-TITLE-CD

EMA XS X-886.066-EX-MAP-1

X-886-PR-SITE

Hay Creek BFEs

PROTECTED FROM SEDIMENTATION DURING CONSTRUCTION UNTIL FINAL STABILIZATION IS ACHIEVED. IF COMPACTION PREVENTION IS FOR INFILTRATION AND VEGETATION CONTROL MEASURES MUST BE LOOSENED PRIOR TO INSTALLATION OF THE CONTROL MEASURE(S).

- CONSTRUCTED FOR THE CONVEYANCE OF STORMWATER AROUND, THROUGH, OR FROM THE EARTH DISTURBANCE AREA SHALL BE A STABILIZED CONVEYANCE DESIGNED TO MINIMIZE EROSION AND THE 28. THE SOILS REPORT FOR THIS SITE HAS BEEN PREPARED BY CTL DISCHARGE OF SEDIMENT OFF SITE.
- ACCORDANCE WITH THE SWMP. NO WASH WATER SHALL BE 29. AT LEAST TEN (10) DAYS PRIOR TO THE ANTICIPATED START OF DISCHARGED TO OR ALLOWED TO ENTER STATE WATERS, INCLUDING ANY SURFACE OR SUBSURFACE STORM DRAINAGE SYSTEM OR FACILITIES. CONCRETE WASHOUTS SHALL NOT BE LOCATED IN AN AREA WHERE SHALLOW GROUNDWATER MAY BE PRESENT, OR WITHIN 50 FEET OF A SURFACE WATER BODY, CREEK OR STREAM.
- PROJECT SHALL BE COMPLETED AND AN EROSION AND STORMWATER 14. DURING DEWATERING OPERATIONS OF UNCONTAMINATED GROUND WATER MAY BE DISCHARGED ON SITE, BUT SHALL NOT LEAVE THE SITE IN THE FORM OF SURFACE RUNOFF UNLESS AN APPROVED STATE DEWATERING PERMIT IS IN PLACE.
 - SHALL BE USED ON SLOPES STEEPER THAN 3:1.
 - 16. CONTRACTOR SHALL BE RESPONSIBLE FOR THE REMOVAL OF ALL WASTES FROM THE CONSTRUCTION SITE FOR DISPOSAL IN ACCORDANCE WITH LOCAL AND STATE REGULATORY REQUIREMENTS. NO CONSTRUCTION DEBRIS, TREE SLASH, BUILDING MATERIAL WASTES OR UNUSED BUILDING MATERIALS SHALL BE BURIED, DUMPED, OR DISCHARGED AT THE SITE.
 - 17. WASTE MATERIALS SHALL NOT BE TEMPORARILY PLACED OR STORED IN THE STREET, ALLEY, OR OTHER PUBLIC WAY, UNLESS IN ACCORDANCE WITH AN APPROVED TRAFFIC CONTROL PLAN. CONTROL MEASURES MAY BE REQUIRED BY EL PASO COUNTY ENGINEERING IF DEEMED NECESSARY, BASED ON SPECIFIC CONDITIONS AND CIRCUMSTANCES.
 - 18. TRACKING OF SOILS AND CONSTRUCTION DEBRIS OFF-SITE SHALL BE MINIMIZED. MATERIALS TRACKED OFF-SITE SHALL BE CLEANED UP AND PROPERLY DISPOSED OF IMMEDIATELY.
 - OF ALL CONSTRUCTION DEBRIS, DIRT, TRASH, ROCK, SEDIMENT, SOIL, AND SAND THAT MAY ACCUMULATE IN ROADS, STORM DRAINS AND OTHER DRAINAGE CONVEYANCE SYSTEMS AND STORMWATER APPURTENANCES AS A RESULT OF SITE DEVELOPMENT.
 - LIMITED, AS MUCH AS PRACTICAL, TO THAT QUANTITY REQUIRED TO PERFORM THE WORK IN AN ORDERLY SEQUENCE. ALL MATERIALS STORED ON-SITE SHALL BE STORED IN A NEAT, ORDERLY MANNER, IN THEIR ORIGINAL CONTAINERS, WITH ORIGINAL MANUFACTURER'S
 - 21. NO CHEMICAL(S) HAVING THE POTENTIAL TO BE RELEASED IN STORMWATER ARE TO BE STORED OR USED ONSITE UNLESS PERMISSION FOR THE USE OF SUCH CHEMICAL(S) IS GRANTED IN WRITING BY THE ECM ADMINISTRATOR. IN GRANTING APPROVAL FOR THE USE OF SUCH CHEMICAL(S), SPECIAL CONDITIONS AND MONITORING MAY BE REQUIRED.
 - ALLOWED LIQUID CHEMICALS IN EXCESS OF 55 GALLONS SHALL REQUIRE ADEQUATE SECONDARY CONTAINMENT PROTECTION TO CONTAIN ALL SPILLS ONSITE AND TO PREVENT ANY SPILLED MATERIALS FROM ENTERING STATE WATERS, ANY SURFACE OR SUBSURFACE STORM DRAINAGE SYSTEM OR OTHER FACILITIES.
 - THE CURB AND GUTTER OR DITCH EXCEPT WITH APPROVED SEDIMENT CONTROL MEASURES.
- AS TO EFFECTIVELY MINIMIZE ACCELERATED SOIL EROSION AND 24. OWNER/DEVELOPER AND THEIR AGENTS SHALL COMPLY WITH THE "COLORADO WATER QUALITY CONTROL ACT" (TITLE 25, ARTICLE 8, CRS), AND THE "CLEAN WATER ACT" (33 USC 1344), IN ADDITION TO THE REQUIREMENTS OF THE LAND DEVELOPMENT CODE, DCM VOLUME II AND THE ECM APPENDIX I. ALL APPROPRIATE PERMITS MUST BE OBTAINED BY THE CONTRACTOR PRIOR TO CONSTRUCTION (1041, NPDES, FLOODPLAIN, 404, FUGITIVE DUST, ETC.). IN THE EVENT OF CONFLICTS BETWEEN THESE REQUIREMENTS AND OTHER LAWS. RULES, OR REGULATIONS OF OTHER FEDERAL, STATE, LOCAL, OR COUNTY AGENCIES, THE MOST RESTRICTIVE LAWS, RULES, OR REGULATIONS SHALL APPLY.

DESIGNATED FOR INFILTRATION CONTROL MEASURES SHALL ALSO BE 25. ALL CONSTRUCTION TRAFFIC MUST ENTER/EXIT THE SITE ONLY AT APPROVED CONSTRUCTION ACCESS POINTS

NOT FEASIBLE DUE TO SITE CONSTRAINTS, ALL AREAS DESIGNATED 26. PRIOR TO CONSTRUCTION THE PERMITTEE SHALL VERIFY THE LOCATION OF EXISTING UTILITIES.

> 27. A WATER SOURCE SHALL BE AVAILABLE ON SITE DURING EARTHWORK 2. OPERATIONS AND SHALL BE UTILIZED AS REQUIRED TO MINIMIZE DUST FROM EARTHWORK EQUIPMENT AND WIND.

THOMPSON, DATED SEPTEMBER 19, 2023, AND SHALL BE CONSIDERED A PART OF THESE PLANS.

CONSTRUCTION, FOR PROJECTS THAT WILL DISTURB ONE (1) ACRE OR MORE, THE OWNER OR OPERATOR OF CONSTRUCTION ACTIVITY SHALL SUBMIT A PERMIT APPLICATION FOR STORMWATER DISCHARGE TO THE COLORADO DEPARTMENT OF PUBLIC HEALTH AND ENVIRONMENT, WATER QUALITY DIVISION. THE APPLICATION CONTAINS CERTIFICATION OF COMPLETION OF A STORMWATER MANAGEMENT PLAN (SWMP), OF WHICH THIS GRADING AND EROSION CONTROL PLAN MAY BE A PART. FOR INFORMATION OR APPLICATION MATERIALS CONTACT:

COLORADO DEPARTMENT OF PUBLIC HEALTH AND ENVIRONMENT WATER QUALITY CONTROL DIVISION

WQCD - PERMITS 4300 CHERRY CREEK DRIVE SOUTH

DENVER. CO 80246-1530 ATTN: PERMITS UNIT

NRCS SOIL SURVEY FOR EL PASO COUNTY

SOIL ID NO	. SOIL TYPE	HYDROLOGIC CLASSIFICATION
38	JARRE-TECOLOTE COMPLEX (8%-65% SLOPES)	В
71	PRING COARSE SANDY LOAM (3%-8% SLOPES)	В
93	TOMAH-CROWFOOT COMPLEX (8%-15% SLOPES)	В

TIMING

ANTICIPATED STARTING AND COMPLETION TIME PERIOD OF SITE GRADING:

SEPTEMBER 2023 THRU DECEMBER 2023

EXPECTED DATE ON WHICH THE FINAL STABILIZATION WILL BE COMPLETED:

Update to future dates.

JULY 2024

ADDRESSED TOTAL DISTURBED

RECEIVING WATERS NAME OF RECEIVING WATERS HAY CREEK (ULTIMATE)

ENGINEER'S NOTES:

THE EXISTING VEGETATION CONSISTS OF MODERATELY DENSE NATIVE GRASSES AND SHRUBS. BASED ON SITE VISITS AND A REVIEW OF AERIAL PHOTOGRAPHY, THE VEGETATIVE COVER AT HAY CREEK VALLEY IS APPROXIMATELY 80%.

ABBREVIATIONS

ASSY	ASSEMBLY	DEFL	DEFLECT	INV	INVERT	RED
BOP	BOTTOM OF PIPE	DIP	DUCTILE IRON PIPE	LT	LEFT OF CENTER LINE	RSN ⁻
3OV	BLOWOFF ASSEMBLY	EL.	ELEVATION	MIN	MINIMUM	
	AND VALVE	EX	EXISTING	MJ	MECHANICAL JOINT	RT
3OW	BACK OF WALL	FLG	FLANGE	N,S,E,W	NORTH,SOUTH,EAST,WEST	
CPLNG.	COUPLING	FH	FIRE HYDRANT	PL	PROPERTY LINE	SHLE
INS.)	(INSULATING)	GPM	GALLONS PER MINUTE	PSI	POUNDS PER SQUARE INCH	SJ
RED.)	(REDUCING)	GRD BRK	V.P.I. GRADE BREAK	PVC	POLYVINYL CHLORIDE PIPE	SL
STR.)	(STRAIGHT)	HD	HIGH DEFLECTION	RCP	REINFORCED CONCRETE PIPE	SS
CRA	CONCRETE REVERSE	HORIZ	HORIZONTAL			STA
	ANCHOR	HYD ASSY	INCLUDES FIRE HYDRANT,			STS
CTRB	CONCRETE THRUST		LATERAL, VALVE, TIE RODS,			TOP
	REACTION BLOCK		AND REVERSE ANCHOR.			TOW
						TYP
FGFND						WI

LEGENU

PROPERTY BOUNDARY **EXISTING FENCE** EXISTING STORM DRAIN PROPOSED STORM DRAIN

__ _ _ _ _ _ _ _ ______

NPDES NOTES:

THE FLOWLINES AND PUBLIC RIGHTS OF WAYS AS A RESULT OF THIS CONSTRUCTION PROJECT. SAID REMOVAL

SHALL BE CONDUCTED IN A TIMELY MANNER, OR AS DIRECTED BY THE ENGINEER. THIS CONSTRUCTION ACTIVITIES STORMWATER MANAGEMENT PLAN (SWMP) HAS BEEN SUBMITTED AS PART OF Know what's below. AN APPLICATION FOR AN EROSION AND SEDIMENT CONTROL PERMIT FILED WITH EL PASO COUNTY AND AS INCLUSION BY REFERENCE TO THE CDPHE CONSTRUCTION ACTIVITY PERMIT. THE SWMP IS A LIVING

1. THE CONTRACTOR SHALL REMOVE ALL SEDIMENT. MUD. AND CONSTRUCTION DEBRIS THAT MAY ACCUMULATE IN

Call before you dig. DOCUMENT AND ADDITIONAL EROSION AND SEDIMENT CONTROL MEASURES MAY BE REQUIRED OF THE CONTRACTOR DUE TO UNFORESEEN EROSION PROBLEMS OR IF THE SUBMITTED PLAN DOES NOT FUNCTION AS INTENDED. THE REQUIREMENTS OF THIS PLAN SHALL BE THE OBLIGATION OF THE LAND OWNER AND/OR HIS SUCCESSORS OR HEIRS; UNTIL SUCH TIME AS THE PLAN IS PROPERLY COMPLETED, MODIFIED, OR VOIDED.

- THE CONTRACTOR SHALL BE HELD RESPONSIBLE FOR REMEDIATION OF ANY ADVERSE IMPACTS TO ADJACENT WATERWAYS, WETLANDS, ETC., RESULTING FROM WORK DONE AS PART OF THIS PROJECT
- THE CONTRACTOR SHALL PREVENT SEDIMENT, DEBRIS AND ALL OTHER POLLUTANTS FROM ENTERING THE STORM SEWER SYSTEM DURING ALL DEMOLITION, EXCAVATION, TRENCHING, BORING, GRADING OR OTHER CONSTRUCTION OPERATIONS THAT ARE PART OF THIS PROJECT.
- A LAYER OF SUITABLE MULCH SHALL BE APPLIED TO ALL DISTURBED PORTIONS OF THE SITE WITHIN 21 DAYS OF THE COMPLETION OF GRADING. SAID MULCH SHALL BE APPLIED AT A RATE OF 2 TONS PER ACRE AND SHALL BE TACKED OR FASTENED BY AN APPROVED METHOD SUITABLE FOR THE TYPE OF MULCH USED. ROUGH-CUT STREETS SHALL BE MULCHED UNLESS A LAYER OF AGGREGATE ROAD BASE OR ASPHALT PAVING IS TO BE APPLIED TO SAID ROUGH-CUT STREETS WITHIN THE 21 DAY PERIOD AFTER COMPLETION OF OVERLOT GRADING. AN AREA THAT IS GOING TO REMAIN IN AN INTERIM STATE FOR MORE THEN SIXTY (60) DAYS SHALL ALSO BE SEEDED. ALL TEMPORARY SOIL EROSION CONTROL MEASURES AND BMP'S SHALL BE MAINTAINED UNTIL PERMANENT SOIL EROSION CONTROL MEASURES ARE IMPLEMENTED
- THE CONTRACTOR SHALL LOCATE, INSTALL, AND MAINTAIN ALL EROSION CONTROL AND WATER QUALITY "BEST MANAGEMENT PRACTICES" AS INDICATED IN THE APPROVED CONSTRUCTION ACTIVITIES STORMWATER MANAGEMENT PLAN. BMP'S SHALL BE MAINTAINED AND KEPT IN GOOD REPAIR FOR THE DURATION OF THIS PROJECT
- AT A MINIMUM, THE CONTRACTOR SHALL INSPECT, AND KEEP A LOG OF, ALL BMP'S WEEKLY AND AFTER SIGNIFICANT PRECIPITATION EVENTS. ALL NECESSARY MAINTENANCE AND REPAIR SHALL BE COMPLETED IN A TIMELY MANNER. ACCUMULATED SEDIMENT AND DEBRIS SHALL BE REMOVED FROM A BMP WHEN THE SEDIMENT LEVEL REACHES ONE-HALF THE HEIGHT OF THE BMP. OR. AT ANY TIME THAT SEDIMENT OR DEBRIS ADVERSELY IMPACTS THE FUNCTIONING OF THE BMP.
- THE CONTRACTOR SHALL PROPERLY COVER ALL LOADS OF CUT AND FILL MATERIAL IMPORTED TO OR EXPORTED FROM THIS SITE TO PREVENT LOSS OF THE MATERIAL DURING TRANSPORT WITHIN PUBLIC RIGHTS OF WAY.
- THE USE OF REBAR, STEEL STAKES, OR STEEL FENCE POSTS TO STAKE DOWN STRAW OR HAY BALES; OR TO SUPPORT SILT FENCING USED AS AN EROSION CONTROL MEASURE; IS PROHIBITED. THE USE OF OSHA APPROVED COLORED WARNING CAPS ON REBAR OR FENCE POSTS USED WITH EROSION CONTROL MEASURES IS NOT ACCEPTABLE
- 10. SOILS THAT WILL BE STOCKPILED FOR MORE THAN 30 DAYS SHALL BE MULCHED AND SEEDED WITH A TEMPORARY OR PERMANENT GRASS COVER WITHIN 21 DAYS OF STOCKPILE CONSTRUCTION. IF STOCKPILES ARE LOCATED WITHIN 100 FEET OF A DRAINAGEWAY. ADDITIONAL SEDIMENT CONTROLS SUCH AS TEMPORARY DIKES OR SILT FENCE SHALL BE REQUIRED.
- 11. MODIFICATION OF AN ACTIVE EROSION AND SEDIMENT CONTROL PERMIT BY THE CONTRACTOR SHALL REQUIRE TIMELY NOTIFICATION OF AND APPROVAL BY EL PASO COUNTY. TERMINATION OF AN ACTIVE EROSION AND SEDIMENT CONTROL PERMIT UPON COMPLETION OF THE PROJECT REQUIRES NOTIFICATION OF AND APPROVAL BY EL PASO COUNTY.
- 12. UNLESS CONFINED IN A PREDEFINED. BERMED CONTAINMENT AREA, THE CLEANING OF CONCRETE TRUCK DELIVERY CHUTES IS PROHIBITED AT THE JOB SITE. THE DISCHARGE OF WATER CONTAINING WASTE CEMENT TO THE STORM SEWER SYSTEM IS PROHIBITED.
- THE CONTRACTOR SHALL PROTECT ALL STORM SEWER FACILITIES ADJACENT TO ANY LOCATION WHERE PAVEMENT CUTTING OPERATIONS INVOLVING WHEEL CUTTING, SAW CUTTING OR ABRASIVE WATER JET CUTTING ARE TO TAKE PLACE. THE DISCHARGE OF ANY WATER CONTAMINATED BY WASTE PRODUCTS FROM CUTTING OPERATIONS TO THE STORM SEWER SYSTEM IS PROHIBITED. THE CONTRACTOR SHALL REMOVE AND PROPERLY DISPOSE OF ALL WASTE PRODUCTS GENERATED BY SAID CUTTING OPERATIONS ON A DAILY BASIS.
- 14. LOCATION OF STAGING, STORAGE, EQUIPMENT MAINTENANCE, TEMPORARY DISPOSAL, VEHICLE TRACKING CONTROL AND CONCRETE TRUCK WASHOUT AREAS WILL BE DETERMINED IN THE FIELD AT THE START OF CONSTRUCTION ACTIVITY AND DELINEATED ON THIS

MATCHLINE PROPOSED LOT/TRACT LINE EASEMENT PROPOSED BUILDING SETBACK NO BUILD ZONE (SLOPE GREATER THAN 29.99 %)

REDUCER

RIGHT OF

MJ RESTRAINT

(i.e. MEGALUG)

CENTER LINE

SANITARY SEWER

STORM SEWER

TOP OF PIPE

TOP OF WALL

WATER LINE

SHOULDER

SLIP JOINT SI FFVF

STATION

TYPICAL

PROJECT ELEVATIONS ARE NAVD 88 ELEVATIONS BASED ON AN OPUS DERIVED ELEVATION ON CONTROL POINT 10, A NO. 5 REBAR HAVING AN ELEVATION OF 5769.92.

BASIS OF BEARING

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PREPARED BY:

Excellence by Design

PRELIMINARY THIS DRAWING HAS NOT BEEN APPROVED BY GOVERNING AGENCIES AND IS SUBJECT TO CHANGE

FOR AND ON BEHALF OF

MATRIX DESIGN GROUP, INC.

PROJECT No. 22.886.076

DESIGNED BY:

CHECKED BY:

JAO

DRAWN BY:

EL PASO COUNTY, COLORADO FINAL GRADING & EROSION CONTROL PLANS

HAY CREEK VALLEY

GENERAL NOTES

N/A SHEET

SCALE SEPTEMBER 2023 DATE ISSUED: CVW HORIZ.

DRAWING No. GN02 03 OF 11


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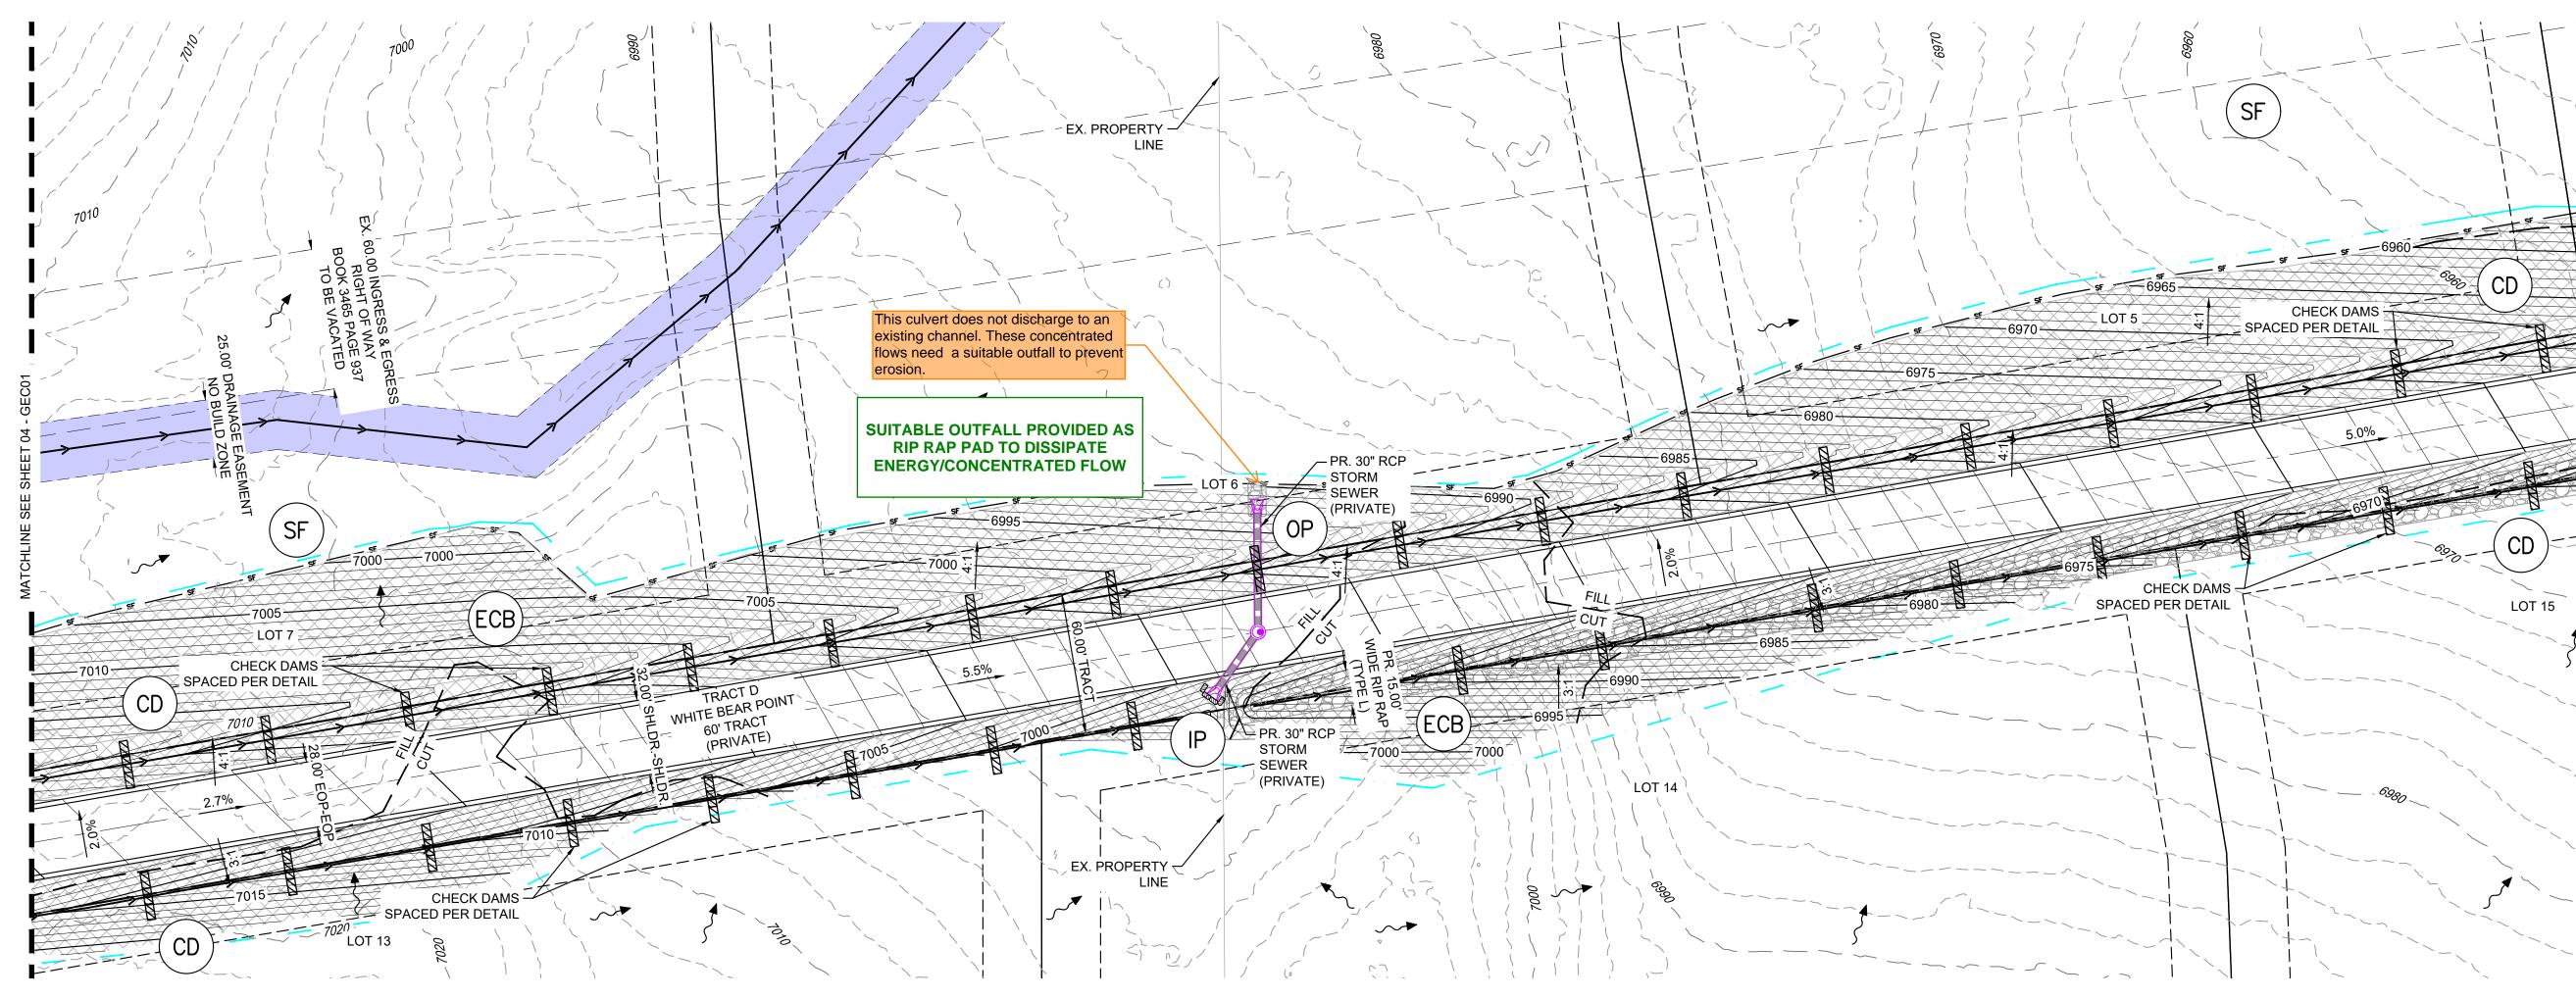
DESCRIPTION

REVISIONS


FILE NAME: S:\22.886.076 Hay Creek-Forest Manor-O'Leary Properties\500 CADD\504 Plan Sets\Construction Plans\GEC Plan\TS01.dwg

SHEET KEY



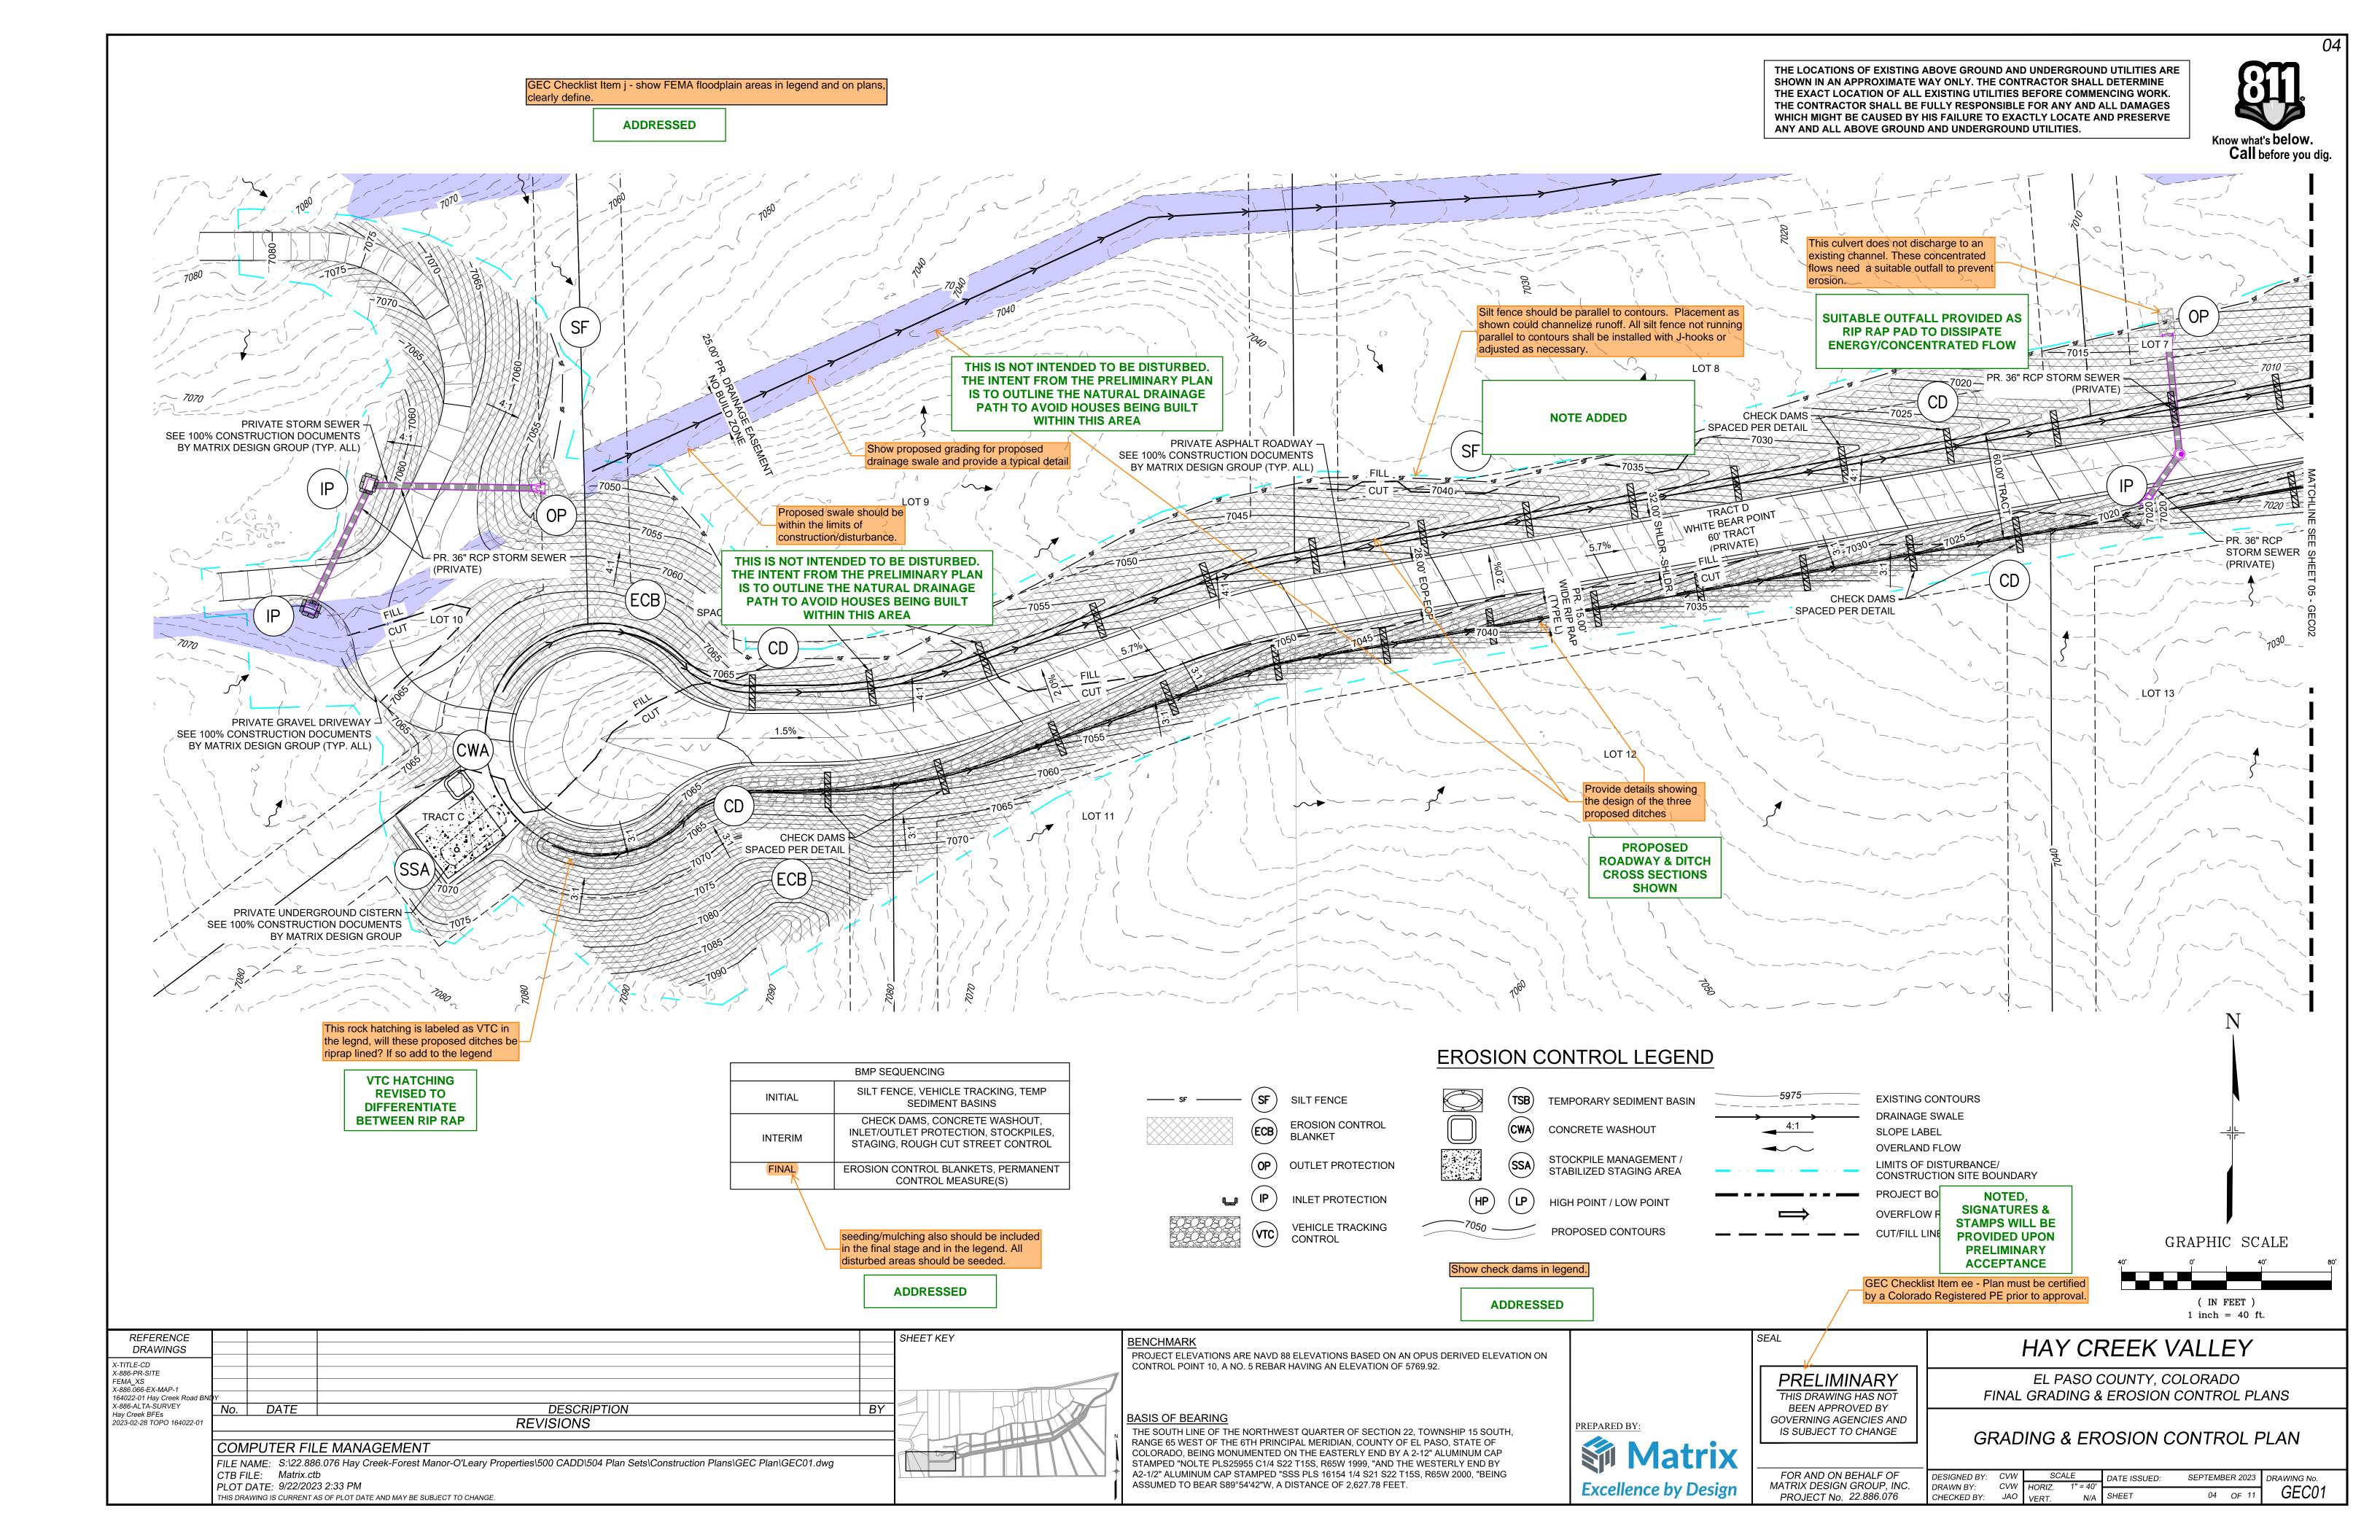

INITIAL	SILT FENCE, VEHICLE TRACKING, TEMP SEDIMENT BASINS			
INTERIM	CHECK DAMS, CONCRETE WASHOUT, INLET/OUTLET PROTECTION, STOCKPILES, STAGING, ROUGH CUT STREET CONTROL			
FINAL	EROSION CONTROL BLANKETS, PERMANENT CONTROL MEASURE(S)			

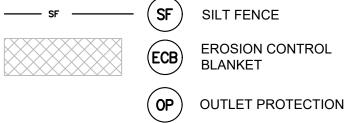



	GRAPHIC	C SCALE	
40'	0'	40'	80*
	(IN F 1 inch =	•	

REFERENCE DRAWINGS					SHEET K
X-TITLE-CD X-886-PR-SITE FEMA XS					-
ТЕМИ-ДАЗ X-886.066-EX-MAP-1 164022-01 Hay Creek Road BNL X-886-ALTA-SURVEY		DATE	DESCRIPTION	BY	
Hay Creek BFEs 2023-02-28 TOPO 164022-01	No.	DATE	REVISIONS	<u> Dî</u>	
	COM	PUTER FIL	E MANAGEMENT		
	CTB FI PLOT I	LE: Matrix.ctb DATE: 9/22/2023			

PROJECT ELEVATIONS ARE NAVD 88 ELEVATIONS BASED ON AN OPUS DERIVED ELEVATION ON CONTROL POINT 10, A NO. 5 REBAR HAVING AN ELEVATION OF 5769.92.

THE SOUTH LINE OF THE NORTHWEST QUARTER OF SECTION 22, TOWNSHIP 15 SOUTH, RANGE 65 WEST OF THE 6TH PRINCIPAL MERIDIAN, COUNTY OF EL PASO, STATE OF COLORADO, BEING MONUMENTED ON THE EASTERLY END BY A 2-12" ALUMINUM CAP STAMPED "NOLTE PLS25955 C1/4 S22 T15S, R65W 1999, "AND THE WESTERLY END BY A2-1/2" ALUMINUM CAP STAMPED "SSS PLS 16154 1/4 S21 S22 T15S, R65W 2000, "BEING ASSUMED TO BEAR S89°54'42"W, A DISTANCE OF 2,627.78 FEET.

PREPARED BY:

Excellence by Design

THIS DRAWING HAS NOT BEEN APPROVED BY GOVERNING AGENCIES AND IS SUBJECT TO CHANGE

FOR AND ON BEHALF OF MATRIX DESIGN GROUP, INC. PROJECT No. 22.886.076

FINAL GRADING & EROSION CONTROL PLANS

GRADING & EROSION CONTROL PLAN

DESIGNED BY:	CVW	SC	ALE	DATE ISSUED:	SEPTEME	BER 2023	DRAWING No.
DRAWN BY:	CVW JAO	HORIZ.	1" = 40'	SHEET	05	OF 11	GFC02
CHECKED BY:	JAU	VERT.	N/A	STILLT	00	01 11	02002

THE LOCATIONS OF EXISTING ABOVE GROUND AND UNDERGROUND UTILITIES ARE SHOWN IN AN APPROXIMATE WAY ONLY. THE CONTRACTOR SHALL DETERMINE THE EXACT LOCATION OF ALL EXISTING UTILITIES BEFORE COMMENCING WORK. THE CONTRACTOR SHALL BE FULLY RESPONSIBLE FOR ANY AND ALL DAMAGES WHICH MIGHT BE CAUSED BY HIS FAILURE TO EXACTLY LOCATE AND PRESERVE ANY AND ALL ABOVE GROUND AND UNDERGROUND UTILITIES.



(IN FEET)
1 inch = 40 ft

SEPTEMBER 2023 DRAWING No.

06 OF 11

GEC03

HAY CREEK VALLEY

EL PASO COUNTY, COLORADO

FINAL GRADING & EROSION CONTROL PLANS

GRADING & EROSION CONTROL PLAN

SCALE DATE ISSUED:

_{N/A} SHEET

CVW HORIZ. 1" = 40'

PRELIMINARY

THIS DRAWING HAS NOT

BEEN APPROVED BY

PREPARED BY:

Excellence by Design

GOVERNING AGENCIES AND

IS SUBJECT TO CHANGE

FOR AND ON BEHALF OF


MATRIX DESIGN GROUP, INC.

PROJECT No. 22.886.076

DESIGNED BY:

CHECKED BY: JAO VERT.

DRAWN BY:

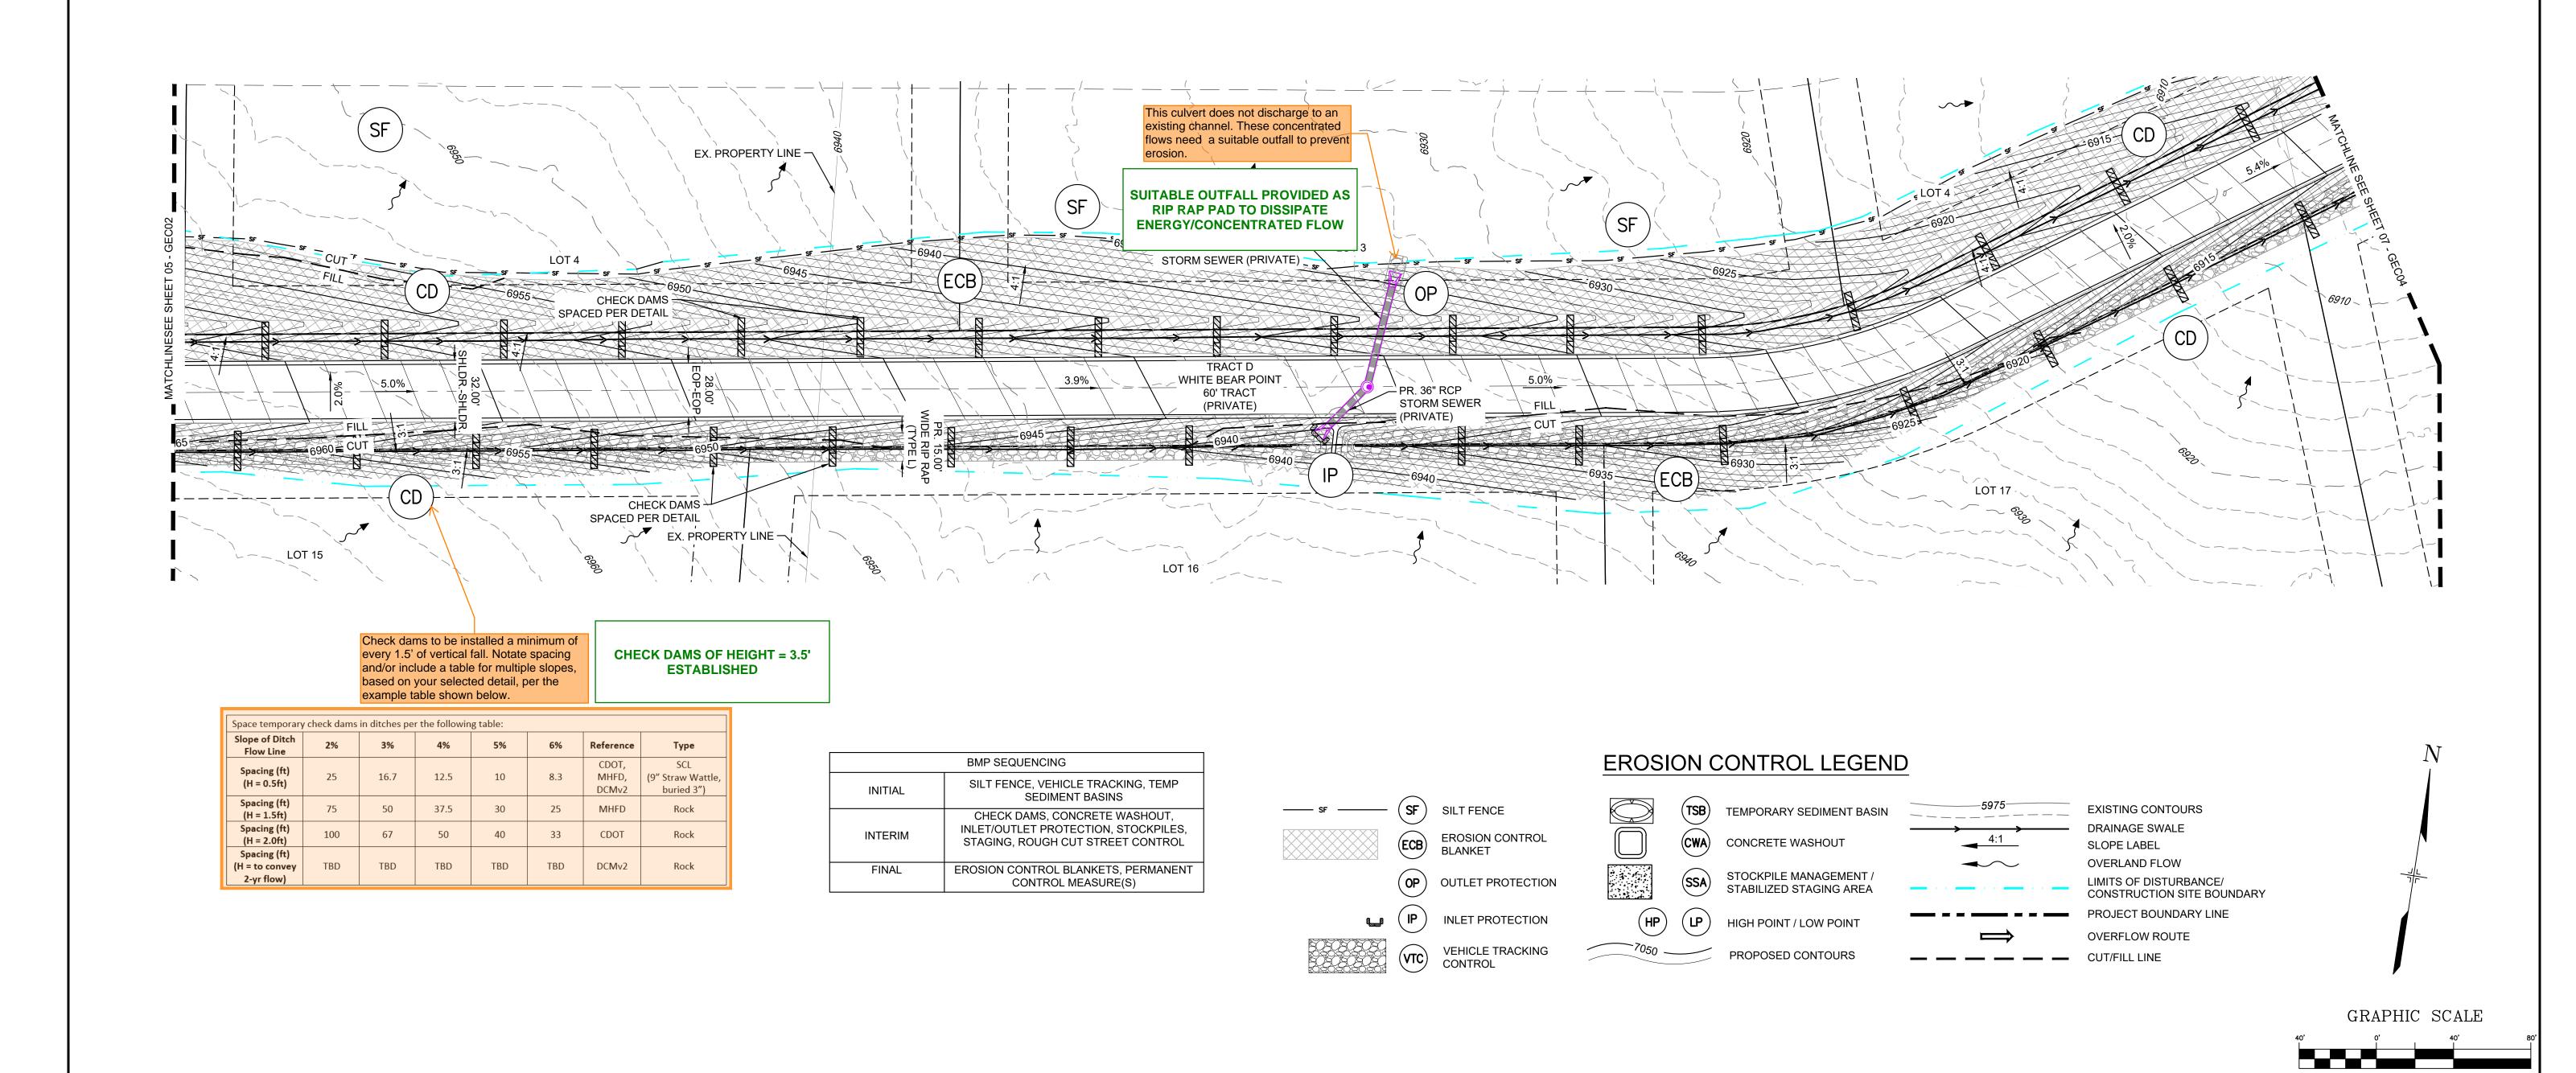

PROJECT ELEVATIONS ARE NAVD 88 ELEVATIONS BASED ON AN OPUS DERIVED ELEVATION ON

THE SOUTH LINE OF THE NORTHWEST QUARTER OF SECTION 22, TOWNSHIP 15 SOUTH,

RANGE 65 WEST OF THE 6TH PRINCIPAL MERIDIAN, COUNTY OF EL PASO, STATE OF

COLORADO, BEING MONUMENTED ON THE EASTERLY END BY A 2-12" ALUMINUM CAP

STAMPED "NOLTE PLS25955 C1/4 S22 T15S, R65W 1999, "AND THE WESTERLY END BY A2-1/2" ALUMINUM CAP STAMPED "SSS PLS 16154 1/4 S21 S22 T15S, R65W 2000, "BEING

CONTROL POINT 10, A NO. 5 REBAR HAVING AN ELEVATION OF 5769.92.

ASSUMED TO BEAR S89°54'42"W, A DISTANCE OF 2,627.78 FEET.

BASIS OF BEARING

SHEET KEY

DESCRIPTION

REVISIONS

FILE NAME: S:\22.886.076 Hay Creek-Forest Manor-O'Leary Properties\500 CADD\504 Plan Sets\Construction Plans\GEC Plan\GEC01.dwg

REFERENCE

DRAWINGS

164022-01 Hay Creek Road BNI X-886-ALTA-SURVEY

2023-02-28 TOPO 164022-0

No. DATE

CTB FILE: Matrix.ctb

PLOT DATE: 9/22/2023 2:33 PM

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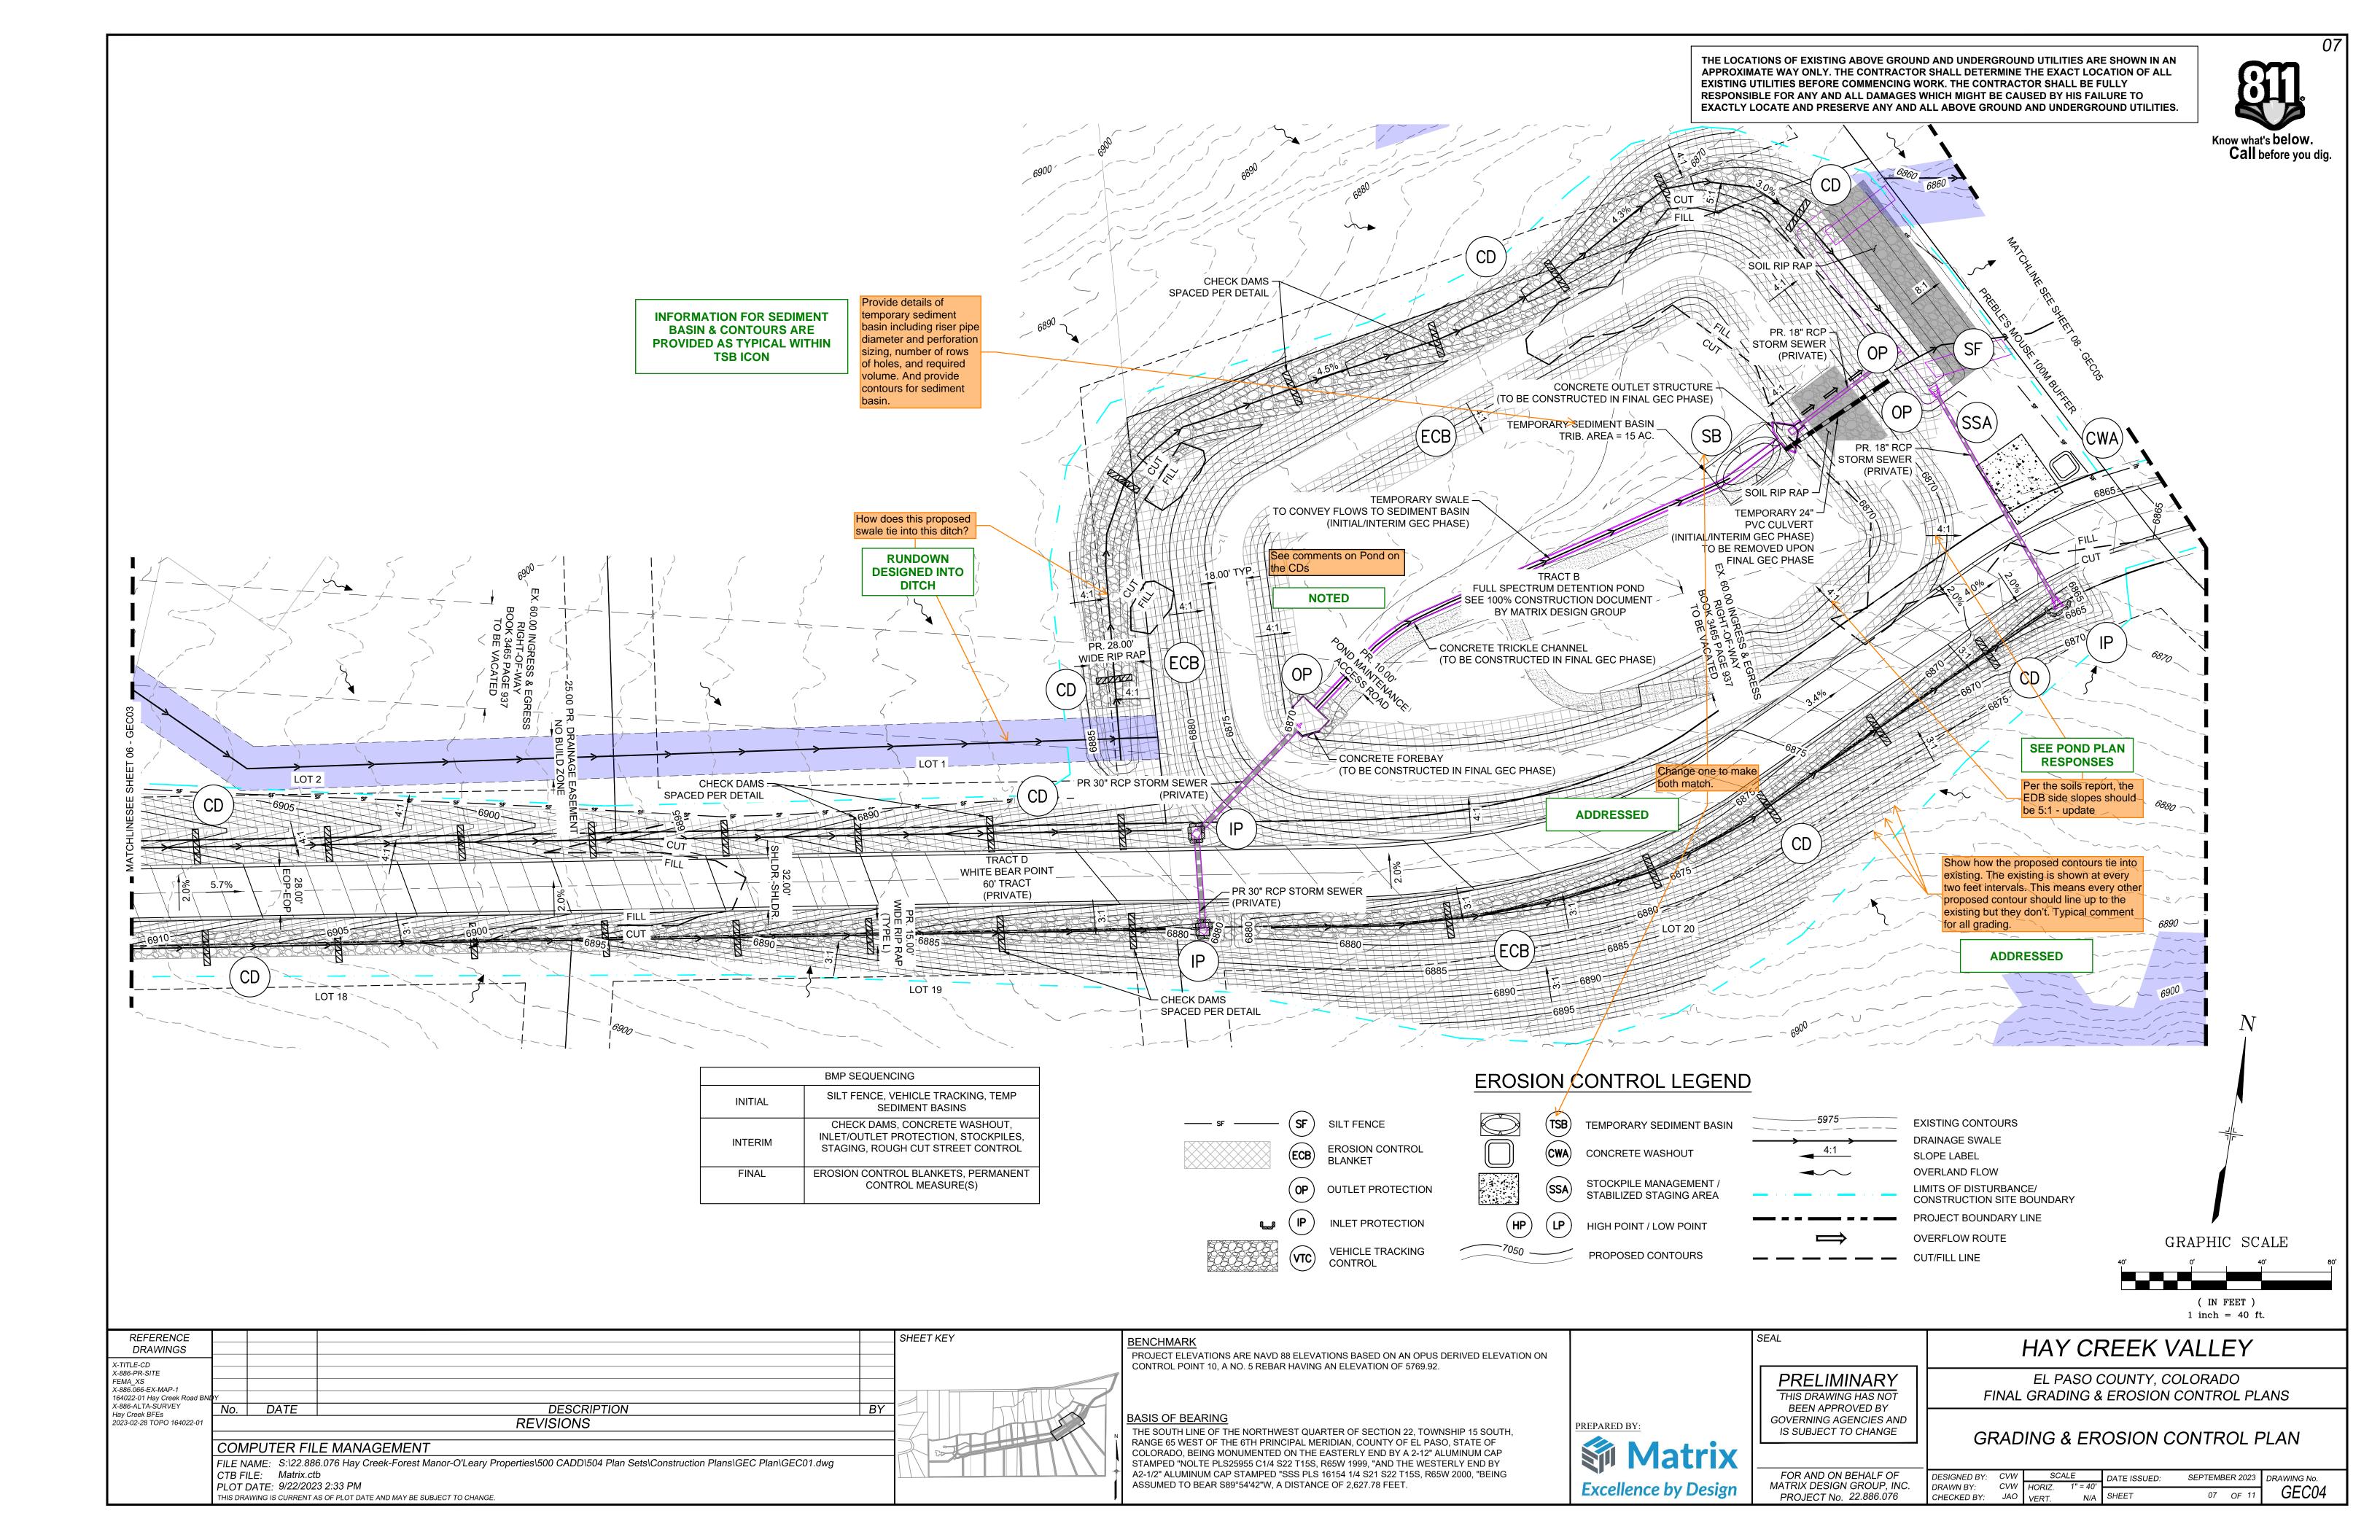
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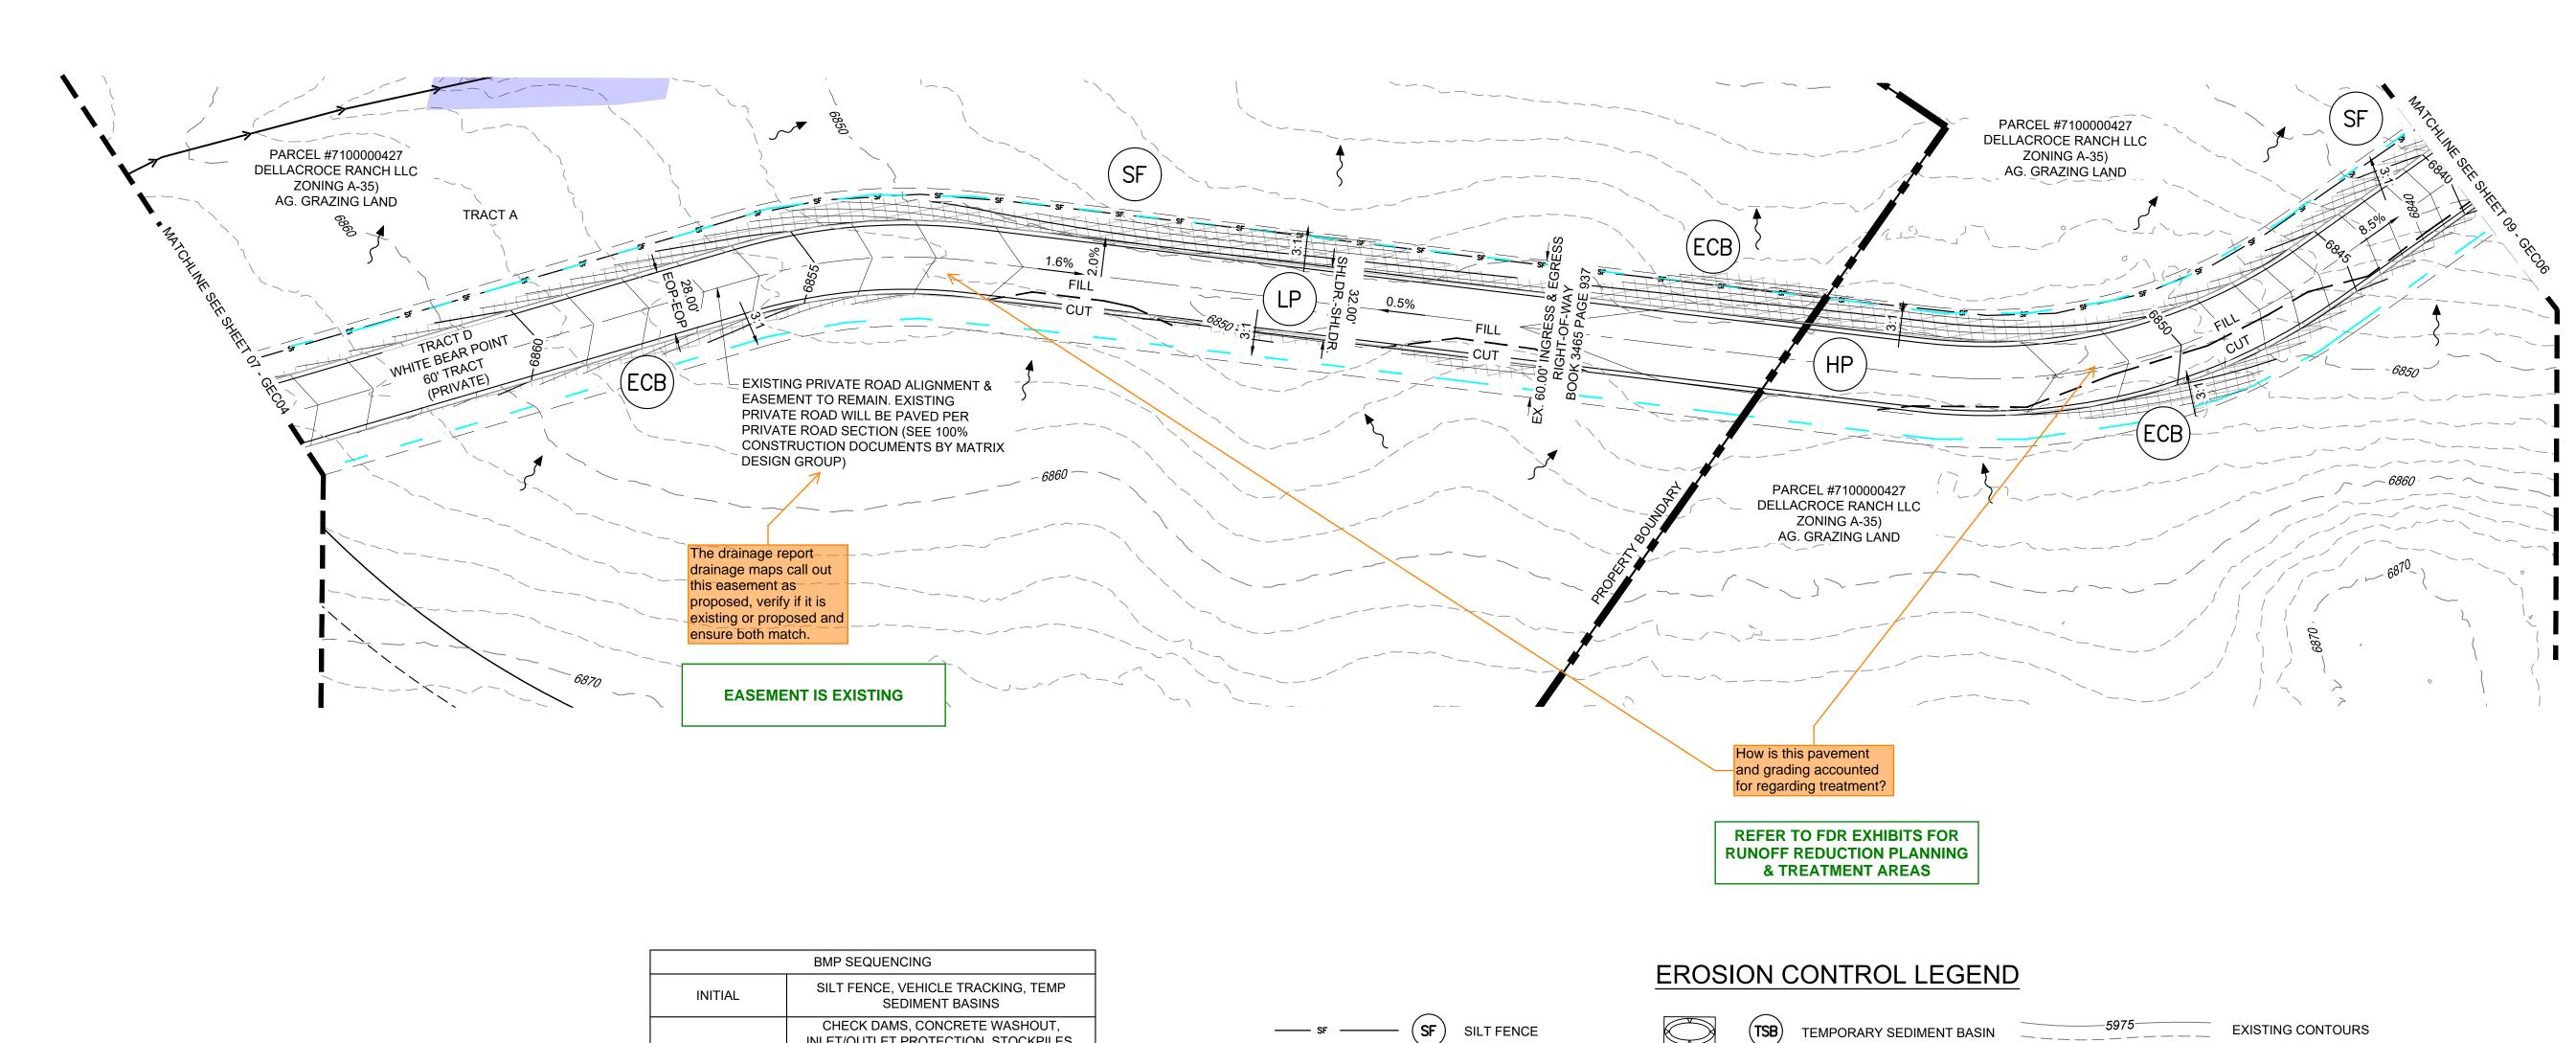
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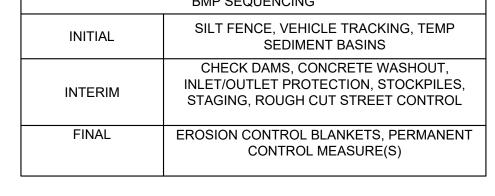
X-886-PR-SITE

FEMA_XS X-886.066-EX-MAP-1

Hay Creek BFEs















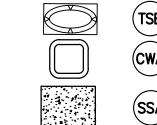


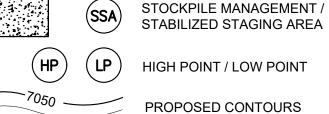

CONCRETE WASHOUT

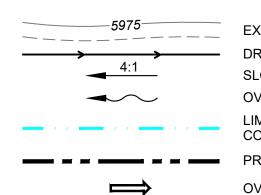

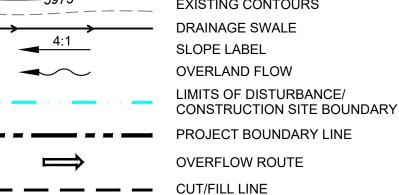

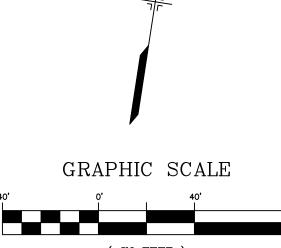

	GIVAI IIIC	DOALL			
40'	0'	40'	80'		
	(IN FEET) $1 \text{ inch} = 40 \text{ ft.}$				

REFERENCE DRAWINGS					SHEET KEY
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FEMA_XS X-886.066-EX-MAP-1 164022-01 Hay Creek Road BNI	Y				
X-886-ALTA-SURVEY Hay Creek BFEs	No.	DATE	DESCRIPTION	BY	
2023-02-28 TOPO 164022-01			REVISIONS	•	
	COM				
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PROJECT ELEVATIONS ARE NAVD 88 ELEVATIONS BASED ON AN OPUS DERIVED ELEVATION ON CONTROL POINT 10, A NO. 5 REBAR HAVING AN ELEVATION OF 5769.92.

BASIS OF BEARING

THE SOUTH LINE OF THE NORTHWEST QUARTER OF SECTION 22, TOWNSHIP 15 SOUTH, RANGE 65 WEST OF THE 6TH PRINCIPAL MERIDIAN, COUNTY OF EL PASO, STATE OF COLORADO, BEING MONUMENTED ON THE EASTERLY END BY A 2-12" ALUMINUM CAP STAMPED "NOLTE PLS25955 C1/4 S22 T15S, R65W 1999, "AND THE WESTERLY END BY A2-1/2" ALUMINUM CAP STAMPED "SSS PLS 16154 1/4 S21 S22 T15S, R65W 2000, "BEING ASSUMED TO BEAR S89°54'42"W, A DISTANCE OF 2,627.78 FEET.



PRELIMINARY

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FOR AND ON BEHALF OF MATRIX DESIGN GROUP, INC. PROJECT No. 22.886.076

HAY CREEK VALLEY


EL PASO COUNTY, COLORADO FINAL GRADING & EROSION CONTROL PLANS

GRADING & EROSION CONTROL PLAN

.									
	DESIGNED BY:	CVW	SC	ALE	DATE ISSUED:	SEPTEME	BER 2023	DRAWING No.	
	DRAWN BY:	CVW	HORIZ.	1" = 40'				CECOS	
	CHECKED BY:	JAO	VFRT	N/A	SHEET	08	OF 11	GECUO	

THE LOCATIONS OF EXISTING ABOVE GROUND AND UNDERGROUND UTILITIES ARE SHOWN IN AN APPROXIMATE WAY ONLY. THE CONTRACTOR SHALL DETERMINE THE EXACT LOCATION OF ALL EXISTING UTILITIES BEFORE COMMENCING WORK. THE CONTRACTOR SHALL BE FULLY RESPONSIBLE FOR ANY AND ALL DAMAGES WHICH MIGHT BE CAUSED BY HIS FAILURE TO EXACTLY LOCATE AND PRESERVE ANY AND ALL ABOVE GROUND AND UNDERGROUND UTILITIES.




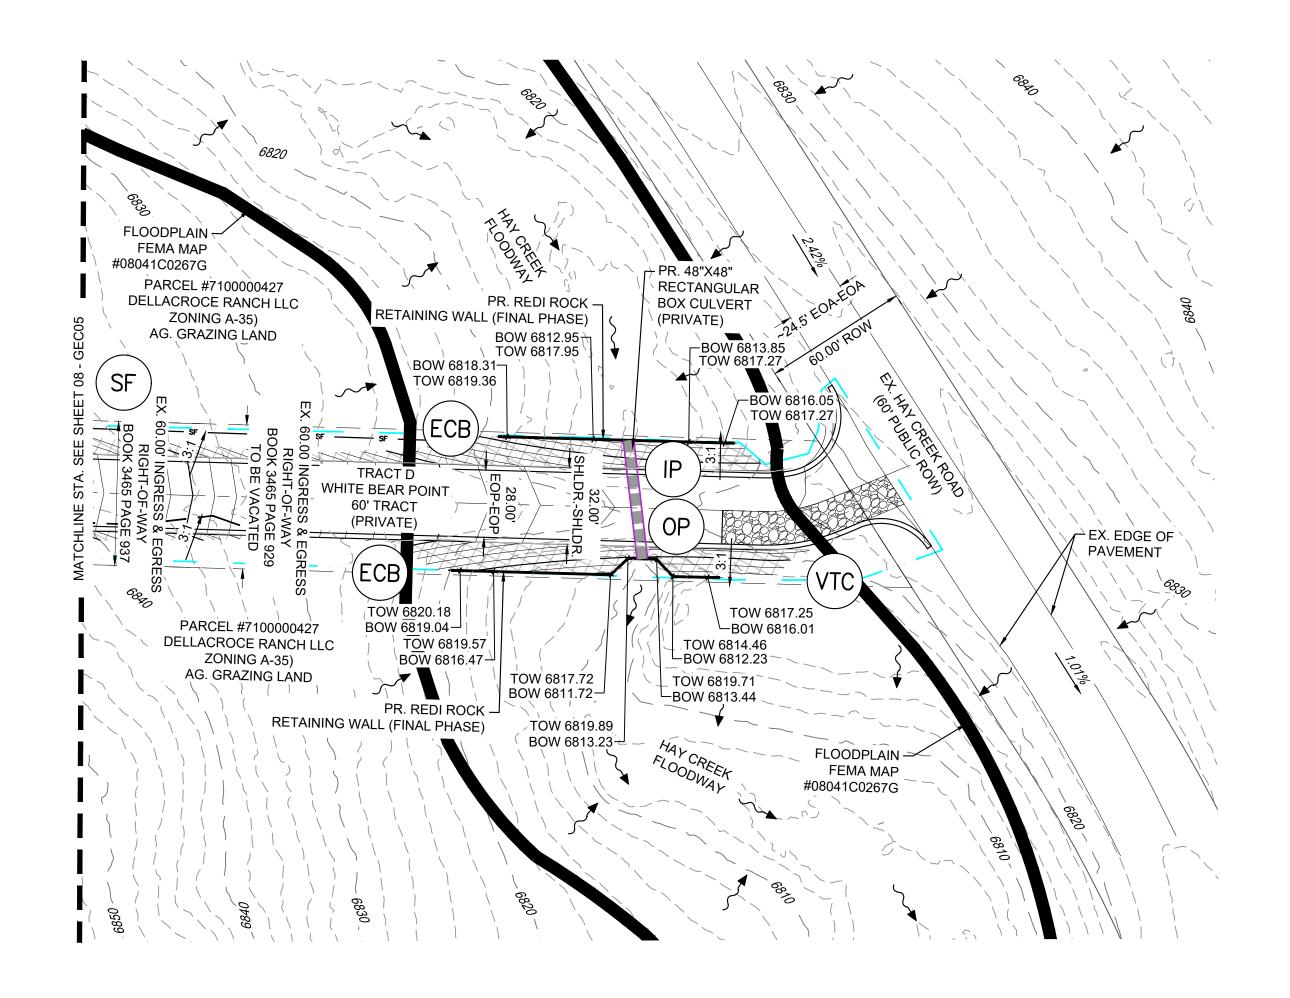


	BMP SEQUENCING
INITIAL	SILT FENCE, VEHICLE TRACKING, TEMP SEDIMENT BASINS
INTERIM	CHECK DAMS, CONCRETE WASHOUT, INLET/OUTLET PROTECTION, STOCKPILES, STAGING, ROUGH CUT STREET CONTROL
FINAL	EROSION CONTROL BLANKETS, PERMANENT CONTROL MEASURE(S)




TEMPORARY SEDIMENT BASIN

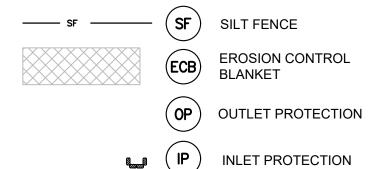

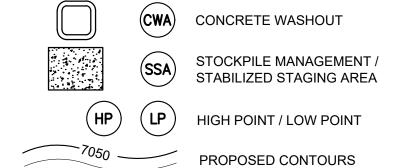

_	
5975	EXISTING CONTOURS
	DRAINAGE SWALE
4:1	SLOPE LABEL
\longrightarrow	OVERLAND FLOW
	LIMITS OF DISTURBANCE/ CONSTRUCTION SITE BOUNDARY
	PROJECT BOUNDARY LINE
\Longrightarrow	OVERFLOW ROUTE
	CUT/FILL LINE

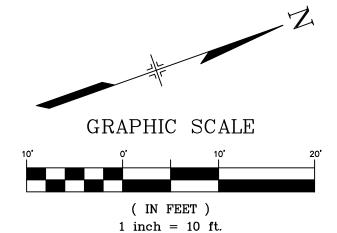

REFERENCE DRAWINGS					SHE				
X-TITLE-CD X-886-PR-SITE FEMA_XS X-886.066-EX-MAP-1 164022-01 Hay Creek Road BNI X-886-ALTA-SURVEY									
	No.	DATE	DESCRIPTION	BY	Y				
	REVISIONS								
	COMPUTER FILE MANAGEMENT								
	FILE NAME: S:\22.886.076 Hay Creek-Forest Manor-O'Leary Properties\500 CADD\504 Plan Sets\Construction Plans\GEC Plan\GEC01.dwg CTB FILE: Matrix.ctb PLOT DATE: 9/22/2023 2:34 PM THIS DRAWING IS CURRENT AS OF PLOT DATE AND MAY BE SUBJECT TO CHANGE.								



BENCHMARK

PROJECT ELEVATIONS ARE NAVD 88 ELEVATIONS BASED ON AN OPUS DERIVED ELEVATION ON CONTROL POINT 10, A NO. 5 REBAR HAVING AN ELEVATION OF 5769.92.

BASIS OF BEARING

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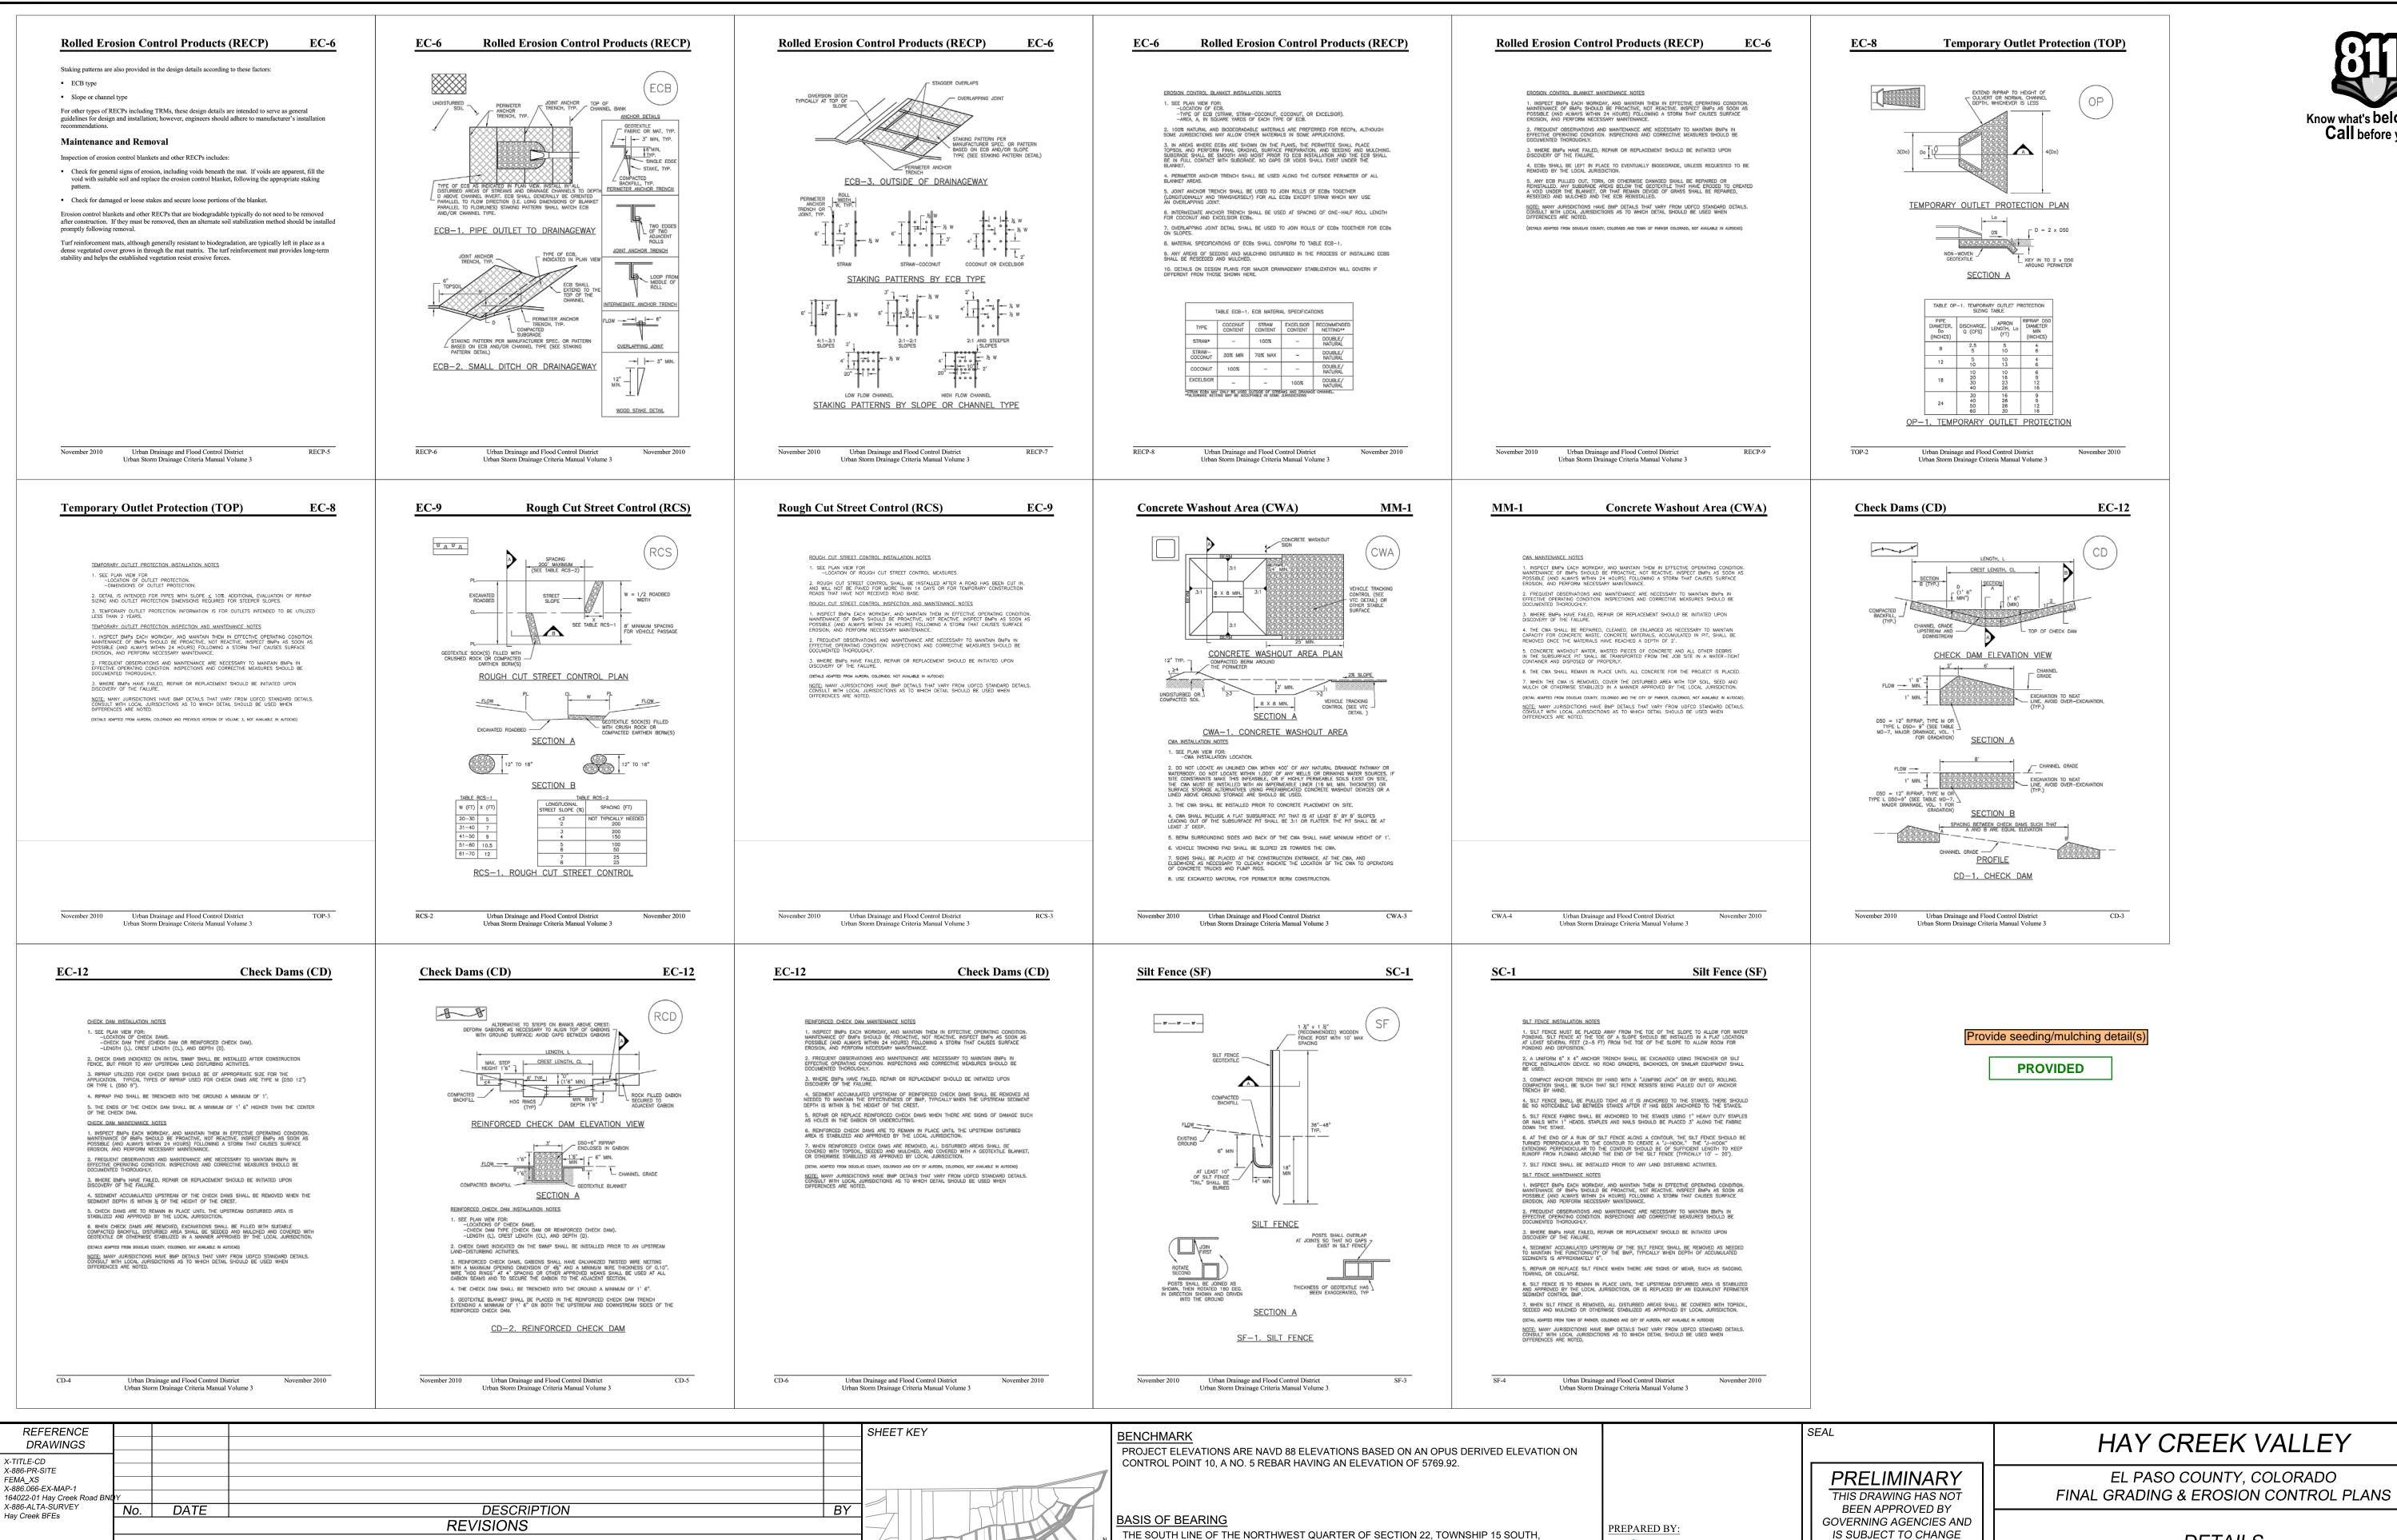
FINAL GRADING & EROSION CONTROL PLANS

HAY CREEK VALLEY

EL PASO COUNTY, COLORADO

GRADING & EROSION CONTROL PLAN

DESIGNED BY:	CVW	SCALE		DATE ISSUED:	SEPTEMBER 2023	DRAWING No.	
DRAWN BY:	CVW	HORIZ.	1" = 40'			CECOG	
CHECKED BY:	JAO	VFRT	N/A	SHEET	09 OF 11	GE000	



COMPUTER FILE MANAGEMENT

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CTB FILE: Matrix.ctb

PLOT DATE: 9/22/2023 2:33 PM

FILE NAME: S:\22.886.076 Hay Creek-Forest Manor-O'Leary Properties\500 CADD\504 Plan Sets\Construction Plans\GEC Plan\ECN01.dwg

RANGE 65 WEST OF THE 6TH PRINCIPAL MERIDIAN, COUNTY OF EL PASO, STATE OF

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STAMPED "NOLTE PLS25955 C1/4 S22 T15S, R65W 1999, "AND THE WESTERLY END BY A2-1/2" ALUMINUM CAP STAMPED "SSS PLS 16154 1/4 S21 S22 T15S, R65W 2000, "BEING

ASSUMED TO BEAR S89°54'42"W, A DISTANCE OF 2,627.78 FEET.

DETAILS SEPTEMBER 2023 DRAWING No. DATE ISSUED: ECN01

10 OF 11

SCALE

_{N/A} SHEET

CVW HORIZ.

JAO VERT.

DESIGNED BY:

CHECKED BY:

DRAWN BY:

FOR AND ON BEHALF OF


MATRIX DESIGN GROUP, INC.

PROJECT No. 22.886.076

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ASSUMED TO BEAR S89°54'42"W, A DISTANCE OF 2,627.78 FEET.

MATRIX DESIGN GROUP, INC.

PROJECT No. 22.886.076

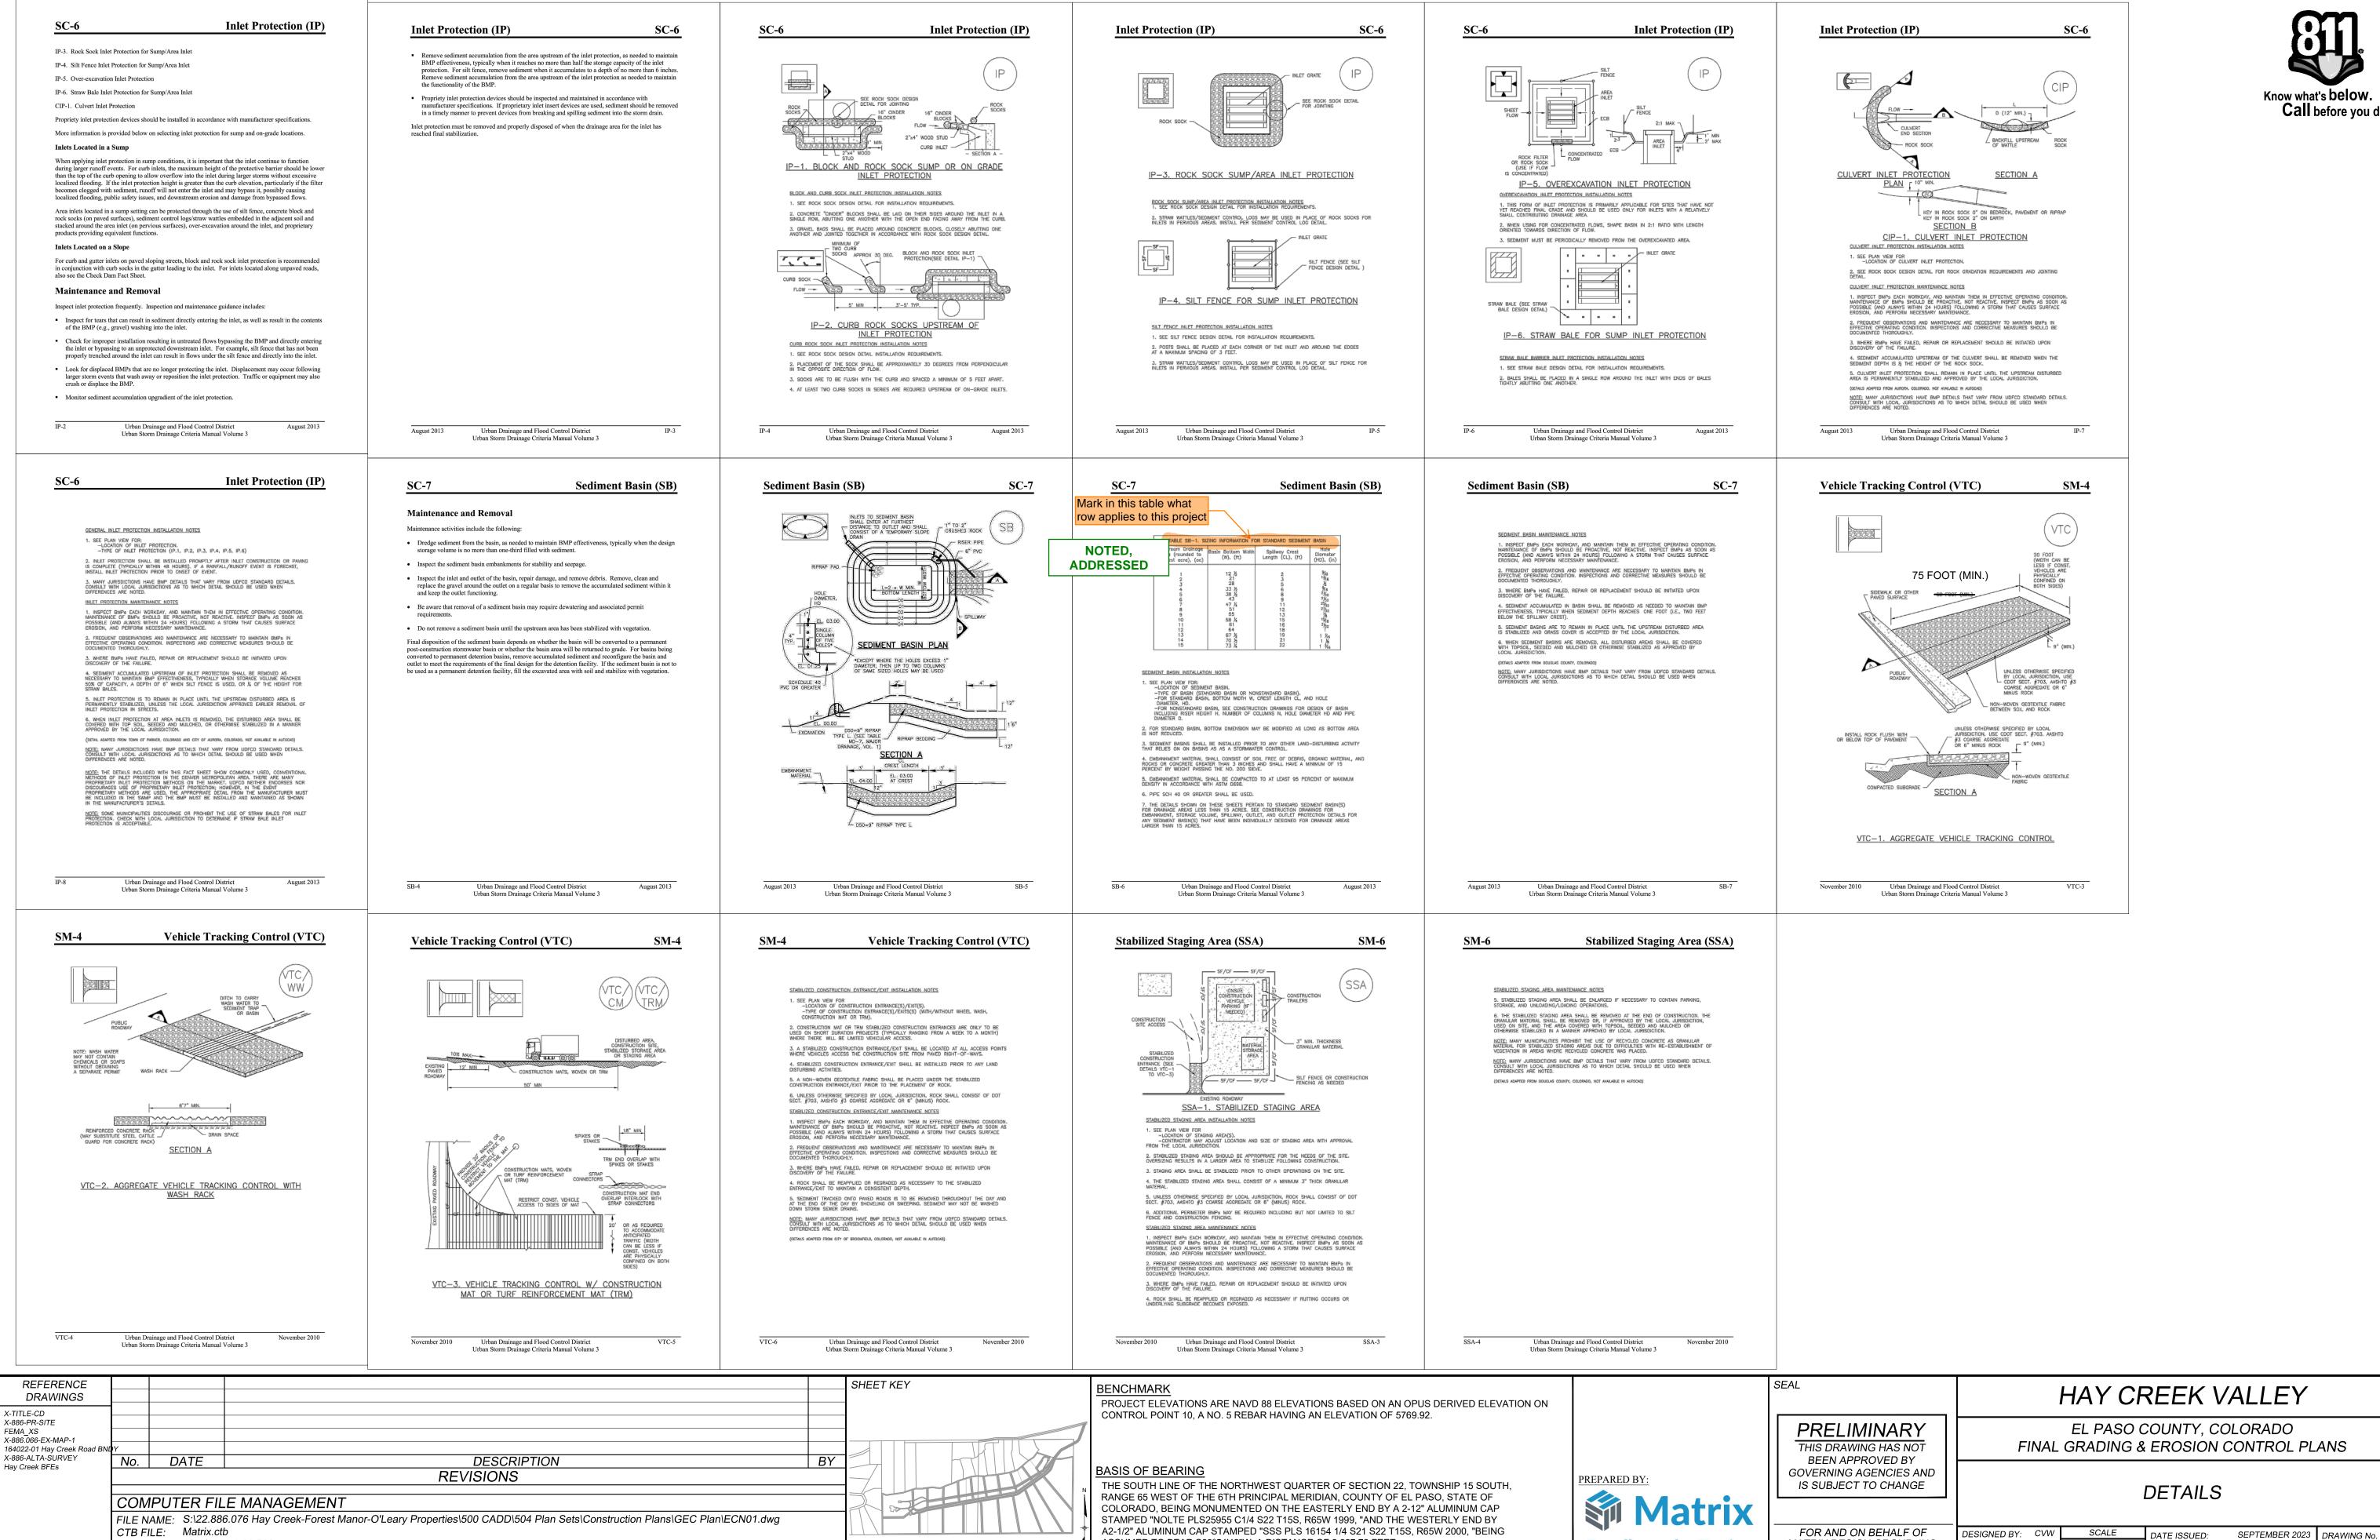DRAWN BY:

CHECKED BY:

CVW HORIZ.

JAO VERT.

_{N/A} | SHEET

ECN02

11 OF 11

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