SHEET No. **INDEX OF SHEETS** TITLE SHEET GN01 **OVERALL SHEET KEY** GN02 **GENERAL NOTES** RD01-RD07 **ROADWAY PLAN & PROFILE** SDGN01 STORM DRAIN SHEET KEY 12 SDGN02 STORM DRAIN GENERAL NOTES & DETAILS 13 SD01-SD05 STORM DRAIN PLAN & PROFILE 14-18a DFGN01 **DETENTION POND GENERAL NOTES** 19 20-25 DF01-DF06 DETENTION POND 1 SITE PLAN WT01 WATER CISTERN PLAN & DETAILS

HAY CREEK VALLEY

EL PASO COUNTY, COLORADO

CONSTRUCTION DOCUMENTS

MAY 2024

OWNER/DEVELOPER VIEW HOMES, INC.

555 MIDDLE CREEK PARKWAY, SUITE 500

COLORADO SPRINGS, CO 80921 TIM BUSCHAR, (719)-382-9433

CIVIL ENGINEER MATRIX DESIGN GROUP

> 2435 RESEARCH PARKWAY, SUITE 300 COLORADO SPRINGS, CO 80920

(719)-575-0100

ELECTRIC MOUNTAIN VIEW ELECTRIC ASSOCIATION

> 15706 JACKSON CREEK PARKWAY, SUITE 100 MONUMENT, CO 80132

GINA PERRY, (719) 494-2636

BLACK HILLS ENERGY

105 S VICTORIA AVENUE **PUEBLO, CO 81003** (800) 303-0752

ENGINEERING EL PASO COUNTY PUBLIC WORKS DEPARTMENT

3275 AKERS DRIVE

COLORADO SPRINGS, CO 80922

(719) 520-6460

TRAFFIC EL PASO COUNTY PUBLIC WORKS DEPARTMENT

3275 AKERS DRIVE

COLORADO SPRINGS, CO 80922 (719) 520-6460

DRAINAGE EL PASO COUNTY PUBLIC WORKS DEPARTMENT

> 3275 AKERS DRIVE COLORADO SPRINGS, CO 80922

(719) 520-6460


FIRE DEPARTMENT MONUMENT FIRE DISTRICT

16055 OLD FOREST POINT, SUITE 102

MONUMENT, CO 80132 (719)-484-0911



SITE MAP

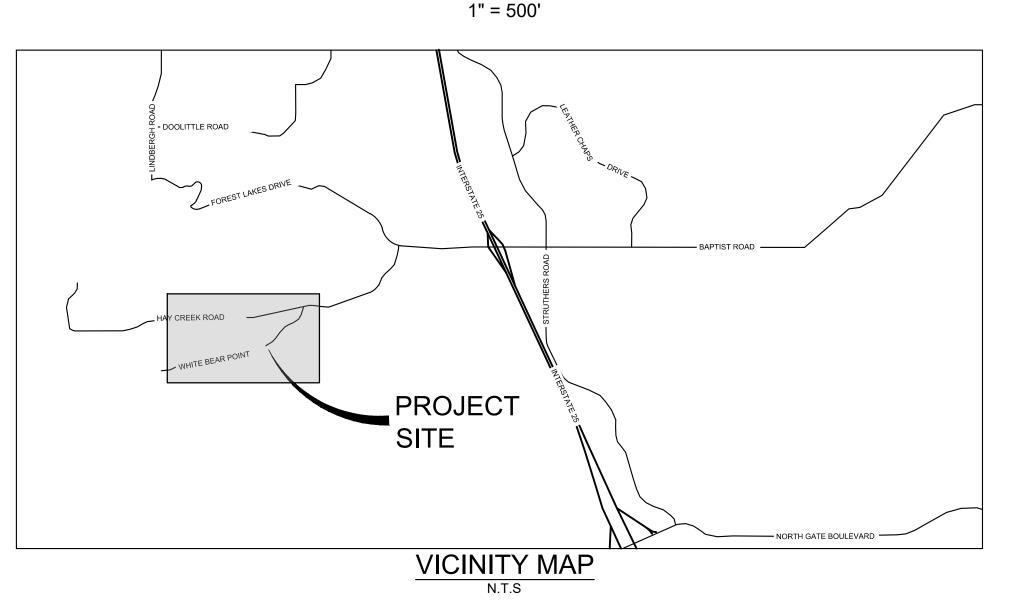

THE LOCATIONS OF EXISTING ABOVE GROUND AND UNDERGROUND UTILITIES ARE SHOWN IN AN APPROXIMATE WAY ONLY. THE CONTRACTOR SHALL DETERMINE THE EXACT LOCATION OF ALL **EXISTING UTILITIES BEFORE COMMENCING WORK. THE** CONTRACTOR SHALL BE FULLY RESPONSIBLE FOR ANY AND ALL DAMAGES WHICH MIGHT BE CAUSED BY HIS FAILURE TO EXACTLY LOCATE AND PRESERVE ANY AND ALL ABOVE GROUND AND **UNDERGROUND UTILITIES.**



OWNER/DEVELOPER'S STATEMENT:

I, THE OWNER/DEVELOPER HAVE READ AND WILL COMPLY WITH ALL OF THE REQUIREMENTS SPECIFIED

VIEW HOMES, INC. 555 MIDDLE CREEK PARKWAY, SUITE 500 COLORADO SPRINGS, CO 80921

TIM BUSCHAR, (719)-382-9433

DESIGN ENGINEER'S STATEMENT

THESE DETAILED PLANS AND SPECIFICATIONS WERE PREPARED UNDER MY DIRECTION AND SUPERVISION SAID DETAILED PLANS AND SPECIFICATIONS HAVE BEEN PREPARED ACCORDING TO THE CRITERION ESTABLISHED BY THE COUNTY FOR DETAILED DRAINAGE PLANS AND SPECIFICATIONS, AND SAID DETAILED PLANS AND SPECIFICATIONS ARE IN CONFORMITY WITH THE MASTER PLAN OF THE DRAINAGE BASIN. SAID DETAILED DRAINAGE PLANS AND SPECIFICATIONS MEET THE PURPOSE FOR WHICH THE PARTICULAR DRAINAGE FACILITY(S) IS DESIGNED. I ACCEPT RESPONSIBILITY FOR ANY LIABILITY CAUSED BY ANY NEGLIGENT ACTS, ERRORS OR OMISSIONS ON MY PART IN PREPARATION OF THE DETAILED DRAINAGE PLANS AND SPECIFICATIONS.

DATE: <u>5/29/2024</u>

FOR AND ON BEHALF OF MATRIX DESIGN GROUP, INC.

JEFFREY A. ODOR, PE #39265

EL PASO COUNTY:

COUNTY PLAN REVIEW IS PROVIDED ONLY FOR GENERAL CONFORMANCE WITH COUNTY DESIGN CRITERIA. THE COUNTY IS NOT RESPONSIBLE FOR THE ACCURACY AND ADEQUACY OF THE DESIGN, DIMENSIONS, AND/OR ELEVATIONS WHICH SHALL BE CONFIRMED AT THE JOB SITE. THE COUNTY THROUGH THE APPROVAL OF THIS DOCUMENT ASSUMES NO RESPONSIBILITY FOR COMPLETENESS AND/OR ACCURACY OF THIS DOCUMENT.

FILED IN ACCORDANCE WITH THE REQUIREMENTS OF THE EL PASO COUNTY LAND DEVELOPMENT CODE, DRAINAGE CRITERIA MANUAL, VOLUMES 1 AND 2, AND ENGINEERING CRITERIA MANUAL AS AMENDED.

IN ACCORDANCE WITH ECM SECTION 1.12, THESE CONSTRUCTION DOCUMENTS WILL BE VALID FOR CONSTRUCTION FOR A PERIOD OF 2 YEARS FROM THE DATE SIGNED BY THE EL PASO COUNTY ENGINEER. IF CONSTRUCTION HAS NOT STARTED WITHIN THOSE 2 YEARS, THE PLANS WILL NEED TO BE RESUBMITTED FOR APPROVAL, INCLUDING PAYMENT OF REVIEW FEES AT THE PLANNING AND COMMUNITY DEVELOPMENT DIRECTORS DISCRETION.

Gilbert LaForce, P.E. Reason: Authorized signatory as County Engineer designee JOSHUA PALMER, P.E.

COUNTY ENGINEER / ECM ADMINISTRATOR

9/9/2024 DATE

THE PARTIES RESPONSIBLE FOR THIS PLAN HAVE FAMILIARIZED THEMSELVES WITH ALL CURRENT ACCESSIBILITY CRITERIA AND SPECIFICATIONS AND THE PROPOSED PLAN REFLECTS ALL SITE ELEMENTS REQUIRED BY THE APPLICABLE ADA DESIGN STANDARDS AND GUIDELINES AS PUBLISHED BY THE UNITED STATES DEPARTMENT OF JUSTICE. APPROVAL OF THIS PLAN BY EL PASO COUNTY DOES NOT ASSURE COMPLIANCE WITH THE ADA OR ANY REGULATIONS OR GUIDELINES ENACTED OR PROMULGATED UNDER OR WITH RESPECT TO SUCH LAWS.

PCD FILE #: SF2324

REFERENCE DRAWINGS	1	02/05/2025	UPDATED STORM SEWER LAYOUT	WCG	
X-TITLE-CD X-886-PR-SITE FEMA_XS X-886.066-EX-MAP-1 164022-01 Hay Creek Road BNDY X-886-ALTA-SURVEY					
Hay Creek BFEs DESCRIPTION					
			REVISIONS		
	FILE N CTB FI PLOT I	AME: S:\22.88 ILE: Matrix.c DATE: 2/5/202			

PROJECT ELEVATIONS ARE NAVD 88 ELEVATIONS BASED ON AN OPUS DERIVED ELEVATION ON CONTROL POINT 10, A NO. 5 REBAR HAVING AN ELEVATION OF 5769.92.

BASIS OF BEARING

THE SOUTH LINE OF THE NORTHWEST QUARTER OF SECTION 22, TOWNSHIP 15 SOUTH, RANGE 65 WEST OF THE 6TH PRINCIPAL MERIDIAN, COUNTY OF EL PASO, STATE OF COLORADO, BEING MONUMENTED ON THE EASTERLY END BY A 2-12" ALUMINUM CAP STAMPED "NOLTE PLS25955 C1/4 S22 T15S, R65W 1999, "AND THE WESTERLY END BY A2-1/2" ALUMINUM CAP STAMPED "SSS PLS 16154 1/4 S21 S22 T15S, R65W 2000, "BEING ASSUMED TO BEAR S89°54'42"W, A DISTANCE OF 2,627.78 FEET.





FOR AND ON BEHALF OF

MATRIX DESIGN GROUP, INC.


PROJECT No. 22.886.076

TITLE SHEET

HAY CREEK VALLEY

EL PASO COUNTY, COLORADO CONSTRUCTION DOCUMENTS

MAY 2024 DRAWING No. DESIGNED BY: DATE ISSUED: CVW HORIZ. DRAWN BY: TS01 _{N/A} SHEET 01 OF 26 CHECKED BY:

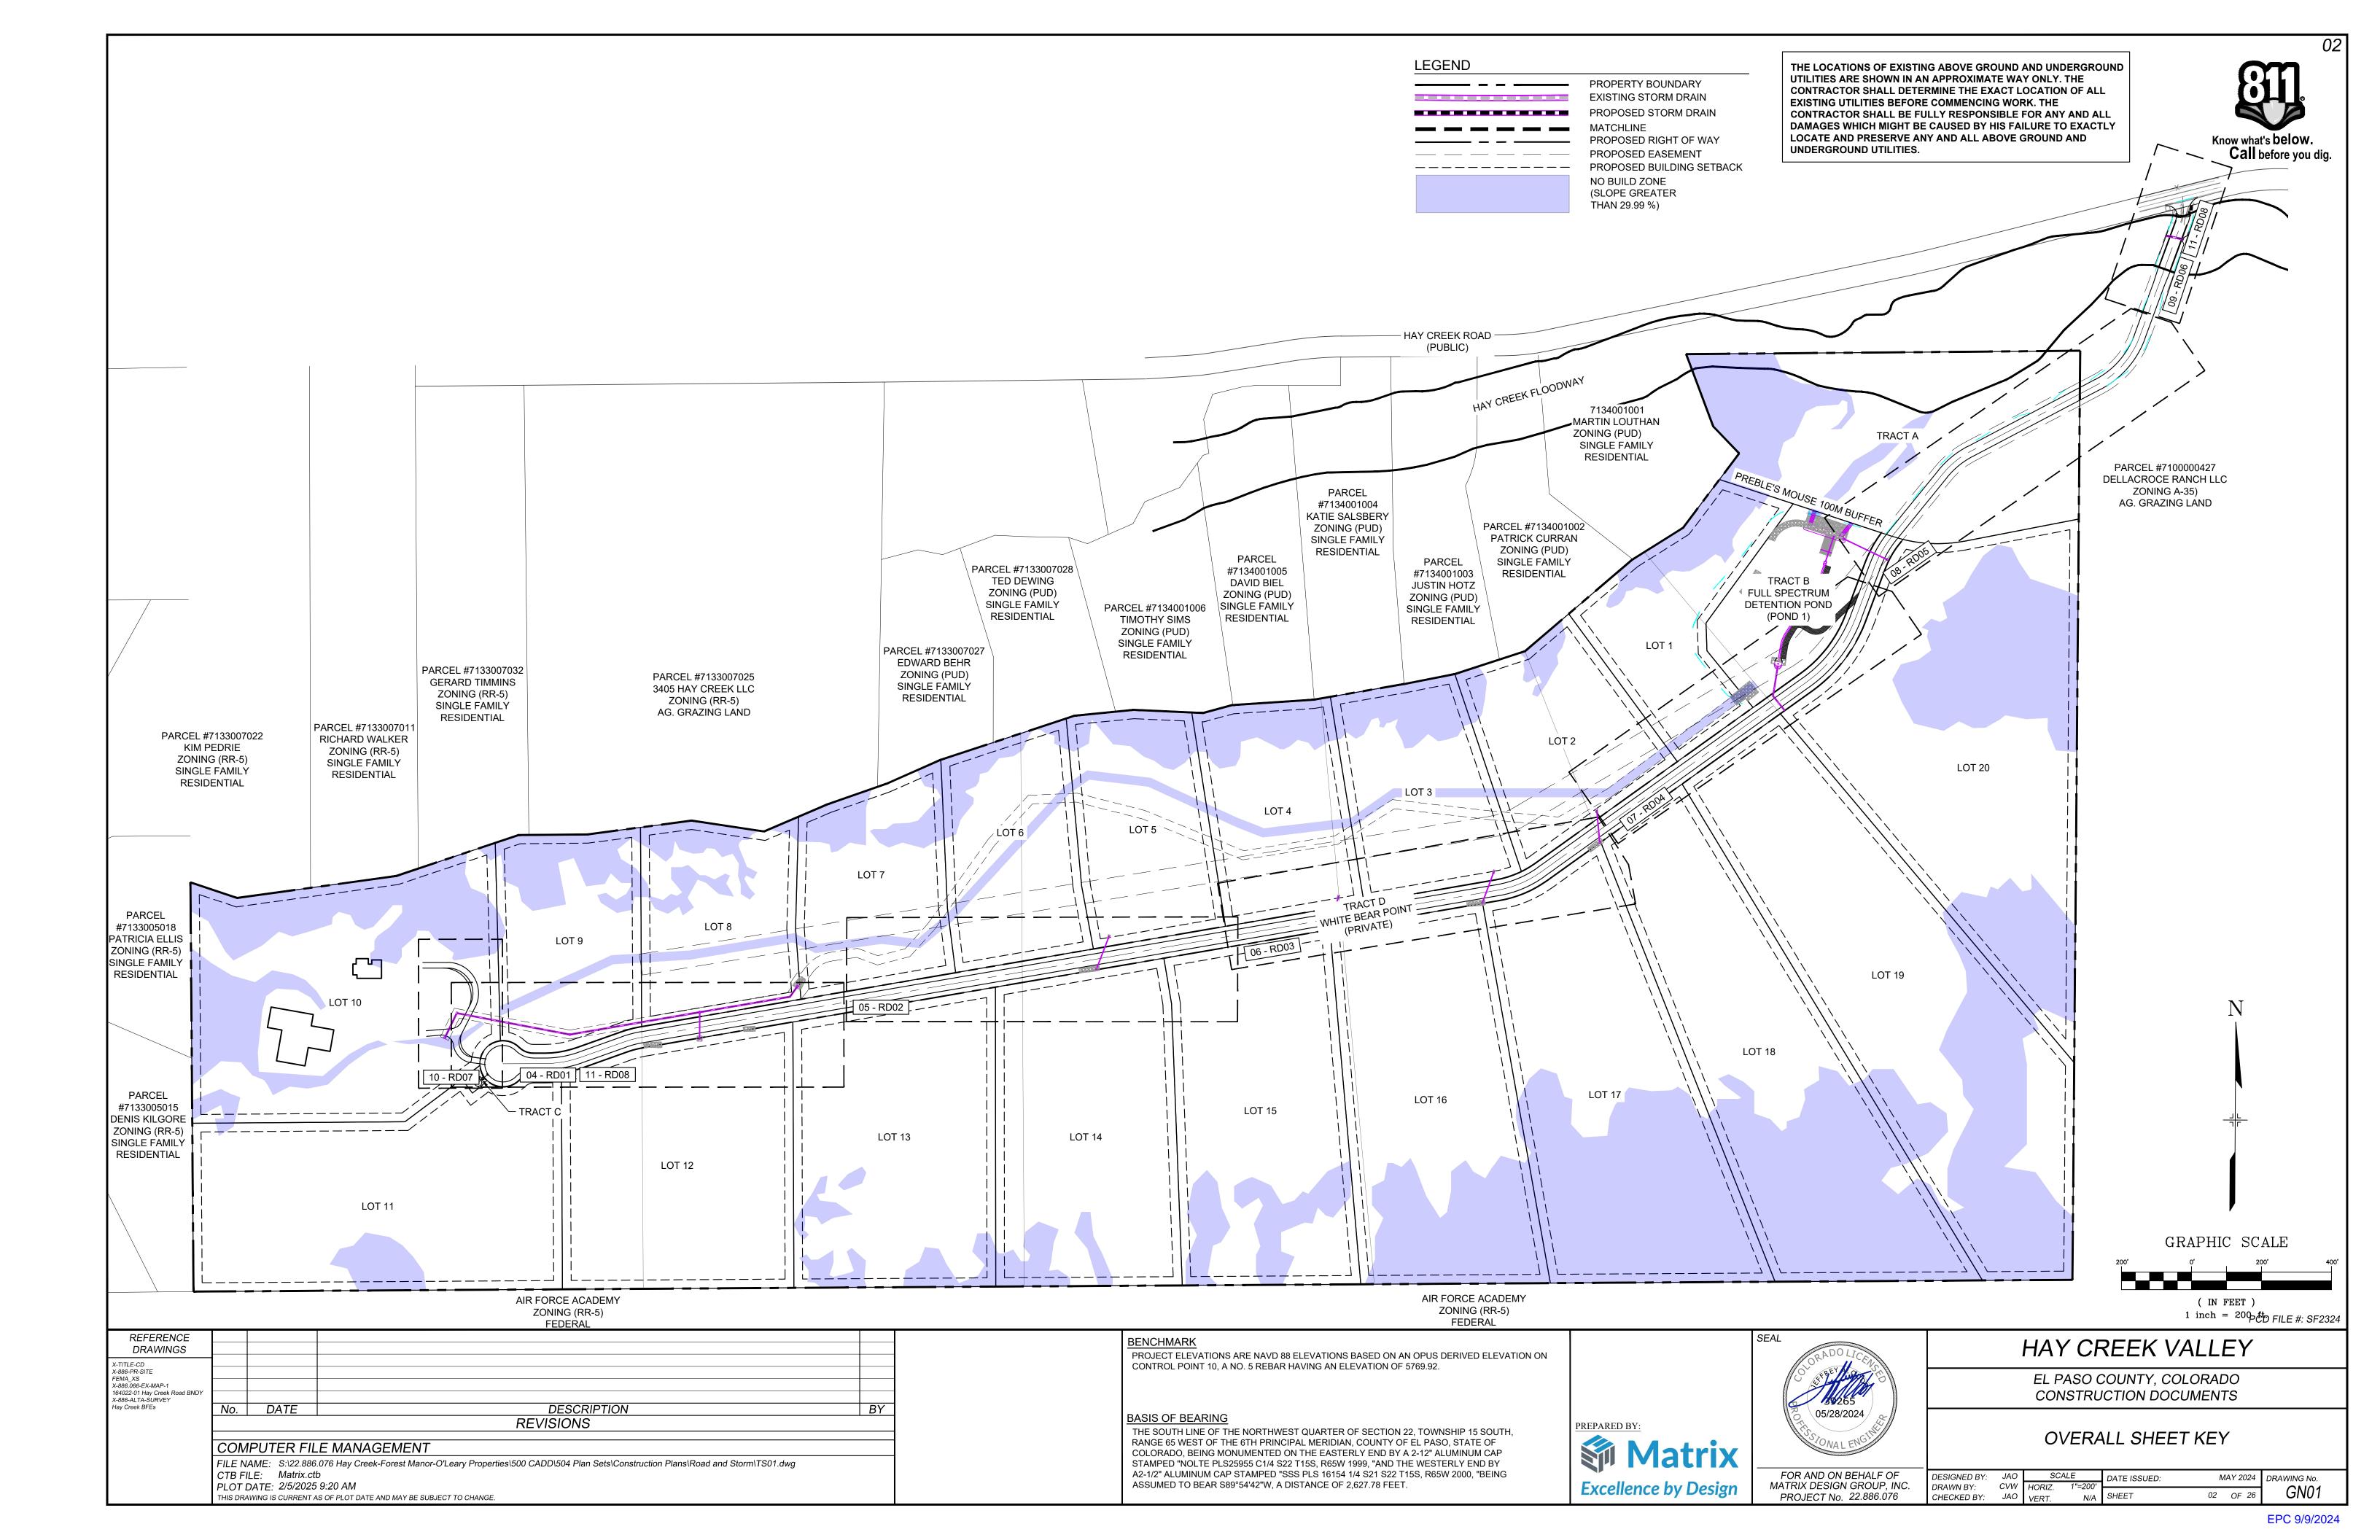

GENERAL NOTES:

- ALL WORK SHALL BE DONE IN ACCORDANCE WITH THE EL PASO COUNTY ENGINEERING CRITERIA MANUAL. REVISED 12-13-2016 AND CDOT STANDARD SPECIFICATIONS. LATEST
- 2. IT SHALL BE THE CONTRACTOR'S RESPONSIBILITY TO ENSURE THAT ALL WORK IS PERFORMED IN ACCORDANCE WITH APPLICABLE STANDARDS AND REGULATIONS AS SET FORTH BY THE OCCUPATIONAL SAFETY AND HEALTH ADMINISTRATION (O.S.H.A.).
- 3. NO FIELD CHANGES SHALL BE MADE WITHOUT PRIOR WRITTEN APPROVAL OF THE FIELD **ENGINEER**
- 4. SUBMITTALS SHALL BE MADE FOR ALL MATERIALS TO BE INCORPORATED INTO THE PROJECT.
- 5. UTILITY LINES AS SHOWN ON THE PLAN SHEETS ARE PLOTTED FROM THE BEST AVAILABLE INFORMATION. THE CONTRACTOR SHALL BE RESPONSIBLE FOR THE VERIFICATION AND PROTECTION OF ALL UTILITIES IN PLACE.
- 6. THE CONTRACTOR SHALL CONTACT THE UTILITY NOTIFICATION CENTER OF COLORADO AT 1-800-922-1987 TWO BUSINESS DAYS IN ADVANCE OF ANY EXCAVATION OR GRADING.
- . THE CONTRACTOR SHALL PROTECT AND MAINTAIN ALL UTILITY AND STRUCTURES AFFECTED BY THE WORK AND ANY DAMAGE SHALL BE REPAIRED AND RESTORED TO THE SATISFACTION OF THE RESPECTIVE UTILITY OWNER. THE CONTRACTOR IS RESPONSIBLE FOR THE LOCATION AND PROTECTION OF ALL UTILITIES DURING CONSTRUCTION. THE CONTRACTOR SHALL COORDINATE ALL UTILITY RELOCATIONS AS NECESSARY. THE COUNTY ENGINEERING INSPECTIONS, UTILITY DEPARTMENTS AND UTILITY OWNERS SHALL BE NOTIFIED A MINIMUM OF 48 HOURS PRIOR TO COMMENCING WORK WHERE THESE UTILITIES MAY BE AFFECTED.
- 8. IN SOME OF THE PROPOSED AREAS OF CONSTRUCTION EXISTING UNDERGROUND TELEPHONE, FIBER AND CABLE TELEVISION FACILITIES MAY BE LOCATED IN CLOSE PROXIMITY TO THE WORK. THE CONTRACTOR MAY, IF NECESSARY, TEMPORARILY DISPLACE THE CABLES DURING CONSTRUCTION AND REINSTALL THEM IN ACCORDANCE WITH THE APPROPRIATE TELEPHONE, FIBER OR CABLE COMPANY'S GUIDELINES. COORDINATION WITH BOTH THE TELEPHONE AND CABLE TELEVISION COMPANY IS REQUIRED TO BE DONE BY THE CONTRACTOR.
- 9. THE CONTRACTOR SHALL OBTAIN AN APPROVED TRAFFIC CONTROL PLAN PRIOR TO COMMENCING CONSTRUCTION ACTIVITIES.
- 10. THE PHYSICAL FEATURES WITHIN THE LIMITS OF THE PROJECT HAVE BEEN SHOWN BASED ON THE BEST AVAILABLE INFORMATION AT THE TIME OF DESIGN. THE ENGINEER ASSUMES NO RESPONSIBILITY FOR THE ACCURACY OF THE FEATURES SHOWN. THE CONTRACTOR SHALL REVIEW AND VERIFY EXISTING PHYSICAL FEATURES AND ELEVATIONS THEMSELVES OF THE CONDITIONS TO BE ENCOUNTERED DURING THE CONSTRUCTION.
- 11. THE CONTRACTOR SHALL LIMIT ALL WORK AND STORAGE AREAS TO THE PUBLIC RIGHT-OF-WAYS AND EASEMENTS. USE OF ANY PRIVATE AREAS FOR THIS PROJECT BY THE CONTRACTOR MUST BE APPROVED IN WRITING BY THE PROPERTY OWNER WITH A COPY OF THIS APPROVAL PROVIDED TO THE FIELD ENGINEER PRIOR TO USAGE
- 12. ALL CONSTRUCTION IS TO INCLUDE COMPACTION AND FINISH GRADING IN THE UNIT PRICE RELATED WORK ITEM.
- 13. ALL WORK SHALL BE DONE TO THE LINES, GRADES, SECTIONS, AND ELEVATIONS SHOWN ON THE PLANS UNLESS OTHERWISE NOTED OR APPROVED BY THE FIELD ENGINEER.
- 14. ALL MATERIALS AND WORKMANSHIP SHALL BE SUBJECT TO INSPECTION AND APPROVAL BY EL PASO COUNTY AND THE FIELD ENGINEER.
- 15. THE FIELD ENGINEER SHALL BE NOTIFIED WITHIN 48 HOURS PRIOR TO THE COMMENCEMENT OF ANY CONSTRUCTION.
- 16. PAYMENT, DIMENSIONS AND RADII ARE SHOWN TO THE LIP OF CURB UNLESS OTHERWISE
- 17. THE CONTRACTOR SHALL LIMIT CONSTRUCTION ACTIVITIES TO THOSE AREAS WITHIN THE LIMITS OF DISTURBANCE AND/OR TOES OF SLOPE AS SHOWN ON THE PLANS. ANY DISTURBANCE BEYOND THESE LIMITS SHALL BE RESTORED TO ORIGINAL CONDITIONS BY THE CONTRACTOR AT HIS/HER OWN EXPENSE.
- 18. THE CONTRACTOR SHALL CLOSELY MONITOR ACCESS FOR HEAVY CONSTRUCTION EQUIPMENT THROUGH THE PROJECT AREAS.
- 19. WHERE PAVEMENT IS TO ABUT EXISTING PAVEMENT, THE EXISTING PAVEMENT SHALL BE REMOVED TO A NEAT VERTICAL LINE BY FULL DEPTH SAWING. SAWING WILL NOT BE PAID FOR SEPARATELY BUT SHALL BE INCIDENTAL TO "REMOVAL OF ASPHALT PAVEMENT". THE CONTRACTOR WILL BE REQUIRED TO PAINT THE EDGE OF CUT PAVEMENT WITH DILUTED EMULSIFIED ASPHALT (SLOW SETTING) PRIOR TO PAVING OPERATIONS. VERTICAL EDGES SHALL NOT REMAIN OVERNIGHT. DILUTED EMULSIFIED ASPHALT FOR TACK COAT SHALL CONSIST OF ONE PART EMULSIFIED ASPHALT AND ONE PART WATER.
- 20. WATER SHALL BE USED AS A DUST PALLIATIVE WHERE REQUIRED. LOCATIONS SHALL BE AS ORDERED. THE COST OF WATER SHALL BE INCIDENTAL TO OTHER BID ITEMS.
- 21. THE PHYSICAL FEATURES REQUIRING REMOVAL OR OBLITERATION WITHIN THE PROJECT SHALL BECOME THE PROPERTY OF THE CONTRACTOR AND BE DISPOSED OF OFF-SITE.
- 22. THE CONTRACTOR SHALL BE RESPONSIBLE FOR PRESERVING ANY MONUMENT, RANGE POINTS, TIES, BENCHMARKS AND/OR SURVEY CONTROL POINTS WHICH MAY BE DISTURBED OR DESTROYED BY CONSTRUCTION. SUCH POINTS SHALL BE REFERENCED AND REPLACED WITH APPROPRIATE MONUMENT BY A REGISTERED PROFESSIONAL LAND SURVEYOR AUTHORIZED TO PRACTICE LAND SURVEYING IN THE STATE OF COLORADO.
- 23. THE CONTRACTOR SHALL HAVE A COPY OF ALL APPLICABLE STANDARDS AND PLANS ON SITE FOR THE DURATION OF THE PROJECT.
- 24. THE CONTRACTOR SHALL NOT STOCKPILE MATERIAL WITHIN 10 FEET OF THE EDGE OF TRAVELED WAY
- 25. ANY LAYER OF BITUMINOUS PAVEMENT THAT IS TO HAVE SUCCEEDING LAYER PLACED THEREON SHALL BE COMPLETED FULL WIDTH BEFORE SUCCEEDING LAYER IS PLACED.
- 26. BEFORE PLACEMENT OF THE TACK COAT, THE CONTRACTOR SHALL CLEAN THE PRESENT ROADWAY AS DIRECTED. CLEANING WILL NOT BE PAID FOR SEPARATELY, BUT SHALL BE INCLUDED IN THE COST OF THE PROJECT.

GENERAL NOTES con't.

- 27. A TACK COAT OF EMULSIFIED ASPHALT (SLOW SETTING) IS TO BE APPLIED BETWEEN PAVEMENT COURSES TO IMPROVE BOND. DILUTED EMULSIFIED ASPHALT FOR TACK COAT SHALL CONSIST OF 1 PART EMULSIFIED ASPHALT AND 1 PART WATER.
- 28. THE CONTRACTOR SHALL FURNISH, INSTALL, AND MAINTAIN TEMPORARY TRAFFIC CONTROL DEVICES NECESSARY THROUGHOUT THE DURATION OF CONSTRUCTION. THE CONTRACTOR SHALL CONTACT TRAFFIC ENGINEERING FORTY-EIGHT (48) HOURS IN ADVANCE FOR ANY REQUIRED MODIFICATION OF TRAFFIC SIGNALS WITHIN CONSTRUCTION AREAS AS NECESSARY TO MAINTAIN SAFE OPERATIONS.
- 29. ANY DISCREPANCY WITHIN THESE PLANS SHOULD BE BROUGHT TO THE IMMEDIATE ATTENTION OF THE ENGINEER AND WORK SHALL STOP UNTIL THE DISCREPANCY IS DISCUSSED AND DECISIONS/AGREEMENTS HAVE BEEN MADE

- THE CONTRACTOR SHALL BE RESPONSIBLE FOR THE LEGAL DISPOSAL OF ANY EXCESS SOIL, DEBRIS AND WASTE MATERIAL OFF OF THE PROJECT SITE.
- ANY MATERIAL NOT SUITABLE FOR BACKFILL SHALL BE REMOVED FROM THE SITE AND DISPOSED OF, BY AND AT THE EXPENSE OF THE CONTRACTOR.
- ANY SOIL LYING BELOW THE SUBGRADE ELEVATION WHICH IS DISTURBED BY CONSTRUCTION OPERATIONS SHALL BE REMOVED AND REPLACED WITH STRUCTURAL FILL IN ACCORDANCE WITH THE SPECIFICATION REQUIREMENTS

BENCHMARK AND SURVEY CONTROL

- THE CONTRACTOR SHALL BE RESPONSIBLE FOR CONSTRUCTION STAKING OF BOTH HORIZONTAL AND VERTICAL LAYOUT ON THIS PROJECT. COORDINATES ARE REFERENCED IN THE COORDINATE LIST SHOWN ON THESE PLANS. THE CONTRACTOR SHALL COORDINATE WITH THE PROJECT ENGINEER FOR INTERPRETATION AND INFORMATION IN STAKING OF THE PROJECT FOR CONSTRUCTION.
- PRIOR TO PROJECT COMPLETION, THE CONTRACTOR SHALL BE RESPONSIBLE FOR THE REPLACEMENT OF ANY PROPERTY MONUMENTATION DISTURBED OR REMOVED BY CONSTRUCTION OPERATIONS. THIS WORK SHALL BE PERFORMED BY A LAND SURVEYOR LICENSED IN THE STATE OF COLORADO. PROPERTY CORNERS WHICH FALL WITHIN NEW CONCRETE FLATWORK SHALL BE DURABLE AND SET FLUSH. THIS SHALL BE CONSIDERED INCIDENTAL TO THE PROJECT

RAFFIC GENERAL NOTES

- THE CONTRACTOR SHALL PREPARE A DETAILED TRAFFIC CONTROL PLAN, SUBMIT TO EL PASO COUNTY DEPARTMENT OF PUBLIC WORKS FOR APPROVAL, AND OBTAIN APPROPRIATE PERMITS IN ACCORDANCE WITH THE M.U.T.C.D.
- THE CONTRACTOR SHALL BE RESPONSIBLE FOR ALL WORK ZONE TRAFFIC CONTROL, INCLUDING PEDESTRIAN DETOURS. CONTRACTOR SHALL BE RESPONSIBLE FOR FURNISHING, INSTALLING, AND MAINTAINING THE TEMPORARY TRAFFIC CONTROL DEVICES THROUGHOUT THE DURATION OF THE PROJECT
- APPROVAL OF THESE PLANS BY THE COUNTY ENGINEER DOES NOT AUTHORIZE ANY WORK TO BE PERFORMED UNTIL A PERMIT HAS BEEN ISSUED.
- 4. THE APPROVAL OF THESE PLANS OR ISSUANCE OF A PERMIT BY EL PASO COUNTY DOES NOT AUTHORIZE THE OWNER OR CONTRACTOR TO VIOLATE ANY FEDERAL, STATE OR CITY LAWS, ORDINANCES, REGULATIONS, OR POLICIES.
- ALL TRAFFIC SIGNS, PAVEMENT MARKINGS, AND TRAFFIC SIGNALS SHALL MEET OR EXCEED M.U.T.C.D. STANDARDS.
- 6. THE CONTRACTOR SHALL NOT REMOVE ANY EXISTING SIGNS, PAVEMENT MARKINGS, OR TRAFFIC SIGNALS DURING THE PROJECT WITHOUT SIGNED AUTHORIZATION OF THE EL PASO COUNTY INSPECTOR ASSIGNED TO THE PROJECT

CONSTRUCTION NOTES:

- ALL DRAINAGE AND ROADWAY CONSTRUCTION SHALL MEET THE STANDARDS AND SPECIFICATIONS OF THE EL PASO COUNTY DRAINAGE CRITERIA MANUAL, VOLUMES 1 AND 2, AND THE EL PASO COUNTY ENGINEERING CRITERIA MANUAL.
- 2. CONTRACTOR SHALL BE RESPONSIBLE FOR THE NOTIFICATION AND FIELD NOTIFICATION OF ALL EXISTING UTILITIES, WHETHER SHOWN ON THE PLANS OR NOT, BEFORE BEGINNING CONSTRUCTION. LOCATION OF EXISTING UTILITIES SHALL BE VERIFIED BY THE CONTRACTOR PRIOR TO CONSTRUCTION. CALL 811 TO CONTACT THE UTILITY NOTIFICATION CENTER OF COLORADO (UNCC).
- CONTRACTOR SHALL KEEP A COPY OF THESE APPROVED PLANS, THE GRADING AND EROSION CONTROL PLAN. THE STORMWATER MANAGEMENT PLAN (SWMP). THE SOILS AND GEOTECHNICAL REPORT, AND THE APPROPRIATE DESIGN AND CONSTRUCTION STANDARDS AND SPECIFICATIONS AT THE JOB SITE AT ALL TIMES, INCLUDING THE FOLLOWING:
- a. EL PASO COUNTY ENGINEERING CRITERIA MANUAL (ECM)
- b. EL PASO COUNTY DRAINAGE CRITERIA MANUAL, VOLUMES 1 AND 2
- c. COLORADO DEPARTMENT OF TRANSPORTATION (CDOT) STANDARD SPECIFICATIONS FOR ROAD AND BRIDGE CONSTRUCTION
- d. CDOT M & S STANDARDS
- NOTWITHSTANDING ANYTHING DEPICTED IN THESE PLANS IN WORDS OR GRAPHIC REPRESENTATION, ALL DESIGN AND CONSTRUCTION RELATED TO ROADS, STORM DRAINAGE AND EROSION CONTROL SHALL CONFORM TO THE STANDARDS AND REQUIREMENTS OF THE MOST RECENT VERSION OF THE RELEVANT ADOPTED EL PASO COUNTY STANDARDS, INCLUDING THE LAND DEVELOPMENT CODE, THE ENGINEERING CRITERIA MANUAL, THE DRAINAGE CRITERIA MANUAL, AND THE DRAINAGE CRITERIA MANUAL VOLUME 2. ANY DEVIATIONS FROM REGULATIONS AND STANDARDS MUST BE REQUESTED, AND APPROVED, IN WRITING. ANY MODIFICATIONS NECESSARY TO MEET CRITERIA AFTER-THE-FACT WILL BE ENTIRELY THE DEVELOPER'S RESPONSIBILITY TO RECTIFY.
- IT IS THE DESIGN ENGINEER'S RESPONSIBILITY TO ACCURATELY SHOW EXISTING CONDITIONS, BOTH ONSITE AND OFFSITE, ON THE CONSTRUCTION PLANS. ANY MODIFICATIONS NECESSARY DUE TO CONFLICTS, OMISSIONS, OR CHANGED CONDITIONS WILL BE ENTIRELY THE DEVELOPER'S RESPONSIBILITY TO RECTIFY.

CONSTRUCTION NOTES con't.:

- 6. CONTRACTOR SHALL SCHEDULE A PRE-CONSTRUCTION MEETING WITH EL PASO COUNTY PLANNING AND COMMUNITY DEVELOPMENT (PCD) -INSPECTIONS, PRIOR TO STARTING CONSTRUCTION.
- IT IS THE CONTRACTOR'S RESPONSIBILITY TO UNDERSTAND THE REQUIREMENTS OF ALL JURISDICTIONAL AGENCIES AND TO OBTAIN ALL REQUIRED PERMITS, INCLUDING BUT NOT LIMITED TO EL PASO COUNTY EROSION AND STORMWATER QUALITY CONTROL PERMIT (ESQCP), REGIONAL BUILDING FLOODPLAIN DEVELOPMENT PERMIT, U.S. ARMY CORPS OF ENGINEERS-ISSUED 401 AND/OR 404 PERMITS, AND COUNTY AND STATE FUGITIVE DUST PERMITS.
- 8. CONTRACTOR SHALL NOT DEVIATE FROM THE PLANS WITHOUT FIRST OBTAINING WRITTEN APPROVAL FROM THE DESIGN ENGINEER AND PCD. CONTRACTOR SHALL NOTIFY THE DESIGN ENGINEER IMMEDIATELY UPON DISCOVERY OF ANY ERRORS OR INCONSISTENCIES.
- 9. ALL STORM DRAIN PIPE SHALL BE CLASS III RCP UNLESS OTHERWISE NOTED AND APPROVED BY PCD.
- 10. CONTRACTOR SHALL COORDINATE GEOTECHNICAL TESTING PER ECM STANDARDS. PAVEMENT DESIGN SHALL BE APPROVED BY EL PASO COUNTY PCD PRIOR TO PLACEMENT OF CURB AND GUTTER AND PAVEMENT
- 11. ALL CONSTRUCTION TRAFFIC MUST ENTER/EXIT THE SITE AT APPROVED CONSTRUCTION ACCESS POINTS.
- 12. SIGHT VISIBILITY TRIANGLES AS IDENTIFIED IN THE PLANS SHALL BE PROVIDED AT ALL INTERSECTIONS. OBSTRUCTIONS GREATER THAN 18 INCHES ABOVE FLOWLINE ARE NOT ALLOWED WITHIN SIGHT TRIANGLES.
- 13. SIGNING AND STRIPING SHALL COMPLY WITH EL PASO COUNTY DOT AND MUTCD CRITERIA. [IF APPLICABLE, ADDITIONAL SIGNING AND STRIPING NOTES WILL BE PROVIDED.1
- CONTRACTOR SHALL OBTAIN ANY PERMITS REQUIRED BY EL PASO COUNTY DOT, INCLUDING WORK WITHIN THE RIGHT-OF-WAY AND SPECIAL TRANSPORT PERMITS.
- 15. THE LIMITS OF CONSTRUCTION SHALL REMAIN WITHIN THE PROPERTY LINE UNLESS OTHERWISE NOTED. THE OWNER/DEVELOPER SHALL OBTAIN WRITTEN PERMISSION AND EASEMENTS, WHERE REQUIRED, FROM ADJOINING PROPERTY OWNER(S) PRIOR TO ANY OFF-SITE DISTURBANCE, GRADING, OR CONSTRUCTION.

SIGNING & STRIPING NOTES:

- ALL SIGNS AND PAVEMENT MARKINGS SHALL BE IN COMPLIANCE WITH THE CURRENT MANUAL ON UNIFORM TRAFFIC CONTROL DEVICES (MUTCD).
- 2. REMOVAL OF EXISTING PAVEMENT MARKINGS SHALL BE ACCOMPLISHED BY A METHOD THAT DOES NOT MATERIALLY DAMAGE THE PAVEMENT. THE PAVEMENT MARKINGS SHALL BE REMOVED TO THE EXTENT THAT THEY WILL NOT BE VISIBLE UNDER DAY OR NIGHT CONDITIONS. AT NO TIME WILL IT BE ACCEPTABLE TO PAINT OVER EXISTING PAVEMENT MARKINGS
- ANY DEVIATION FROM THE STRIPING AND SIGNING PLAN SHALL BE APPROVED BY EL PASO COUNTY PLANNING AND COMMUNITY **DEVELOPMENT**
- 4. ALL SIGNS SHOWN ON THE SIGNING AND STRIPING PLAN SHALL BE NEW SIGNS. EXISTING SIGNS MAY REMAIN OR BE REUSED IF THEY MEET CURRENT EL PASO COUNTY AND MUTCD STANDARDS.
- 5. STREET NAME AND REGULATORY STOP SIGNS SHALL BE ON THE SAME POST
- 6. ALL REMOVED SIGNS SHALL BE DISPOSED OF IN A PROPER MANNER BY THE CONTRACTOR.
- 7. ALL STREET NAME SIGNS SHALL HAVE "D" SERIES LETTERS, WITH LOCAL ROADWAY SIGNS BEING 4" UPPER-LOWER CASE LETTERING ON 8" BLANK AND NON-LOCAL ROADWAY SIGNS BEING 6" LETTERING, UPPER-LOWER CASE ON 12" BLANK, WITH A WHITE BORDER THAT IS NOT RECESSED. MULTI-LANE ROADWAYS WITH SPEED LIMITS OF 40 MPH OR HIGHER SHALL HAVE 8" UPPER-LOWER CASE LETTERING ON 18" BLANK WITH A WHITE BORDER THAT IS NOT RECESSED. THE WIDTH OF THE NON-RECESSED WHITE BORDERS SHALL MATCH PAGE 255 OF THE 2012 MUTCD "STANDARD **HIGHWAY SIGNS"**
- 8. ALL TRAFFIC SIGNS SHALL HAVE A MINIMUM HIGH INTENSITY PRISMATIC GRADE SHEETING.
- ALL LOCAL RESIDENTIAL STREET SIGNS SHALL BE MOUNTED ON A 1.75" X 1.75" SQUARE TUBE SIGN POST AND STUB POST BASE. FOR OTHER APPLICATIONS, REFER TO THE CDOT STANDARD S-614-8 REGARDING USE OF THE P2 TUBULAR STEEL POST SLIPBASE DESIGN.
- 10. ALL SIGNS SHALL BE SINGLE SHEET ALUMINUM WITH 0.100" MINIMUM THICKNESS.
- 11. ALL LIMIT LINES/STOP LINES, CROSSWALK LINES, PAVEMENT LEGENDS, AND ARROWS SHALL BE A MINIMUM 125 MIL THICKNESS PREFORMED THERMOPLASTIC PAVEMENT MARKINGS WITH TAPERED LEADING EDGES PER CDOT STANDARD S-627-1. WORD AND SYMBOL MARKINGS SHALL BE THE NARROW TYPE. STOP BARS SHALL BE 24" IN WIDTH. CROSSWALKS LINES SHALL BE 12" WIDE AND 8' LONG PER CDOT S-627-1.
- 12. ALL LONGITUDINAL LINES SHALL BE A MINIMUM 15MIL THICKNESS EPOXY PAINT. ALL NON-LOCAL RESIDENTIAL ROADWAYS SHALL INCLUDE BOTH RIGHT AND LEFT EDGE LINE STRIPING AND ANY ADDITIONAL STRIPING AS REQUIRED BY CDOT S-627-1.
- 13. THE CONTRACTOR SHALL NOTIFY EL PASO COUNTY PLANNING AND COMMUNITY DEVELOPMENT (719) 520-6819 PRIOR TO AND UPON COMPLETION OF SIGNING AND STRIPING.
- 14. THE CONTRACTOR SHALL OBTAIN A WORK IN THE RIGHT OF WAY PERMIT FROM THE EL PASO COUNTY DEPARTMENT OF PUBLIC WORKS (DPW) PRIOR TO ANY SIGNAGE OR STRIPING WORK WITHIN AN EXISTING EL PASO COUNTY ROADWAY.

NORMAL CROWN ALGEBRAIC DIFFERENCE NIC **NOT IN CONTRACT ASSEMBLY** NO NUMBER AMERICAN SOCIETY OF TESTING AND MATERIALS NOM **NOMINAL** APPROXIMATE or APPROXIMATELY NTS NOT TO SCALE **AVENUE** OC ON CENTER **AVERAGE** Know what's **below** O/S OFFSET **BACK OF CURB** Call before you dig. PROPOSED BASELINE PC POINT OF CURVATURE **BOULEVARD** PCC POINT OF COMPOUND CURVE BOTTOM PCR POINT OF CURB RETURN

ABBREVIATIONS con't:

STREET

BOW **BOTTOM OF WALI** PLAIN END **CAST IRON** PIE PUBLIC IMPROVEMENT EASEMENT CEN CENTER PGL PROFILE GRADE LINE € or CL CENTERLINE PROPERTY LINE ₽ or P/L CFS CUBIC FEET PER SECOND PRC POINT OF REVERSE CURVE CLR CLEAR PΤ POINT OF TANGENCY CMP CORRUGATED METAL PIPE PVC POINT OF VERTICAL CURVE or POLYVINYL CHLORIDE CONC CONCRETE PVI POINT OF VERTICAL INTERSECTION CONST CONSTRUCTION PVMT PAVEMENT CONT CONTINUOUS PVT POINT OF VERTICAL TANGENT DIA DIAMETER R OR RAD RADIUS DN DOWN REVERSE CROWN DWG **DRAWING** RCP REINFORCED CONCRETE PIPE **EACH** RED REDUCER **ENERGY GRADE LINE REF REFERENCE** ELEVATION REINF REINFORCING **ELBOW** REQUIRED

EGL ELEV or EL ELL **REQ ESMT** EASEMENT REV REVISION **EACHWAY** EW **ROW** RIGHT-OF-WAY EXISTING EX or EXIST RIGHT FES FLARED END **SCHEDULE** SCH FIN FINISHED SD STORM SEWER **FLOWLINE** ਾ or FL SHLD **SHOULDER** FLG FLANGE SQ SQUARE

STA STATION GAL GALLON STD STANDARD GALV GALVANIZED STL STEEL GAU **GAUGE (MATERIAL)** SS OR SAN SANITARY SEWER **GATE VALVE** SW OR S/W SIDEWALK **GROUNDWATER** GW TAN TANGENT HBP HOT BITUMINOUS PAVEMENT THRUST BLOCK HGL HYDRAULIC GRADE LINE TOP BACK OF CURB **HIGH POINT** TFC TOP FACE OF CURB

HORIZ HORIZONTAL THD THREADED HCL HORIZONTAL CONTROL LINE THK THICKNESS **TOW** TOP OF WALL **INVERT** TYP **TYPICAL** VERTICAL CURVE FACTOR UG **UNDERGROUND POUNDS** UTIL UTILITY LINEAR FEET VERTICAL CURVE VC LANE

VERT VERTICAL **LOW POINT** WIDTH LANDSCAPING I FFT MAXIMUM MAX

MFGR MANUFACTURER MH MANHOLE MID MIDDLE or MIDPOINT MIN MINIMUM

MECHANICAL JOINT

MEAN SEA LEVEL

FOOT / FEET

FIBERGLASS REINFORCED PIPE

ABBREVIATIONS:

ASSY

ASTM

AVE

AVG

B/C

₽ or B/L

BLVD

BTM

FT

FRP

MSL

APPROX

* PAVEMENT SECTION TO BE DESIGNED BY GEOTECHNICAL ENGINEER PER EPC SPECIFICATIONS. (3" ASPHALT, 4" BASE **IMPROVEMENT** COURSE FOR BIDDING PURPOSES) EASEMENT 28' ASPHALT PAVEMENT 12' TRAVEL LANE TRAVEL LANE SHLD. —ROADSIDE SWALE

PRIVATE RURAL LOCAL ROADWAY **FXISTING** 25 MPH POSTED: 25 MPH DESIGN GRADE NOT TO SCALE

* PAVEMENT SECTION TO BE DESIGNED BY GEOTECHNICAL 10' PUBLIC ENGINEER PER EPC SPECIFICATIONS. (3" ASPHALT, 4" BASE **IMPROVEMENT** IMPROVEMENT COURSE FOR BIDDING PURPOSES EASEMENT EASEMENT 28' ASPHALT PAVEMENT —CATCH **EXISTING** VARIES VARIES ¬ GRADE TRAVEL LANE TRAVEL LANE SHLD. SHLD. The state of the s **EXISTING** PRIVATE RURAL LOCAL ROADWAY 2 GRADE 25 MPH POSTED; 25 MPH DESIGN PCD FILE #: SF2324 NOT TO SCALE

DESIGNED BY:

CHECKED BY:

DRAWN BY:

CVW HORIZ.

REFERENCE DRAWINGS X-TITLE-CD X-886-PR-SITE (-886.066-EX-MAP-1 1022-01 Hav Creek Road BND (-886-ALTA-SURVEY DESCRIPTION Hay Creek BFEs No. DATE REVISIONS COMPUTER FILE MANAGEMENT FILE NAME: S:\22.886.076 Hay Creek-Forest Manor-O'Leary Properties\500 CADD\504 Plan Sets\Construction Plans\Road and Storm\TS01.dwg CTB FILE: Matrix.ctb PLOT DATE: 2/5/2025 9:21 AM THIS DRAWING IS CURRENT AS OF PLOT DATE AND MAY BE SUBJECT TO CHANGE

PROJECT ELEVATIONS ARE NAVD 88 ELEVATIONS BASED ON AN OPUS DERIVED ELEVATION ON CONTROL POINT 10, A NO. 5 REBAR HAVING AN ELEVATION OF 5769.92.

BASIS OF BEARING

THE SOUTH LINE OF THE NORTHWEST QUARTER OF SECTION 22, TOWNSHIP 15 SOUTH, RANGE 65 WEST OF THE 6TH PRINCIPAL MERIDIAN, COUNTY OF EL PASO, STATE OF COLORADO, BEING MONUMENTED ON THE EASTERLY END BY A 2-12" ALUMINUM CAP STAMPED "NOLTE PLS25955 C1/4 S22 T15S, R65W 1999, "AND THE WESTERLY END BY A2-1/2" ALUMINUM CAP STAMPED "SSS PLS 16154 1/4 S21 S22 T15S, R65W 2000, "BEING ASSUMED TO BEAR S89°54'42"W, A DISTANCE OF 2,627.78 FEET.



FOR AND ON BEHALF OF

PROJECT No. 22.886.076

HAY CREEK VALLEY

EL PASO COUNTY, COLORADO CONSTRUCTION DOCUMENTS

GENERAL NOTES

N/A SHEET

SCALE MAY 2024 DRAWING No. DATE ISSUED:

EPC 9/9/2024

03 OF 26

GN02

10' PUBLIC

IMPROVEMENT

EASEMENT


VARIES


EXISTING GRADE

ROADSIDE-


SWALE


CATCH-

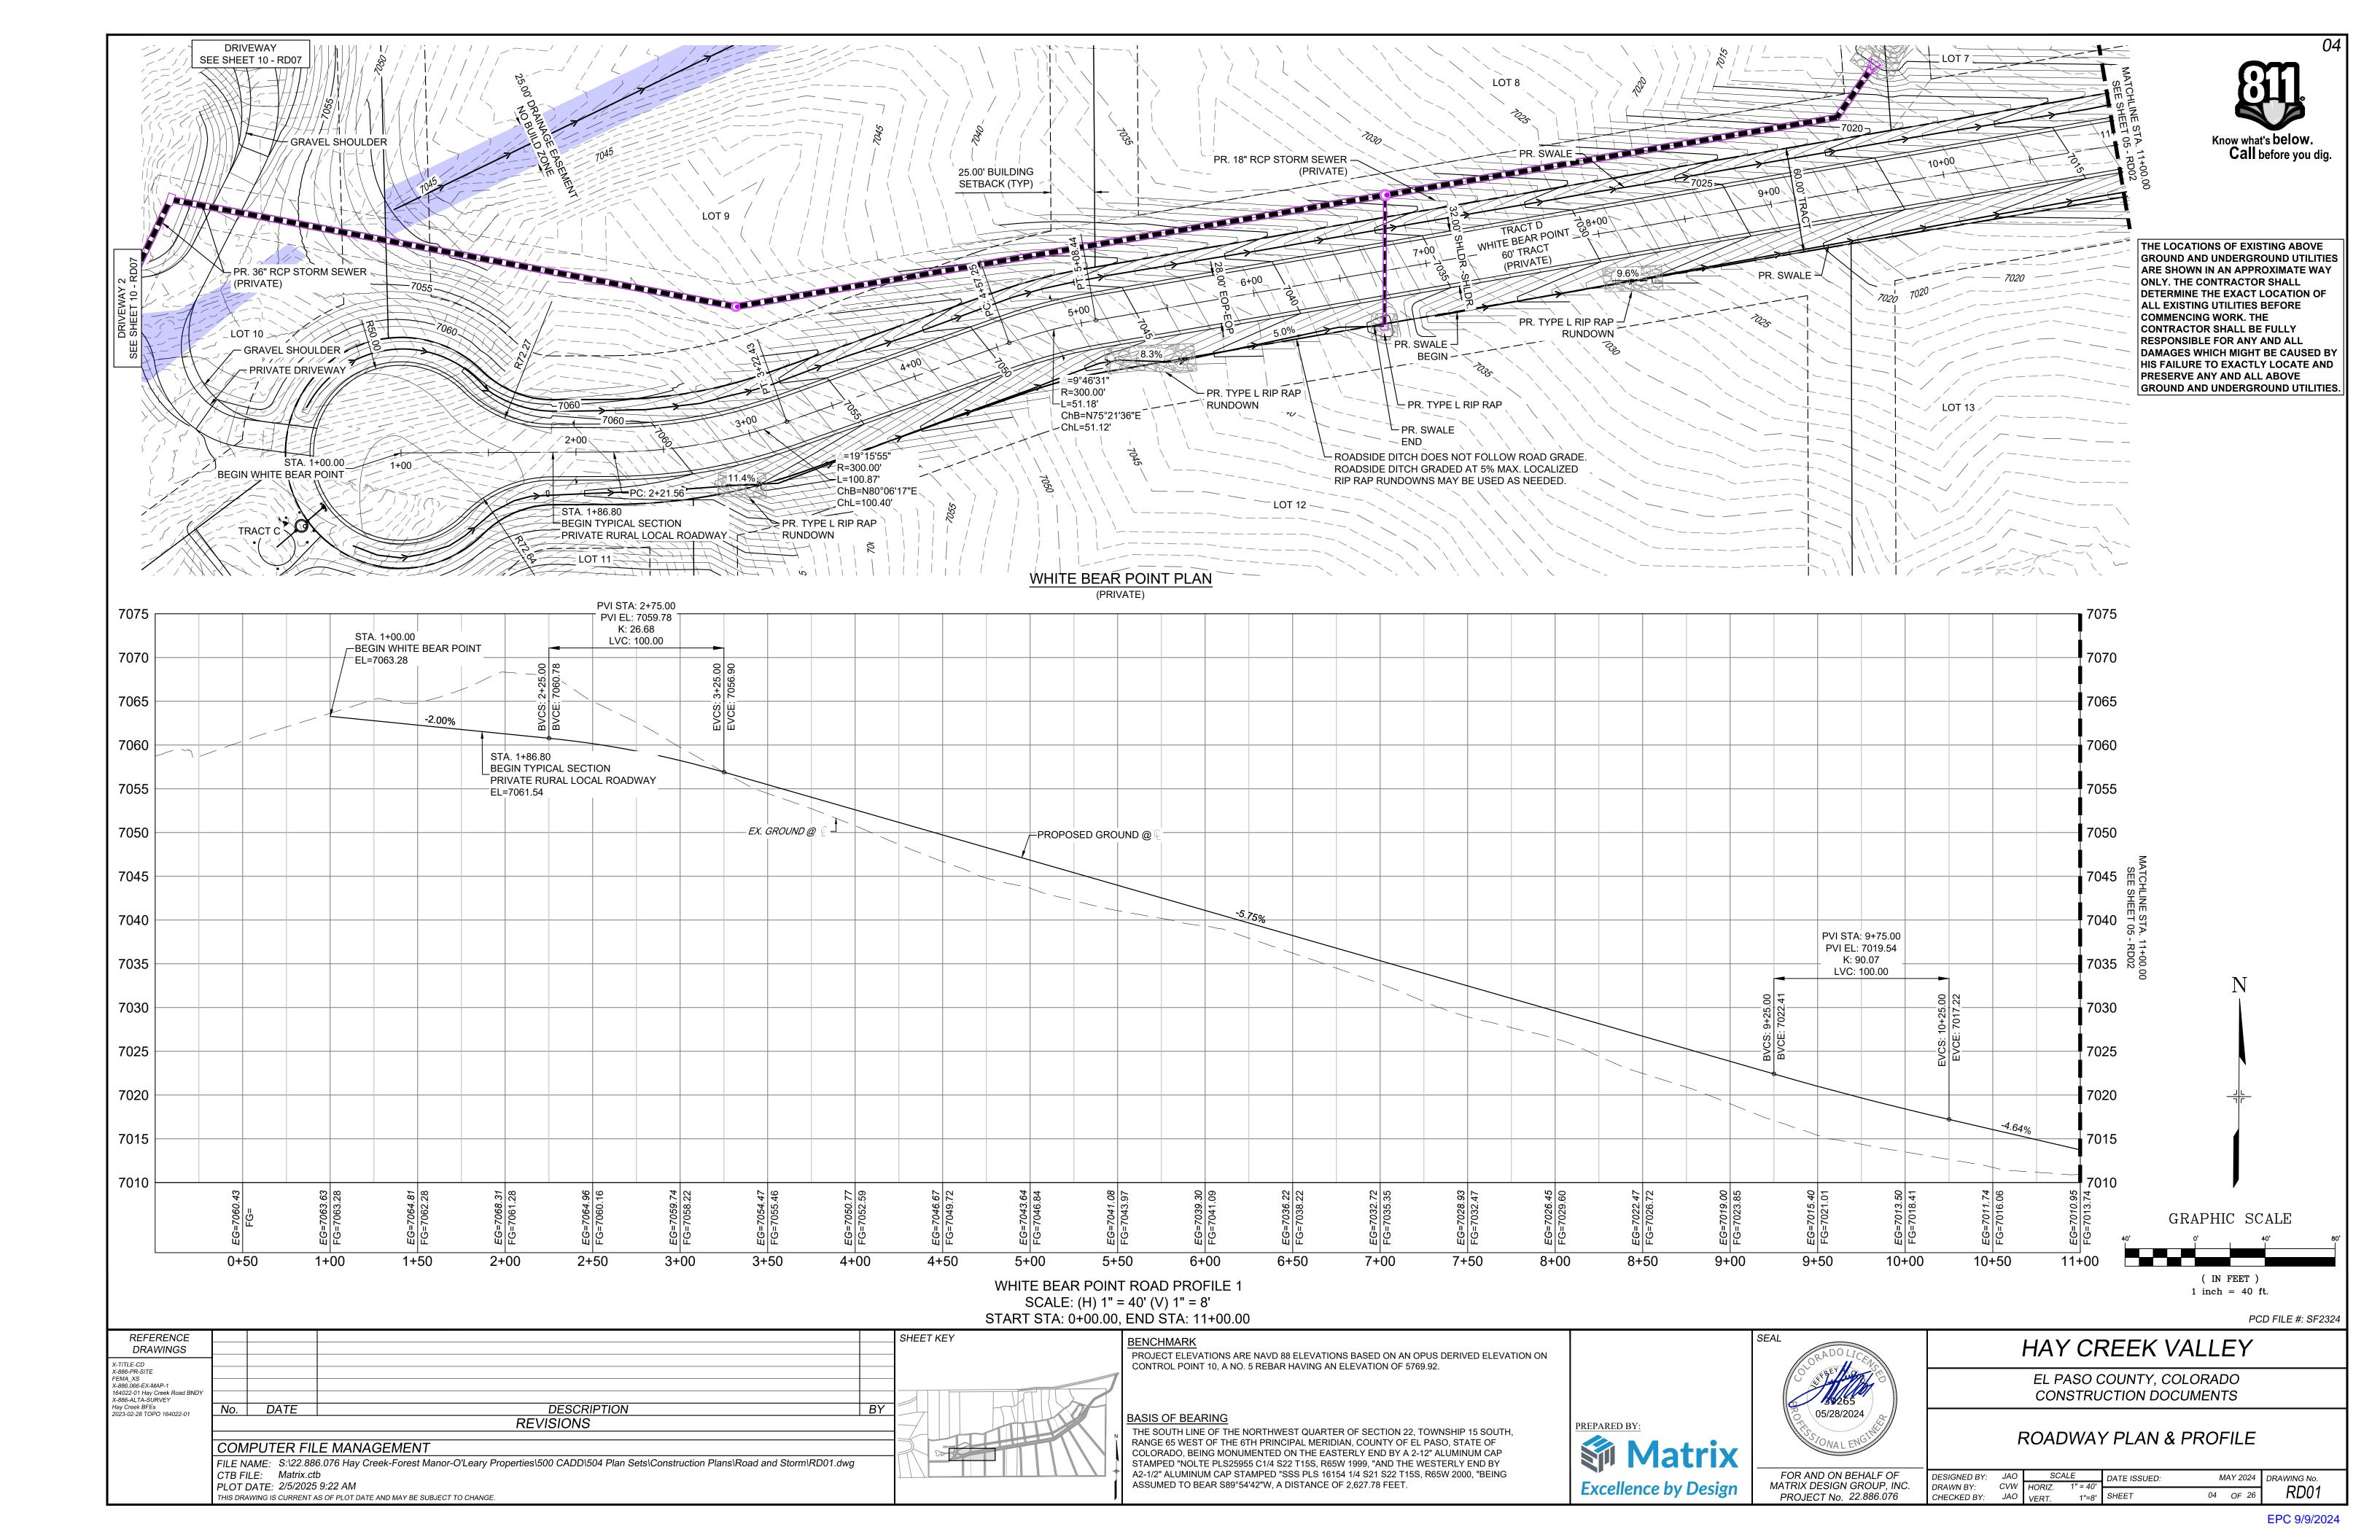

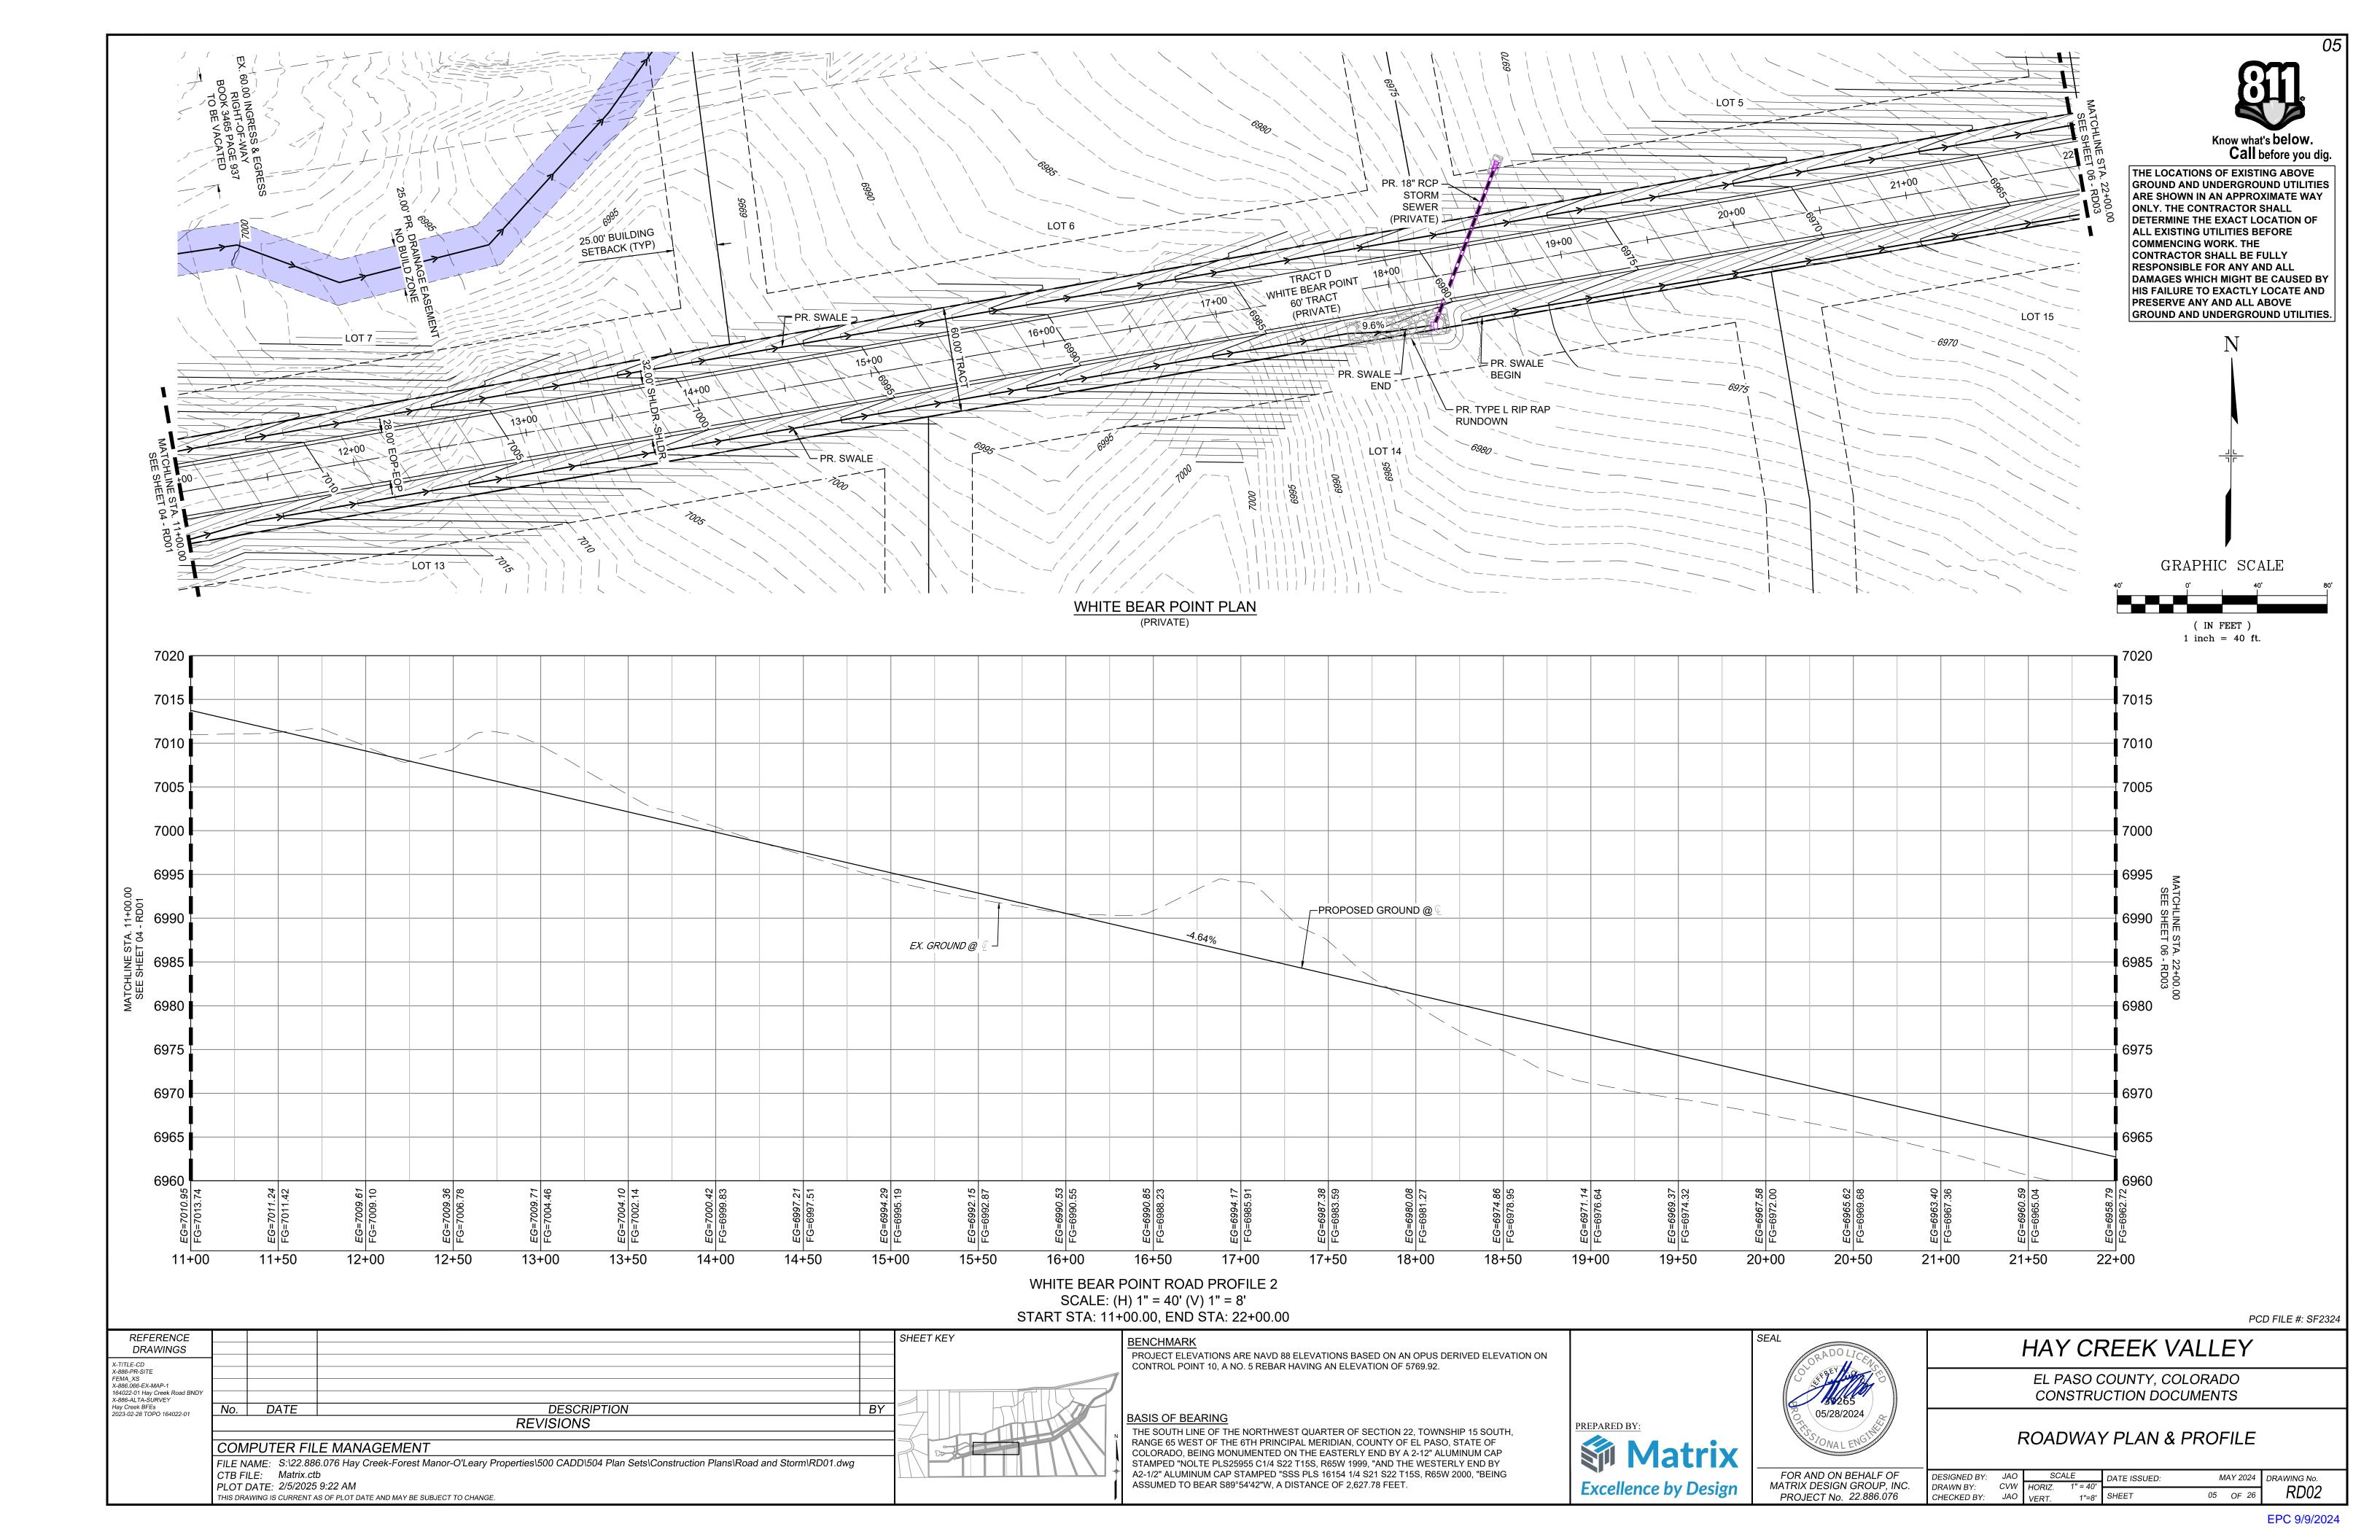


THE LOCATIONS OF EXISTING ABOVE GROUND AND UNDERGROUND UTILITIES ARE SHOWN IN AN APPROXIMATE WAY ONLY. THE CONTRACTOR SHALL DETERMINE THE EXACT LOCATION OF ALL EXISTING UTILITIES BEFORE COMMENCING WORK. THE CONTRACTOR SHALL BE FULLY RESPONSIBLE FOR ANY AND ALL DAMAGES WHICH MIGHT BE CAUSED BY HIS FAILURE TO EXACTLY LOCATE AND PRESERVE ANY AND ALL ABOVE GROUND AND UNDERGROUND UTILITIES. Call before you dig. STORM SEWER STA: 31+00 - 39+00 -MAINTAIN 2' TALL BERM ABOVE EXISTING GRADE ON NORTH. SIDE OF ROADSIDE DITCH SETBACK (TYP) PR. TYPE L RIP RAP PR. TYPE L RIP RAP STORM SEWER -STORM SEWER (PRIVATE) PR. SWALE PR. TYPE L RIP RAP (PRIVATE) -27+00 WHITE BEAR POINT 29+00 26+00 60' TRACT (PRIVATE) PR. SWALE PR. SWALE -PR. SWALE END WHITE BEAR POINT PLAN (PRIVATE) 6965 6960 6955 6955 6950 PROPOSED GROUND @ 6945 6940 ₽ SHEET 07 6930 EX. GROUND @ PVI STA: 32+50.28 PVI EL: 6914.01 K: 140.45 LVC: 100.00 6925 6925 6920 6920 6915 6915 6910 6910 6905 6905 22+00 22+50 23+00 23+50 24+50 25+00 25+50 26+00 26+50 27+00 27+50 28+50 29+00 29+50 30+00 30+50 31+00 32+00 32+50 33+00 33+50 33+75 24+00 28+00 31+50 GRAPHIC SCALE WHITE BEAR POINT ROAD PROFILE 3 SCALE: (H) 1" = 40' (V) 1" = 8' START STA: 22+00.00, END STA: 33+75.00 (IN FEET) 1 inch = 40 ft.PCD FILE #: SF2324 REFERENCE SHEET KEY HAY CREEK VALLEY DRAWINGS PROJECT ELEVATIONS ARE NAVD 88 ELEVATIONS BASED ON AN OPUS DERIVED ELEVATION ON X-TITLE-CD X-886-PR-SITE CONTROL POINT 10, A NO. 5 REBAR HAVING AN ELEVATION OF 5769.92. EL PASO COUNTY, COLORADO FEMA_XS X-886.066-EX-MAP-1 CONSTRUCTION DOCUMENTS 4022-01 Hay Creek Road BNDY X-886-ALTA-SURVEY No. DATE DESCRIPTION Hay Creek BFEs 2023-02-28 TOPO 164022-01 BASIS OF BEARING REVISIONS THE SOUTH LINE OF THE NORTHWEST QUARTER OF SECTION 22, TOWNSHIP 15 SOUTH, ROADWAY PLAN & PROFILE RANGE 65 WEST OF THE 6TH PRINCIPAL MERIDIAN, COUNTY OF EL PASO, STATE OF COMPUTER FILE MANAGEMENT COLORADO, BEING MONUMENTED ON THE EASTERLY END BY A 2-12" ALUMINUM CAP FILE NAME: S:\22.886.076 Hay Creek-Forest Manor-O'Leary Properties\500 CADD\504 Plan Sets\Construction Plans\Road and Storm\RD01.dwg STAMPED "NOLTE PLS25955 C1/4 S22 T15S, R65W 1999, "AND THE WESTERLY END BY A2-1/2" ALUMINUM CAP STAMPED "SSS PLS 16154 1/4 S21 S22 T15S, R65W 2000, "BEING CTB FILE: Matrix.ctb FOR AND ON BEHALF OF JAO SCALE DATE ISSUED:
CVW HORIZ. 1" = 40' DESIGNED BY: MAY 2024 DRAWING No. ASSUMED TO BEAR S89°54'42"W, A DISTANCE OF 2,627.78 FEET. **Excellence by Design** PLOT DATE: 2/5/2025 9:22 AM MATRIX DESIGN GROUP, INC. DRAWN BY: RD03 1"=8' SHEET 06 OF 26 PROJECT No. 22.886.076 THIS DRAWING IS CURRENT AS OF PLOT DATE AND MAY BE SUBJECT TO CHANGE. CHECKED BY: JAO VERT. EPC 9/9/2024

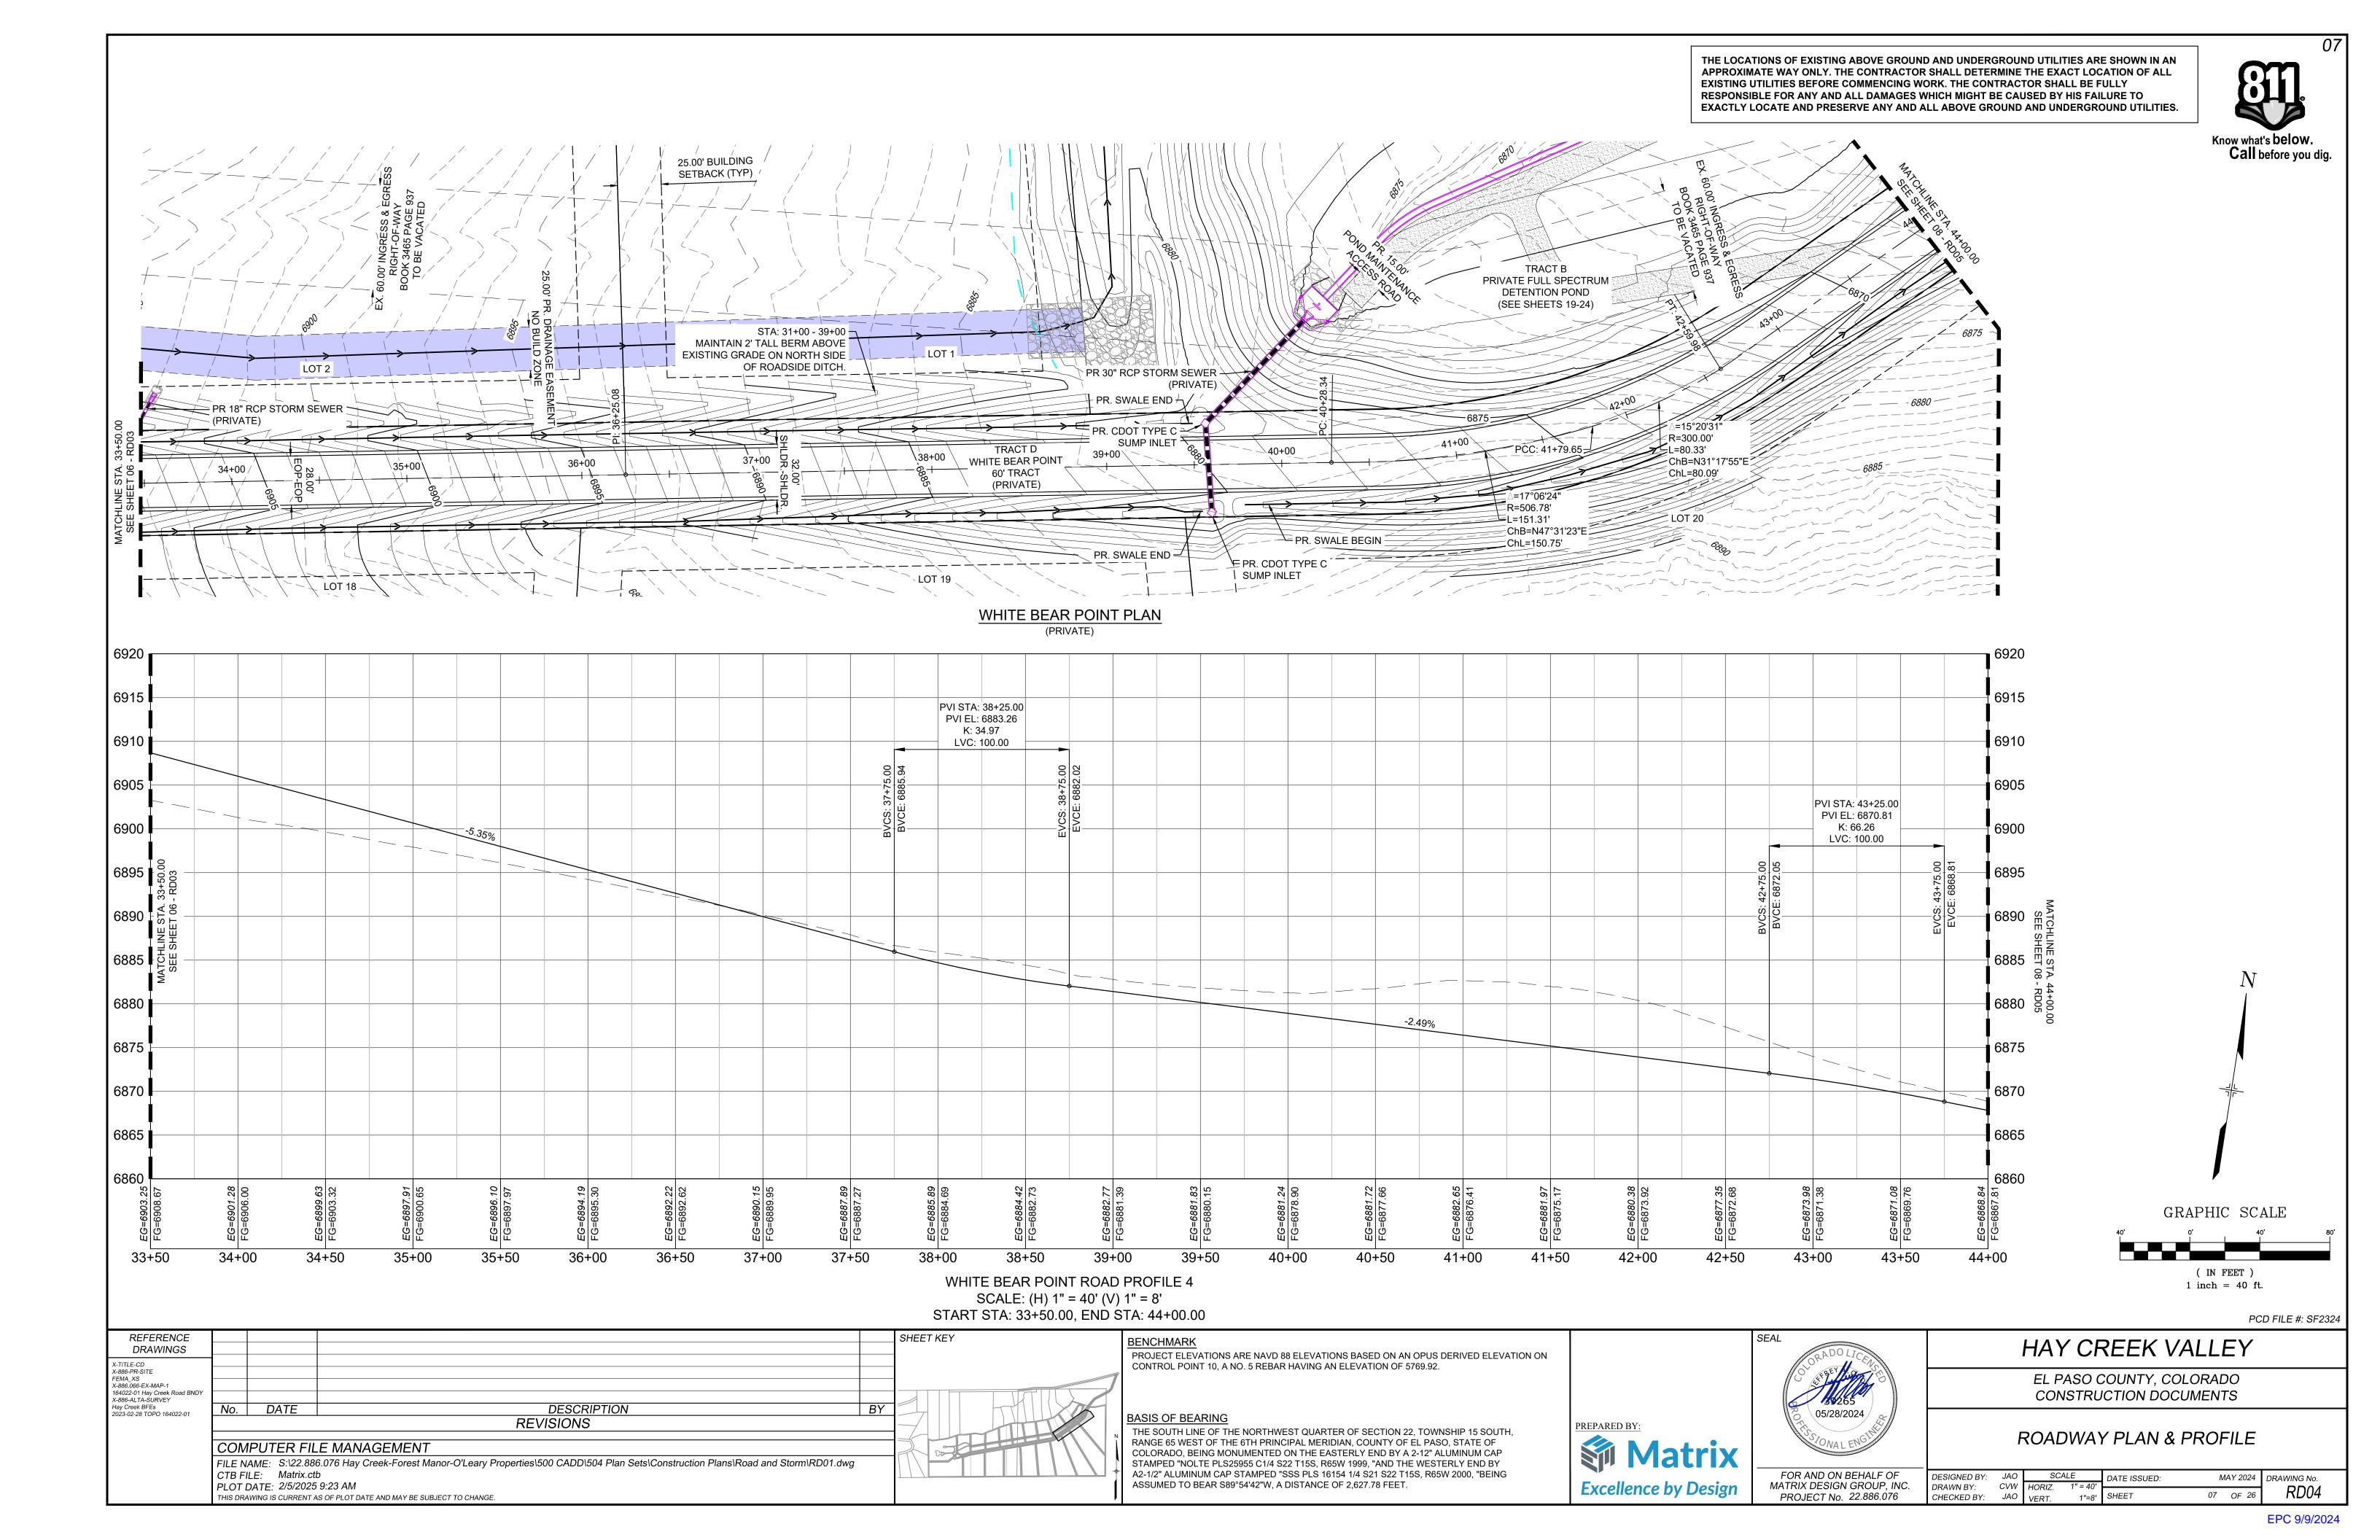


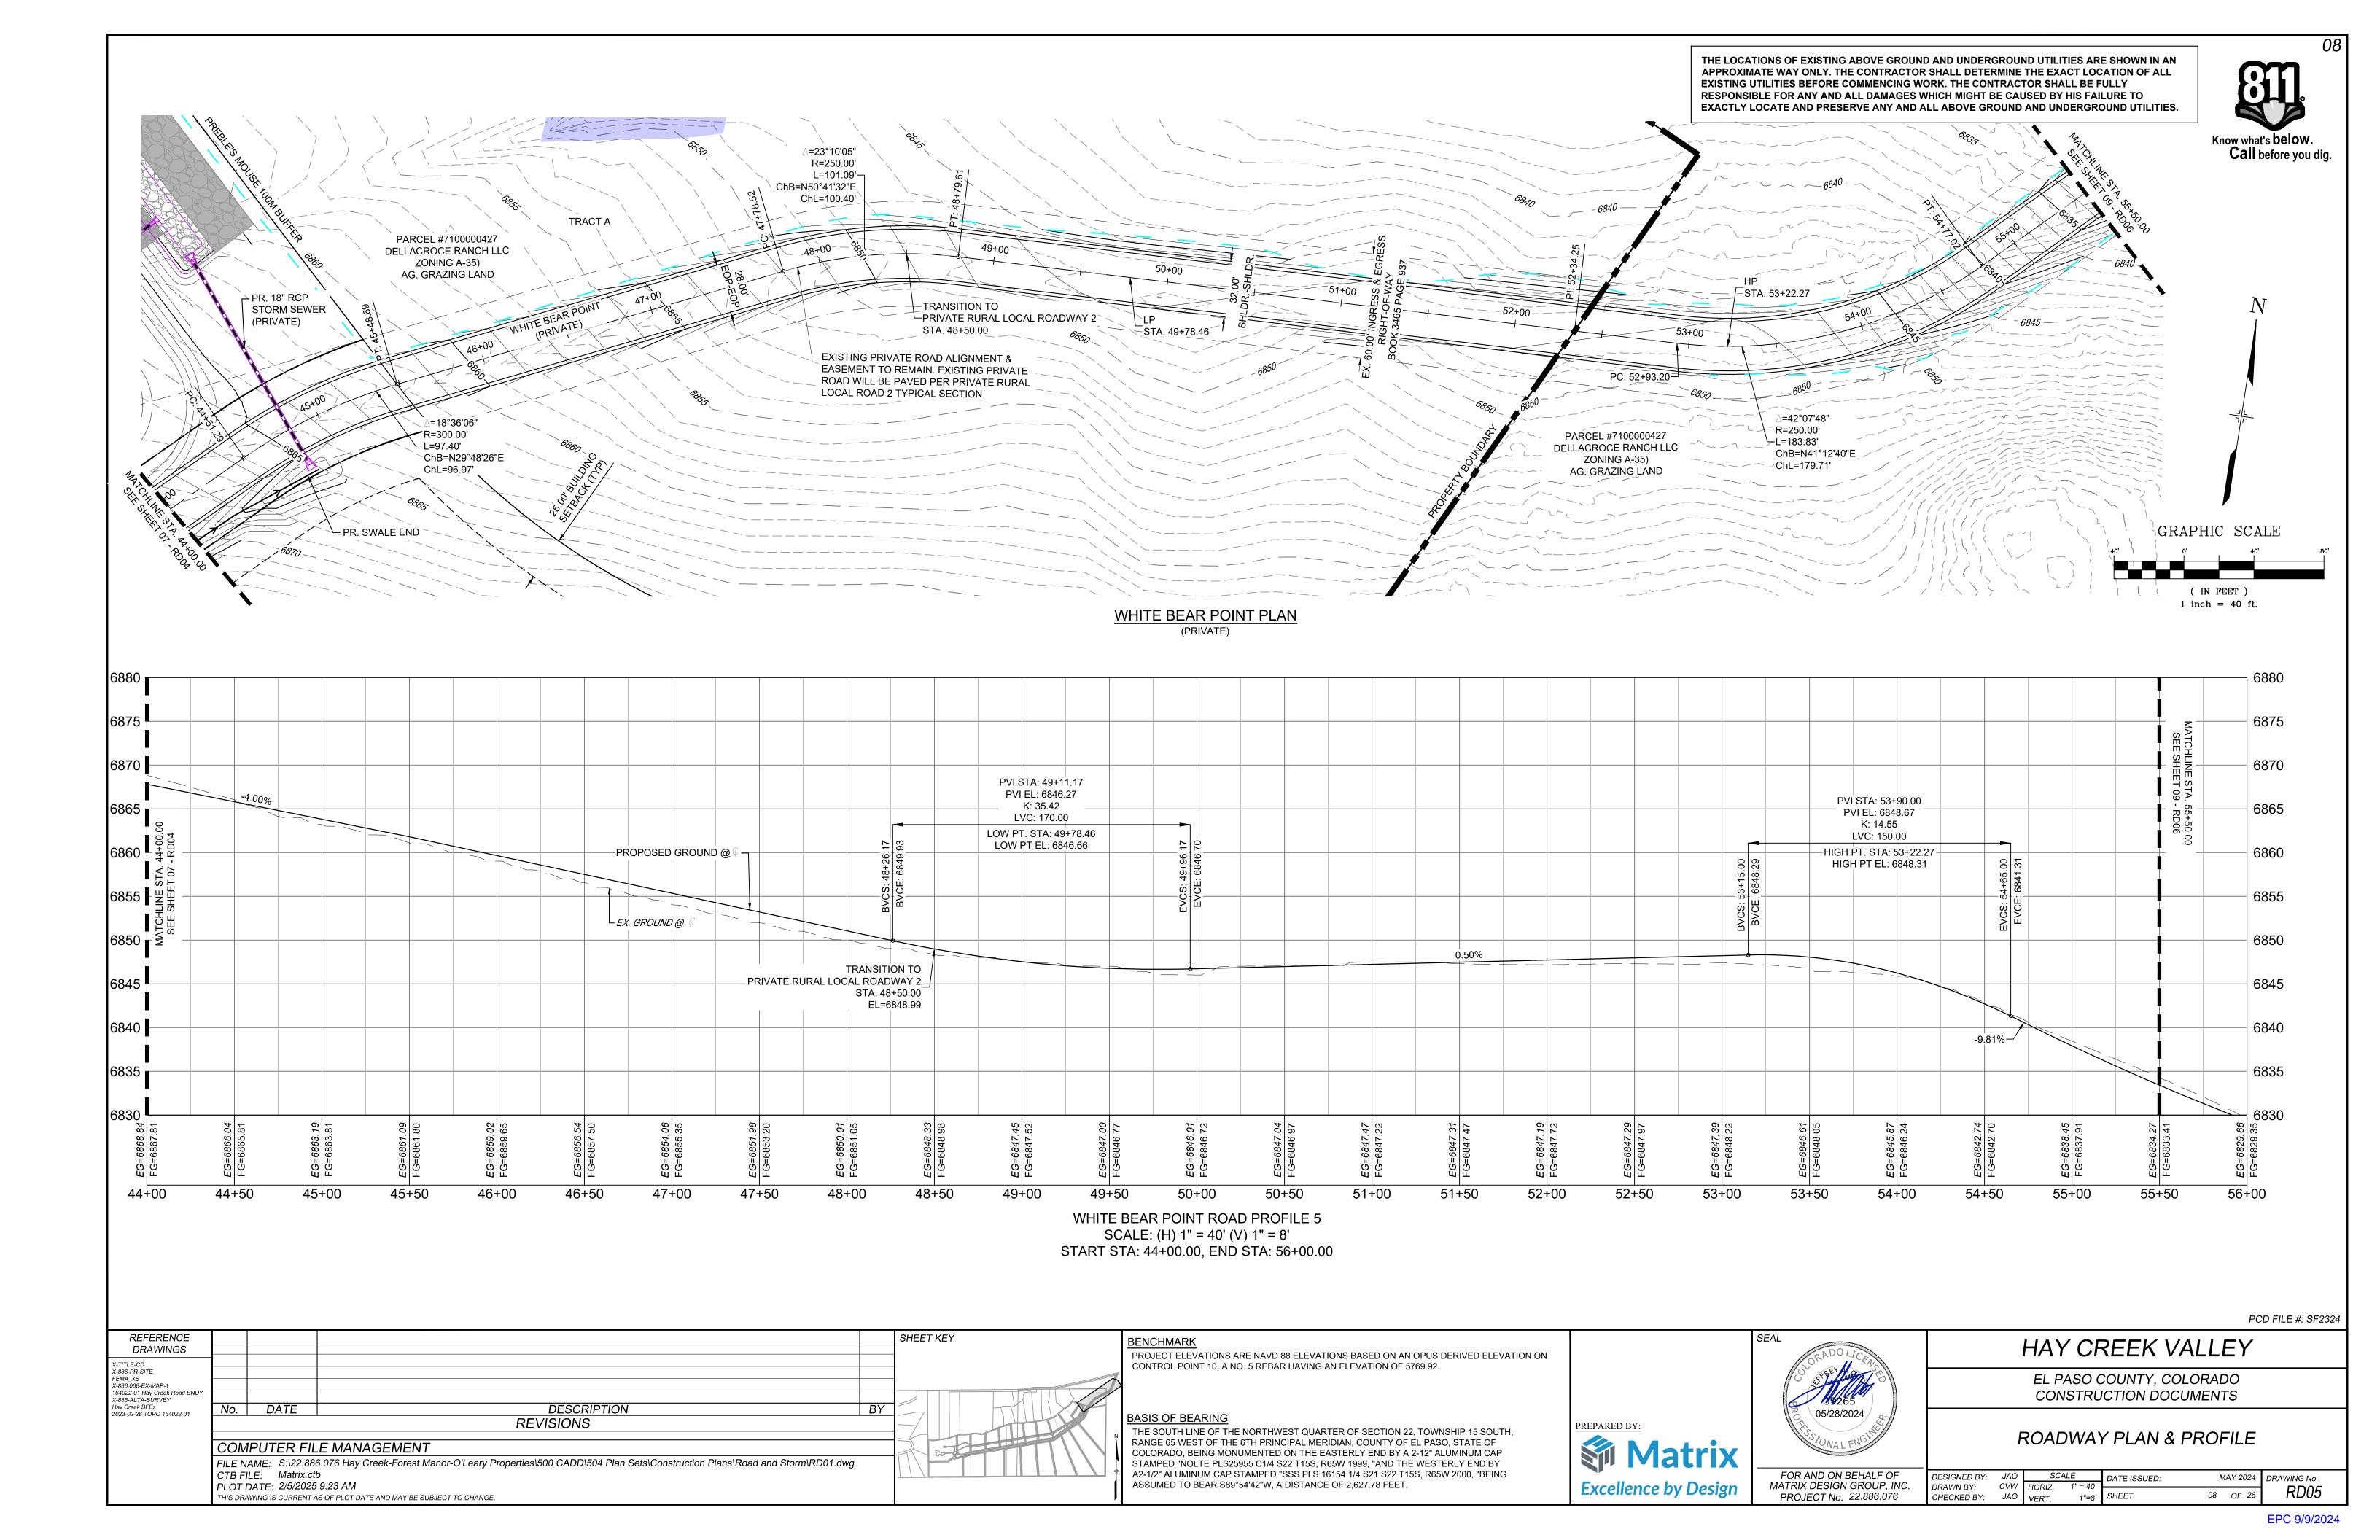

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PCD FILE #: SF2324

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BASIS OF BEARING

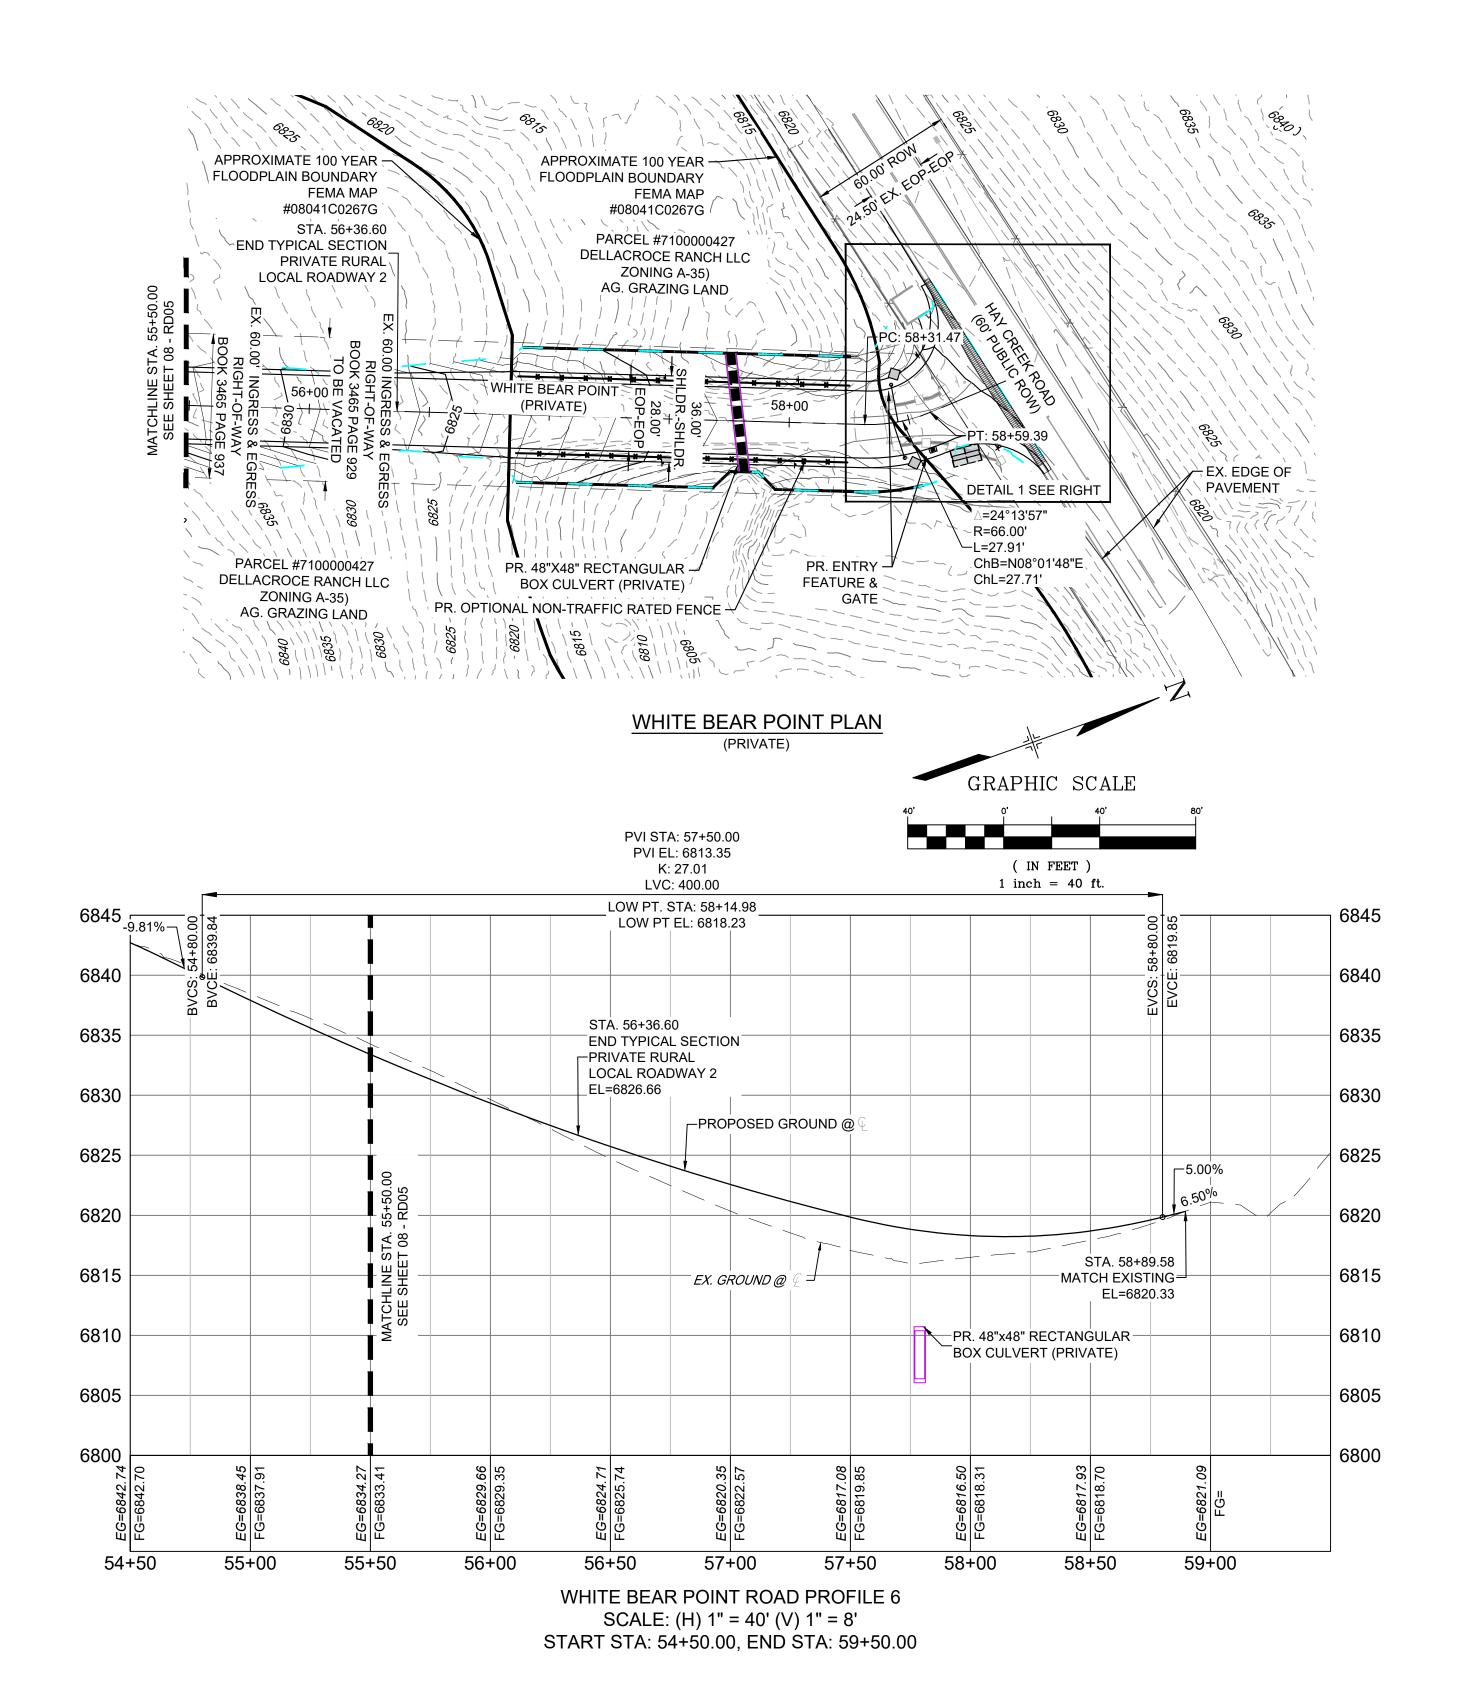THE SOUTH LINE OF THE NORTHWEST QUARTER OF SECTION 22, TOWNSHIP 15 SOUTH, RANGE 65 WEST OF THE 6TH PRINCIPAL MERIDIAN, COUNTY OF EL PASO, STATE OF COLORADO, BEING MONUMENTED ON THE EASTERLY END BY A 2-12" ALUMINUM CAP STAMPED "NOLTE PLS25955 C1/4 S22 T15S, R65W 1999, "AND THE WESTERLY END BY A2-1/2" ALUMINUM CAP STAMPED "SSS PLS 16154 1/4 S21 S22 T15S, R65W 2000, "BEING ASSUMED TO BEAR S89°54'42"W, A DISTANCE OF 2,627.78 FEET.

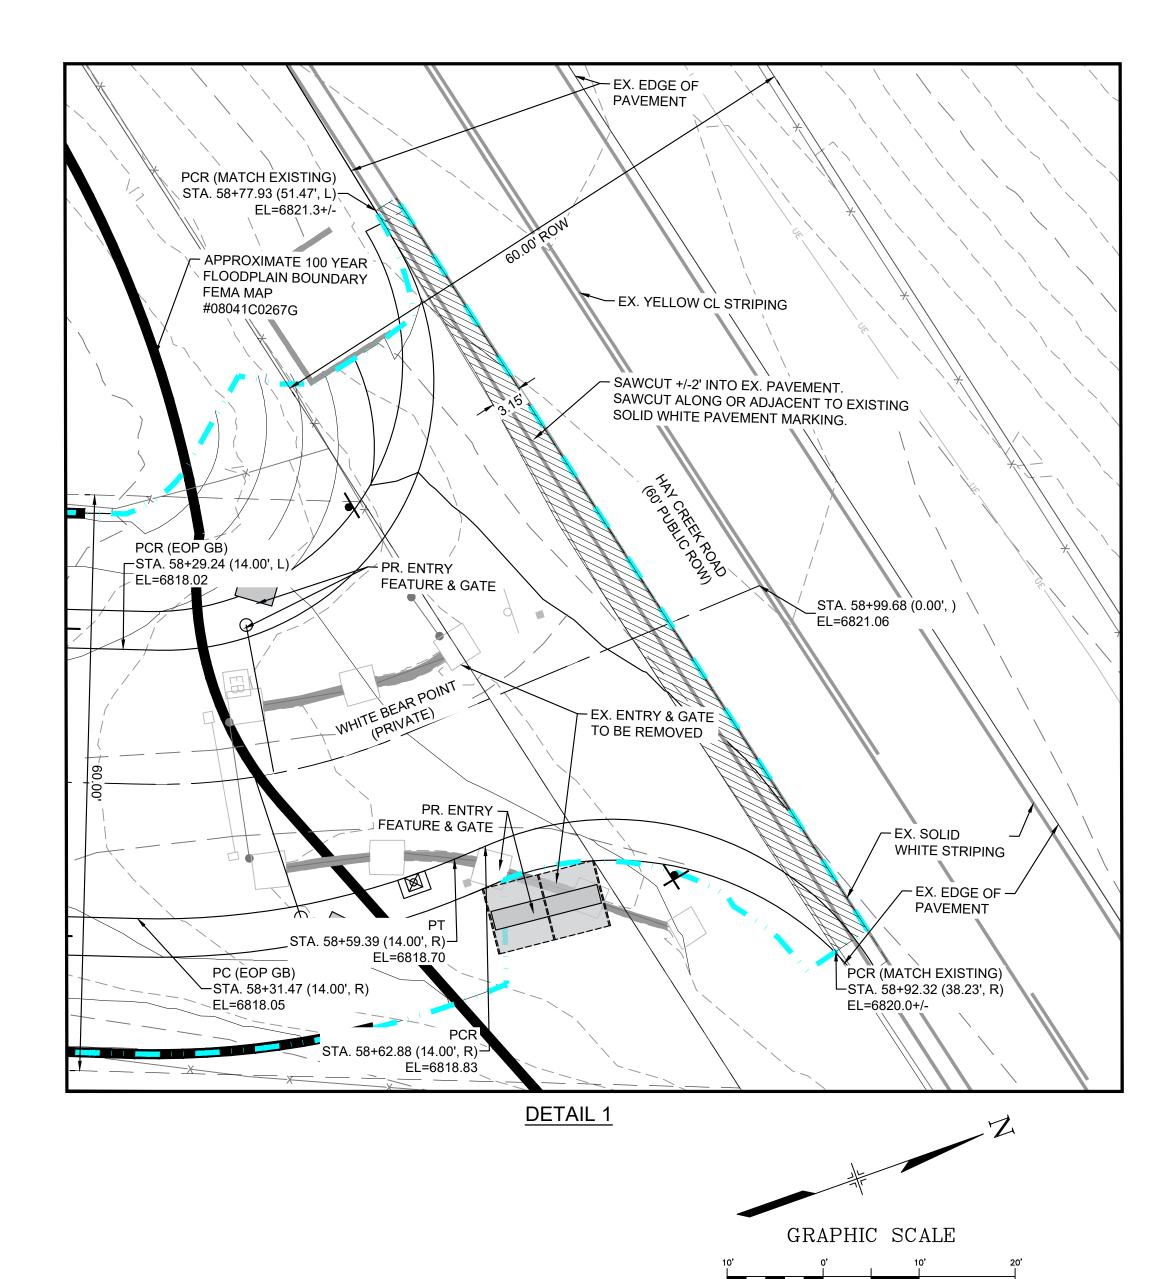

MATRIX DESIGN GROUP, INC.

PROJECT No. 22.886.076

EL PASO COUNTY, COLORADO CONSTRUCTION DOCUMENTS

(IN FEET) 1 inch = 10 ft.


ROADWAY PLAN & PROFILE

HAY CREEK VALLEY


SCALE DATE ISSUED: DESIGNED BY: MAY 2024 DRAWING No. CVW HORIZ. VARIES DRAWN BY: RD06 09 OF 26 CHECKED BY: JAO VERT.

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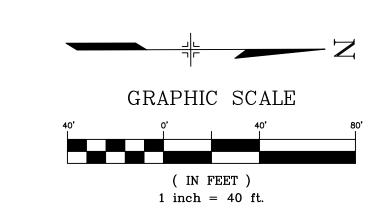


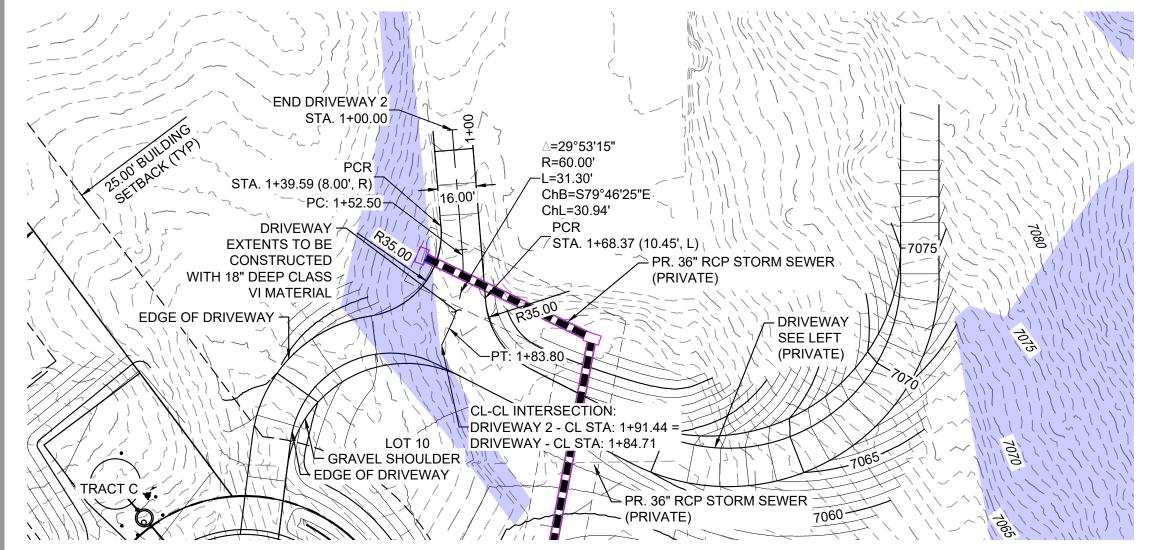

DRIVEWAY 2 PLAN (PRIVATE)

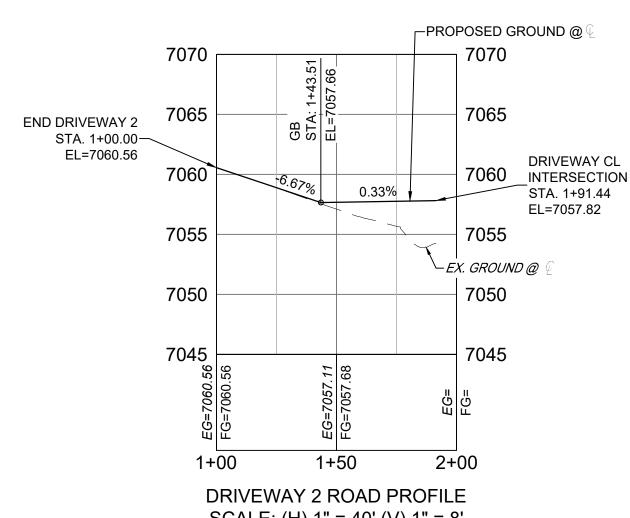

SCALE: (H) 1" = 40' (V) 1" = 8' START STA: 1+00.00, END STA: 2+00.00



PCD FILE #: SF2324

SHEET KEY No. DATE DESCRIPTION REVISIONS COMPUTER FILE MANAGEMENT FILE NAME: S:\22.886.076 Hay Creek-Forest Manor-O'Leary Properties\500 CADD\504 Plan Sets\Construction Plans\Road and Storm\RD01.dwg CTB FILE: Matrix.ctb PLOT DATE: 2/5/2025 9:24 AM

2+50

DRIVEWAY 1 ROAD PROFILE SCALE: (H) 1" = 40' (V) 1" = 8'

START STA: 0+00.00, END STA: 5+10.00

2+00

STA. 5+04.79

PT: 4+41.10

PROPOSED GROUND @

4+00

9.29%-

END DRIVEWAY

- DRIVEWAY 2

(PRIVATE)

STA. 2+11.70

GRAVEL SHOULDER PT, CL-CL INTERSECTION:

PVI STA: 2+22.30

PVI EL: 7053.60

K: 13.10

LVC: 200.00

LOW PT. STA: 2+00.53 LOW PT EL: 7057.24

PR. 36" RCP STORM SEWER

EDGE OF DRIVEWAY DRIVEWAY 2 - CL STA: 1+84.71 = ChB=N31°30'0

ChB=N31°30'0

ChB=N31°30'A

DRIVEWAY PLAN

(PRIVATE)

└*EX. GROUND @*

3+00

3+50

PR. 36" RCP STORM SEWER

GRAVEL SHOULDER

SEE RIGHT (PRIVATE)

R=50.00'

L=95.86'-

STA. 0+50.00

BEGIN DRIVEWAY /

ChL=81.84'

ChB=N27°55'51"W

WHITE BEAR POINT SEE SHEET 04 - RD01

EDGE OF DRIVEWAY

DRIVEWAY

EXTENTS TO BE

CONSTRUCTED

WITH 18" DEEP CLASS

PVI STA: 0+85.41

PVI EL: 7061.78

K: 7.56

LVC: 30.00

BEGIN DRIVEWAY

PT, DRIVEWAY 2 CL

1+50

STA. 1+84.71

EL=7057.33-

└STA. 0+50.00 _EL=7062.48

-2.00%

0+50

THIS DRAWING IS CURRENT AS OF PLOT DATE AND MAY BE SUBJECT TO CHANGE

* TRACT C

GRAPHIC SCALE

(IN FEET)

1 inch = 40 ft.

7090

7085

7080

7070

7060

7055

7050

7045

REFERENCE

DRAWINGS

4022-01 Hay Creek Road BNDY X-886-ALTA-SURVEY

Hay Creek BFEs 2023-02-28 TOPO 164022-01

X-TITLE-CD X-886-PR-SITE

FEMA_XS X-886.066-EX-MAP-1

SHLINE STA. 2002 - 4- 2000

5+00

4+50

7085

7080

7075

7070

7065

7060

7055

7050

7045

END DRIVEWAY_

STA. 5+04.79-

EL=7079.72

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BASIS OF BEARING

THE SOUTH LINE OF THE NORTHWEST QUARTER OF SECTION 22, TOWNSHIP 15 SOUTH, RANGE 65 WEST OF THE 6TH PRINCIPAL MERIDIAN, COUNTY OF EL PASO, STATE OF COLORADO, BEING MONUMENTED ON THE EASTERLY END BY A 2-12" ALUMINUM CAP STAMPED "NOLTE PLS25955 C1/4 S22 T15S, R65W 1999, "AND THE WESTERLY END BY A2-1/2" ALUMINUM CAP STAMPED "SSS PLS 16154 1/4 S21 S22 T15S, R65W 2000, "BEING ASSUMED TO BEAR S89°54'42"W, A DISTANCE OF 2,627.78 FEET.

Excellence by Design

FOR AND ON BEHALF OF MATRIX DESIGN GROUP, INC. PROJECT No. 22.886.076 HAY CREEK VALLEY EL PASO COUNTY, COLORADO

CONSTRUCTION DOCUMENTS

ROADWAY PLAN & PROFILE

JAO SCALE DATE ISSUED:

CVW HORIZ. 1" = 40' DESIGNED BY: MAY 2024 DRAWING No. DRAWN BY: RD07 10 OF 26 CHECKED BY: JAO VERT.

COLORS: LEGEND, BORDER

BACKGROUND

SIGN DIMENSIONS

 A
 B
 C
 D
 E
 F
 G
 H
 J
 K
 P
 Q


 VAR
 8
 0.375
 2
 4 D
 3 D
 3
 3 (MIN)
 3
 1
 2.25
 1.5

 VAR
 12
 0.5
 3
 6 D
 4 D
 5
 4.5 (MIN)
 4.5
 1.5
 3
 2

-WHITE (RETROREFLECTIVE) -GREEN (RETROREFLECTIVE)

El Paso County Department of Public Works

3275 Akers Drive Colorado Springs, Colorado 80922-1547 Ph: 719-520-6460 Fax: 719-520-6878

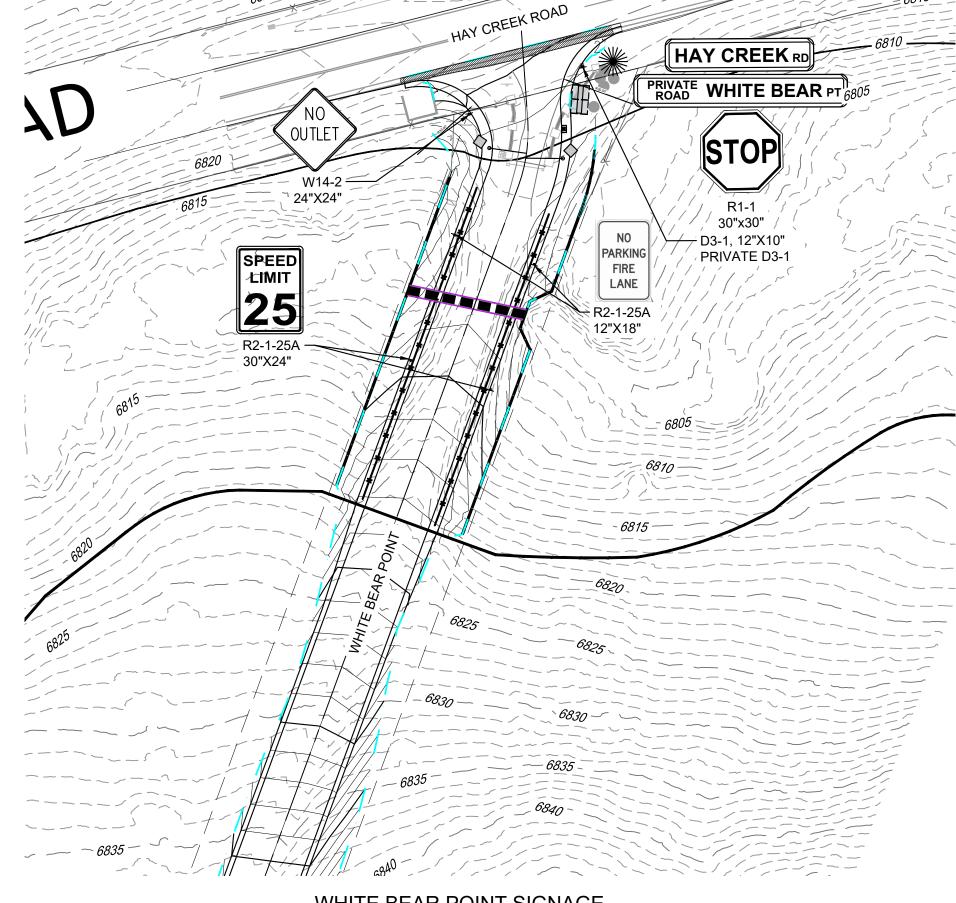

WHITE BEAR POINT SIGNAGE (SOUTHEAST END)

July 13, 2021

Supplemental Specification - El Paso County, Colorado

DESCRIPTION

PRIVATE ROAD SIGNS

This work consists of the construction of traffic signs. This work shall be done in accordance with the latest version of the CDOT Standard Specifications for Road and Bridge Construction, the latest revision of the "Manual on Uniform Traffic Control Devices for Streets and Highways" published by the FHWA and adopted by CDOT, the latest revision of the Colorado Supplement thereto, and in conformity with the EPC Standard Private Road Detail together and the details shown

MATERIALS

Private Road sign panel materials shall conform to this specification, Sections 614 and 713 of the CDOT Standard Specifications for Road and Bridge Construction and to the details shown on the plans.

The Private Road sign panel shall contain a retroreflective green background with a retroreflective white legend and border.

Private road street name signing that faces approach roads which are classified or operate as local residential area subdivision roads that provide direct access to consistently subdivided residential lots will typically utilize an 8-inch sign panel height with 4-inch initial upper-case lettering for the primary street name legend. Private road street name signing that faces approach roads which are classified or operate as non-local residential area subdivision roads will typically utilize a 12-inch sign panel height with 6-inch initial upper-case lettering for the primary street name legend. Larger signs may be required per

The words "PRIVATE ROAD" shall be located prior to the street name and shall be center justified. The words shall be all capital letters, stacked and centered vertically. For an 8-inch sign panel height, use 2.25 inches for the PRIVATE ROAD letter height and a 1.5-inch vertical space between the legend. For a 12-inch sign panel height, use 3 inches for the PRIVATE ROAD letter height and a 2-inch vertical space between the legend.

CONSTRUCTION REQUIREMENTS

Private Road sign panel construction shall conform to Section 614 of the CDOT Standard Specifications for Road and Bridge

METHOD OF MEASUREMENT

Private Road signs will be measured by the square feet of facing.

BASIS OF PAYMENT

The accepted quantities will be paid for at the contract price per unit of measurement for each of the pay items listed below

Payment will be made under:

Pay Item Pay Unit Sign Panel (Class) Square Foot GRAPHIC SCALE

(IN FEET)

1 inch = 40_P t FILE #: SF2324

Call before you dig.

THE LOCATIONS OF EXISTING ABOVE **GROUND AND UNDERGROUND UTILITIES**

ARE SHOWN IN AN APPROXIMATE WAY

DAMAGES WHICH MIGHT BE CAUSED BY HIS FAILURE TO EXACTLY LOCATE AND

GROUND AND UNDERGROUND UTILITIES.

ONLY. THE CONTRACTOR SHALL DETERMINE THE EXACT LOCATION OF

ALL EXISTING UTILITIES BEFORE

PRESERVE ANY AND ALL ABOVE

COMMENCING WORK. THE CONTRACTOR SHALL BE FULLY **RESPONSIBLE FOR ANY AND ALL**

REFERENCE SHEET KEY DRAWINGS X-TITLE-CD X-886-PR-SITE FEMA_XS X-886.066-EX-MAP-1 4022-01 Hay Creek Road BND X-886-ALTA-SURVEY DESCRIPTION No. DATE Hay Creek BFEs 2023-02-28 TOPO 164022-01 REVISIONS COMPUTER FILE MANAGEMENT FILE NAME: S:\22.886.076 Hay Creek-Forest Manor-O'Leary Properties\500 CADD\504 Plan Sets\Construction Plans\Road and Storm\RD01.dwg CTB FILE: Matrix.ctb

PLOT DATE: 2/5/2025 9:24 AM

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NOTES: REFERENCE SUPPLEMENTAL SPECIFICATION

Private Road Detail

PROJECT ELEVATIONS ARE NAVD 88 ELEVATIONS BASED ON AN OPUS DERIVED ELEVATION ON CONTROL POINT 10, A NO. 5 REBAR HAVING AN ELEVATION OF 5769.92.

BASIS OF BEARING

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PROJECT No. 22.886.076


SIGNAGE PLAN

HAY CREEK VALLEY

EL PASO COUNTY, COLORADO

CONSTRUCTION DOCUMENTS

SCALE DATE ISSUED: DESIGNED BY: MAY 2024 DRAWING No. CVW HORIZ. 1" = 40' DRAWN BY: RD08 1"=8' SHEET 11 OF 26 CHECKED BY: JAO VERT.

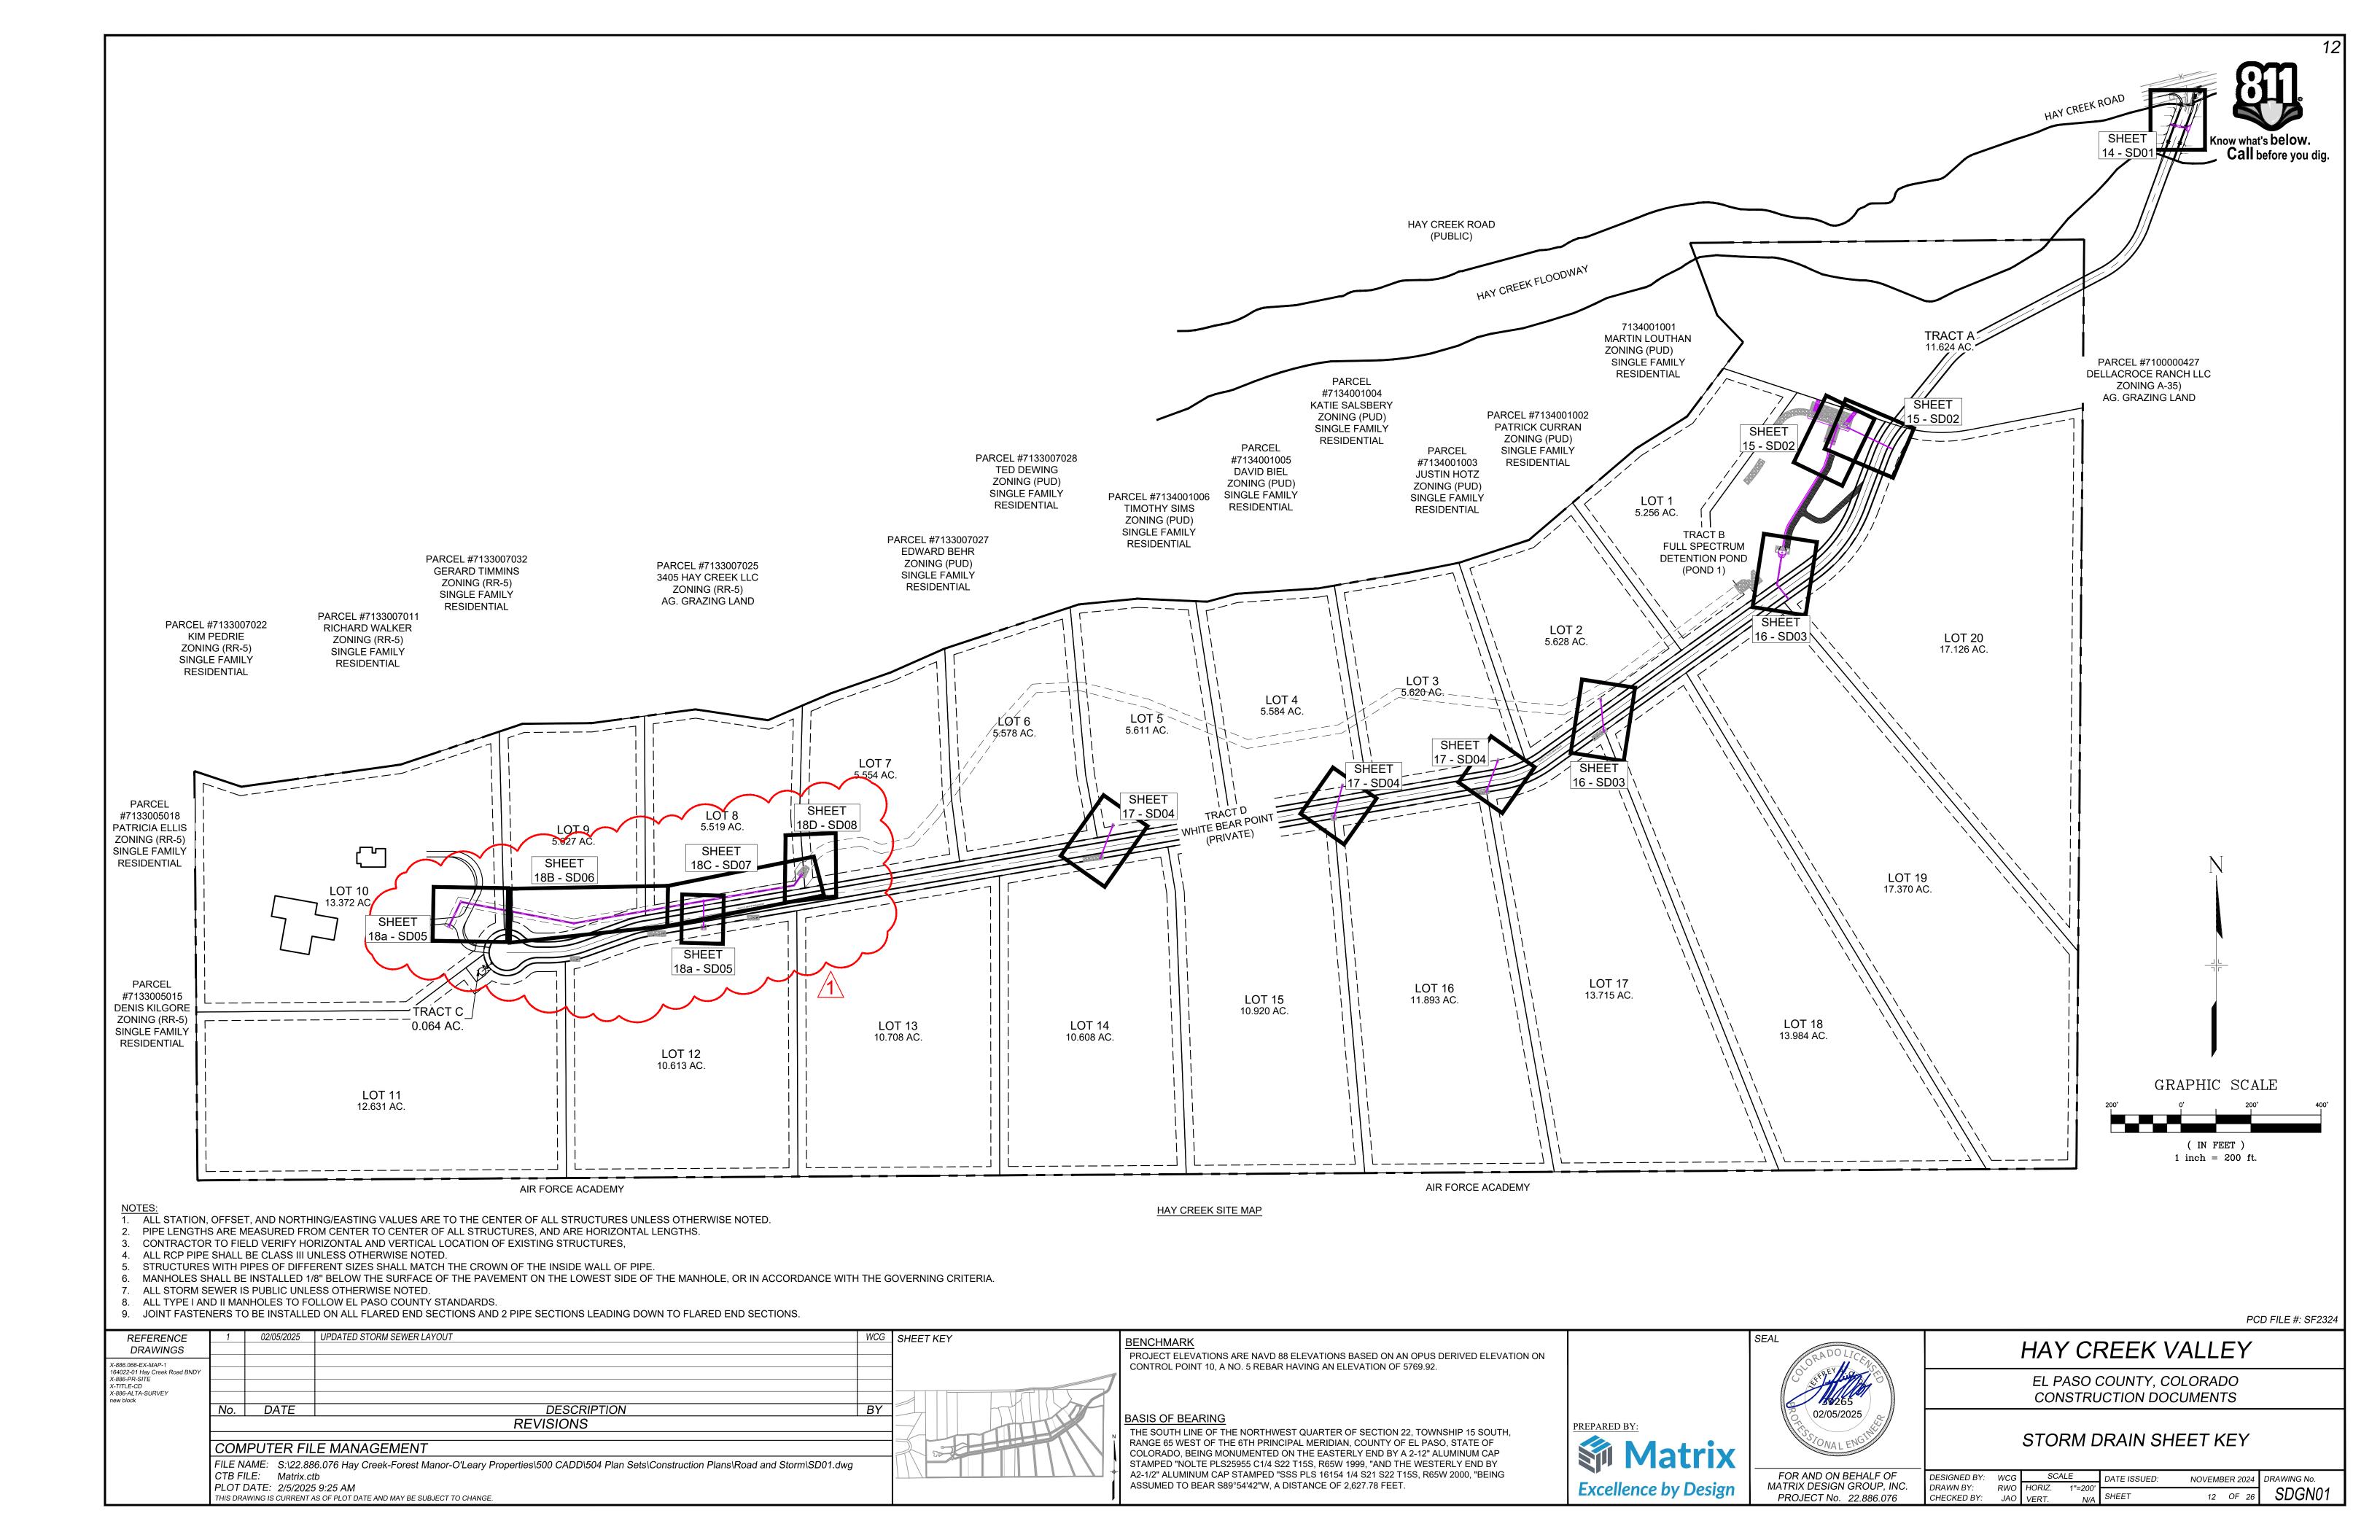

GENERAL NOTES:

- PER THE COLORADO SENATE BILL 18-167, ALL UNDERGROUND UTILITIES, INCLUDING STORM SEWER, MUST BE INSTALLED WITH A DETECTABLE MATERIAL SO THEY CAN BE TRACED AT GROUND LEVEL. ENSURE ALL PIPES INSTALLED ARE EQUIPPED WITH MEANS OF BEING DETECTED, AS PER CITY STANDARD D-37
- DO NOT BACKFILL INLETS PRIOR TO ONE-POUND ANODE AND 1.5# MAGNESIUM GROUND ROD INSTALLATION.
- TRACER WIRE SHALL BE INSTALLED IN ALL UNDERGROUND PIPE.
- TRACER WIRE FOR STORM SEWER AND DRAIN LINES SHALL BE GREEN IN ACCORDANCE WITH AMERICAN PUBLIC WORKS ASSOCIATION (APWA) UNIFORM COLOR CODE.
- "OPEN TRENCH" TRACER WIRE SHALL BE #8 OR #10 AWG COPPER SOLID OR #12 AWG COPPER CLAD HIGH STRENGTH WITH MINIMUM 30 MIL HDPE INSULATION THICKNESS COMPLYING WITH ASRM D-1248, AND A MINIMUM AVERAGE TENSILE BREAK LOAD OF 450-LBS, AND A 30-MIL HDPE JACKET-GREEN (TYPICAL).
- "PIPE/SLIP LINING" TRACER WIRE SHALL BE 7X7 STRANDED COPPER CLAD STEEL, EXTREME STRENGTH WITH 4,700 LB. BREAK LOAD, WITH MINIMUM 50-MIL HDPE INSULATION THICKNESS.
- TRACER WIRE SHALL BE SECURED EVERY 5-FEET TO 8-FEET ON THE TOP OF THE PIPE BY TAPING OR TYING TO THE PIPE.
- A 4-WAY CONNECTOR OR (2) 3-WAY CONNECTORS WITH SHORT JUMP WIRE ARE REQUIRED AT ALL CROSSINGS.
- TRACER WIRE SHALL BE AS CONTINUOUS AS POSSIBLE. IF SPLICING IS NECESSARY, THE ONLY APPROVED SPLICE METHOD IS A SPLIT BOLT CONNECTOR HOUSED IN A SPLIT BOLT HOUSING.
- ANY DAMAGE OCCURRING DURING INSTALLATION OF THE TRACER WIRE MUST BE IMMEDIATELY REPAIRED BY REMOVING THE DAMAGED WIRE AND INSTALLING A NEW SECTION OF WIRE WITH APPROVED CONNECTORS. TAPING AND/OR SPRAY COATING SHALL NOT BE ALLOWED AS A CONNECTION.
- EXPOSED WIRE SHALL BE WRAPPED WITH SCOTCH LINERLESS RUBBER SPLICING TAPE TO SEAL OUT MOISTURE, AND THEN COATED WITH SCOTCH SUPPER 33+ VINYL ELECTRIC TAPE TO SEAL THE RUBBER TAPE.
- TRACER WIRE CAN NOT BE PLACED INSIDE DRAINAGE INLETS.

- TRACER WIRE SHALL BE BROUGHT ABOVE GROUND AND CONNECT AT EACH INLET AND MANHOLE IN A GRADE LEVEL TRACER WIRE TEST BOX.
- A MINIMUM OF 2-FEET OF EXCESS/SLACK WIRE IS REQUIRED IN ALL TRACER WIRE ACCESS BOXES AFTER MEETING FINAL ELEVATION.
- DRIVE-IN 1.5# MAGNESIUM GROUND RODS (ANODE) WHICH SHALL BE ATTACHED TO THE END OF THE TRACER WIRE.
- TRACER WIRE MUST BE PROPERLY GROUNDED AT ALL DEAD ENDS (INLETS, OUTFALL,ETC.), AND DRIVEN INTO NATIVE SOIL AT
- TRACER WIRE TERMINATION POINTS MUST UTILIZE A WIRE ACCESS BOX.
- TRACER WIRE ACCESS BOXES MUST INCLUDE A MANUAL INTERRUPTIBLE CONDUCTIVE/CONNECTIVE LINK BETWEEN
- TERMINAL FOR TRACER WIRE CONNECTION AND TERMINAL FOR GROUND ROD WIRE CONNECTION. GROUNDING ANODE WIRE AND 1.5# MAGNESIUM GROUND ROD WIRE SHALL BE CONNECTED TO THE IDENTIFIED LOCATION
- (BOTTOM) TERMINAL IN ALL ACCESS BOXES.
- ALL SERVICE LATERAL TRACER WIRE MUST BE PROPERLY CONNECTED TO THE MAINLINE TRACER WIRE TO ENSURE FULL TRACING/LOCATING CAPABILITIES FROM A SINGLE CONNECTION POINT.
- TRUNK LINE TRACER WIRE SHALL BE CONTINUOUS, BY-PASSING AROUND THE OUTSIDE OF MANHOLES/STRUCTURES ON THE NORTH OR EAST SIDE, UNLESS ON THE END SECTION.
- ALL NEW TRACER WIRE INSTALLATIONS SHALL BE TESTED AND LOCATED PRIOR TO ACCEPTANCE. TESTING AND LOCATING SHALL BE PERFORMED BY A THIRD PARTY AT THE COMPLETION OF ROUGH GRADING AND PRIOR TO FINAL ACCEPTANCE OF THE PROJECT. ANY DEFICIENCIES SHALL BE CORRECTED PRIOR TO FINAL ACCEPTANCE.
- 23. WHEN REPAIRS ARE PERFORMED ON STORMWATER LINE, TRACER WIRE SHALL BE TESTED PRIOR TO FINAL ACCEPTANCE.

GENERAL NOTES:

TRACER WIRE:

- ALL WORK SHALL BE DONE IN ACCORDANCE WITH CURRENT CITY OF COLORADO SPRINGS ENGINEERING DIVISION (THE CITY)
- STANDARD SPECIFICATIONS. THE CONTRACTOR SHALL OBTAIN ALL REQUIRED PERMITS (EXCAVATION, CONCRETE, TRAFFIC CONTROL, ETC.), AND
- NOTIFY THE CITY BY 1500 HOURS THE BUSINESS DAY BEFORE INSPECTION IS REQUIRED. DO NOT BACKFILL INLETS PRIOR TO ONE-POUND ANODE AND
- TRACER WIRE SHALL BE INSTALLED ON ALL UNDERGROUND

ASSOCIATION (APWA) UNIFORM COLOR CODE.

1.5# MAGNESIUM GROUND ROD INSTALLATION.

- TRACER WIRE FOR STORM SEWER AND DRAIN LINES SHALL BE GREEN IN ACCORDANCE WITH AMERICAN PUBLIC WORKS
- "OPEN TRENCH" TRACER WIRE SHALL BE #8 OR #10 AWG COPPER SOLID OR #12 AWG COPPER CLAD HIGH STRENGTH WITH MINIMUM 30 MIL HDPE INSULATION THICKNESS COMPLYING WITH ASTM D-1248, AND A MINIMUM AVERAGE TENSILE BREAK OAD OF 450-LBS, AND A 30-MIL HDPE JACKET-GREEN
- "PIPE/SLIP LINING" TRACER WIRE SHALL BE 7X7 STRANDED COPPER CLAD STEEL, EXTREME STRENGTH WITH 4,700 LB. BREAK LOAD, WITH MINIMUM 50-MIL HDPE INSULATION
- TRACER WIRE SHALL BE SECURED EVERY 5-FFET TO 8-FFET ON THE TOP OF THE PIPE BY TAPING OR TYING TO THE PIPE.
- A 4-WAY CONNECTOR OR (2) 3-WAY CONNECTORS WITH SHORT JUMP WIRE ARE REQUIRED AT ALL CROSSINGS. TRACER WIRE SHALL BE AS CONTINUOUS AS POSSIBLE. IF SPLICING IS NECESSARY, THE ONLY APPROVED SPLICE METHOD IS A SPLIT BOLT CONNECTOR HOUSED IN A SPLIT BOLT
- ANY DAMAGE OCCURRING DURING INSTALLATION OF THE TRACER WIRE MUST BE IMMEDIATELY REPAIRED BY REMOVING THE DAMAGED WIRE AND INSTALLING A NEW SECTION OF WIRE WITH APPROVED CONNECTORS, TAPING AND/OR SPRAY COATING SHALL NOT BE ALLOWED AS A CONNECTION.
- EXPOSED WIRE SHALL BE WRAPPED WITH SCOTCH LINERLESS RUBBER SPLICING TAPE TO SEAL OUT MOISTURE, AND THEN COATED WITH SCOTCH SUPER 33+ VINYL ELECTRIC TAPE TO SEAL THE RUBBER TAPE. 3. TRACER WIRE CAN NOT BE PLACED INSIDE DRAINAGE INLETS

INLET (SEE NOTE 2)

(TYPICAL)

TRACER WIRE PER

FUTURE STUB CONNECTION

1. WIRE SHOWN AWAY FROM PIPE FOR CLARITY. WIRE SHALL BE INSTALLED ON TOP OF THE PIPE. THE WIRE SHALL BE FASTENED TO THE PIPE WITH TAPE OR PLASTIC TIES AT 5-FOOT TO 8-FOOT

2. TRACER WIRE FOR INLETS SHALL TERMINATE AT A GRADE LEVEL IN—GROUND ACCESS BOX. DRIVE—IN MAGNESIUM GROUND ROD MUST BE USED AT ALL TERMINATION POINTS.

3. PLACE A TEST STATION WITH A DRIVEN-IN 1.5# MAGNESIUM GROUND ROD AT DEAD ENDS AND FUTURE CONNECTIONS

- 14. TRACER WIRE SHALL BE BROUGHT ABOVE GROUND AND
- CONNECT AT EACH INLET AND MANHOLE IN A GRADE LEVEL TRACER WIRE TEST BOX.
- ALL TRACER WIRE ACCESS BOXES AFTER MEETING FINAL ELEVATION. 16. DRIVE—IN 1.5# MAGNESIUM GROUND RODS (ANODE) WHICH SHALL BE ATTACHED TO THE END OF THE TRACER WIRE.

15. A MINIMUM OF 2-FEET OF EXCESS/SLACK WIRE IS REQUIRED IN

- 17. TRACER WIRE MUST BE PROPERLY GROUNDED AT ALL DEAD ENDS (INLETS, OUTFALL, ETC.), AND DRIVEN INTO NATIVE SOIL
- 18. TRACER WIRE TERMINATION POINTS MUST UTILIZE A WIRE ACCESS BOX. 19. TRACER WIRE ACCESS BOXES MUST INCLUDE A MANUAL INTERRUPTIBLE CONDUCTIVE/CONNECTIVE LINK BETWEEN
- TERMINAL FOR TRACER WIRE CONNECTION AND TERMINAL FOR GROUND ROD WIRE CONNECTION. 20. GROUNDING ANODE WIRE AND 1.5# MAGNESIUM GROUND ROD WIRE SHALL BE CONNECTED TO THE IDENTIFIED LOCATION
- (BOTTOM) TERMINAL IN ALL ACCESS BOXES. 21. ALL SERVICE LATERAL TRACER WIRES MUST BE PROPERLY CONNECTED TO THE MAINLINE TRACER WIRE TO ENSURE FULL

TRACING/LOCATING CAPABILITIES FROM A SINGLE CONNECTION

- 22. TRUNK LINE TRACER WIRE SHALL BE CONTINUOUS, BY-PASSING AROUND THE OUTSIDE OF MANHOLES/STRUCTURES ON THE NORTH OR EAST SIDE, UNLESS ON THE END SECTION.
- 23. ALL NEW TRACER WIRE INSTALLATIONS SHALL BE TESTED AND LOCATED PRIOR TO ACCEPTANCE. TESTING AND LOCATING SHALL BE PERFORMED BY A THIRD PARTY AT THE COMPLETION ROUGH GRADING AND PRIOR TO FINAL ACCEPTANCE OF THE PROJECT. ANY DEFICIENCIES SHALL BE CORRECTED PRIOR TO
- TRACER WIRE SHALL BE TESTED PRIOR TO FINAL ACCEPTANCE




TRACER WIRE SHALL BE ROUTED AROUND MANHOLES ON THE


TRACER WIRE SAMPLE


STORM SEWER PLAN


NORTH AND/OR EAST SIDE.

COLORADO

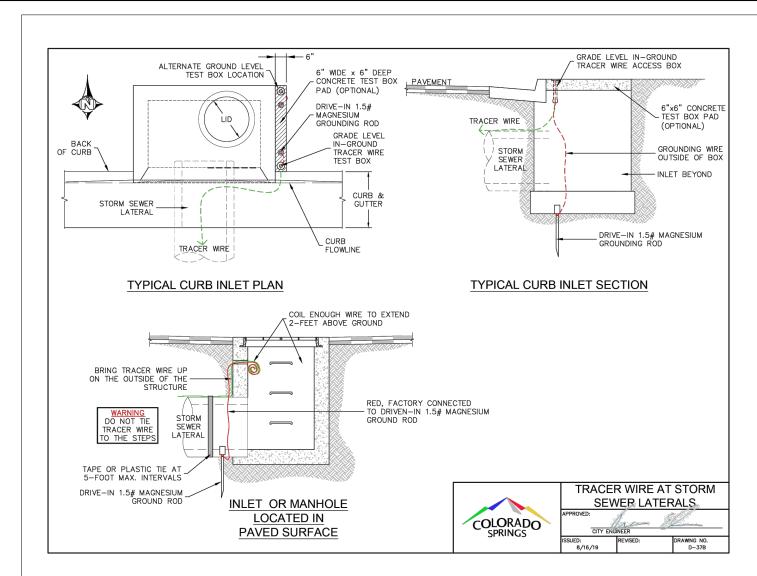

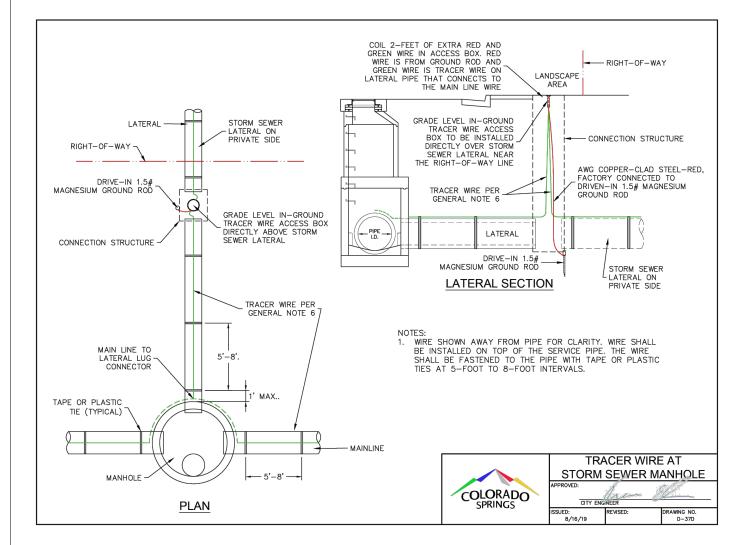

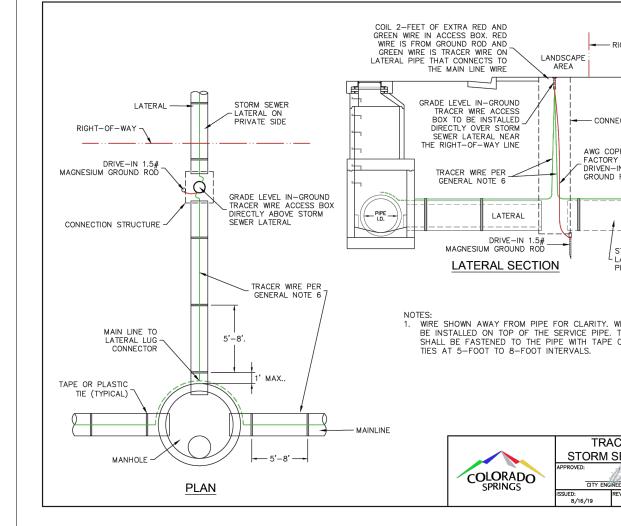

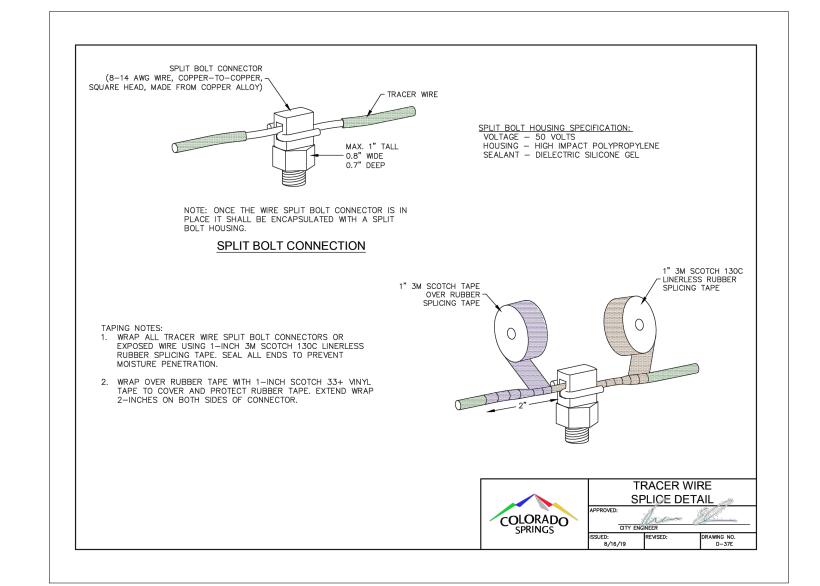

PCD FILE #: SF2324

Know what's below.

Call before you dig.

REFERENCE DRAWINGS X-TITLE-CD X-886-PR-SITE FMA XS X-886.066-EX-MAP-1 4022-01 Hav Creek Road BND X-886-ALTA-ŚURVEY DESCRIPTION No. DATE Hay Creek BFEs REVISIONS COMPUTER FILE MANAGEMENT FILE NAME: S:\22.886.076 Hay Creek-Forest Manor-O'Leary Properties\500 CADD\504 Plan Sets\Construction Plans\Road and Storm\SD00.dwg CTB FILE: Matrix.ctb PLOT DATE: 2/5/2025 9:25 AM THIS DRAWING IS CURRENT AS OF PLOT DATE AND MAY BE SUBJECT TO CHANGE

SHEET KEY

PROJECT ELEVATIONS ARE NAVD 88 ELEVATIONS BASED ON AN OPUS DERIVED ELEVATION ON CONTROL POINT 10, A NO. 5 REBAR HAVING AN ELEVATION OF 5769.92.

BASIS OF BEARING

THE SOUTH LINE OF THE NORTHWEST QUARTER OF SECTION 22, TOWNSHIP 15 SOUTH, RANGE 65 WEST OF THE 6TH PRINCIPAL MERIDIAN, COUNTY OF EL PASO, STATE OF COLORADO, BEING MONUMENTED ON THE EASTERLY END BY A 2-12" ALUMINUM CAP STAMPED "NOLTE PLS25955 C1/4 S22 T15S, R65W 1999, "AND THE WESTERLY END BY A2-1/2" ALUMINUM CAP STAMPED "SSS PLS 16154 1/4 S21 S22 T15S, R65W 2000, "BEING ASSUMED TO BEAR S89°54'42"W, A DISTANCE OF 2,627.78 FEET.





FOR AND ON BEHALF OF

MATRIX DESIGN GROUP, INC.


PROJECT No. 22.886.076


HAY CREEK VALLEY

EL PASO COUNTY, COLORADO CONSTRUCTION DOCUMENTS

STORM DRAIN GENERAL NOTES & DETAILS


DESIGNED BY:	WCG	SCA	LE	DATE ISSUED:	М	AY 2024	DRAWING No.
DRAWN BY:	RWO	HORIZ.	N/A				
CHECKED BY:	JAO	VERT	N/A	SHEET	13	OF 26	SDGN02

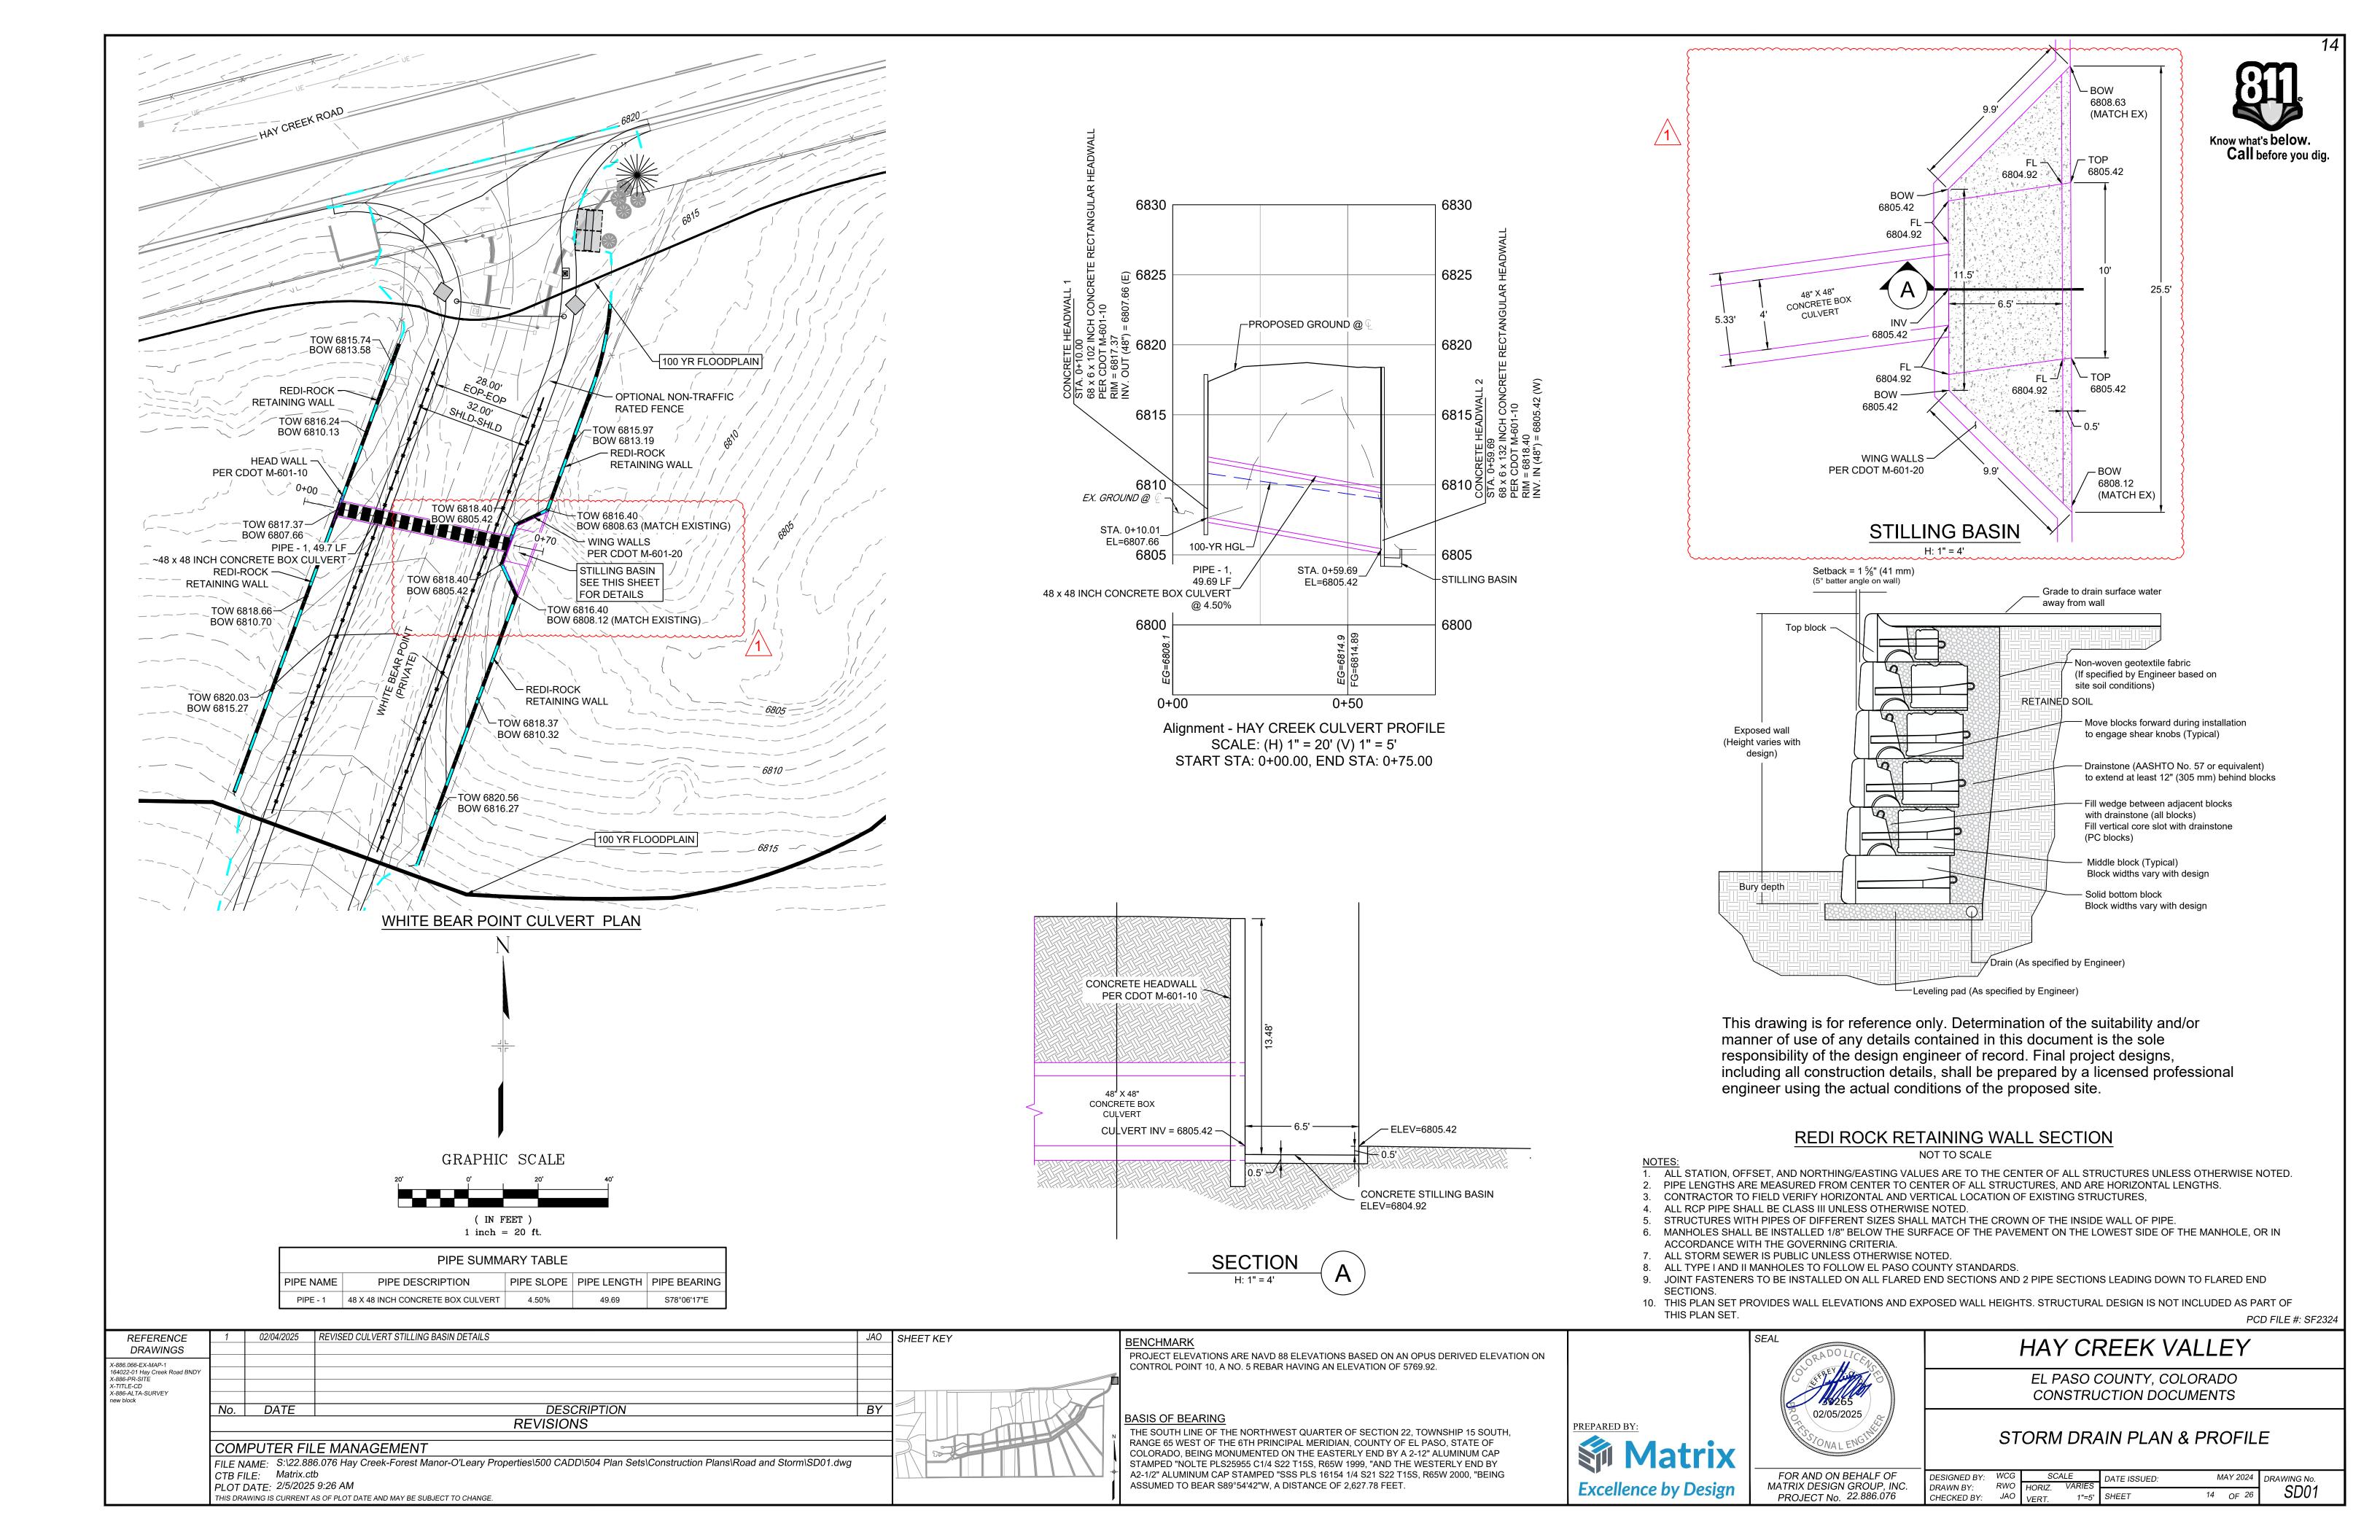

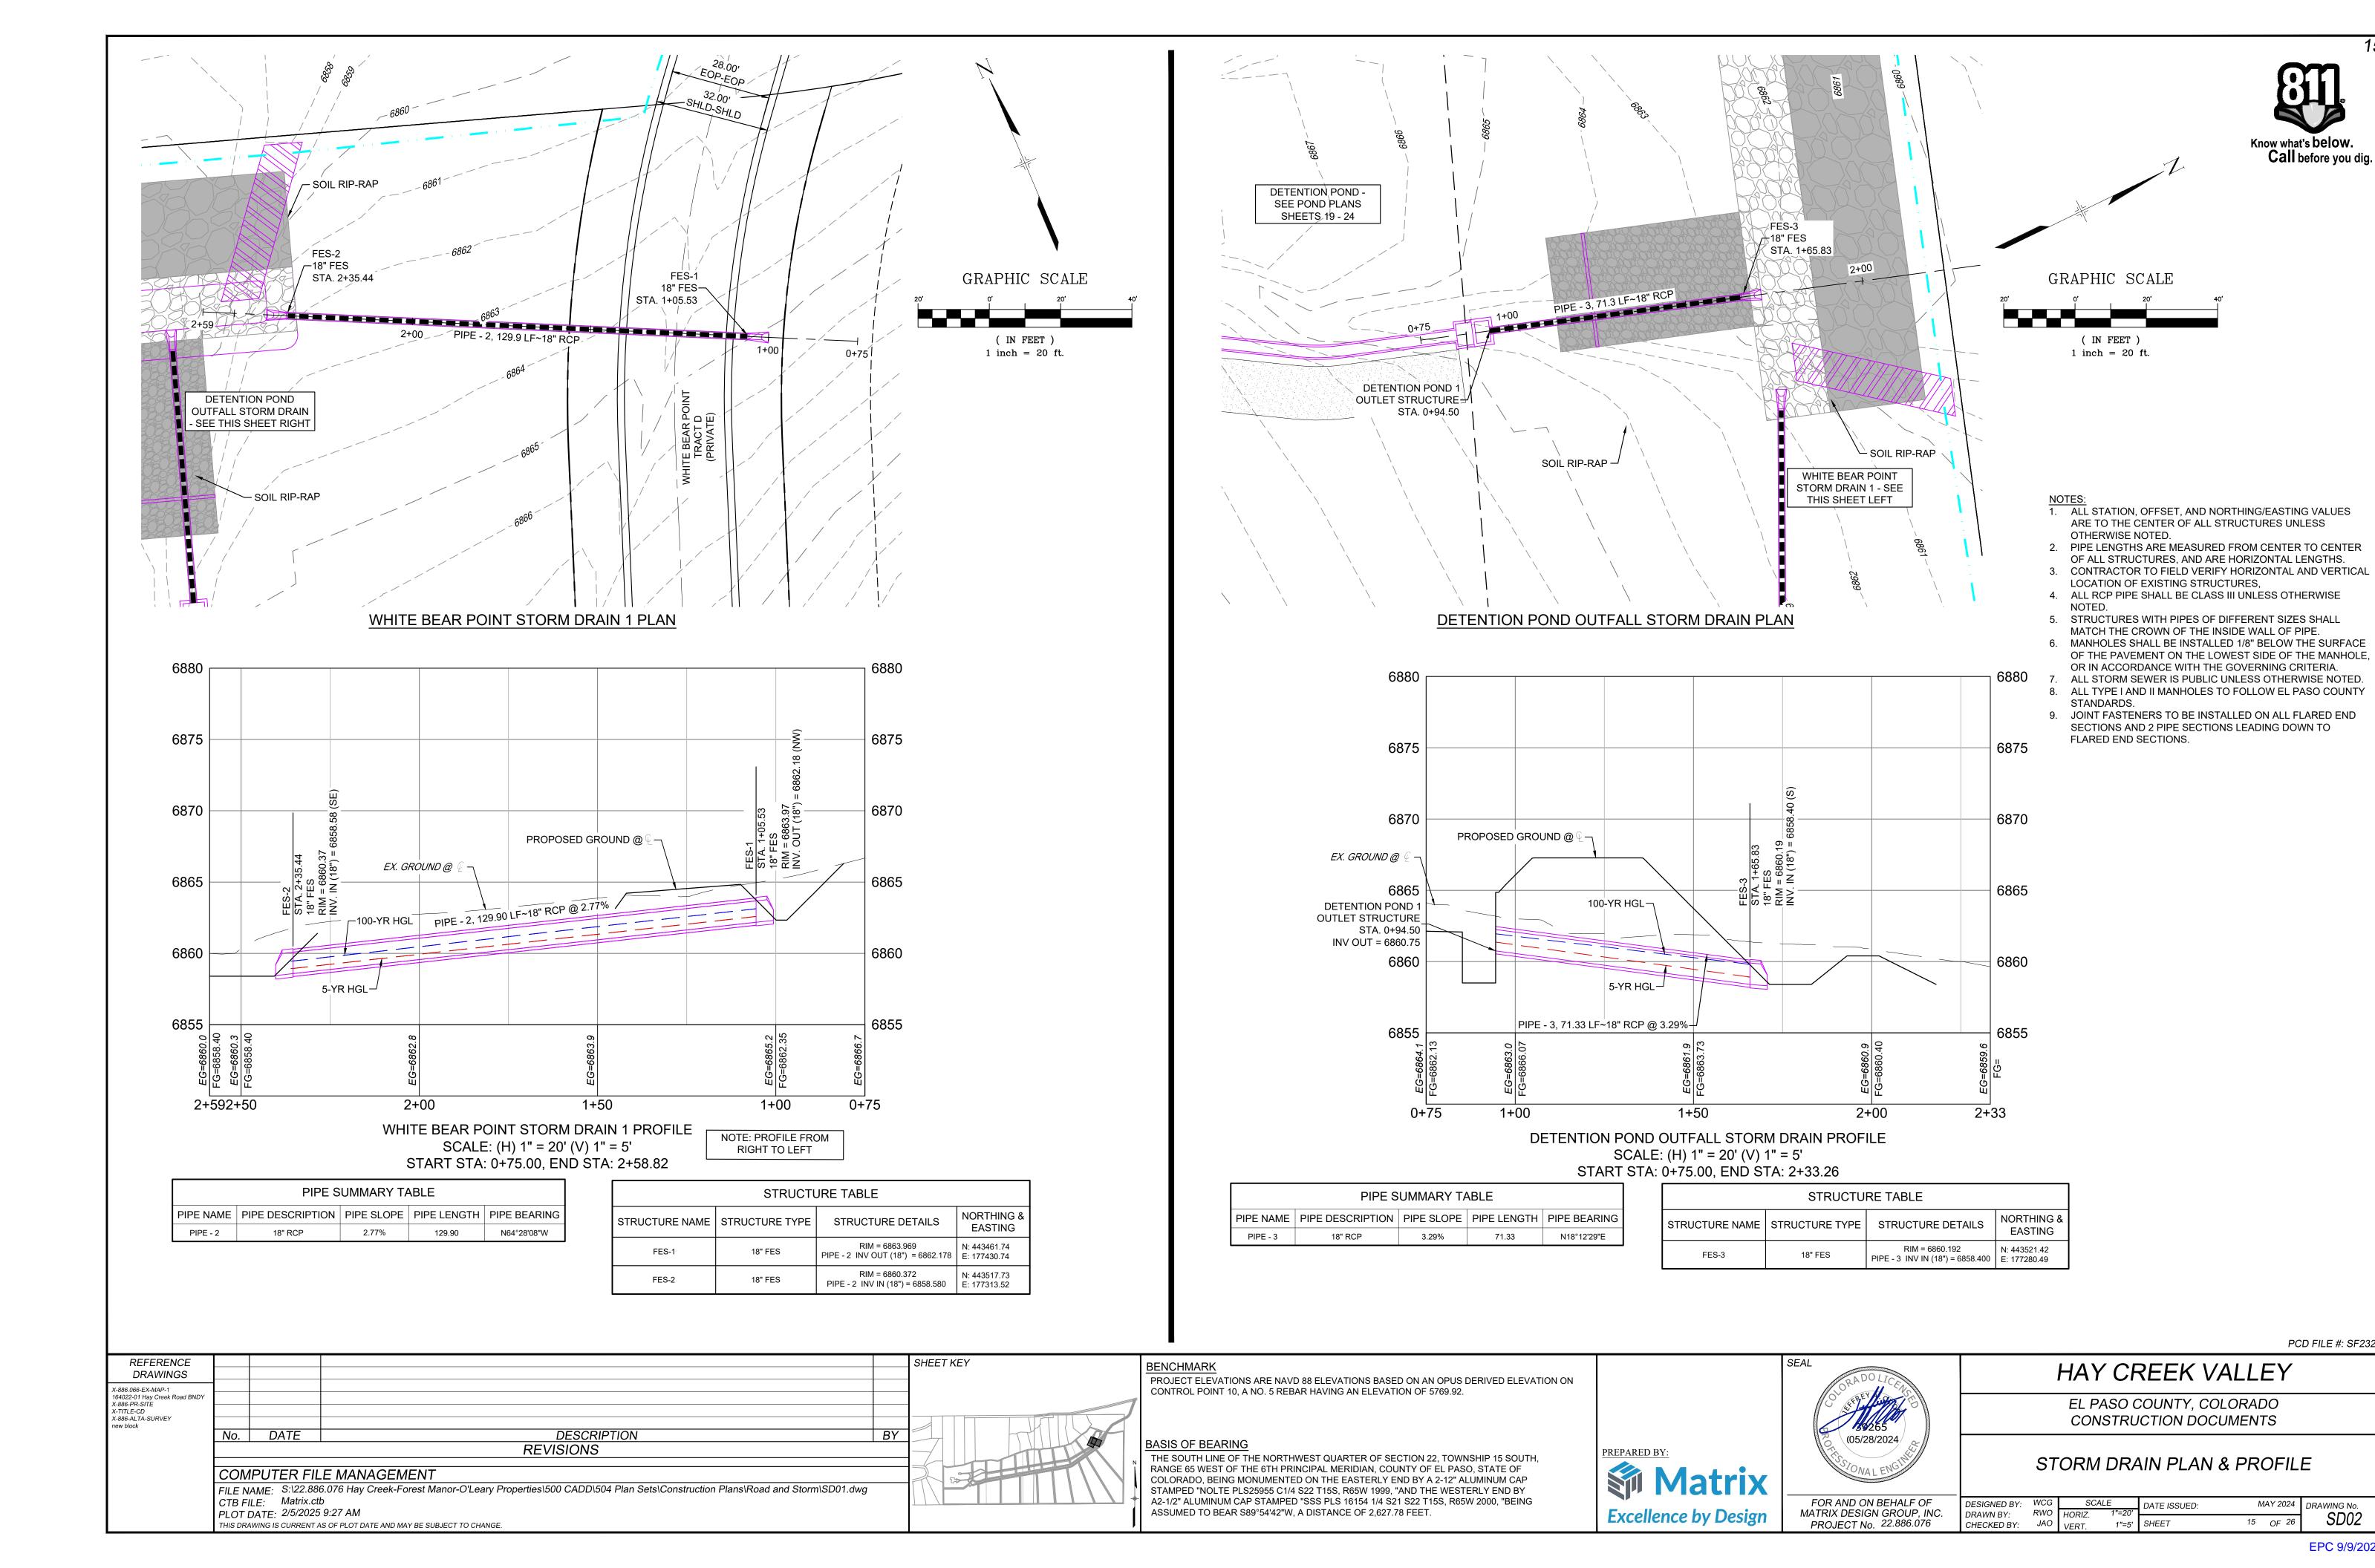

SD02

PCD FILE #: SF2324

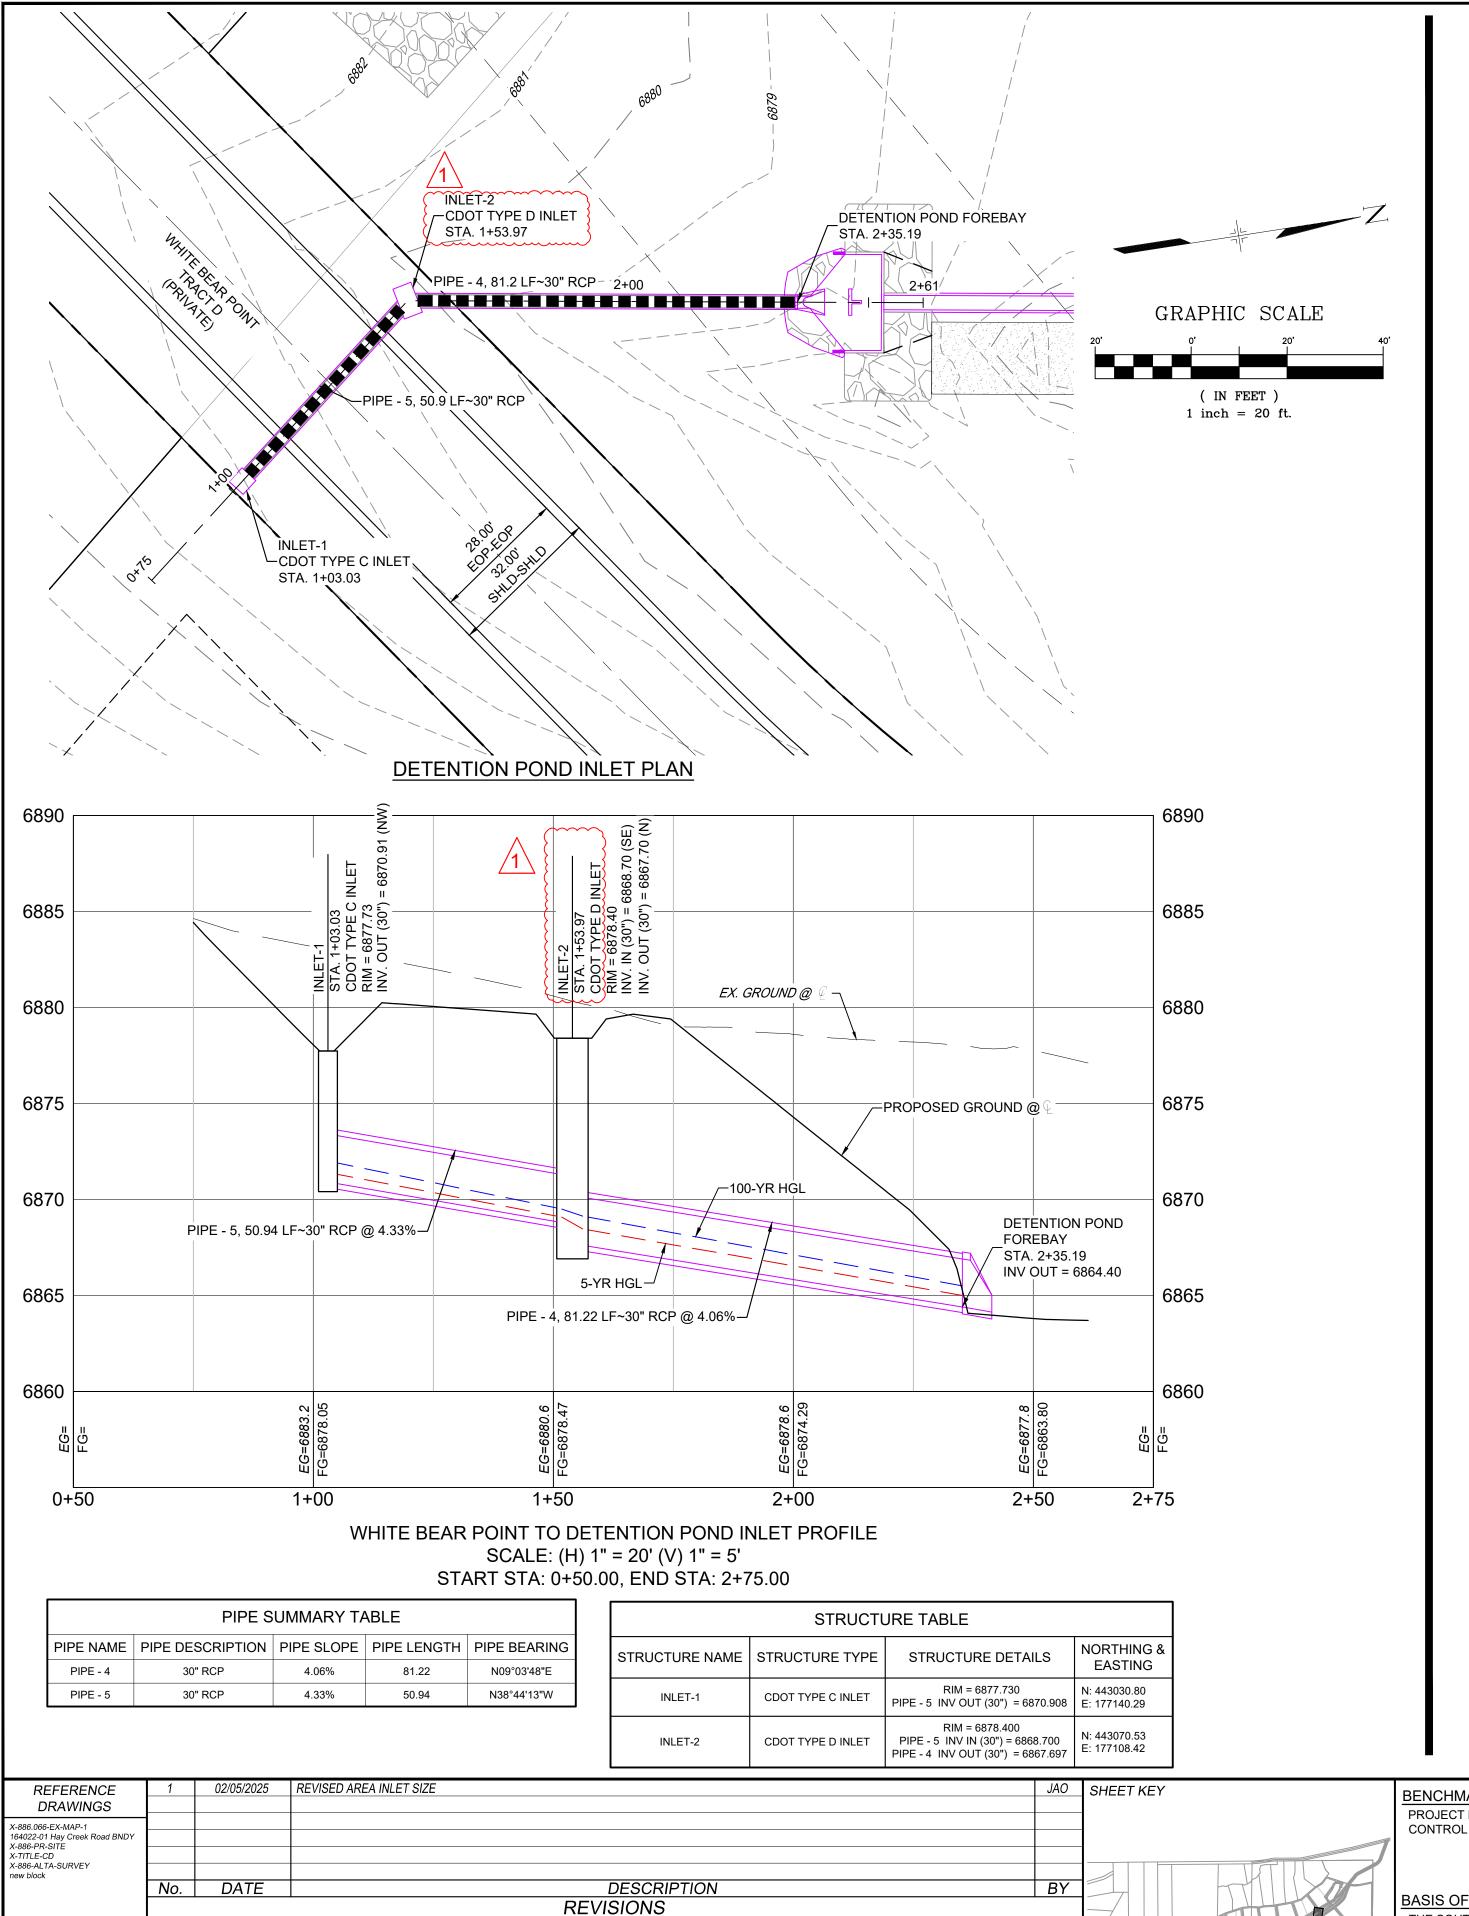

COMPUTER FILE MANAGEMENT

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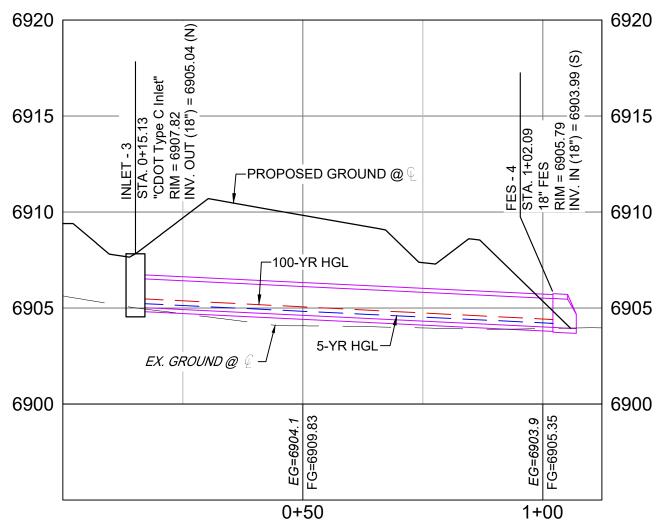
PLOT DATE: 2/5/2025 2:53 PM

FILE NAME: S:\22.886.076 Hay Creek-Forest Manor-O'Leary Properties\500 CADD\504 Plan Sets\Construction Plans\Road and Storm\SD01.dwg

`,"CDOT Type C Inlet"¬ STA. 0+15.13 FES - 4 18" FES¬ STA. 1+02.09 WHITE BEAR POINT STORM DRAIN 2 PLAN NOTE: ALIGNMENT FROM RIGHT TO LEFT

GRAPHIC SCALE (IN FEET) 1 inch = 20 ft.NOTES:

1. ALL STATION, OFFSET, AND NORTHING/EASTING VALUES ARE TO THE CENTER OF ALL STRUCTURES UNLESS OTHERWISE NOTED. 2. PIPE LENGTHS ARE MEASURED FROM CENTER TO CENTER OF ALL STRUCTURES, AND ARE HORIZONTAL LENGTHS. CONTRACTOR TO FIELD VERIFY HORIZONTAL AND VERTICAL LOCATION OF EXISTING STRUCTURES, ALL RCP PIPE SHALL BE CLASS III UNLESS OTHERWISE 5. STRUCTURES WITH PIPES OF DIFFERENT SIZES SHALL MATCH THE CROWN OF THE INSIDE WALL OF PIPE. MANHOLES SHALL BE INSTALLED 1/8" BELOW THE SURFACE OF THE PAVEMENT ON THE LOWEST SIDE OF THE MANHOLE, OR IN ACCORDANCE WITH THE GOVERNING CRITERIA. ALL STORM SEWER IS PUBLIC UNLESS OTHERWISE NOTED. 8. ALL TYPE I AND II MANHOLES TO FOLLOW EL PASO COUNTY STANDARDS. 9. JOINT FASTENERS TO BE INSTALLED ON ALL FLARED END SECTIONS AND 2 PIPE SECTIONS LEADING DOWN TO FLARED END SECTIONS.



WHITE BEAR POINT STORM 2 PROFILE SCALE: (H) 1" = 20' (V) 1" = 5' START STA: 0+00.00, END STA: 1+12.27

PIPE SUMMARY TABLE					
PIPE NAME	PIPE DESCRIPTION	PIPE SLOPE	PIPE LENGTH	PIPE BEARING	
PIPE - 7	18" RCP	1.20%	86.96	N05°34'40"W	

STRUCTURE TABLE						
STRUCTURE NAME	STRUCTURE TYPE	STRUCTURE DETAILS	NORTHING & EASTING			
FES - 4	18" FES	RIM = 6905.785 PIPE - 7 INV IN (18") = 6903.994	N: 442738.25 E: 176605.10			
INLET - 3	"CDOT Type C Inlet"	RIM = 6907.819 PIPE - 7 INV OUT (18") = 6905.037	N: 442651.70 E: 176613.56			

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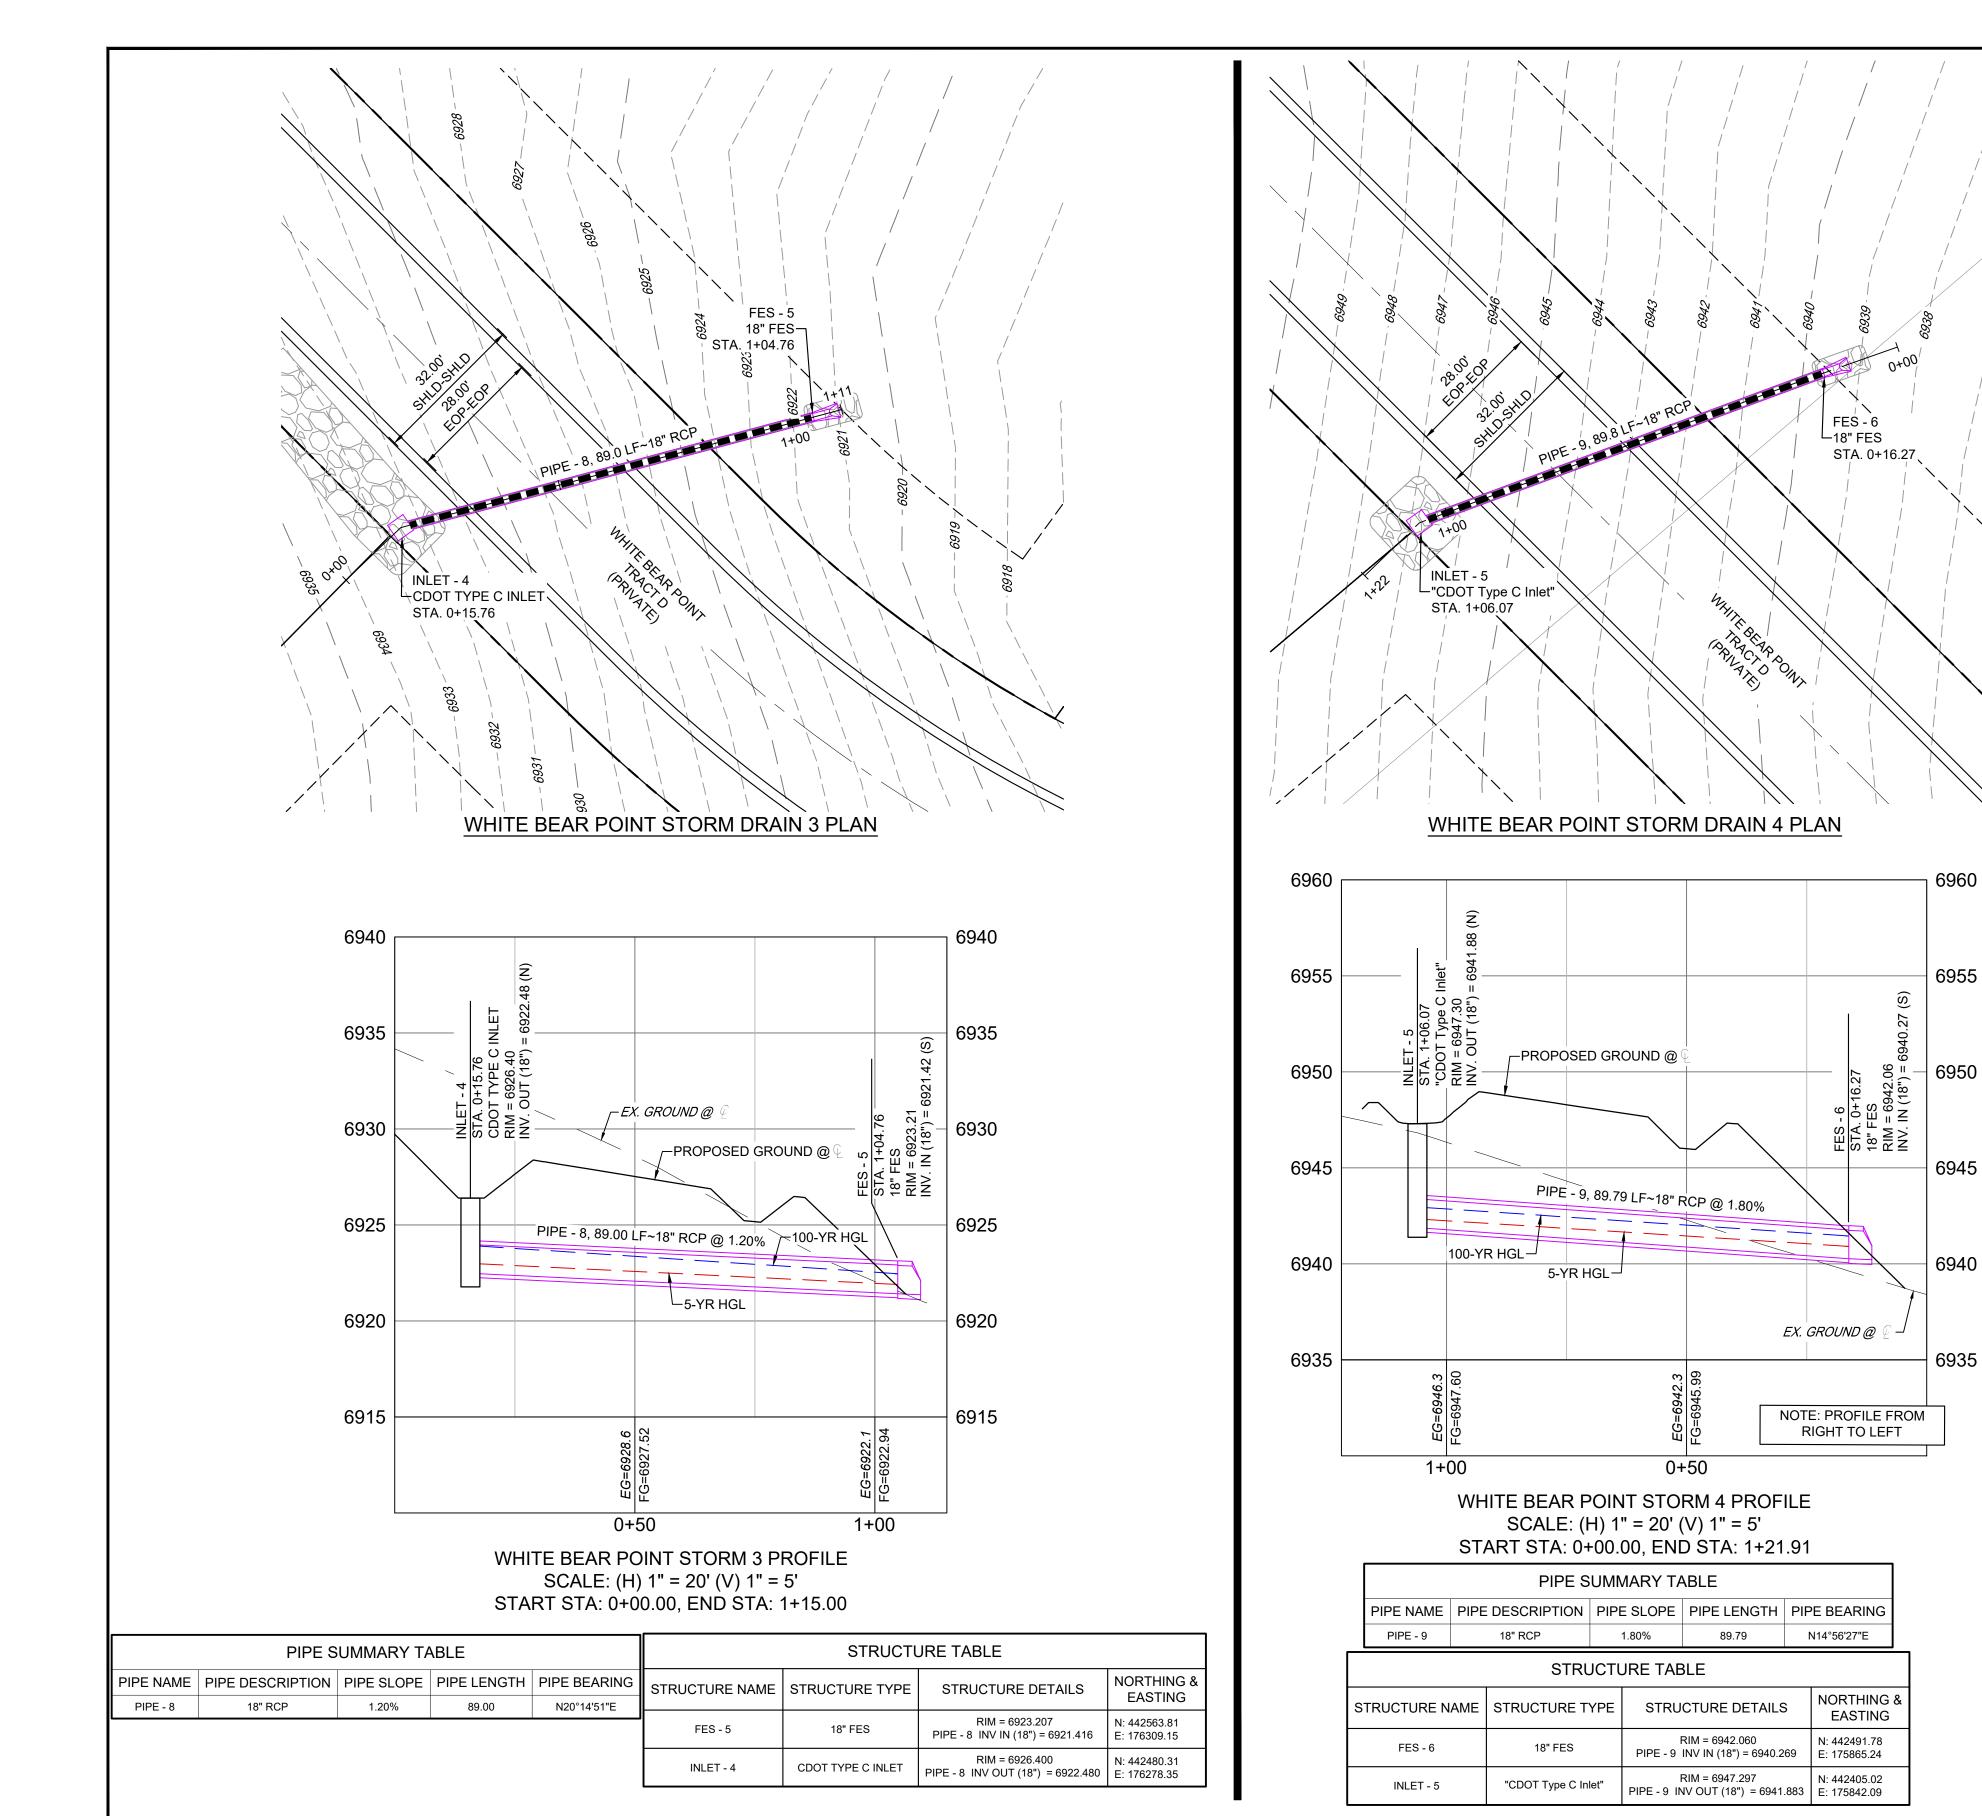



HAY CREEK VALLEY


EL PASO COUNTY, COLORADO CONSTRUCTION DOCUMENTS

STORM DRAIN PLAN & PROFILE

DESIGNED BY: WCG SCALE DATE ISSUED: DRAWN BY: RWO HORIZ. 1"=20' MAY 2024 DRAWING No. FOR AND ON BEHALF OF MATRIX DESIGN GROUP, INC. PROJECT No. 22.886.076 SD03 16 OF 26 CHECKED BY:



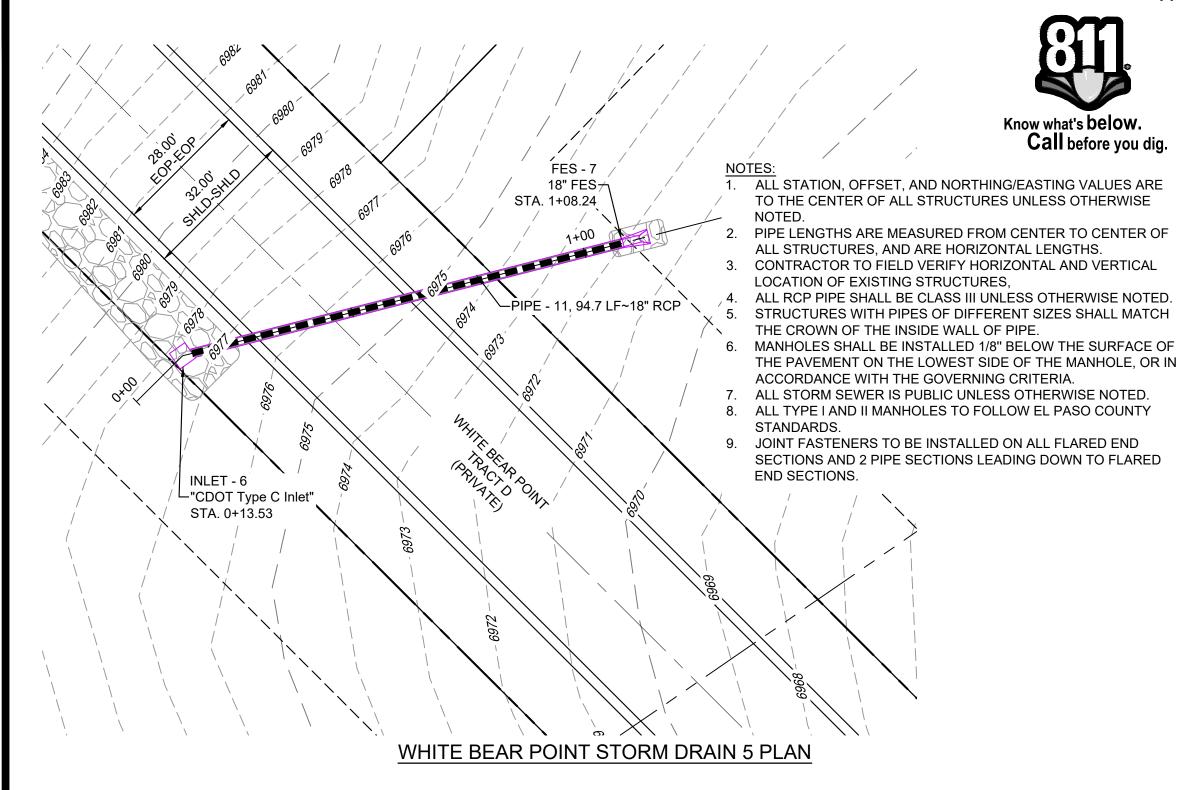


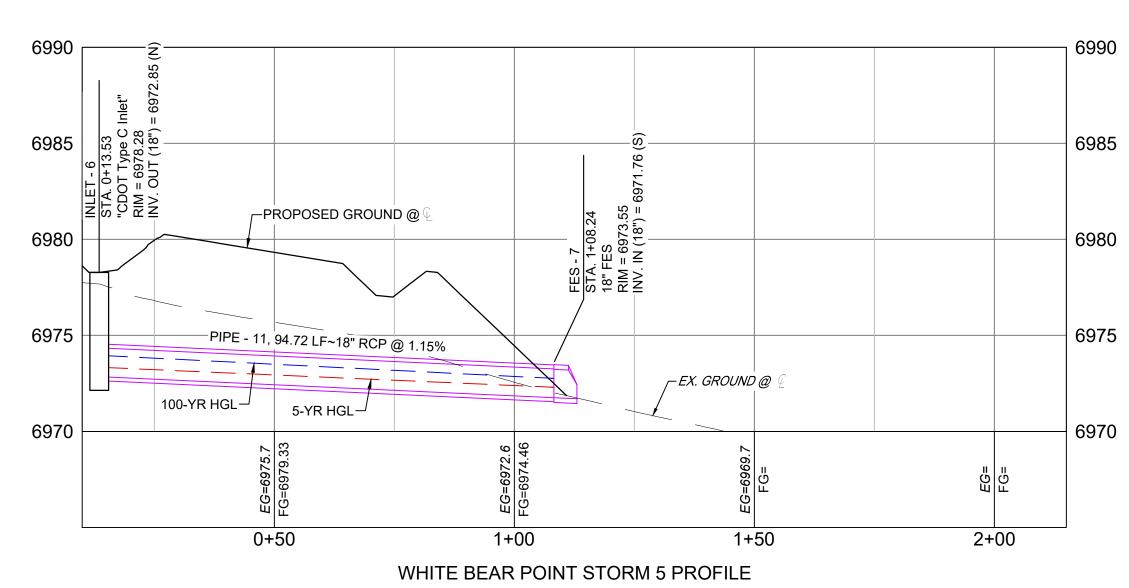

SCALE: (H) 1" = 20' (V) 1" = 5' START STA: 0+10.00, END STA: 2+15.00

	PIPE S	UMMARY TA	ABLE	
PIPE NAME	PIPE DESCRIPTION	PIPE SLOPE	PIPE LENGTH	PIPE BEARING
PIPE - 11	18" RCP	1.15%	94.72	N20°54'21"E

STRUCTURE TABLE **NORTHING 8** STRUCTURE DETAILS STRUCTURE NAME | STRUCTURE TYPE **EASTING** RIM = 6973.549 N: 442378.97 PIPE - 11 INV IN (18") = 6971.758 E: 175209.32 RIM = 6978.280 N: 442290.49 "CDOT Type C Inlet" INLET - 6 PIPE - 11 INV OUT (18") = 6972.850 | E: 175175.52

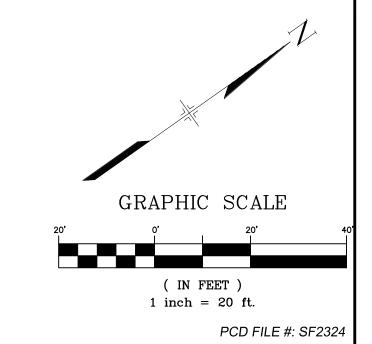

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REFERENCE DRAWINGS					SHEET KEY
X-886.066-EX-MAP-1 164022-01 Hay Creek Road BNDY					_
X-886-PR-SITE X-TITLE-CD X-886-ALTA-SURVEY					1
new block	No.	DATE	DESCRIPTION	BY	
			REVISIONS		
			LE MANAGEMENT		
	FILE NA		6.076 Hay Creek-Forest Manor-O'Leary Properties\500 CADD\504 Plan Sets\Construction Plans\Road and Storm\SD01.dwg		
	PLOT D	DATE: 2/5/2025			

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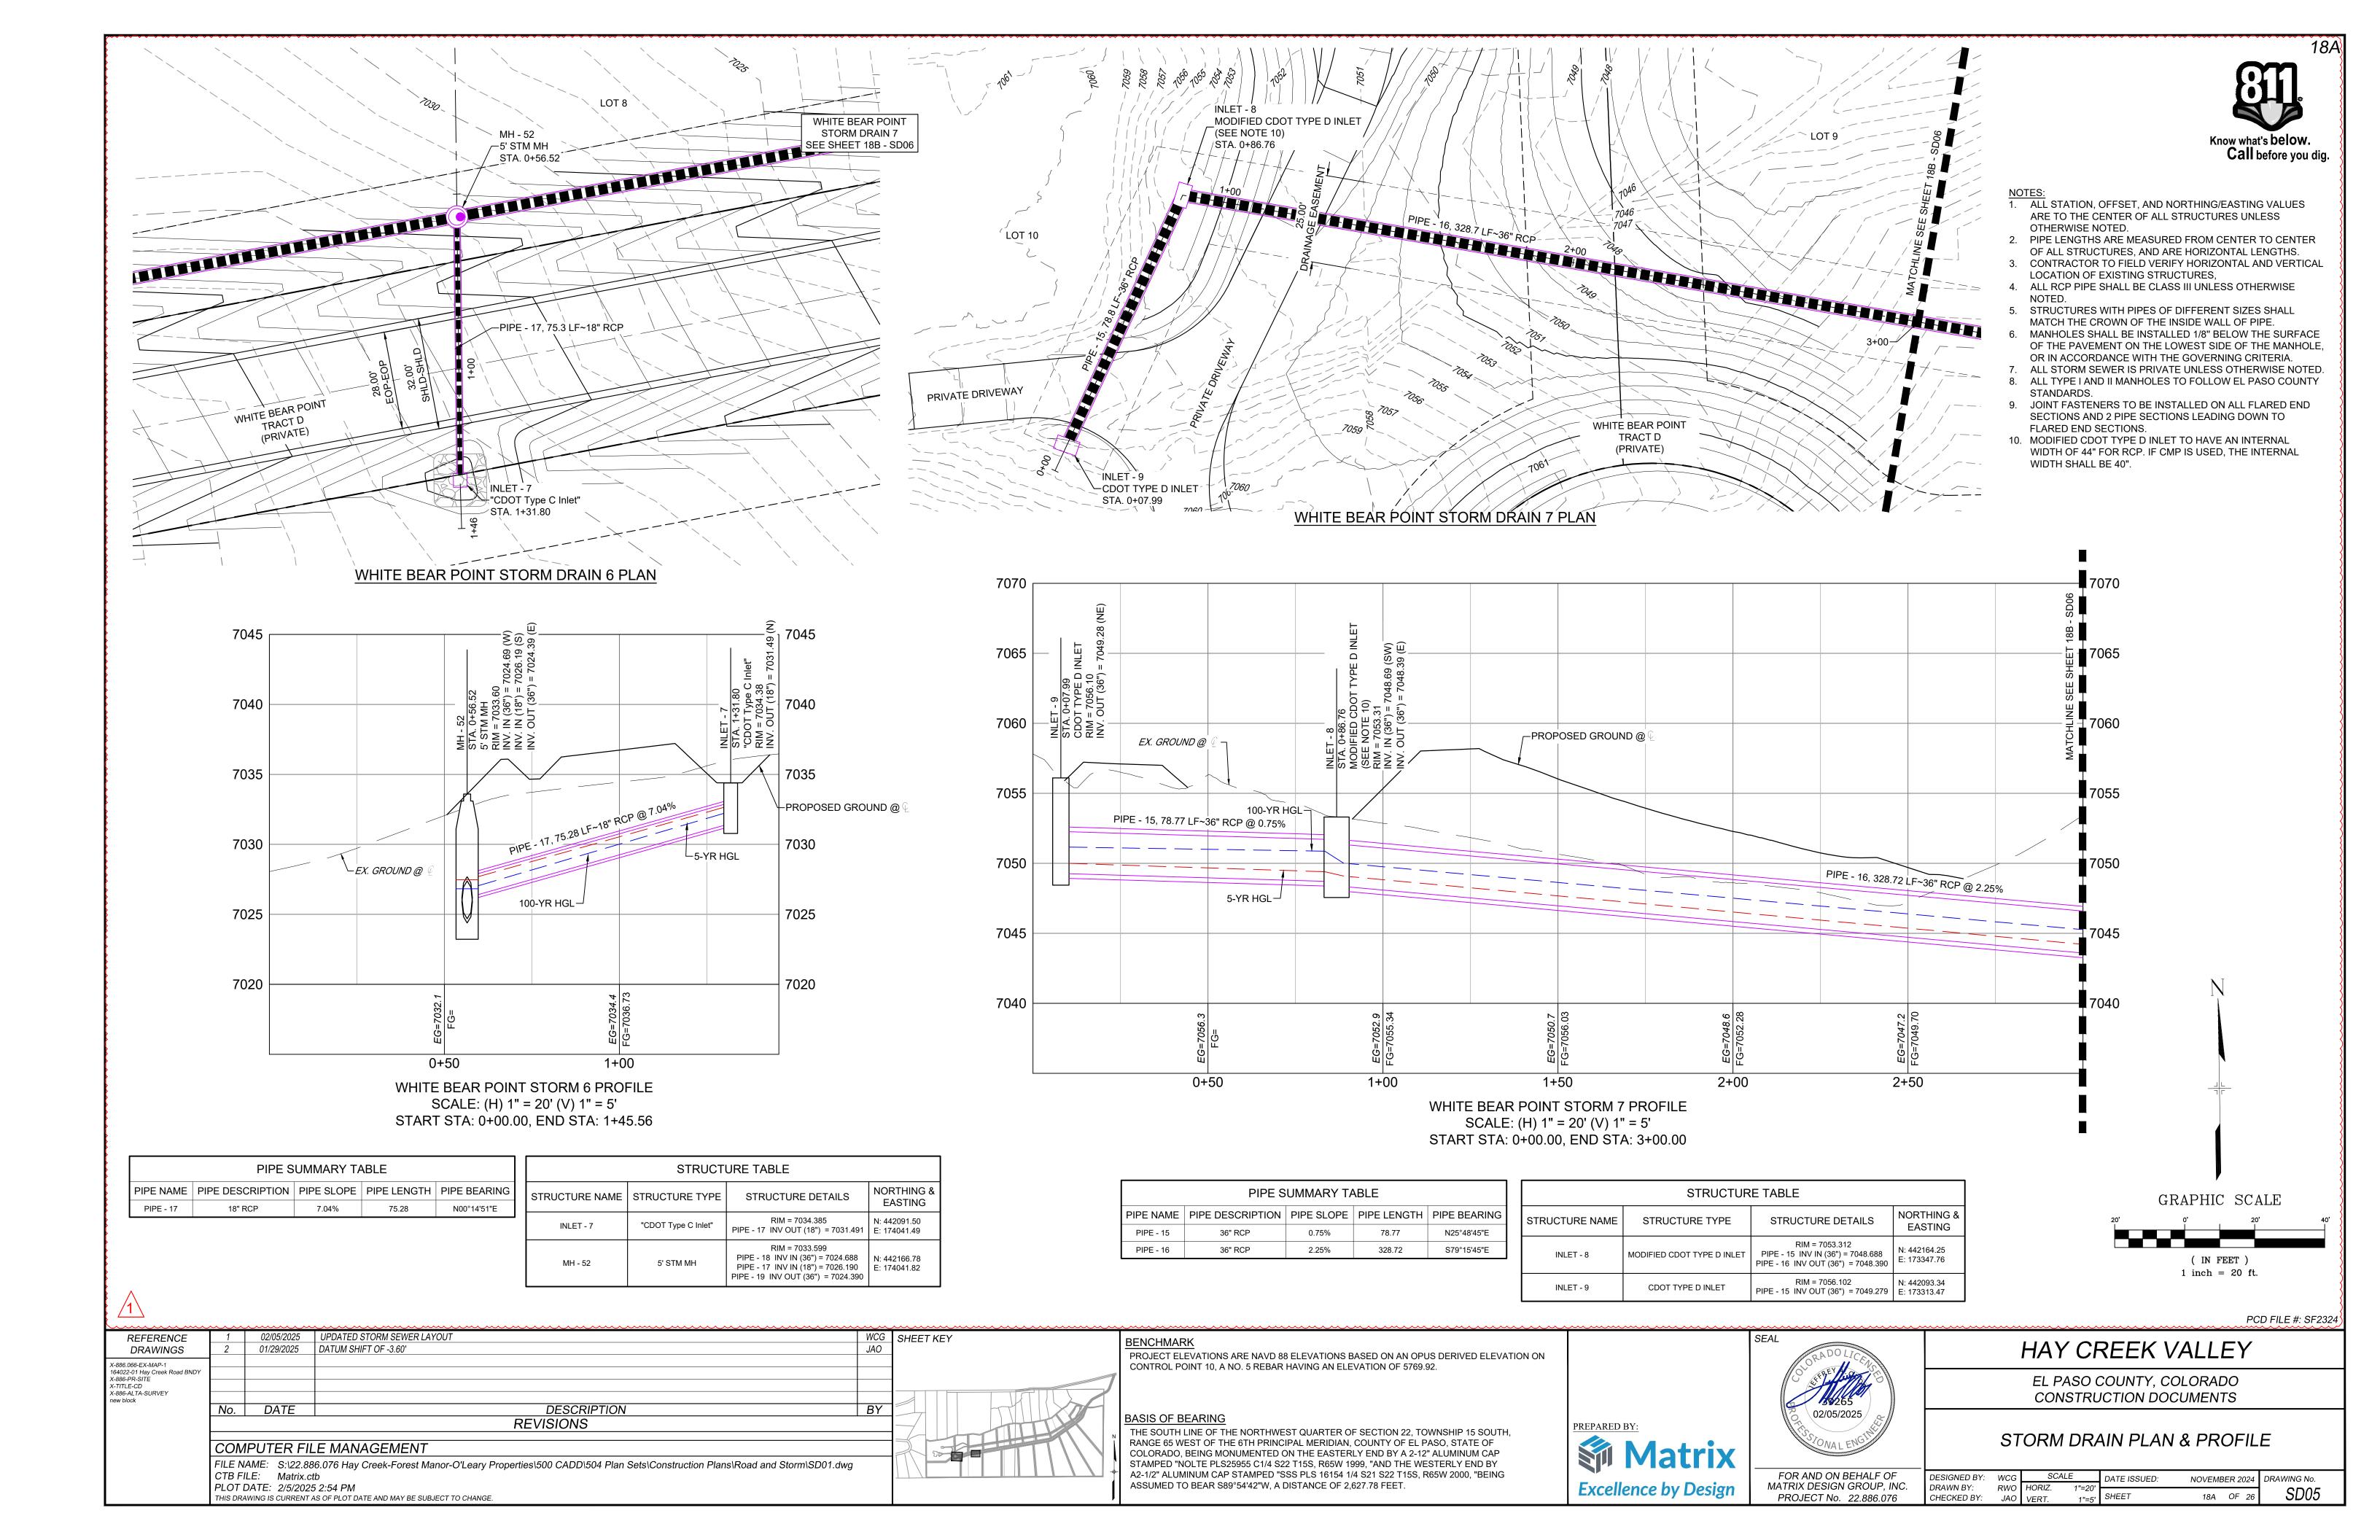



HAY CREEK VALLEY


EL PASO COUNTY, COLORADO CONSTRUCTION DOCUMENTS


STORM DRAIN PLAN & PROFILE


DESIGNED BY: WCG SCALE DATE ISSUED:
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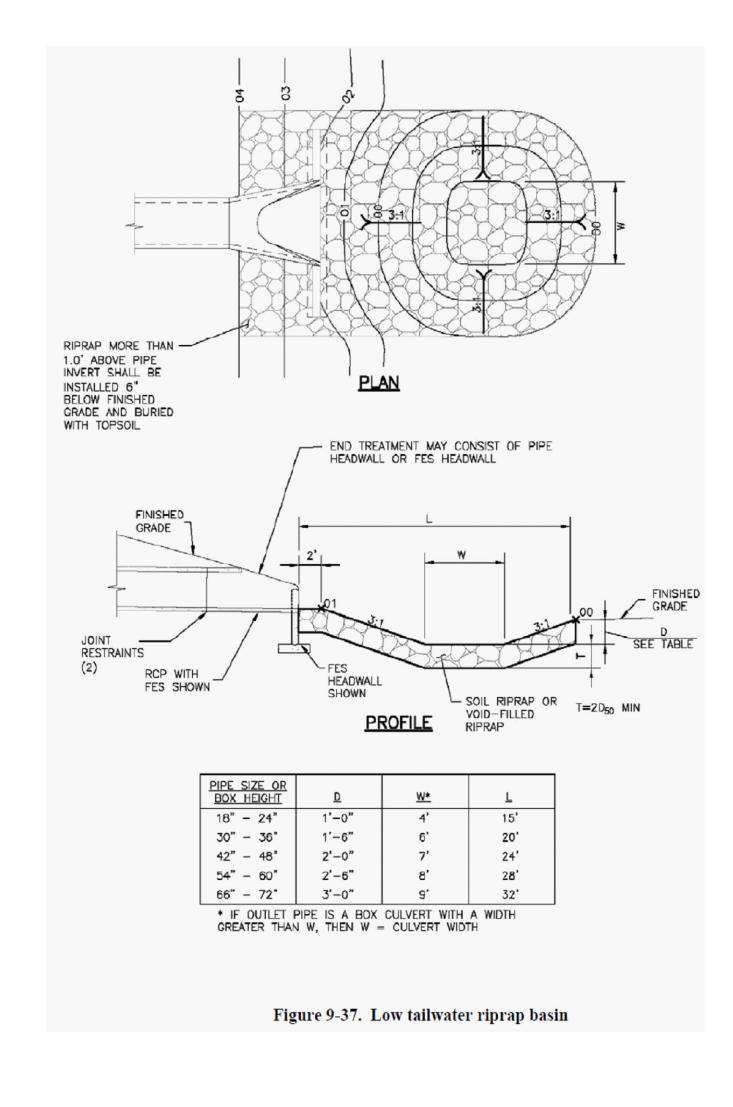




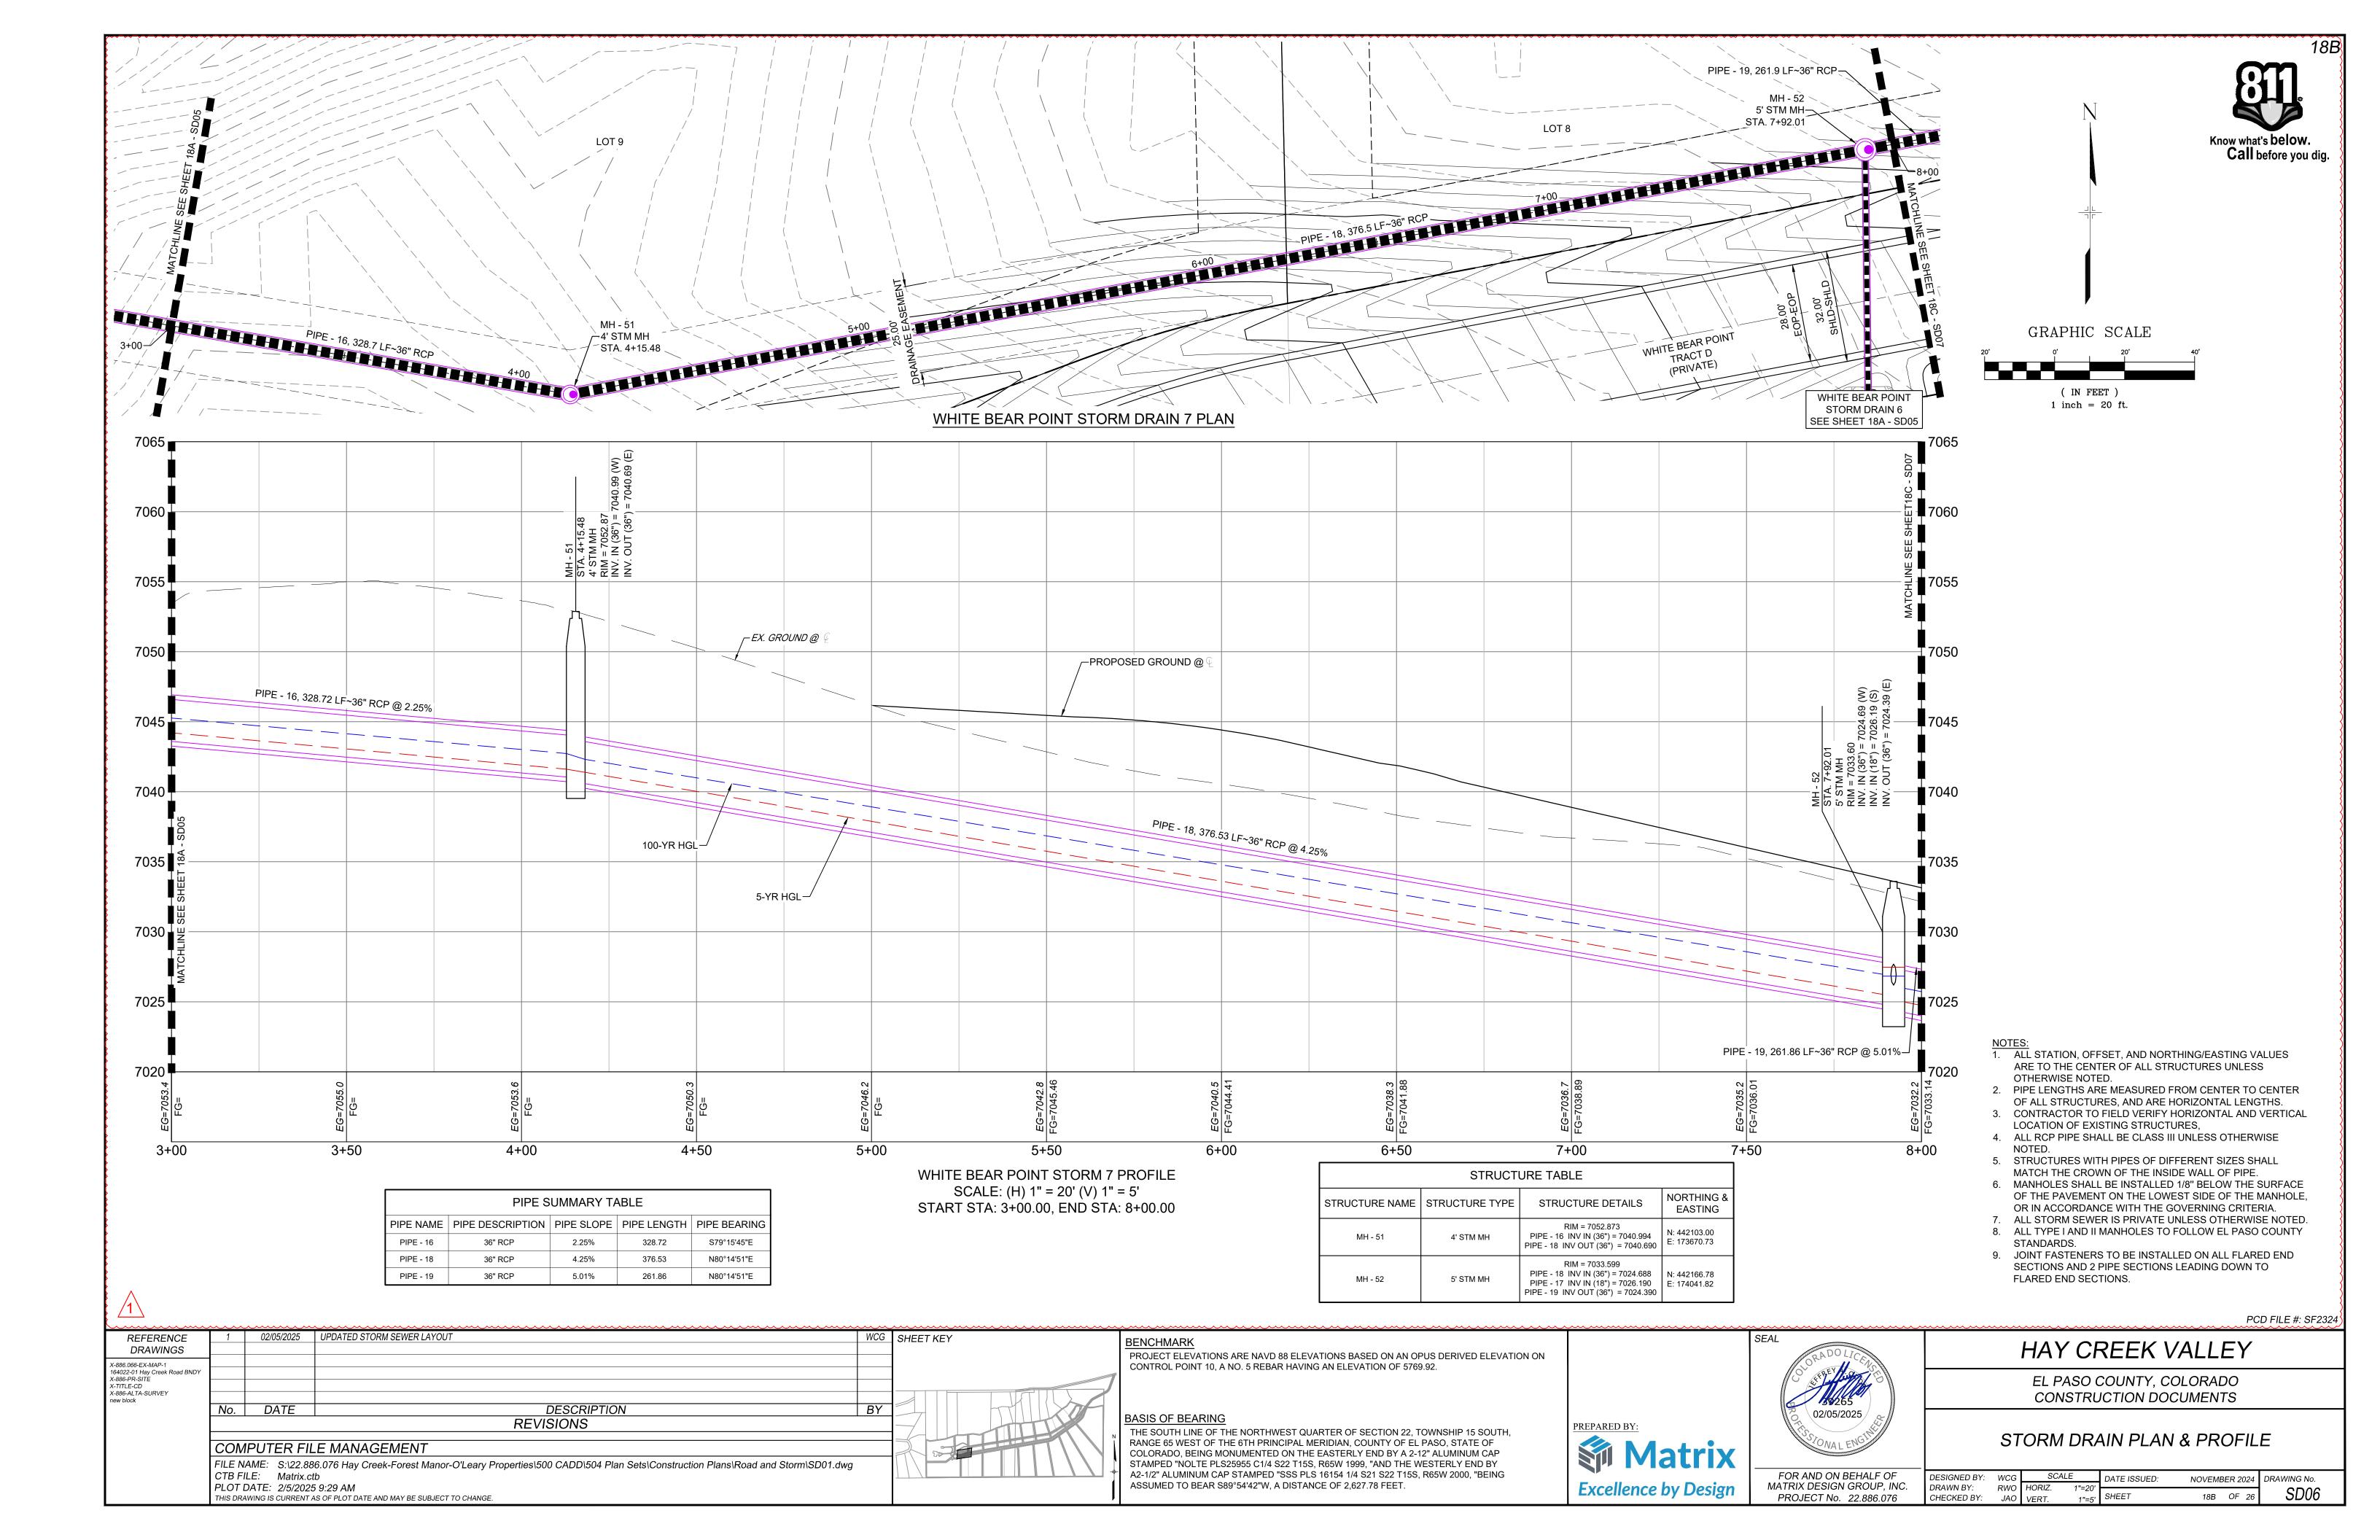

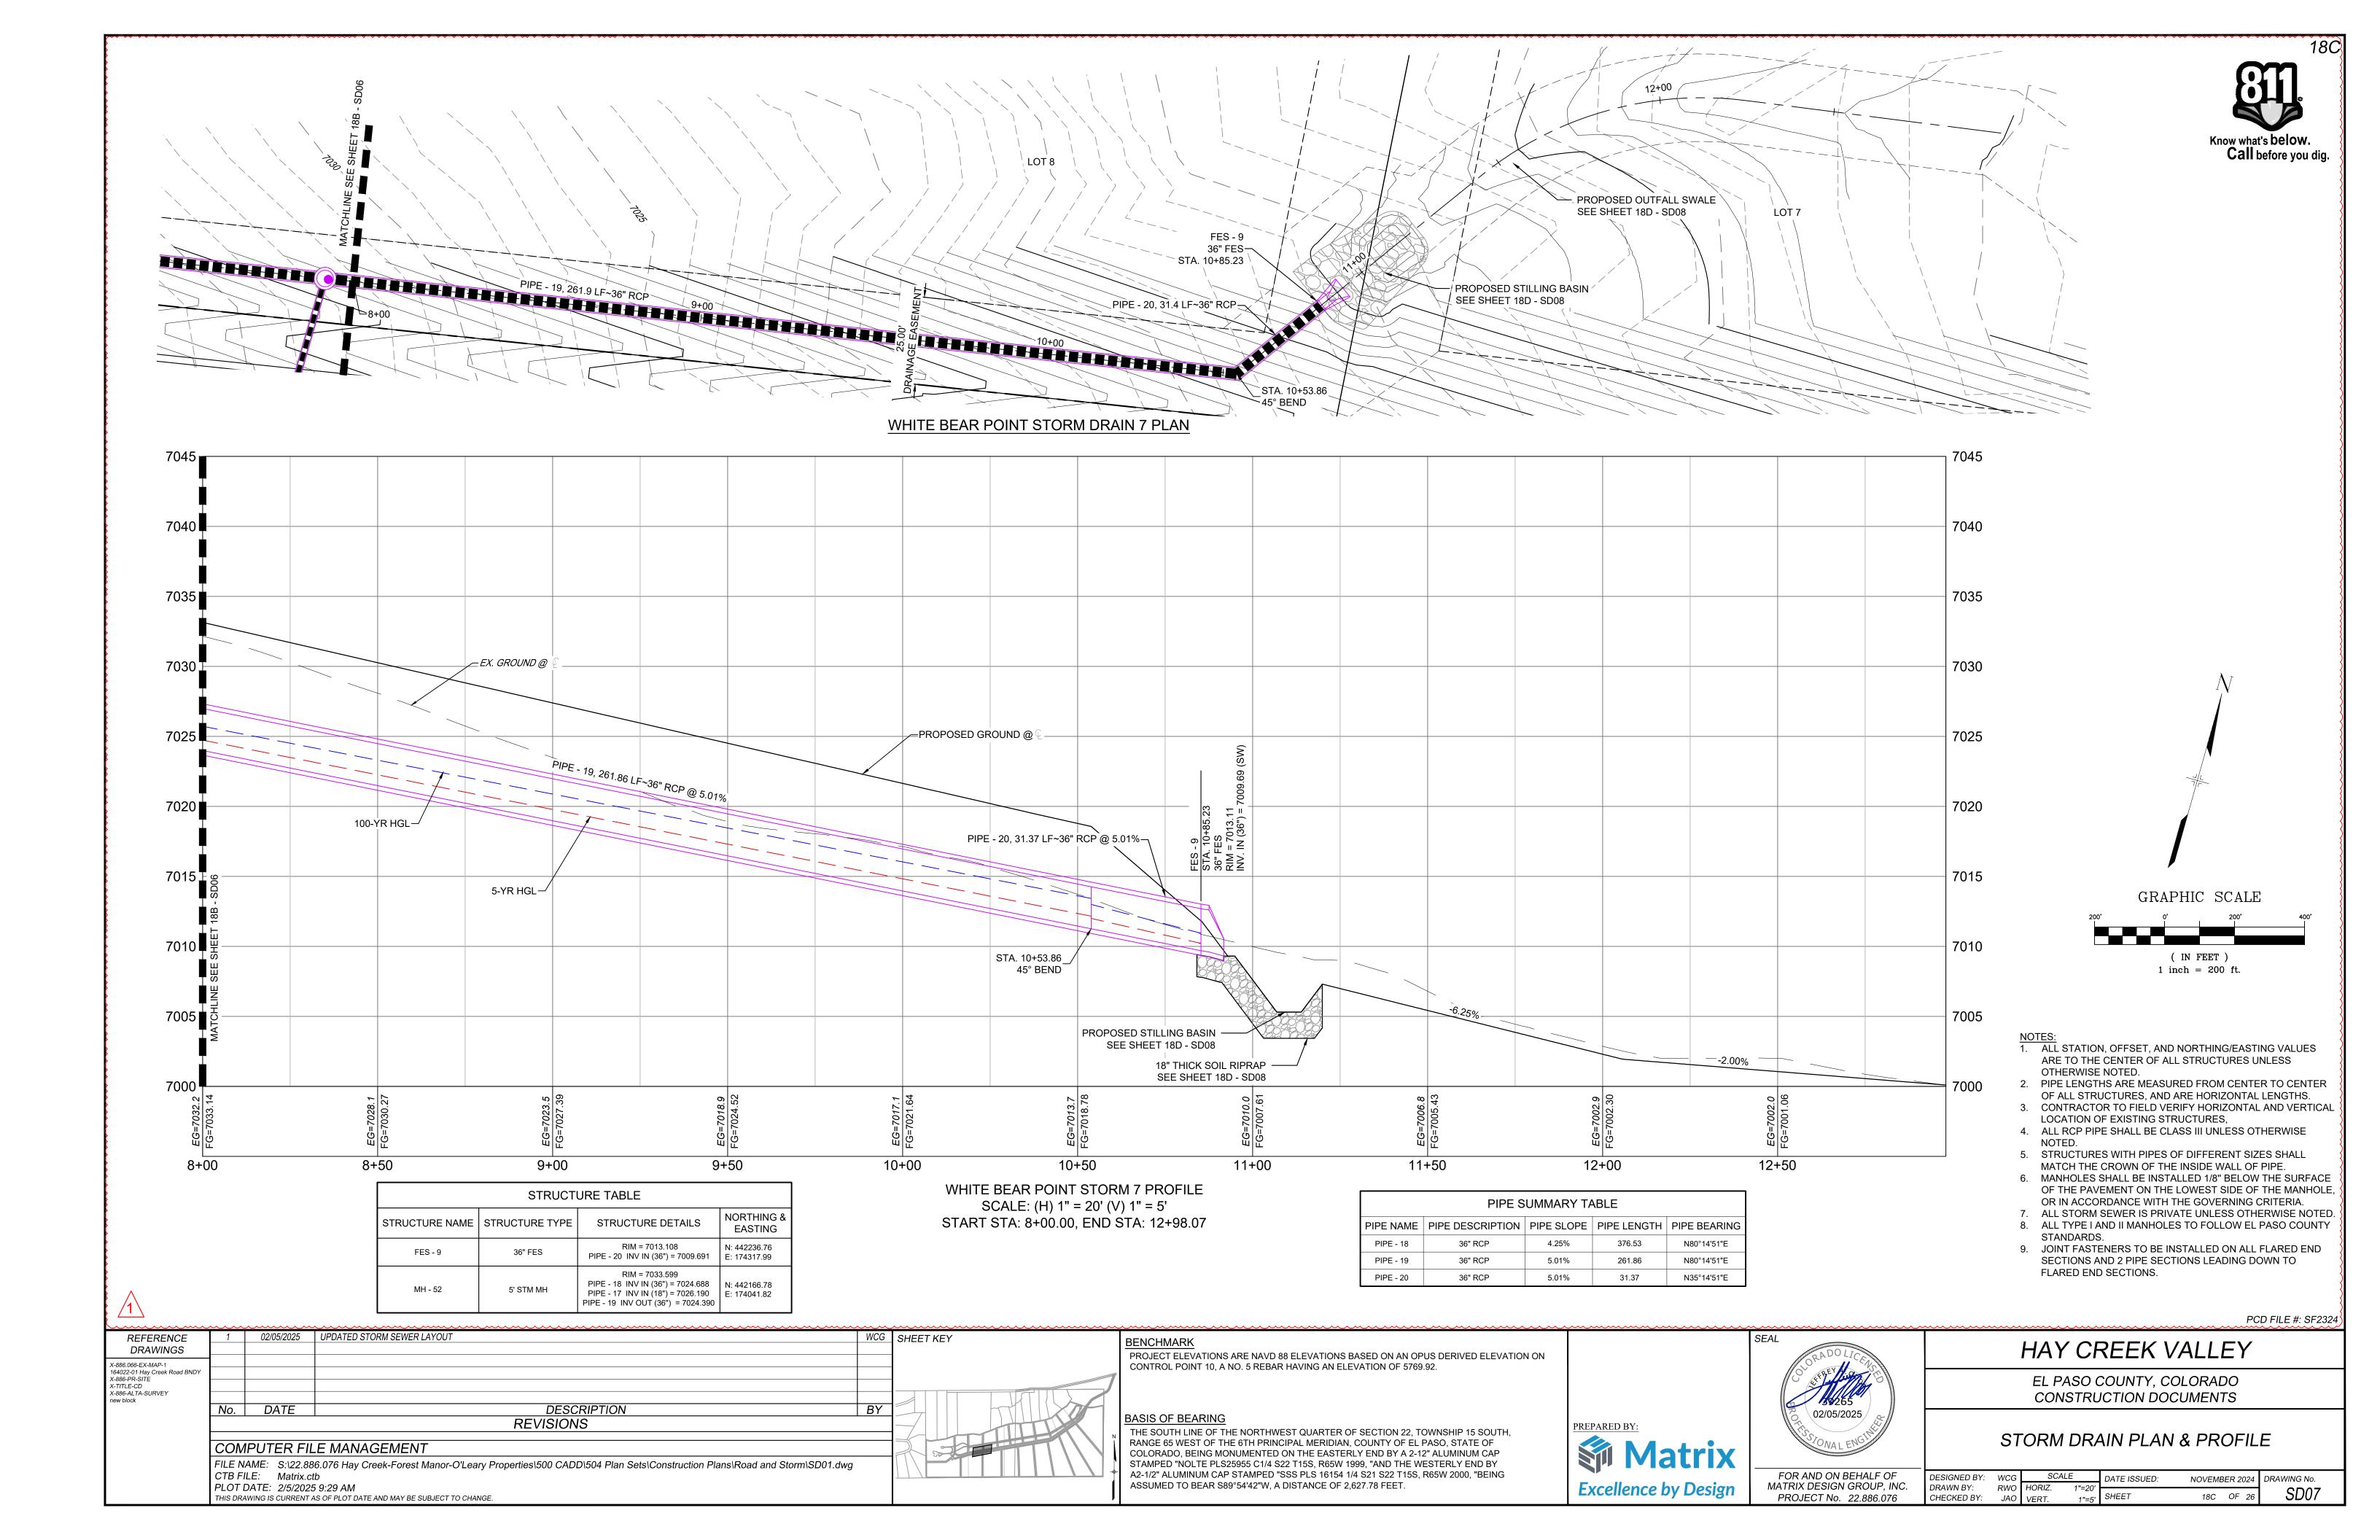

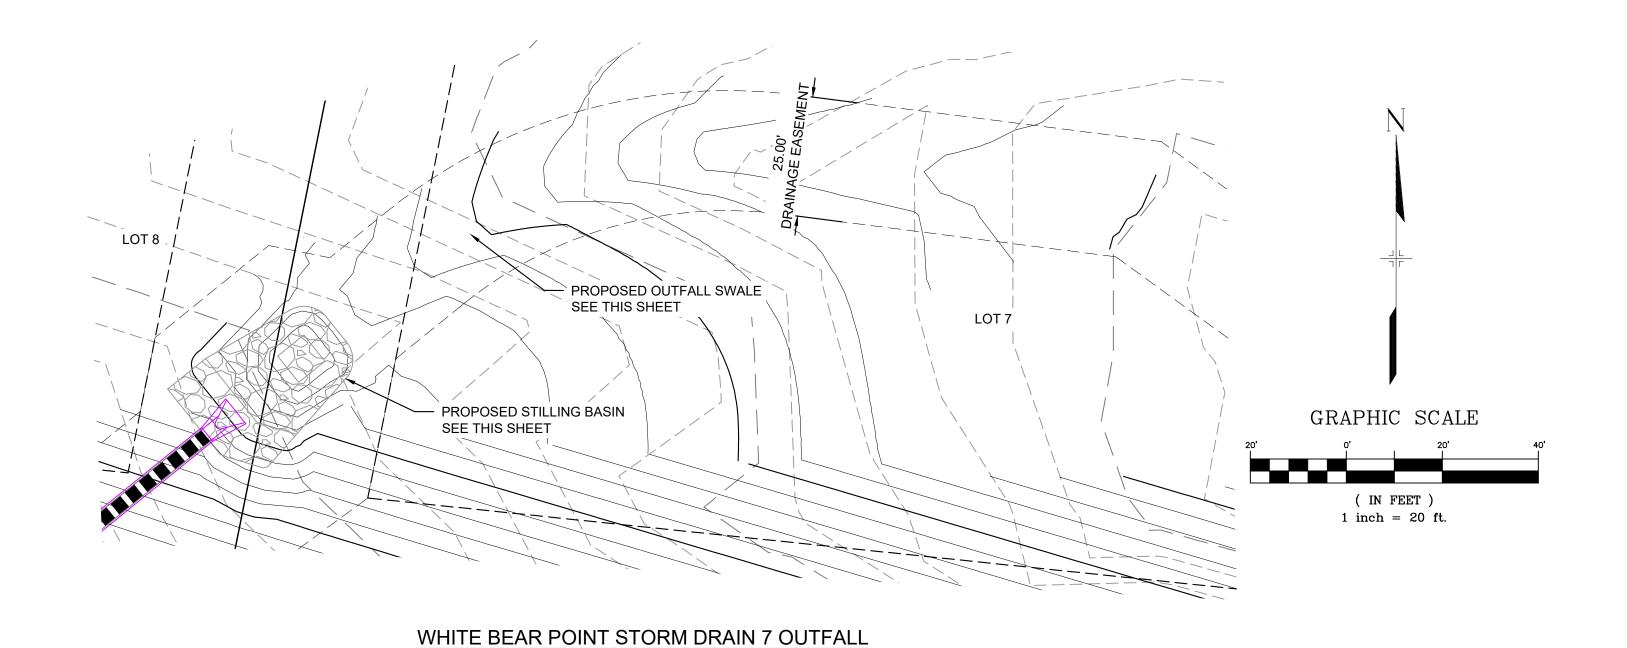PLAN

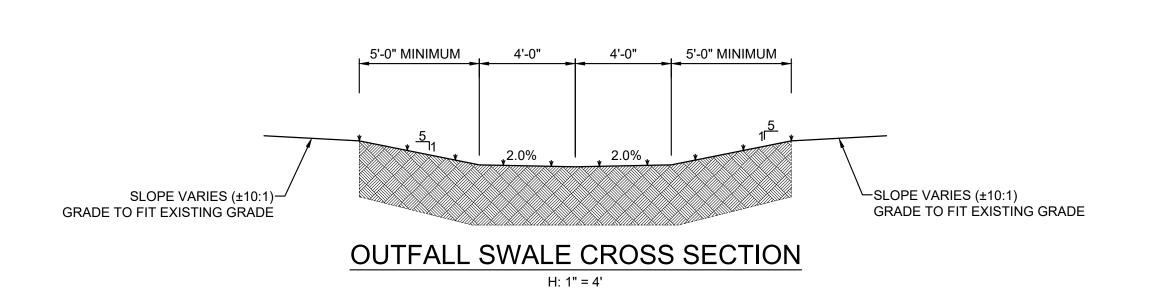

- NOTES:

 1. ALL STATION, OFFSET, AND NORTHING/EASTING VALUES ARE TO THE CENTER OF ALL STRUCTURES UNLESS OTHERWISE NOTED.
- 2. PIPE LENGTHS ARE MEASURED FROM CENTER TO CENTER OF ALL STRUCTURES, AND ARE HORIZONTAL LENGTHS.
- 3. CONTRACTOR TO FIELD VERIFY HORIZONTAL AND VERTICAL LOCATION OF EXISTING STRUCTURES,
- 4. ALL RCP PIPE SHALL BE CLASS III UNLESS OTHERWISE NOTED.
- 5. STRUCTURES WITH PIPES OF DIFFERENT SIZES SHALL MATCH THE CROWN OF THE INSIDE WALL OF PIPE. 6. MANHOLES SHALL BE INSTALLED 1/8" BELOW THE SURFACE OF THE PAVEMENT ON THE LOWEST SIDE OF THE MANHOLE,
- OR IN ACCORDANCE WITH THE GOVERNING CRITERIA. 7. ALL STORM SEWER IS PRIVATE UNLESS OTHERWISE NOTED.
- 8. ALL TYPE I AND II MANHOLES TO FOLLOW EL PASO COUNTY STANDARDS.
- 9. JOINT FASTENERS TO BE INSTALLED ON ALL FLARED END SECTIONS AND 2 PIPE SECTIONS LEADING DOWN TO FLARED END SECTIONS.

PCD FILE #: SF2324

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SEL SEL
F.

HAY CREEK VALLEY

EL PASO COUNTY, COLORADO CONSTRUCTION DOCUMENTS

STORM DRAIN PLAN & PROFILE

FOR AND ON BEHALF OF	DESIGNED BY:	WCG	SCA	LE	DATE ISSUED:	NOVEMBER 2024	DRAWING No.
MATRIX DESIGN GROUP, INC. PROJECT No. 22.886.076	DRAWN BY: CHECKED BY:	RWO	HORIZ.	1"=20'	SHEET	18D OF 26	SD08
FINOULOTINO, 22.000.070	CHLORED DT.	JAO	VERT.	1"=5'	0,,,	100 01 20	

- ALL MATERIALS AND WORKMANSHIP SHALL BE IN CONFORMANCE WITH EL PASO COUNTY SPECIFICATIONS, UNLESS NOTED OTHERWISE.
- 2. IT IS SUGGESTED THAT THE CONTRACTOR INITIATE A REQUEST TO MOUNTAIN VIEW ELECTRIC ASSOCIATION FOR ANY CONSTRUCTION RELATED TEMPORARY ELECTRICAL POWER SOURCES AS SOON AS POSSIBLE. IN SOME INSTANCES UP TO 30 DAYS MAY BE REQUIRED TO PROVIDE THE SOURCE.
- THE CONTRACTOR IS RESPONSIBLE FOR THE RE-ESTABLISHMENT OF ALL SURVEY MONUMENTS DISTURBED WITHIN THE PROJECT LIMITS.
- 4. THE CONTRACTOR IS RESPONSIBLE FOR PROVIDING HIS OWN ESTIMATE OF EARTHWORK QUANTITIES.
- EXISTING DRAINAGE STRUCTURES TO BE INSPECTED AND REPAIRED AS NEEDED. AND EXISTING PIPES TO BE CLEANED OUT TO REMOVE ALL SILT AND DEBRIS.
- IF ANY EXISTING STRUCTURES TO REMAIN ARE DAMAGED DURING CONSTRUCTION, IT SHALL BE THE CONTRACTOR'S RESPONSIBILITY TO REPAIR AND/OR REPLACE THE EXISTING STRUCTURES AS NECESSARY TO RETURN THEM TO EXISTING CONDITIONS OR BETTER.
- CONTRACTOR SHALL ADJUST AND/OR REMOVE AND REPLACE EXISTING PAVEMENT AS NECESSARY TO ASSURE A SMOOTH FIT AND CONTINUOUS GRADE.
- CONSTRUCTION SHALL COMPLY WITH ALL APPLICABLE GOVERNING CODES AND BE CONSTRUCTED TO SAME.

GENERAL GRADING NOTES:

- THE SITE SHALL BE STRIPPED A MINIMUM OF 0.5' BELOW EXISTING GRADE AND STOCKPILED IN CONFORMANCE WITH THE SWMP MANAGEMENT DIRECTION.
- 2. MAXIMUM CUT/FILL SLOPES SHALL NOT EXCEED 3:1, UNLESS OTHERWISE NOTED. ALL SLOPES MUST BE PROTECTED FROM EROSION.
- IF DURING THE OVERLOT GRADING PROCESS, CONDITIONS ARE ENCOUNTERED WHICH COULD INDICATE AN UNIDENTIFIED SITUATION IS PRESENT. THE SOILS ENGINEER SHALL BE CONTACTED FOR RECOMMENDATIONS.
- THE CONTRACTOR SHALL PROTECT ALL WORK AREAS AND FACILITIES FROM FLOODING AT ALL TIMES. AREAS AND FACILITIES SUBJECTED TO FLOODING, REGARDLESS OF THE SOURCE OF WATER, SHALL BE PROMPTLY DEWATERED AND RESTORED.
- THE CONTRACTOR IS RESPONSIBLE FOR PREVENTING AND CONTROLLING EROSION DURING CONSTRUCTION ACTIVITIES AT ALL TIMES DURING GRADING AND CONSTRUCTION.
- SPOT ELEVATIONS SHALL TAKE PRECEDENCE OVER CONTOURS AND SLOPES SHOWN. THE CONTRACTOR SHALL NOTIFY THE ENGINEER OF THE SPOT ELEVATIONS THAT DO NOT APPEAR TO BE CONSISTENT WITH THE CONTOURS AND SLOPES.
- BENCHMARK VERIFICATION: CONTRACTOR SHALL USE BENCHMARKS AND DATUMS SHOWN HEREON TO SET PROJECT BENCHMARK(S), BY RUNNING A LEVEL LOOP BETWEEN AT LEAST TWO BENCHMARK, AND SHALL PROVIDE SURVEY NOTES OF SUCH TO PROJECT ENGINEER PRIOR TO COMMENCING CONSTRUCTION.
- SPOT ELEVATIONS REPRESENT FLOW LINE OR FINISH GRADE UNLESS OTHERWISE NOTED.
- EXISTING GRADE CONTOUR INTERVALS SHOWN AT 1 FOOT INTERVALS.
- 10. PROPOSED GRADE CONTOUR INTERVALS SHOWN AT 1 FOOT INTERVALS.

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PLOT DATE: 2/5/2025 9:30 AM

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- 11. LOCATION OF SOILS STOCKPILES, DESIGNATED FOR TOPSOIL AND SUBSOIL STORAGE AREAS, WILL BE DETERMINED IN THE FIELD AT THE START OF CONSTRUCTION ACTIVITY AND INDICATED ON THE PLAN BY THE CONTRACTOR WHEN REQUIRED.
- 12. THE CONTRACTOR SHALL BE RESPONSIBLE TO CONSTRUCT THE POND IN A MANNER WHICH COMPLIES WITH THE GEOTECHNICAL RECOMMENDATIONS FOR THE SITE AND/OR DETENTION FACILITIES

PROJECT DATA

HAY CREEK VALLEY

REPORT CONTAINING PCM DESIGN CALCULATIONS: HAY CREEK VALLEY FINAL DRAINAGE REPORT (PENDING APPROVAL)

PARCEL NUMBERS: TAX SCHEDULE NUMBERS 7100000269.

7100000268, 7100000267, 7100000270, 7133000001, 7133007014

HAY CREEK VALLEY GRADING & EROSION GEC/STORMWATER QC PLAN:

CONTROL PLANS

FLOODPLAIN: THERE ARE PORTIONS OF THE SITE THAT ARE

LOCATED WITHIN A REGULATORY FLOODPLAIN ZONE (FIRM 08041C0267G DECEMBER 7, 2018)

HAY CREEK VALLEY HOMEOWNER'S ASSOCIATION

AESTHETIC MAINTENANCE OF PCM: HAY CREEK VALLEY HOMEOWNER'S ASSOCIATION

DETENTION POND

FUNCTIONAL MAINTENANCE OF PCM:

6864.27 **WQCV WATER SURFACE ELEVATION: EURV WATER SURFACE ELEVATION:** 6864.71 100-YR WATER SURFACE ELEVATION: 6866.35

OPINION OF PROBABLE PCM IMPROVEMENT COSTS

DETENTION POND

1.	DETENTION POND GRADING	G	\$ 35,000.00
2.	FOREBAY		\$ 40,000.00
3.	OUTLET STRUCTURE		\$ 40,000.00
4.	TRICKLE CHANNEL		\$ 77,500.00
5.	EMERGENCY SPILLWAY		\$ 5,000.00
6.	STILLING BASIN		\$ 30,000.00
7.	10% CONTINGENCY		\$ 22,750.00
		TOTAL	\$250,250.00

MATRIX DESIGN GROUP, INC. CANNOT AND DOES NOT GUARANTEE THAT THE CONSTRUCTION COSTS WILL NOT VARY FROM THESE OPINIONS OF PROBABLE COSTS. THESE OPINIONS REPRESENT OUR BEST JUDGEMENT AS A DESIGN PROFESSIONAL. FAMILIAR WITH THE CONSTRUCTION INDUSTRY AND THIS DEVELOPMENT.

NRCS SOIL SURVEY FOR EL PASO COUNTY

SOIL ID NO	. SOIL TYPE	CLASSIFICATION
38	JARRE-TECOLOTE COMPLEX (8%-65% SLOPES)	В
71	PRING COARSE SANDY LOAM (3%-8% SLOPES)	В
93	TOMAH-CROWFOOT COMPLEX (8%-15% SLOPES)	В

ABBREVIATIONS

APPROX	APPROXIMATE or APPROXIMATELY
B/C	BACK OF CURB
BTM	BOTTOM
CDOT	COLORADO DEPARTMENT OF TRANSPORTATION
CFS	CUBIC FEET PER SECOND
€ or CL	CENTERLINE
_	CORRUGATED METAL PIPE
CMP	CONCRETE
CONC	
CONST	CONSTRUCTION
CONT	CONTINUOUS
EA	EACH
ESMT	EASEMENT
ELEV or EL	ELEVATION
EX or EXIST	EXISTING
FES	FLARED END SECTION
f or FL	FLOWLINE
FT	FOOT/FEET
HGL	HYDRAULIC GRADE LINE
HP	HIGH POINT
HORIZ	HORIZONTAL
INV	INVERT
	VERTICAL CURVE FACTOR
K	POUNDS
LBS	
LF	LINEAR FEET
LP	LOW POINT
LT	LEFT
MAX	MAXIMUM
MH	MANHOLE
MIN	MINIMUM
MJ	MECHANICAL JOINT
NTS	NOT TO SCALE
PC	POINT OF CURVATURE
PCC	POINT OF COMPOUND CURVE
PCR	POINT OF CURB RETURN
PRC	POINT OF REVERSE CURVE
PT	POINT OF TANGENCY
PVC	POINT OF VERTICAL CURVE or
1 40	POLYVINYL CHLORIDE
PVI	POINT OF VERTICAL INTERSECTION
PVMT	PAVEMENT
PVT	POINT OF VERTICAL TANGENT
	RADIUS
R or RAD	REINFORCED CONCRETE PIPE
RCP	
RED	REDUCER
ROW	RIGHT-OF-WAY
RT	RIGHT
SCH	SCHEDULE
SD	STORM SEWER
ST	STREET
STA	STATION
STD	STANDARD
	0.444745)/.054455

Know what's below. Call before you dig.

LEGEND

 PROPERTY
 EXISTING S
 PROPOSED
 MATCHLINE
 PROPOSED

LINE TORM DRAIN STORM DRAIN

RIGHT OF WAY

PCD FILE #: SF2324

REFERENCE DRAWINGS -886.066-EX-MAP-1 164022-01 Hay Creek Road BNDY X-886-PR-SITE X-TITLE-CD DESCRIPTION No. DATE **REVISIONS** COMPUTER FILE MANAGEMENT FILE NAME: S:\22.886.076 Hay Creek-Forest Manor-O'Leary Properties\500 CADD\504 Plan Sets\Construction Plans\Pond Plans\DF01.dwg

SHEET KEY

PROJECT ELEVATIONS ARE NAVD 88 ELEVATIONS BASED ON AN OPUS DERIVED ELEVATION ON CONTROL POINT 10, A NO. 5 REBAR HAVING AN ELEVATION OF 5769.92.

BASIS OF BEARING

THE SOUTH LINE OF THE NORTHWEST QUARTER OF SECTION 22, TOWNSHIP 15 SOUTH, RANGE 65 WEST OF THE 6TH PRINCIPAL MERIDIAN, COUNTY OF EL PASO, STATE OF COLORADO, BEING MONUMENTED ON THE EASTERLY END BY A 2-12" ALUMINUM CAP STAMPED "NOLTE PLS25955 C1/4 S22 T15S, R65W 1999, "AND THE WESTERLY END BY A2-1/2" ALUMINUM CAP STAMPED "SSS PLS 16154 1/4 S21 S22 T15S, R65W 2000, "BEING ASSUMED TO BEAR S89°54'42"W, A DISTANCE OF 2,627.78 FEET.





MATRIX DESIGN GROUP, INC.

PROJECT No. 22.886.076

DRAWN BY:

CHECKED BY:

CONSTRUCTION DOCUMENTS

DETENTION POND GENERAL NOTES

HAY CREEK VALLEY


EL PASO COUNTY, COLORADO


FOR AND ON BEHALF OF DESIGNED BY: WCG SCALE


DFGN01


MAY 2024 DRAWING No.

19 OF 26

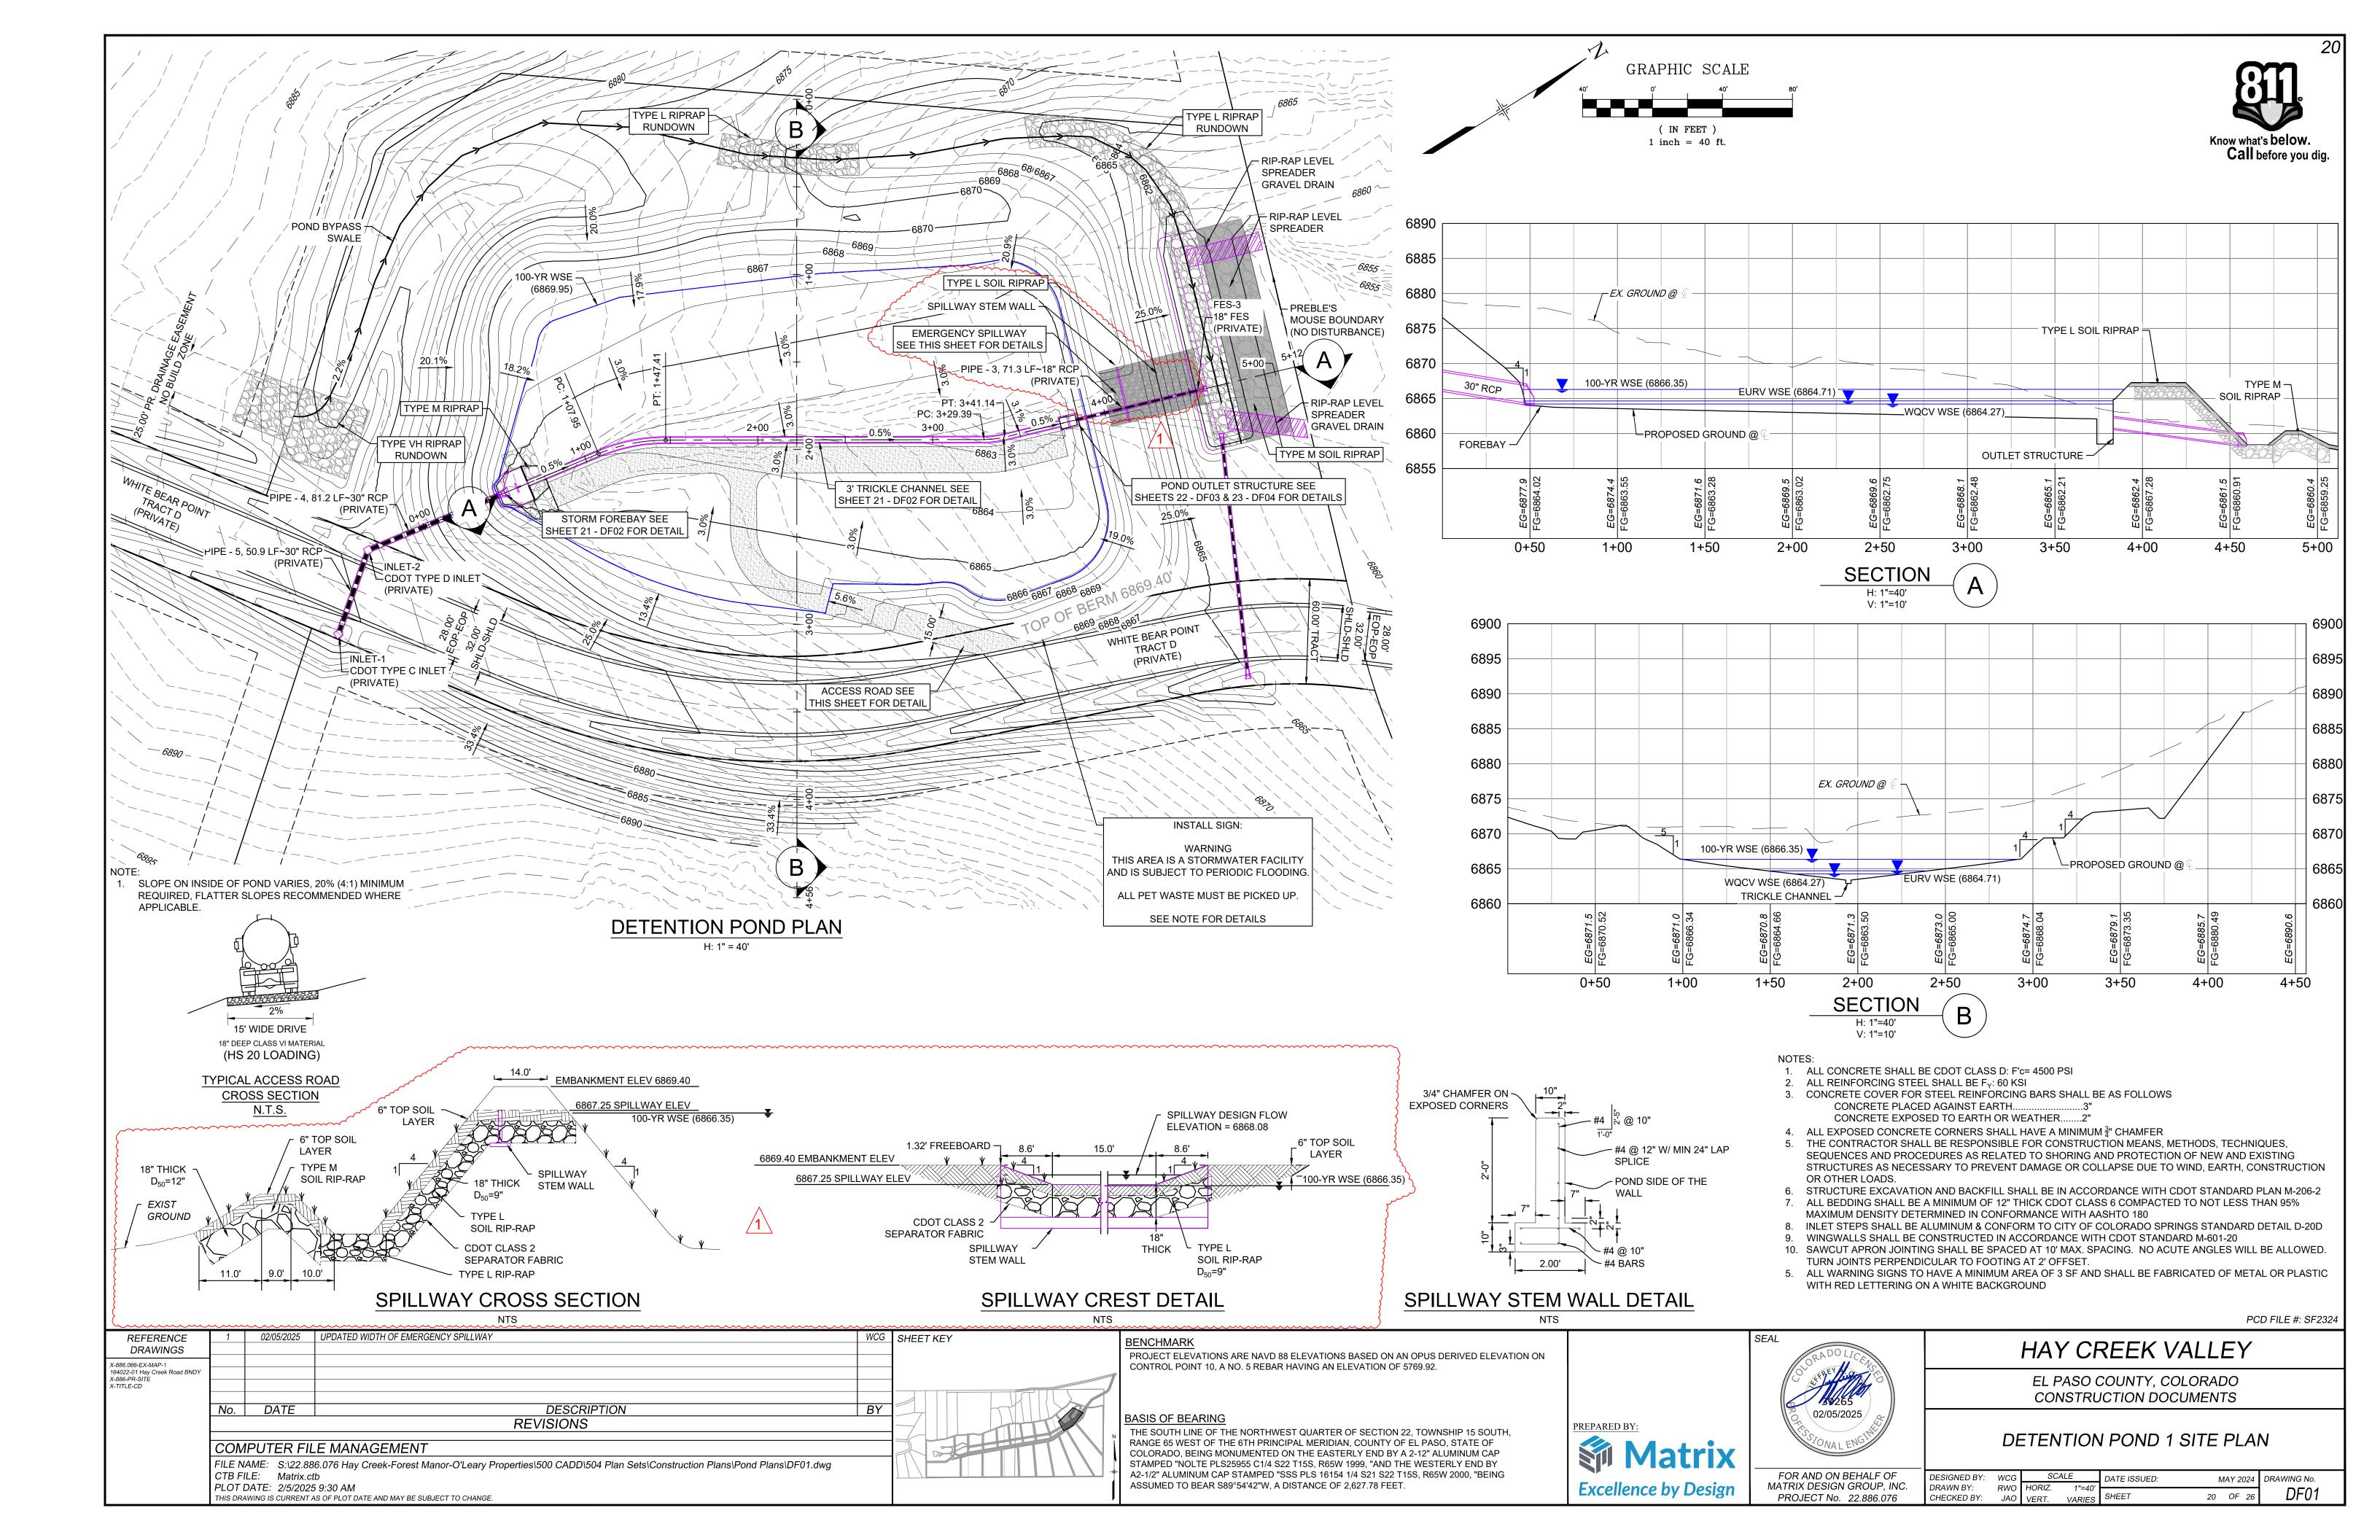

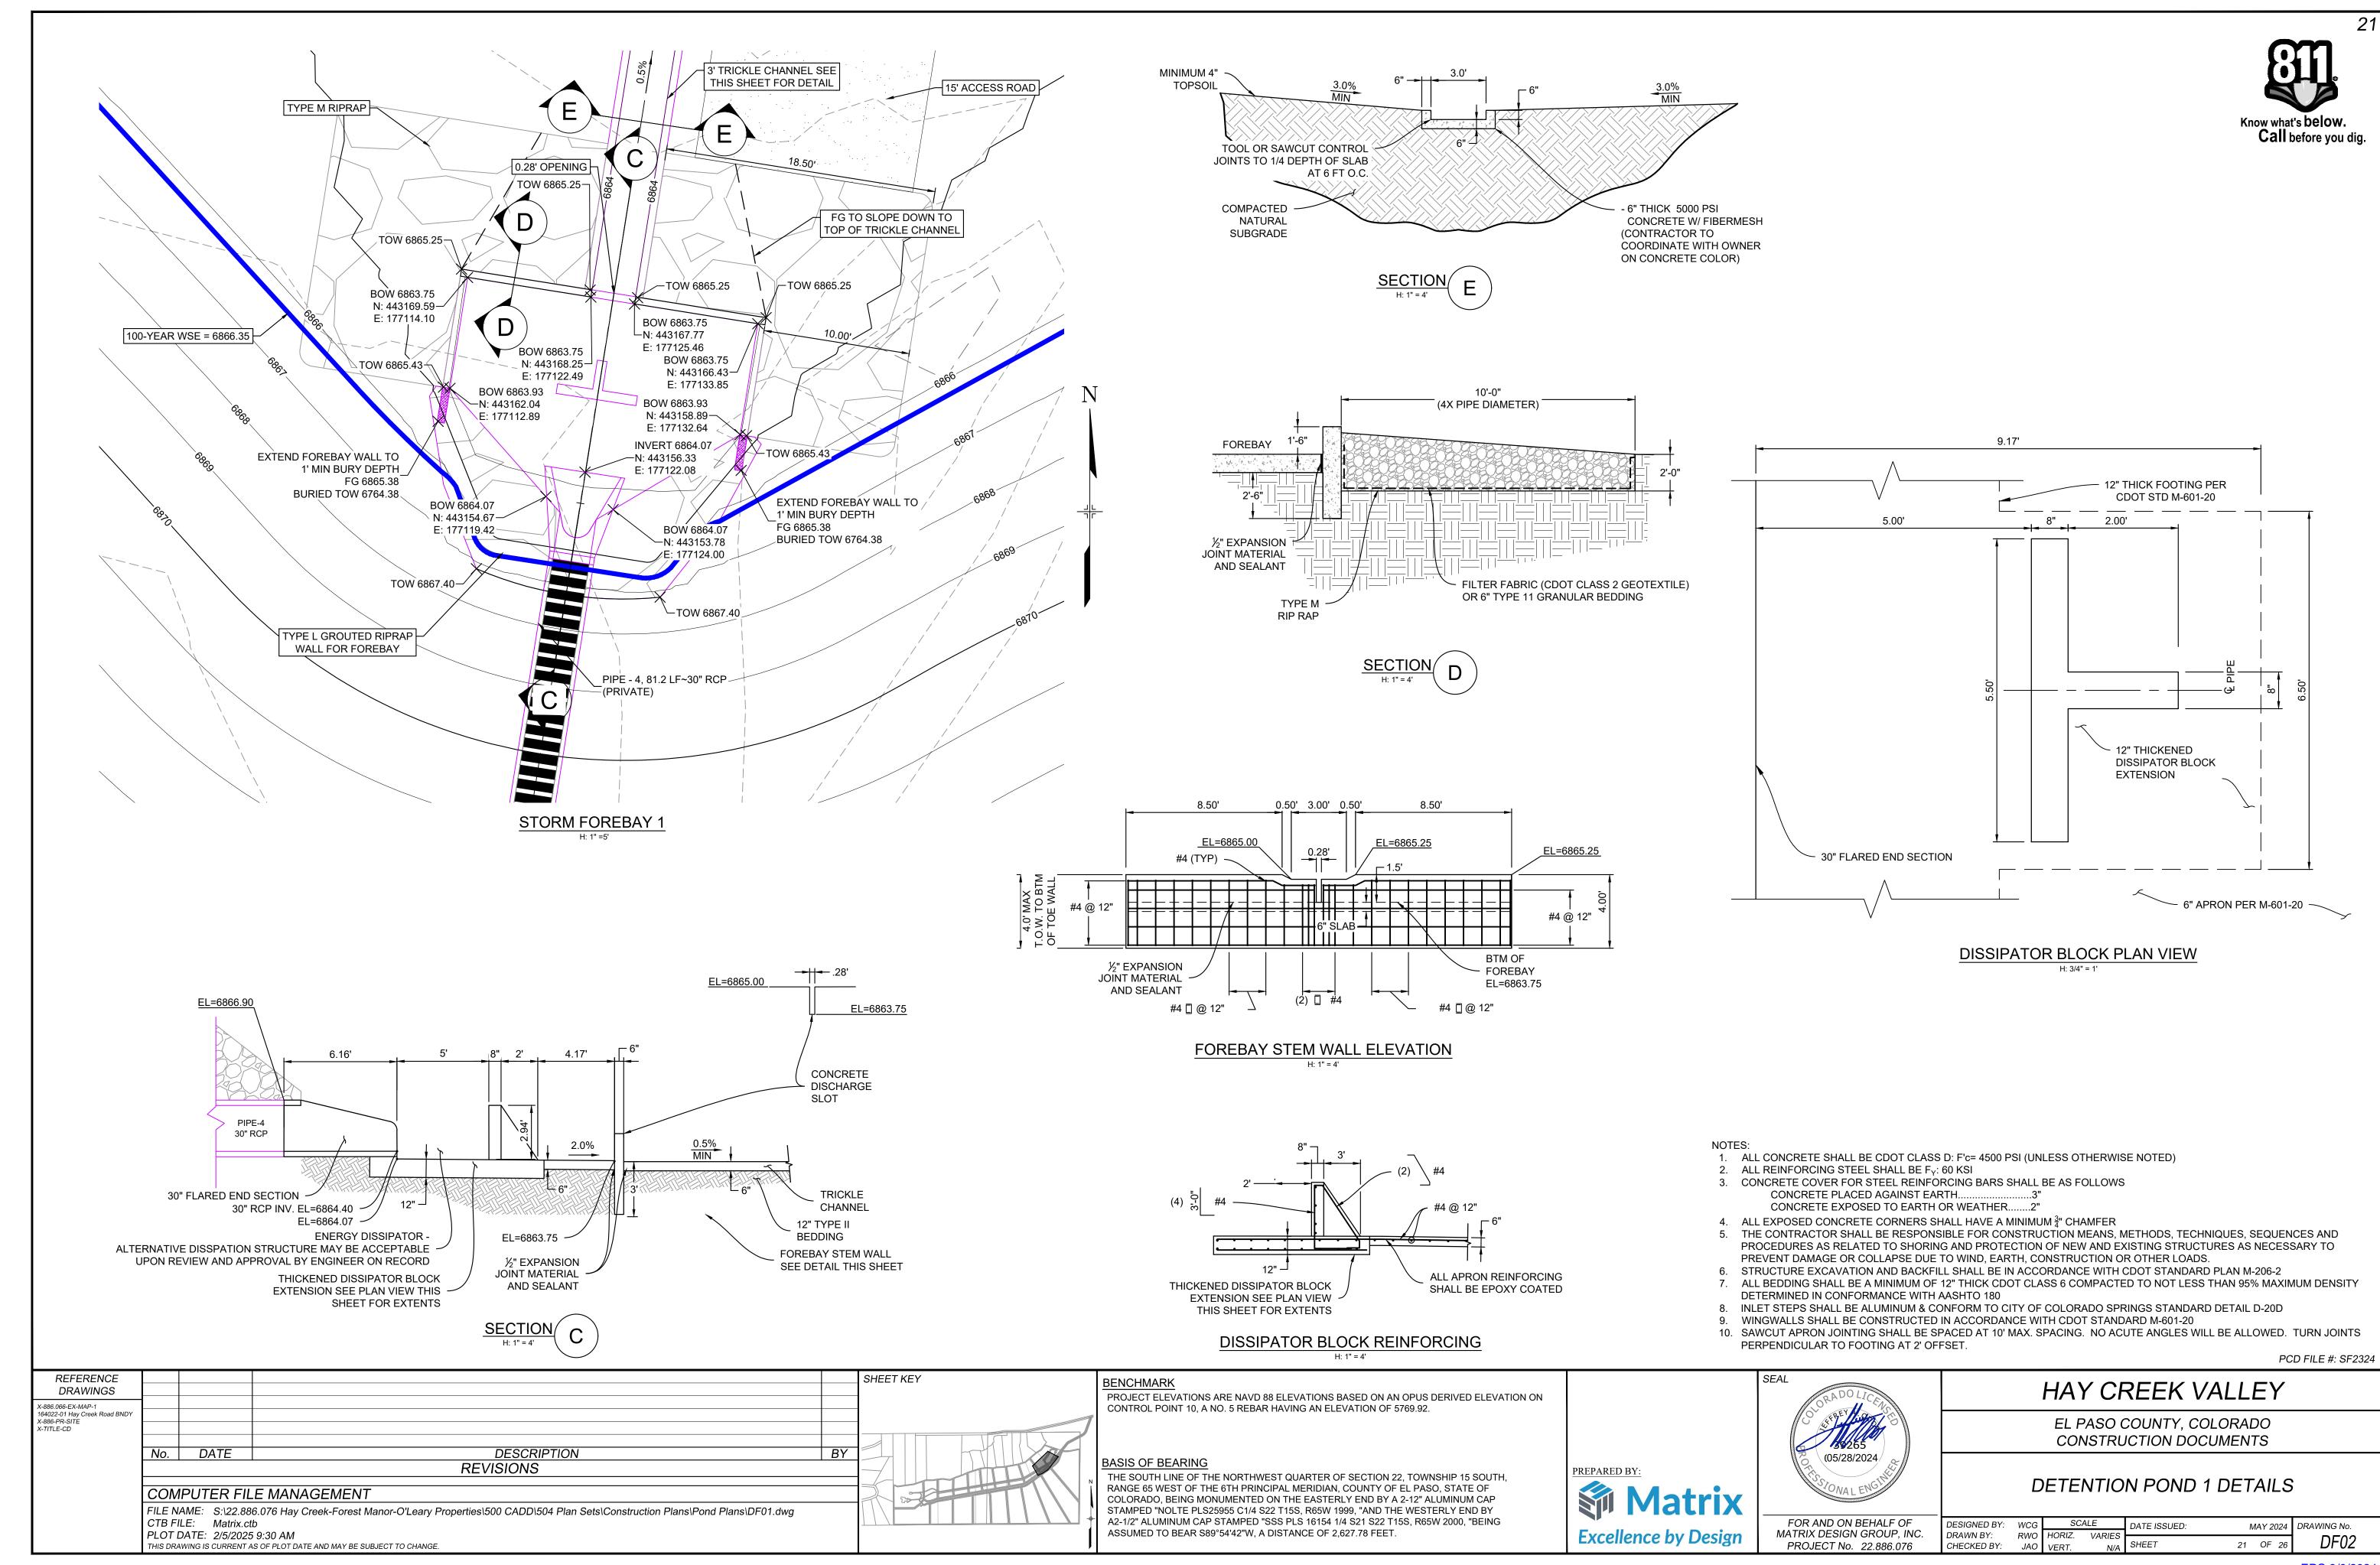

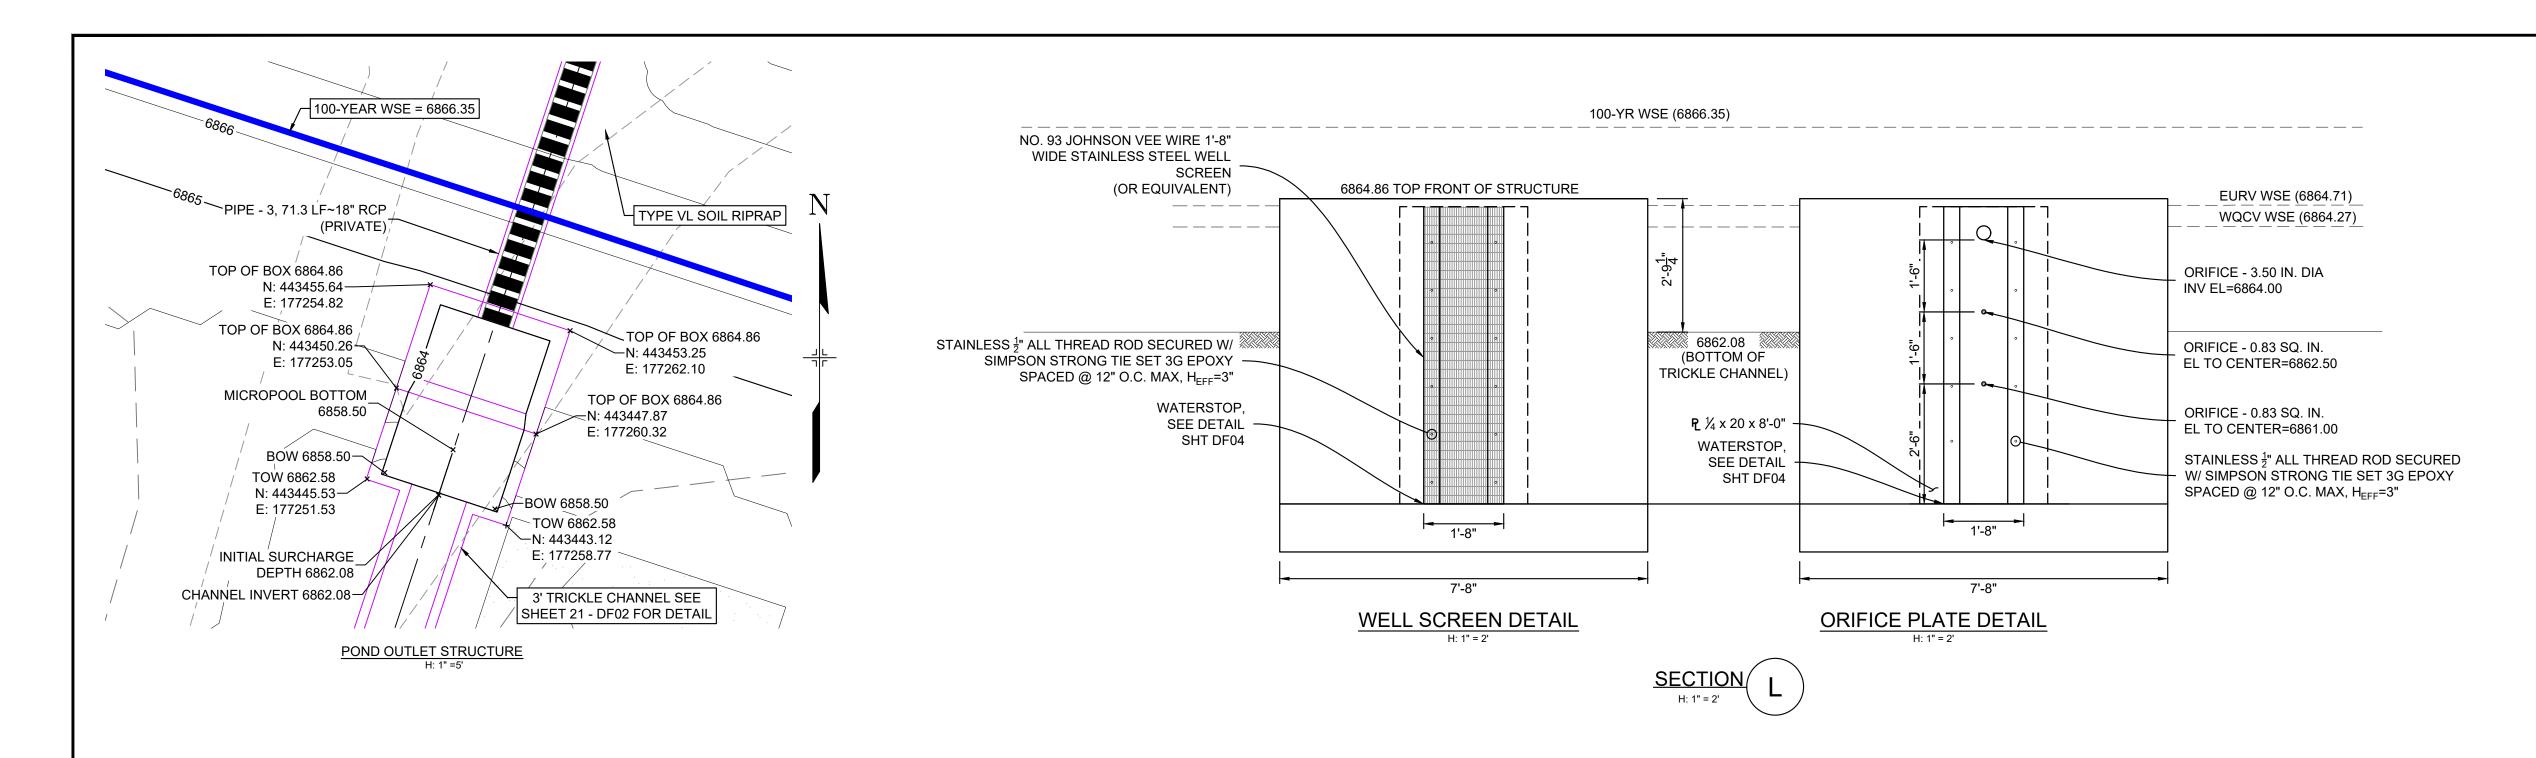

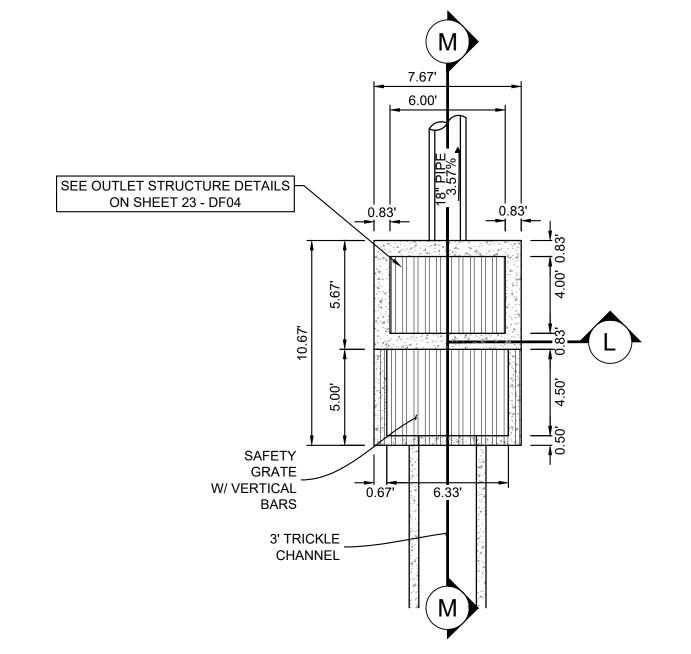

MICROPOOL DETAILS

REFERENCE

DRAWINGS

164022-01 Hay Creek Road BNDY X-886-PR-SITE X-TITLE-CD

X-886.066-EX-MAP-1

- 1. ALL CONCRETE SHALL BE CDOT CLASS D: F'c= 4500 PSI
- 2. ALL REINFORCING STEEL SHALL BE F_Y: 60 KSI 3. CONCRETE COVER FOR STEEL REINFORCING BARS SHALL BE AS FOLLOWS CONCRETE PLACED AGAINST EARTH...
- CONCRETE EXPOSED TO EARTH OR WEATHER......2" 4. ALL EXPOSED CONCRETE CORNERS SHALL HAVE A MINIMUM \(\frac{3}{4}\)" CHAMFER

COMPUTER FILE MANAGEMENT

THIS DRAWING IS CURRENT AS OF PLOT DATE AND MAY BE SUBJECT TO CHANGE.

- 5. THE CONTRACTOR SHALL BE RESPONSIBLE FOR CONSTRUCTION MEANS, METHODS, TECHNIQUES, SEQUENCES AND PROCEDURES AS RELATED TO SHORING AND PROTECTION OF NEW AND EXISTING STRUCTURES AS NECESSARY TO PREVENT DAMAGE OR COLLAPSE DUE TO WIND, EARTH, CONSTRUCTION OR OTHER LOADS.
- 6. STRUCTURE EXCAVATION AND BACKFILL SHALL BE IN ACCORDANCE WITH CDOT STANDARD PLAN M-206-2 7. ALL BEDDING SHALL BE A MINIMUM OF 12" THICK CDOT CLASS 6 COMPACTED TO NOT LESS THAN 95% MAXIMUM DENSITY

No. DATE


CTB FILE: Matrix.ctb

PLOT DATE: 2/5/2025 9:31 AM

- DETERMINED IN CONFORMANCE WITH AASHTO 180
- 8. INLET STEPS SHALL BE ALUMINUM & CONFORM TO CITY OF COLORADO SPRINGS STANDARD DETAIL D-20D 9. WINGWALLS SHALL BE CONSTRUCTED IN ACCORDANCE WITH CDOT STANDARD M-601-20
- 10. SAWCUT APRON JOINTING SHALL BE SPACED AT 10' MAX. SPACING. NO ACUTE ANGLES WILL BE ALLOWED. TURN JOINTS PERPENDICULAR TO FOOTING AT 2' OFFSET.

DESCRIPTION

REVISIONS

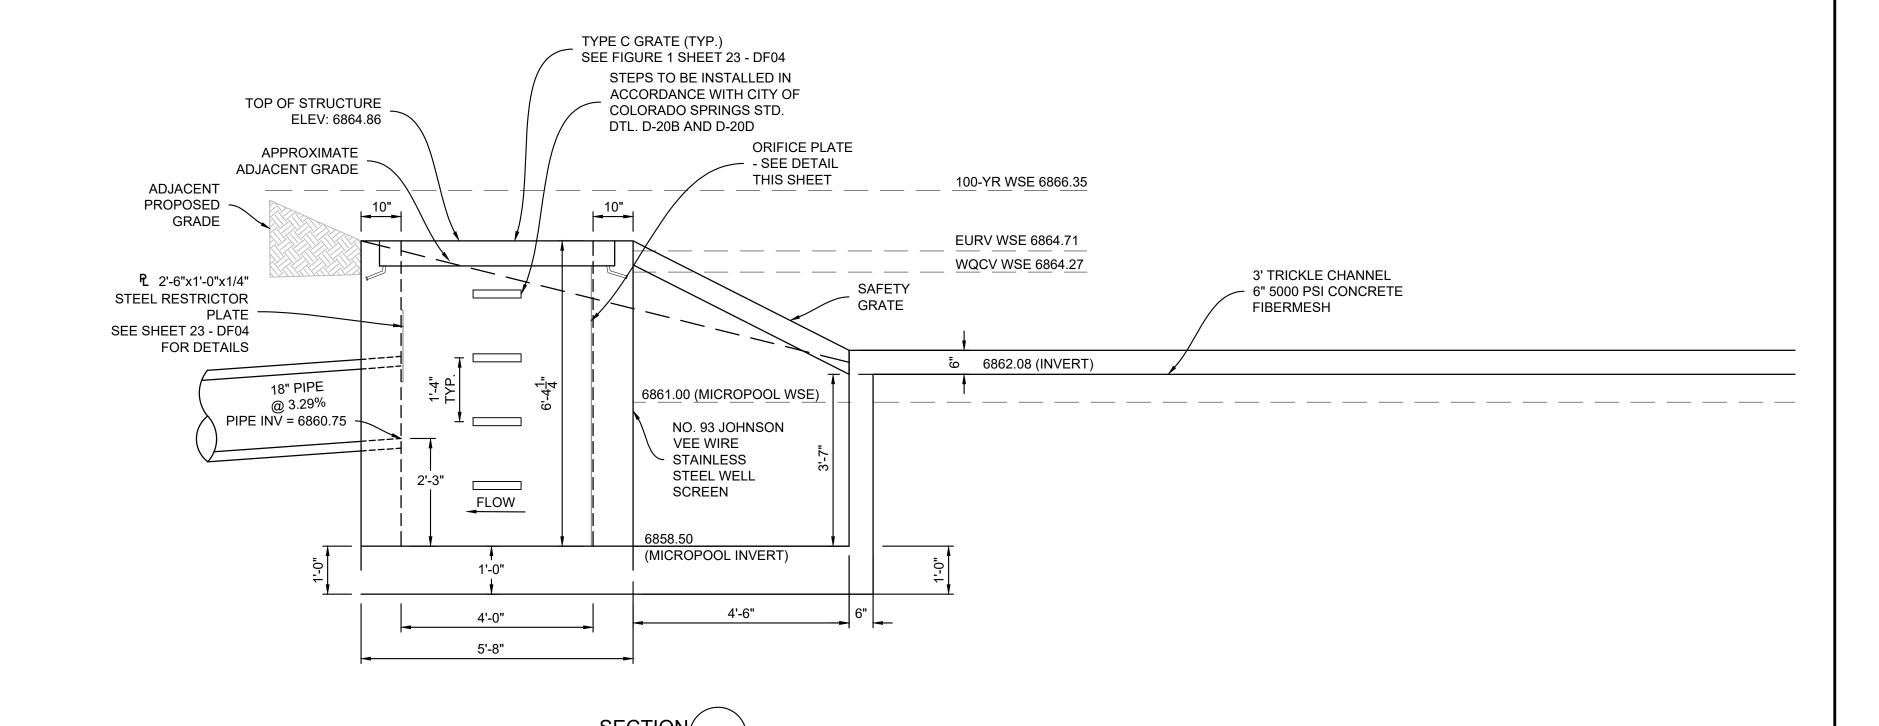

PROJECT ELEVATIONS ARE NAVD 88 ELEVATIONS BASED ON AN OPUS DERIVED ELEVATION ON

BASIS OF BEARING

THE SOUTH LINE OF THE NORTHWEST QUARTER OF SECTION 22, TOWNSHIP 15 SOUTH, RANGE 65 WEST OF THE 6TH PRINCIPAL MERIDIAN, COUNTY OF EL PASO, STATE OF COLORADO, BEING MONUMENTED ON THE EASTERLY END BY A 2-12" ALUMINUM CAP STAMPED "NOLTE PLS25955 C1/4 S22 T15S, R65W 1999, "AND THE WESTERLY END BY A2-1/2" ALUMINUM CAP STAMPED "SSS PLS 16154 1/4 S21 S22 T15S, R65W 2000, "BEING ASSUMED TO BEAR S89°54'42"W, A DISTANCE OF 2,627.78 FEET.



HAY CREEK VALLEY EL PASO COUNTY, COLORADO

DESIGNED BY: WCG

DRAWN BY:

CHECKED BY:

DETENTION POND 1 DETAILS

CONSTRUCTION DOCUMENTS

RWO HORIZ.

JAO VERT.

SCALE

VARIES

SHEET KEY CONTROL POINT 10, A NO. 5 REBAR HAVING AN ELEVATION OF 5769.92. FILE NAME: S:\22.886.076 Hay Creek-Forest Manor-O'Leary Properties\500 CADD\504 Plan Sets\Construction Plans\Pond Plans\DF01.dwg


FOR AND ON BEHALF OF MATRIX DESIGN GROUP, INC. **Excellence by Design** PROJECT No. 22.886.076

MAY 2024 DRAWING No.

22 OF 26

PCD FILE #: SF2324

Call before you dig.

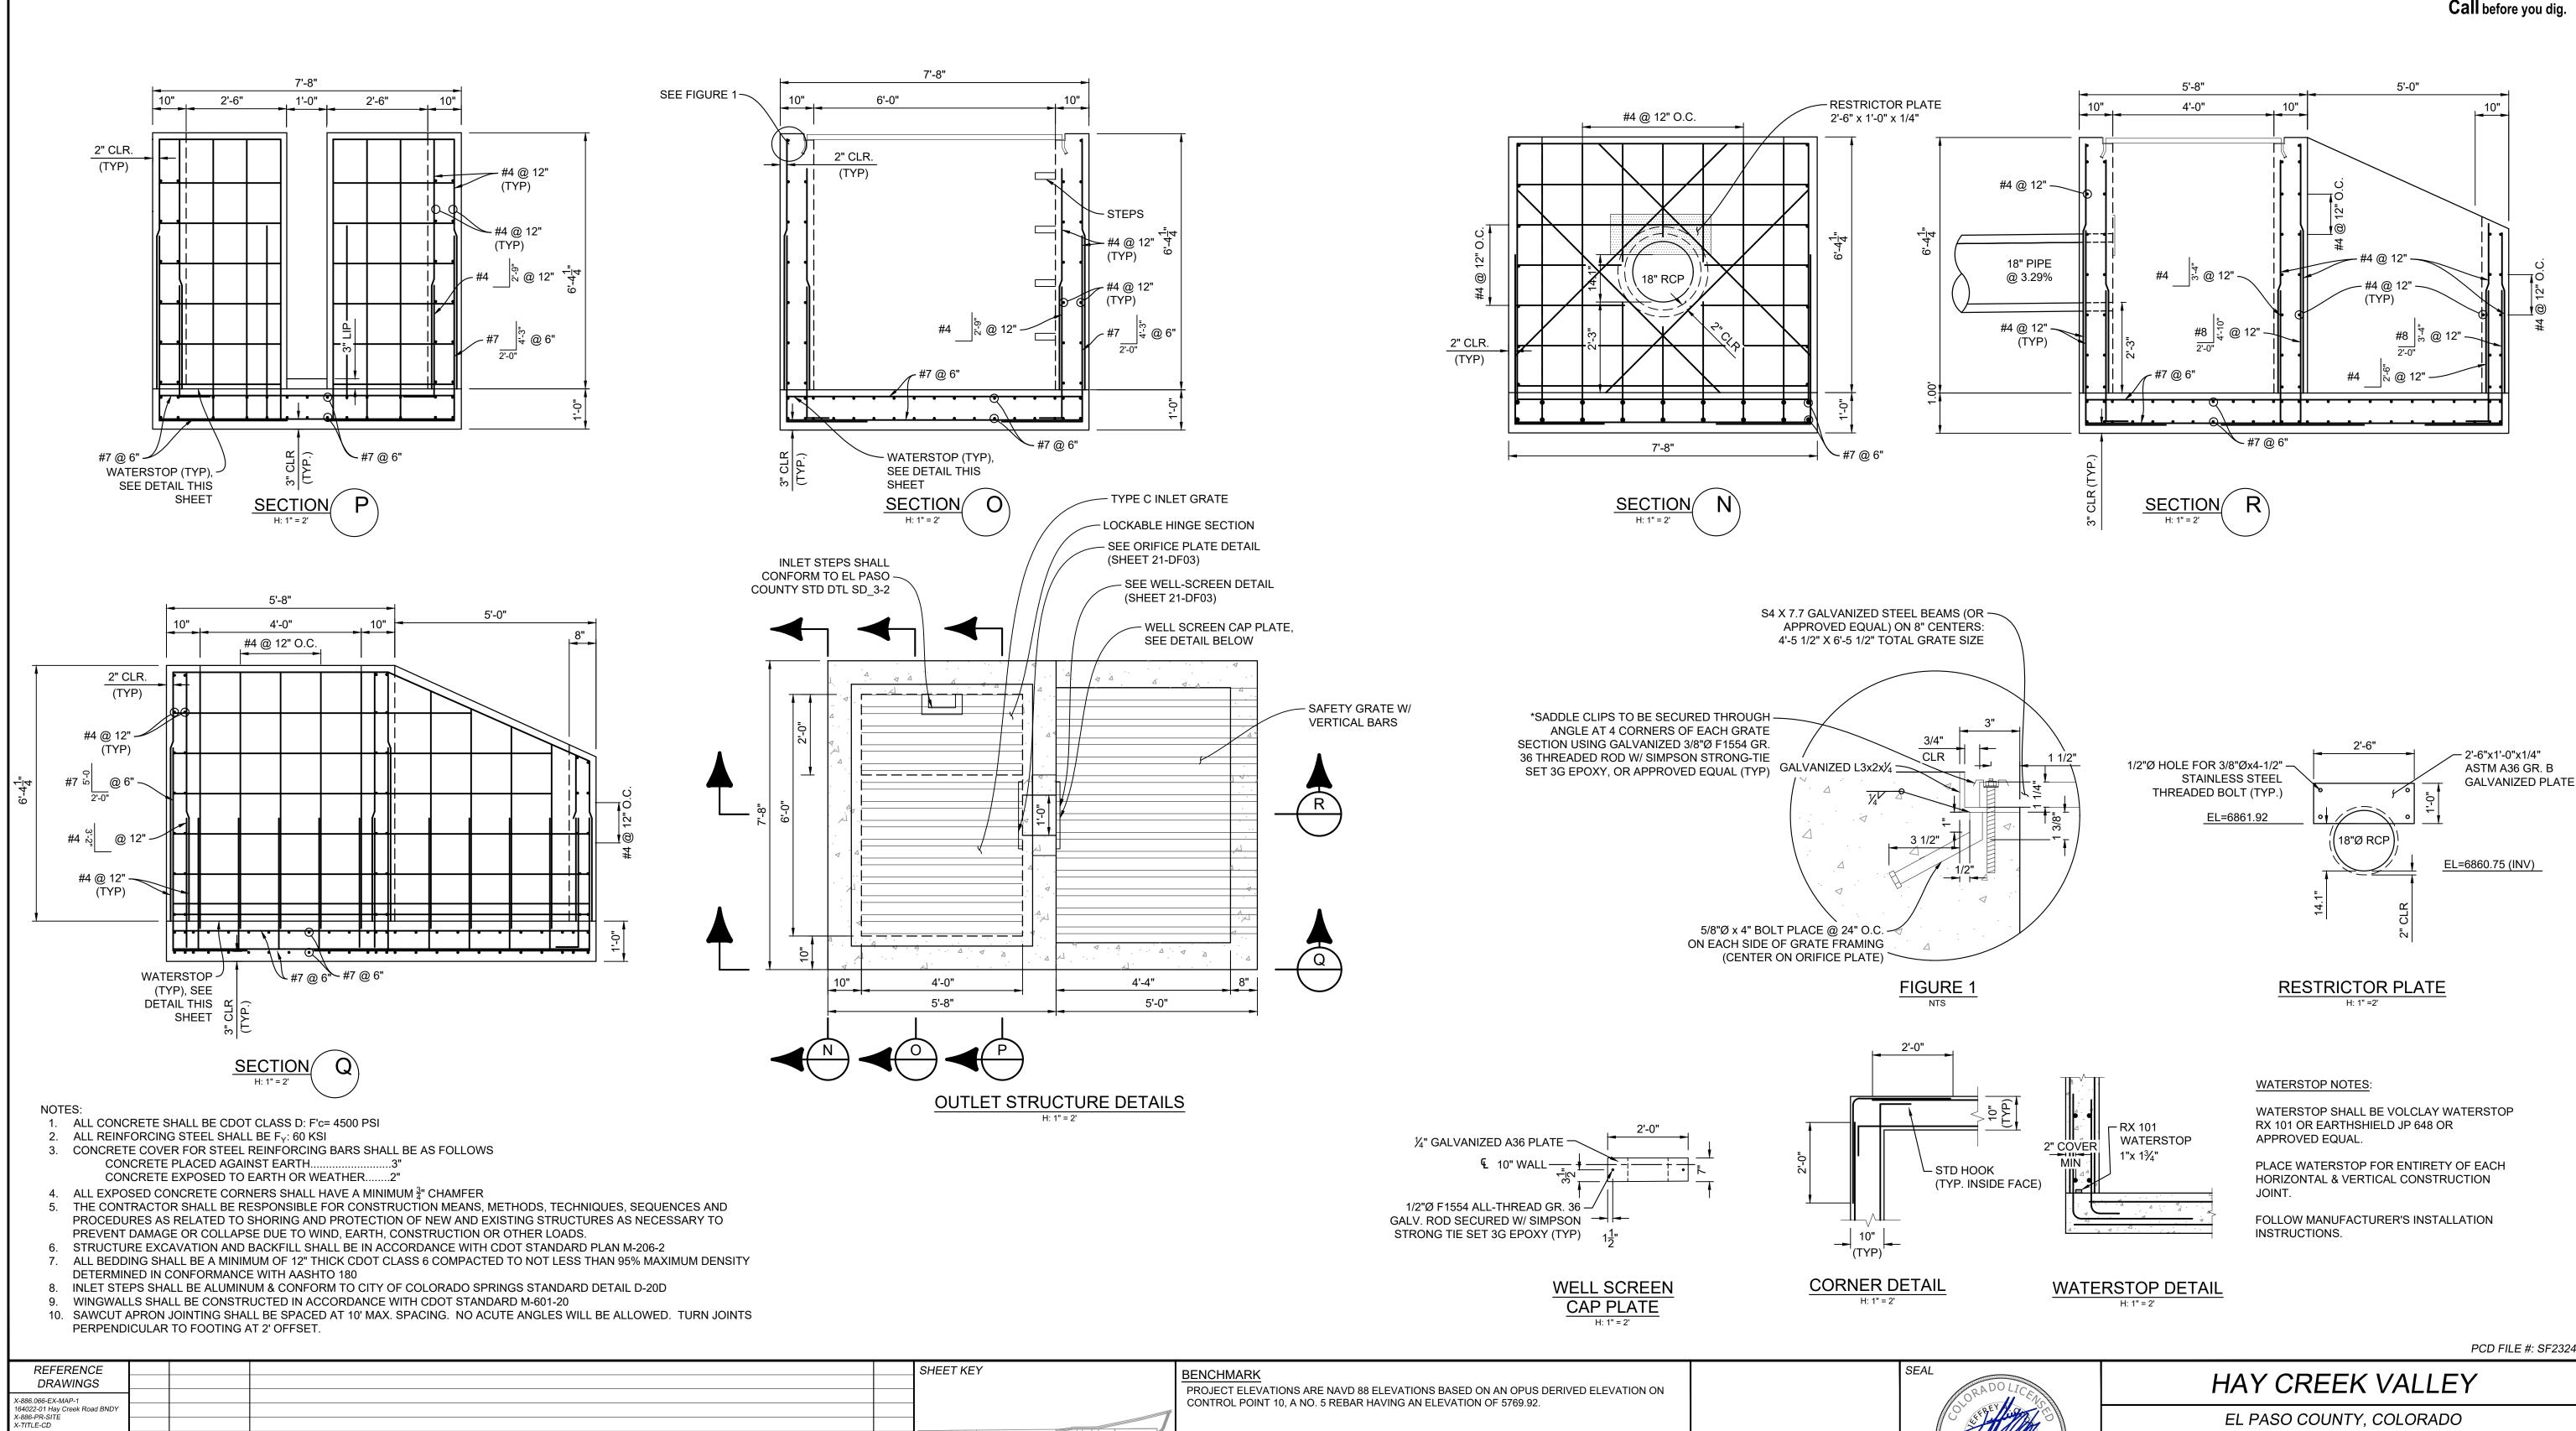

BASIS OF BEARING

THE SOUTH LINE OF THE NORTHWEST QUARTER OF SECTION 22, TOWNSHIP 15 SOUTH,

RANGE 65 WEST OF THE 6TH PRINCIPAL MERIDIAN, COUNTY OF EL PASO, STATE OF

COLORADO, BEING MONUMENTED ON THE EASTERLY END BY A 2-12" ALUMINUM CAP

STAMPED "NOLTE PLS25955 C1/4 S22 T15S, R65W 1999, "AND THE WESTERLY END BY A2-1/2" ALUMINUM CAP STAMPED "SSS PLS 16154 1/4 S21 S22 T15S, R65W 2000, "BEING

ASSUMED TO BEAR S89°54'42"W, A DISTANCE OF 2,627.78 FEET.

DESCRIPTION

REVISIONS

FILE NAME: S:\22.886.076 Hay Creek-Forest Manor-O'Leary Properties\500 CADD\504 Plan Sets\Construction Plans\Pond Plans\DF01.dwg

No. DATE

CTB FILE: Matrix.ctb

PLOT DATE: 2/5/2025 9:31 AM

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23 OF 26 **DF04 EPC** 9/9/2024

MAY 2024 DRAWING No.

CONSTRUCTION DOCUMENTS

DETENTION POND 1 DETAILS

DATE ISSUED:

SCALE

FOR AND ON BEHALF OF

Excellence by Design

MATRIX DESIGN GROUP, INC.

PROJECT No. 22.886.076

DESIGNED BY: WCG

DRAWN BY:

CHECKED BY:

