PROJECT DESCRIPTION

AT&T WIRELESS PROPOSES TO MODIFY AN EXISTING WIRELESS INSTALLATION. THE SCOPE WILL CONSIST OF THE FOLLOWING: ROOFTOP WORK:

● REMOVE (12) RRHs

REMOVE (9) ANTENNAS
REMOVE (3) TMAs
INSTALL (12) ANTENNAS

INSTALL (12) ARTHS

INSTALL (9) RRHs

INSTALL (1) DC9

INSTALL (1) FIBER TRUNK

INSTALL (1) POWER TRUNK

GROUND WORK:

PROPERTY OWNER:

ROOFTOP OWNER:

LONGITUDE (NAD83):

GROUND FLEVATION:

ZONING JURISDICTION:

ZONING DISTRICT:

PARCEL NUMBER

OCCUPANCY GROUP:

CONSTRUCTION TYPE: POWER COMPANY:

TELEPHONE COMPANY:

RF ENGINEER:

SITE ACQUISITION MANAGER:

CONSTRUCTION MANAGER

COUNTY:

ADDRESS:
SITE ADDRESS:

REMOVE (6) CONVERTERS
INSTALL (10) CONVERTERS
INSTALL (2) CONVERTER KITS
INSTALL (2) RECTIFIERS
INSTALL (8) BATTERIES
INSTALL (1) FLEX 42
INSTALL (1) GENERIC BBU

●INSTALL (1) DC12-48-60-0-25E

SITE NAME: FONTAINE & POWERS SITE NUMBER: COLO2099



NOKIA MARKETS MODERNIZATION IWM NUMBER: WSUTH0033975 FA #: 10115180 ROOFTOP

VICINITY MAP LOCAL MAP FORTAINE BLVD. SITE LOCATION NO. SCALE

CONTACT INFORMATION

SITE INFORMATION

PIKES PEAK BAPTIST TEMPLE

7925 FONTAINE BLVD
COLORADO SPRINGS, CO 8090

DIAMOND

FL PASO

104" 40" 48.65" V

5,874' AMSL

5521002016

COLORADO SPRINGS UTILITIES

CORY HAMMEN (414) 455-2289

JOHN RUTKOWITZ (303) 264-0523

RON BLEDSOE (913) 458-8114

EL PASO COUNTY

7923 FONTAINE BLVD COLORADO SPRINGS, CO 80925

ENGINEER: BLACK & VEATCH CORPORATION 4600 SOUTH SYRACUSE STREET, SUITE 800

DENVER, CO 80237

CONTACT: DAN GRUMAN
PHONE: (913) 458-6112

DRIVING DIRECTIONS

DIRECTIONS FROM COLORADO SPRINGS AIRPORT

HEAD NORTH ON MILTON E PROBY PKWY. KEEP LEFT TO CONTINUE ON MILTON E PROBY PARKWAY ARPORT EXIT. USE THE RIGHT LANE TO TURN SLIGHTLY LEFT ONTO MILTON E PROBY PKWY. TURN LEFT ONTO PEAK INNOVATION PKWY. AT THE ROUNDABOUT, TAKE THE 2ND EXIT AND STAY ON PEAK INNOVATION PKWY. TURN LEFT ONTO CO-21 S. SLIGHT LEFT TOWARD FONTAINE BLVD. TURN LEFT ONTO FONTAINE BLVD. TURN RIGHT. TURN RIGHT.

ENGINEERING

2021 INTERNATIONAL FIRE CODE
2021 INTERNATIONAL BUILDING CODE OR LATEST ADOPTED EDITION
2020 NATIONAL ELECTRIC CODE OR LATEST ADOPTED EDITION
11A/EIA-222-H OR LATEST EDITION

GENERAL NOTES

THE FACILITY IS UNMANNED AND NOT FOR HUMAN HABITATION. A TECHNICIAN WILL VISIT THE SITE AS REQUIRED FOR ROUTINE MAINTENANCE. THE PROJECT WILL NOT RESULT IN ANY SIGNIFICANT DISTURBANCE OR EFFECT ON DRAINAGE. NO SANITARY SEWER SERVICE, POTABLE WATER, OR TRASH DISPOSAL IS REQUIRED AND NO COMMERCIAL SIGNAGE IS PROPOSED.

SHEET NO.	SHEET TITLE DRAWING INDEX		
T-1	TITLE SHEET		
C-1	SITE PLAN		
C-1.1	ENLARGED SITE PLAN		
C-2	EQUIPMENT LAYOUTS		
C-3	ELEVATIONS		
C-4	ANTENNA LAYOUTS		
C-5	ANTENNA SCHEDULE		
C-6	EQUIPMENT DETAILS		
C-6.1	EQUIPMENT DETAILS		
E-1	ELECTRICAL AC ONE-LINE DIAGRAM		
E-2	ELECTRICAL DC ONE-LINE DIAGRAM		
G-1	GROUNDING ONE-LINE DIAGRAM		
G-2	GROUNDING DETAILS		
GN-1	LEGEND & ABBREVIATIONS		
GN-2	GENERAL CONSTRUCTION NOTES		
GN-3	GENERAL SITE WORK & DRAINAGE NOTES		
GN-4	GENERAL CONCRETE WORK NOTES		
GN-5	GENERAL STRUCTURAL STEEL NOTES		
GN-6	GENERAL ELECTRICAL NOTES		
GN-7	BATTERY SAFETY NOTES		

11"x17" PLOT WILL BE HALF SCALE UNLESS OTHERWISE NOTED

CONTRACTOR SHALL VERIFY ALL PLANS, EXISTING DIMENSIONS, AND CONDITIONS ON THE JOB SITE, AND SHALL IMMEDIATELY NOTIFY THE ENGINEER IN WRITING OF ANY DISCREPANCIES BEFORE PROCEEDING WITH THE WORK.



UNDERGROUND SERVICE ALERT
UTILITY NOTIFICATION CENTER OF COLORADO
(800) 922-1987
WWW.UNCC.ORG

3 WORKING DAYS UTILITY NOTIFICATION PRIOR TO CONSTRUCTIO



188 INVERNESS DRIVE WEST SUITE 400 ENGLEWOOD, CO 80112



BLACK & VEATC 4600 SOUTH SYRACUSE STREET SUITE 800 DENVER, COLORADO 80237



П	PROJECT#:	314248
Ш	DRAWN BY:	KRS
Ш	CHECKED BY:	к00
Ц	RFDS:	N/A

1			
	0	07/23/24	ISSUED FOR CONSTRUCTION
	A	06/24/24	ISSUED FOR REVIEW
	REV	DATE	DESCRIPTION
	$\overline{}$		



July 23, 202

IT IS A VIOLATION OF LAW FOR ANY PERSON,
UNLESS THEY ARE ACTING UNDER THE DIRECTION
OF A LICENSED PROFESSIONAL ENGINEER,
TO ALTER THIS DOCUMENT.

FONTAINE & POWERS
COLO2099
7923 FONTAINE BLVD
COLORADO SPRINGS. CO 80925

NOKIA MARKETS MODERNIZATION

SHEET TITLE
TITLE SHEET

SHEET NUMBER

T-1

NOTES

- PASSING STRUCTURAL ANALYSIS (CONFORMING TO TIA-222-H) FOR THE EXISTING ROOFTOP WAS COMPLETED BY ACCELERATED TOWER ENGINEERING ON 05/16/2024. ACCORDING TO THIS ANALYSIS, THE EXISTING ROOFTOP HAS SUFFICIENT CAPACITY TO SUPPORT THE LOADING INDICATED.
- . A PASSING ANTENNA MOUNT ANALYSIS (CONFORMING TO TIA-222-H) FOR THE EXISTING MOUNT WAS COMPLETED BY ATE ON 05/16/2024. ACCORDING TO THIS ANALYSIS, THE EXISTING MOUNT HAS SUFFICIENT CAPACITY TO SUPPORT THE LOADING INDICATED.

COAX & CABLE INFORMATION

- ALL EXISTING CABLES/COAX TO REMAIN UNLESS NOTED ALL EXISTING COBLES/COAX TO REMAIN UNLOTHERWISE
 (1) PROPOSED 24 PAIR FIBER TRUNK
 (1) PROPOSED 6AWG DC TRUNK
 (1) EXISTING 18 PAIR FIBER TRUNK
 (4) EXISTING 8AWG DC TRUNKS
 (12) EXISTING 7/8" COAX CABLES



188 INVERNESS DRIVE WEST SUITE 400 ENGLEWOOD, CO 80112



BLACK & VEATCH 600 SOUTH SYRACUSE STREET SUITE 800 DENVER, COLORADO 80237



L	PROJECT#:	314248
ı	DRAWN BY:	KRS
ı	CHECKED BY:	коо
П	RFDS:	N/A

_		I
0	07/23/24	ISSUED FOR CONSTRUCTION
A	06/24/24	ISSUED FOR REVIEW
REV	DATE	DESCRIPTION




IT IS A VIOLATION OF LAW FOR ANY PERSON, UNLESS THEY ARE ACTING UNDER THE DIRECTION OF A LICENSED PROFESSIONAL ENGINEER, TO ALTER THIS DOCUMENT.

FONTAINE & POWERS COLO2099 7923 FONTAINE BLVD COLORADO SPRINGS, CO 80925 NOKIA MARKETS MODERNIZATION

FINAL ELEVATIONS


SHEET NUMBER

C-3

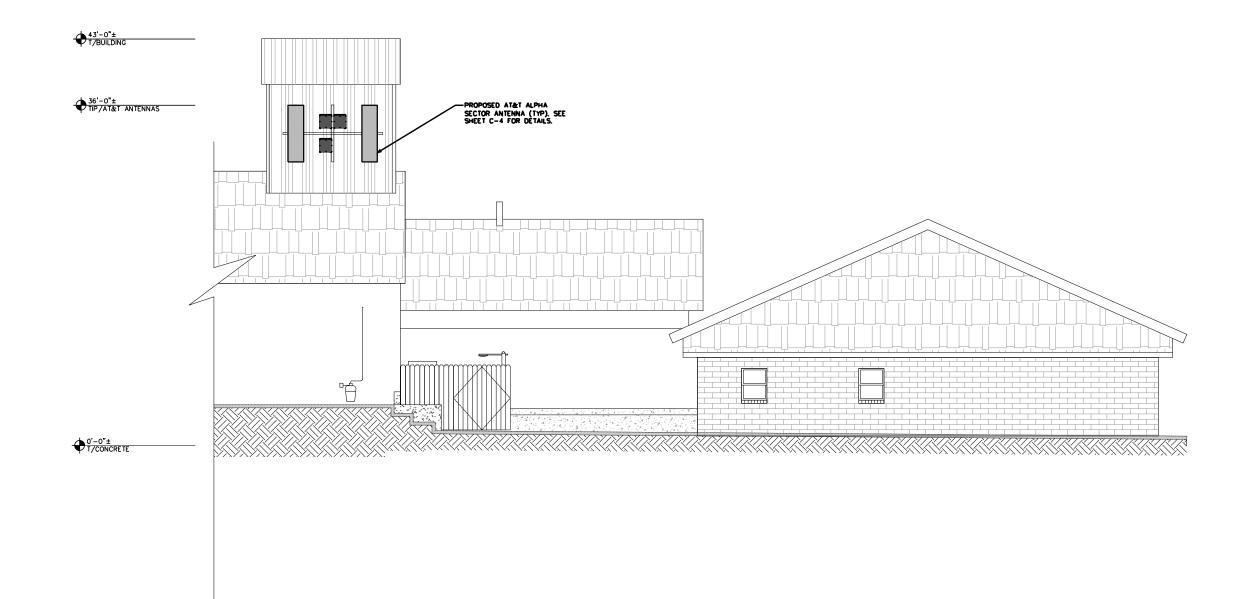

FINAL NORTH ELEVATION

5' 2.5' 0

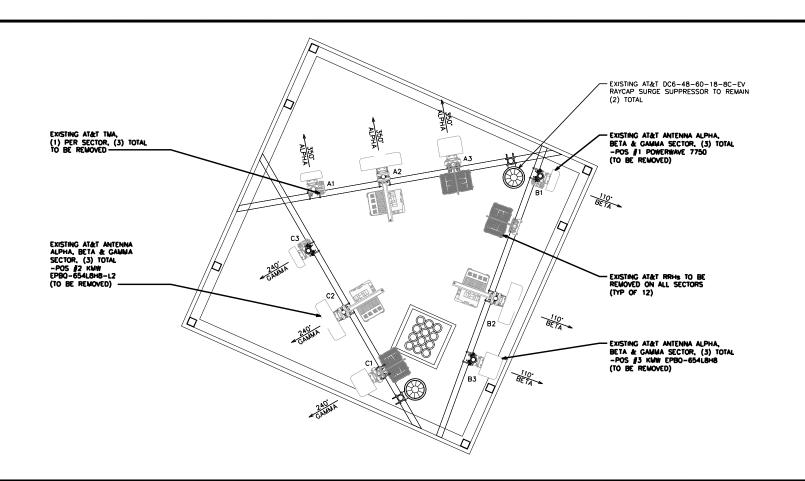





BLACK & VEATCH SUITE 800 DENVER, COLORADO 80237



PROJECT#:	314248
DRAWN BY:	KRS
CHECKED BY:	к00
RFDS:	N/A

ı	1			
ı				
ı				
ı				
ı				
4				
ı				
ı				
1				
ı		0	07/23/24	ISSUED FOR CONSTRUCTION
ı		A	06/24/24	ISSUED FOR REVIEW
ı	Į	REV	DATE	DESCRIPTION



IT IS A VIOLATION OF LAW FOR ANY PERSON, UNLESS THEY ARE ACTING UNDER THE DIRECTION OF A LICENSED PROFESSIONAL ENGINEER, TO ALTER THIS DOCUMENT.


FONTAINE & POWERS COLO2099 7923 FONTAINE BLVD COLORADO SPRINGS, CO 80925 NOKIA MARKETS MODERNIZATION

> SHEET TITLE **ELEVATIONS**

SHEET NUMBER

C-4

EXISTING ANTENNA LAYOUT

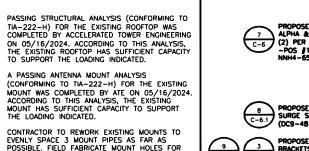


CONTRACTOR TO REWORK EXISTING MOUNTS TO EVENLY SPACE 3 MOUNT PIPES AS FAR AS POSSIBLE. FIELD FABRICATE MOUNT HOLES FOR ANTENNA PIPE POSITIONS AS NEEDED.

2. A PASSING ANTENNA MOUNT ANALYSIS

THE LOADING INDICATED.

<u>NOTE</u>

ANTENNA PIPE MOUNTS TO BE EVENLY SPACED (PER SECTOR). ENSURE 24" MIN SPACING IS MAINTAINED BETWEEN ANTENNAS.

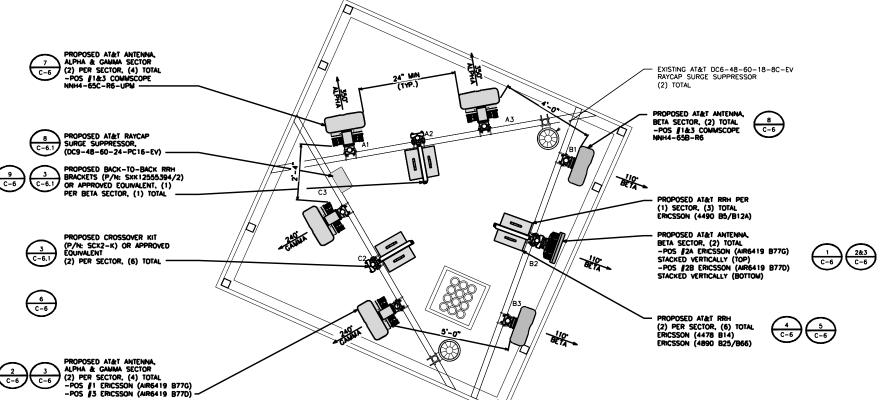

PROPOSED ANTENNA LAYOUT

1"=2'-0"