THE COMMONS AT FALCON FIELD

EAST HALF OF SECTION 7, TOWNSHIP 13 SOUTH, RANGE 64 WEST OF THE 6TH P.M.

Public Improvements

PEYTON, EL PASO COUNTY, COLORADO

COMMERCIAL CONSTRUCTION PLANS

EPC File No. SF2435

LEGAL DESCRIPTION:

PARCEL ONE:

A PARCEL OF LAND SITUATED IN SECTION 7, TOWNSHIP 13 SOUTH, RANGE 64 WEST OF THE SIXTH P.M., EL PASO COUNTY, COLORADO, BEING A PORTION OF THAT TRACT OF LAND DESCRIBED UNDER RECEPTION NO. 202131510 OF THE RECORDS OF SAID COUNTY, SAID PARCEL OF LAND BEING MORE PARTICULARLY DESCRIBED AS FOLLOWS:

COMMENCING AT THE NORTHWEST CORNER OF "ARROWHEAD ESTATES FILING NO. 1" AS DESCRIBED IN PLAT BOOK Y3 AT PAGE 39 OF THE RECORDS OF SAID COUNTY, SAID CORNER ALSO BEING THE NORTHWEST CORNER OF LOT 13, OF SAID "ARROWHEAD ESTATES FILING NO. 1"; (THE FOLLOWING FOUR (4) COURSES ARE ALONG THE WESTERLY AND NORTHERLY BOUNDARY LINES OF SAID "ARROWHEAD ESTATES FILING NO. 1".)

1) THENCE S 00 DEGREES 46 MINUTES 12 SECONDS W, 197.28 FEET TO THE POINT OF BEGINNING OF THE PARCEL OF LAND HEREIN DESCRIBED;

2) THENCE CONTINUE S 00 DEGREES 46 MINUTES 12 SECONDS W, 988.14 FEET;

3) THENCE S 86 DEGREES 00 MINUTES 46 SECONDS W, 327.52 FEET (327.53 FEET RECORDED);

4) THENCE S 00 DEGREES 25 MINUTES 05 SECONDS W, 68.17 FEET (67.53 FEET RECORDED) TO THE NORTHERLY LINE OF THAT TRACT OF LAND DESCRIBED UNDER RECEPTION NO. 202090702; THENCE N 89 DEGREES 59 MINUTES 43 SECONDS W, 430.45 FEET (430.08 FEET RECORDED) ALONG SAID NORTHERLY LINE TO THE SOUTHWESTERLY CORNER OF VERBURG SUBDIVISION WAIVER, A TRACT OF LAND AS DESCRIBED UNDER RECEPTION NO. 201000639 OF SAID RECORDS; THENCE N 00 DEGREES 14 MINUTES 15 SECONDS E, 1475.39 FEET (1475.79 FEET RECORDED) ALONG THE EASTERLY LINE OF SAID "VERBURG SUBDIVISION WAIVER" TO THE SOUTHEASTERLY RIGHT OF WAY LINE OF U.S. HIGHWAY NO. 24 AS

DESCRIBED IN BOOK 840 AT PAGE 258 OF SAID RECORDS; (THE FOLLOWING TWO (2) COURSES ARE ALONG SAID SOUTHWESTERLY RIGHT OF WAY LINE;

1) THENCE N 50 DEGREES 05 MINUTES 41 SECONDS E, 125.34 FEET (125.38 FEET RECORDED);
2) THENCE ALONG THE ARC OF A CURVE TO THE LEFT, SAID CURVE BEING CONCAVE TO THE NORTHWEST, HAVING A CHORD BEARING AND DISTANCE OF N 49 DEGREES 13 MINUTES 05 SECONDS E, 178.19 FEET, A CENTRAL ANGLE OF 1 DEGREES 45 MINUTES 37 SECONDS, A RADIUS OF 5800.00 FEET, FOR AN ARC DISTANCE OF 178.20 FEET; THENCE S 41 DEGREES 58 MINUTES 50 SECONDS E, 798.01 FEET TO THE POINT OF

PARCEL TWO:

A PARCEL OF LAND SITUATED IN SECTION 7, TOWNSHIP 13 SOUTH, RANGE 64 WEST OF THE SIXTH P.M., EL PASO COUNTY COLORADO, BEING A PORTION OF THAT TRACT OF LAND DESCRIBED UNDER RECEPTION NO. 202131510 OF THE RECORDS OF SAID COUNTY, SAID PARCEL OF LAND BEING MORE PARTICULARLY DESCRIBED AS FOLLOWS:

BEGINNING AT THE NORTHWEST CORNER OF "ARROWHEAD ESTATES FILING NO. 1" AS DESCRIBED IN PLAT BOOK Y-3 AT PAGE 39 OF THE RECORDS OF SAID COUNTY, SAID CORNER ALSO BEING THE NORTHWEST CORNER OF LOT 13, OF SAID "ARROWHEAD ESTATES FILING NO. 1"; THENCE S 00 DEGREES 46 MINUTES 12 SECONDS W, 197.28 FEET ALONG THE WESTERLY LINE OF SAID LOT 13 TO A POINT THEREON; THENCE N 41 DEGREES 58 MINUTES 50 SECONDS W, 798.01 FEET TO THE SOUTHEASTERLY RIGHT OF WAY LINE OF U.S. HIGHWAY NO. 24 AS DESCRIBED IN BOOK 840 AT PAGE 258 OF SAID RECORDS; (THE FOLLOWING TWO (2) COURSES ARE

ALONG SAID SOUTHEASTERLY RIGHT OF WAY LINE.)


1.) THENCE ALONG THE ARC OF A CURVE TO THE LEFT, SAID CURVE BEING CONCAVE TO THE NORTHWEST, HAVING A CHORD BEARING AND DISTANCE OF N 47 DEGREES 22 MINUTES 56 SECONDS E, 193.52 FEET, A CENTRAL ANGLE OF 1 DEGREE 54 MINUTES 42 SECONDS, A RADIUS OF

5800.00 FEET, FOR AN ARC DISTANCE OF 193.53 FEET;
2.) THENCE NORTH 46 DEGREES 25 MINUTES 11 SECONDS E, 760. 04 FEET (760.22 FEET RECORDED) TO THE INTERSECTION OF SAID SOUTHEASTERLY RIGHT OF WAY LINE WITH THE WESTERLY RIGHT OF WAY LINE OF RIO ROAD, A 60 FOOT RIGHT OF WAY SHOWN ON "FALCON RANCH ESTATES SUBDIVISION" AS RECORDED IN PLAT BOOK T-2 AT PAGE 47 OF SAID RECORDS; (THE FOLLOWING TWO (2) COURSES ARE ALONG SAID WESTERLY RIGHT OF WAY LINE AND THE SOUTHERLY RIGHT OF WAY LINE OF RIO ROAD.)

1.) THENCE S 22 DEGREES 22 MINUTES 28 SECONDS E, 219.81 FEET (219.73 FEET RECORDED);
2.) THENCE S 89 DEGREES 10 MINUTES 21 SECONDS E, 1071.23 FEET (1071.46 FEET RECORDED) TO THE NORTHWEST CORNER OF LOT 14 OF SAID "FALCON RANCH ESTATES SUBDIVISION"; THENCE S 00 DEGREES 10 MINUTES 51 SECONDS E, 705.04 FEET ALONG THE WESTERLY LINES OF SAID LOT 14 AND 13 OF SAID "FALCON RANCH ESTATES SUBDIVISION" TO THE MOST NORTHERLY NORTHWEST CORNER OF SAID "ARROWHEAD ESTATES FILING NO. 1", SAID CORNER ALSO BEING THE MOST NORTHERLY NORTHWEST CORNER OF LOT 10 OF SAID "ARROWHEAD ESTATES FILING NO. 1"; (THE FOLLOWING TWO (2) COURSES ARE ALONG THE WESTERLY AND NORTHERLY LINES OF SAID "ARROWHEAD ESTATE FILING NO. 1"0.)
1.) THENCE CONTINUE S 00 DEGREES 10 MINUTES 51 SECONDS E, 151.74 FEET (152.43 FEET RECORDED);

2.) THENCE N 88 DEGREES 55 MINUTES 44 SECONDS W, 1314.29 FEET (1314.59 FEET RECORDED) TO THE POINT OF BEGINNING.

THE ABOVE PARCELS OF LAND CONTAIN 2,511,970 SQUARE FEET OR 57.667 ACRES, MORE OR LESS.

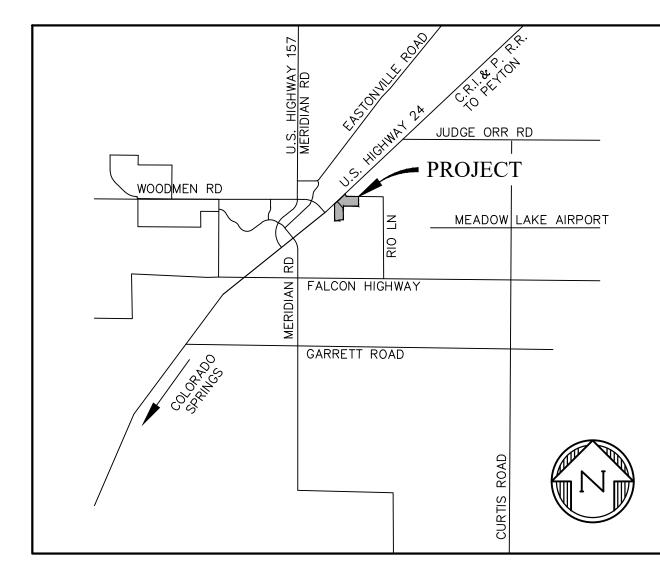

VICINITY MAP

DESIGN ENGINEER'S STATEMENT:

THESE DETAILED PLANS AND SPECIFICATIONS WERE PREPARED UNDER MY DIRECTION AND SUPERVISION. SAID PLANS AND SPECIFICATIONS HAVE BEEN PREPARED ACCORDING TO CRITERIA ESTABLISHED BY THE COUNTY FOR THE DETAILED ROADWAY, DRAINAGE, GRADING AND EROSION CONTROL PLANS AND SPECIFICATIONS, AND SAID PLANS AND SPECIFICATIONS ARE IN CONFORMITY WITH APPLICABLE MASTER DRAINAGE PLANS AND MASTER TRANSPORTATION PLANS. SAID PLANS AND SPECIFICATIONS MEET THE PURPOSES FOR WHICH THE PARTICULAR ROADWAY AND DRAINAGE FACILITIES ARE DESIGNED AND ARE CORRECT TO THE BEST OF MY KNOWLEDGE AND BELIEF. I ACCEPT RESPONSIBILITY FOR ANY LIABILITY CAUSED BY ANY NEGLIGENT ACTS, ERRORS OR OMISSIONS ON MY PART IN PREPARATION OF THESE DETAILED PLANS AND SPECIFICATIONS.

TIM D. MCCONNELL
P.E. # 33797

OWNER'S STATEMENT:

DALE STEWART 213 N. UNION BLVD

(719) 442-4733

COLORADO SPRINGS, CO 80909

I, THE OWNER/DEVELOPER HAVE READ AND WILL COMPLY WITH THE REQUIREMENTS OF THE GRADING AND EROSION CONTROL PLAN AND ALL OF THE REQUIREMENTS SPECIFIED IN THESE DETAILED PLANS AND SPECIFICATIONS.

STEVE ROSSOLL DATE

EL PASO COUNTY:

COUNTY PLAN REVIEW IS PROVIDED ONLY FOR GENERAL CONFORMANCE WITH COUNTY DESIGN CRITERIA. THE COUNTY IS NOT RESPONSIBLE FOR THE ACCURACY AND ADEQUACY OF THE DESIGN, DIMENSIONS, AND/OR ELEVATIONS WHICH SHALL BE CONFIRMED AT THE JOB SITE. THE COUNTY THROUGH THE APPROVAL OF THIS DOCUMENT ASSUMES NO RESPONSIBILITY FOR THE COMPLETENESS AND/OR ACCURACY OF THIS DOCUMENT.

FILED IN ACCORDANCE WITH THE REQUIREMENTS OF THE EL PASO COUNTY LAND DEVELOPMENT CODE, DRAINAGE CRITERIA MANUAL, AND ENGINEERING CRITERIA MANUAL AS AMENDED.

IN ACCORDANCE WITH ECM SECTION 1.12, THESE CONSTRUCTION DOCUMENTS WILL BE VALID FOR CONSTRUCTION FOR A PERIOD OF 2 YEARS FROM THE DATE SIGNED BY THE EL PASO COUNTY ENGINEER. IF CONSTRUCTION HAS NOT STARTED WITHIN THOSE 2 YEARS, THE PLANS WILL NEED TO BE RESUBMITTED FOR APPROVAL, INCLUDING PAYMENT OF REVIEW FEES AT THE PLANNING AND COMMUNITY DEVELOPMENT DIRECTOR'S DISCRETION.

JOSHUA PALMER, P.E.
COUNTY ENGINEER

Revise to: County Engineer/ECM administrator

AGENCY	CONTACTS:	SHEET	INDEX	
				provide missing
<u>COUNTY</u>	EL PASO COUNTY PLANNING & COMMUNITY	SHT1	C1	COVER SHEET sheets for review
	DEVELOPMENT	SHT2	C2	GENERAL NOTES
	RYAN HOWSER, PLANNER	SHT3	C3	SURVEY CONTROL PLAN
	2880 INTERNATIONAL CIRCLE, SUITE 110 COLORADO SPRINGS, CO 80910	SHT4	C4	DEMOLITION PLAN
	(719) 520-6300	SHT5	C5	OVERALL UTILITY
	(719) 320-6300	SHT6	C6	SW RETAIL ROW ST. & CUL-DE-\$AC PLAN & PROFILES
<u>FIRE</u>	FALCON FIRE DEPARTMENT	SHT7	C7	NE RETAIL ROW ST. & KNUCKLE PLAN & PROFILES
<u></u>	TRENT HARWIG, FIRE CHIEF	SHT8	C8	RIO LANE & NORTH KNUCKLE PLAN & PROFILES
	7030 OLD MERIDIAN ROAD	SHT9	C9	DUNLIN HEIGHTS & JACKDAW POINT PLAN & PROFILES
	FALCON, CO 80831	SHT10	C10	PERULA POINT & CUL-DE-SAC FLAN & PROFILES
	(719)495–4050	SHT11 SHT12	C11 C12	WOODMEN ROAD PLAN & PROFILES
		SHT12 SHT13	C12 C13	W ROUNDABOUT C&G FLOWLINE PLAN & PROFILES
<u>WATER</u>	WOODMEN HILLS METROPOLITAN DISTRICT	SHT14	C13	N ROUNDABOUT C&G FLOWLINE PLAN & PROFILES SE ROUNDABOUT C&G FLOWLINE PLAN & PROFILES
	8046 EASTONVILLE ROAD	3H715~	~~ C \5~~~	SPLITTER ISLAND ROUNDABOUT REAN
	FALCON, CO 80831	SHT16	C16	SITE PAVING & CONCRETE PLAN
	(719) 495–2500	SHT17	C17	SIGNAGE & STRIPING PLAN
WASTEWATER	WOODMEN HILLS METROPOLITAN DISTRICT	SHT18	C18	HIGHWAY 24 WIDENING & SIGNAL PLAN
WASILWAILK	8046 EASTONVILLE ROAD	SHTIB	عبوبهب	- ROAD SECTIONS
	FALCON, CO 8083	SHT20	C20	ROAD DETAILS
	(719) 495–2500	SHT21	STM1	STORM SEWER CHANNEL P&P
	(,,,,,,,,,,,,,,,,,,,,,,,,,,,,,,,,,,,,,,	SHT22	STM2	STORM SEWER CHANNEL P&P
<u>ELECTRIC</u>	MOUNTAIN VIEW ELECTRIC ASSOCIATION	SHT23	STM3	STORM SEWER CHANNEL P&P
	LES ULFERS	SHT24	STM4	STORM SEWER CHANNEL P&P
	11140 E. WOODMEN ROAD	SHT25	STM5	STORM SEWER CHANNEL P&P
	FALCON, CO 80831	SHT26	STM6	STORM SEWER CHANNEL P&P
	(719) 495–2283	SHT27	EX01	BOX CULVERT P&P
040	COLORADO CERNACE LITULTICO	SHT28	DTL	BOX CULVERT DETAILS
<u>GAS</u>	COLORADO SPRINGS UTILITIES TODD STURTEVANT	SHT29	DTL2	DETAILS
	1521 HANCOCK EXPRESSWAY			
	COLORADO SPRINGS, CO 80947			Provide detailed
	(719) 668–3556			
	(710) 303 3333			\ roundabout
TELEPHONE	CENTURY LINK			\ grading plan,
	SALLY KLEIN			lighting plan,
	(719) 636-4329			
	(LOCATORS) (719) 597-8418			landscaping and
	ÅT&T			center island
	(LOCATORS) (719) 635-3674			elevation plan
CARLE	COMOACT			σισναιίστι μιατί
<u>CABLE</u>	COMCAST			

Know what's below.
Call before you dig.

CALL 2-BUSINESS DAYS IN ADVANCE BEFORE YOU DIG, GRADE, OR EXCAVATE FOR THE MARKING OF UNDERGROUND MEMBER UTILITIES.

PREPARED BY:



DREXEL, BARRELL & CO
Engineers • Surveyors
101 SAHWATCH ST., SUITE 100
COLORADO SPGS, COLORADO 8090
CONTACT: TIM D. McCONNELL, P.E
(719)260-0887

CLIENT:

COLORADO SPRINGS • LAFAYETTE

PROTERRA PROPERTIES

1864 WOODMOOR DRIVE MONUMENT, CO 80132 (719) 476-0800 CONTACT: STEVE ROSSOLL srossoll@proterraco.com

THE COMMONS AT FALCON FIELD 12445 RIO LANE, AND VACANT LAND

ISSUE DATE

INITIAL ISSUE 12/16/24

DESIGNED BY: KGV

DRAWN BY: SDM

CHECKED BY: TDM

FILE NAME: CV&NOTES

PREPARED UNDER MY DIRECT SUPERVISION FOR AND ON BEHALF OF DREXEL, BARRELL & CO.

DRAWING SCALE:
HORIZONTAL: N/A
VERTICAL: N/A

COVER SHEET

PROJECT NO. 21604-00CSCV

C1

SHEET: 1 OF 29

Per the soils and geology report and plat note there is to be an underground drainage system. Please provide the drainage system on the plans.

STANDARD NOTES FOR EL PASO COUNTY GRADING AND EROSION CONTROL PLANS

- 1. STORMWATER DISCHARGES FROM CONSTRUCTION SITES SHALL NOT CAUSE OR THREATEN TO CAUSE POLLUTION, CONTAMINATION, OR DEGRADATION OF STATE WATERS. ALL WORK AND EARTH DISTURBANCE SHALL BE DONE IN A MANNER THAT MINIMIZES POLLUTION OF ANY ON-SITE OR OFF-SITE WATERS, INCLUDING WETLANDS.
- 2.NOTWITHSTANDING ANYTHING DEPICTED IN THESE PLANS IN WORDS OR GRAPHIC REPRESENTATION, ALL DESIGN AND CONSTRUCTION RELATED TO ROADS, STORM DRAINAGE AND EROSION CONTROL SHALL CONFORM TO THE STANDARDS AND REQUIREMENTS OF THE MOST RECENT VERSION OF THE RELEVANT ADOPTED EL PASO COUNTY STANDARDS, INCLUDING THE LAND DEVELOPMENT CODE, THE ENGINEERING CRITERIA MANUAL, THE DRAINAGE CRITERIA MANUAL, AND THE DRAINAGE CRITERIA MANUAL VOLUME 2. ANY DEVIATIONS FROM REGULATIONS AND STANDARDS MUST BE REQUESTED, AND APPROVED, IN WRITING.
- 3.A SEPARATE STORMWATER MANAGEMENT PLAN (SMWP) FOR THIS PROJECT SHALL BE COMPLETED AND AN EROSION AND STORMWATER QUALITY CONTROL PERMIT (ESQCP) ISSUED PRIOR TO COMMENCING CONSTRUCTION. MANAGEMENT OF THE SWMP DURING CONSTRUCTION IS THE RESPONSIBILITY OF THE DESIGNATED QUALIFIED STORMWATER MANAGER OR CERTIFIED EROSION CONTROL INSPECTOR. THE SWMP SHALL BE LOCATED ON SITE AT ALL TIMES DURING CONSTRUCTION AND SHALL BE KEPT UP TO DATE WITH WORK PROGRESS AND CHANGES IN THE FIELD.
- 4.ONCE THE ESQCP IS APPROVED AND A "NOTICE TO PROCEED" HAS BEEN ISSUED, THE CONTRACTOR MAY INSTALL THE INITIAL STAGE EROSION AND SEDIMENT CONTROL MEASURES AS INDICATED ON THE APPROVED GEC. A PRECONSTRUCTION MEETING BETWEEN THE CONTRACTOR, ENGINEER, AND EL PASO COUNTY WILL BE HELD PRIOR TO ANY CONSTRUCTION. IT IS THE RESPONSIBILITY OF THE APPLICANT TO COORDINATE THE MEETING TIME AND PLACE WITH COUNTY STAFF.
- 5.CONTROL MEASURES MUST BE INSTALLED PRIOR TO COMMENCEMENT OF ACTIVITIES THAT COULD CONTRIBUTE POLLUTANTS TO STORMWATER. CONTROL MEASURES FOR ALL SLOPES, CHANNELS, DITCHES, AND DISTURBED LAND AREAS SHALL BE INSTALLED IMMEDIATELY UPON COMPLETION OF THE DISTURBANCE.
- 6.ALL TEMPORARY SEDIMENT AND EROSION CONTROL MEASURES SHALL BE MAINTAINED AND REMAIN IN EFFECTIVE OPERATING CONDITION UNTIL PERMANENT SOIL EROSION CONTROL MEASURES ARE IMPLEMENTED AND FINAL STABILIZATION IS ESTABLISHED. ALL PERSONS ENGAGED IN LAND DISTURBANCE ACTIVITIES SHALL ASSESS THE ADEQUACY OF CONTROL MEASURES AT THE SITE AND IDENTIFY IF CHANGES TO THOSE CONTROL MEASURES ARE NEEDED TO ENSURE THE CONTINUED EFFECTIVE PERFORMANCE OF THE CONTROL MEASURES. ALL CHANGES TO TEMPORARY SEDIMENT AND EROSION CONTROL MEASURES MUST BE INCORPORATED INTO THE STORMWATER MANAGEMENT PLAN.
- 7. TEMPORARY STABILIZATION SHALL BE IMPLEMENTED ON DISTURBED AREAS AND STOCKPILES WHERE GROUND DISTURBING CONSTRUCTION ACTIVITY HAS PERMANENTLY CEASED OR TEMPORARILY CEASED FOR LONGER THAN 14 DAYS.
- 8.FINAL STABILIZATION MUST BE IMPLEMENTED AT ALL APPLICABLE CONSTRUCTION SITES. FINAL STABILIZATION IS ACHIEVED WHEN ALL GROUND DISTURBING ACTIVITIES ARE COMPLETE AND ALL DISTURBED AREAS EITHER HAVE A UNIFORM VEGETATIVE COVER WITH INDIVIDUAL PLANT DENSITY OF 70 PERCENT OF PRE—DISTURBANCE LEVELS ESTABLISHED OR EQUIVALENT PERMANENT ALTERNATIVE STABILIZATION METHOD IS IMPLEMENTED. ALL TEMPORARY SEDIMENT AND EROSION CONTROL MEASURES SHALL BE REMOVED UPON FINAL STABILIZATION AND BEFORE PERMIT CLOSURE.
- 9.ALL PERMANENT STORMWATER MANAGEMENT FACILITIES SHALL BE INSTALLED AS DESIGNED IN THE APPROVED PLANS. ANY PROPOSED CHANGES THAT AFFECT THE DESIGN OR FUNCTION OF PERMANENT STORMWATER MANAGEMENT STRUCTURES MUST BE APPROVED BY THE ECM ADMINISTRATOR PRIOR TO IMPLEMENTATION.
- 10. EARTH DISTURBANCES SHALL BE CONDUCTED IN SUCH A MANNER SO AS TO EFFECTIVELY MINIMIZE ACCELERATED SOIL EROSION AND RESULTING SEDIMENTATION. ALL DISTURBANCES SHALL BE DESIGNED, CONSTRUCTED, AND COMPLETED SO THAT THE EXPOSED AREA OF ANY DISTURBED LAND SHALL BE LIMITED TO THE SHORTEST PRACTICAL PERIOD OF TIME. PRE-EXISTING VEGETATION SHALL BE PROTECTED AND MAINTAINED WITHIN 50 HORIZONTAL FEET OF A WATERS OF THE STATE UNLESS SHOWN TO BE INFEASIBLE AND SPECIFICALLY REQUESTED AND APPROVED.
- 11. COMPACTION OF SOIL MUST BE PREVENTED IN AREAS DESIGNATED FOR INFILTRATION CONTROL MEASURES OR WHERE FINAL STABILIZATION WILL BE ACHIEVED BY VEGETATIVE COVER. AREAS DESIGNATED FOR INFILTRATION CONTROL MEASURES SHALL ALSO BE PROTECTED FROM SEDIMENTATION DURING CONSTRUCTION UNTIL FINAL STABILIZATION IS ACHIEVED. IF COMPACTION PREVENTION IS NOT FEASIBLE DUE TO SITE CONSTRAINTS, ALL AREAS DESIGNATED FOR INFILTRATION AND VEGETATION CONTROL MEASURES MUST BE LOOSENED PRIOR TO INSTALLATION OF THE CONTROL MEASURE(S).
- 12. ANY TEMPORARY OR PERMANENT FACILITY DESIGNED AND CONSTRUCTED FOR THE CONVEYANCE OF STORMWATER AROUND, THROUGH, OR FROM THE EARTH DISTURBANCE AREA SHALL BE A STABILIZED CONVEYANCE DESIGNED TO MINIMIZE EROSION AND THE DISCHARGE OF SEDIMENT OFF SITE.
- 13. CONCRETE WASH WATER SHALL BE CONTAINED AND DISPOSED OF IN ACCORDANCE WITH THE SWMP. NO WASH WATER SHALL BE DISCHARGED TO OR ALLOWED TO ENTER STATE WATERS, INCLUDING ANY SURFACE OR SUBSURFACE STORM DRAINAGE SYSTEM OR FACILITIES. CONCRETE WASHOUTS SHALL NOT BE LOCATED IN AN AREA WHERE SHALLOW GROUNDWATER MAY BE PRESENT, OR WITHIN 50 FEET OF A SURFACE WATER BODY, CREEK OR STREAM.
- 14. DURING DEWATERING OPERATIONS OF UNCONTAMINATED GROUND WATER MAY BE DISCHARGED ON SITE, BUT SHALL NOT LEAVE THE SITE IN THE FORM OF SURFACE RUNOFF UNLESS AN APPROVED STATE DEWATERING PERMIT IS IN PLACE.
- 15. EROSION CONTROL BLANKETING OR OTHER PROTECTIVE COVERING SHALL BE USED ON SLOPES STEEPER THAN 3:1.
- 16. CONTRACTOR SHALL BE RESPONSIBLE FOR THE REMOVAL OF ALL WASTES FROM THE CONSTRUCTION SITE FOR DISPOSAL IN ACCORDANCE WITH LOCAL AND STATE REGULATORY REQUIREMENTS. NO CONSTRUCTION DEBRIS, TREE SLASH, BUILDING MATERIAL WASTES OR UNUSED BUILDING MATERIALS SHALL BE BURIED, DUMPED, OR DISCHARGED AT THE SITE.
- 17. WASTE MATERIALS SHALL NOT BE TEMPORARILY PLACED OR STORED IN THE STREET, ALLEY, OR OTHER PUBLIC WAY, UNLESS IN ACCORDANCE WITH AN APPROVED TRAFFIC CONTROL PLAN. CONTROL MEASURES MAY BE REQUIRED BY EL PASO COUNTY ENGINEERING IF DEEMED NECESSARY, BASED ON SPECIFIC CONDITIONS AND CIRCUMSTANCES.
- 18. TRACKING OF SOILS AND CONSTRUCTION DEBRIS OFF-SITE SHALL BE MINIMIZED. MATERIALS TRACKED OFF-SITE SHALL BE CLEANED UP AND PROPERLY DISPOSED OF IMMEDIATELY.
- 19. THE OWNER/DEVELOPER SHALL BE RESPONSIBLE FOR THE REMOVAL OF ALL CONSTRUCTION DEBRIS, DIRT, TRASH, ROCK, SEDIMENT, SOIL, AND SAND THAT MAY ACCUMULATE IN ROADS, STORM DRAINS AND OTHER DRAINAGE CONVEYANCE SYSTEMS AND STORMWATER APPURTENANCES AS A RESULT OF SITE DEVELOPMENT.
- 20. THE QUANTITY OF MATERIALS STORED ON THE PROJECT SITE SHALL BE LIMITED, AS MUCH AS PRACTICAL, TO THAT QUANTITY REQUIRED TO PERFORM THE WORK IN AN ORDERLY SEQUENCE. ALL MATERIALS STORED ON—SITE SHALL BE STORED IN A NEAT, ORDERLY MANNER, IN THEIR ORIGINAL CONTAINERS, WITH ORIGINAL MANUFACTURER'S LABELS.
- 21. NO CHEMICAL(S) HAVING THE POTENTIAL TO BE RELEASED IN STORMWATER ARE TO BE STORED OR USED ONSITE UNLESS PERMISSION FOR THE USE OF SUCH CHEMICAL(S) IS GRANTED IN WRITING BY THE ECM ADMINISTRATOR. IN GRANTING APPROVAL FOR THE USE OF SUCH CHEMICAL(S), SPECIAL CONDITIONS AND MONITORING MAY BE REQUIRED.
- 22. BULK STORAGE OF ALLOWED PETROLEUM PRODUCTS OR OTHER ALLOWED LIQUID CHEMICALS IN EXCESS OF 55 GALLONS SHALL REQUIRE ADEQUATE SECONDARY CONTAINMENT PROTECTION TO CONTAIN ALL SPILLS ONSITE AND TO PREVENT ANY SPILLED MATERIALS FROM ENTERING STATE WATERS, ANY SURFACE OR SUBSURFACE STORM DRAINAGE SYSTEM OR OTHER FACILITIES.
- 23. NO PERSON SHALL CAUSE THE IMPEDIMENT OF STORMWATER FLOW IN THE CURB AND GUTTER OR DITCH EXCEPT WITH APPROVED SEDIMENT CONTROL MEASURES.
- 24. OWNER/DEVELOPER AND THEIR AGENTS SHALL COMPLY WITH THE "COLORADO WATER QUALITY CONTROL ACT" (TITLE 25, ARTICLE 8, CRS), AND THE "CLEAN WATER ACT" (33 USC 1344), IN ADDITION TO THE REQUIREMENTS OF THE LAND DEVELOPMENT CODE, DCM VOLUME II AND THE ECM APPENDIX I. ALL APPROPRIATE PERMITS MUST BE OBTAINED BY THE CONTRACTOR PRIOR TO CONSTRUCTION (1041, NPDES, FLOODPLAIN, 404, FUGITIVE DUST, ETC.). IN THE EVENT OF CONFLICTS BETWEEN THESE REQUIREMENTS AND OTHER LAWS, RULES, OR REGULATIONS OF OTHER FEDERAL, STATE, LOCAL, OR COUNTY AGENCIES, THE MOST RESTRICTIVE LAWS, RULES, OR REGULATIONS SHALL APPLY.
- 25. ALL CONSTRUCTION TRAFFIC MUST ENTER/EXIT THE SITE ONLY AT APPROVED CONSTRUCTION ACCESS POINTS.
- 26. PRIOR TO CONSTRUCTION THE PERMITTEE SHALL VERIFY THE LOCATION OF EXISTING UTILITIES.
- 27. A WATER SOURCE SHALL BE AVAILABLE ON SITE DURING EARTHWORK OPERATIONS AND SHALL BE UTILIZED AS REQUIRED TO MINIMIZE DUST FROM EARTHWORK EQUIPMENT AND WIND.
- 28. THE SOILS REPORT FOR THIS SITE HAS BEEN PREPARED BY GROUND ENGINEERING, DATED AUGUST 25, 2015, WITH ADDENDA #1, DATED MARCH 17, 2017, AND SHALL BE CONSIDERED A PART OF THESE PLANS.
- 29. AT LEAST TEN (10) DAYS PRIOR TO THE ANTICIPATED START OF CONSTRUCTION, FOR PROJECTS THAT WILL DISTURB ONE (1) ACRE OR MORE, THE OWNER OR OPERATOR OF CONSTRUCTION ACTIVITY SHALL SUBMIT A PERMIT APPLICATION FOR STORMWATER DISCHARGE TO THE COLORADO DEPARTMENT OF PUBLIC HEALTH AND ENVIRONMENT, WATER QUALITY DIVISION. THE APPLICATION CONTAINS CERTIFICATION OF COMPLETION OF A STORMWATER MANAGEMENT PLAN (SWMP), OF WHICH THIS GRADING AND EROSION CONTROL PLAN MAY BE A PART. FOR INFORMATION OR APPLICATION MATERIALS CONTACT:
- COLORADO DEPARTMENT OF PUBLIC HEALTH AND ENVIRONMENT
- WATER QUALITY CONTROL DIVISION
 WQCD PERMITS
 4300 CHERRY CREEK DRIVE SOUTH
 DENVER, CO 80246—1530

ATTN: PERMITS UNIT

STANDARD NOTES FOR EL PASO COUNTY CONSTRUCTION PLANS

d.CDOT M & S STANDARDS

- 1. ALL DRAINAGE AND ROADWAY CONSTRUCTION SHALL MEET THE STANDARDS AND SPECIFICATIONS OF THE CITY OF COLORADO SPRINGS/EL PASO COUNTY DRAINAGE CRITERIA MANUAL, VOLUMES 1 AND 2, AND THE EL PASO COUNTY ENGINEERING CRITERIA MANUAL.
- 2.CONTRACTOR SHALL BE RESPONSIBLE FOR THE NOTIFICATION AND FIELD NOTIFICATION OF ALL EXISTING UTILITIES, WHETHER SHOWN ON THE PLANS OR NOT, BEFORE BEGINNING CONSTRUCTION. LOCATION OF EXISTING UTILITIES SHALL BE VERIFIED BY THE CONTRACTOR PRIOR TO CONSTRUCTION. CALL 811 TO CONTACT THE UTILITY NOTIFICATION CENTER OF COLORADO (UNCC).
- 3.CONTRACTOR SHALL KEEP A COPY OF THESE APPROVED PLANS, THE GRADING AND EROSION CONTROL PLAN, THE STORMWATER MANAGEMENT PLAN (SWMP), THE SOILS AND GEOTECHNICAL REPORT, AND THE APPROPRIATE DESIGN AND CONSTRUCTION STANDARDS AND SPECIFICATIONS AT THE JOB SITE AT ALL TIMES, INCLUDING THE FOLLOWING:
- a.EL PASO COUNTY ENGINEERING CRITERIA MANUAL (ECM)
 b.CITY OF COLORADO SPRINGS/EL PASO COUNTY DRAINAGE CRITERIA MANUAL, VOLUMES 1 AND 2
 c.COLORADO DEPARTMENT OF TRANSPORTATION (CDOT) STANDARD SPECIFICATIONS FOR ROAD AND BRIDGE CONSTRUCTION
- 4.NOTWITHSTANDING ANYTHING DEPICTED IN THESE PLANS IN WORDS OR GRAPHIC REPRESENTATION, ALL DESIGN AND CONSTRUCTION RELATED TO ROADS, STORM DRAINAGE AND EROSION CONTROL SHALL CONFORM TO THE STANDARDS AND REQUIREMENTS OF THE MOST RECENT VERSION OF THE RELEVANT ADOPTED EL PASO COUNTY STANDARDS, INCLUDING THE LAND DEVELOPMENT CODE, THE ENGINEERING CRITERIA MANUAL, THE DRAINAGE CRITERIA MANUAL, AND THE DRAINAGE CRITERIA MANUAL VOLUME 2. ANY DEVIATIONS FROM REGULATIONS AND STANDARDS MUST BE REQUESTED, AND APPROVED, IN WRITING. ANY MODIFICATIONS NECESSARY TO MEET CRITERIA AFTER—THE—FACT WILL BE ENTIRELY THE DEVELOPER'S RESPONSIBILITY TO RECTIFY.
- 5.IT IS THE DESIGN ENGINEER'S RESPONSIBILITY TO ACCURATELY SHOW EXISTING CONDITIONS, BOTH ONSITE AND OFFSITE, ON THE CONSTRUCTION PLANS. ANY MODIFICATIONS NECESSARY DUE TO CONFLICTS, OMISSIONS, OR CHANGED CONDITIONS WILL BE ENTIRELY THE DEVELOPER'S RESPONSIBILITY TO RECTIFY.
- 6.CONTRACTOR SHALL SCHEDULE A PRE-CONSTRUCTION MEETING WITH EL PASO COUNTY PLANNING AND COMMUNITY DEVELOPMENT (PCD) INSPECTIONS, PRIOR TO STARTING CONSTRUCTION.
- 7.IT IS THE CONTRACTOR'S RESPONSIBILITY TO UNDERSTAND THE REQUIREMENTS OF ALL JURISDICTIONAL AGENCIES AND TO OBTAIN ALL REQUIRED PERMITS, INCLUDING BUT NOT LIMITED TO EL PASO COUNTY EROSION AND STORMWATER QUALITY CONTROL PERMIT (ESQCP), REGIONAL BUILDING FLOODPLAIN DEVELOPMENT PERMIT, U.S. ARMY CORPS OF ENGINEERS—ISSUED 401 AND/OR 404 PERMITS, AND COUNTY AND STATE FUGITIVE DUST PERMITS.
- 8.CONTRACTOR SHALL NOT DEVIATE FROM THE PLANS WITHOUT FIRST OBTAINING WRITTEN APPROVAL FROM THE DESIGN ENGINEER AND PCD. CONTRACTOR SHALL NOTIFY THE DESIGN ENGINEER IMMEDIATELY UPON DISCOVERY OF ANY ERRORS OR INCOMPRESSION OF THE DESIGN ENGINEER IMMEDIATELY UPON DISCOVERY OF ANY ERRORS OR INCOMPRESSION OF THE DESIGN ENGINEER IMMEDIATELY UPON DISCOVERY OF ANY ERRORS OR INCOMPRESSION OF THE DESIGN ENGINEER IMMEDIATELY UPON DISCOVERY OF ANY ERRORS OR INCOMPRESSION OF THE DESIGN ENGINEER IMMEDIATELY UPON DISCOVERY UPON DISCOVERY
- 9.ALL STORM DRAIN PIPE SHALL BE CLASS III RCP UNLESS OTHERWISE NOTED AND APPROVED BY PCD. WATERTIGHT JOINTS SHALL BE PROVIDED ON THE SPECIFIED PIPES.
- 10. CONTRACTOR SHALL COORDINATE GEOTECHNICAL TESTING PER ECM STANDARDS. PAVEMENT DESIGN SHALL BE APPROVED BY EL PASO COUNTY PCD PRIOR TO PLACEMENT OF CURB AND GUTTER AND PAVEMENT.
- 11. ALL CONSTRUCTION TRAFFIC MUST ENTER/EXIT THE SITE AT APPROVED CONSTRUCTION ACCESS POINTS.
- 12. SIGHT VISIBILITY TRIANGLES AS IDENTIFIED IN THE PLANS SHALL BE PROVIDED AT ALL INTERSECTIONS. OBSTRUCTIONS GREATER THAN 18 INCHES ABOVE FLOWLINE ARE NOT ALLOWED WITHIN SIGHT TRIANGLES.
- 13. SIGNING AND STRIPING SHALL COMPLY WITH EL PASO COUNTY DOT AND MUTCD CRITERIA. [IF APPLICABLE, ADDITIONAL SIGNING AND STRIPING NOTES WILL BE PROVIDED.]
- 14. CONTRACTOR SHALL OBTAIN ANY PERMITS REQUIRED BY EL PASO COUNTY DOT, INCLUDING WORK WITHIN THE RIGHT-OF-WAY AND SPECIAL TRANSPORT PERMITS.
- 15. THE LIMITS OF CONSTRUCTION SHALL REMAIN WITHIN THE PROPERTY LINE UNLESS OTHERWISE NOTED. THE OWNER/DEVELOPER SHALL OBTAIN WRITTEN PERMISSION AND EASEMENTS, WHERE REQUIRED, FROM ADJOINING PROPERTY OWNER(S) PRIOR TO ANY OFF-SITE DISTURBANCE, GRADING, OR CONSTRUCTION.

SIGNAGE AND STRIPING NOTES

SIGNING AND STRIPING NOTES:


1. ALL SIGNS AND PAVEMENT MARKINGS SHALL BE IN COMPLIANCE WITH THE CURRENT MANUAL ON UNIFORM TRAFFIC CONTROL DEVICES (MUTCD).

2. REMOVAL OF EXISTING PAVEMENT MARKINGS SHALL BE ACCOMPLISHED BY A METHOD THAT DOES NOT MATERIALLY DAMAGE THE PAVEMENT. THE PAVEMENT MARKINGS SHALL BE REMOVED TO THE EXTENT THAT THEY WILL NOT BE VISIBLE UNDER DAY OR NIGHT CONDITIONS. AT NO TIME WILL IT BE ACCEPTABLE TO PAINT OVER EXISTING PAVEMENT MARKINGS.

3. ANY DEVIATION FROM THE STRIPING AND SIGNING PLAN SHALL BE APPROVED BY EL PASO COUNTY PLANNING AND COMMUNITY DEVELOPMENT.

- 4. ALL SIGNS SHOWN ON THE SIGNING AND STRIPING PLAN SHALL BE NEW SIGNS. EXISTING SIGNS MAY REMAIN OR BE REUSED IF THEY MEET CURRENT EL PASO COUNTY AND MUTCD STANDARDS.
- 5. STREET NAME AND REGULATORY STOP SIGNS SHALL BE ON THE SAME POST AT INTERSECTIONS.
- 6. ALL REMOVED SIGNS SHALL BE DISPOSED OF IN A PROPER MANNER BY THE CONTRACTOR.
- 7. ALL STREET NAME SIGNS SHALL HAVE "D" SERIES LETTERS, WITH LOCAL ROADWAY SIGNS BEING 4" UPPER-LOWER CASE LETTERING ON 8" BLANK AND NON-LOCAL ROADWAY SIGNS BEING 6" LETTERING, UPPER-LOWER CASE ON 12" BLANK, WITH A WHITE BORDER THAT IS NOT RECESSED. MULTI-LANE ROADWAYS WITH SPEED LIMITS OF 35 MPH OR HIGHER SHALL HAVE 8" UPPER-LOWER CASE LETTERING ON 12" BLANK WITH A WHITE BORDER THAT IS NOT RECESSED. THE WIDTH OF THE NON-RECESSED WHITE BORDERS SHALL MATCH PAGE 255 OF THE 2012 MUTCD "STANDARD HIGHWAY SIGNS". SIGNAL POLE MOUNTED AND OVERHEAD STREET NAME SIGNS SHALL BE SIZED TO "MUTCD" SIZE STANDARDS.
- 8. ALL TRAFFIC SIGNS SHALL HAVE A MINIMUM HIGH INTENSITY PRISMATIC GRADE SHEETING.
- 9. ALL LOCAL RESIDENTIAL STREET SIGNS SHALL BE MOUNTED ON A 1.75" X 1.75" SQUARE TUBE SIGN POST AND STUB POST BASE. FOR OTHER APPLICATIONS, REFER TO THE CDOT STANDARD S-614-8 REGARDING USE OF THE P2 TUBULAR STEEL POST SLIPBASE DESIGN.
- 10. ALL SIGNS SHALL BE SINGLE SHEET ALUMINUM WITH 0.100" MINIMUM THICKNESS.
- 11. ALL LIMIT LINES/STOP LINES, CROSSWALK LINES, PAVEMENT LEGENDS, AND ARROWS SHALL BE A MINIMUM 125 MIL THICKNESS PREFORMED THERMOPLASTIC PAVEMENT MARKINGS WITH TAPERED LEADING EDGES PER CDOT STANDARD S-627-1. STOP BARS SHALL BE 24" IN WIDTH. CROSSWALKS LINES SHALL BE 24" WIDE AND 9' LONG.
- 12. WORD AND SYMBOL MARKINGS SHALL BE THE NARROW TYPE.
- 13. ALL LONGITUDINAL LINES SHALL BE A MINIMUM 15MIL THICKNESS EPOXY PAINT. ALL NON-LOCAL RESIDENTIAL ROADWAYS SHALL INCLUDE BOTH RIGHT AND LEFT EDGE LINE STRIPING AND ANY ADDITIONAL STRIPING AS REQUIRED BY CDOT S-627-1.
- 14. THE CONTRACTOR SHALL NOTIFY EL PASO COUNTY PLANNING AND COMMUNITY DEVELOPMENT (719) 520-6819 PRIOR TO AND UPON COMPLETION OF SIGNING AND STRIPING.
- 15. THE CONTRACTOR SHALL OBTAIN A WORK IN THE RIGHT OF WAY PERMIT FROM THE EL PASO COUNTY DEPARTMENT OF PUBLIC WORKS (DPW) PRIOR TO ANY SIGNAGE OR STRIPING WORK WITHIN AN EXISTING EL PASO COUNTY ROADWAY.

PREPARED BY:

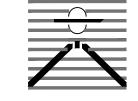

DREXEL, BARRELL & CO.
Engineers • Surveyors
101 SAHWATCH ST., SUITE 100
COLORADO SPGS, COLORADO 80903
CONTACT: TIM D. McCONNELL, P.E.
(719)260-0887

COLORADO SPRINGS • LAFAYETTE

CLIENT:

PROTERRA PROPERTIES

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THE COMMONS AT FALCON FIELD

12445 RIO LANE, AND VACANT LAND

ISSUE	·	DAT
INITIAL ISSU	JE	12/16/
DESIGNED E	BY:	KGV
DRAWN BY	SDM	
CHECKED E	Y:	TDM
FILE NAME:	C/	/&NOTES
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PREPARED UNDER MY DIRECT SUPERVISION FOR AND ON BEHALF OF DREXEL, BARRELL & CO.

DRAWING SCALE:
HORIZONTAL: N/A
VERTICAL: N/A

GENERAL NOTES

PROJECT NO. 21604-00CSCV

C₂


SHEET: 2 OF 29


Know what's below.
Call before you dig.

CALL 2-BUSINESS DAYS IN ADVANCE BEFORE YOU DIG, GRADE, OR EXCAVATE FOR THE MARKING OF UNDERGROUND MEMBER UTILITIES.


Please update per latest EPC

tandard notes

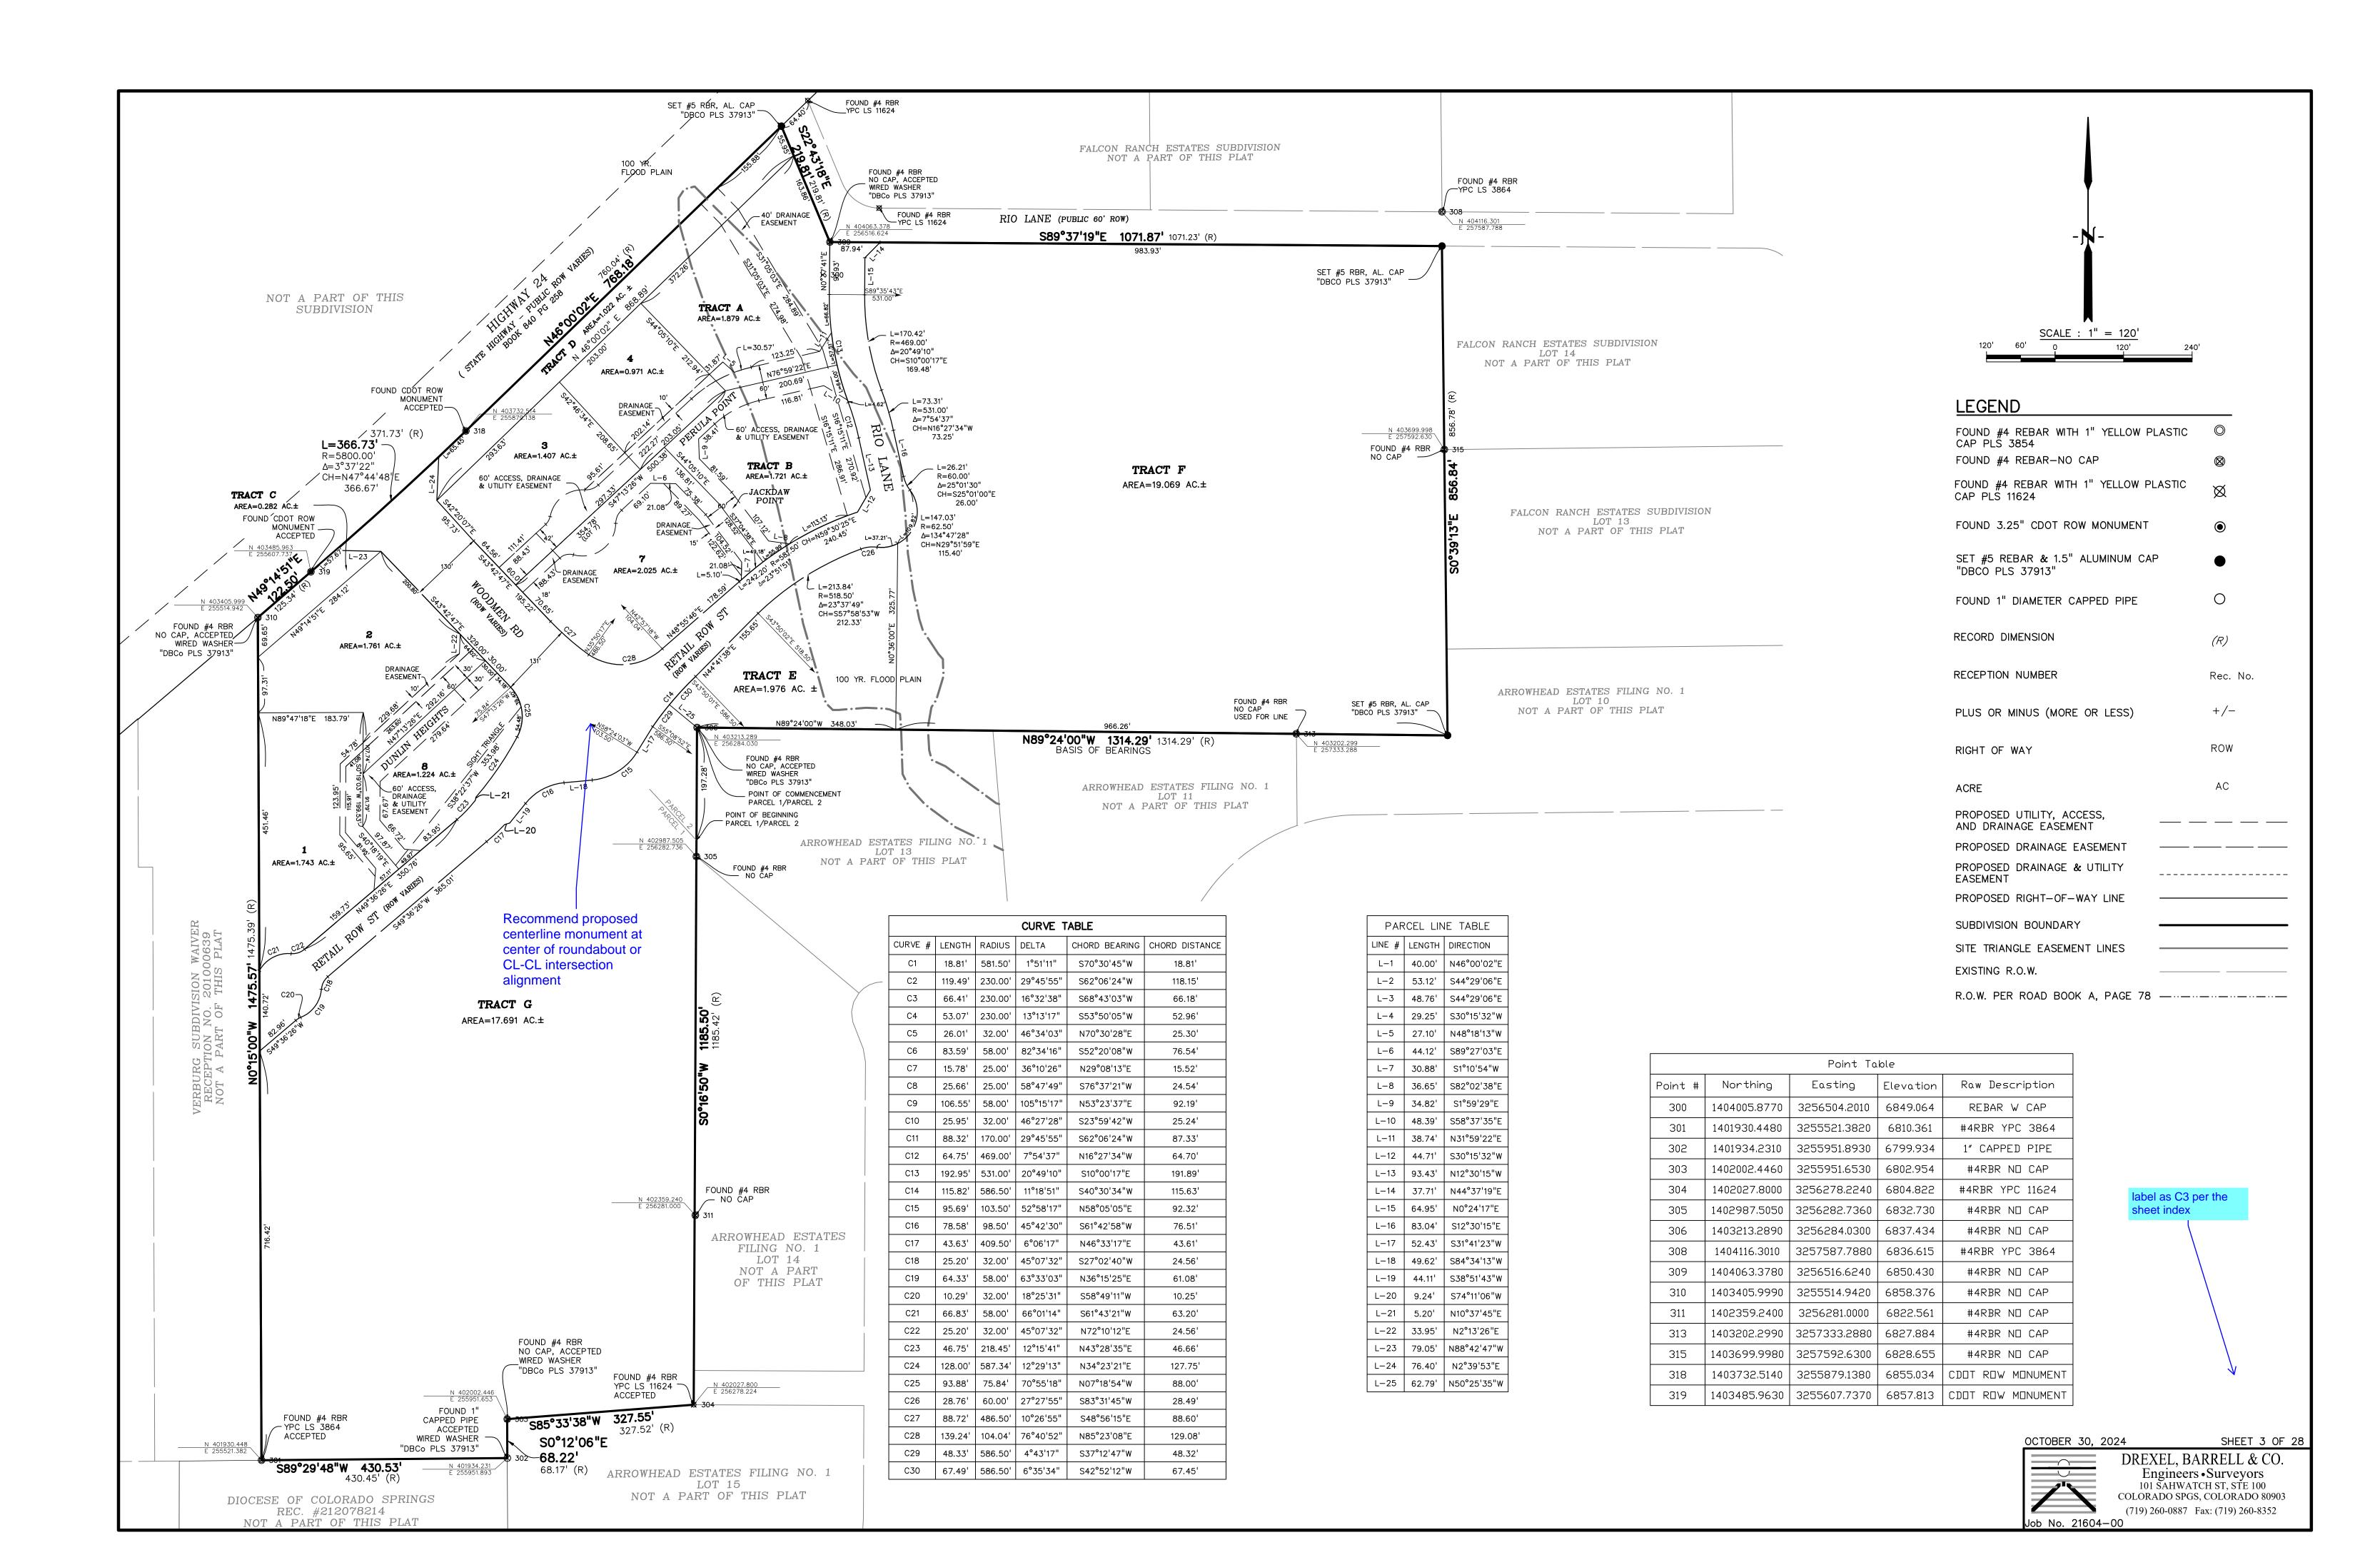


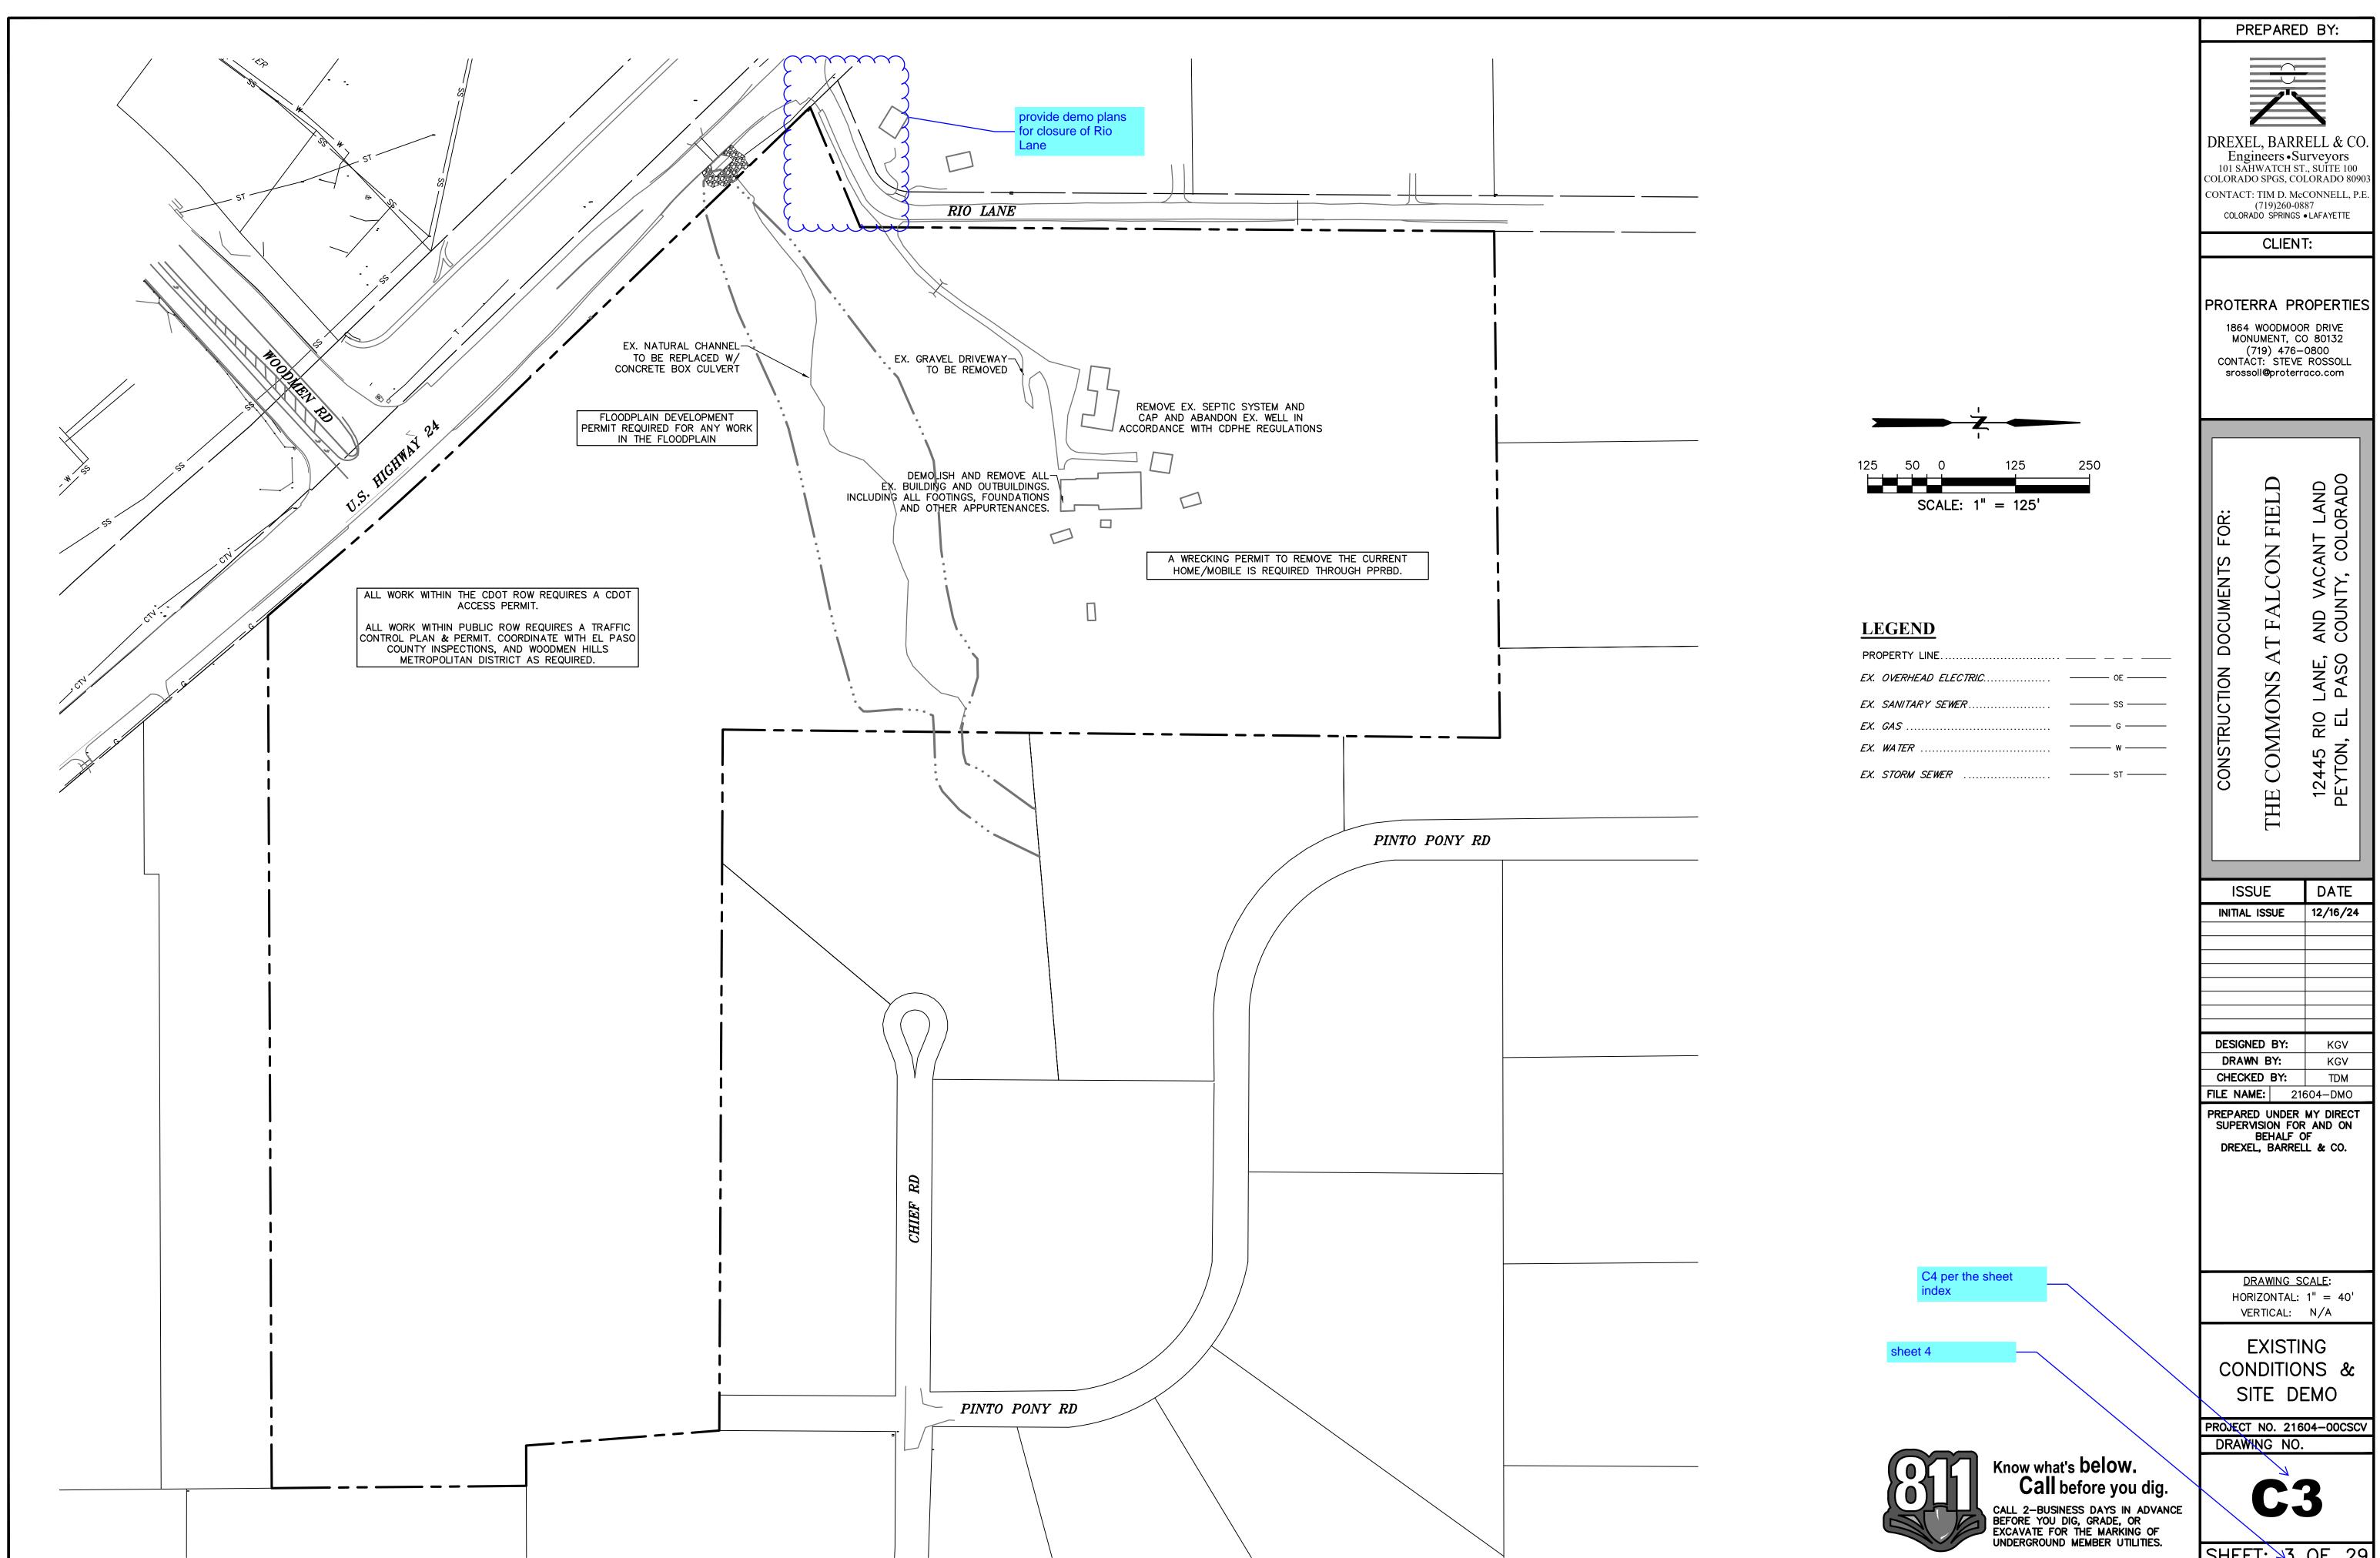

SHEET: 3 OF 29

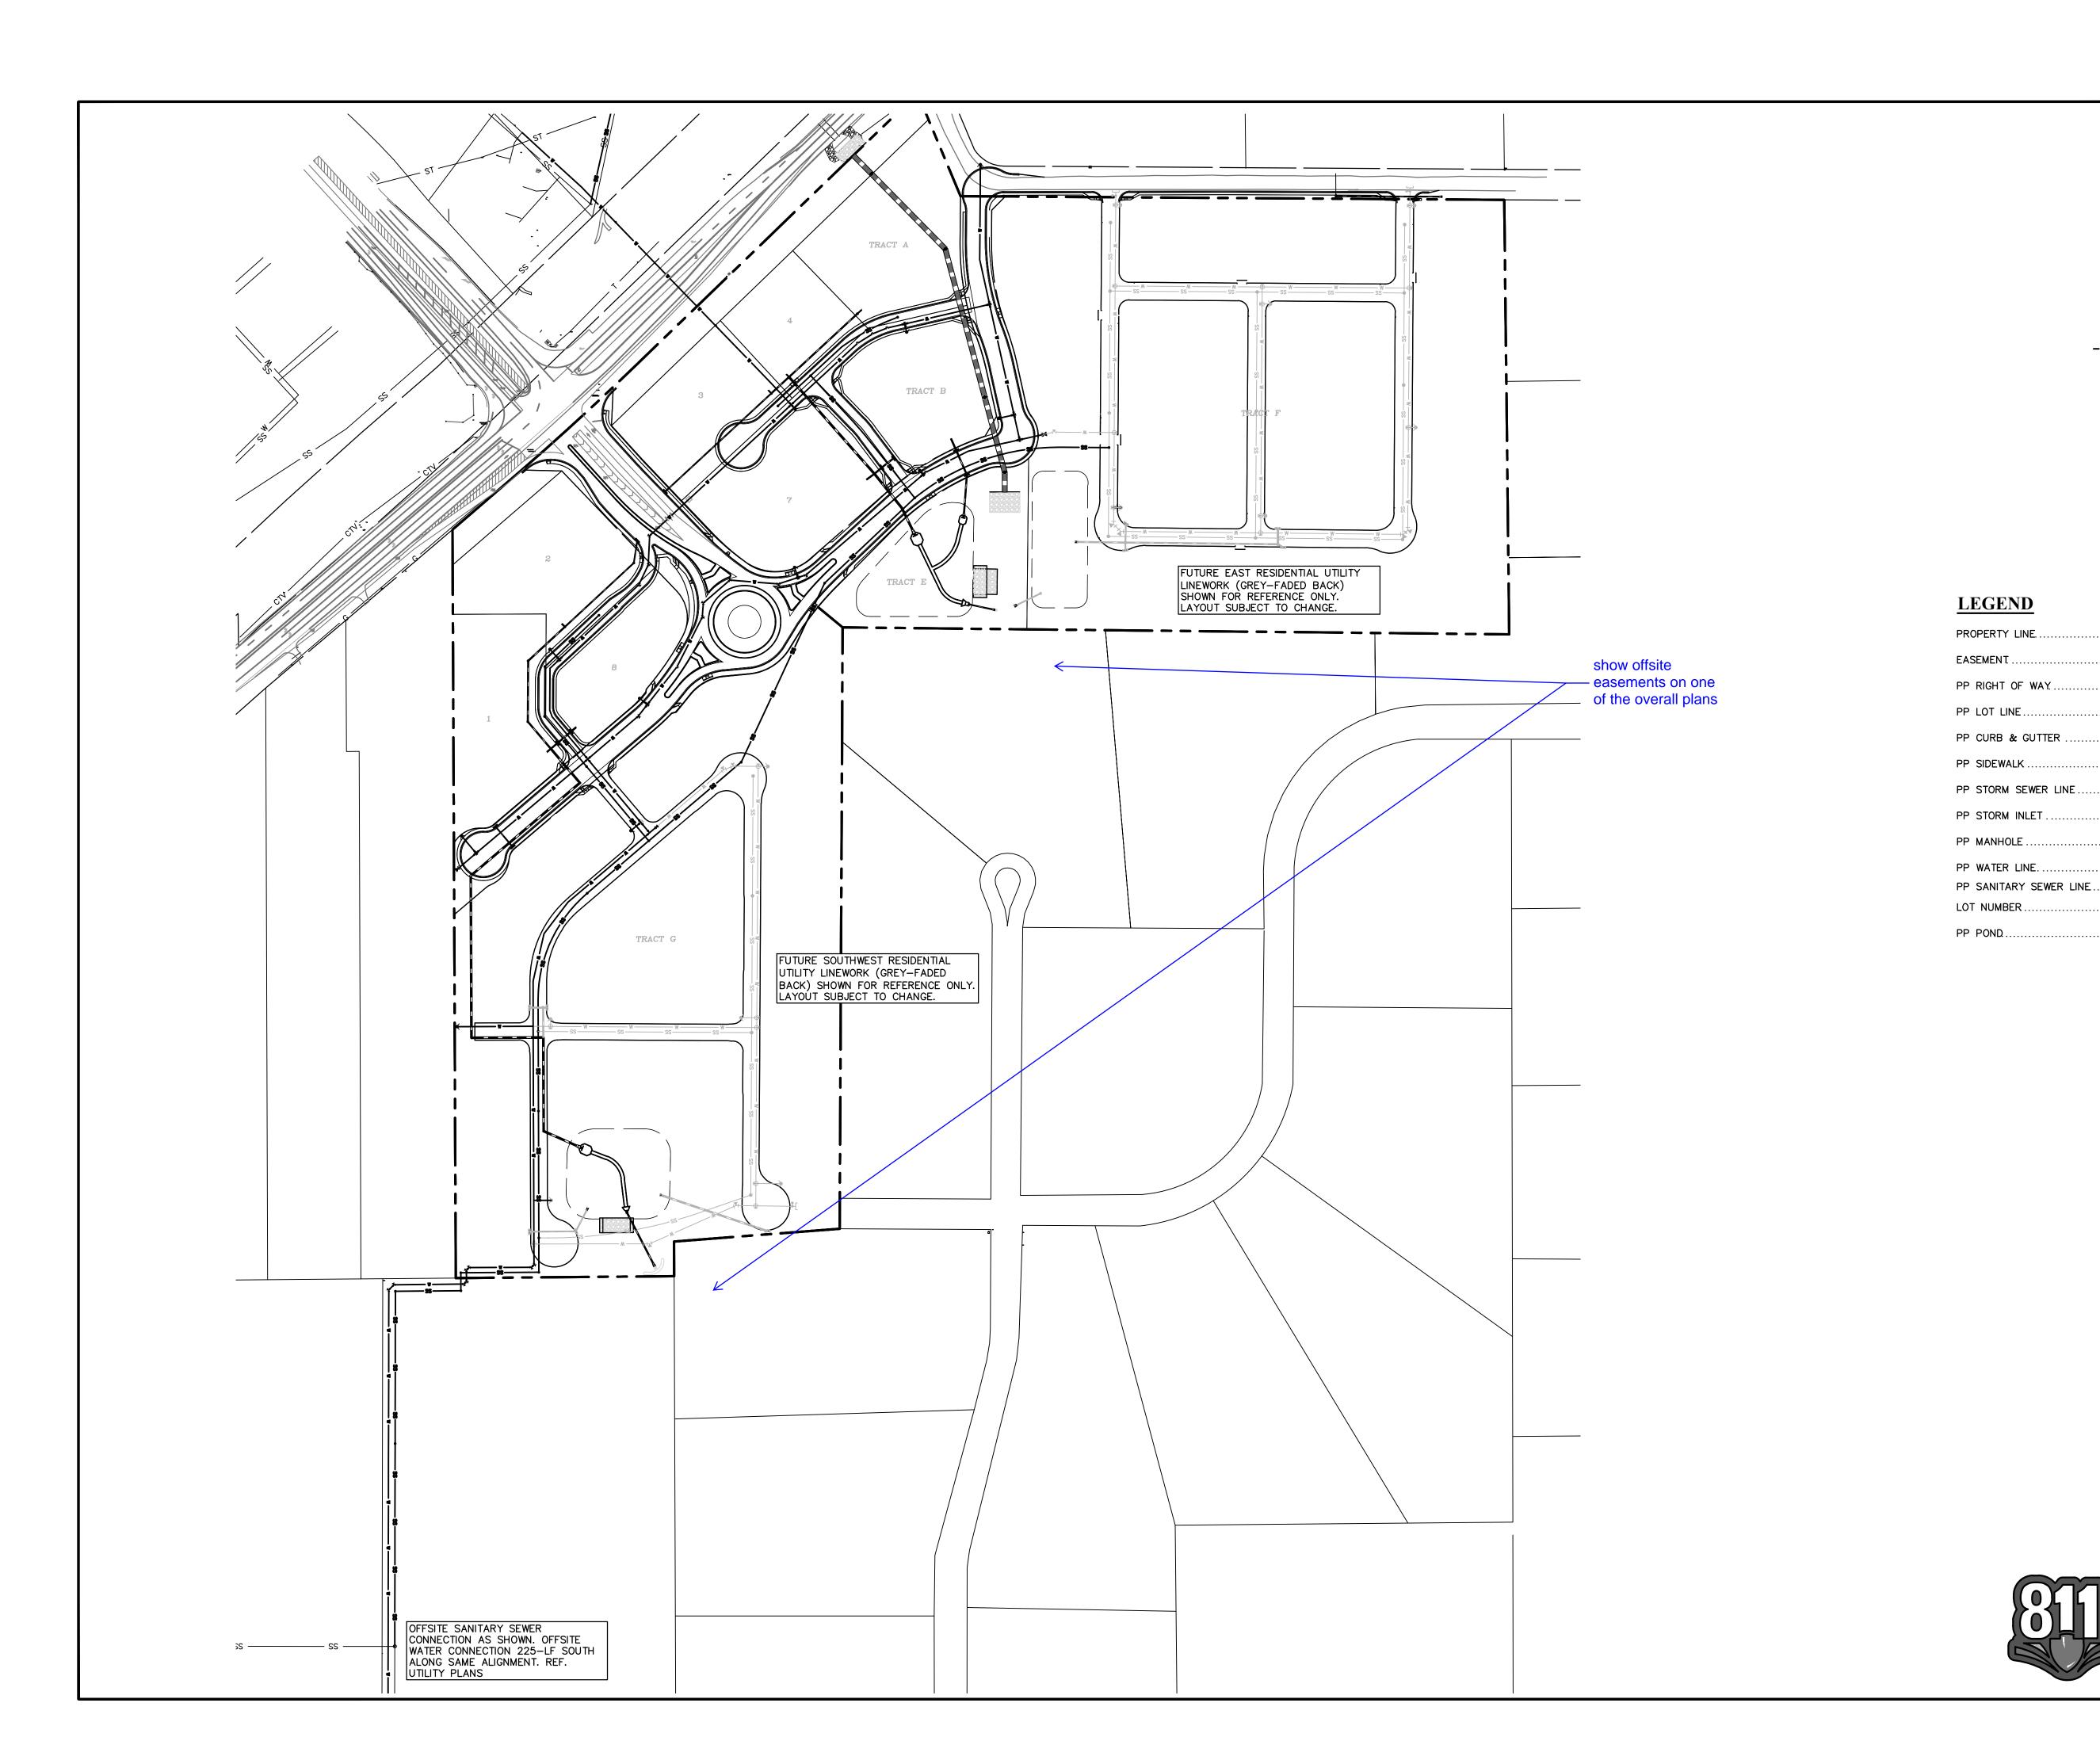

PREPARED BY:

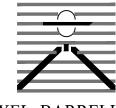

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THE COMMONS AT FALCON FIELD
12445 RIO LANE, AND VACANT LAND
DEVION EL DASO COLONEY COLORADO

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Know what's **below. Call** before you dig.

CALL 2-BUSINESS DAYS IN ADVANCE BEFORE YOU DIG, GRADE, OR EXCAVATE FOR THE MARKING OF UNDERGROUND MEMBER UTILITIES.

DATE
12/16/24
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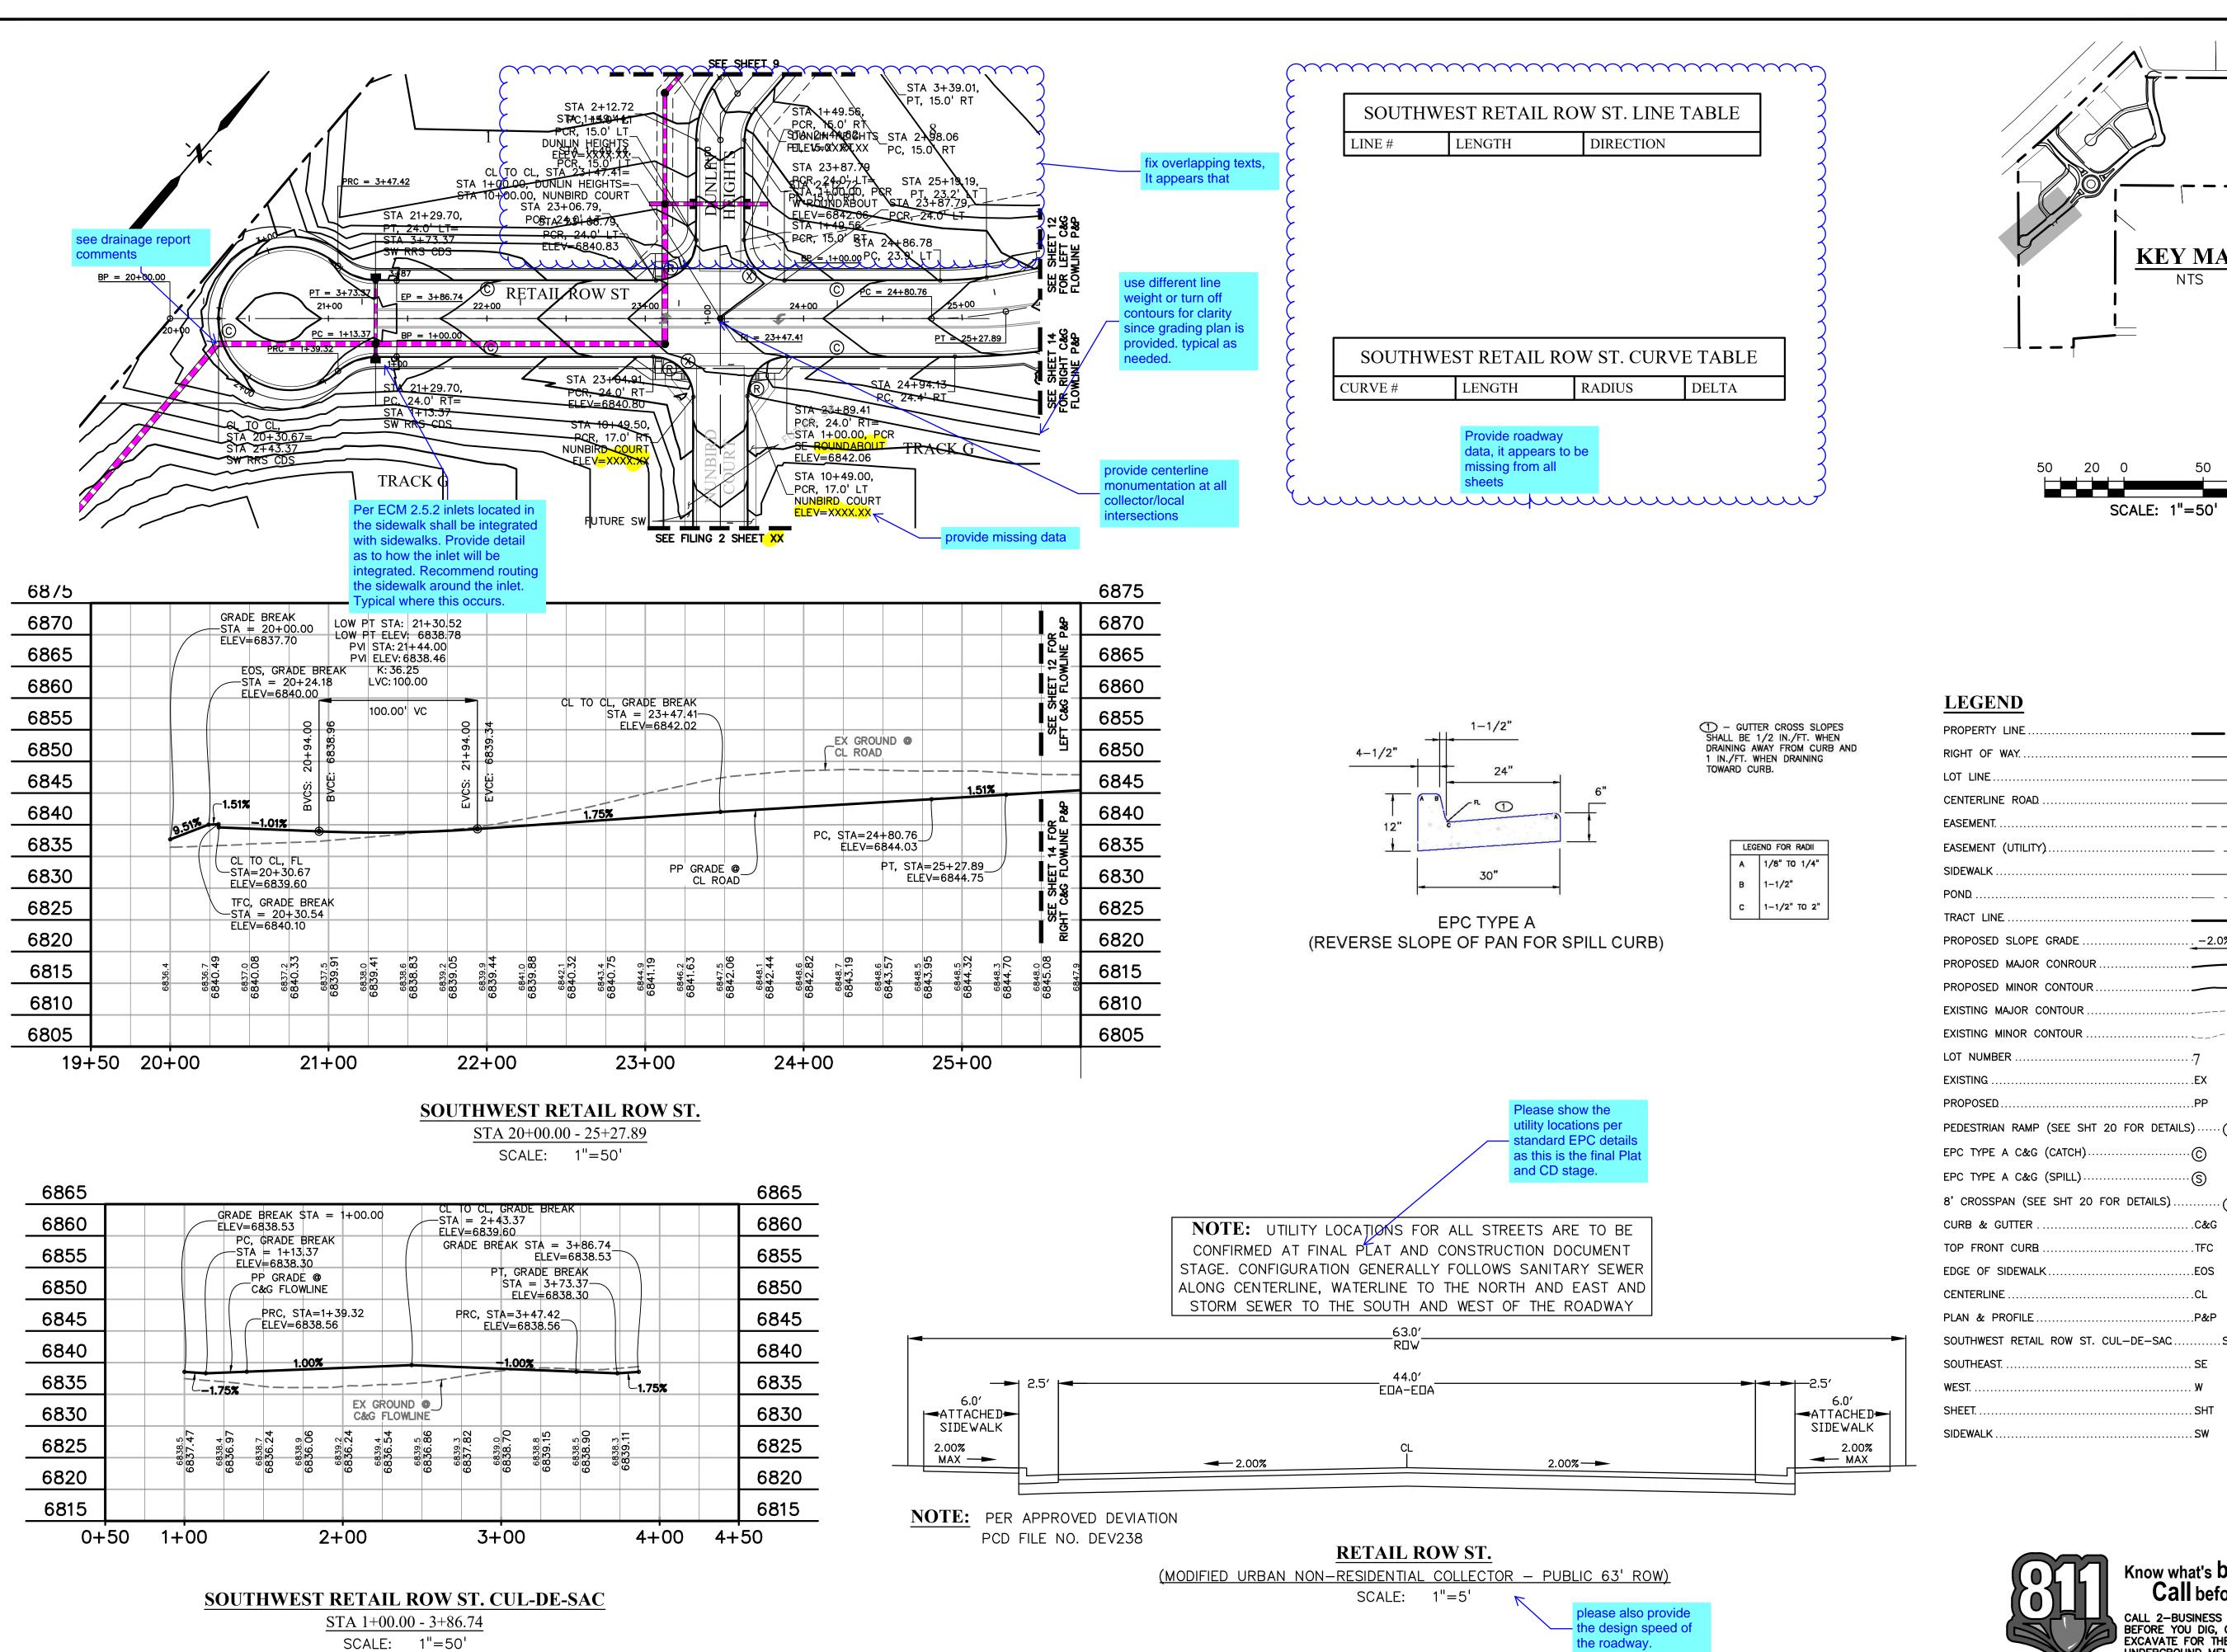
DRAWING SCALE:
HORIZONTAL: 1" = 150'
VERTICAL: N/A

OVERALL UTILITY PLAN


PROJECT NO. 21604-00CSCV
DRAWING NO.



SHEET: 5 OF 29



KEY MAP

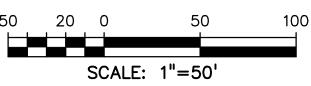

. — — — — — — _ -2.0% **____** 6205**___** _____ 6203_____ -- *6205* -------*6203----*PEDESTRIAN RAMP (SEE SHT 20 FOR DETAILS)...... ..SW RRS CDS



PREPARED BY: DREXEL, BARRELL & CC

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CLIENT:

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FIELD (N S THE

ISSUE	DATE
INITIAL ISSUE	12/16/24
DECIONED DV	14014
DESIGNED BY:	KGV
DRAWN BY:	SDM
CHECKED BY:	TDM
FILE NAME: C	OMM RD
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SUPERVISION FOR AND ON BEHALF OF DREXEL, BARRELL & CO.


DRAWING SCALE: HORIZONTAL: 1" = 50"VERTICAL: 1'' = 12.5'

SW RETAIL ROW ST. & CUL-DE-SAC


PLAN & PROFILE

PROJECT NO. 21604-00CSCV DRAWING NO.

SHEET: 6 OF 29

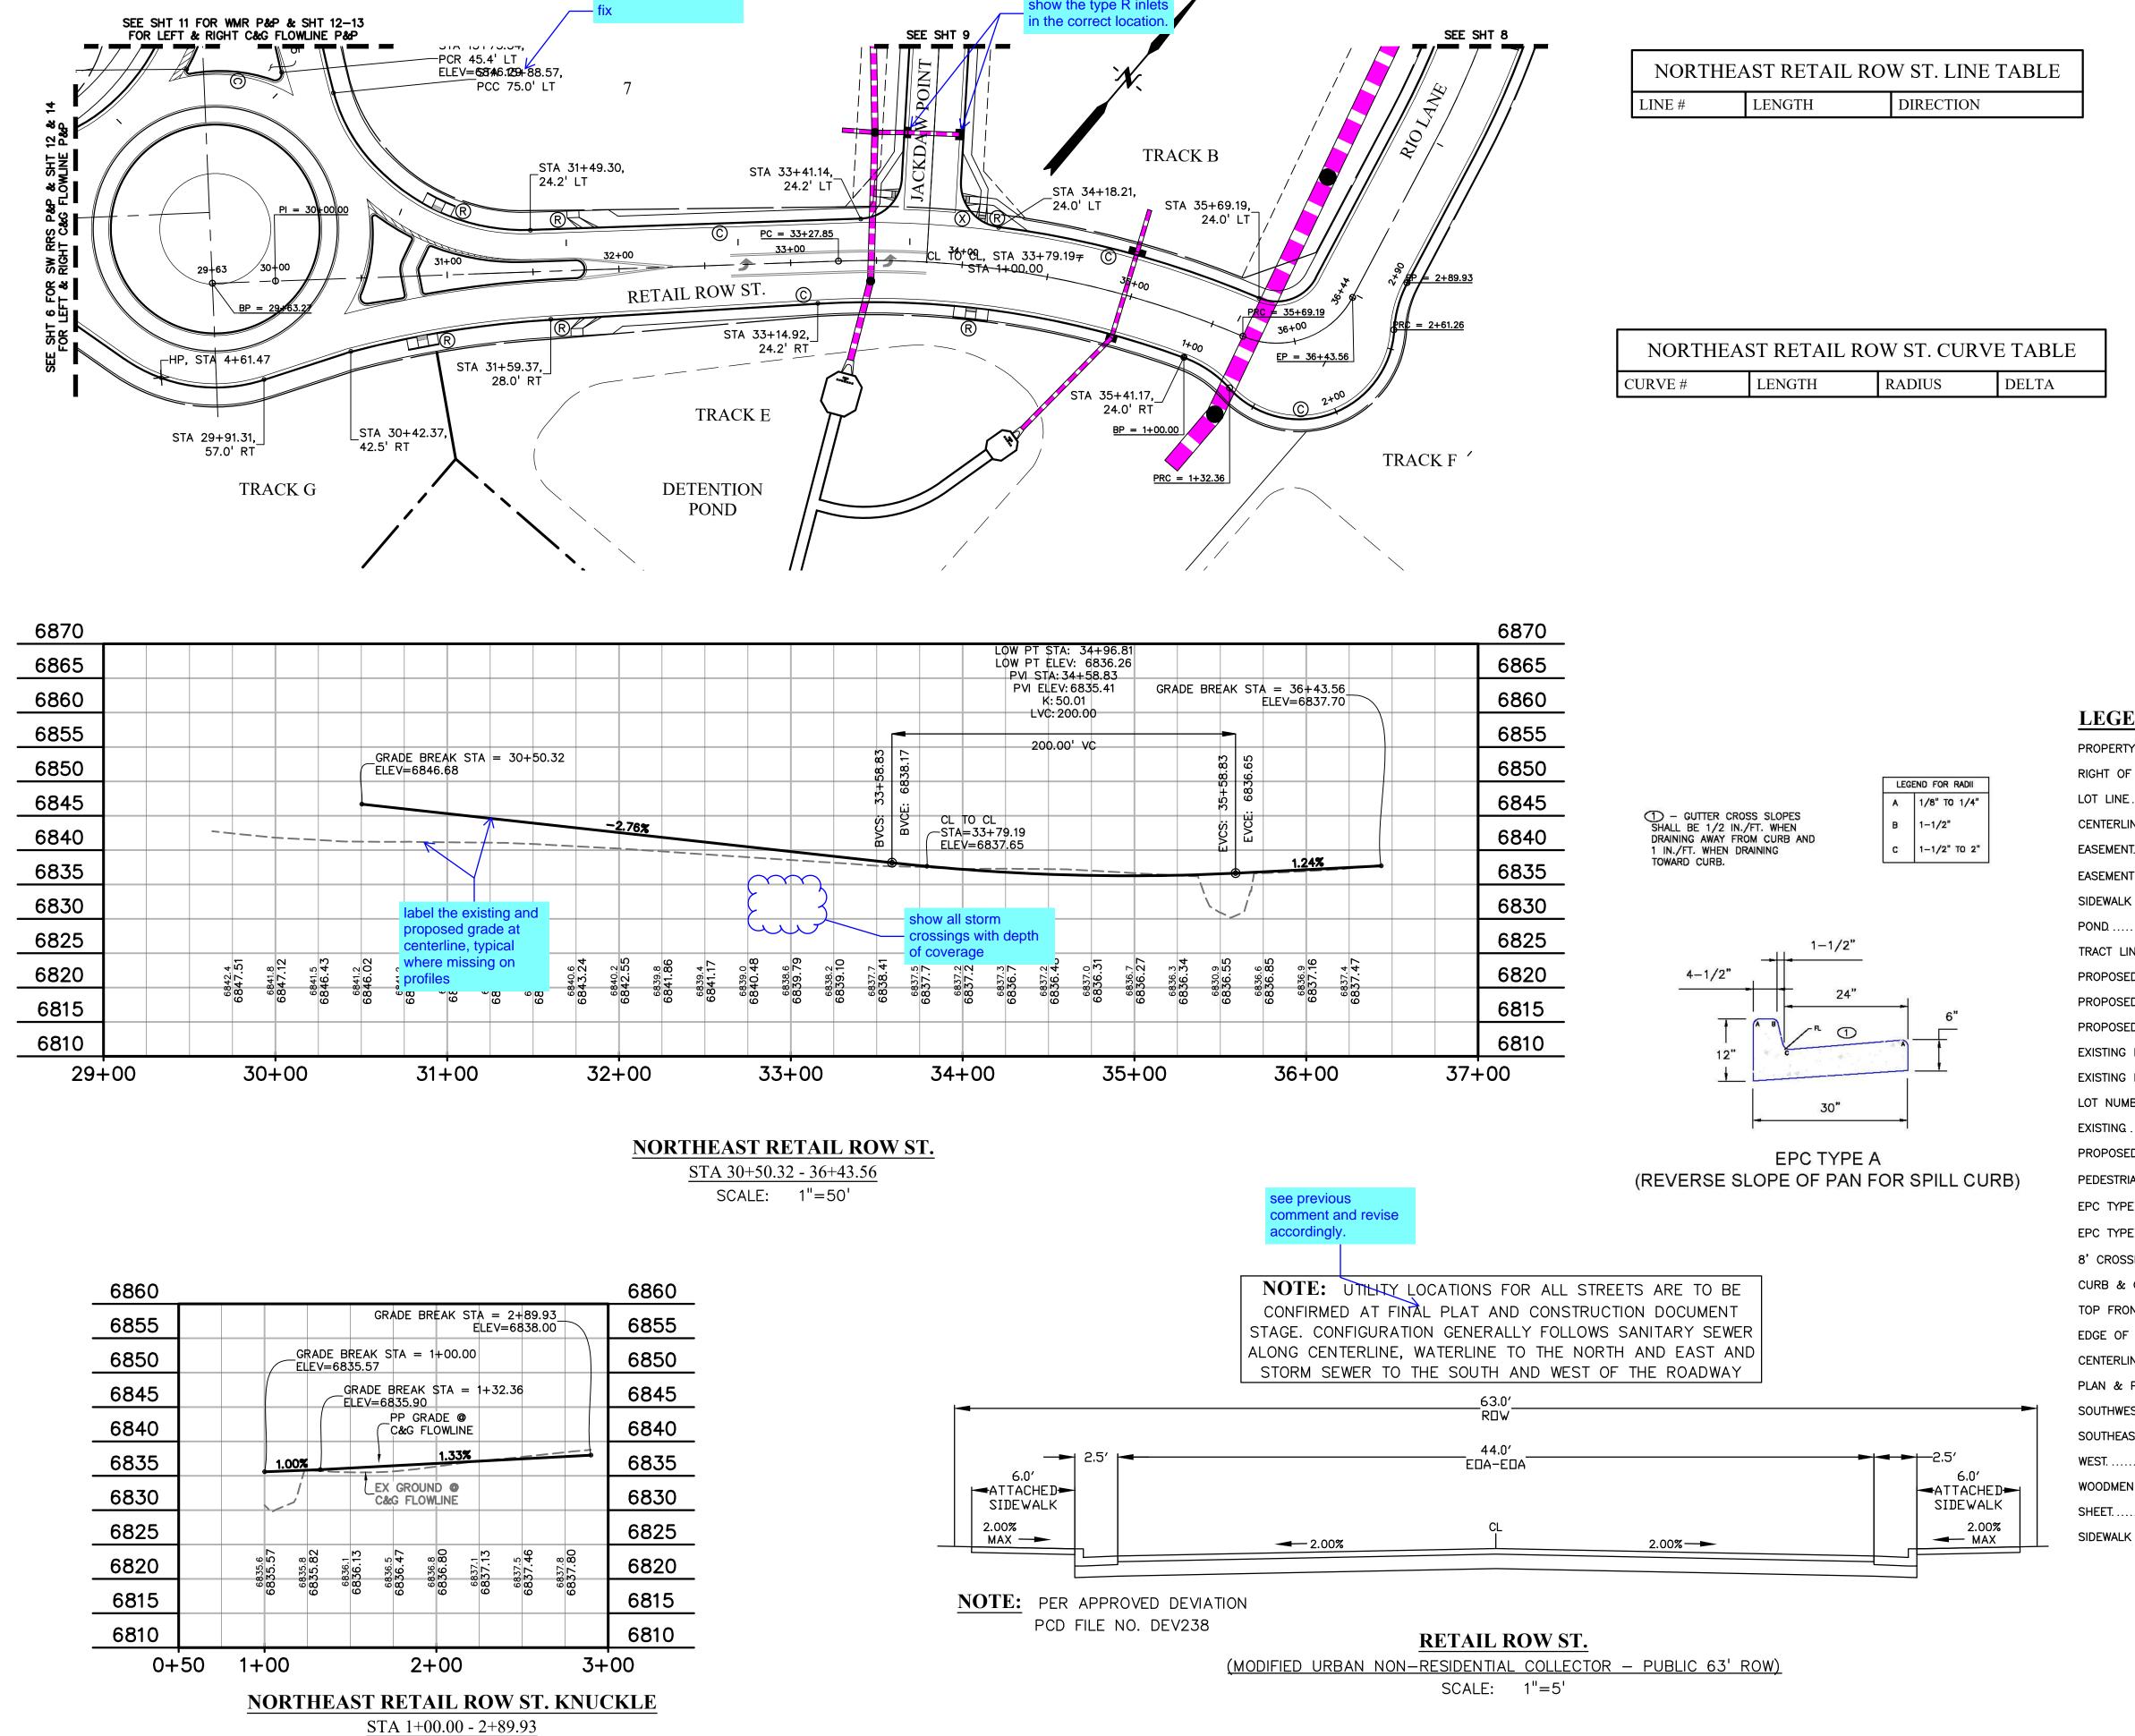

SCALE: 1"=50'

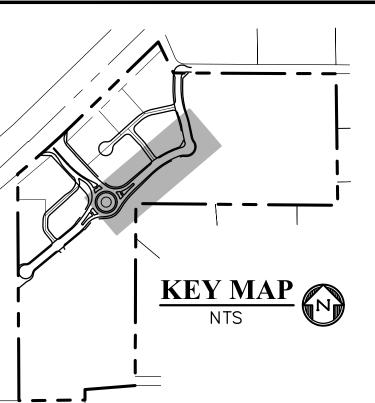

SCALE: 1"=50'

. — — — — — —

LEGEND

PROPERTY LINE RIGHT OF WAY. LOT LINE. CENTERLINE ROAD. EASEMENT. EASEMENT (UTILITY)

SIDEWALK TRACT LINE _ -2.0% PROPOSED SLOPE GRADE PROPOSED MAJOR CONROUR **____** 6205**___** PROPOSED MINOR CONTOUR. EXISTING MAJOR CONTOUR -- *6205* ----EXISTING MINOR CONTOUR _--6203----LOT NUMBER **EXISTING** PROPOSED. PEDESTRIAN RAMP (SEE SHT 20 FOR DETAILS)...... EPC TYPE A C&G (CATCH) EPC TYPE A C&G (SPILL). 8' CROSSPAN (SEE SHT 20 FOR DETAILS). CURB & GUTTER .C&G TOP FRONT CURB .EOS EDGE OF SIDEWALK CENTERLINE PLAN & PROFILE. SOUTHWEST RETAIL ROW ST. CUL-DE-SAC. ..SW RRS CDS SOUTHEAST. WOODMEN ROAD.



PREPARED BY:

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CLIENT:

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FIELD THE

ISSUE	DATE						
INITIAL ISSUE	12/16/24						
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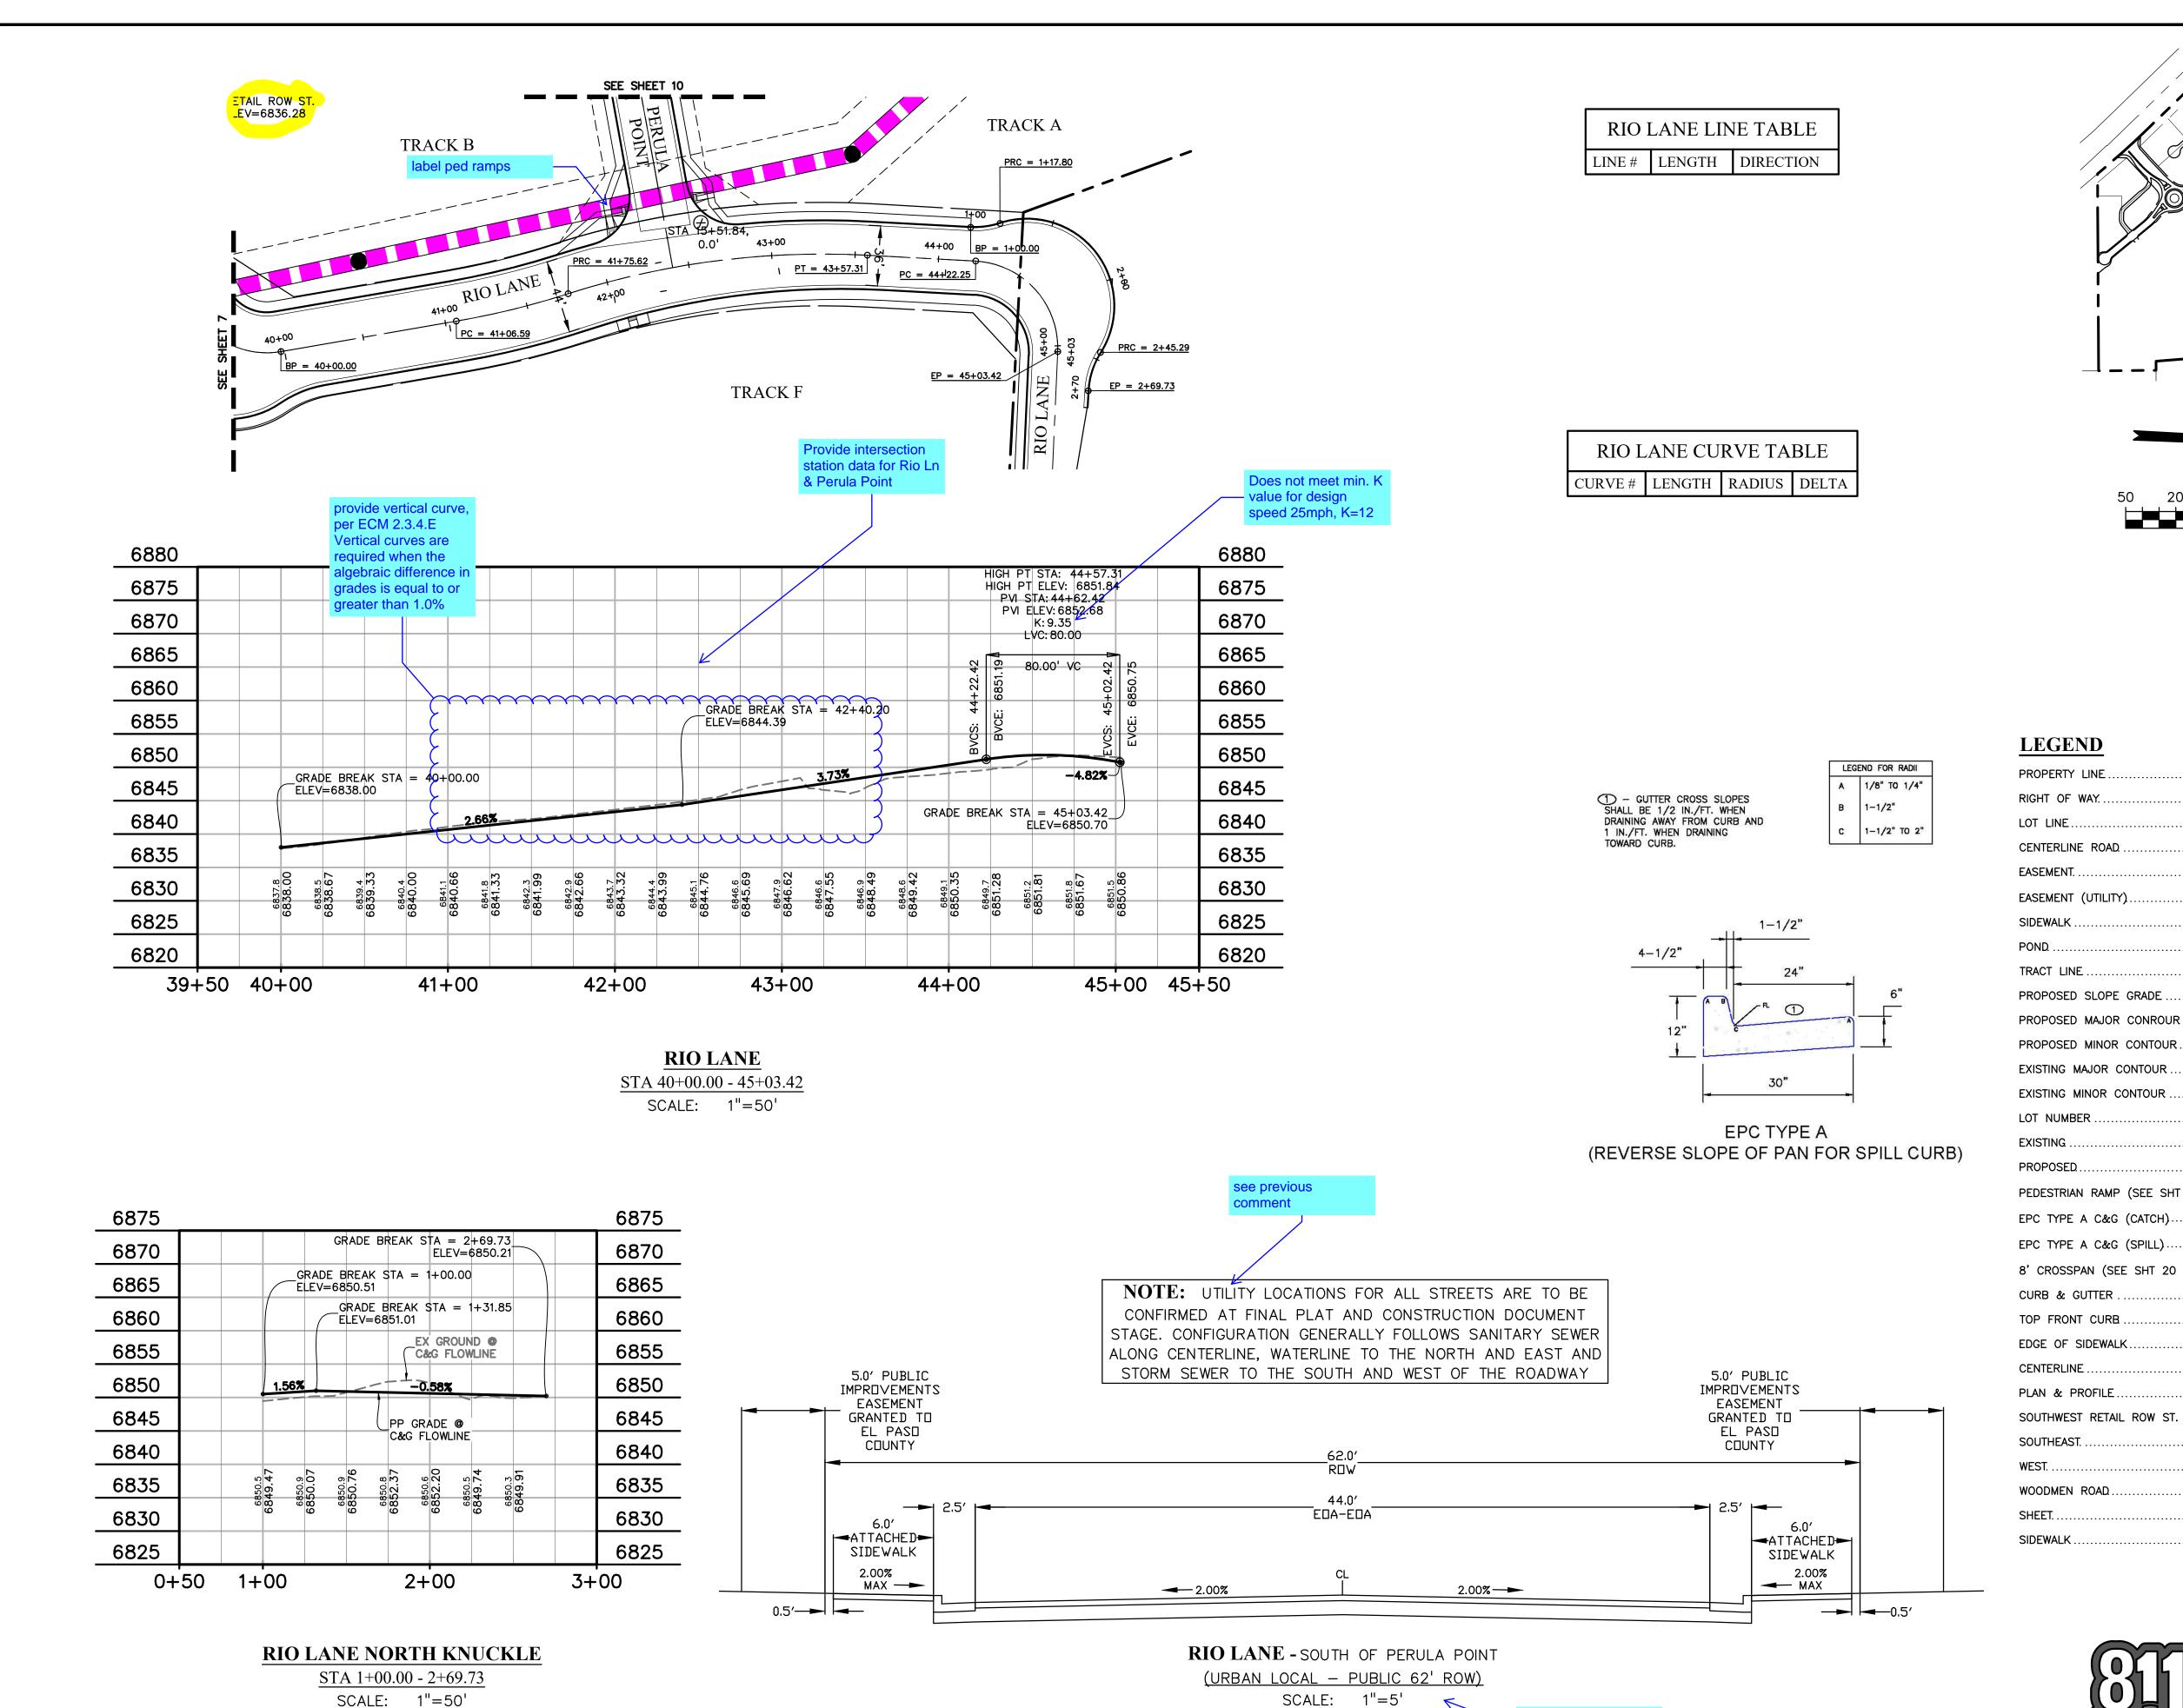
SUPERVISION FOR AND ON BEHALF OF DREXEL, BARRELL & CO.

DRAWING SCALE: HORIZONTAL: 1" = 50"VERTICAL: 1'' = 12.5'


NE RETAIL ROW ST. & KNUCKLE PLAN & PROFILE

PROJECT NO. 21604-00CSCV DRAWING NO.

SHEET: 7 OF 29



provide design speed

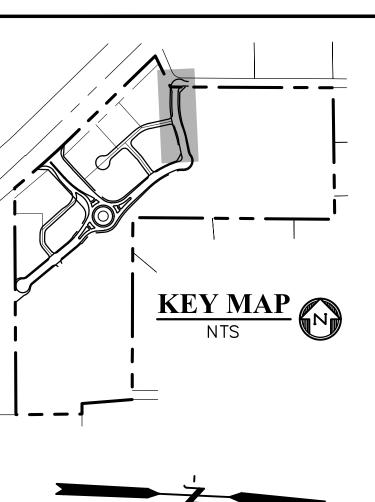

SCALE: 1"=50'

RIGHT OF WAY	
LOT LINE	
CENTERLINE ROAD	— — —
EASEMENT.	
EASEMENT (UTILITY)	— — —
SIDEWALK	
POND	— — —
TRACT LINE	
PROPOSED SLOPE GRADE	2.0%
PROPOSED MAJOR CONROUR	6205——
PROPOSED MINOR CONTOUR	6203
EXISTING MAJOR CONTOUR	6205
EXISTING MINOR CONTOUR	6203
LOT NUMBER	·····7
EXISTING	EX
PROPOSED	PP
PEDESTRIAN RAMP (SEE SHT 20 FOR DET	AILS) (R)
EPC TYPE A C&G (CATCH)	·····©
EPC TYPE A C&G (SPILL)	·····§
8' CROSSPAN (SEE SHT 20 FOR DETAILS)	ı(X)
CURB & GUTTER	C&G
TOP FRONT CURB	TFC
EDGE OF SIDEWALK	EOS
CENTERLINE	CL
PLAN & PROFILE	P&P
SOUTHWEST RETAIL ROW ST. CUL-DE-SAC	SW RRS CDS
SOUTHEAST.	SE
WEST	W



PREPARED BY:

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THE COMMONS AT FALCON FIELD

12445 RIO LANE, AND VACANT LAND

ISSUE	DATE
INITIAL ISSUE	12/16/24
DESIGNED BY:	KGV
DRAWN BY:	SDM
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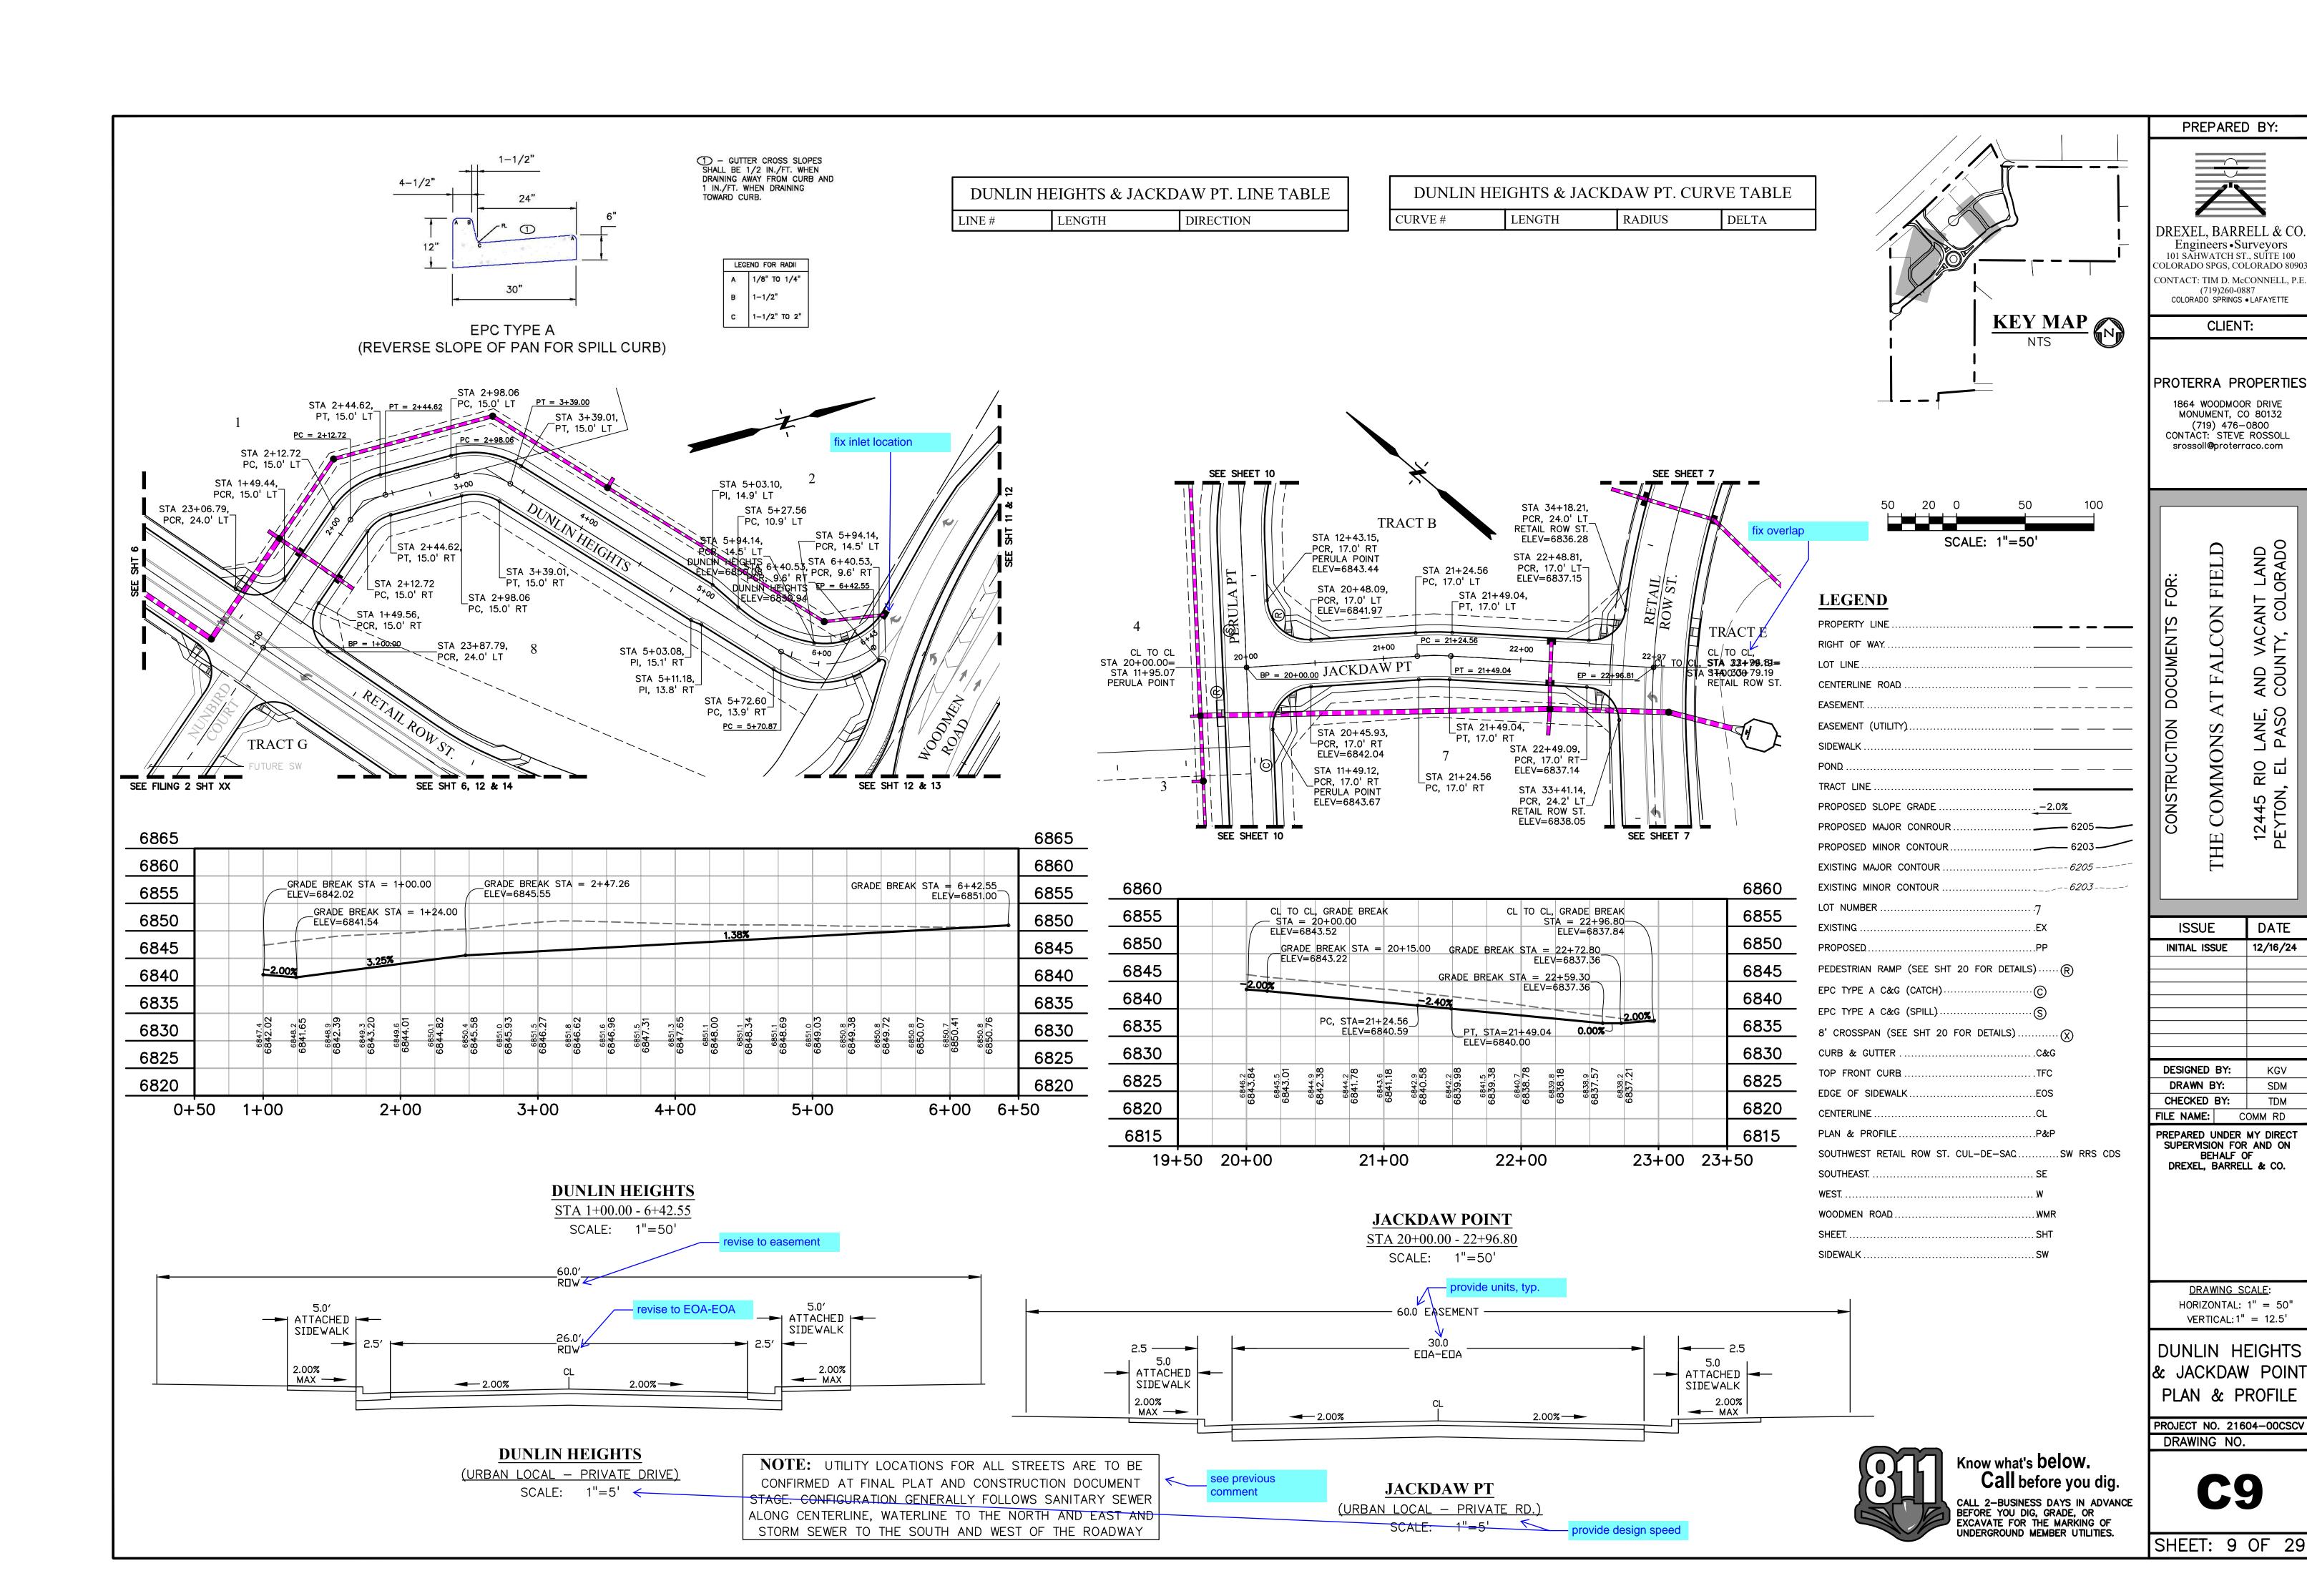
DRAWING SCALE:
HORIZONTAL: 1" = 50"
VERTICAL: 1" = 12.5'


RIO LANE & NORTH KNUCKLE PLAN & PROFILE

PROJECT NO. 21604-00CSCV DRAWING NO.

C8

SHEET: 8 OF 29



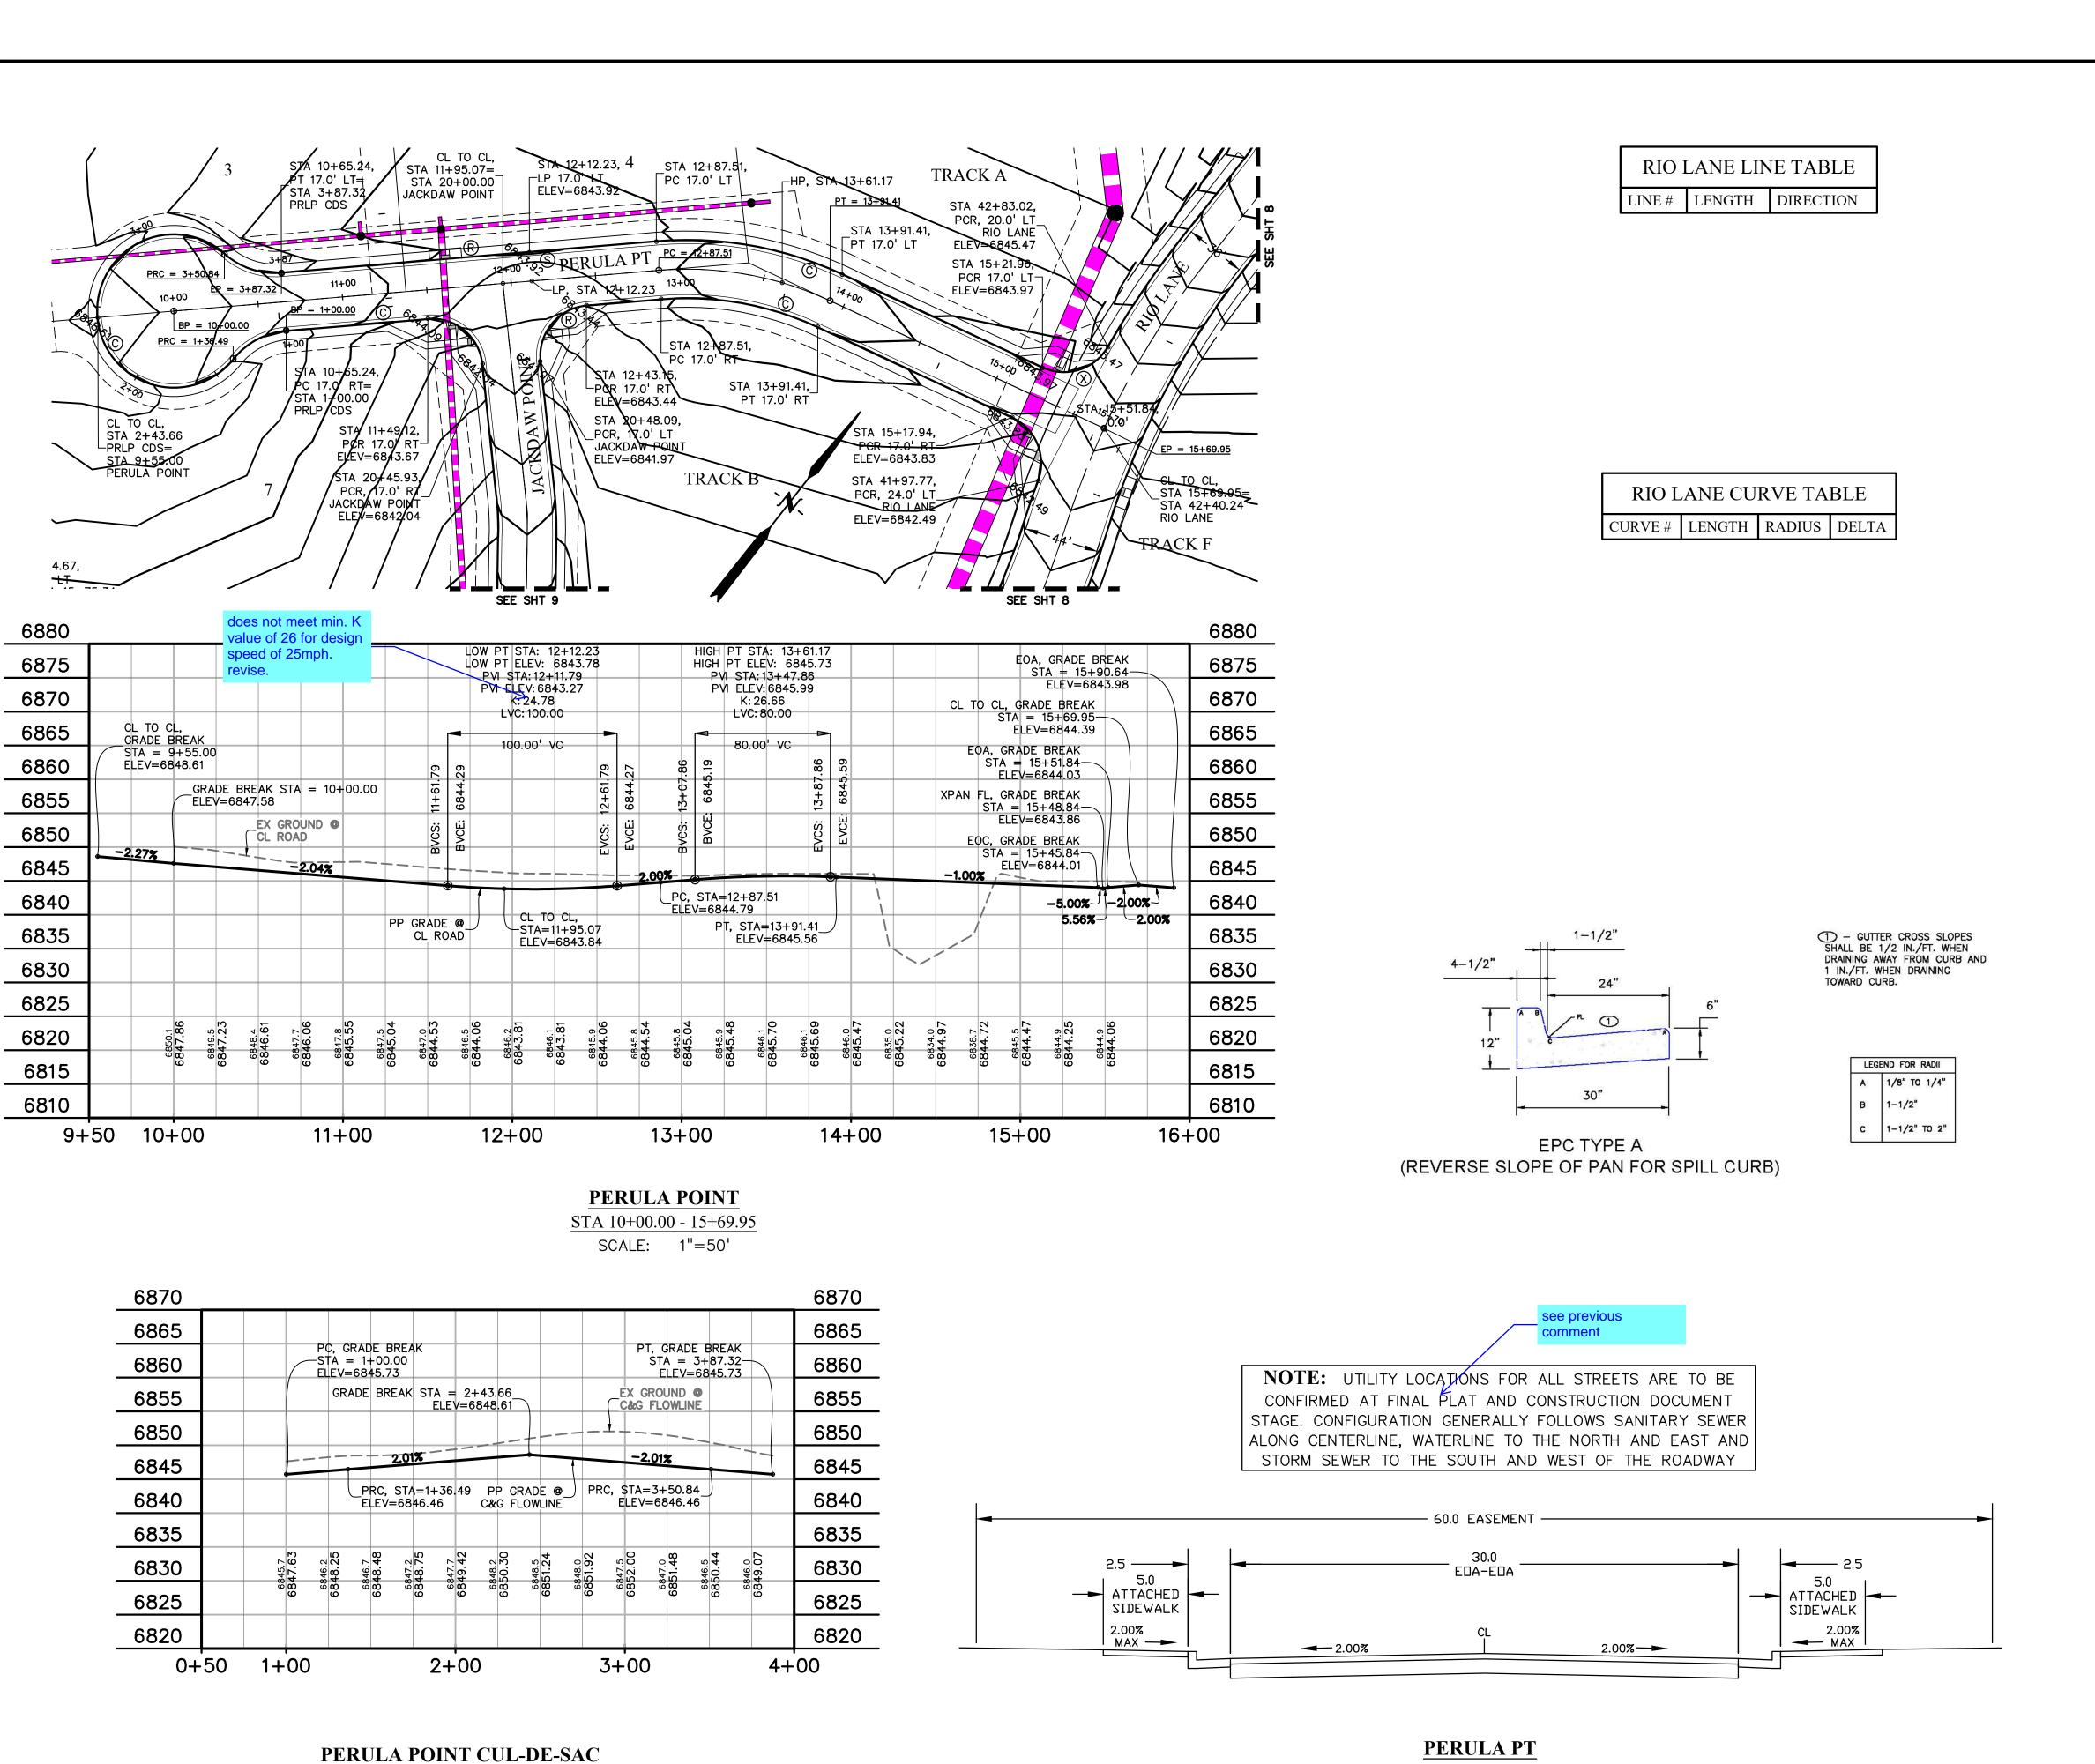

KEY MAP



STA 1+00.00 - 3+87.32

SCALE: 1"=50'

(URBAN LOCAL — PRIVATE RD.) SCALE: 1"=5' provide design speed



PREPARED BY: DREXEL, BARRELL & CC Engineers • Surveyors 101 SAHWATCH ST., SUITE 100

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CLIENT:

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FIELD **USTRUCTION** THE COMMONS 2 CON

ISSUE	DATE
INITIAL ISSUE	12/16/24
DESIGNED BY:	KGV
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CHECKED BY:	: TDM
FILE NAME:	COMM RD

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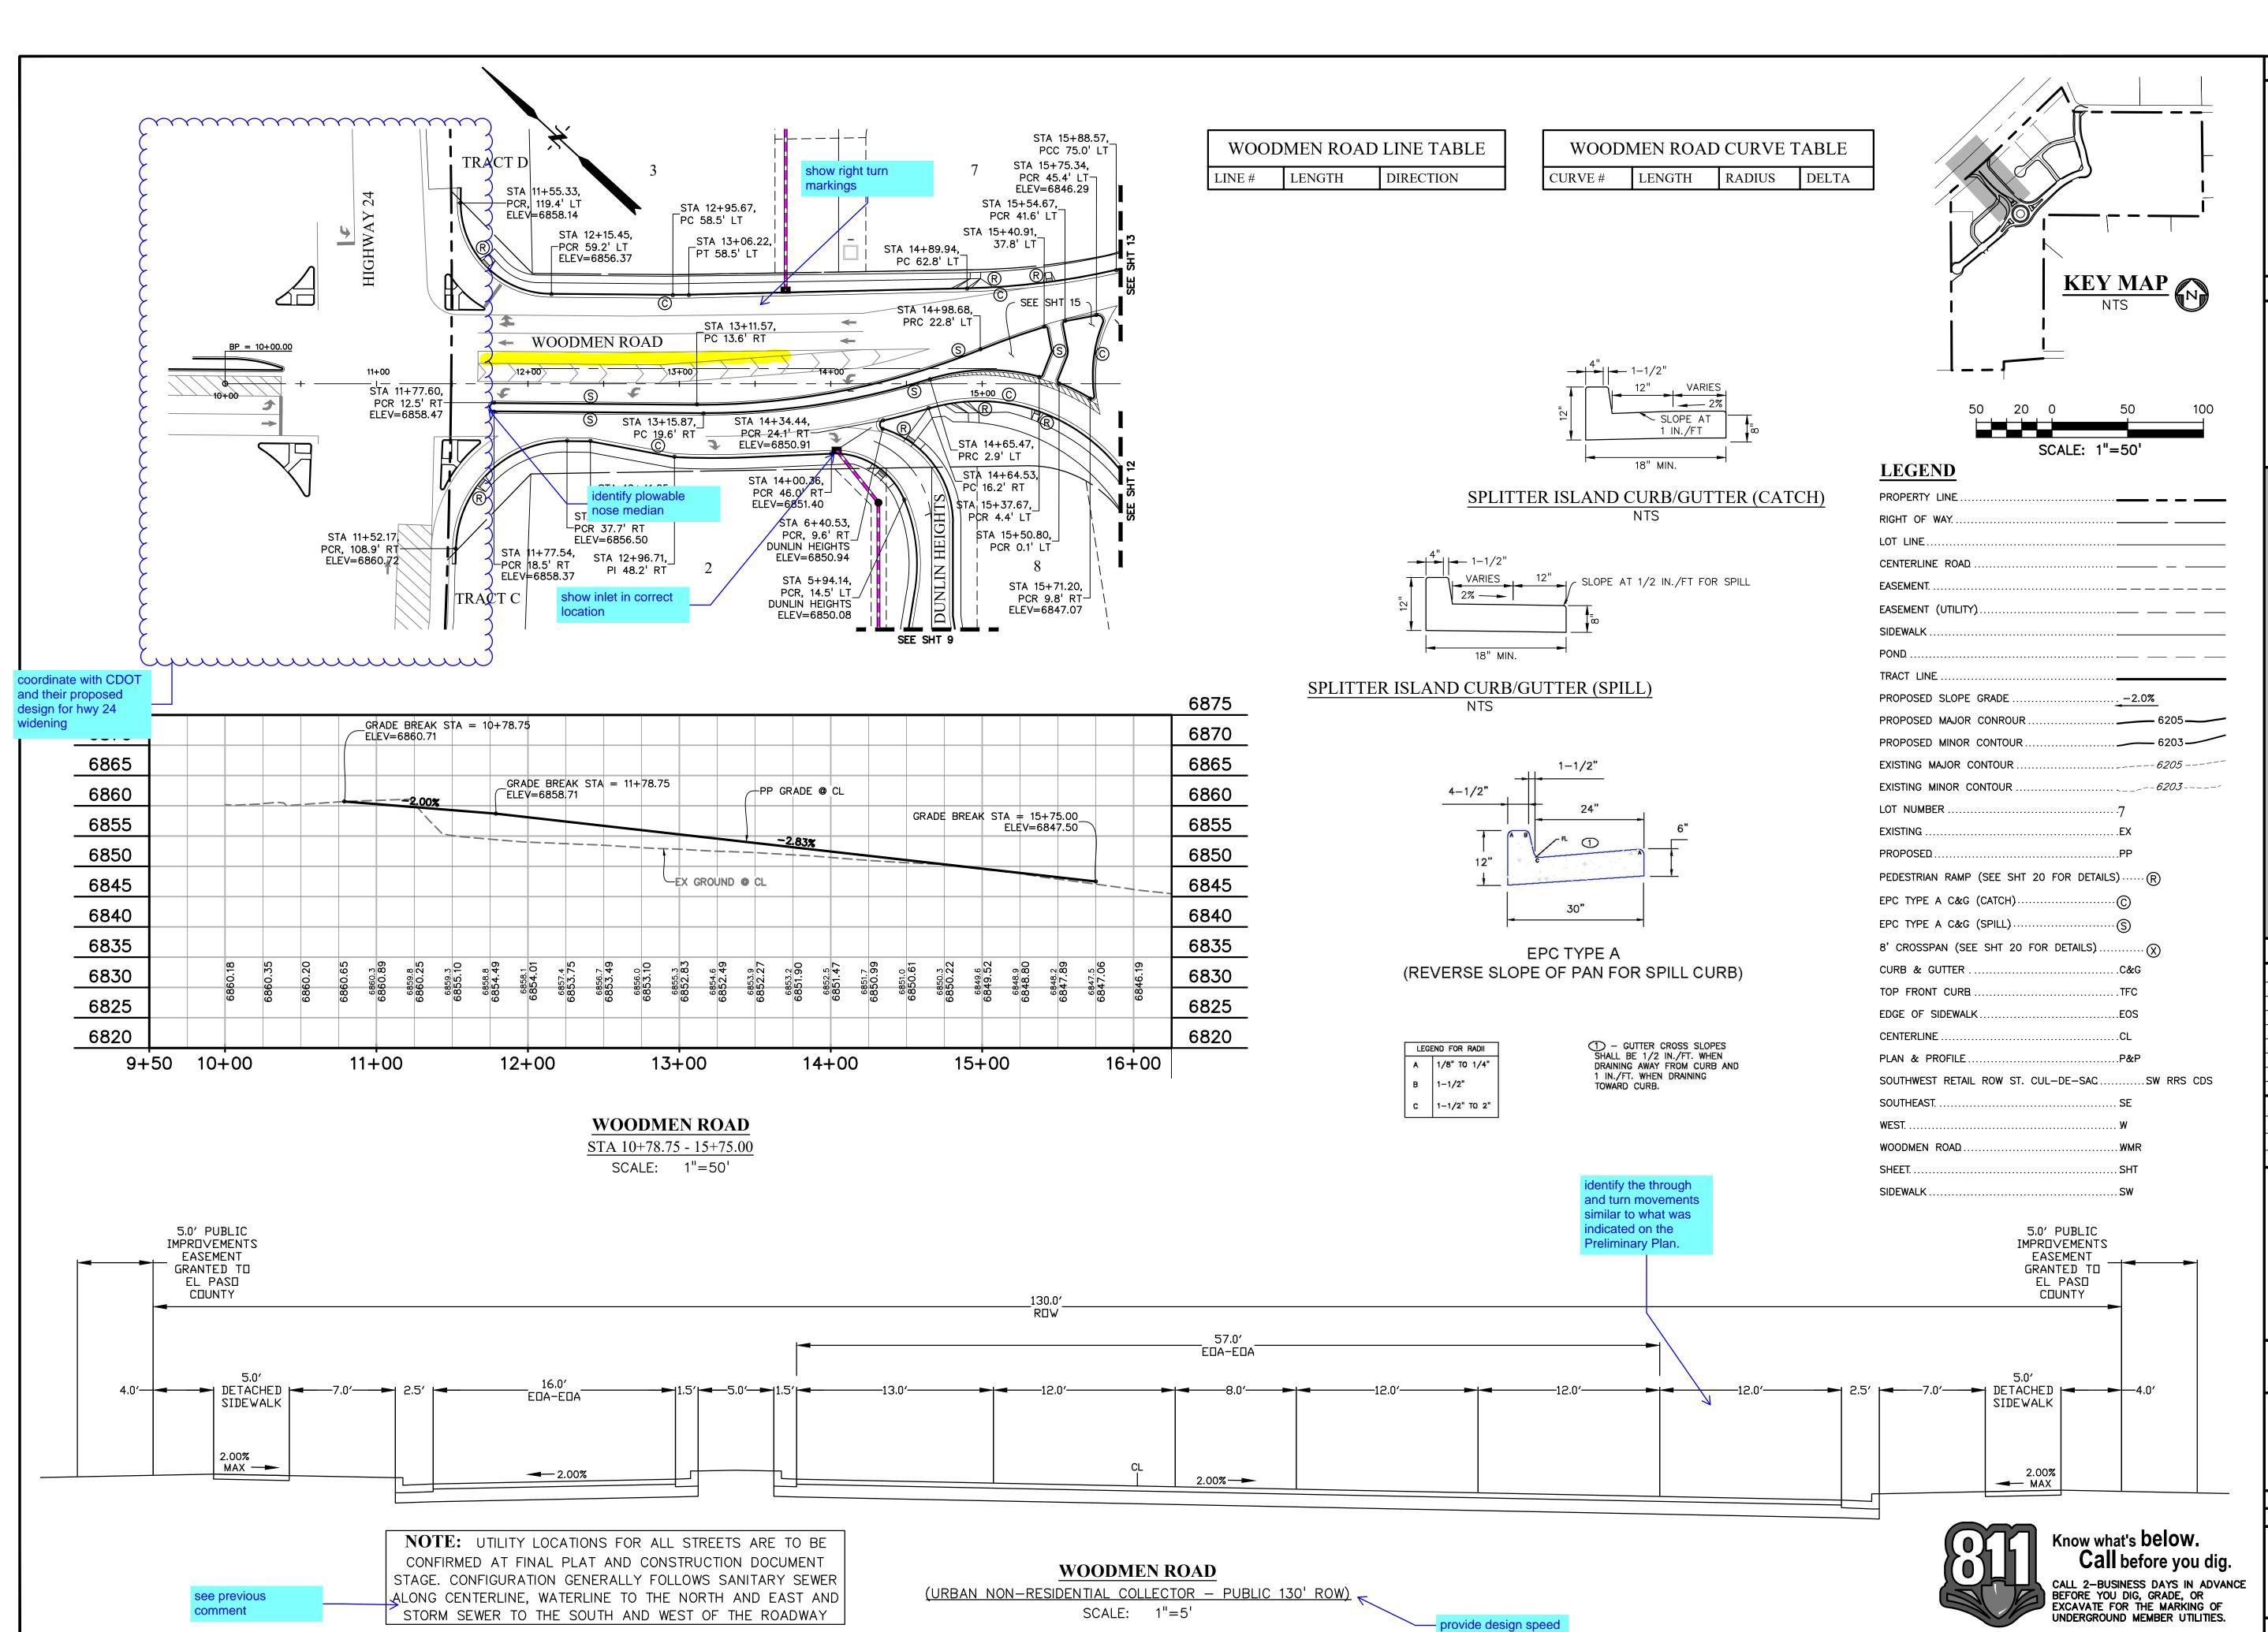
DRAWING SCALE: HORIZONTAL: 1" = 50"VERTICAL: 1'' = 12.5'

PERULA POINT & CUL-DE-SAC PLAN & PROFILE

PROJECT NO. 21604-00CSCV DRAWING NO.

C10

SHEET: 10 OF 29



DREXEL, BARRELL & CO
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COLORADO SPGS, COLORADO 8090

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srossoll@proterraco.com

CLIENT:

THE COMMONS AT FALCON FIELD

12445 RIO LANE, AND VACANT LAND

ISSUE DATE

INITIAL ISSUE 12/16/24

DESIGNED BY: KGV

DRAWN BY: SDM

CHECKED BY: TDM

FILE NAME: COMM RD

PREPARED UNDER MY DIRECT SUPERVISION FOR AND ON BEHALF OF DREXEL, BARRELL & CO.

DRAWING SCALE:

HORIZONTAL: 1" = 50"


VERTICAL: 1" = 12.5'

WOODMEN ROAD PLAN & PROFILE

PROJECT NO. 21604-00CSCV DRAWING NO.


C11

SHEET: 11 OF 29

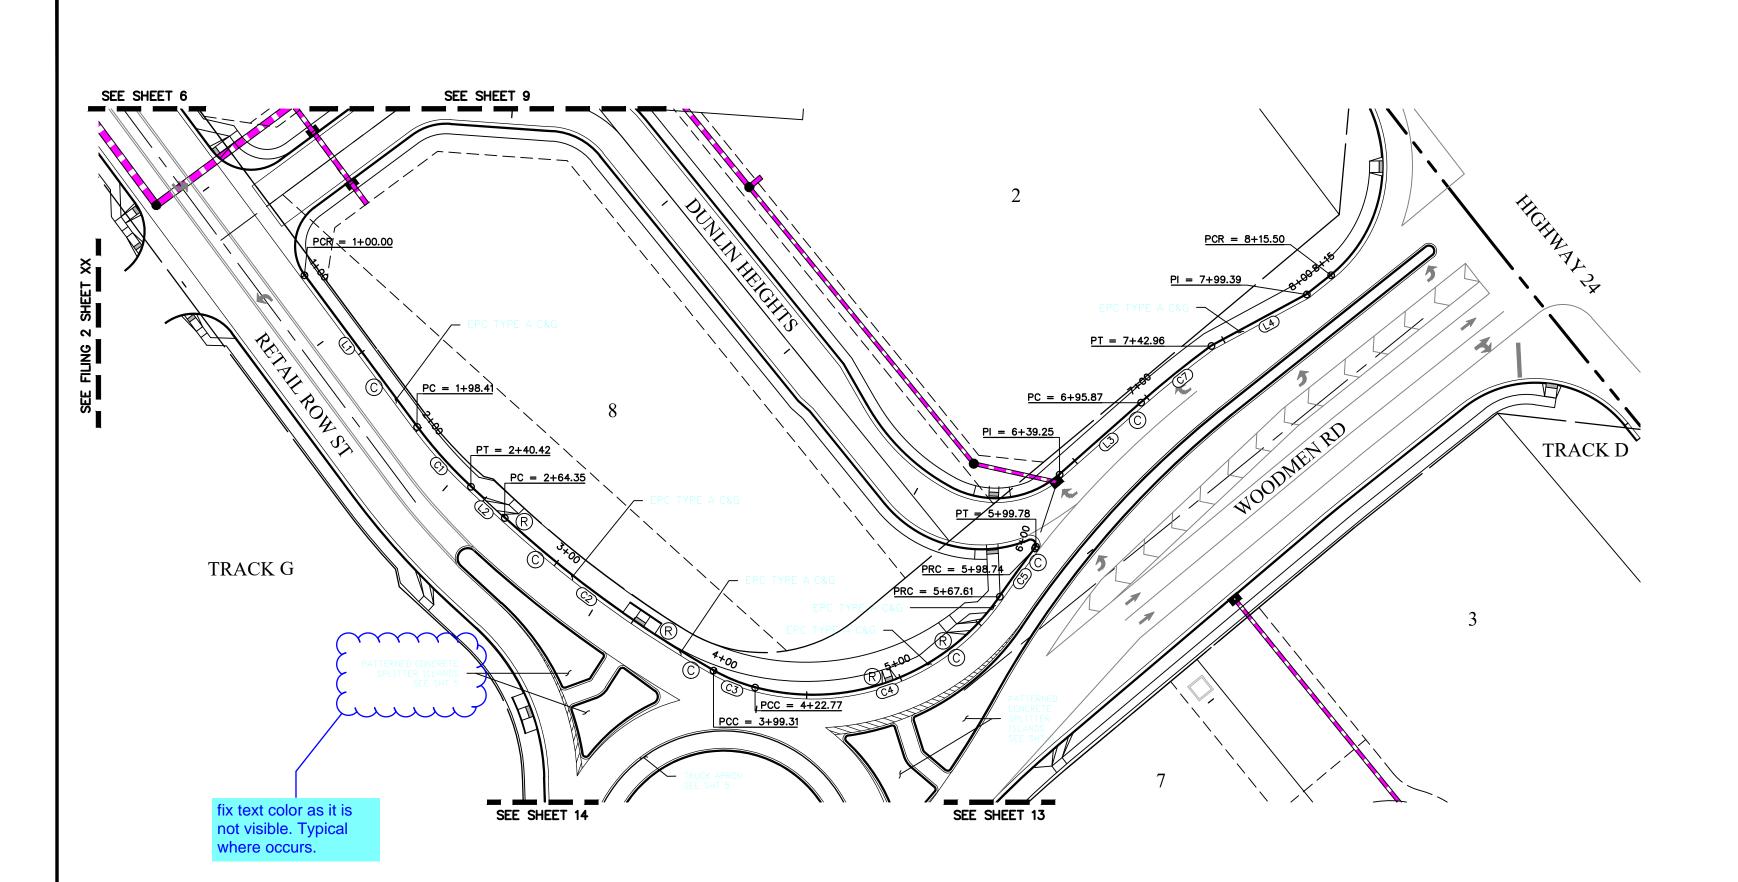


WEST ROUNDABOUT C&G LINE TABLE							
	LINE #	LENGTH	DIRECTION				

WEST RO	UNDABOUT (C&G CURVE	TABLE
CURVE#	LENGTH	RADIUS	DELTA

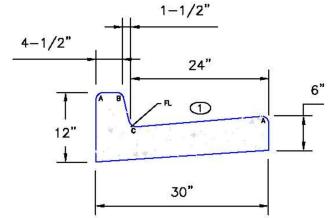


EPC TYPE A (REVERSE SLOPE OF PAN FOR SPILL CURB)

6885																		688
6880				35				22.77										688
6875	00.00			2+64.				+ + + + + + + + + + + + + + + + + + + +										687
6870	+ +							STA :				P-	r, GRADE BREAI	<pre>STA = 7+ ELEV=68</pre>	42.96_ 54.28			687
6865	STA			AK STA				BREAK 70			PC,	GRADE BRE	EAK STA = 6+9 ELEV=68	95.87 52.95				686
6860	BREAK			E BREAK				GRADE B		PI, GR	ADE BREAK	STA = 6+3 ELEV=685	39.25_ 51.40					686
6855	GRADE BREAK 6842.06			GRADE V=6844.				C, GR/	PRC, GRAI	DE BREAK	STA = 5+ ELEV=68					3.15%	2.88%	685
6850	PCR, GR			PC,	EX C&	GROUND @		PCC,					1.03% 2.	73%	<u>2.82%</u>			685
6845	2 = -					1.36	3%			X			PT, STA=5+99.7 ELEV=6850.99	78	ST	GRADE BREA A = 7+99.3 ELEV=6856.0	9—/	684
6840	•		1.51%			PP GRADE	E @	PRO	C, GRADE BREAK		5+67.61 :6850.19					R, GRADE BR		684
6835		PC, STA=1 ELEV=68			A=2+40.4 8844.18	PCC, E	STA=3+99.31 LEV=6846.38)								STA = 8+15 ELEV=6856	5.50 3.52	683
6830																		683
6825																		682
6820	6849.1 6842.06	6842.44 6842.44 6849.2 6842.81	6843.19 6843.19 6843.57	6848.9 6843.94 6848.6 6844.32	6848.4 6848.4	6848.3 6845.37	6845.71 6845.71 6846.05 6846.05	6846.39 6847.8 6846.75	6847.36 6847.36 6848.3 6847.96	6848.56 6849.4 6849.16	6849.77	6850.5 6850.36 6850.8 6850.8	6851.3 6851.26 6851.8 6851.8	6852.1 6852.38 6852.4 6852.4	6852.6 6853.77	6852.9 6854.50 6853.2 6853.2	6853.6 6856.07	682
6815	39 789	89 89 89	789 789	89 89 89 89 89	89	89 89 89	89 88 89 89	6847. 6847.	89 89	684 888	989	68 88 886	988 988 988	988	686	685 685 685	68 85	681
6810																		681

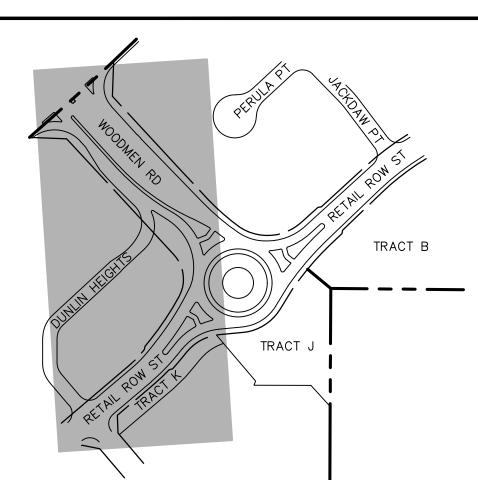



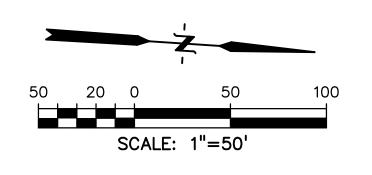

LEGEND

1) - GUTTER CROSS SLOPES
SHALL BE 1/2 IN./FT. WHEN
DRAINING AWAY FROM CURB AND
1 IN./FT. WHEN DRAINING
TOWARD CURB.


LEGEND FOR RADII

A 1/8" TO 1/4"

C 1-1/2" TO 2"

B 1-1/2"

PROPERTY LINE	
RIGHT OF WAY.	
LOT LINE	
CENTERLINE ROAD	
EASEMENT	— — — — — — —
EASEMENT (UTILITY)	
SIDEWALK	
POND	— — —
TRACT LINE	
PROPOSED SLOPE GRADE	<u>-2.0%</u>
PROPOSED MAJOR CONROUR	6205——
PROPOSED MINOR CONTOUR	6203
EXISTING MAJOR CONTOUR	6205
EXISTING MINOR CONTOUR	6203
LOT NUMBER	············7
EXISTING	EX
PROPOSED	PP
PEDESTRIAN RAMP (SEE SHT 20 FOR DET	TAILS) (R)
EPC TYPE A C&G (CATCH)	·····©
EPC TYPE A C&G (SPILL)	······§
8' CROSSPAN (SEE SHT 20 FOR DETAILS)
CURB & GUTTER	C&G
TOP FRONT CURB	TFC
EDGE OF SIDEWALK	EOS
CENTERLINE	CL
PLAN & PROFILE	P&P
SOUTHWEST RETAIL ROW ST. CUL-DE-SA	CSW RRS CDS
SOUTHEAST.	SE
WEST	W
WOODMEN ROAD	WMR
SHEET	SHT
SIDEWALK	SW

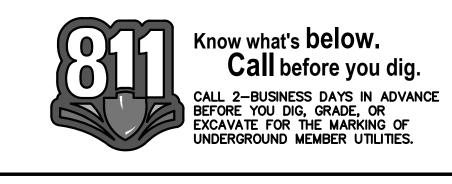

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CONTACT: TIM D. McCONNELL, P.E.
(719)260-0887
COLORADO SPRINGS • LAFAYETIE

CLIENT:

PROTERRA PROPERTIES

1864 WOODMOOR DRIVE MONUMENT, CO 80132 (719) 476-0800 CONTACT: STEVE ROSSOLL srossoll@proterraco.com

THE COMMONS AT FALCON FIELD

12445 RIO LANE, AND VACANT LAND

ISSUE	DATE		
INITIAL ISSUE	12/16/24		
DESIGNED BY:	KGV		
DRAWN BY:	SDM		
CHECKED BY:	TDM		
LE NAME: ROU	JNDABOUT		
REPARED UNDER MY DIRECT			

SUPERVISION FOR AND ON BEHALF OF DREXEL, BARRELL & CO.

DRAWING SCALE:

HORIZONTAL: 1" = 50"

VERTICAL: 1" = 12.5'

W ROUNDABOUT C&G FLOWLINE PLAN & PROFILES

PROJECT NO. 21604-00CSCV
DRAWING NO.


C12

SHEET: 12 OF 29

WEST ROUNDABOUT C&G FLOWLINE

STA 1+00.00 - 8+15.50

SCALE: 1"=50'

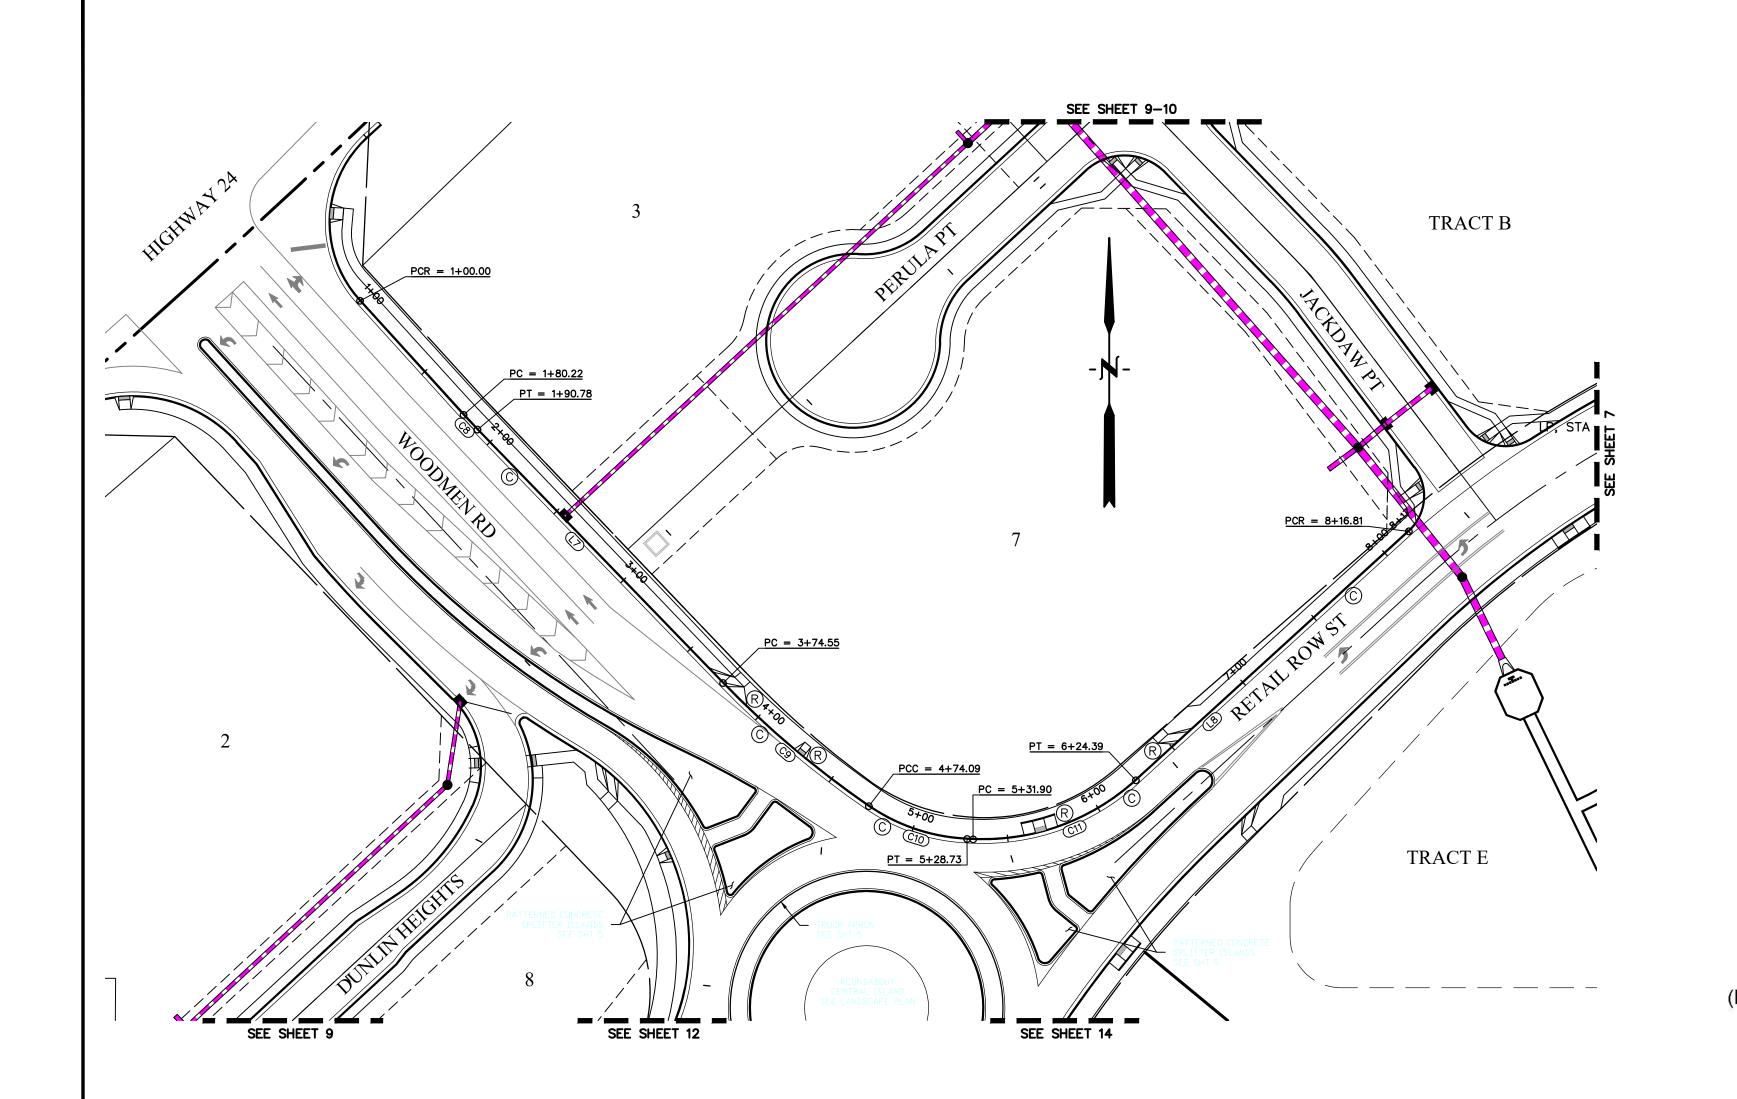

6880

6875

6870

6865

6860

6855

6850

6845

6840

6835

6830

6825

6820

6815

0+50 1+00

PCR, GRADE BREAK STA = 1+00.00 ELEV=6856.37

--2.85%

2+00


_PC, GRADE BREAK STA = 1+80.22 ELEV=6854.11


PT, GRADE BREAK STA = 1+90.78 ELEV=6853.81


3+00

NORTH R	OUNDABOUT (C&G LINE TABLE
LINE #	LENGTH	DIRECTION

NORTH RO	DUNDABOUT	C&G CURVE	ETABLE
CURVE #	LENGTH	RADIUS	DELTA

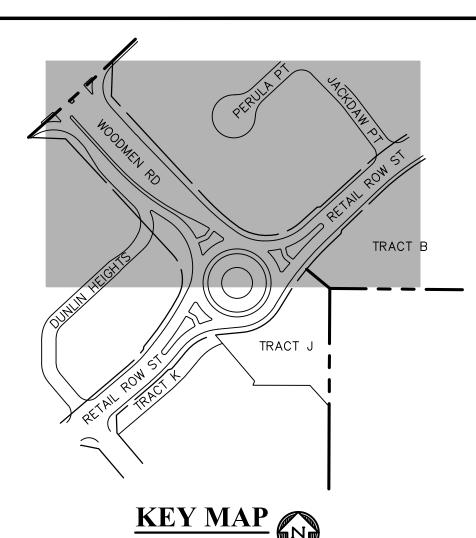

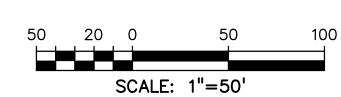

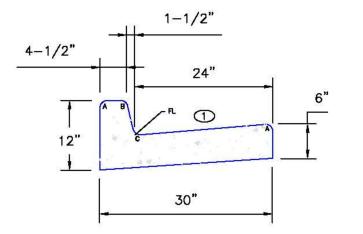

EPC TYPE A (REVERSE SLOPE OF PAN FOR SPILL CURB)

6880

6875

6870

6865

6860

6855

6850

6845

6840

6835

6830

6825

6820

6815

6810

8+00 8+50

LEGEND

SIDEWALK .

1) - GUTTER CROSS SLOPES
SHALL BE 1/2 IN./FT. WHEN
DRAINING AWAY FROM CURB AND
1 IN./FT. WHEN DRAINING
TOWARD CURB.

LEGEND FOR RADII A 1/8" TO 1/4"

C 1-1/2" TO 2"

B 1-1/2"

PROPERTY LINE		
RIGHT OF WAY		_
LOT LINE		
CENTERLINE ROAD		_
EASEMENT.	· ·	
EASEMENT (UTILITY)		
SIDEWALK		
POND		
TRACT LINE		
PROPOSED SLOPE GRADE	2.0%	
PROPOSED MAJOR CONROUR	. —— (6205——
PROPOSED MINOR CONTOUR	6	6203——
EXISTING MAJOR CONTOUR	E	6205
EXISTING MINOR CONTOUR	· · ·	5203
LOT NUMBER	· ·7	
EXISTING	EX	
PROPOSED	PP	
PEDESTRIAN RAMP (SEE SHT 20 FOR DETAILS	s)R	
EPC TYPE A C&G (CATCH)	·©	
EPC TYPE A C&G (SPILL)	· (S)	
8' CROSSPAN (SEE SHT 20 FOR DETAILS)	······ (X)	
CURB & GUTTER	C&G	
TOP FRONT CURB	TFC	
EDGE OF SIDEWALK	EOS	
CENTERLINE	CL	
PLAN & PROFILE	P&P	
SOUTHWEST RETAIL ROW ST. CUL-DE-SAC	SW	RRS CDS
SOUTHEAST.	SE	
WEST.	W	
WOODMEN ROAD	WMR	
SHEET.	SHT	
CIDEMALIA	CW	



PREPARED BY:

DREXEL, BARRELL & CC

Engineers • Surveyors
101 SAHWATCH ST., SUITE 100
COLORADO SPGS, COLORADO 80903

CONTACT: TIM D. McCONNELL, P.I (719)260-0887 COLORADO SPRINGS • LAFAYETTE

CLIENT:

PROTERRA PROPERTIES

1864 WOODMOOR DRIVE MONUMENT, CO 80132 (719) 476-0800 CONTACT: STEVE ROSSOLL srossoll@proterraco.com

DATE

12/16/24

INITIAL ISSUE

DESIGNED BY:

CHECKED BY:

FILE NAME: ROUNDABOUT

PREPARED UNDER MY DIRECT SUPERVISION FOR AND ON BEHALF OF DREXEL, BARRELL & CO.

DRAWING SCALE:

N ROUNDABOUT

C&G FLOWLINE

PLAN & PROFILES

PROJECT NO. 21604-00CSCV

DRAWING NO.

HORIZONTAL: 1'' = 50''VERTICAL: 1'' = 12.5'

DRAWN BY:

SHEET: 13 OF 29

NORTH ROUNDABOUT C&G FLOWLINE STA 1+00.00 - 8+16.81 SCALE: 1"=50'

4+00

PC, GRADE BREAK STA = 3+74.55 ELEV=6848.52

_PCC, GRADE BREAK STA = 4+74.09 ELEV=6845.86

-2.20%

5+00

__PT, GRADE BREAK STA = 5+28.73 ELEV=6845.10

PC, GRADE BREAK STA = 5+31.90 ELEV=6845.17


EX GROUND @ C&G FLOWLINE

6+00

PT, GRADE BREAK STA = 6+24.39 ELEV=6843.34

PP GRADE @ C&G FLOWLINE

7+00

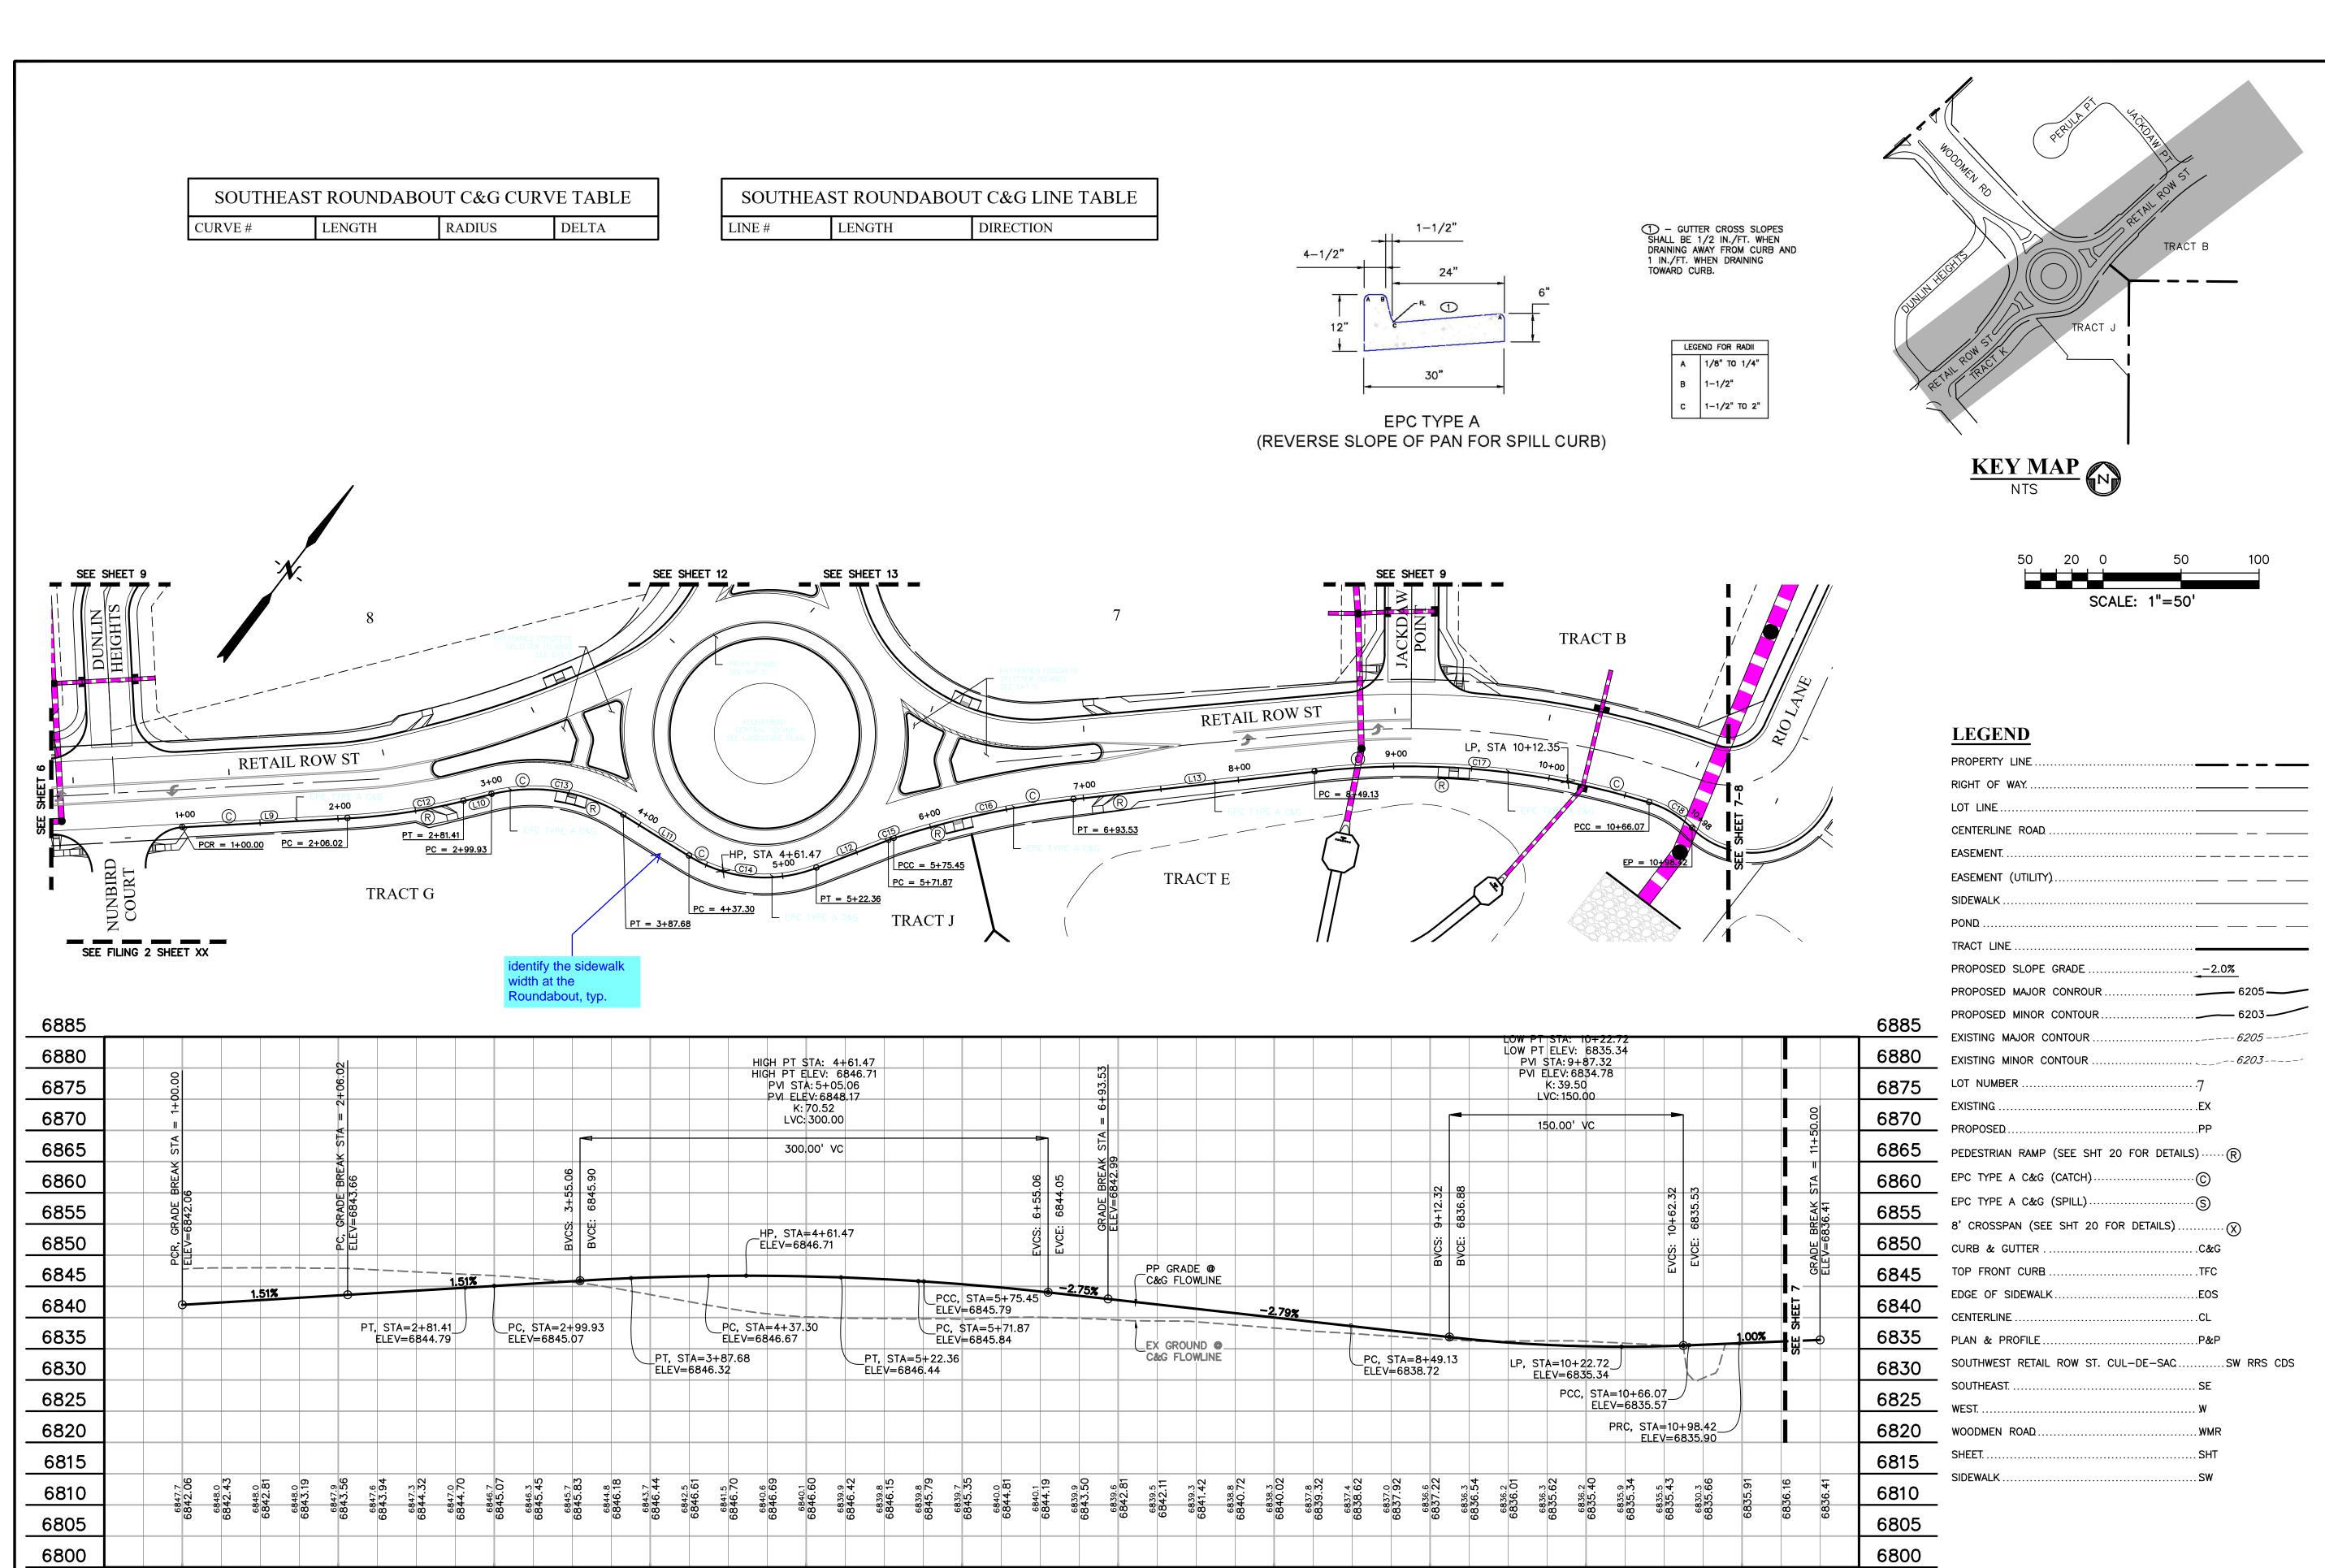

1+00

0+50

3+00

2+00

4+00

5+00

6+00

SOUTHEAST ROUNDABOUT C&G FLOWLINE

STA 1+00.00 - 11+50.00

SCALE: 1"=50'

7+00

8+00

9+00

10+00

11+00

11+75

PREPARED BY:

DREXEL, BARRELL & CO.
Engineers • Surveyors
101 SAHWATCH ST., SUITE 100
COLORADO SPGS, COLORADO 80903
CONTACT: TIM D. McCONNELL, P.E
(719)260-0887
COLORADO SPRINGS • LAFAYETTE

CLIENT:

PROTERRA PROPERTIES

1864 WOODMOOR DRIVE
MONUMENT, CO 80132
(719) 476-0800
CONTACT: STEVE ROSSOLL
srossoll@proterraco.com

THE COMMONS AT FALCON FIELD 12445 RIO LANE, AND VACANT LAND

ESIGNED BY:	KGV		
DRAWN BY:	SDM		
CHECKED BY:	TDM		
E NAME: ROL	JNDABOUT		
EPARED UNDER MY DIRECT SUPERVISION FOR AND ON BEHALF OF DREXEL, BARRELL & CO.			

INITIAL ISSUE 12/16/24

DATE

DRAWING SCALE:
HORIZONTAL: 1" = 50"

SE ROUNDABOUT C&G FLOWLINE

VERTICAL: 1'' = 12.5'

PLAN & PROFILES

PROJECT NO. 21604-00CSCV


DRAWING NO.

Know what's below.

Call before you dig.

CALL 2-BUSINESS DAYS IN ADVANCE BEFORE YOU DIG, GRADE, OR EXCAVATE FOR THE MARKING OF UNDERGROUND MEMBER UTILITIES. C14

SHEET: 14 OF 29

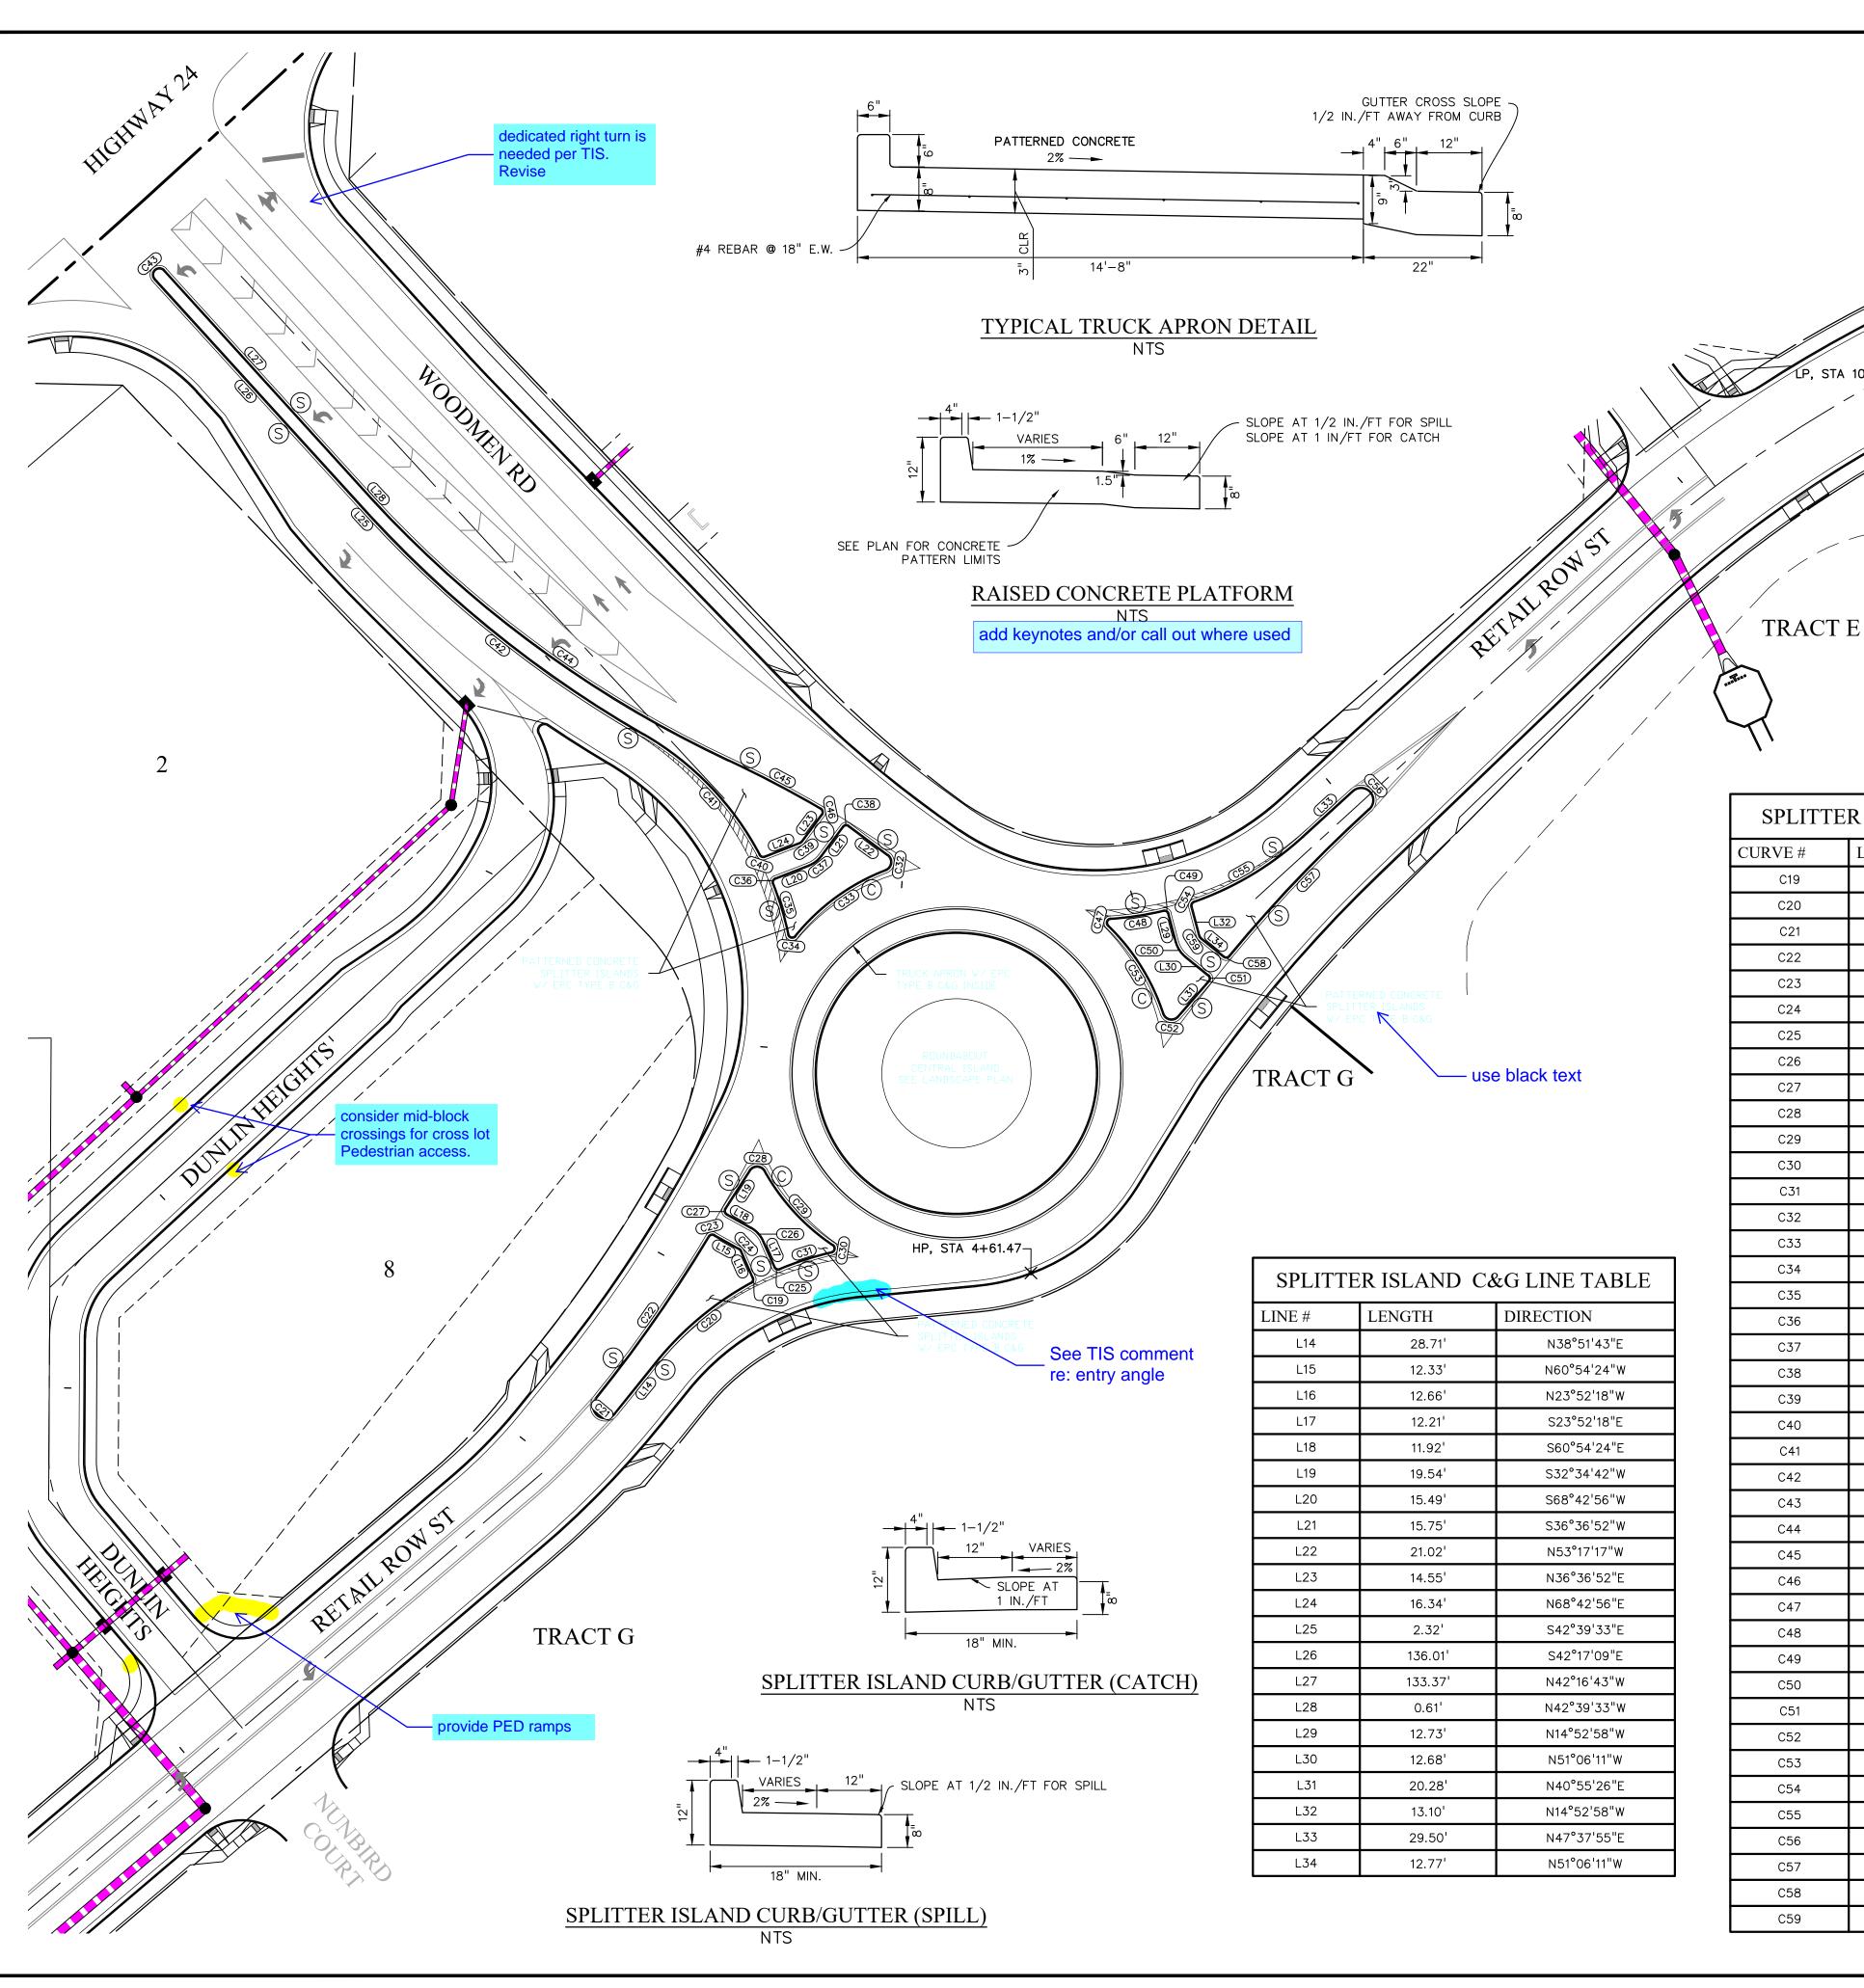



CURVE #	LENGTH	RADIUS	DELTA
C19	2.98'	2.00'	85°15'51"
C20	53.48'	136.00'	22°31'50"
C21	17.28'	5.50'	180°00'00"
C22	85.29'	621.00'	7°52'08"
C23	3.08'	2.00'	88°06'00"
C24	1.29'	2.00'	37°02'06"
C25	3.10'	2.00'	88°55'04"
C26	7.76'	12.00'	37°02'06"
C27	3.26'	2.00'	93°29'06"
C28	8.26'	4.00'	118°18'35"
C29	43.77'	93.00'	26°57'58"
C30	4.65'	2.00'	133°09'04"
C31	23.41'	136.00'	9°51'45"
C32	8.53'	4.00'	122°09'58"
C33	48.71'	93.00'	30°00'37"
C34	4.52'	2.00'	129°25'39"
C35	22.73'	130.00'	10°01'06"
C36	3.16'	2.00'	90°26'18"
C37	6.72'	12.00'	32°06'04"
C38	3.14'	2.00'	90°05'51"
C39	1.12'	2.00'	32°06'04"
C40	2.91'	2.00'	83°28'14"
C41	73.17'	130.00'	32°14'57"
C42	151.88'	500.00'	17°24'15"
C43	9.42'	3.00'	180°00'00"
C44	191.83'	494.00'	22°14'56"
C45	44.82'	499.00'	5°08'48"
C46	3.36'	2.00'	96°22'32"
C47	4.61'	2.00'	132°12'19"
C48	23.03'	136.00'	9°42'03"
C49	3.09'	2.00'	88°35'46"
C50	7.59'	12.00'	36°13'13"
C51	3.21'	2.00'	92°01'37"
C52	8.44'	4.00'	120°54'36"
C53	45.15'	93.00'	27°49'02"
C54	2.99'	2.00'	85°35'13"
C55	54.77'	136.00'	23°04'20"
C56	17.28'	5.50'	180°00'00"
C57	87.70'	621.00'	8°05'29"
C58	3.12'	2.00'	89°21'22"

40 16 8 0	40 80
- SCALE: 1	'=40'
- J - SOALL. 1	_+0
LEGEND	
PROPERTY LINE	
RIGHT OF WAY	
LOT LINE	
CENTERLINE ROAD	
EASEMENT.	
EASEMENT (UTILITY)	
SIDEWALK	
POND	
TRACT LINE	
PROPOSED SLOPE GRADE PROPOSED MAJOR CONROUR	-
PROPOSED MINOR CONTOUR	_
EXISTING MAJOR CONTOUR	
EXISTING MINOR CONTOUR	
LOT NUMBER	
EXISTING	,
PROPOSED	PP
PEDESTRIAN RAMP (SEE SHT 20 FOR DETAI	LS)(R)
EPC TYPE A C&G (CATCH)	···©
EPC TYPE A C&G (SPILL)	··· · ⑤
8' CROSSPAN (SEE SHT 20 FOR DETAILS)	(X)
CURB & GUTTER	C&G
TOP FRONT CURB	TFC
EDGE OF SIDEWALK	EOS
CENTERLINE	CL
PLAN & PROFILE	P&P
SOUTHWEST RETAIL ROW ST. CUL-DE-SAC.	SW RRS CDS

Know what's below.

Call before you dig.

CALL 2-BUSINESS DAYS IN ADVANCE BEFORE YOU DIG, GRADE, OR EXCAVATE FOR THE MARKING OF UNDERGROUND MEMBER UTILITIES.

SOUTHEAST. .

WOODMEN ROAD ...

WEST. .

SHEET..

SIDEWALK.

KEY MAP



Engineers • Surveyors
101 SAHWATCH ST., SUITE 100
COLORADO SPGS, COLORADO 80903 CONTACT: TIM D. McCONNELL, P.E (719)260-0887 COLORADO SPRINGS • LAFAYETTE

CLIENT:

PROTERRA PROPERTIES

1864 WOODMOOR DRIVE MONUMENT, CO 80132 (719) 476-0800 CONTACT: STEVE ROSSOLL srossoll@proterraco.com

	DATE		
JE	12/16/24		
		-	
3Y:	KGV		
Y:	SDM		
3Y:	TDM		
ROL	INDABOUT		
EPARED UNDER MY DIRECT UPERVISION FOR AND ON BEHALF OF DREXEL, BARRELL & CO.			
	BY: Y: ROU NDER N FOR	BY: KGV Y: SDM BY: TDM ROUNDABOUT NDER MY DIRECT N FOR AND ON ALF OF	

SPLITTER ISLAND ROUNDABOUT


PLAN


DRAWING SCALE:

HORIZONTAL: 1'' = 40''VERTICAL: N/A

PROJECT NO. 21604-00CSCV DRAWING NO.

SHEET: 15 OF 29

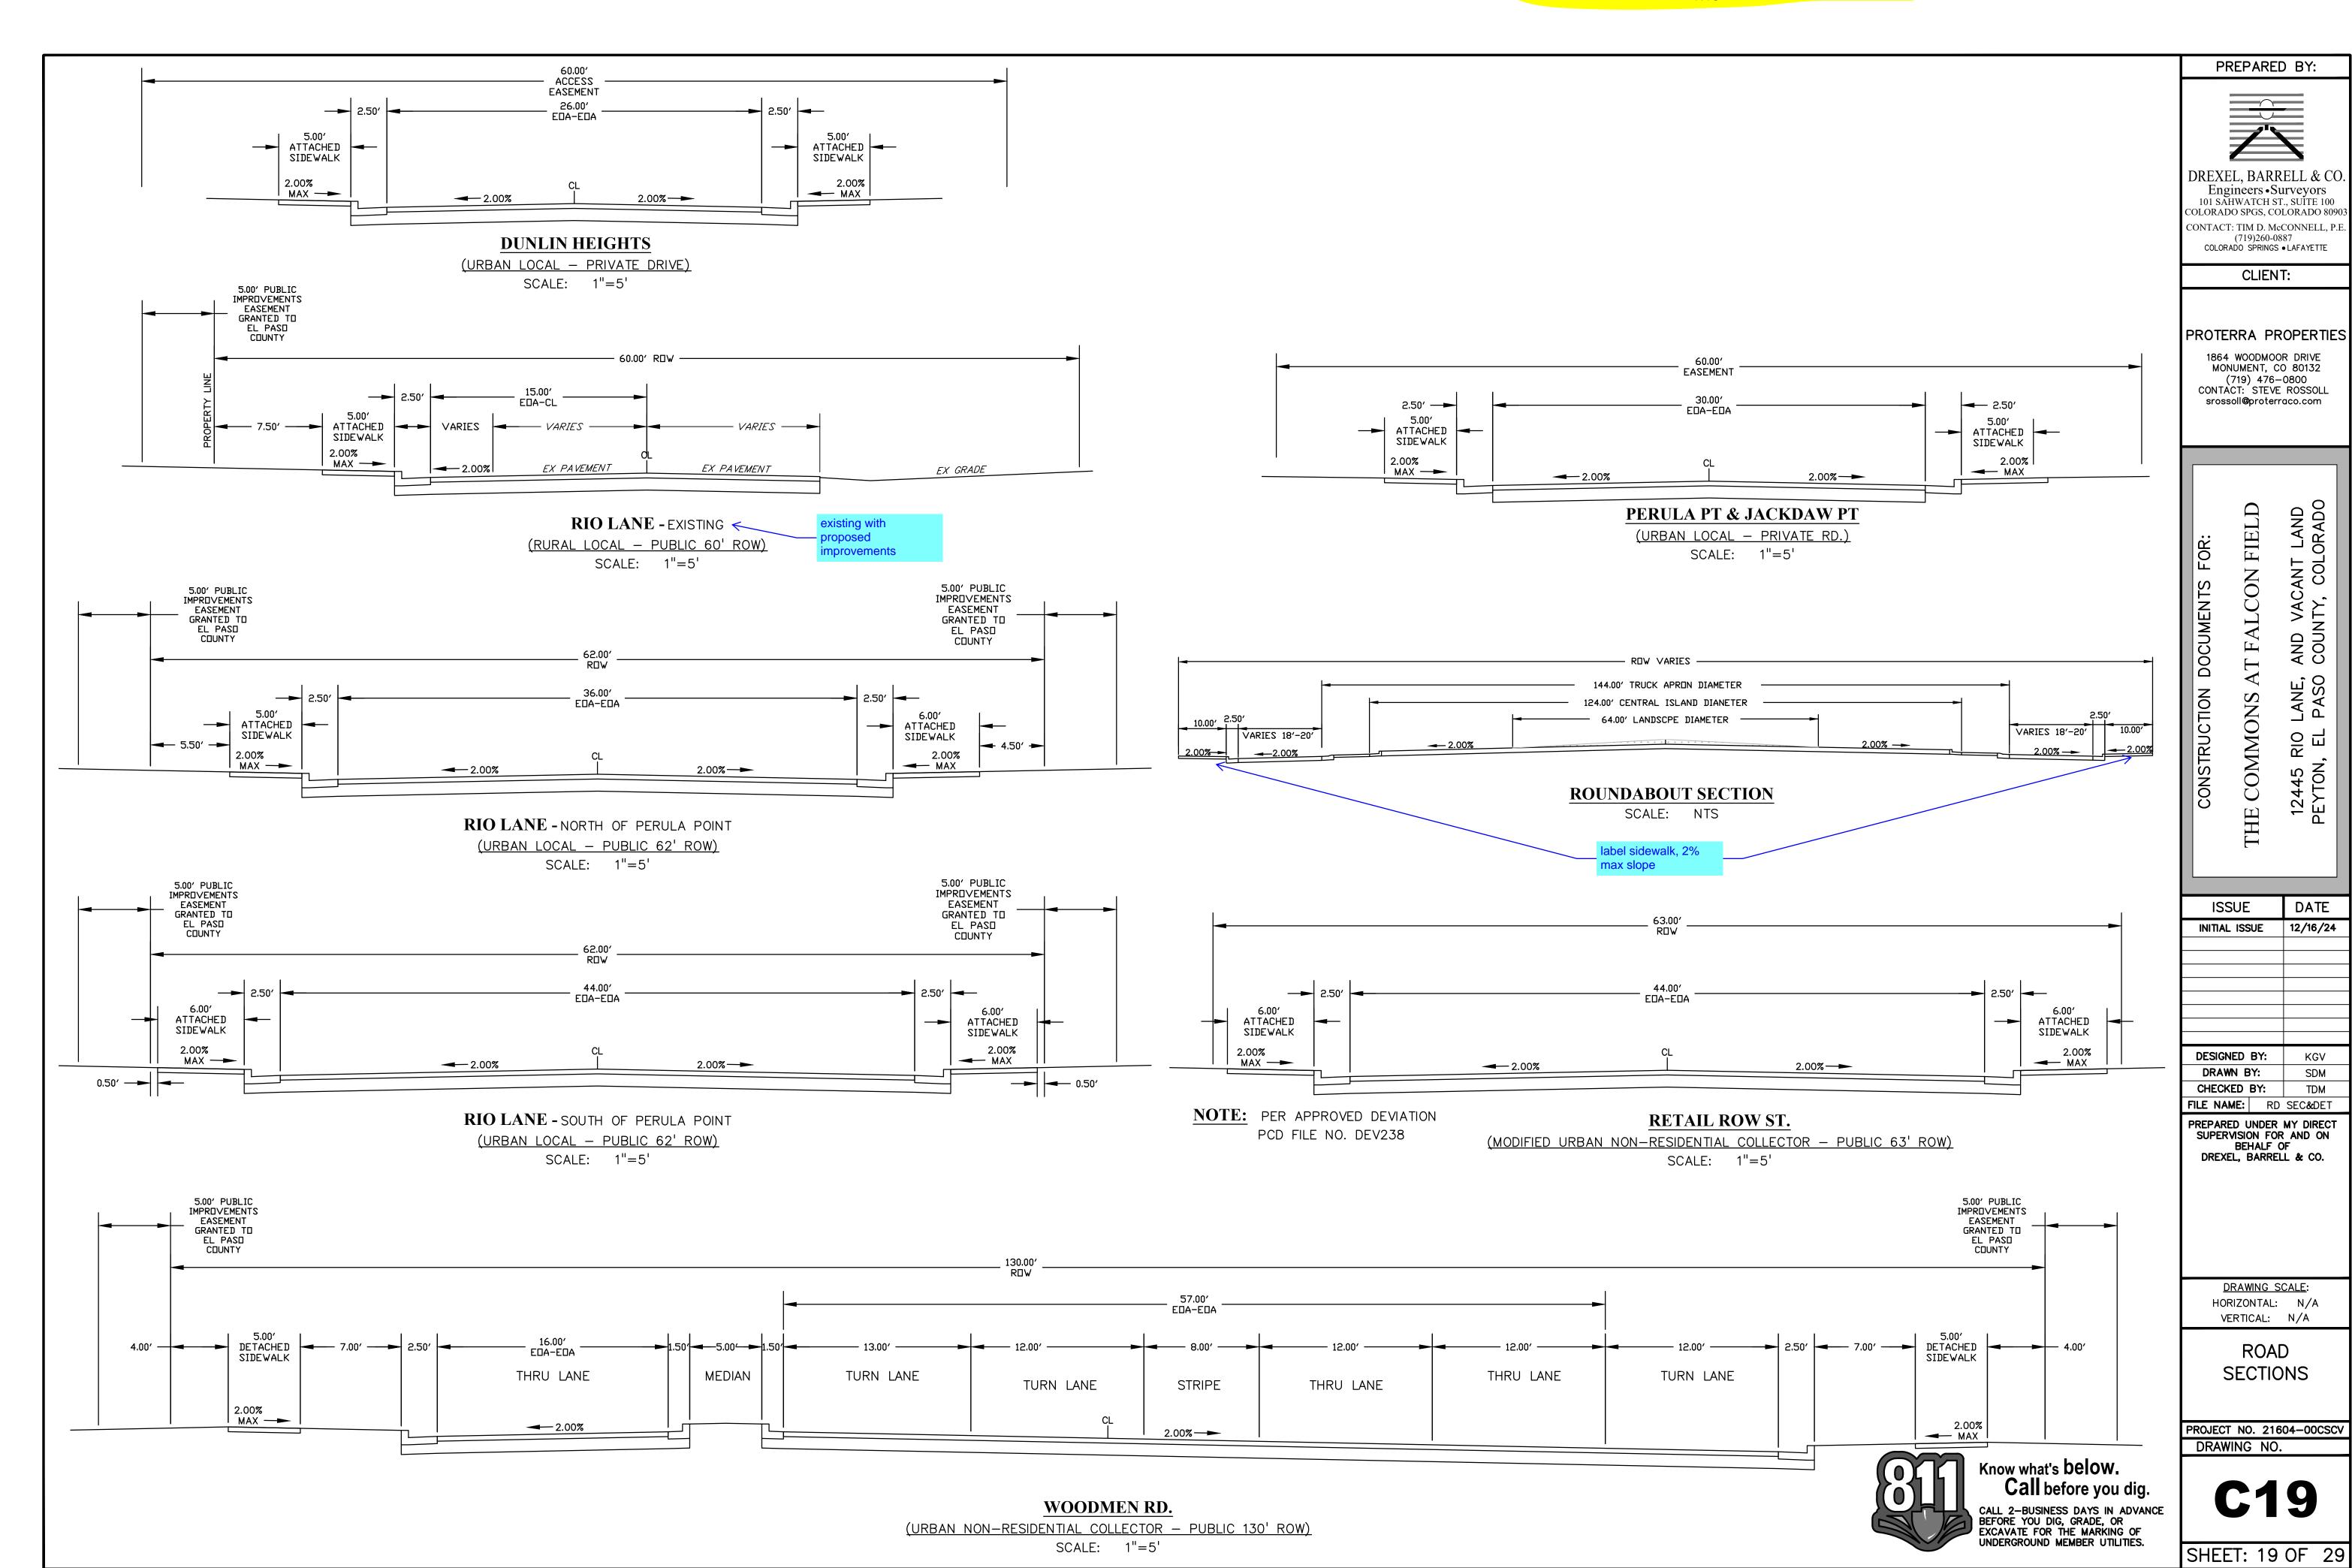

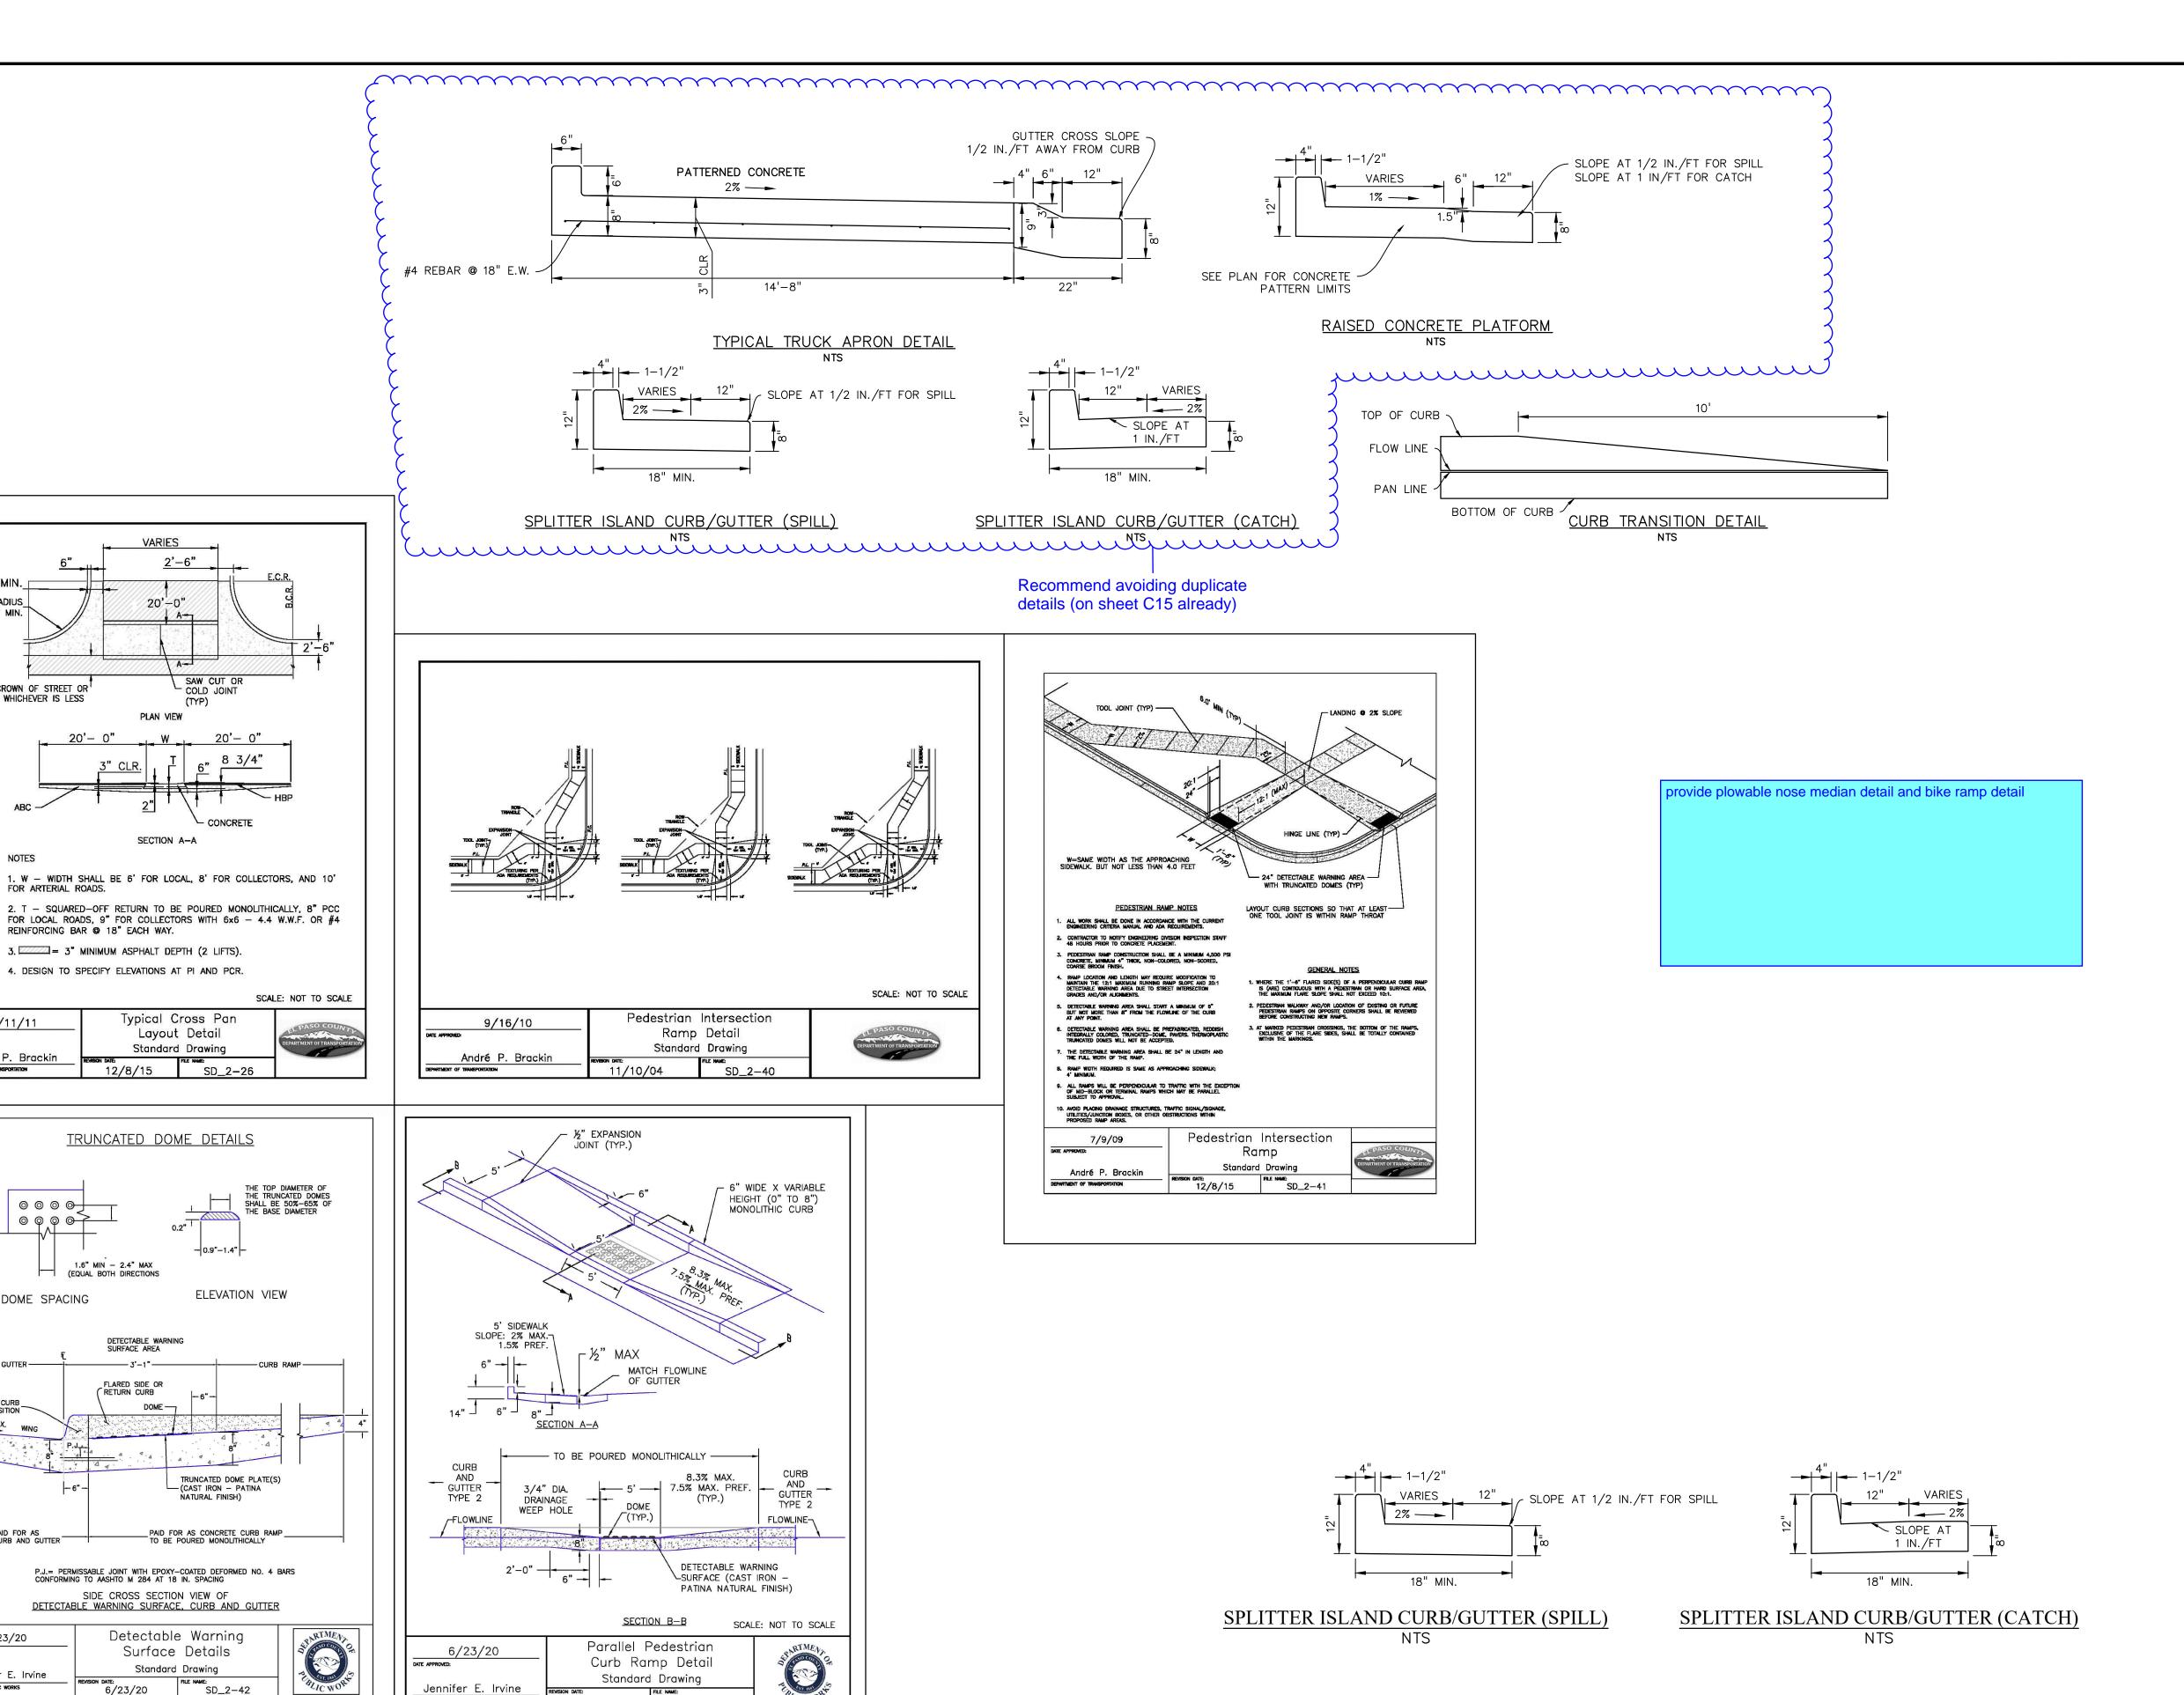

CURB RADIUS

TO CROWN OF STREET OR 1 20', WHICHEVER IS LESS

CONCRETE

SECTION A-A

Typical Cross Pan

Layout Detail

Standard Drawing

12/8/15 SD_2-26

TRUNCATED DOME DETAILS

REINFORCING BAR @ 18" EACH WAY.

| @ @ @ >

DOME SPACING

___PAID FOR AS CURB AND GUTTER

6/23/20

Jennifer E. Irvine

DEPARTMENT OF PUBLIC WORKS

DATE APPROVED:

1.6" MIN - 2.4" MAX (EQUAL BOTH DIRECTIONS

DETECTABLE WARNING SURFACE AREA

NATURAL FINISH)

FILE NAME: SD_2-42

DEPARTMENT OF PUBLIC WORKS

6/23/20

SD_2-50

Detectable Warning

Surface Details

Standard Drawing

6/23/20

FLARED SIDE OR RETURN CURB

4. DESIGN TO SPECIFY ELEVATIONS AT PL AND PCR.

Know what's below.

Call before you dig. CALL 2-BUSINESS DAYS IN ADVANCE BEFORE YOU DIG, GRADE, OR EXCAVATE FOR THE MARKING OF UNDERGROUND MEMBER UTILITIES. PREPARED BY:

DREXEL, BARRELL & CO Engineers • Surveyors 101 SAHWATCH ST., SUITE 100 COLORADO SPGS, COLORADO 8090 CONTACT: TIM D. McCONNELL, P.I (719)260-0887
COLORADO SPRINGS • LAFAYETTE

CLIENT:

PROTERRA PROPERTIES

1864 WOODMOOR DRIVE MONUMENT, CO 80132 (719) 476-0800 CONTACT: STEVE ROSSOLL srossoll@proterraco.com

FIELD

USTRUCTION

12/16/24 INITIAL ISSUE DESIGNED BY: DRAWN BY: TDM CHECKED BY: FILE NAME: RD SEC&DET

ISSUE

DATE


PREPARED UNDER MY DIRECT SUPERVISION FOR AND ON BEHALF OF DREXEL, BARRELL & CO.


> DRAWING SCALE: HORIZONTAL: N/A VERTICAL: N/A


> > ROAD **DETAILS**

PROJECT NO. 21604-00CSCV DRAWING NO.

SHEET: 20 OF 29

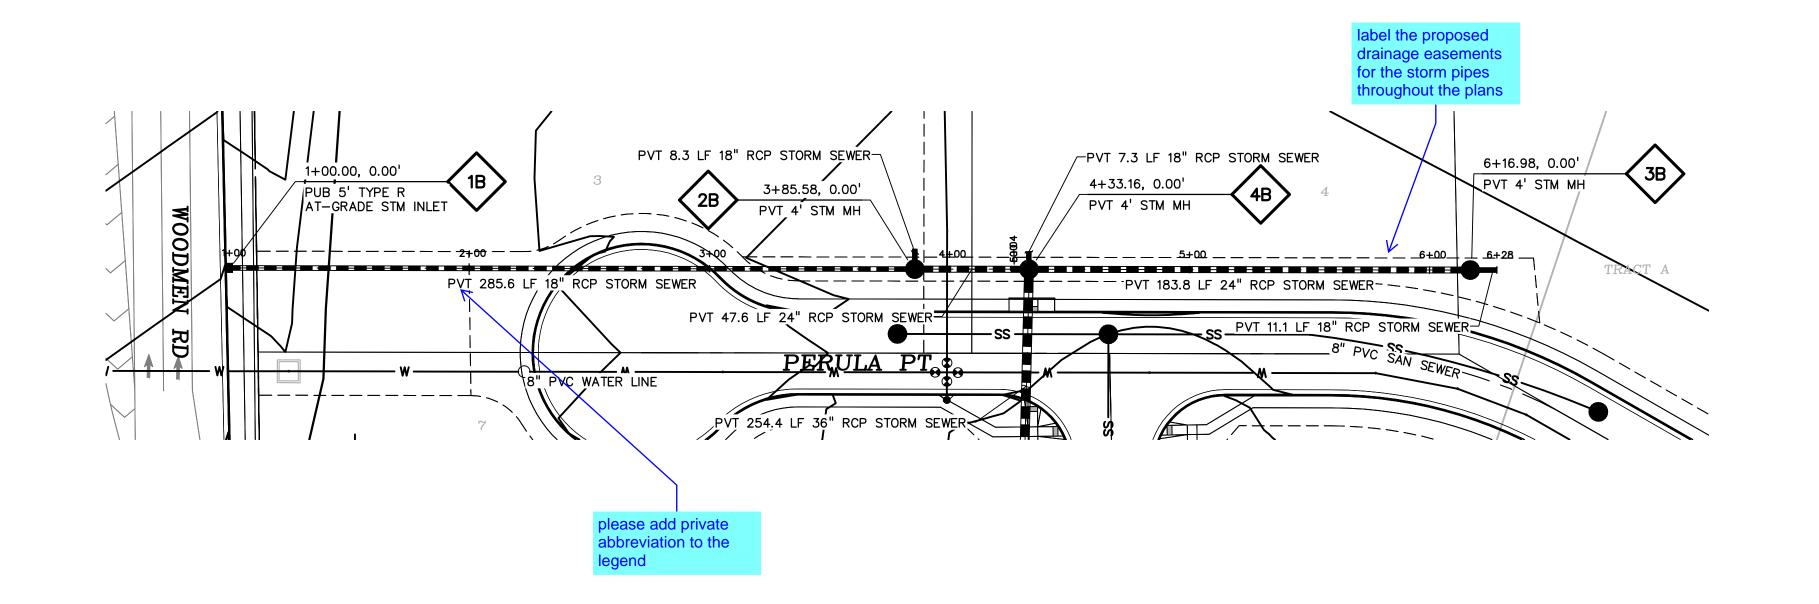

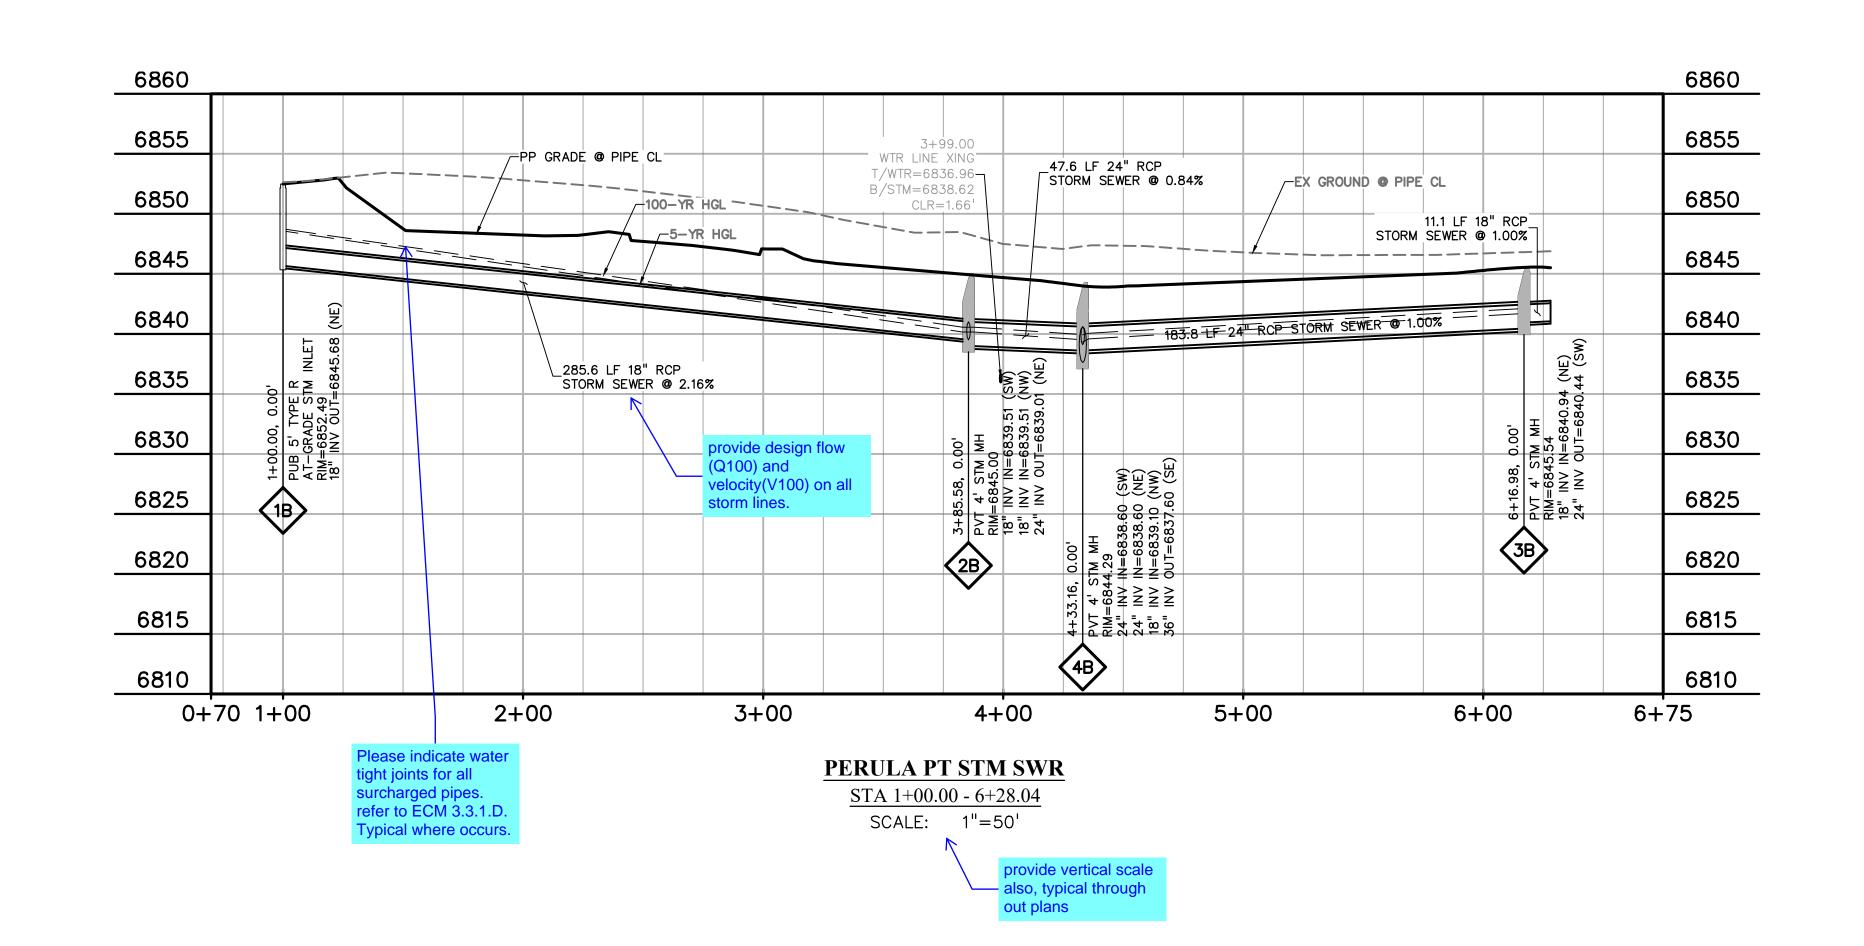

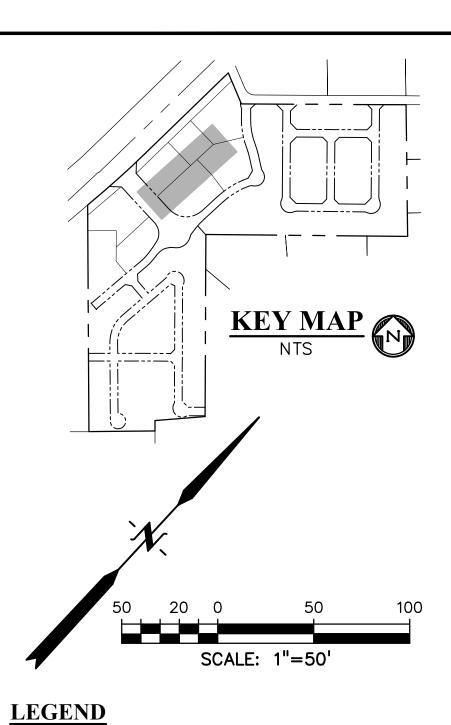

PROP	erty line	
EASE	MENT	
PP R	IGHT OF WAY	·
PP LO	OT LINE	
PP C	URB & GUTTER	
PP SI	DEWALK	
PP S	TORM SEWER LINE	
HYDR	AULIC GRADE LINE	
ENER	GY GRADE LINE	
PP S	TORM INLET	
PP M	ANHOLE	•
PP W	ATER LINE	w
PP FI	RE HYDRANT	Ή
PP W	ATER VALVE	····· •
PP S	ANITARY SEWER LINE	ss——
	TORM SEWER IOLE DESIGNATOR	
LOT N	NUMBER	11
PP P	OND	
PP T	ELEPHONE	т ——
PP T	RAIL	
PP G	RADE @ COF PIPE	
EX W	VATER FIRE HYDRANT	
EX W	YATER LINE	w
EX W	/T PLUG▶[
EX S.	S LINE	ss ——
EX S.	<i>S MH</i>	
EX G	ROUND @ @ OF PIPE	
EX E	LECTRIC	Ε
EX 10	00YR FLOOD	
MH PP		

.. SANITARY SEWER

.. CURB AND GUTTER

.STORM SEWER


.WATER

.. CROSSING

XING.

C&G .

PUB..

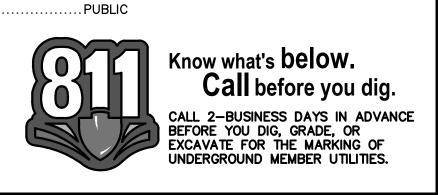

PREPARED BY:

DREXEL, BARRELL & CO.
Engineers • Surveyors
101 SAHWATCH ST., SUITE 100
COLORADO SPGS, COLORADO 80903
CONTACT: TIM D. McCONNELL, P.E

CLIENT:

(719)260-0887 COLORADO SPRINGS • LAFAYETTE

PROTERRA PROPERTIES

1864 WOODMOOR DRIVE MONUMENT, CO 80132 (719) 476-0800 CONTACT: STEVE ROSSOLL

srossoll@proterraco.com

MMONS AT FALCON FIELD

S RIO LANE, AND VACANT LAND

N FI PASO COUNTY COLORADO

ISSUE	•	DATE
INITIAL ISSUE		12/16/24
DESIGNED	BY:	KGV
DRAWN B	BY:	CGH
CHECKED	BY:	TDM
FILE NAME:	21604-STM	

THE

CON

PREPARED UNDER MY DIRECT SUPERVISION FOR AND ON BEHALF OF DREXEL, BARRELL & CO.


DRAWING SCALE:
HORIZONTAL: 1" = 50"
VERTICAL: 1" = 10'


STORM SEWER PLAN & PROFILE

PROJECT NO. 21604-00CSCV
DRAWING NO.

STM1


SHEET: 21 OF 29

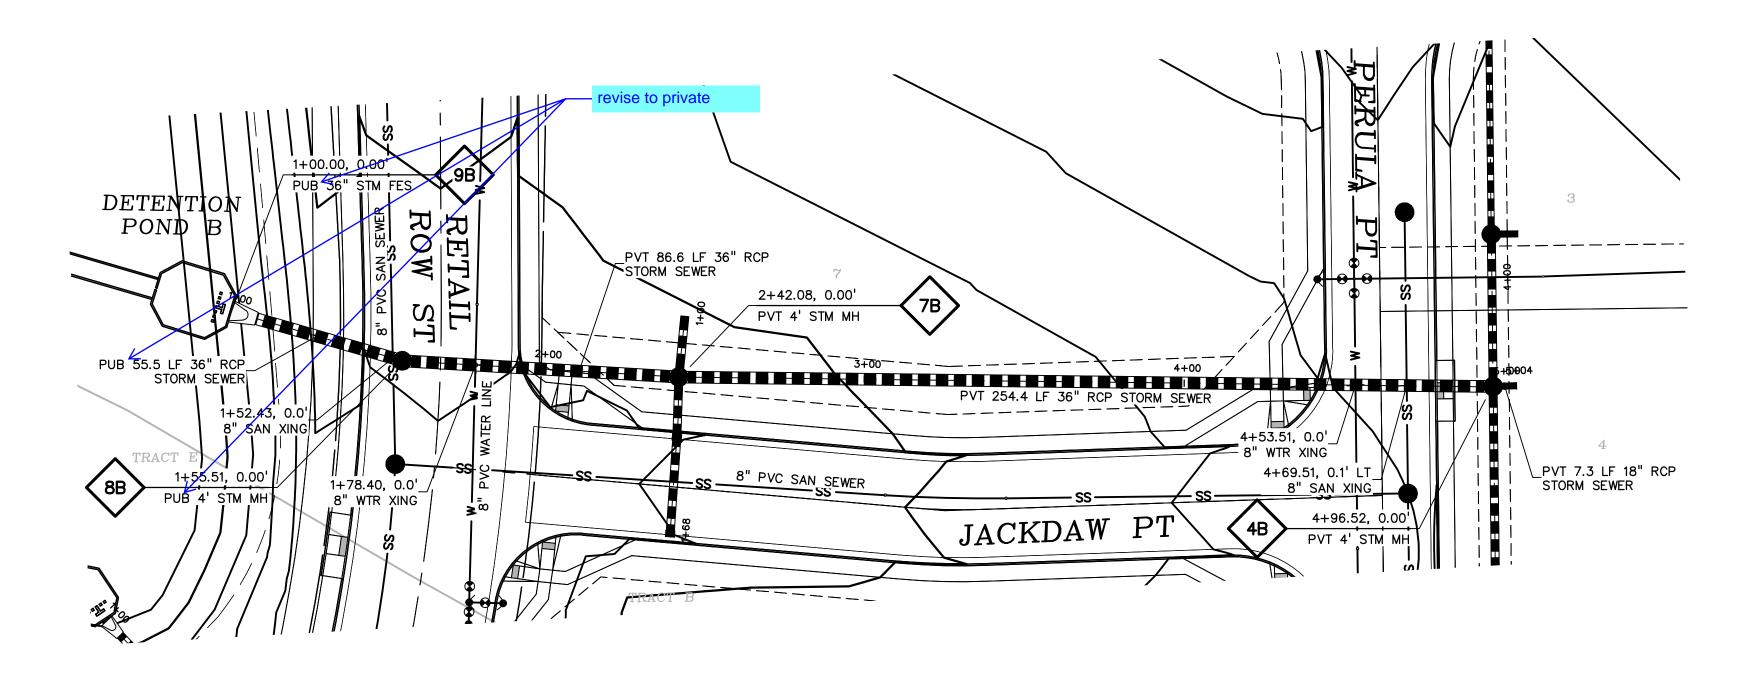

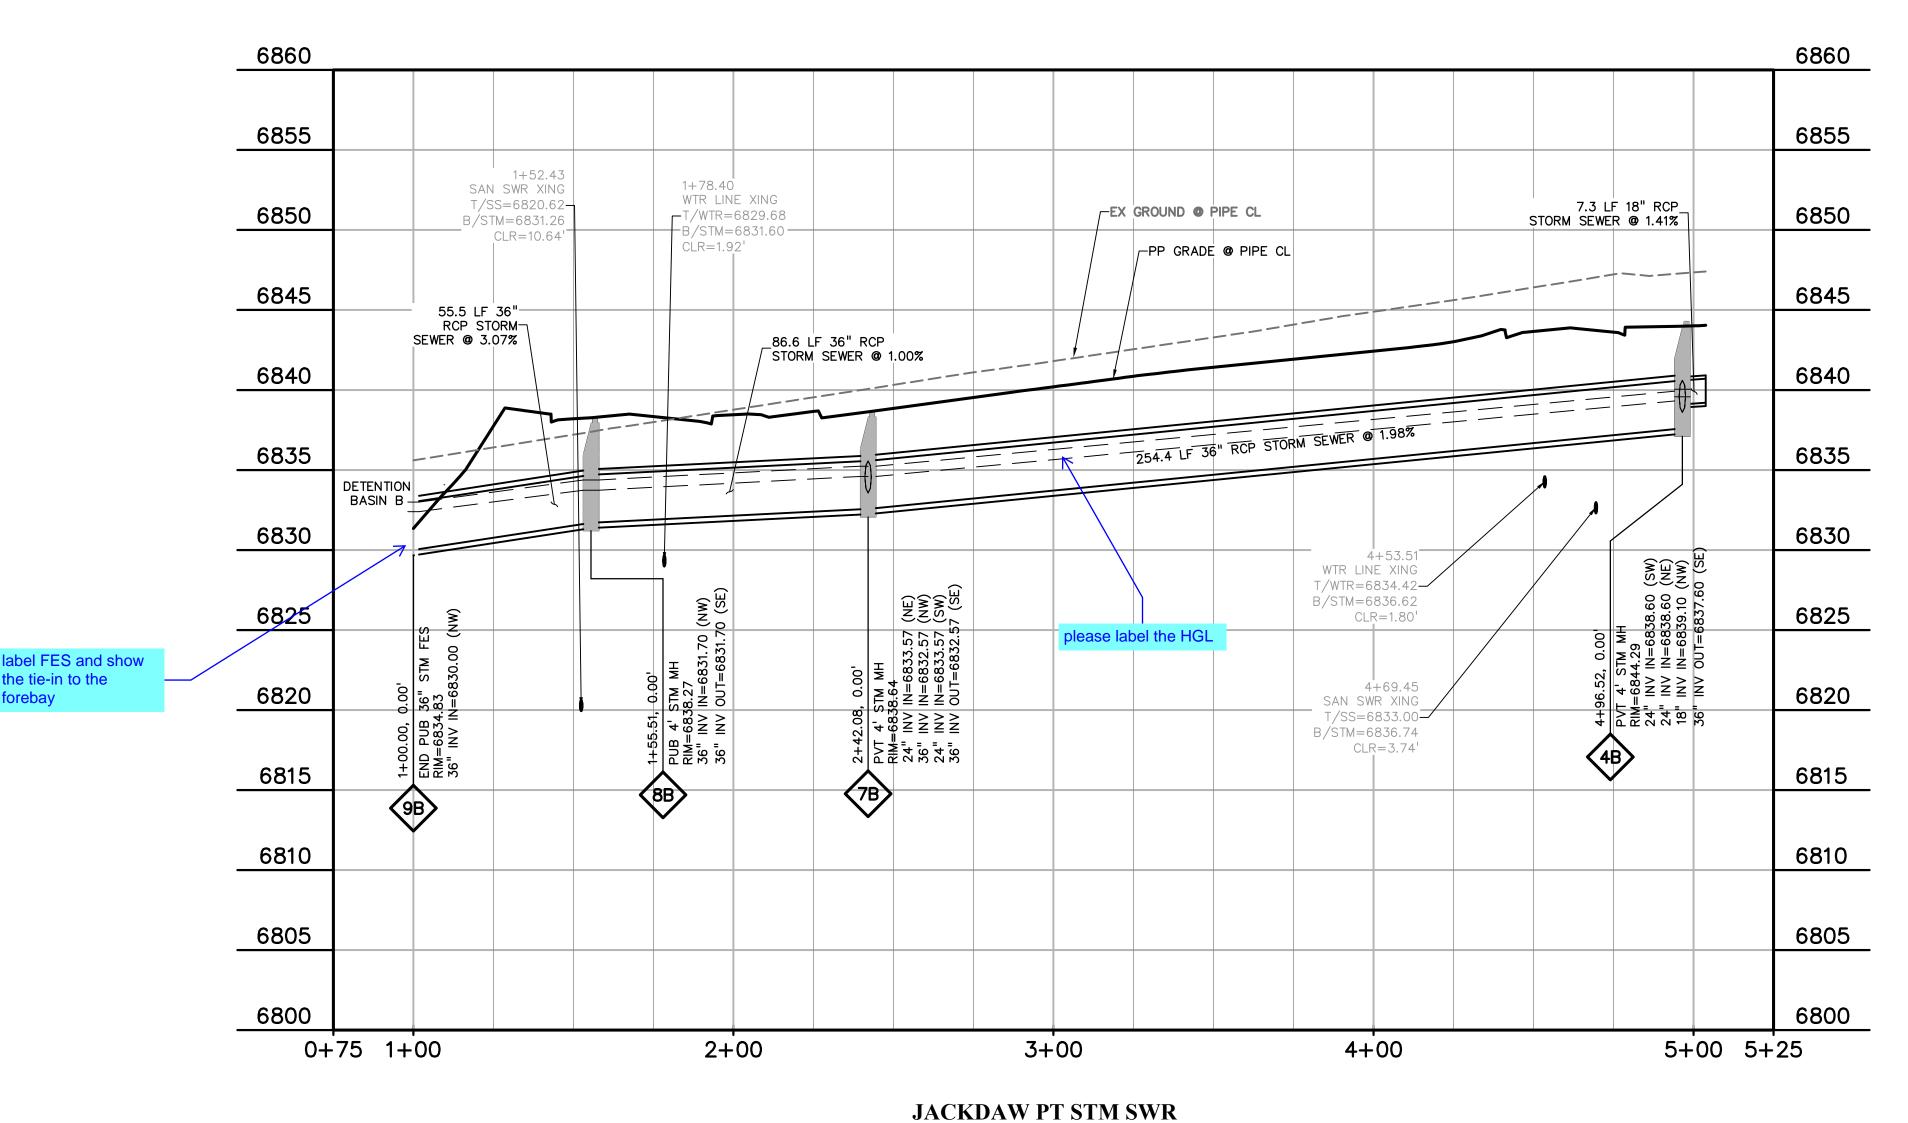

STA 1+00.00 - 5+03.81 SCALE: 1"=50'

the tie-in to the

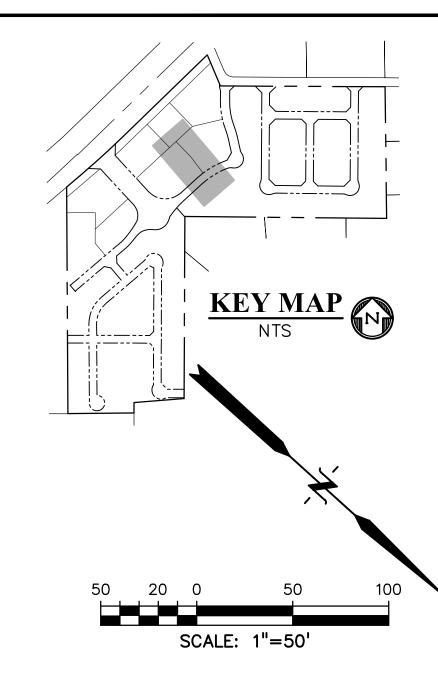

PROPERTY LINE	·····	
	Y	
	TER <u>—</u>	
	R LINE	
	DE LINE	
ENERGY GRADE L	_INE	
PP STORM INLET		
PP MANHOLE		
PP WATER LINE	·····	— w —
PP FIRE HYDRAN	Т	∢ FH
PP WATER VALVE	Ξ	·····• 8
PP SANITARY SEV	WER LINE	— ss —
PP STORM SEWER MANHOLE DESIGN	R JATOR	13
LOT NUMBER		11
PP POND		
PP TELEPHONE	<u> </u>	— т —
PP TRAIL		
	OF PIPE	
PP GRADE @ @ (
	HYDRANT	
EX WATER FIRE		
EX WATER FIRE	HYDRANT	w
EX WATER FIRE EX WATER LINE EX WT PLUG	HYDRANT	
EX WATER FIRE EX WATER LINE EX WT PLUG EX SS LINE	HYDRANT	
EX WATER FIRE EX WATER LINE EX WT PLUG EX SS LINE EX SS MH	HYDRANT	
EX WATER FIRE EX WATER LINE EX WT PLUG EX SS LINE EX SS MH EX GROUND @ Q	OF PIPE.	
EX WATER FIRE EX WATER LINE EX WT PLUG EX SS LINE EX SS MH EX GROUND @ Q EX ELECTRIC	HYDRANT	
EX WATER FIRE EX WATER LINE EX WT PLUG EX SS LINE EX GROUND @ Q EX ELECTRIC EX 100YR FLOOD.	OF PIPE.	
EX WATER FIRE EX WATER LINE EX WT PLUG EX SS LINE EX GROUND @ Q EX ELECTRIC EX 100YR FLOOD. EX	THYDRANT	
EX WATER FIRE EX WATER LINE EX WT PLUG EX SS LINE EX GROUND @ Q EX ELECTRIC EX 100YR FLOOD. EX MH	### HYDRANT	
EX WATER FIRE EX WATER LINE EX WT PLUG EX SS LINE EX GROUND @ @ EX ELECTRIC EX 100YR FLOOD. EX MH PP	EXISTING MANHOLE PROPOSED POINT	
EX WATER FIRE EX WATER LINE EX WT PLUG EX SS LINE EX GROUND @ @ EX ELECTRIC EX 100 YR FLOOD. EX MH PP	HYDRANT	
EX WATER FIRE EX WATER LINE EX WT PLUG EX SS LINE EX GROUND @ @ EX ELECTRIC EX. MH PP SS ST WT	HYDRANT	
EX WATER FIRE EX WATER LINE EX SS LINE EX GROUND © © EX ELECTRIC EX 100YR FLOOD EX EX.	HYDRANT	w · ▶c ss ⊕



.. CURB AND GUTTER

PREPARED BY:

DREXEL, BARRELL & CO.
Engineers • Surveyors
101 SAHWATCH ST., SUITE 100
COLORADO SPGS, COLORADO 80903 CONTACT: TIM D. McCONNELL, P.E (719)260-0887 COLORADO SPRINGS • LAFAYETTE

CLIENT:

PROTERRA PROPERTIES

1864 WOODMOOR DRIVE MONUMENT, CO 80132 (719) 476-0800 CONTACT: STEVE ROSSOLL srossoll@proterraco.com

AT FALCON FIELD NSTRUCTION THE COMMONS

ISSUE	DATE
INITIAL ISSUE	12/16/24
DESIGNED BY:	KGV
DRAWN BY:	CGH
CHECKED BY:	TDM
TLE NAME: 21	604-STM

PREPARED UNDER MY DIRECT SUPERVISION FOR AND ON BEHALF OF DREXEL, BARRELL & CO.


DRAWING SCALE: HORIZONTAL: 1" = 50"VERTICAL: 1'' = 10'

STORM SEWER CHANNEL PLAN & PROFILE

PROJECT NO. 21604-00CSCV

DRAWING NO.

SHEET: 22 OF 29

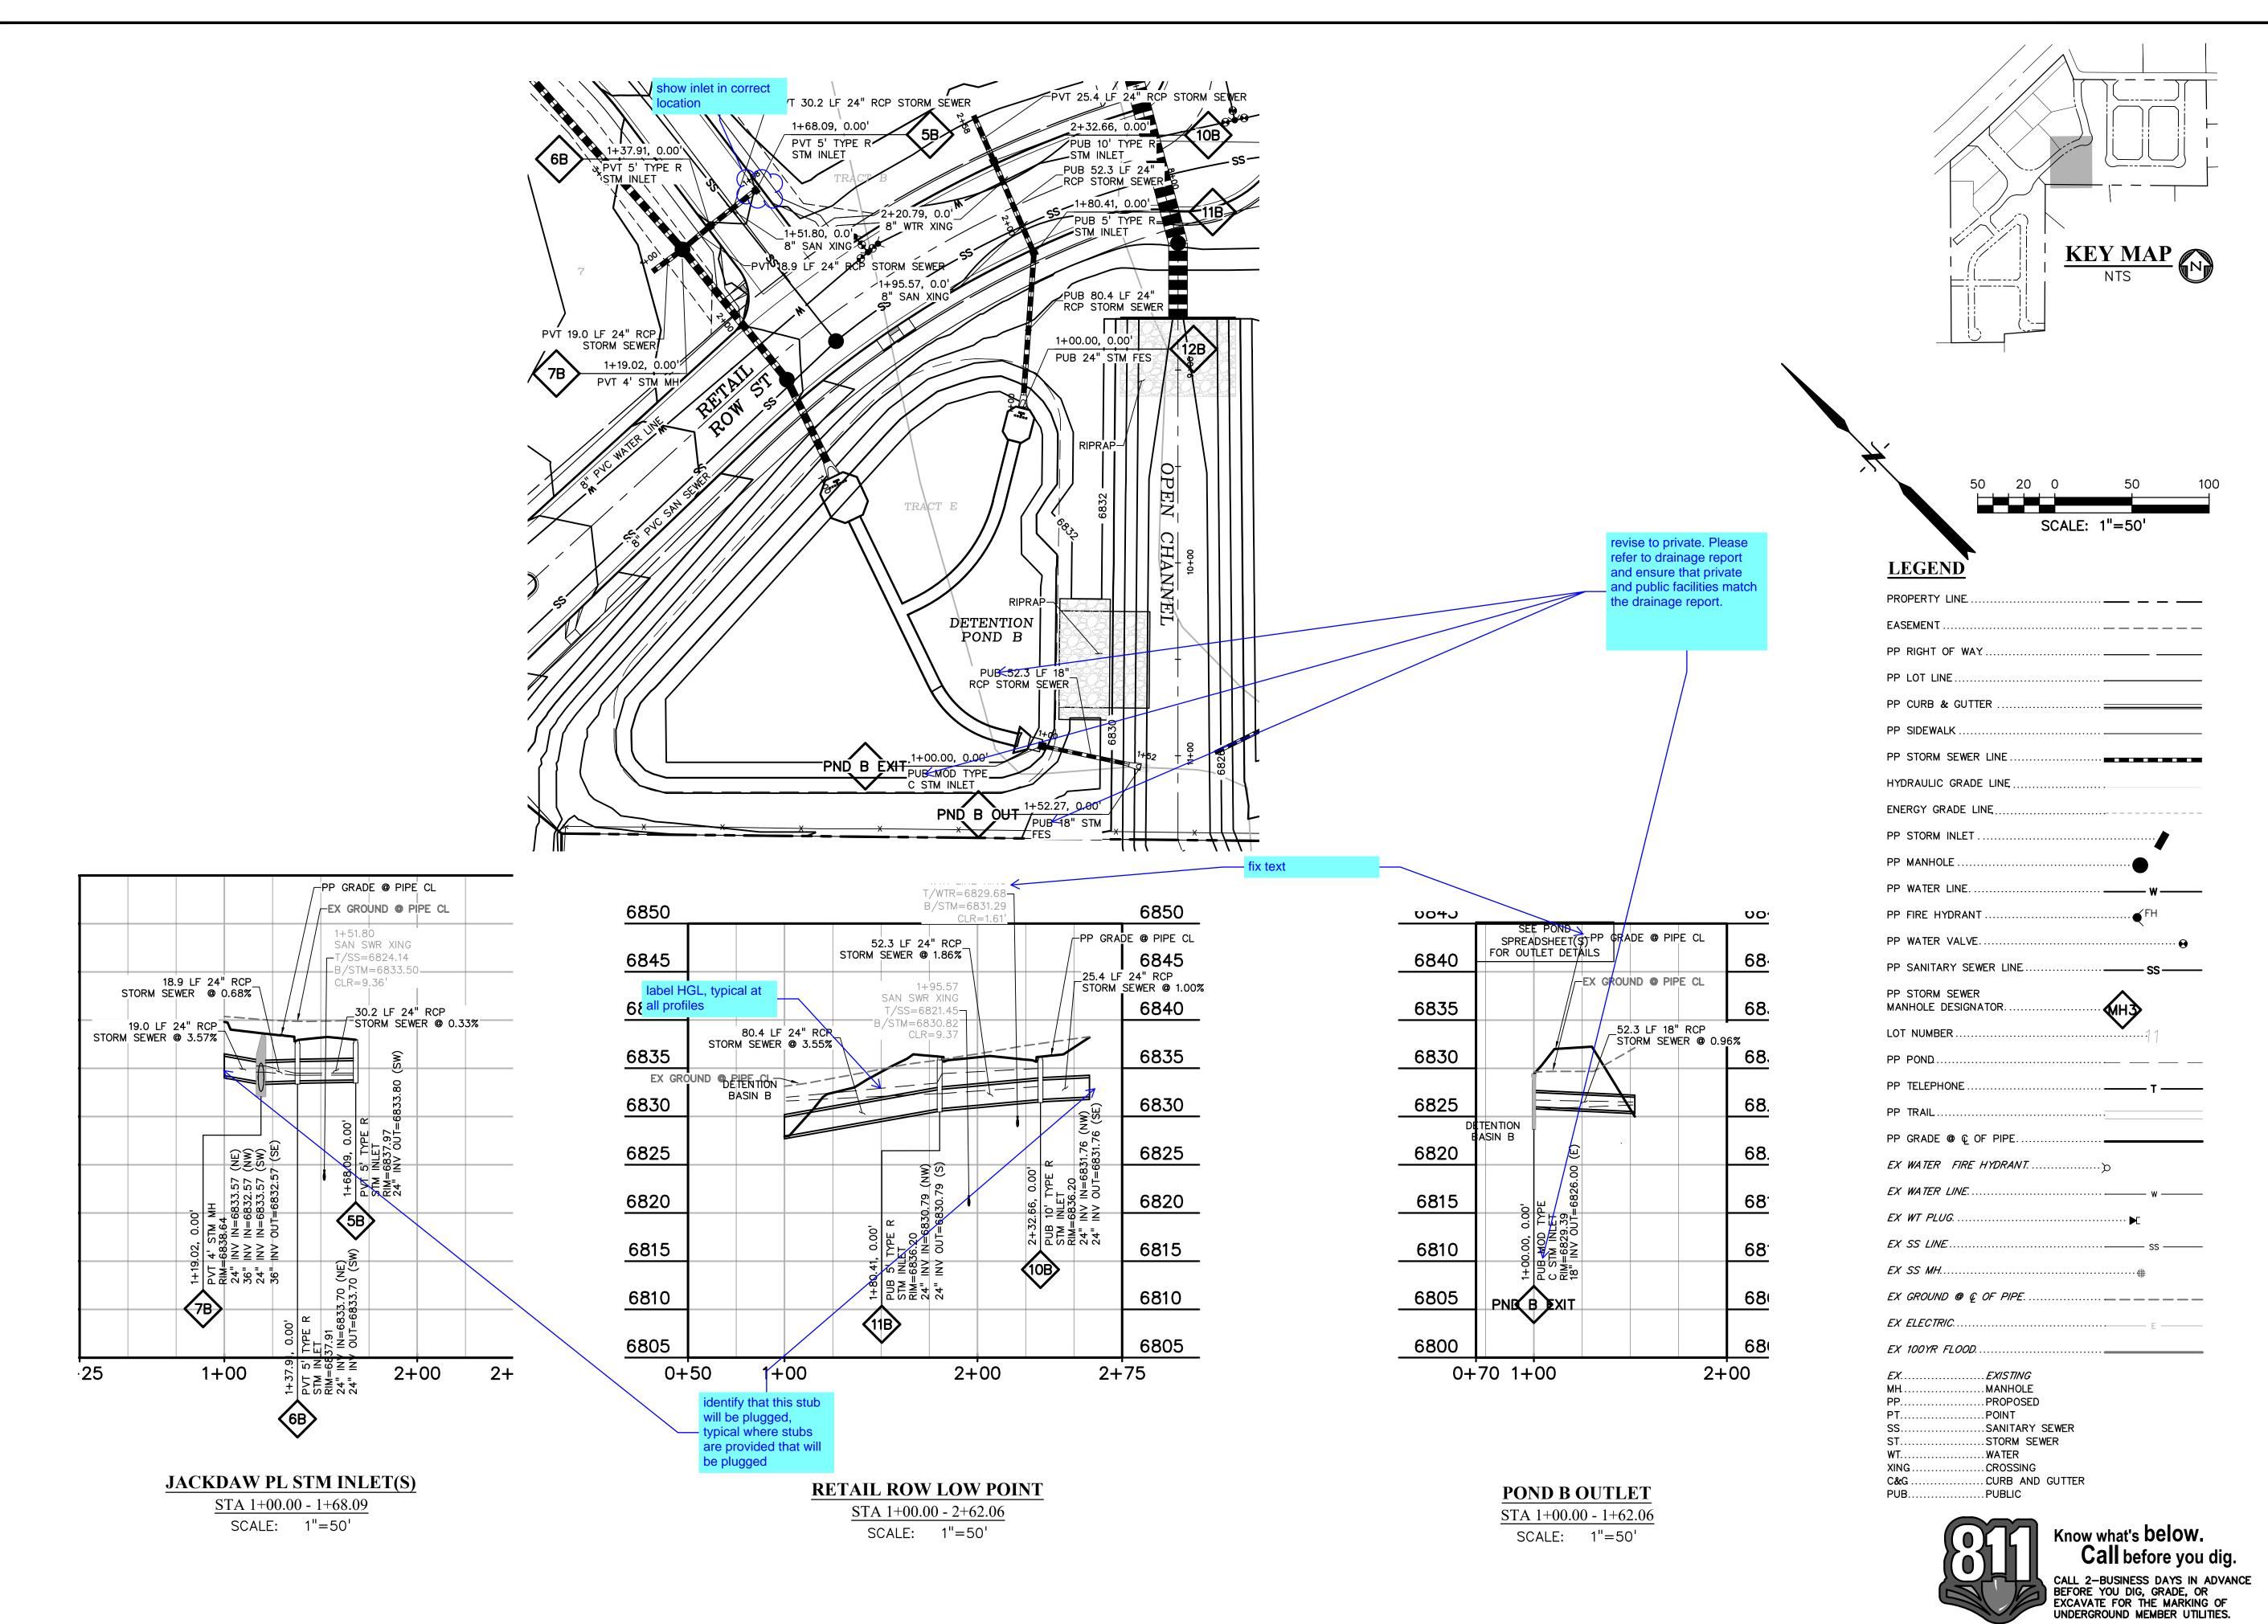

PREPARED BY:

DREXEL, BARRELL & CO.
Engineers • Surveyors
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COLORADO SPGS, COLORADO 80903
CONTACT: TIM D. McCONNELL, P.E.
(719)260-0887
COLORADO SPRINGS • LAFAYETTE

CLIENT:

PROTERRA PROPERTIES

1864 WOODMOOR DRIVE MONUMENT, CO 80132 (719) 476-0800 CONTACT: STEVE ROSSOLL

srossoll@proterraco.com

CONSTRUCTION DOCUMENTS FOR:

THE COMMONS AT FALCON FIELD

12445 RIO LANE, AND VACANT LAND

ISSUE	DATE
INITIAL ISSUE	12/16/24
DESIGNED BY:	KGV
DRAWN BY:	CGH
CHECKED BY:	TDM
FILE NAME: 21	604-STM

PREPARED UNDER MY DIRECT SUPERVISION FOR AND ON BEHALF OF DREXEL, BARRELL & CO.

DRAWING SCALE:
HORIZONTAL: 1" = 50"
VERTICAL: 1" = 10'

STORM SEWER CHANNEL

PLAN & PROFILE


PROJECT NO. 21604-00CSCV

DRAWING NO.

STM3

911419

SHEET: 23 OF 29

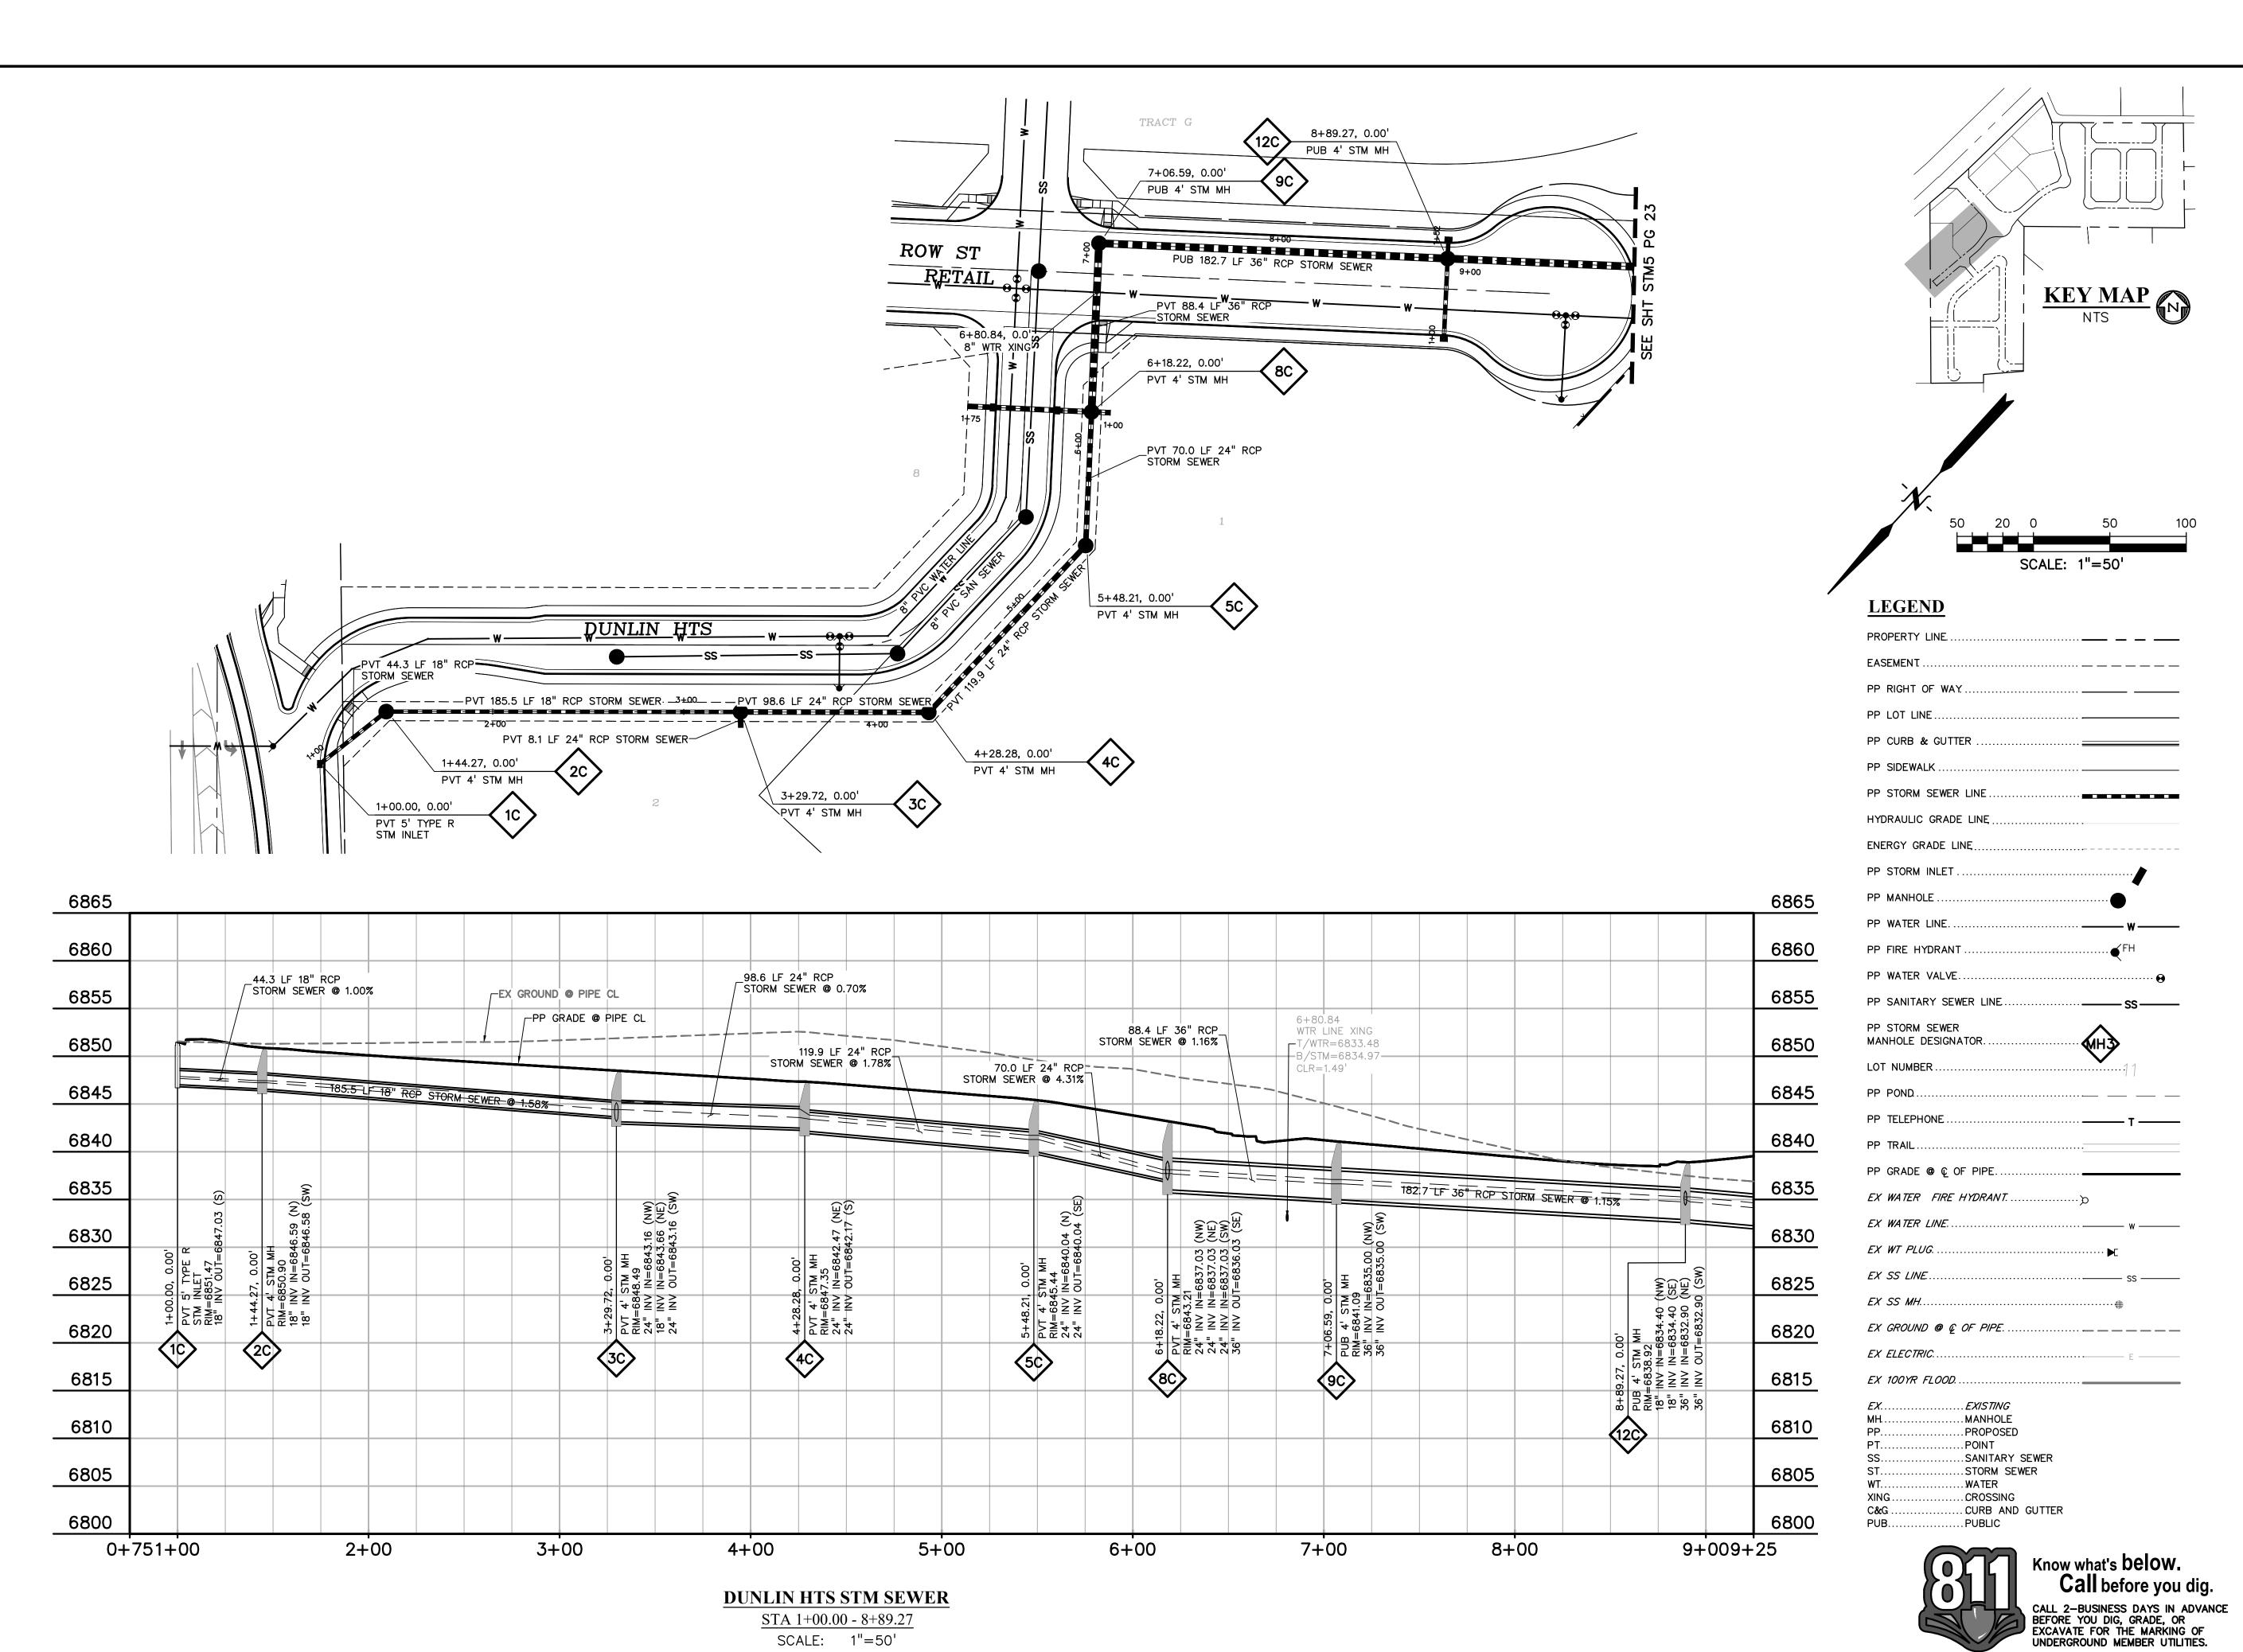

SCALE: 1"=50'

PREPARED BY:

DREXEL, BARRELL & CC

Engineers • Surveyors 101 SAHWATCH ST., SUITE 100 COLORADO SPGS, COLORADO 8090 CONTACT: TIM D. McCONNELL, P.E (719)260-0887 COLORADO SPRINGS • LAFAYETTE

CLIENT:

PROTERRA PROPERTIES

1864 WOODMOOR DRIVE MONUMENT, CO 80132 (719) 476-0800 CONTACT: STEVE ROSSOLL

srossoll@proterraco.com

ALCON FIELD STRUCTION

DATE ISSUE 12/16/24 INITIAL ISSUE DESIGNED BY: KGV DRAWN BY: CHECKED BY: FILE NAME: 21604—STM

PREPARED UNDER MY DIRECT SUPERVISION FOR AND ON BEHALF OF DREXEL, BARRELL & CO.


> DRAWING SCALE: HORIZONTAL: 1" = 50"VERTICAL: 1'' = 10'


STORM SEWER CHANNEL

PLAN & PROFILE PROJECT NO. 21604-00CSCV


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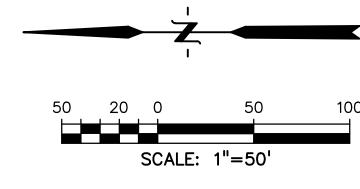
SHEET: 24 OF 29



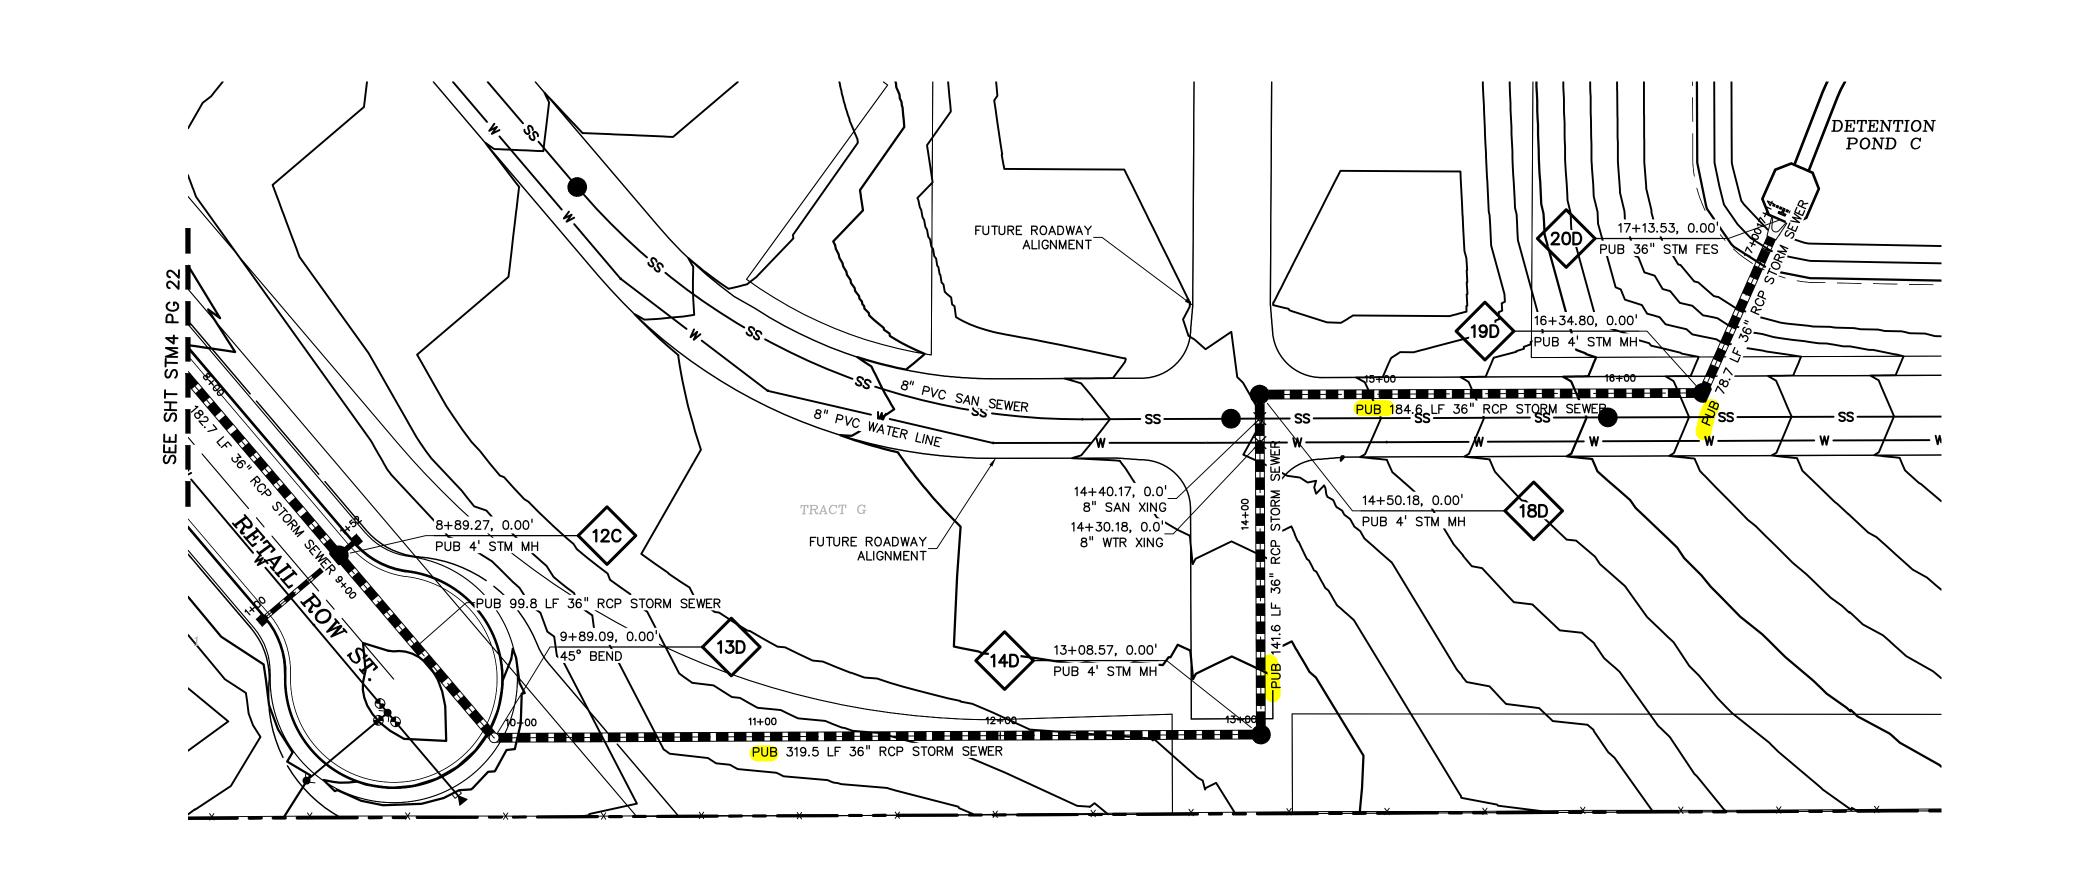

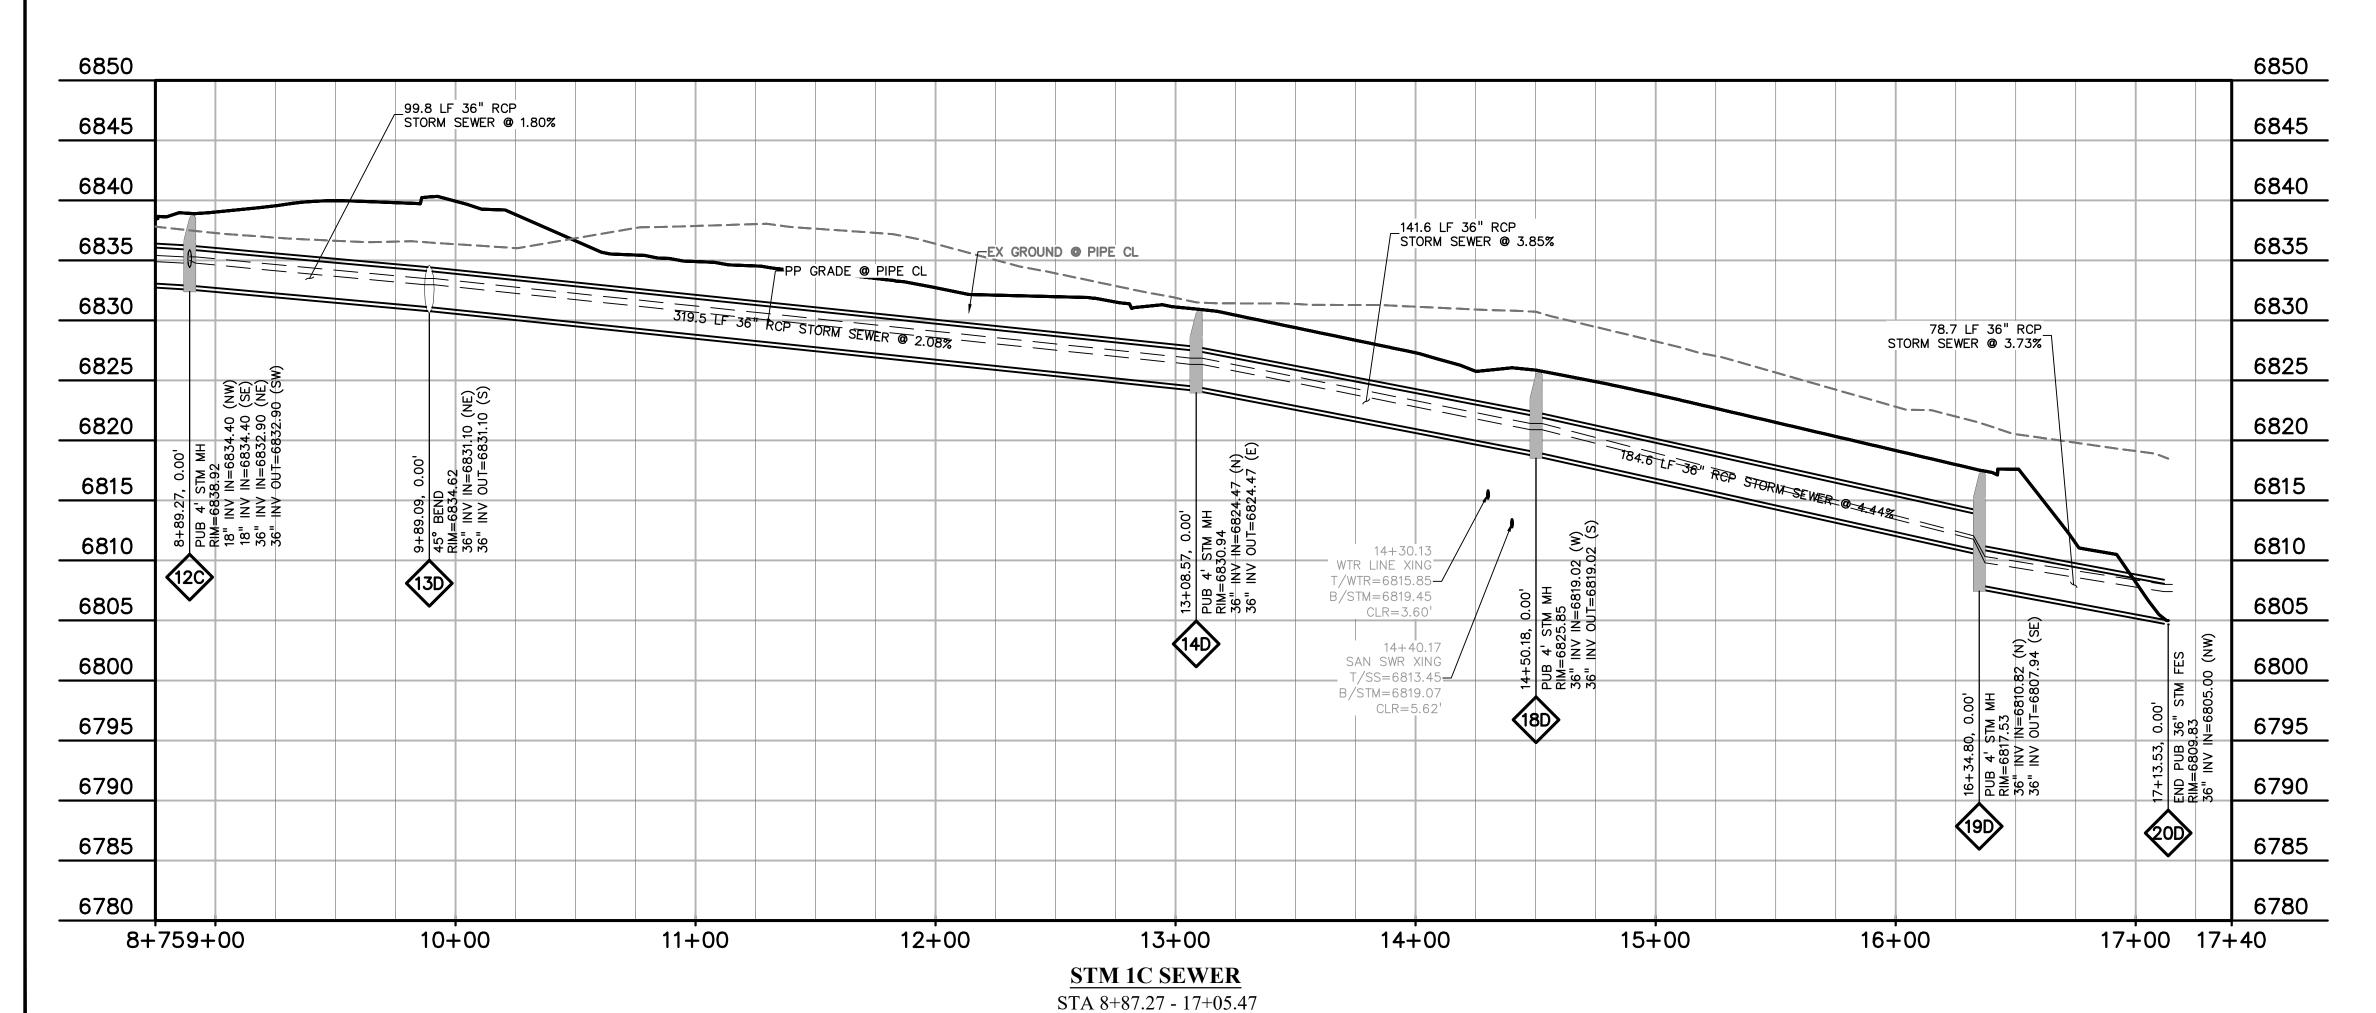SCALE: 1"=50'



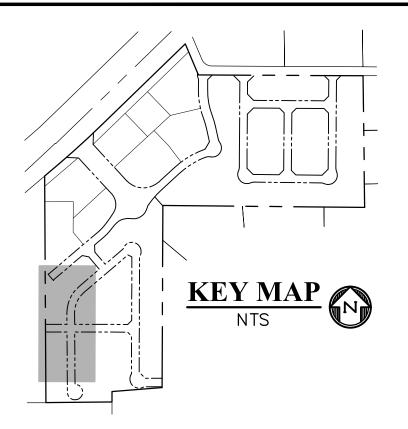

LEGEND

EEGEITE	
PROPERTY LINE	
EASEMENT	
PP RIGHT OF WAY	
PP LOT LINE	
PP CURB & GUTTER	
PP SIDEWALK	
PP STORM SEWER LINE	
HYDRAULIC GRADE LINE	
ENERGY GRADE LINE	
PP STORM INLET	
PP MANHOLE	
PP WATER LINE	w
PP FIRE HYDRANT	∢ FH
PP WATER VALVE	······································
PP SANITARY SEWER LINE	— ss —
PP STORM SEWER MANHOLE DESIGNATOR	13
LOT NUMBER	11
PP POND	
PP TELEPHONE	— т —
PP TRAIL	
PP GRADE @ @ OF PIPE	
EX WATER FIRE HYDRANT	
EX WATER LINE	w
EX WT PLUG	· Þ E
EX SS LINE	ss
EX SS MH	…⊕
EX GROUND @ @ OF PIPE	
EX ELECTRIC	
EX ELECTRIC.	— Е ——



. WATER

. CROSSING

. CURB AND GUTTER

XING..

C&G .

PREPARED BY:

DREXEL, BARRELL & CO.
Engineers • Surveyors
101 SAHWATCH ST., SUITE 100
COLORADO SPGS, COLORADO 80903
CONTACT: TIM D. McCONNELL, P.E

(719)260-0887
COLORADO SPRINGS • LAFAYETTE

CLIENT:

PROTERRA PROPERTIES

1864 WOODMOOR DRIVE MONUMENT, CO 80132 (719) 476-0800 CONTACT: STEVE ROSSOLL srossoll@proterraco.com

THE COMMONS AT FALCON FIELD 12445 RIO LANE, AND VACANT LAND PEYTON, EL PASO COUNTY, COLORADO

NSTRUCTION

ISSUE	DATE
INITIAL ISSUE	12/16/24
DESIGNED BY:	KGV
DESIGNED BY: DRAWN BY:	KGV CGH
DRAWN BY: CHECKED BY:	CGH

DRAWING SCALE:
HORIZONTAL: 1" = 50"
VERTICAL: 1" = 10'

STORM SEWER


CHANNEL


PLAN & PROFILE


PROJECT NO. 21604-00CSCV
DRAWING NO.


STM5

SHEET: 25 OF 29

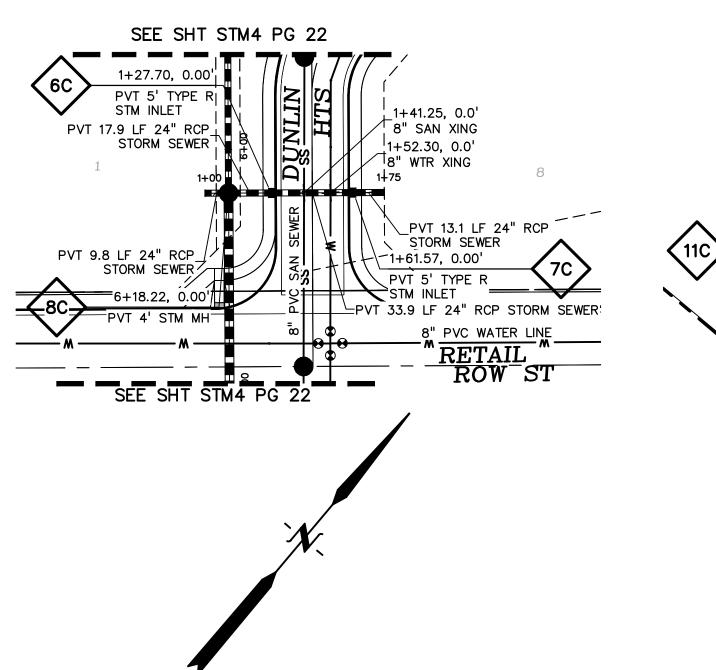

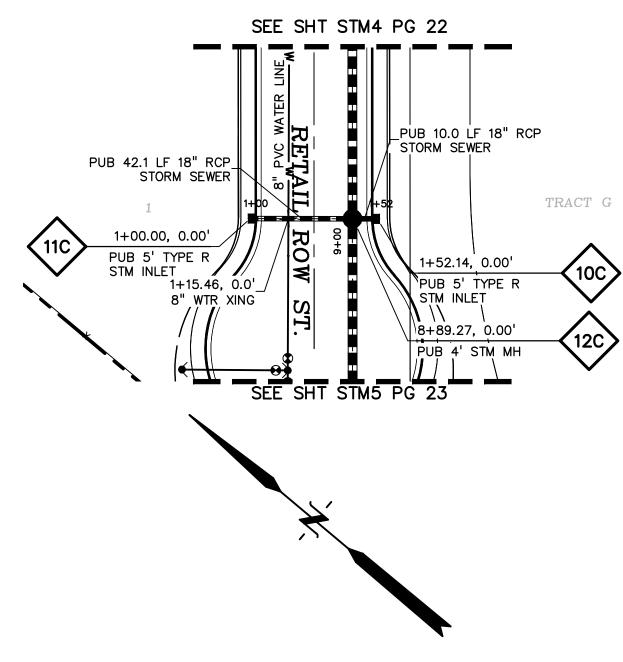

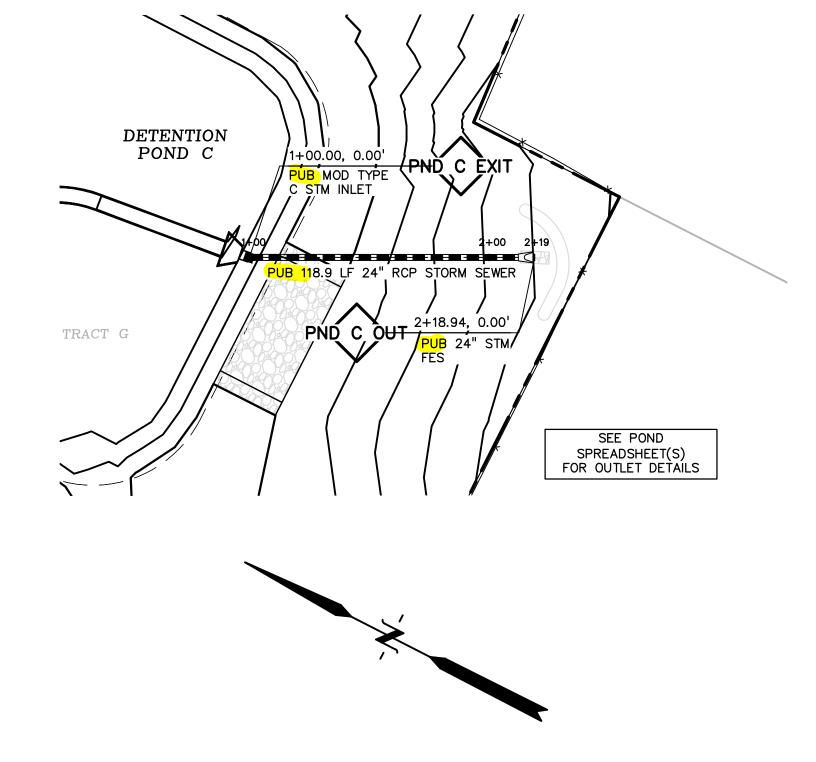

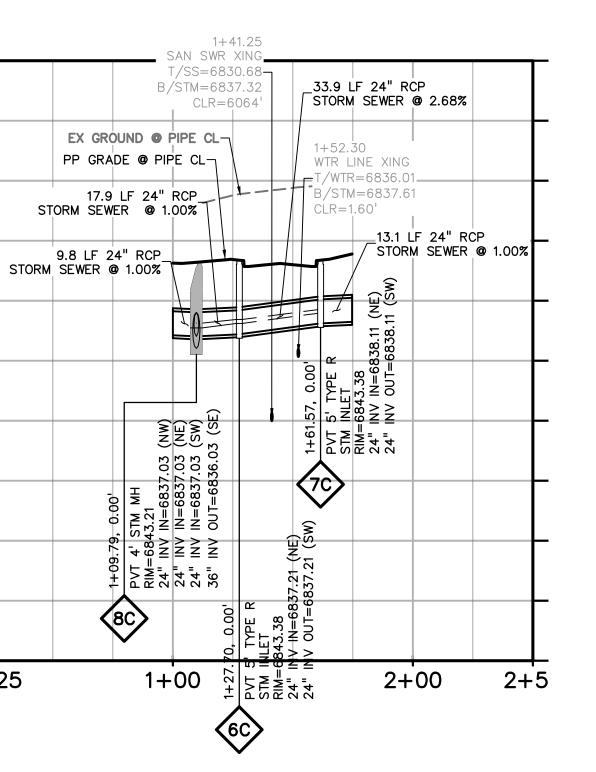


DUNLIN HTS STM INLET


STA 1+00.00 - 1+74.68

SCALE: 1"=50'


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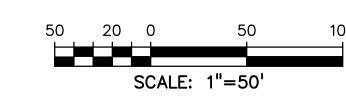


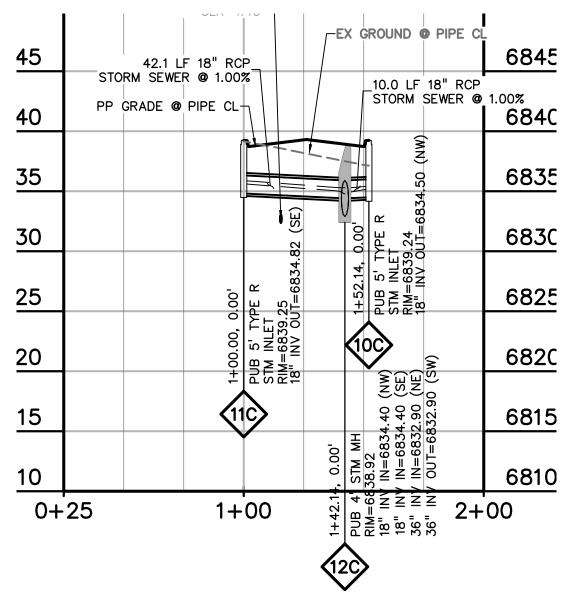

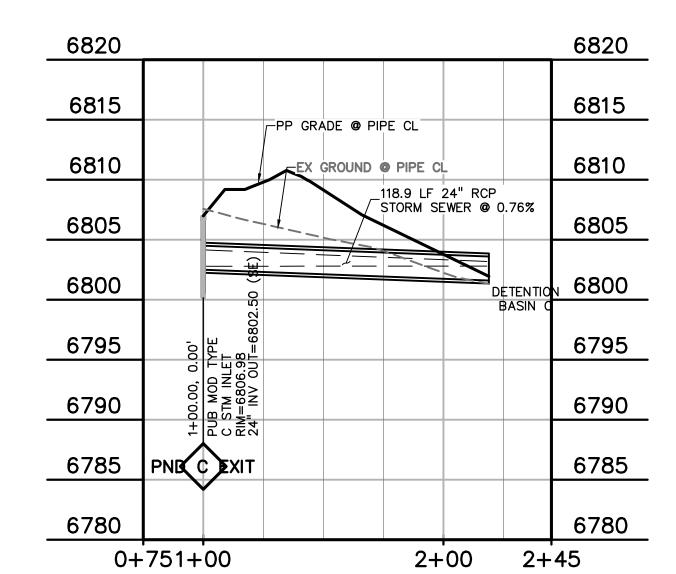

POND C OUTFALL STA 1+00.00 - 2+62.06 SCALE: 1"=50'



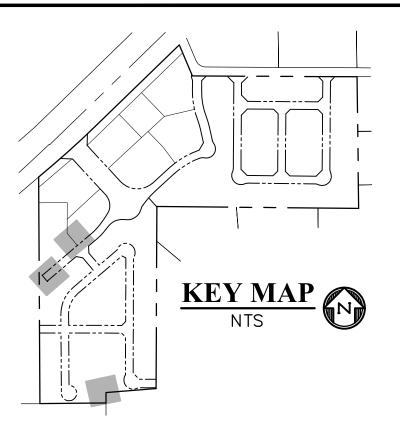

LEGEND

PROPERTY LINE	
EASEMENT	- — —
PP RIGHT OF WAY	
PP LOT LINE	
PP CURB & GUTTER	
PP SIDEWALK	
PP STORM SEWER LINE	
HYDRAULIC GRADE LINE	
ENERGY GRADE LINE	
PP STORM INLET	
PP MANHOLE	
PP WATER LINE W	
PP FIRE HYDRANT	
PP WATER VALVE	⊖
PP SANITARY SEWER LINESS-	
PP STORM SEWER MANHOLE DESIGNATOR	
LOT NUMBER	
PP POND	
PP TELEPHONE T —	
PP TRAIL	
PP GRADE @ C OF PIPE	
EX WATER FIRE HYDRANT	
EX WATER LINE w —	
EX WT PLUG▶	
<i>EX SS LINE</i> ss –	
<i>EX SS MH.</i>	
EX GROUND @ Q OF PIPE	
<i>EX ELECTRIC</i> E —	
EX 100YR FLOOD	
EX. EXISTING MH. MANHOLE PP. PROPOSED PT. POINT SS. SANITARY SEWER ST. STORM SEWER	



. CROSSING

. CURB AND GUTTER

PREPARED BY:

DREXEL, BARRELL & CC Engineers • Surveyors
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COLORADO SPGS, COLORADO 80903 CONTACT: TIM D. McCONNELL, P.I (719)260-0887
COLORADO SPRINGS • LAFAYETTE

CLIENT:

PROTERRA PROPERTIES

1864 WOODMOOR DRIVE MONUMENT, CO 80132 (719) 476-0800 CONTACT: STEVE ROSSOLL srossoll@proterraco.com

ALCON FIELD NSTRUCTION

ISSUE DATE INITIAL ISSUE 12/16/24 DESIGNED BY: KGV DRAWN BY: CGH CHECKED BY: TDM TILE NAME: 21604—STM PREPARED UNDER MY DIRECT SUPERVISION FOR AND ON BEHALF OF DREXEL, BARRELL & CO.		
DESIGNED BY: KGV DRAWN BY: CGH CHECKED BY: TDM ILE NAME: 21604—STM PREPARED UNDER MY DIRECT SUPERVISION FOR AND ON BEHALF OF	ISSUE	DATE
DRAWN BY: CGH CHECKED BY: TDM ILE NAME: 21604—STM PREPARED UNDER MY DIRECT SUPERVISION FOR AND ON BEHALF OF	INITIAL ISSUE	12/16/24
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CHECKED BY: TDM TILE NAME: 21604—STM PREPARED UNDER MY DIRECT SUPERVISION FOR AND ON BEHALF OF	DESIGNED BY:	KGV
PREPARED UNDER MY DIRECT SUPERVISION FOR AND ON BEHALF OF	DRAWN BY:	CGH
PREPARED UNDER MY DIRECT SUPERVISION FOR AND ON BEHALF OF	CHECKED BY:	TDM
SUPERVISION FOR AND ON BEHALF OF	ILE NAME: 21	604-STM

STORM SEWER CHANNEL


DRAWING SCALE: HORIZONTAL: 1" = 50"

VERTICAL: 1'' = 10'

PLAN & PROFILE


PROJECT NO. 21604-00CSCV DRAWING NO.

SHEET: 26 OF 29

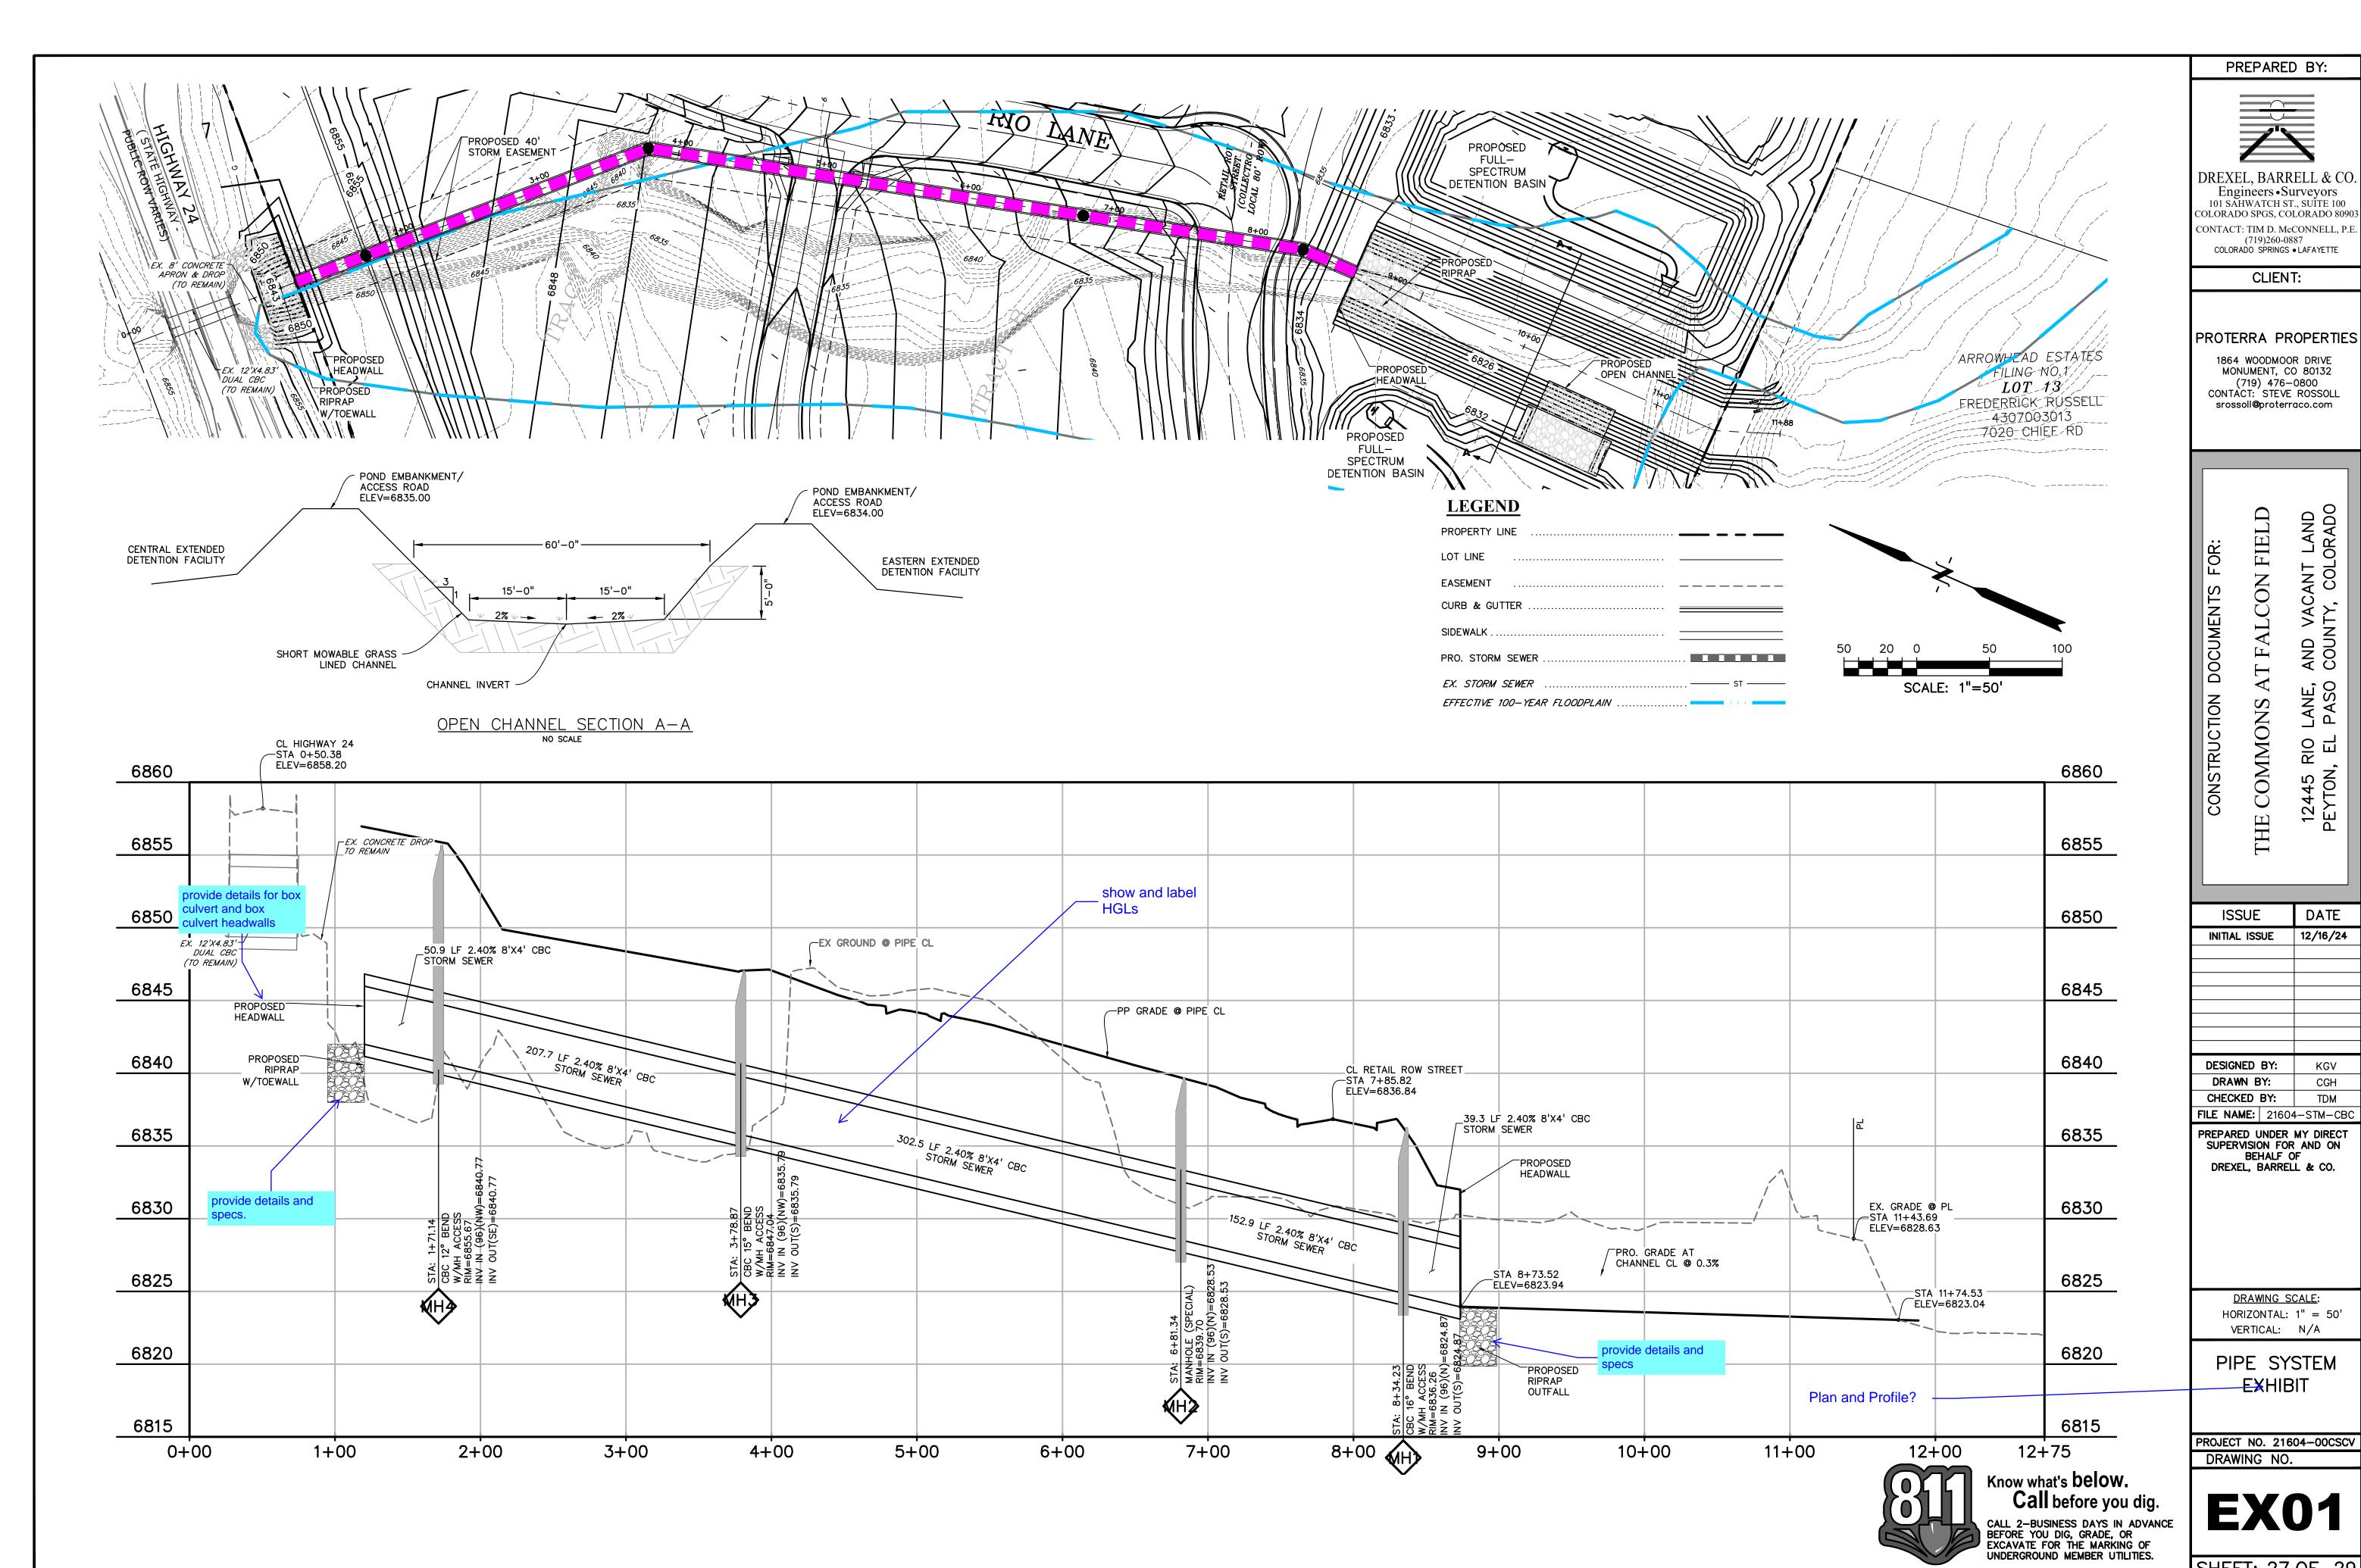

ISSUE	•	DATE
INITIAL ISS	SUE	12/16/24
DESIGNED	BY:	KGV
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CHECKED	BY:	TDM
FILE NAME:	21604	1-STM-CBC
PREPARED UNDER MY DIRECT SUPERVISION FOR AND ON BEHALF OF DREXEL, BARRELL & CO.		


SHEET: 27 OF 29

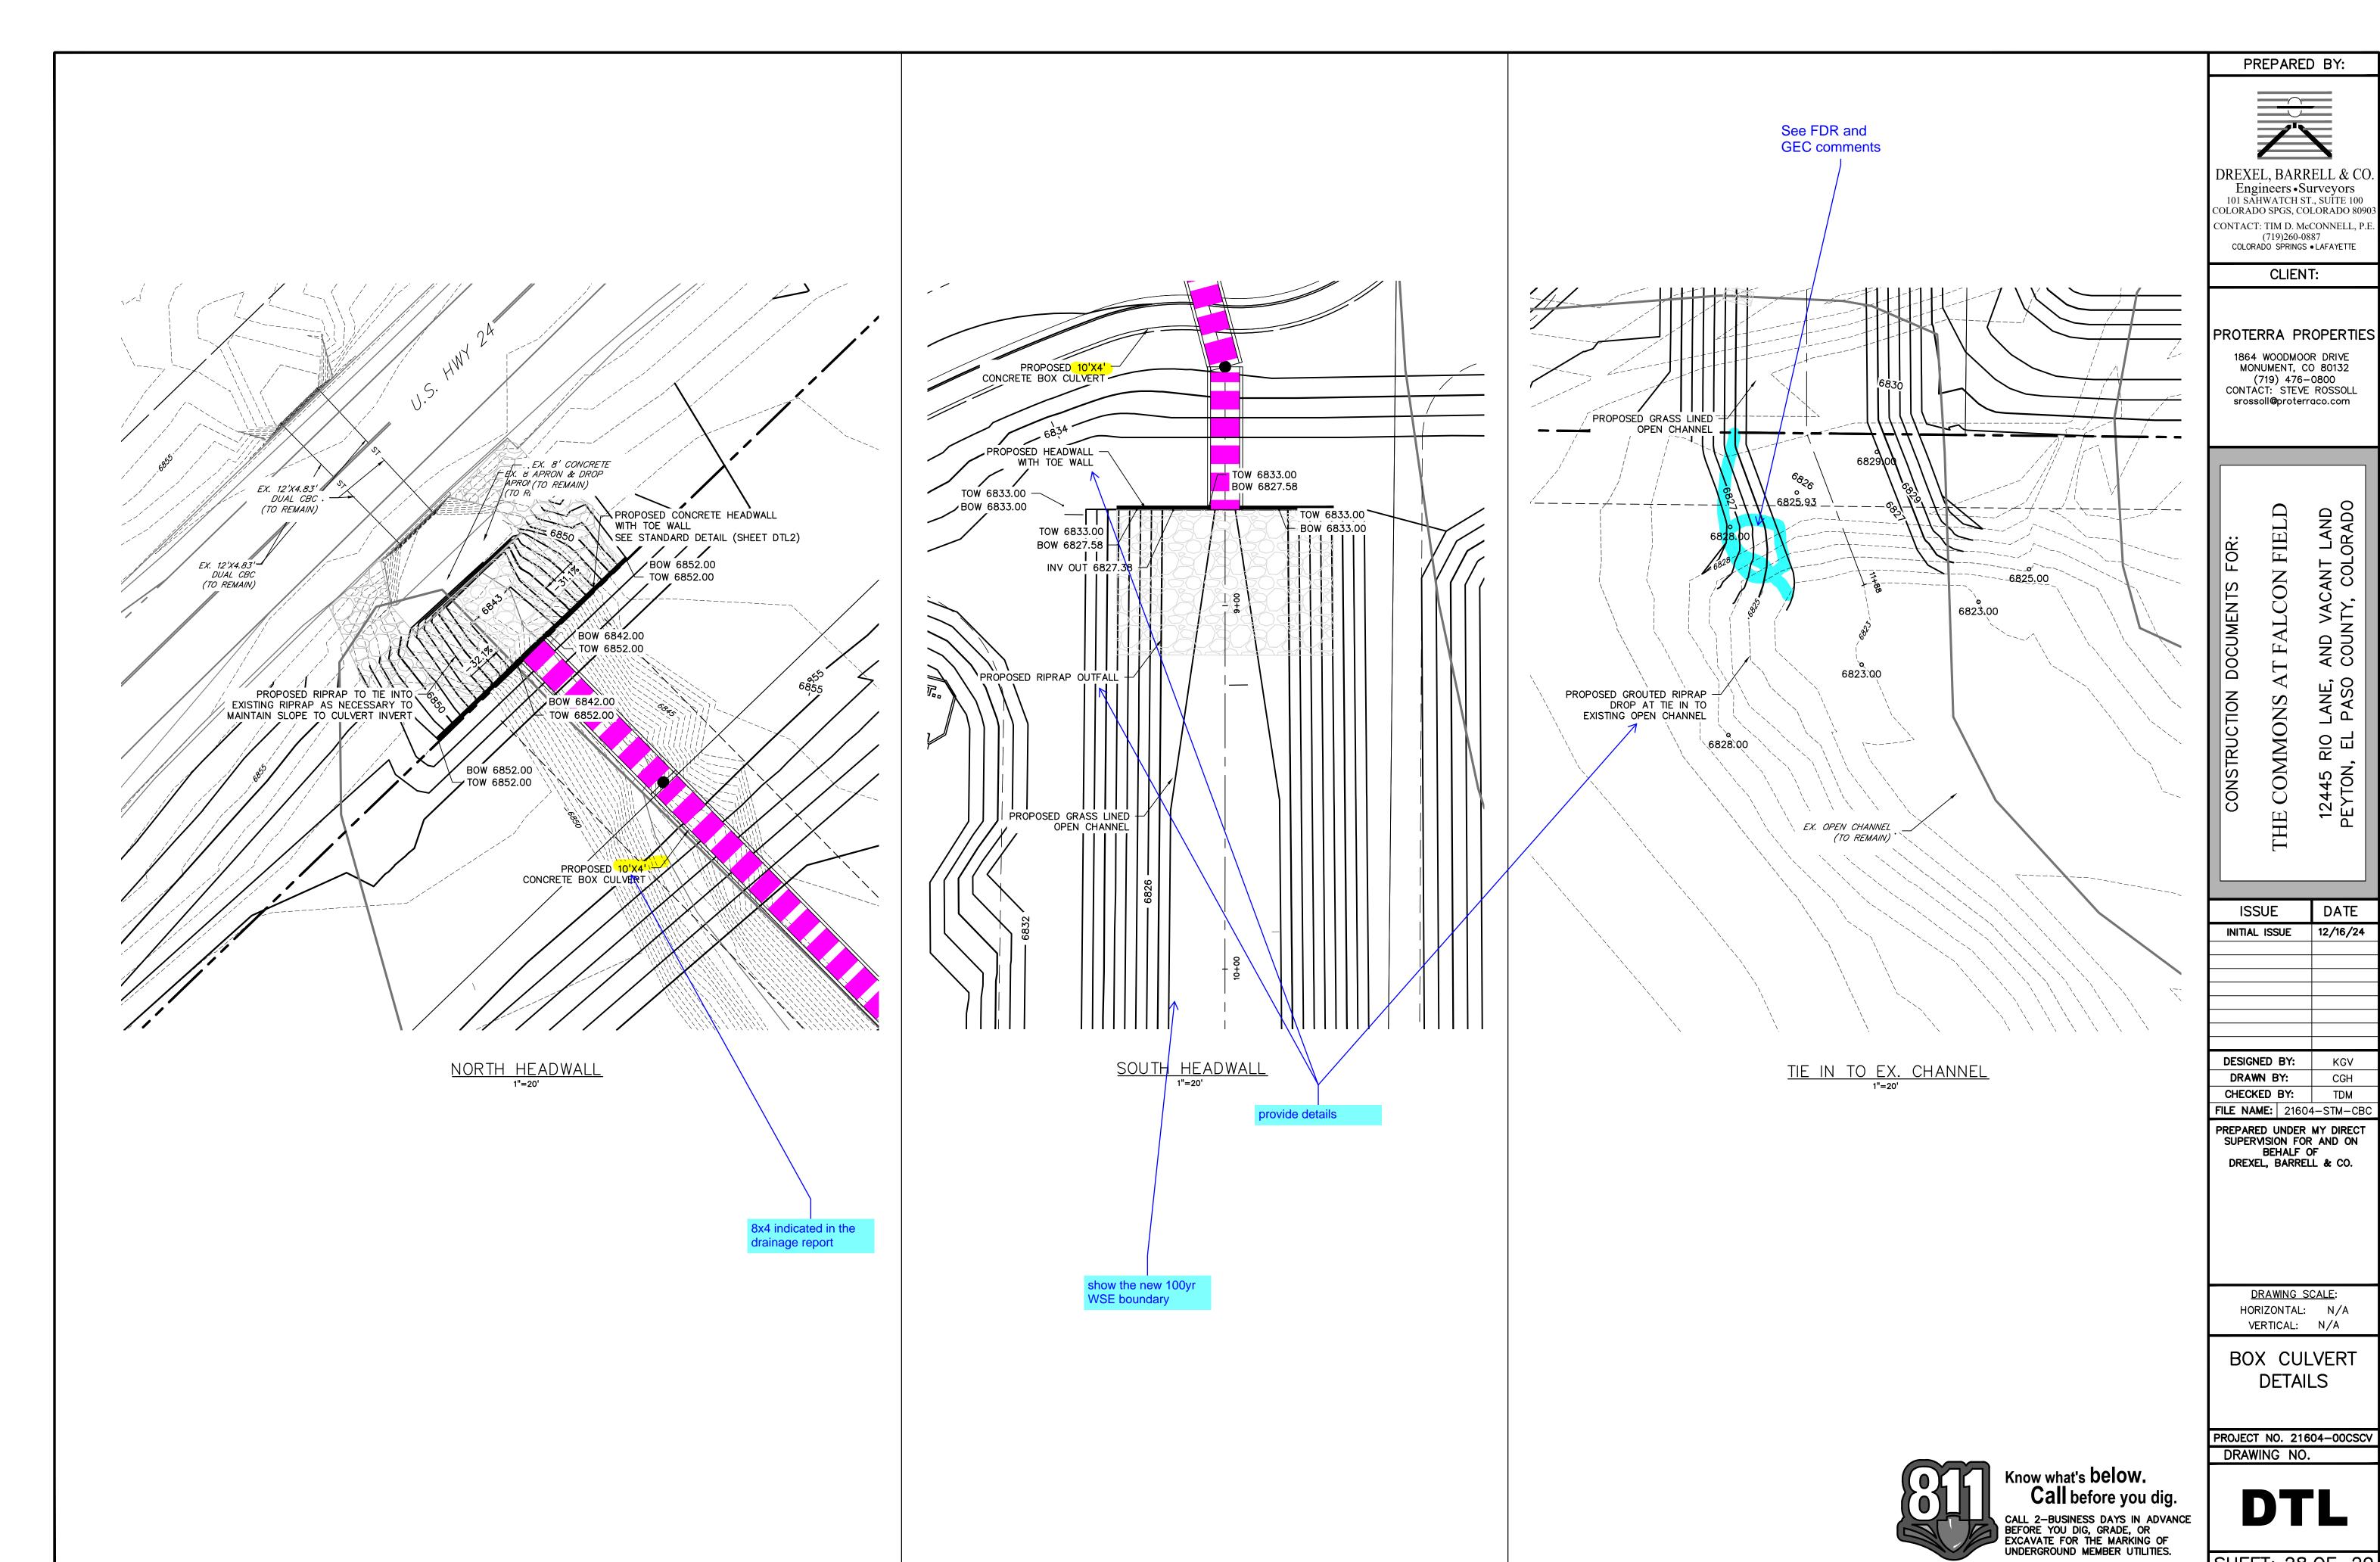



ISSUE	DATE
INITIAL ISSUE	12/16/24


DESIGNED	BY:	KGV
DRAWN E	BY:	CGH
CHECKED BY:		TDM
IF NAME.	21604	L_STM_CRC

SHEET: 28 OF 29

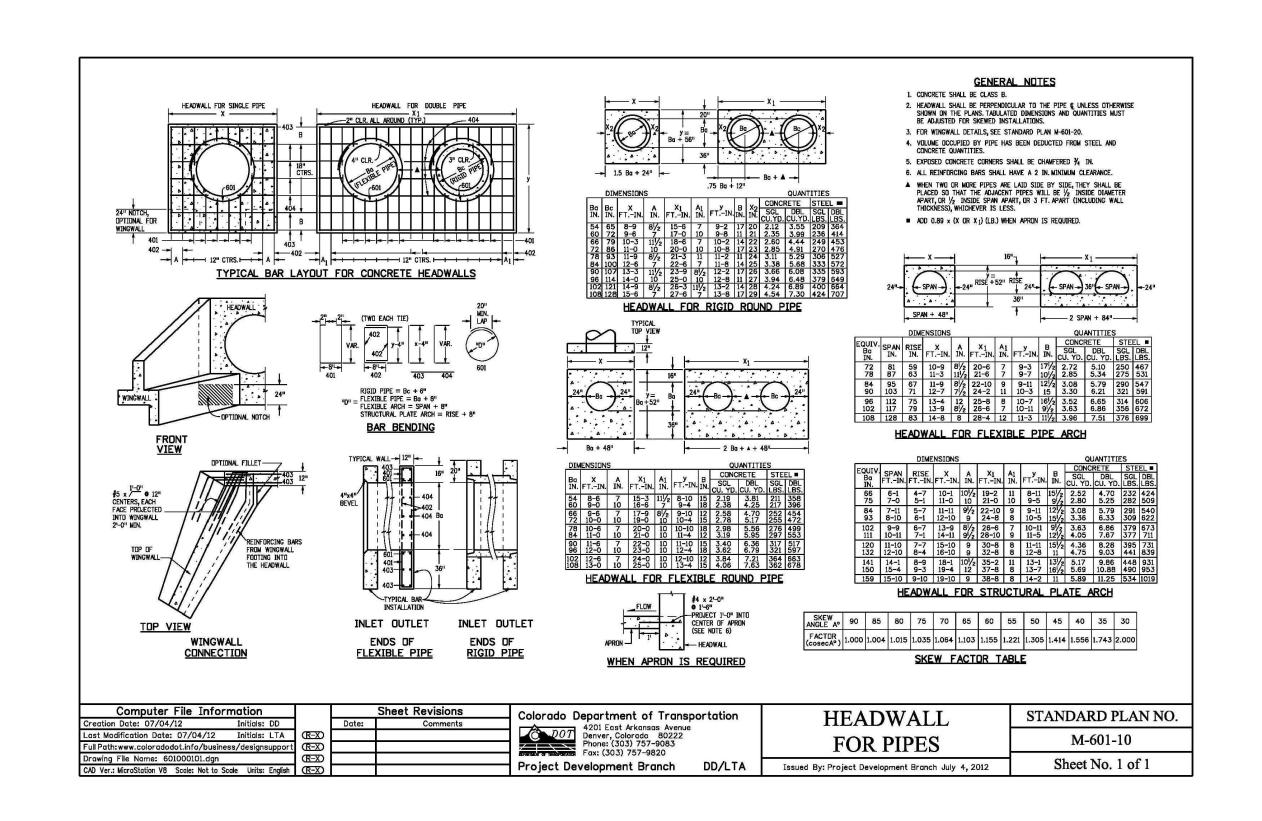

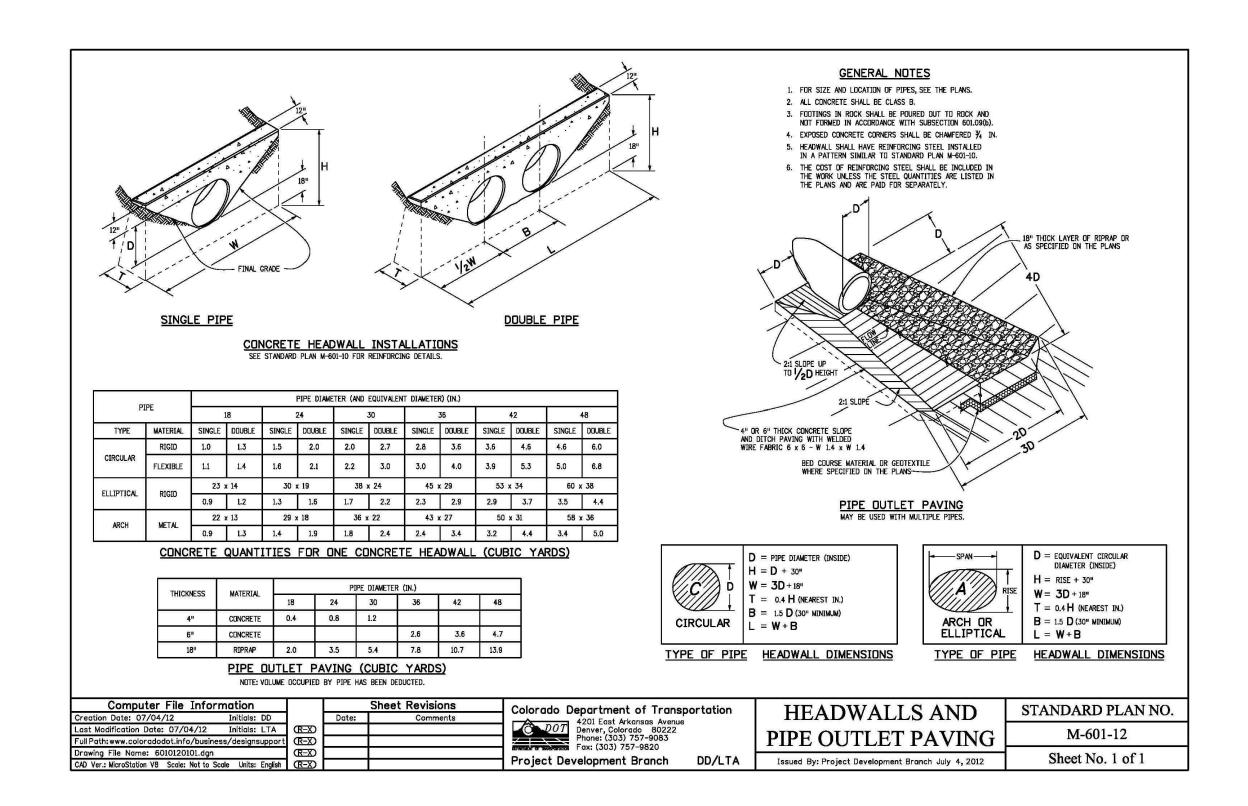

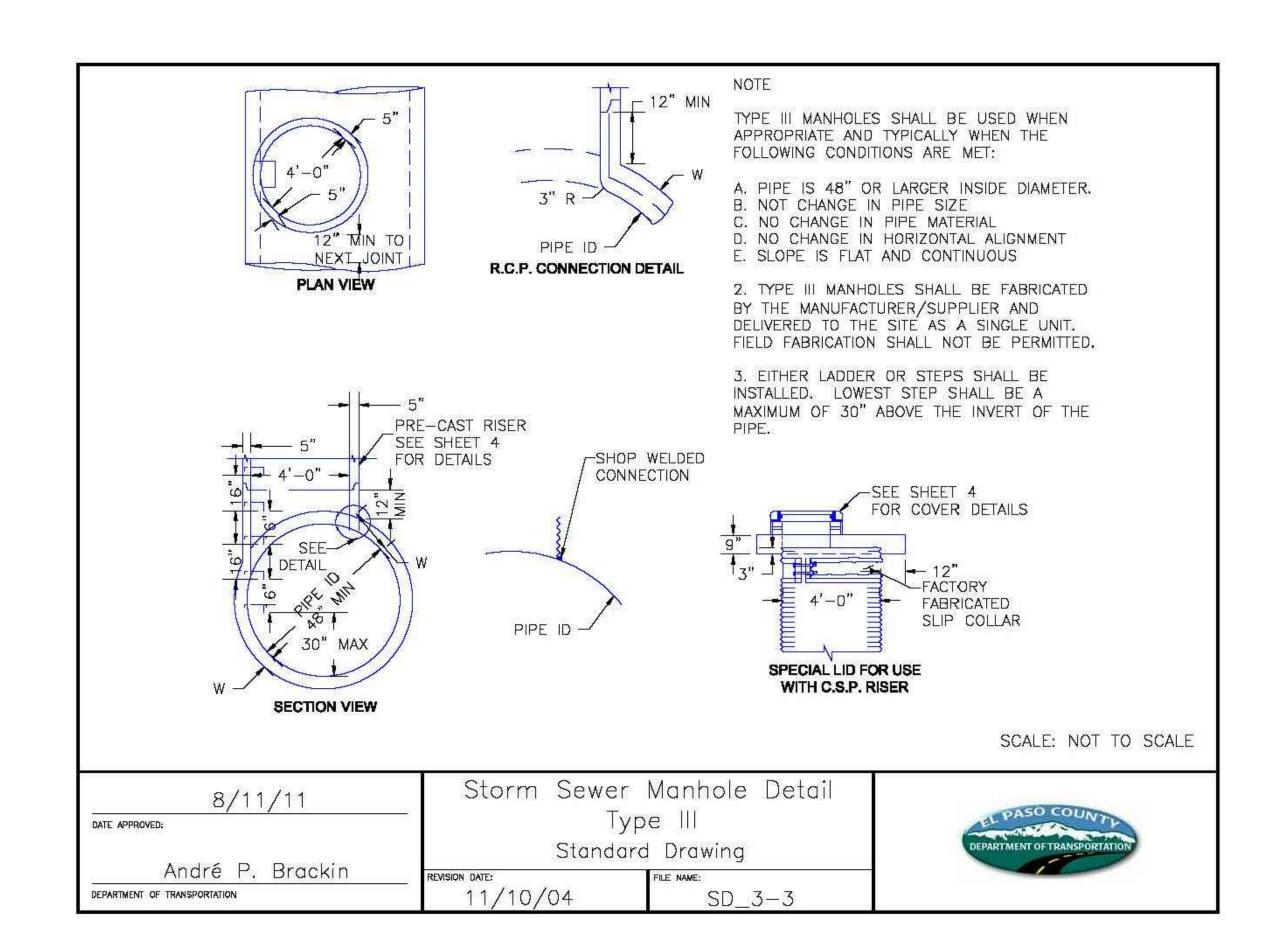

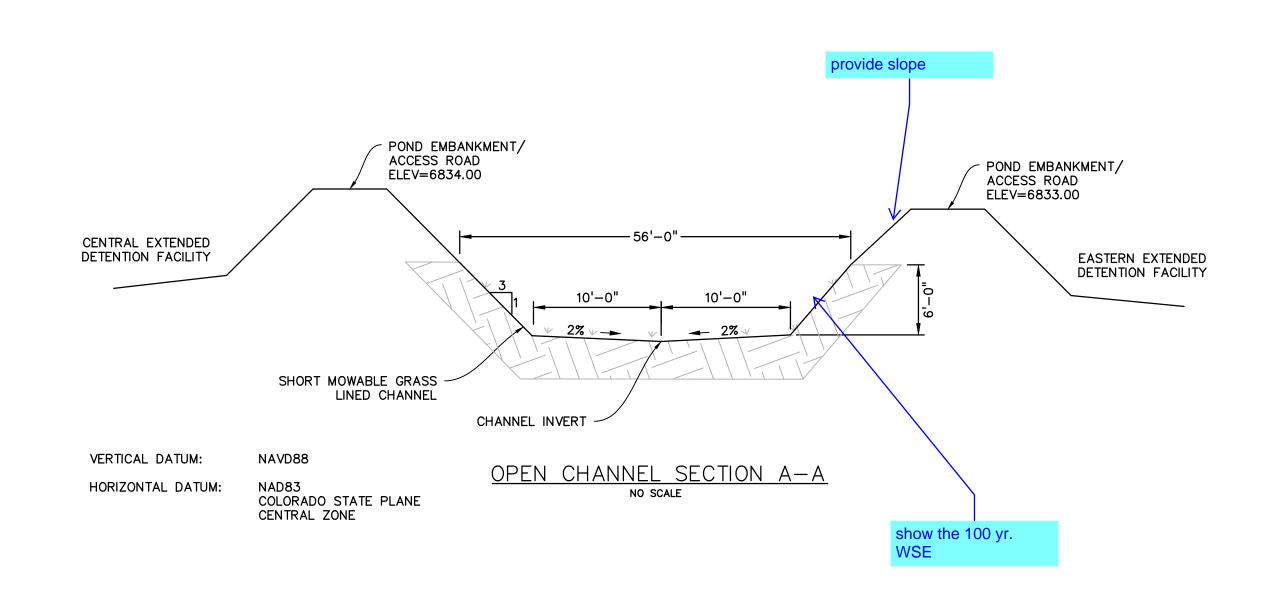



PREPARED BY:

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ISSUE	DATE	
INITIAL ISSUE	12/16/24	
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DRAWN BY:	CGH	
CHECKED BY:	TDM	
FILE NAME: 21604	1-STM-CB	
PREPARED UNDER MY DIRECT SUPERVISION FOR AND ON BEHALF OF DREXEL, BARRELL & CO.		

DRAWING SCALE:
HORIZONTAL: N/A
VERTICAL: N/A

DETAILS

PROJECT NO. 21604-00CSCV

DRAWING NO.

DTL2

SHEET: 29 OF 29