

# HANNAH RIDGE AT FEATHERGRASS FILING NO. 3

COUNTY OF EL PASO, STATE OF COLORADO

## OVERLOT GRADING AND EROSION CONTROL PLAN

APRIL 2017

### GENERAL CONSTRUCTION NOTES:

- IT SHALL BE THE RESPONSIBILITY OF THE CONTRACTOR TO VERIFY THE EXISTENCE AND LOCATION OF ALL UNDERGROUND UTILITIES ALONG THE ROUTE OF THE WORK. THE OMISSION FROM OR THE INCLUSION OF UTILITY LOCATIONS ON THE PLANS IS NOT TO BE CONSIDERED AS THE NONEXISTENCE OF OR A DEFINITE LOCATION OF EXISTING UNDERGROUND UTILITIES.
- THE CONTRACTOR WILL TAKE THE NECESSARY PRECAUTIONS TO PROTECT EXISTING UTILITIES FROM DAMAGE DUE TO THIS OPERATION. ANY DAMAGE TO THE UTILITIES WILL BE REPAIRED AT THE CONTRACTOR'S EXPENSE, AND ANY SERVICE DISRUPTION WILL BE SETTLED BY THE CONTRACTOR.
- ADDITIONAL EROSION CONTROL STRUCTURES MAY BE REQUIRED AT THE TIME OF CONSTRUCTION.
- ALL BACKFILL, SUB-BASE AND/OR BASE COURSE (CLASS 6) MATERIAL SHALL BE COMPACTED TO THE SOILS ENGINEER'S RECOMMENDATIONS, AND APPROVED BY EL PASO COUNTY DEVELOPMENT SERVICES ENGINEERING DIVISION.
- TYPE L RIP-RAP WITH MIRAFI FW 700 OR EQUAL IS REQUIRED UNDER ALL RIP-RAP PADS.
- ALL MATERIALS AND INSTALLATION PROCEDURES SHALL BE IN COMPLIANCE WITH ANY AND ALL APPLICABLE EL PASO COUNTY STANDARDS.

### EL PASO COUNTY GRADING AND EROSION CONTROL NOTES:

- CONSTRUCTION MAY NOT COMMENCE UNTIL A CONSTRUCTION PERMIT IS OBTAINED FROM "PLANNING AND COMMUNITY DEVELOPMENT" AND A PRECONSTRUCTION CONFERENCE IS HELD WITH "PLANNING AND COMMUNITY DEVELOPMENT" INSPECTIONS.
- STORMWATER DISCHARGES FROM CONSTRUCTION SITES SHALL NOT CAUSE OR THREATEN TO CAUSE POLLUTION, CONTAMINATION, OR DEGRADATION OF STATE WATERS. ALL WORK AND EARTH DISTURBANCE SHALL BE DONE IN A MANNER THAT MINIMIZES POLLUTION OF ANY ON-SITE OR OFF SITE WATERS, INCLUDING WETLANDS.
- NOTWITHSTANDING ANYTHING DEPICTED IN THESE PLANS IN WORDS OR GRAPHIC REPRESENTATION, ALL DESIGN AND CONSTRUCTION RELATED TO ROADS, STORM DRAINAGE AND EROSION CONTROL SHALL CONFORM TO THE STANDARDS AND REQUIREMENTS OF THE MOST RECENT VERSION OF THE RELEVANT ADOPTED EL PASO COUNTY STANDARDS, INCLUDING THE LAND DEVELOPMENT CODE, THE ENGINEERING CRITERIA MANUAL, THE DRAINAGE CRITERIA MANUAL, AND THE DRAINAGE CRITERIA MANUAL VOLUME 2. ANY DEVIATIONS TO REGULATIONS AND STANDARDS MUST BE REQUESTED, AND APPROVED, IN WRITING.
- A SEPARATE STORMWATER MANAGEMENT PLAN (SWMP) FOR THIS PROJECT SHALL BE COMPLETED AND AN EROSION AND STORMWATER QUALITY CONTROL PERMIT (ESQCP) ISSUED PRIOR TO COMMENCING CONSTRUCTION. DURING CONSTRUCTION THE SWMP IS THE RESPONSIBILITY OF THE DESIGNATED STORMWATER MANAGER, SHALL BE LOCATED ON SITE AT ALL TIMES AND SHALL BE KEPT UP TO DATE WITH WORK PROGRESS AND CHANGES IN THE FIELD.
- ONCE THE ESQCP HAS BEEN ISSUED, THE CONTRACTOR MAY INSTALL THE INITIAL STAGE EROSION AND SEDIMENT CONTROL BMPs AS INDICATED ON THE GEC. A PRECONSTRUCTION MEETING BETWEEN THE CONTRACTOR, ENGINEER, AND EL PASO COUNTY WILL BE HELD PRIOR TO ANY CONSTRUCTION. IT IS THE RESPONSIBILITY OF THE APPLICANT TO COORDINATE THE MEETING TIME AND PLACE WITH COUNTY "PLANNING AND COMMUNITY DEVELOPMENT" INSPECTIONS STAFF.
- SOIL EROSION CONTROL MEASURES FOR ALL SLOPES, CHANNELS, DITCHES, OR ANY DISTURBED LAND AREA SHALL BE COMPLETED WITHIN 21 CALENDAR DAYS AFTER FINAL GRADING, OR FINAL EARTH DISTURBANCE, HAS BEEN COMPLETED. DISTURBED AREAS AND STOCKPILES WHICH ARE NOT AT FINAL GRADE BUT WILL REMAIN DOMINANT FOR MORE THAN 30 DAYS SHALL BE MULCHED WITHIN 21 DAYS AFTER INTERIM GRADING. AN AREA THAT IS GOING TO REMAIN IN AN INTERIM STATE FOR MORE THAN 60 DAYS SHALL ALSO BE SEEDED. ALL TEMPORARY SOIL EROSION CONTROL MEASURES AND BMPs SHALL BE MAINTAINED UNTIL PERMANENT SOIL EROSION CONTROL MEASURES ARE IMPLEMENTED AND ESTABLISHED.
- TEMPORARY SOIL EROSION CONTROL FACILITIES SHALL BE REMOVED AND EARTH DISTURBANCE AREAS GRADED AND STABILIZED WITH PERMANENT SOIL EROSION CONTROL MEASURES PURSUANT TO STANDARDS AND SPECIFICATION PRESCRIBED IN THE DCM VOLUME II AND THE ENGINEERING CRITERIA MANUAL (ECM) APPENDIX I.
- ALL PERSONS ENGAGED IN EARTH DISTURBANCE SHALL IMPLEMENT AND MAINTAIN ACCEPTABLE SOIL EROSION AND SEDIMENT CONTROL MEASURES INCLUDING BMPs IN CONFORMANCE WITH THE EROSION CONTROL TECHNICAL STANDARDS OF THE DRAINAGE CRITERIA MANUAL (DCM) VOLUME II AND IN ACCORDANCE WITH THE STORMWATER MANAGEMENT PLAN (SWMP).
- ALL TEMPORARY EROSION CONTROL FACILITIES INCLUDING BMPs AND ALL PERMANENT FACILITIES INTENDED TO CONTROL EROSION OF ANY EARTH DISTURBANCE OPERATIONS, SHALL BE INSTALLED AS DEFINED IN THE APPROVED PLANS, THE SWMP AND THE DCM VOLUME II AND MAINTAINED THROUGHOUT THE DURATION OF THE EARTH DISTURBANCE OPERATION.
- ANY EARTH DISTURBANCE SHALL BE CONDUCTED IN SUCH A MANNER SO AS TO EFFECTIVELY REDUCE ACCELERATED SOIL EROSION AND RESULTING SEDIMENTATION. ALL DISTURBANCES SHALL BE DESIGNED, CONSTRUCTED, AND COMPLETED SO THAT THE EXPOSED AREA OF ANY DISTURBED LAND SHALL BE LIMITED TO THE SHORTEST PRACTICAL PERIOD OF TIME.
- ANY TEMPORARY OR PERMANENT FACILITY DESIGNED AND CONSTRUCTED FOR THE CONVEYANCE OF STORMWATER AROUND, THROUGH, OR FROM THE EARTH DISTURBANCE AREA SHALL BE DESIGNED TO LIMIT THE DISCHARGE TO A NON-EROSIVE VELOCITY.
- CONCRETE WASH WATER SHALL BE CONTAINED AND DISPOSED OF IN ACCORDANCE WITH THE SWMP. NO WASH WATER SHALL BE DISCHARGED TO OR ALLOWED TO RUNOFF TO STATE WATERS, INCLUDING ANY SURFACE OR SUBSURFACE STORM DRAINAGE SYSTEM OR FACILITIES.
- EROSION CONTROL BLANKETING IS TO BE USED ON SLOPES STEEPER THAN 3:1.
- BUILDING, CONSTRUCTION, EXCAVATION, OR OTHER WASTE MATERIALS SHALL NOT BE TEMPORARILY PLACED OR STORED IN THE STREET, ALLEY, OR OTHER PUBLIC WAY, UNLESS IN ACCORDANCE WITH AN APPROVED TRAFFIC CONTROL PLAN. BMP'S MAY BE REQUIRED BY EL PASO COUNTY ENGINEERING IF DEEMED NECESSARY, BASED ON SPECIFIC CONDITIONS AND CIRCUMSTANCES.
- VEHICLE TRACKING OF SOILS AND CONSTRUCTION DEBRIS OFF-SITE SHALL BE MINIMIZED. MATERIALS TRACKED OFFSITE SHALL BE CLEANED UP AND PROPERLY DISPOSED OF IMMEDIATELY.
- CONTRACTOR SHALL BE RESPONSIBLE FOR THE REMOVAL OF ALL WASTES FROM THE CONSTRUCTION SITE FOR DISPOSAL IN ACCORDANCE WITH LOCAL AND STATE REGULATORY REQUIREMENTS. NO CONSTRUCTION DEBRIS, TREE SLASH, BUILDING MATERIAL WASTES OR UNUSED BUILDING MATERIALS SHALL BE BURIED, DUMPED, OR DISCHARGED AT THE SITE.
- THE OWNER, SITE DEVELOPER, CONTRACTOR, AND/OR THEIR AUTHORIZED AGENTS SHALL BE RESPONSIBLE FOR THE REMOVAL OF ALL CONSTRUCTION DEBRIS, DIRT, TRASH, ROCK, SEDIMENT, AND SAND THAT MAY ACCUMULATE IN THE STORM SEWER OR OTHER DRAINAGE CONVEYANCE SYSTEM AND STORMWATER APPURTENANCES AS A RESULT OF SITE DEVELOPMENT.
- THE QUANTITY OF MATERIALS STORED ON THE PROJECT SITE SHALL BE LIMITED, AS MUCH AS PRACTICAL, TO THAT QUANTITY REQUIRED TO PERFORM THE WORK IN AN ORDERLY SEQUENCE. ALL MATERIALS STORED ON-SITE SHALL BE STORED IN A NEAT, ORDERLY MANNER, IN THEIR ORIGINAL CONTAINERS, WITH ORIGINAL MANUFACTURER'S LABELS.
- NO CHEMICALS ARE TO BE USED BY THE CONTRACTOR, WHICH HAVE THE POTENTIAL TO BE RELEASED IN STORMWATER UNLESS PERMISSION FOR THE USE OF A SPECIFIC CHEMICAL IS GRANTED IN WRITING BY THE ECM ADMINISTRATOR. IN GRANTING THE USE OF SUCH CHEMICALS, SPECIAL CONDITIONS AND MONITORING MAY BE REQUIRED.
- BULK STORAGE STRUCTURES FOR PETROLEUM PRODUCTS AND OTHER CHEMICALS SHALL HAVE ADEQUATE PROTECTION SO AS TO CONTAIN ALL SPILLS AND PREVENT ANY SPILLED MATERIAL FROM ENTERING STATE WATERS, INCLUDING ANY SURFACE OR SUBSURFACE STORM DRAINAGE SYSTEM OR FACILITIES.
- NO PERSON SHALL CAUSE THE IMPEDIMENT OF STORMWATER FLOW IN THE FLOW LINE OF THE CURB AND GUTTER OR IN THE DITCHLINE.
- INDIVIDUALS SHALL COMPLY WITH THE "COLORADO WATER QUALITY CONTROL ACT" (TITLE 25, ARTICLE 8, CRS), AND THE "CLEAN WATER ACT" (33 USC 1344), IN ADDITION TO THE REQUIREMENTS INCLUDED IN THE DCM VOLUME II AND THE ECM APPENDIX I. ALL APPROPRIATE PERMITS MUST BE OBTAINED BY THE CONTRACTOR PRIOR TO CONSTRUCTION (NPDES, FLOODPLAIN, 404, FUGITIVE DUST, ETC.), IN THE EVENT OF CONFLICTS BETWEEN THESE REQUIREMENTS AND LAWS, RULES, OR REGULATIONS OF OTHER FEDERAL, STATE, OR COUNTY AGENCIES, THE MORE RESTRICTIVE LAWS, RULES, OR REGULATIONS SHALL APPLY.
- ALL CONSTRUCTION TRAFFIC MUST ENTER/EXIT THE SITE AT APPROVED CONSTRUCTION ACCESS POINTS.
- PRIOR TO ACTUAL CONSTRUCTION THE PERMITEE SHALL VERIFY THE LOCATION OF EXISTING UTILITIES.
- A WATER SOURCE SHALL BE AVAILABLE ON SITE DURING EARTHWORK OPERATIONS AND UTILIZED AS REQUIRED TO MINIMIZE DUST FROM EARTHWORK EQUIPMENT AND WIND.
- THE SOILS REPORT FOR THIS SITE HAS BEEN PREPARED BY ENTECH ENGINEERING, INC., TITLED "SOIL, GEOLOGY, GEOLOGIC HAZARD AND PRELIMINARY SUBSURFACE SOIL INVESTIGATION - WATERBURY - PHASE 1", DATED MARCH 22, 2013, AND SHALL BE CONSIDERED A PART OF THESE PLANS.
- AT LEAST TEN DAYS PRIOR TO THE ANTICIPATED START OF CONSTRUCTION, FOR PROJECTS THAT WILL DISTURB 1 ACRE OR MORE, THE OWNER OR OPERATOR OF CONSTRUCTION ACTIVITY SHALL SUBMIT A PERMIT APPLICATION FOR STORMWATER DISCHARGE TO THE COLORADO DEPARTMENT OF PUBLIC HEALTH AND ENVIRONMENT QUALITY DIVISION. THE APPLICATION CONTAINS CERTIFICATION OF A STORMWATER MANAGEMENT PLAN (SWMP), OF WHICH THIS GRADING AND EROSION CONTROL PLAN MAY BE A PART. FOR INFORMATION OR APPLICATION MATERIALS CONTACT:

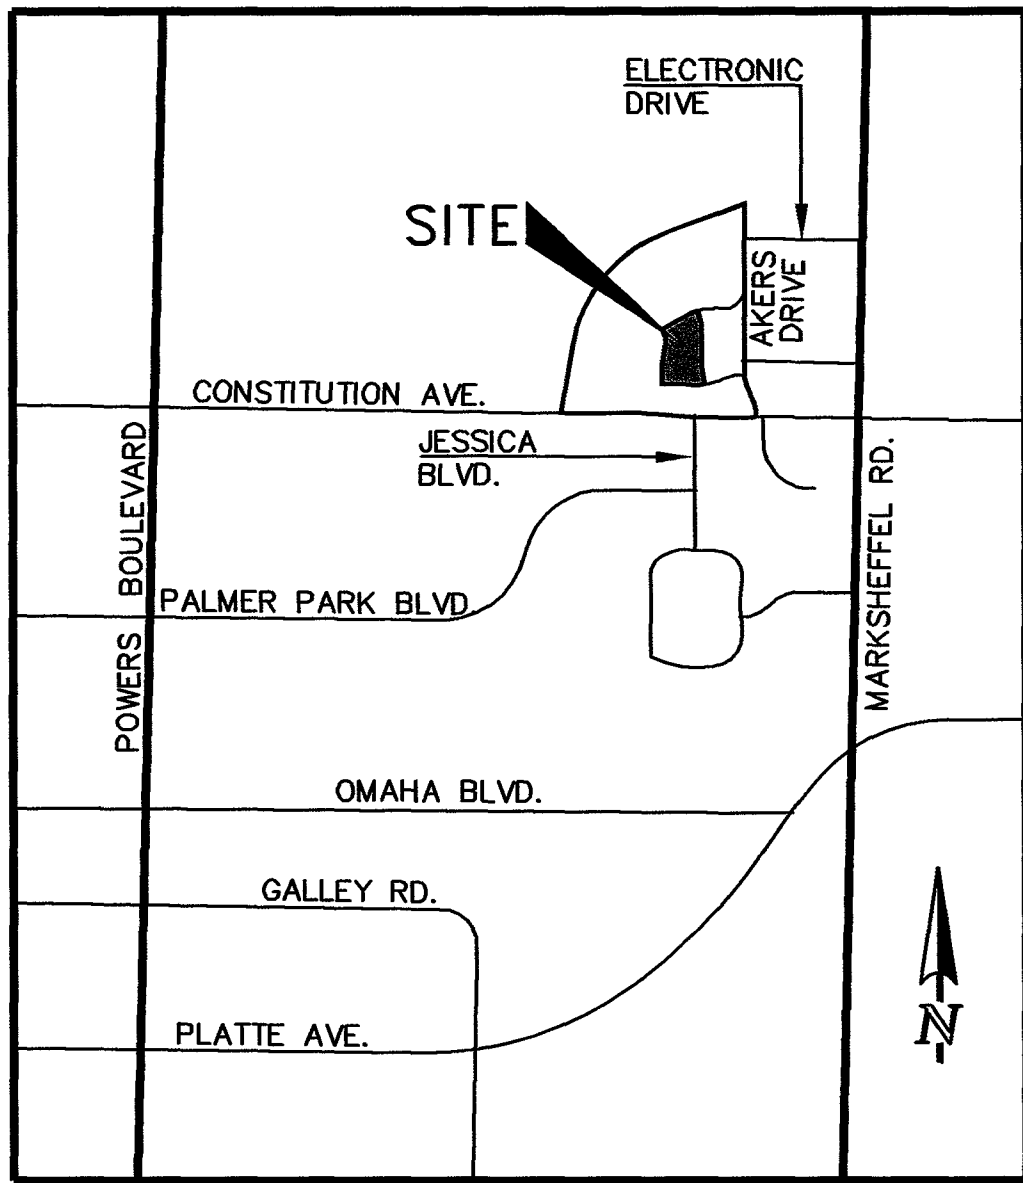
COLORADO DEPARTMENT OF PUBLIC HEALTH AND ENVIRONMENT  
WATER QUALITY CONTROL DIVISION  
WOOD - PERMITS  
4300 CHERRY CREEK DRIVE SOUTH  
DENVER, CO 80246-1530  
ATTN: PERMITS UNIT

### BENCHMARK:


THE BENCHMARK FOR THESE PLANS IS THE TOP OF #4 REBAR, PANEL POINT NO. 1, LOCATED ON THE SOUTH EDGE OF CONSTITUTION AVE. AND THE WEST EDGE OF THE ROCK ISLAND TRAIL, 535 FEET WEST OF THE CENTERLINE OF SHAWNEE DR. ELEVATION = 6486.63 (EPC DATUM ELEVATION = 6485.29)

### BASIS OF BEARINGS:

BEARING REFERRED TO HEREIN ARE BASED ON THE SOUTH LINE OF TRACT FF, HANNAH RIDGE AT FEATHERGRASS FILING NO. 1. ASSUMED TO BEALIN 185°30'12"W MONUMENTED AT EACH END W/ NO. 5 REBAR W/ ALUM CAP MARKED "POLARIS, PLS 27605".



VICINITY MAP  
NOT TO SCALE

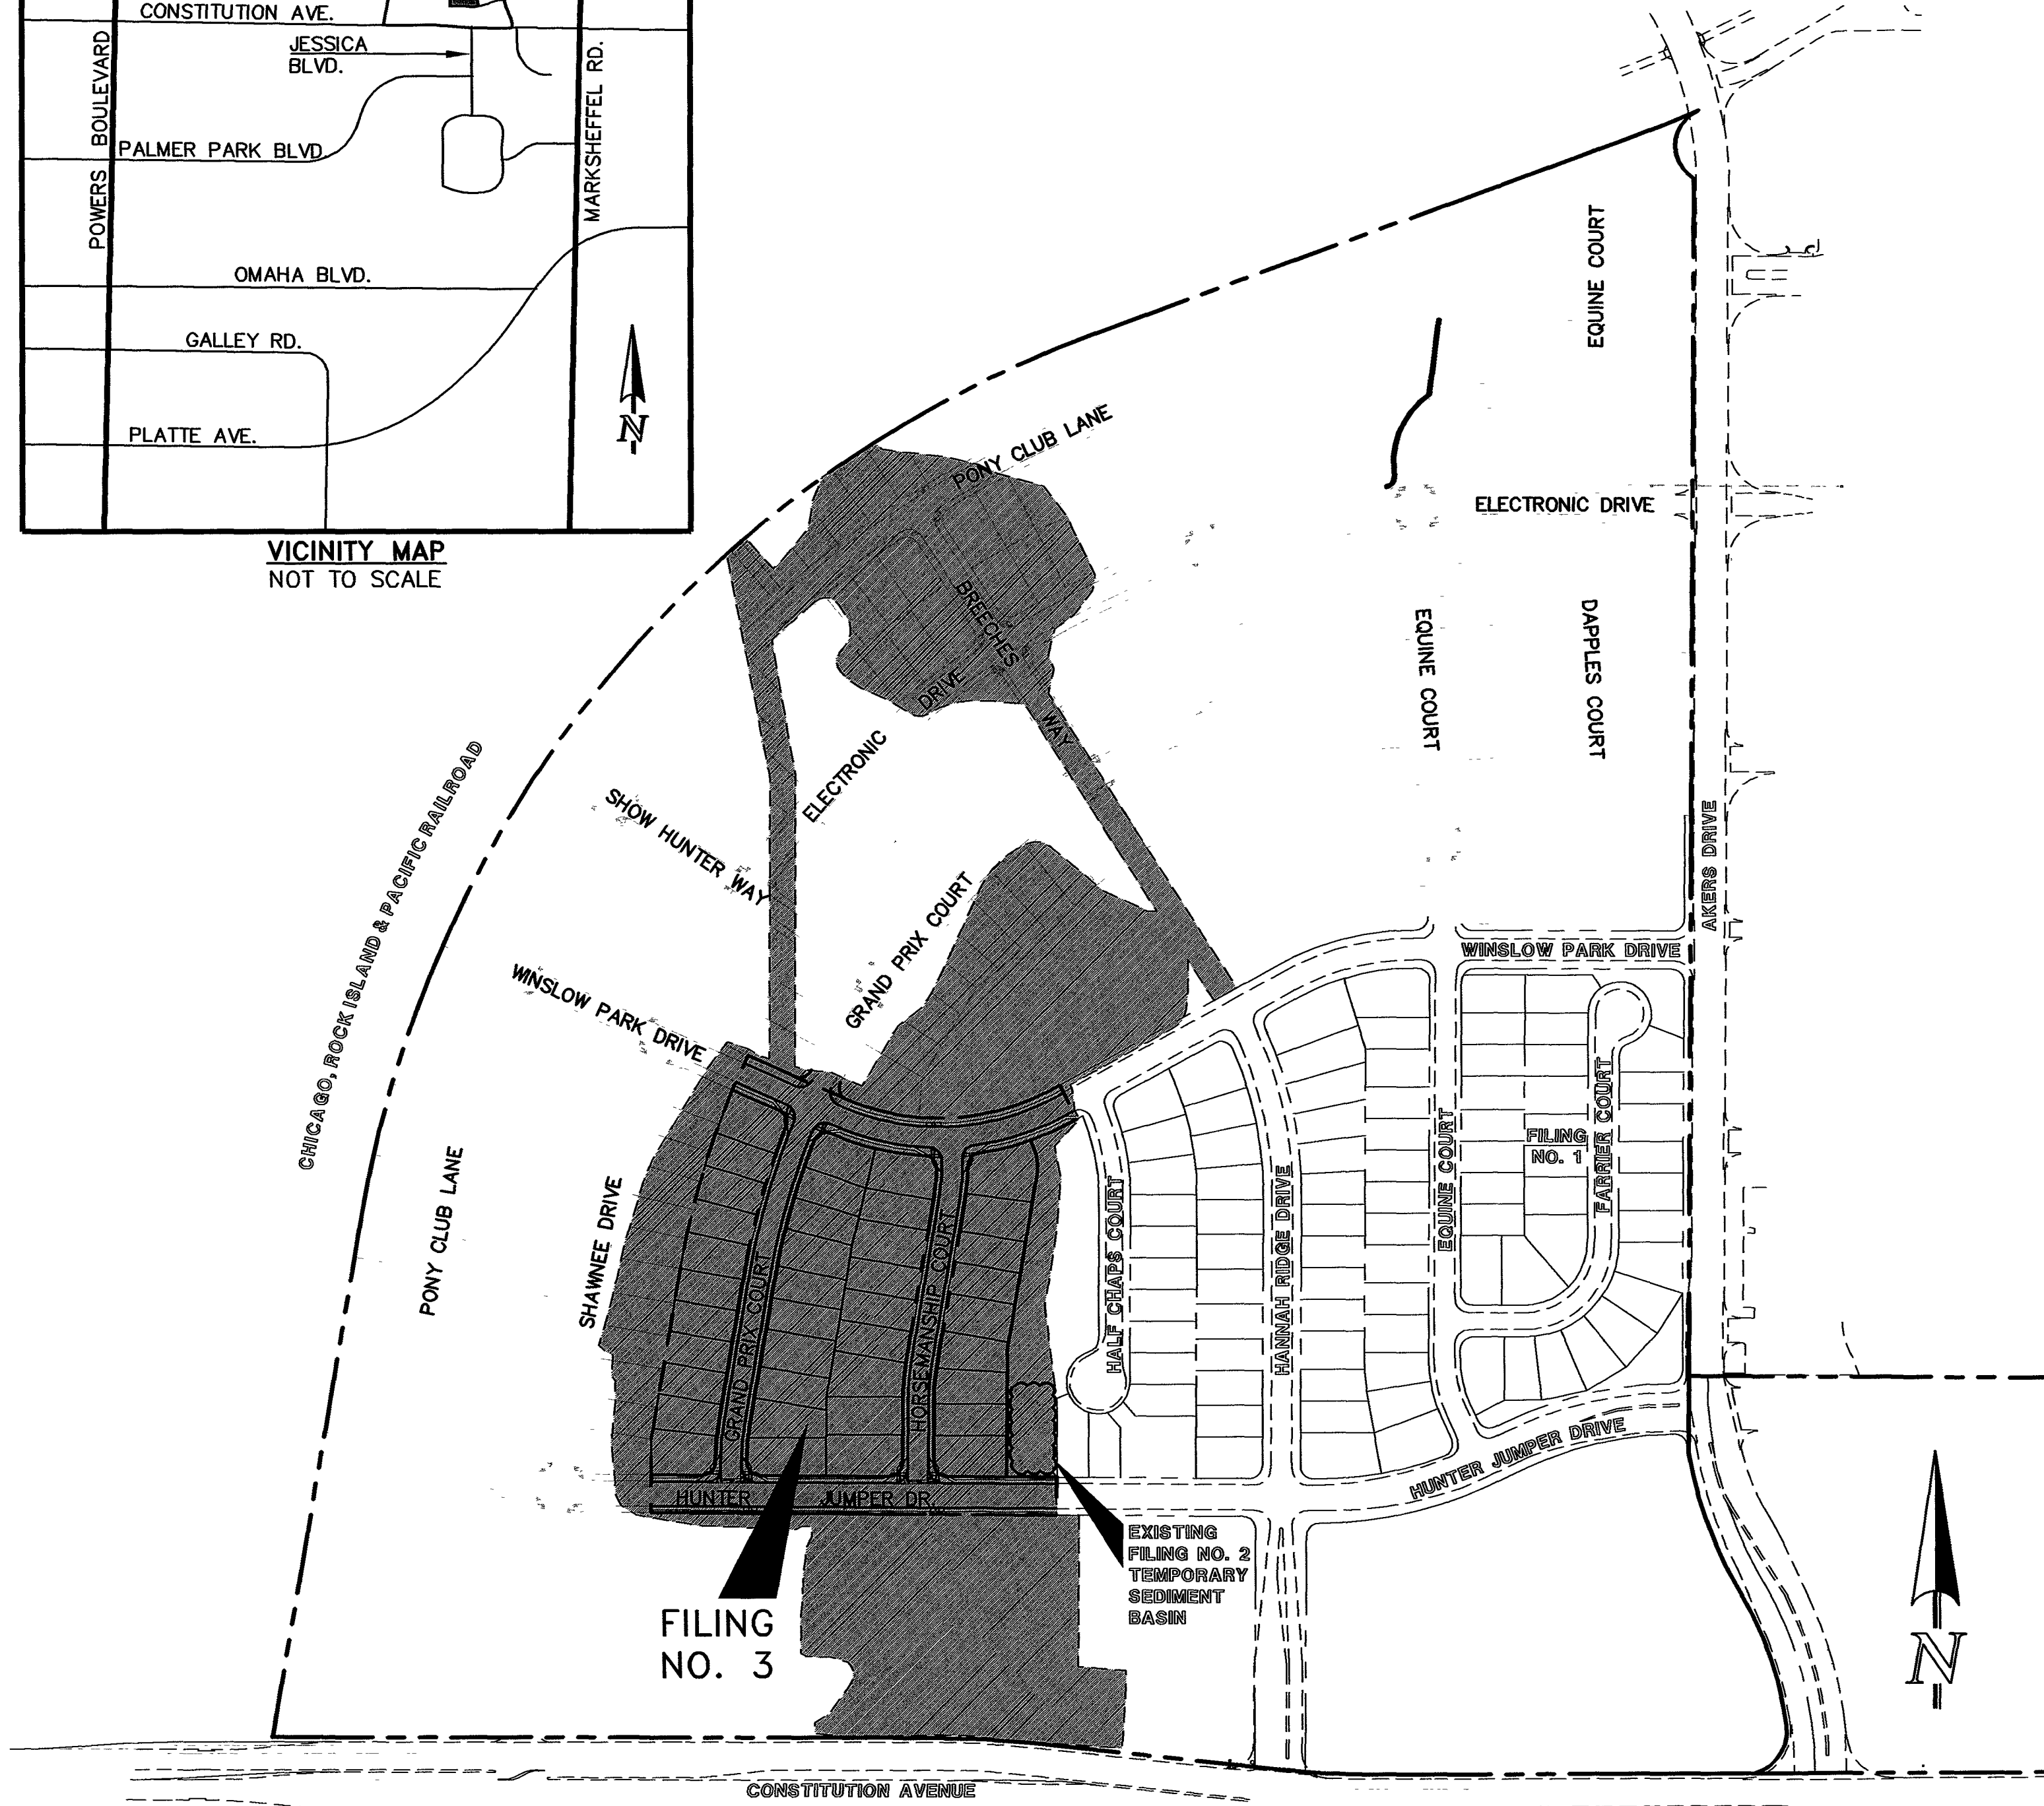

KEY MAP  
SCALE: 1" = 200'

### Planning and Community Development

#### AGENCIES:

- OWNER: FEATHERGRASS INVESTMENTS, LLC  
4715 N. CHESTNUT STREET  
COLORADO SPRINGS, CO 80907  
MR. KENNETH P. DRISCOLL (719) 593-8367
- CIVIL ENGINEER: CLASSIC CONSULTING ENGINEERS & SURVEYORS  
6385 CORPORATE DRIVE SUITE 304  
COLORADO SPRINGS, COLORADO 80919  
MR. KYLE R. CAMPBELL, P.E. (719) 785-2800
- ENGINEERING DIVISION: EL PASO COUNTY DEVELOPMENT SERVICES  
2880 INTERNATIONAL SQUARE, SUITE 110  
COLORADO SPRINGS, COLORADO 80910  
MR. JEFF RICE, (719) 520-7877
- GAS DEPARTMENT: BLACK HILLS ENERGY  
7000 ALEGRE ST.  
FOUNTAIN, COLORADO 80817 MR.  
GEORGE PETERSON (719) 393-6625
- ELECTRIC DEPARTMENT: MOUNTAIN VIEW ELECTRIC ASSOCIATION  
11140 E. WOODMEN RD.  
FALCON, COLORADO 80831  
MR. DARRYL EDWARDS, (719) 495-2283
- TELEPHONE COMPANY: A.T.&T.  
(LOCATORS) (719) 635-3674  
CENTURY LINK  
(LOCATORS) 811
- FIRE DEPARTMENT: FALCON FIRE PROTECTION DISTRICT  
7030 N. MERIDIAN RD.  
FALCON, COLORADO 80831  
CHIEF HARMIG (719) 495-4050

#### APPROVALS:

#### ENGINEER'S STATEMENT:

GRADING AND EROSION CONTROL PLAN ENGINEER'S STATEMENT:  
THESE GRADING AND EROSION CONTROL PLANS WERE PREPARED UNDER MY DIRECTION AND SUPERVISION AND IS CORRECT TO THE BEST OF MY KNOWLEDGE AND BELIEF. SAID PLAN HAS BEEN PREPARED ACCORDING TO THE CRITERIA ESTABLISHED BY THE COUNTY FOR GRADING AND EROSION CONTROL PLANS.

I ACCEPT RESPONSIBILITY FOR ANY LIABILITY CAUSED BY ANY NEGLIGENT ACTS, ERRORS OR OMISSIONS ON MY PART IN PREPARING THIS PLAN

KYLE R. CAMPBELL, COLORADO P.E. #29794  
FOR AND ON THE BEHALF OF CLASSIC CONSULTING ENGINEERS & SURVEYORS

DATE:

#### OWNER/DEVELOPER STATEMENT:

THE OWNER WILL COMPLY WITH THE REQUIREMENTS OF THE DRAINAGE REPORT AND PLAN AND THIS SET OF CONSTRUCTION DOCUMENTS. THE OWNER WILL COMPLY WITH THE REQUIREMENTS OF THE GRADING AND EROSION CONTROL PLAN.

FEATHERGRASS INVESTMENTS, LLC  
4715 N. CHESTNUT STREET  
COLORADO SPRINGS, CO 80907  
MR. KENNETH P. DRISCOLL

DATE:

#### EL PASO COUNTY:

COUNTY PLAN REVIEW IS PROVIDED ONLY FOR GENERAL CONFORMANCE WITH COUNTY DESIGN CRITERIA. THE COUNTY IS NOT RESPONSIBLE FOR THE ACCURACY AND ADEQUACY OF THE DESIGN, DIMENSIONS, AND/OR ELEVATIONS WHICH SHALL BE CONFIRMED AT THE JOB SITE. THE COUNTY THROUGH THE APPROVAL OF THIS DOCUMENT ASSUMES NO RESPONSIBILITY FOR COMPLETENESS AND/OR ACCURACY OF THIS DOCUMENT.

FILED IN ACCORDANCE WITH THE REQUIREMENTS OF THE EL PASO COUNTY LAND DEVELOPMENT CODE, DRAINAGE CRITERIA, AND ENGINEERING CRITERIA MANUAL AS AMENDED.

JENNIFER E. IRVINE  
COUNTY ENGINEER / ECM ADMINISTRATOR

DATE:

#### SHEET INDEX

TITLE SHEET	SHEET 1 OF 4
OVERLOT GRADING AND EROSION CONTROL PLAN	SHEET 2 OF 4
OVERLOT GRADING AND EROSION CONTROL PLAN	SHEET 3 OF 4
OVERLOT GRADING DETAILS	SHEET 4 OF 4

48 HOURS BEFORE YOU DIG,  
CALL UTILITY LOCATORS  
**811**  
UTILITY NOTIFICATION OF COLORADO  
IT'S THE LAW

THE LOCATIONS OF EXISTING UNDERGROUND UTILITIES ARE SHOWN IN AN APPROXIMATE WAY ONLY. THE CONTRACTOR SHALL DETERMINE THE EXACT LOCATION OF ALL EXISTING UTILITIES BEFORE COMMENCING WORK. THE CONTRACTOR SHALL BE FULLY RESPONSIBLE FOR ANY AND ALL DAMAGES WHICH MIGHT BE CAUSED BY HIS FAILURE TO EXACTLY LOCATE AND PRESERVE ANY AND ALL UNDERGROUND UTILITIES.

NO REVISION

DATE

REVIEW:

PREPARED UNDER MY DIRECT SUPERVISION FOR AND ON BEHALF OF  
CLASSIC CONSULTING ENGINEERS AND SURVEYORS, LLC

KYLE R. CAMPBELL, COLORADO P.E. #29794

DATE

CLASSIC  
CONSULTING  
ENGINEERS & SURVEYORS

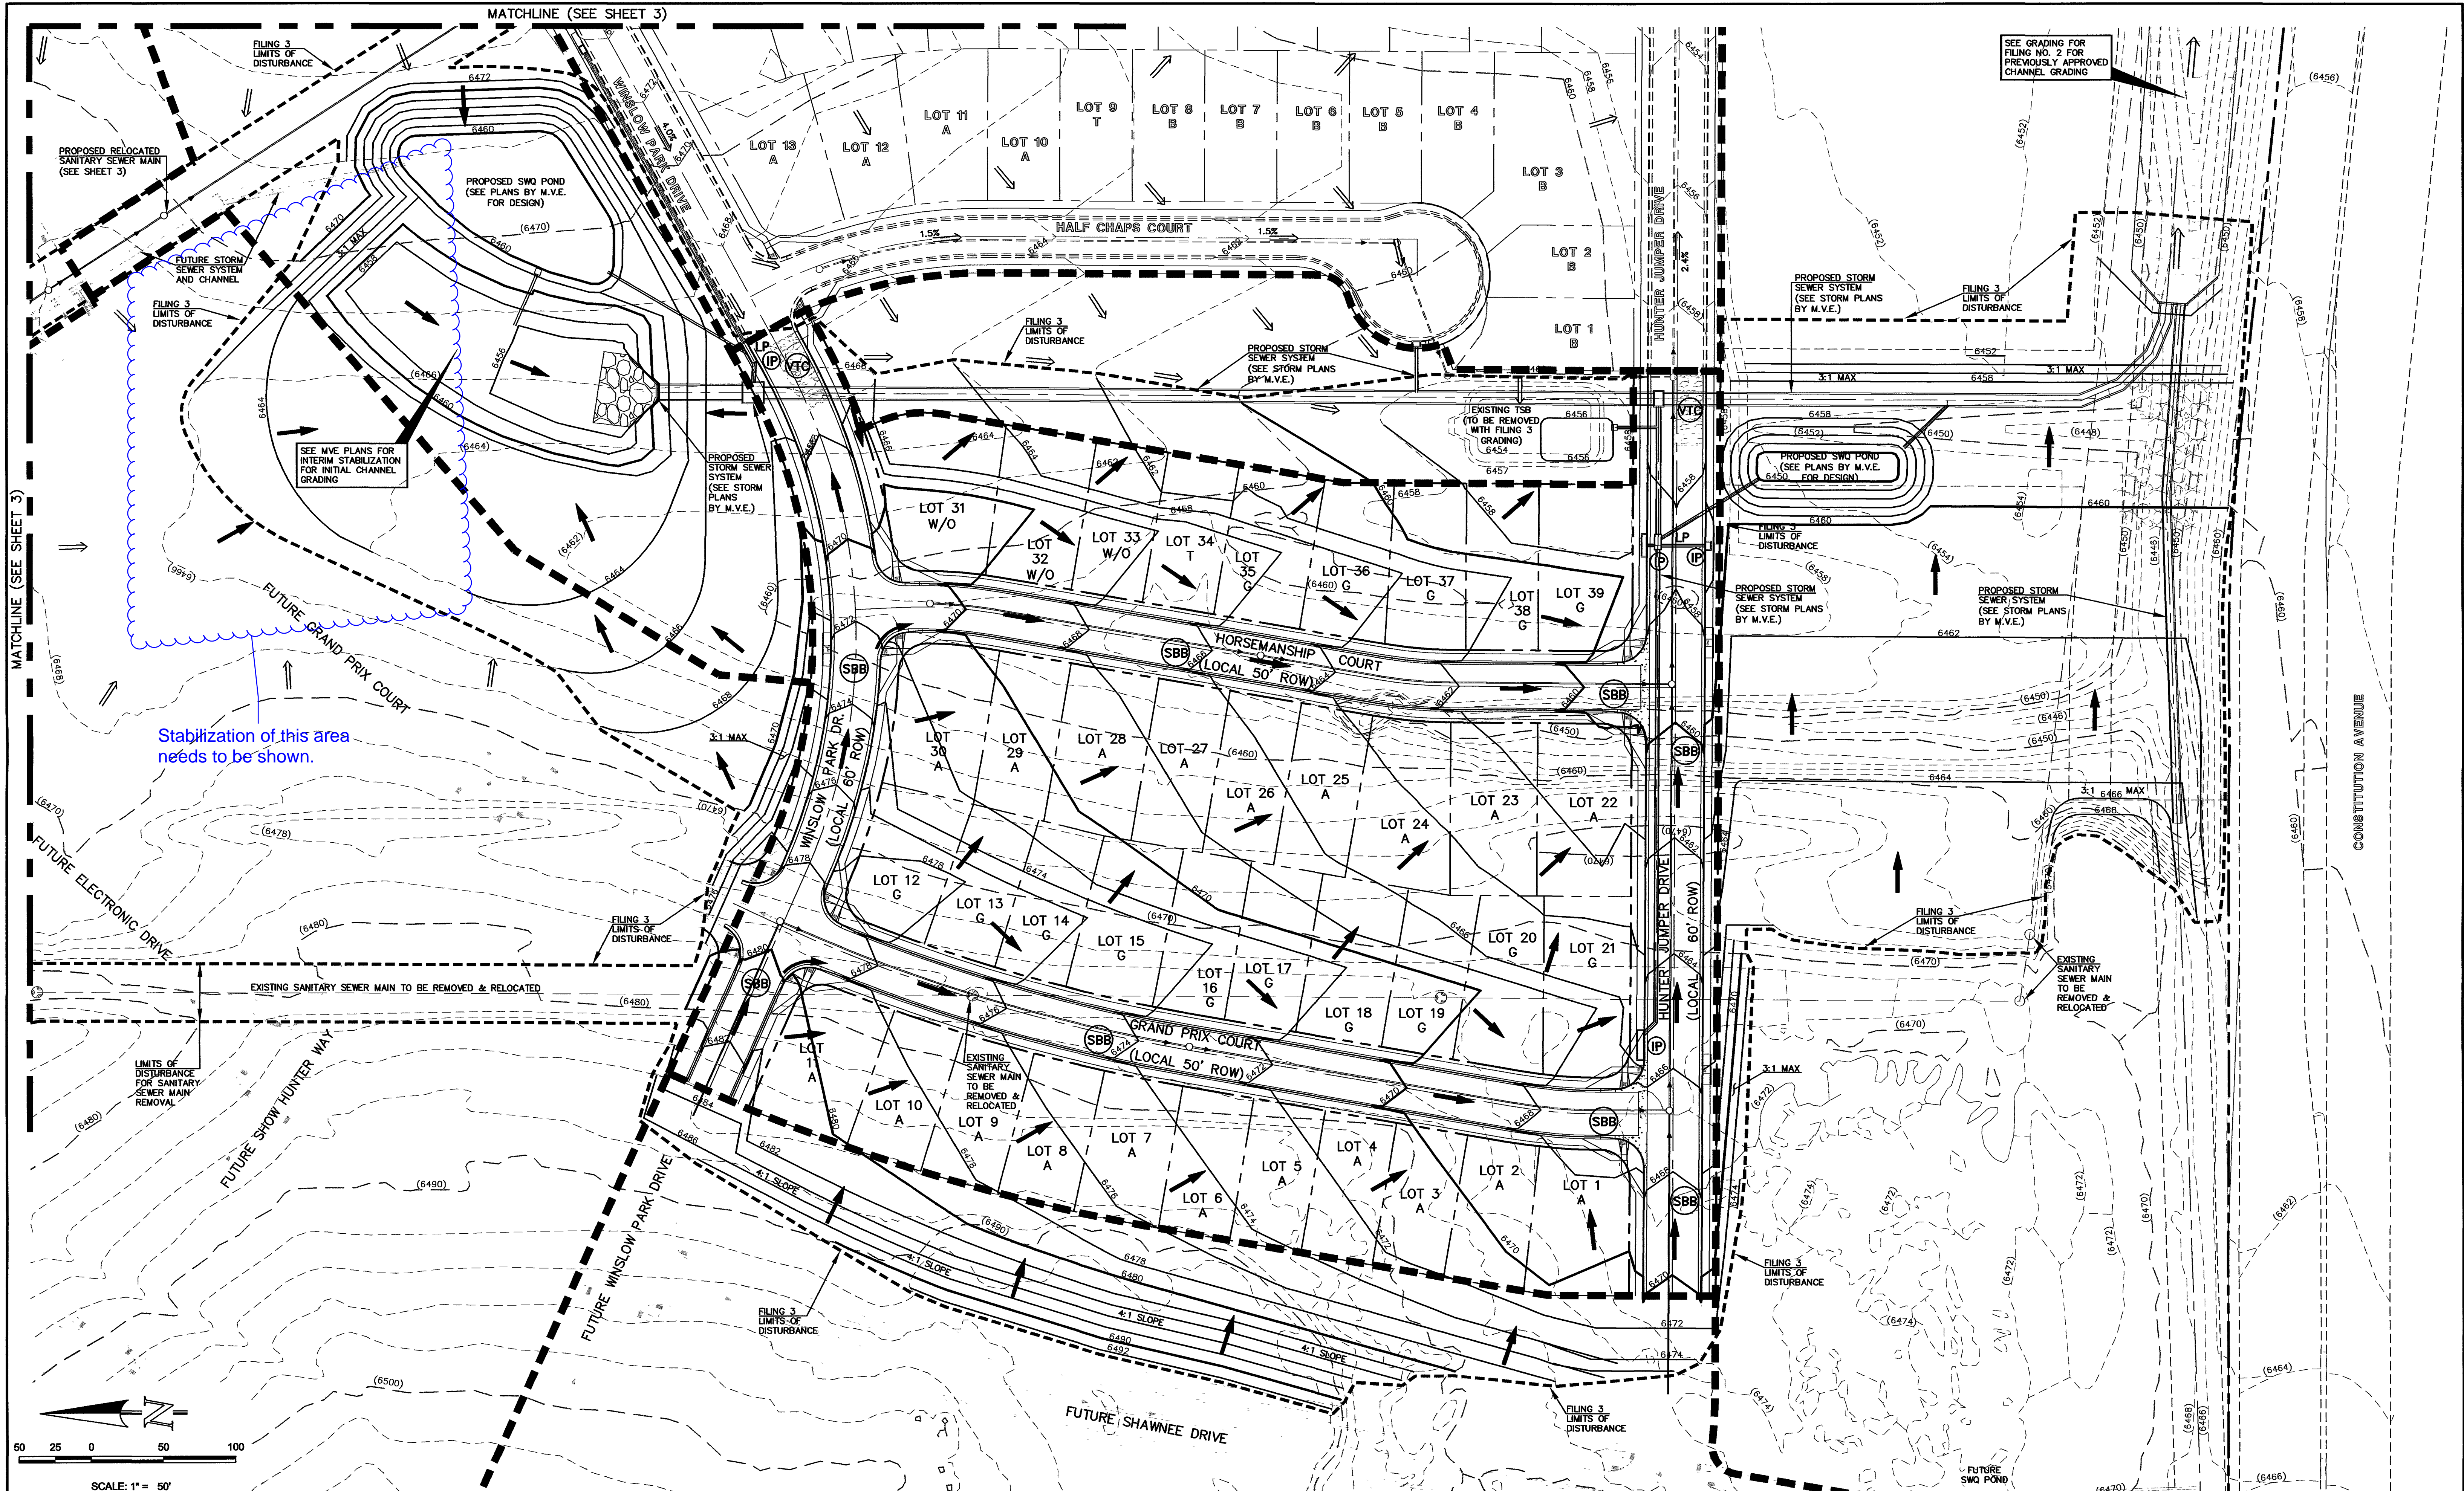
6385 Corporate Drive, Suite 101  
Colorado Springs, Colorado 80919  
(719)785-0790  
(719)785-0799(fax)

HANNAH RIDGE AT FEATHERGRASS  
FILING NO. 3  
OVERLOT GRADING AND EROSION CONTROL PLAN  
TITLE SHEET

DESIGNED BY	KRC	SCALE	DATE	04/11/17
DRAWN BY	MES	(H) 1"=VARIES	SHEET	1 OF 4
CHECKED BY	(V) 1"= N/A	JOB NO.	1116 00	

CLASSIC  
CONSULTING  
ENGINEERS & SURVEYORS





<b>LEGEND</b>		<b>48 HOURS BEFORE YOU DIG, CALL UTILITY LOCATORS 811</b> UTILITY NOTIFICATION OF COLORADO IT'S THE LAW		NO REVISION		DATE		REVIEW	
EXISTING CONTOUR	(6060)	PROPOSED FLOW	→					PREPARED UNDER MY DIRECT SUPERVISION FOR AND ON BEHALF OF CLASSIC CONSULTING ENGINEERS AND SURVEYORS, LLC	
PROPOSED CONTOUR	6060	EXISTING FLOW	→						
PHASE LINE	---	INLET PROTECTION	IP						
A LOT	"A"	SILT FENCE	SF						
B LOT	"B"	VEHICLE TRACKING CONTROL	VTC						
WALKOUT LOT	"W/O"	(2) STRAW BALE CHECK DAM (BOTH SIDES OF ROADWAY)	SBB						
GARDEN LOT	"G"								
TRANSITION LOT	"T"								


**CLASSIC**  
CONSULTING ENGINEERS & SURVEYORS  
6385 Corporate Drive, Suite 101  
Colorado Springs, Colorado 80919  
(719) 785-0780  
(719) 785-0799 (fax)

**HANNAH RIDGE AT FEATHERGRASS**  
FILING NO. 3  
OVERLOT GRADING AND EROSION CONTROL PLAN  
DESIGNED BY KRC  
SCALE (H) 1" = 50'  
DATE 04/11/17  
DRAWN BY MES  
(V) 1" = N/A  
SHEET 2 OF 4  
JOB NO. 1116 03

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Show and label offsite culvert improvements.




<b>EXISTING CONTOUR</b> --- (6060) --- <b>PROPOSED CONTOUR</b> --- 6060 --- <b>PHASE LINE</b> A LOT B LOT WALKOUT LOT GARDEN LOT TRANSITION LOT	<b>LEGEND</b> PROPOSED FLOW EXISTING FLOW INLET PROTECTION SILT FENCE VEHICLE TRACKING CONTROL (2) STRAW BALE CHECK DAM (BOTH SIDES OF ROADWAY)	<b>48 HOURS BEFORE YOU DIG, CALL UTILITY LOCATORS 811</b> UTILITY NOTIFICATION OF COLORADO IT'S THE LAW THE LOCATIONS OF EXISTING UNDERGROUND UTILITIES ARE SHOWN IN AN APPROXIMATE WAY ONLY. THE CONTRACTOR SHALL DETERMINE THE EXACT LOCATION OF ALL EXISTING UTILITIES BEFORE COMMENCING WORK. THE CONTRACTOR SHALL BE FULLY RESPONSIBLE FOR ANY AND ALL DAMAGES WHICH MIGHT BE CAUSED BY HIS FAILURE TO EXACTLY LOCATE AND PRESERVE ANY AND ALL UNDERGROUND UTILITIES.	NO REVISION DATE	REVIEW: PREPARED UNDER MY DIRECT SUPERVISION FOR AND ON BEHALF OF CLASSIC CONSULTING ENGINEERS AND SURVEYORS, LLC KYLE R CAMPBELL, COLORADO P.E. #29794 DATE	<b>CLASSIC</b> CONSULTING ENGINEERS & SURVEYORS 6385 Corporate Drive, Suite 101 Colorado Springs, Colorado 80919 (719) 785-0790 (719) 785-0799 (fax)	<b>HANNAH RIDGE AT FEATHERGRASS FILING NO. 3 OVERLOT GRADING AND EROSION CONTROL PLAN</b> DESIGNED BY KRC DRAWN BY MES CHECKED BY SCALE (H) 1" = 50' (V) 1" = N/A DATE 04/11/17 SHEET 3 OF 4 JOB NO. 1116.03
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## Silt Fence (SF)

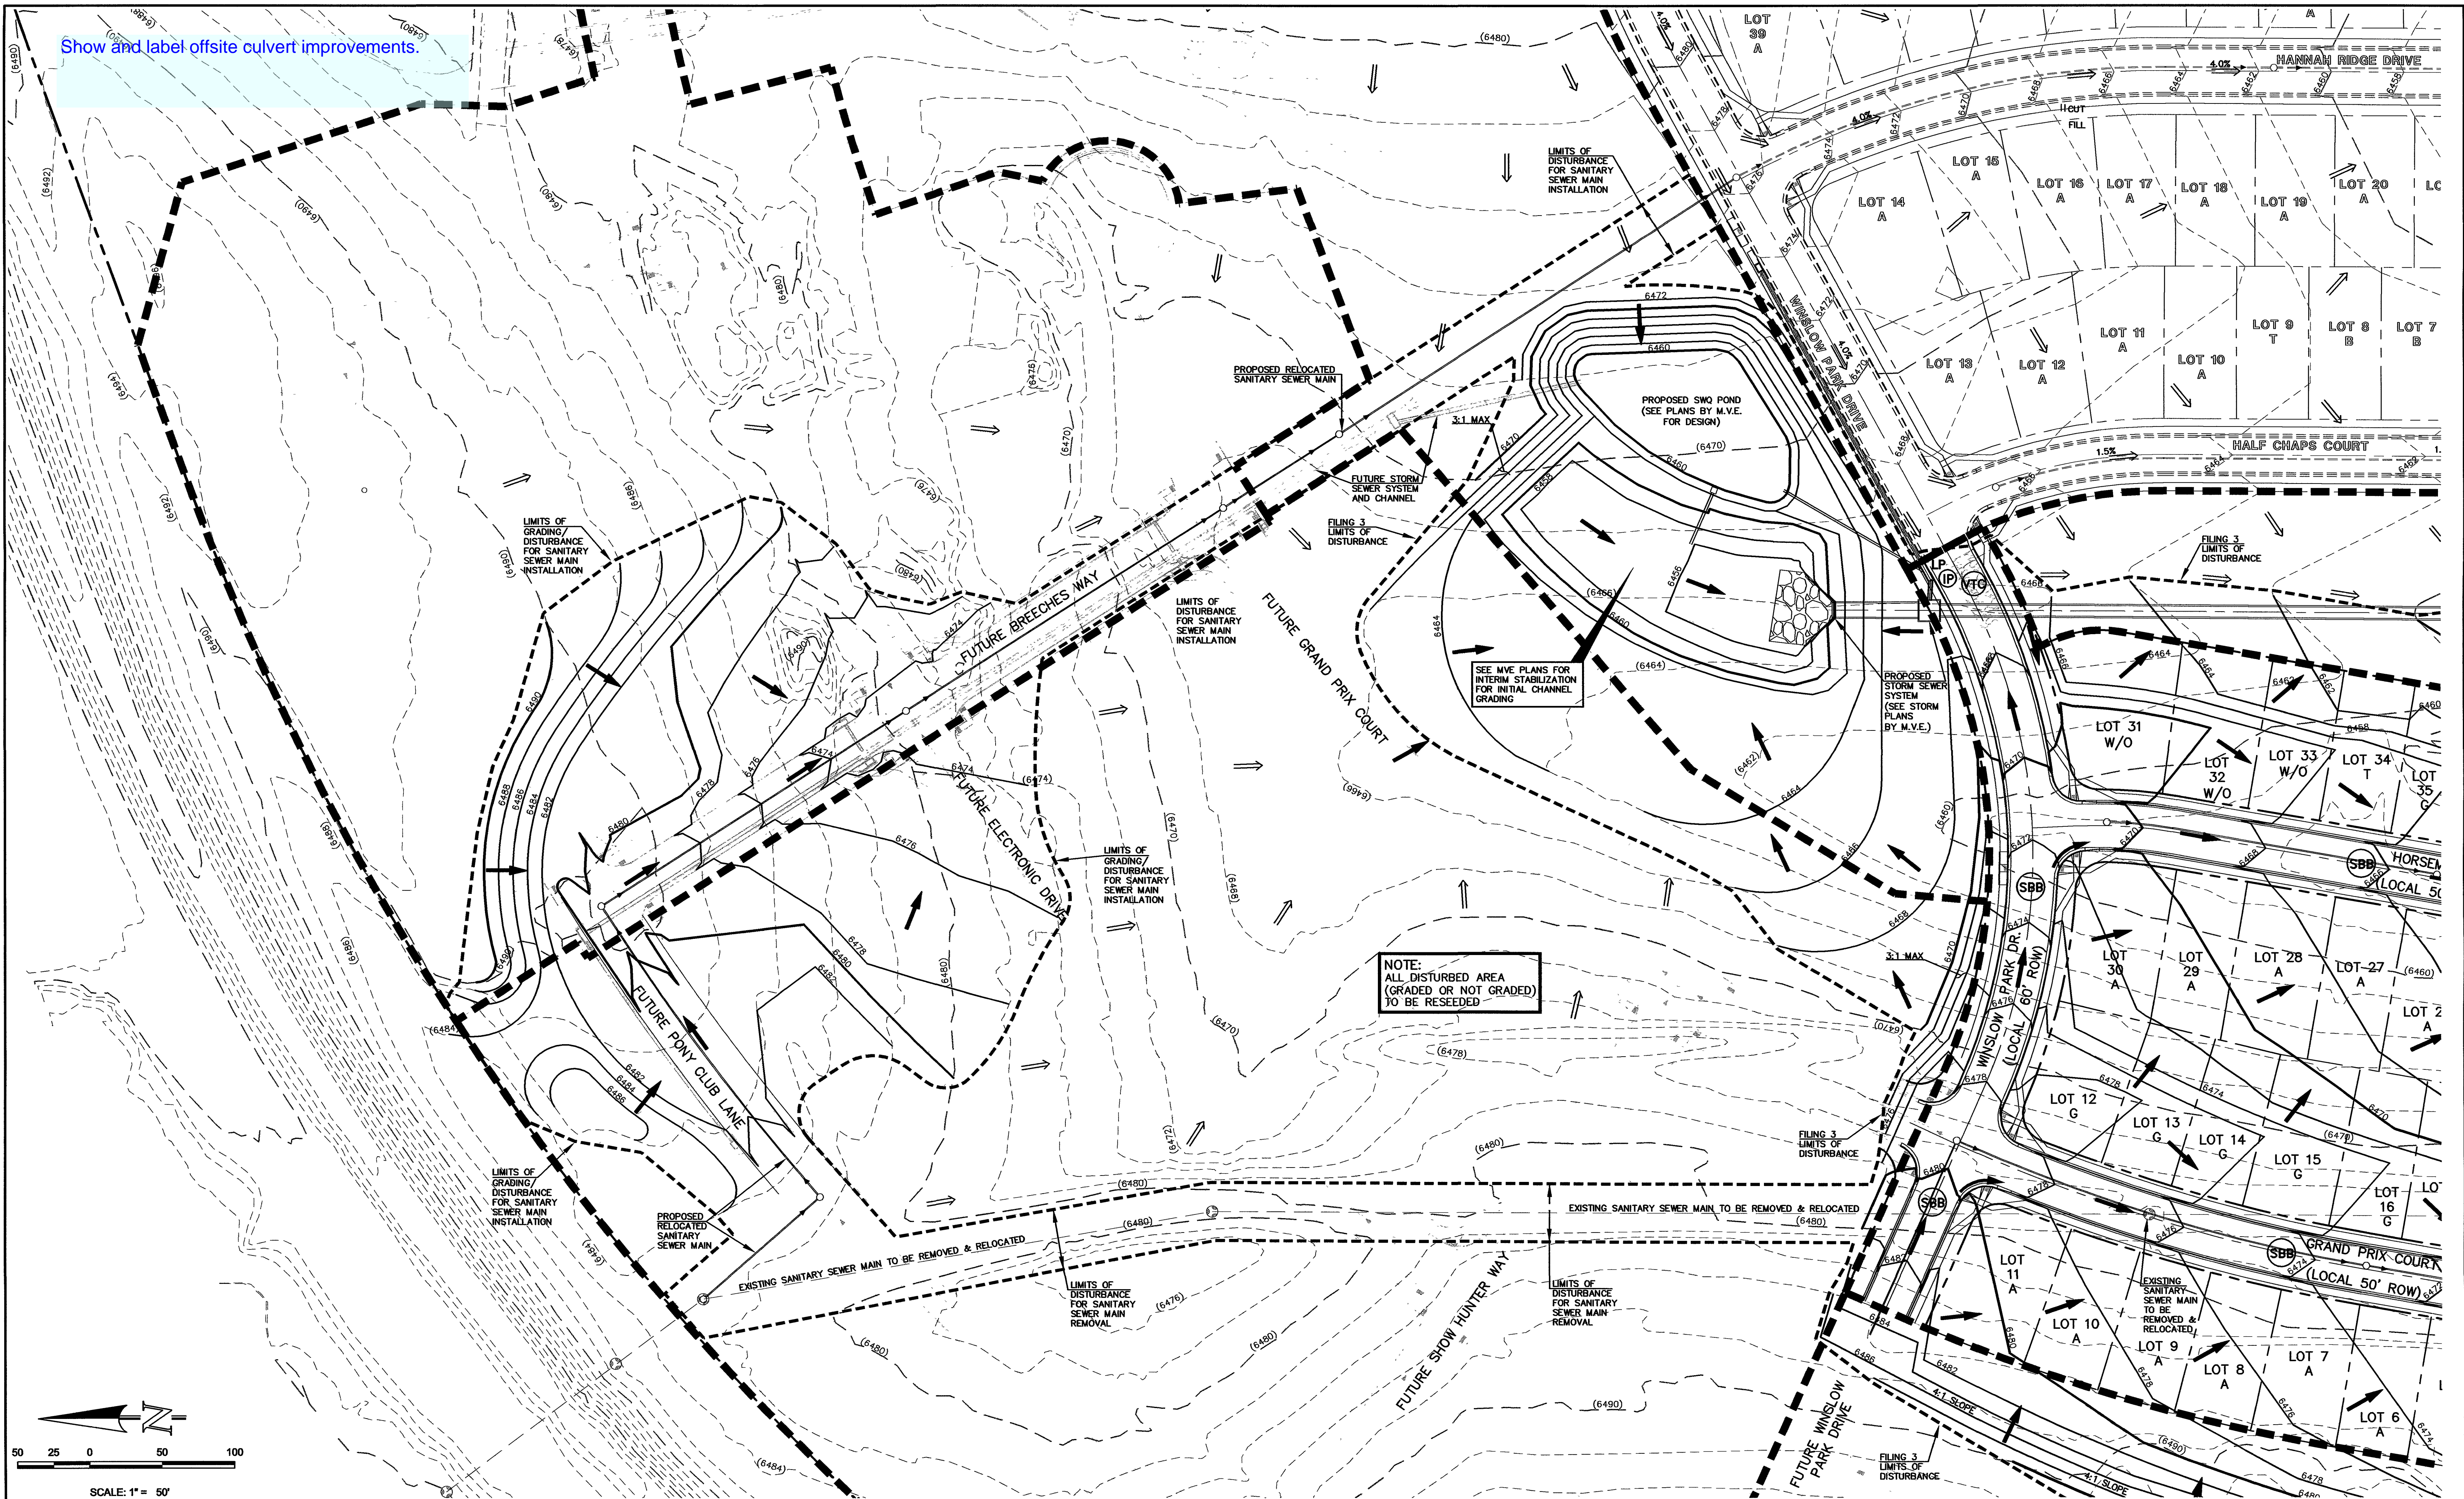
SC-1



November 2010 Urban Drainage and Flood Control District  
Urban Storm Drainage Criteria Manual Volume 3

## Vehicle Tracking Control (VTC)

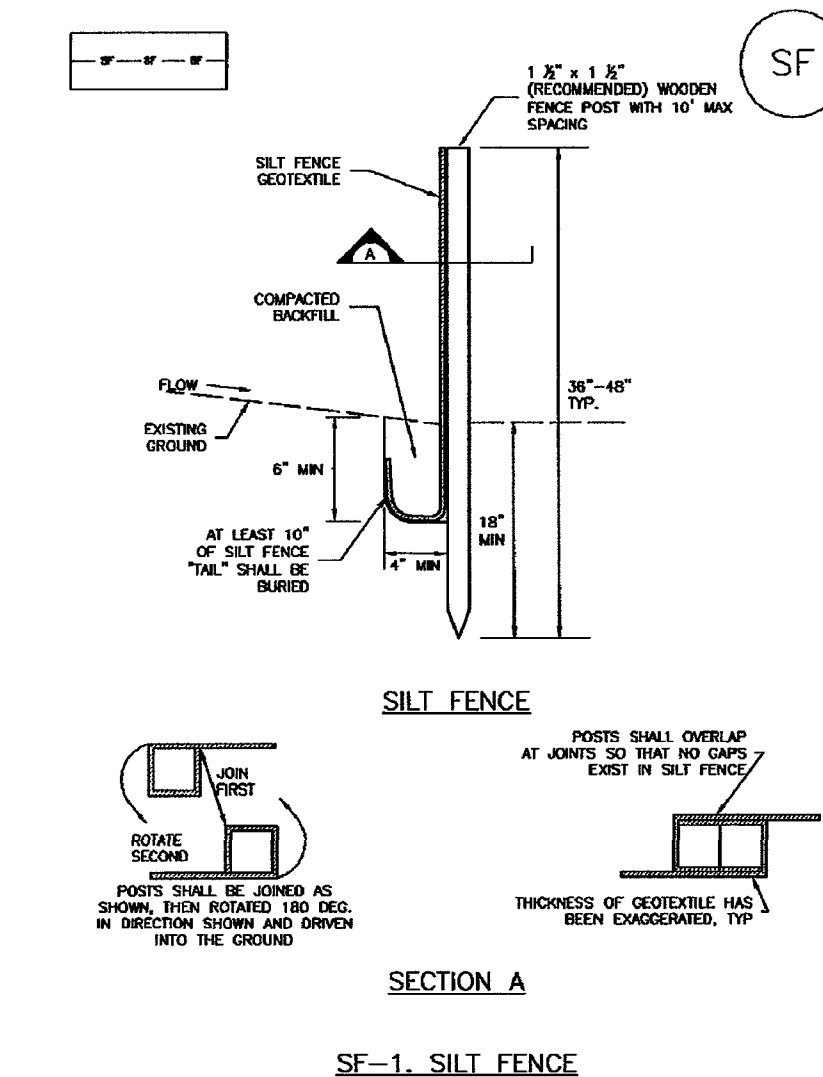
SM-4

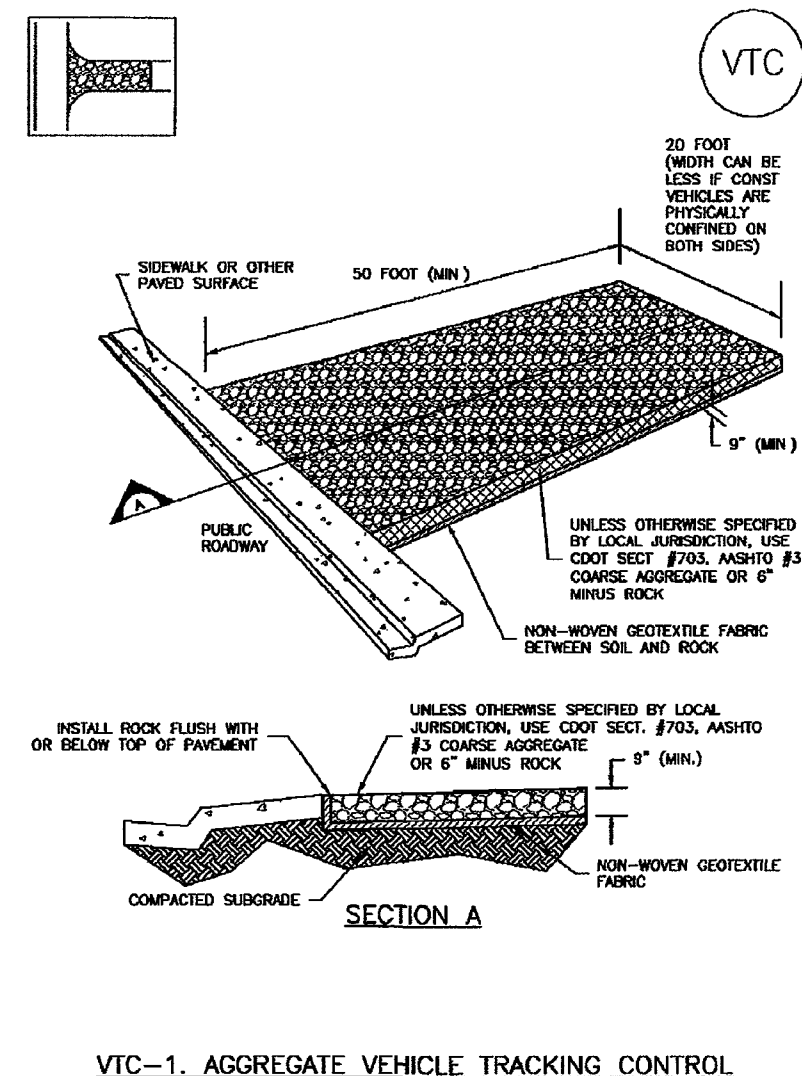


November 2010 Urban Drainage and Flood Control District  
Urban Storm Drainage Criteria Manual Volume 3

## SC-6
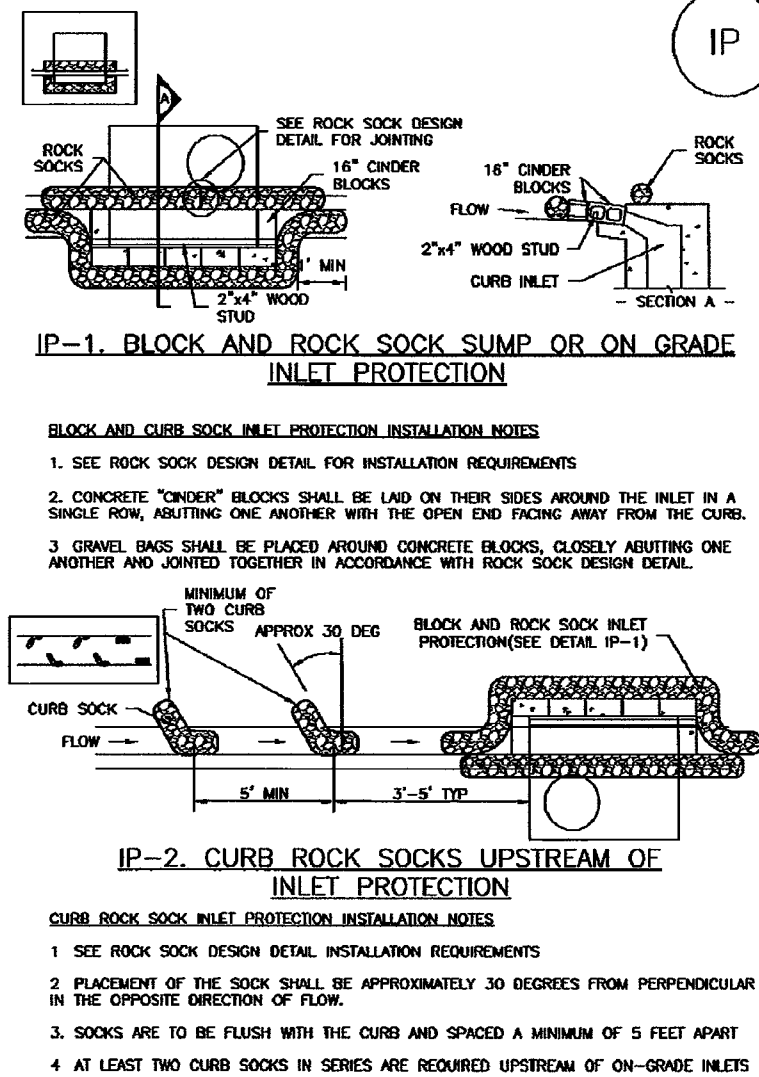
## Inlet Protection (IP)



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Urban Storm Drainage Criteria Manual Volume 3

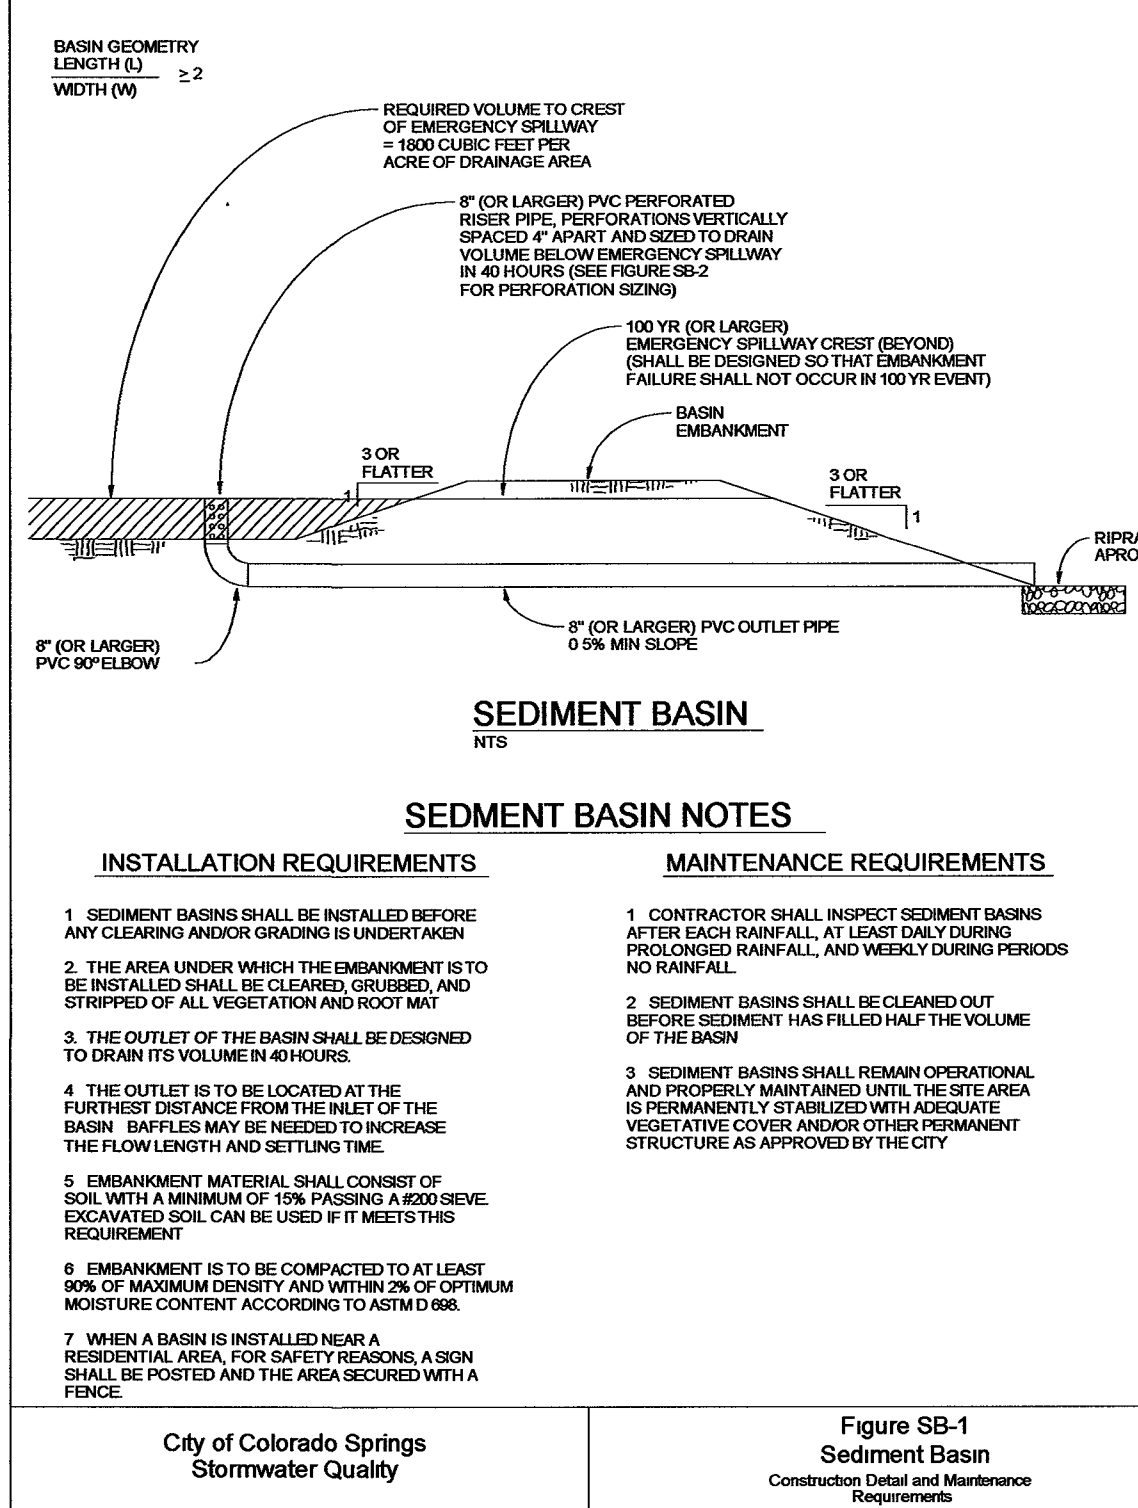

City of Colorado Springs  
Stormwater Quality

Required Area per Row (ft <sup>2</sup> )	Depth at Outlet (ft)									
	1.0	1.5	2.0	2.5	3.0	3.5	4.0	4.5	5.0	5.5
1	2.52	3.88	5.24	6.60	7.96	9.32	10.68	12.04	13.40	14.76
2	1.26	1.94	2.62	3.30	3.98	4.66	5.34	6.02	6.70	7.38
3	0.84	1.29	1.74	2.20	2.66	3.12	3.58	4.04	4.50	4.96
4	0.64	0.97	1.30	1.64	1.98	2.32	2.66	3.00	3.34	3.68
5	0.50	0.75	1.00	1.25	1.50	1.75	2.00	2.25	2.50	2.75
6	0.42	0.63	0.84	1.05	1.26	1.47	1.68	1.89	2.10	2.31
7	0.37	0.56	0.75	0.94	1.13	1.32	1.51	1.70	1.89	2.08
8	0.33	0.50	0.67	0.84	1.01	1.18	1.35	1.52	1.69	1.86
9	0.30	0.45	0.60	0.75	0.90	1.05	1.20	1.35	1.50	1.65
10	0.28	0.42	0.56	0.70	0.84	0.98	1.12	1.26	1.40	1.54
11	0.26	0.40	0.53	0.66	0.79	0.92	1.05	1.18	1.31	1.44
12	0.25	0.38	0.50	0.62	0.74	0.86	0.98	1.10	1.22	1.34
13	0.24	0.36	0.48	0.59	0.70	0.81	0.92	1.03	1.14	1.25
14	0.23	0.35	0.46	0.57	0.68	0.79	0.90	1.01	1.12	1.23
15	0.22	0.34	0.45	0.56	0.67	0.78	0.89	1.00	1.11	1.22
16	0.21	0.33	0.44	0.55	0.66	0.77	0.88	0.99	1.10	1.21
17	0.20	0.32	0.43	0.54	0.65	0.76	0.87	0.98	1.09	1.20
18	0.20	0.31	0.42	0.53	0.64	0.75	0.86	0.97	1.08	1.19
19	0.19	0.30	0.41	0.52	0.63	0.74	0.85	0.96	1.07	1.18
20	0.19	0.29	0.40	0.51	0.62	0.73	0.84	0.95	1.06	1.17
21	0.18	0.28	0.39	0.50	0.61	0.72	0.83	0.94	1.05	1.16
22	0.18	0.27	0.38	0.49	0.60	0.71	0.82	0.93	1.04	1.15
23	0.17	0.27	0.37	0.48	0.59	0.70	0.81	0.92	1.03	1.14
24	0.17	0.26	0.37	0.48	0.59	0.70	0.81	0.92	1.03	1.14
25	0.16	0.26	0.36	0.47	0.58	0.69	0.80	0.91	1.02	1.13
26	0.16	0.25	0.36	0.47	0.58	0.69	0.80	0.91	1.02	1.13
27	0.16	0.25	0.35	0.46	0.57	0.68	0.79	0.90	1.01	1.12
28	0.15	0.24	0.35	0.46	0.57	0.68	0.79	0.90	1.01	1.12
29	0.15	0.24	0.34	0.45	0.56	0.67	0.78	0.89	1.00	1.11
30	0.15	0.23	0.34	0.45	0.56	0.67	0.78	0.89	1.00	1.11

TABLE SB-1

Circular Perforation Spacing	Area per Row (ft <sup>2</sup> )									
	1.0	1.5	2.0	2.5	3.0	3.5	4.0	4.5	5.0	5.5
14	0.250	0.375	0.500	0.625	0.750	0.875	1.000	1.125	1.250	1.375
16	0.281	0.422	0.562	0.703	0.844	0.985	1.126	1.267	1.408	1.549
18	0.313	0.469	0.625	0.781	0.938	1.094	1.250	1.406	1.562	1.719
20	0.357	0.536	0.714	0.893	1.071	1.250	1.429	1.607	1.786	1.964
22	0.400	0.600	0.800	1.000	1.200	1.400	1.600	1.800	2.000	2.200
24	0.450	0.675	0.900	1.125	1.350	1.575	1.800	2.025	2.250	2.475
26	0.500	0.750	1.000	1.250	1.500	1.750	2.000	2.250	2.500	2.750
28	0.562	0.844	1.126	1.408	1.689	1.971	2.253	2.535	2.817	3.099
30	0.625	0.938	1.250	1.562	1.875	2.188	2.500	2.812	3.125	3.438
32	0.694	1.041	1.375	1.688	2.000	2.312	2.625	2.938	3.250	3.562
34	0.766	1.146	1.500	1.812	2.125	2.438	2.750	3.062	3.375	3.688
36	0.839	1.250	1.625	1.938	2.250	2.562	2.875	3.188	3.500	3.812
38	0.913	1.357	1.750	2.062	2.375	2.688	3.000	3.312	3.625	3.938
40	0.985	1.464	1.875	2.188	2.500	2.812	3.125	3.438	3.750	4.062
42	1.059	1.571	2.000	2.312	2.625	2.938	3.250	3.562	3.875	4.188
44	1.133	1.679	2.125	2.438	2.750	3.062	3.375	3.688	4.000	4.312
46	1.208	1.786	2.250	2.562	2.875	3.188	3.500	3.812	4.125	4.438
48	1.281	1.893	2.375	2.688	3.000	3.312	3.625	3.938	4.250	4.562
50	1.357	2.000	2.500	2.812	3.125	3.438	3.750	4.062	4.375	4.688
52	1.432	2.107	2.625	2.938	3.250	3.562	3.875	4.188	4.500	4.812
54	1.508	2.214	2.750	3.062	3.375	3.688	4.000	4.312	4.625	4.938
56	1.583	2.321	2.875	3.188	3.500	3.812	4.125	4.438	4.750	5.062
58	1.659	2.429	3.000	3.312	3.625	3.938	4.250	4.562	4.875	5.188
60	1.734	2.536	3.125	3.438	3.750	4.062	4.375	4.688	5.000	5.312
62	1.810	2.643	3.250	3.562	3.875	4.188	4.500	4.812	5.125	5.438
64	1.885	2.750	3.375	3.688	4.000	4.312	4.625	4.938	5.250	5.562
66	1.961	2.857	3.500	3.812	4.125	4.438	4.750	5.062	5.375	5.688
68	2.037	2.964	3.625	3.938	4.250	4.562	4.875	5.188	5.500	5.812
70	2.112	3.071	3.750	4.062	4.375	4.688	5.000	5.312	5.625	5.938
72	2.188	3.179	3.875	4.188	4.500	4.812	5.125	5.438	5.750	6.062
74	2.263	3.286	4.000	4.312	4.625	4.938	5.250	5.562	5.875	6.188
76	2.339	3.393	4.125	4.438	4.750	5.062	5.375	5.688	5.999	6.312
78	2.414	3.500	4.250	4.562	4.875	5.188	5.500	5.812	6.125	6.438
80	2.490	3.607	4.375	4.688	5.000	5.312	5.625	5.938	6.250	6.562
82	2.565	3.714	4.500	4.812	5.125	5.438	5.750	6.062	6.375	6.688
84	2.641	3.821	4.625	4.938	5.250	5.562	5.875	6.188	6.500	6.812
86	2.716	3.929	4.750	5.062	5.375	5.688	6.000	6.312	6.625	6.938
88	2.792	4.036	4.875	5.188	5.500	5.812	6.125	6.438	6.750	7.062
90	2.867	4.143	5.000	5.312	5.625	5.938	6.250	6.562	6.875	7.188
92	2.943	4.250	5.125	5.438	5.750	6.062	6.375	6.688	7.000	7.312
94	3.018	4.357	5.250	5.562	5.875	6.188	6.500	6.812	7.125	7.438
96	3.094	4.464	5.375	5.688	6.000	6.312	6.625	6.938	7.250	7.562
98	3.169	4.571	5.500	5.812	6.125	6.438	6.750	7.062	7.375	7.688
100	3.245	4.679	5.625	5.938	6.250	6.562	6.875	7.188	7.500	7.812

TABLE SB-2

City of Colorado Springs  
Stormwater Quality

## EROSION CONTROL CRITERIA:

EROSION CONTROL MEASURES SHALL BE IMPLEMENTED IN A MANNER THAT WILL PROTECT PROPERTIES AND PUBLIC FACILITIES FROM THE ADVERSE EFFECTS OF EROSION AND SEDIMENTATION AS A RESULT OF CONSTRUCTION AND EARTHWORK ACTIVITIES WITHIN THE PROJECT SITE.

- 1) THE OMISSION FROM OR THE INCLUSION OF UTILITY LOCATIONS ON THE PLANS IS NOT TO BE CONSIDERED AS THE NON-EXISTENCE OF OR A DEFINITE LOCATION OF EXISTING UNDERGROUND UTILITIES.
- 2) DURING GRADING OPERATIONS, LOCATE AND SET THE STRAW BALE CHECK DAMS AND SILT FENCES AS SHOWN ON THE EROSION CONTROL PLAN. AT THIS TIME RESEED ALL DISTURBED AREAS WITH AN EL PASO COUNTY APPROVED SEED MIX.
- 3) SEEDING APPLICATION: DRILLED TO A DEPTH OF .25" TO .50" INTO SOIL WHERE POSSIBLE, BROADCAST AND RAKED TO COVER ON STEEPER THAN 3:1 SLOPES WHERE ACCESS IS LIMITED OR UNSAFE FOR EQUIPMENT.
- 4) MULCHING REQUIREMENT AND APPLICATION: 1.5 TONS PER ACRE NATIVE HAY MECHANICALLY CRIMPED INTO SOIL.
- 5) THE STRAW BALE CHECK DAMS AND SILT FENCES SHALL BE KEPT IN PLACE AND MAINTAINED UNTIL EROSION AND SEDIMENTATION POTENTIAL IS MITIGATED. REMOVAL OF SILT AND SEDIMENT COLLECTED BY THE STRAW BALES IS REQUIRED ONCE IT REACHES HALF THE HEIGHT OF THE STRAW BALES OR SILT FENCE.
- 6) DISTURBED SOIL SHALL BE VEGETATED WITHIN 60 DAYS AFTER SUBSTANTIAL FINAL GRADING IS COMPLETE. PROVIDE TEMPORARY VEGETATION TO DISTURBED AREAS THAT WILL HAVE A PERIOD OF EXPOSURE OF 6 MONTHS OR LONGER PRIOR TO FINAL STABILIZATION.
- 7) ALL FACILITIES, VEGETATION AND OTHER ITEMS REQUIRED BY THE APPROVED FINAL GRADING, EROSION CONTROL AND RECLAMATION PLAN SHALL BE PROPERLY MAINTAINED BY THE OWNERS OF THE PROPERTY. SUCH MAINTENANCE SHALL INCLUDE, BUT NOT BE LIMITED TO KEEPING ALL EROSION CONTROL FACILITIES IN GOOD ORDER AND FUNCTIONAL, REPAIRING ANY EROSION DAMAGE THAT OCCURS, KEEPING ALL VEGETATION HEALTHY AND IN GROWING CONDITION AND REPLACING ANY DEAD VEGETATION AS SOON AS PRACTICABLE.
- 8) ALL SILT FENCES ARE TO BE REGULARLY INSPECTED AND REPAIRED AS NEEDED.
- 9) THE CONTRACTOR SHALL PROVIDE VEHICLE TRACKING CONTROL FACILITIES FOR EACH ENTRANCE/EXIT TO THE SITE. THE CONTRACTOR SHALL SUBMIT A PLAN WHICH WILL ASSURE USAGE OF THIS FACILITY BY ALL VEHICLES LEAVING THE SITE.
- 10) EROSION CONTROL MEASURES SHALL BE CHECKED AFTER EACH STORM EVENT AND REPAIRED WHEN NECESSARY.
- 11) CONTRACTOR SHALL MAINTAIN ALL TEMPORARY EROSION CONTROL FACILITIES IN GOOD WORKING ORDER UNTIL SUCH TIME AS PERMANENT FACILITIES ARE IN PLACE AND THE CONSTRUCTION MANAGER HAS APPROVED THEIR REMOVAL.
- 12) ADDITIONAL EROSION CONTROL STRUCTURES MAY BE REQUIRED AT THE TIME OF CONSTRUCTION.
- 13) THE EROSION CONTROL MEASURES OUTLINED ON THE PLAN ARE THE RESPONSIBILITY OF THE DEVELOPER TO MONITOR AND REPLACE, REGRADE AND REBUILD AS NECESSARY UNTIL VEGETATION IS ESTABLISHED.
- 14) MAXIMUM ACREAGE OPEN AT ANY GIVEN TIME IS TO BE 30 ACRES.

## SCHEDULE OF ANTICIPATED CONSTRUCTION ACTIVITY:

1. INSTALL INITIAL BMP'S
2. INSPECTION OF INITIAL BMP'S BY COUNTY STAFF
3. PRECONSTRUCTION MEETING WITH COUNTY STAFF

BEGIN CONSTRUCTION UPON APPROVAL	ACTIVITY ALL SITE ROADWAY GRADING AND UTILITY INSTALLATION	COMPLETION 6 MONTHS	EROSION CONTROL ALL SHOWN ON GRADING PLAN
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Colorado Springs, Colorado 80919

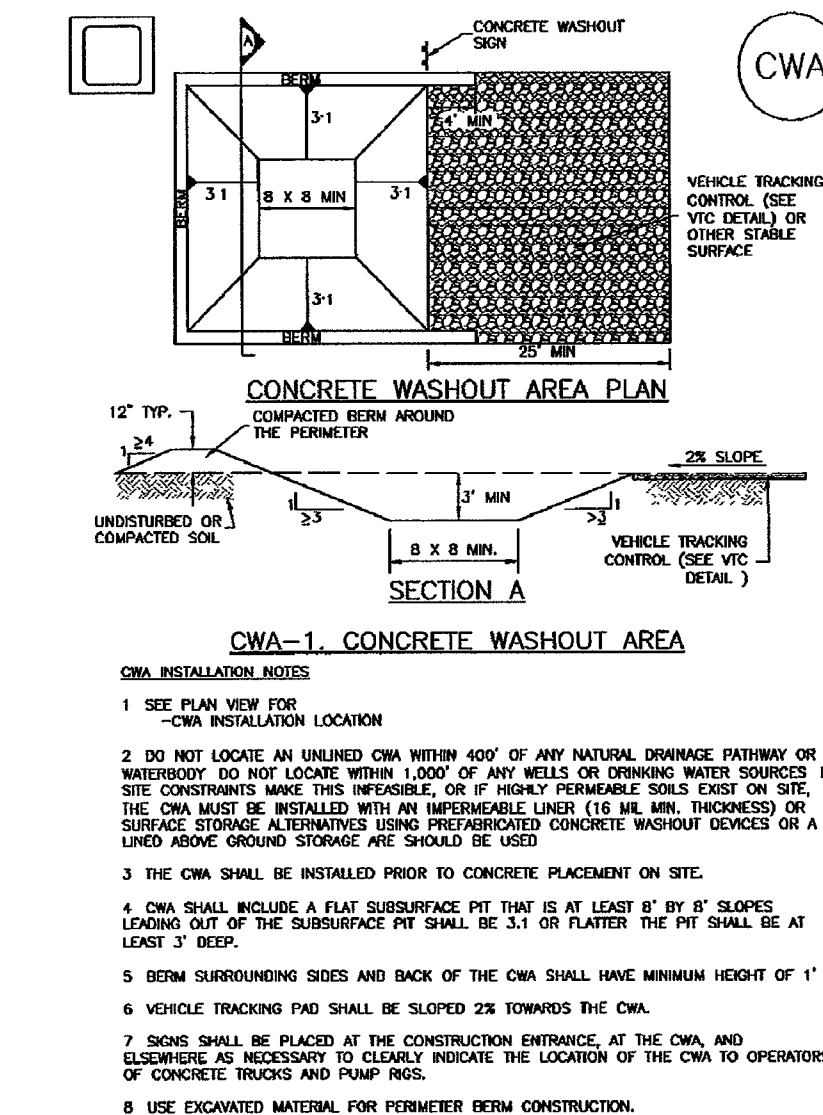
(719) 785-0790  
(719) 785-0799 (fax)

HANNAH RIDGE AT FEATHERGRASS  
FILING NO. 3  
OVERLOT GRADING AND EROSION CONTROL PLAN  
DETAILS

DESIGNED BY	KRC	SCALE	DATE	04/11/17
DRAWN BY	MES	(H) 1" = N/A	SHEET	4 OF 4
CHECKED BY	(V) 1" = N/A	JOB NO.	1116	03

## Concrete Washout Area (CWA)


MM-1



November 2010 Urban Drainage and Flood Control District  
Urban Storm Drainage Criteria Manual Volume 3

## SC-3

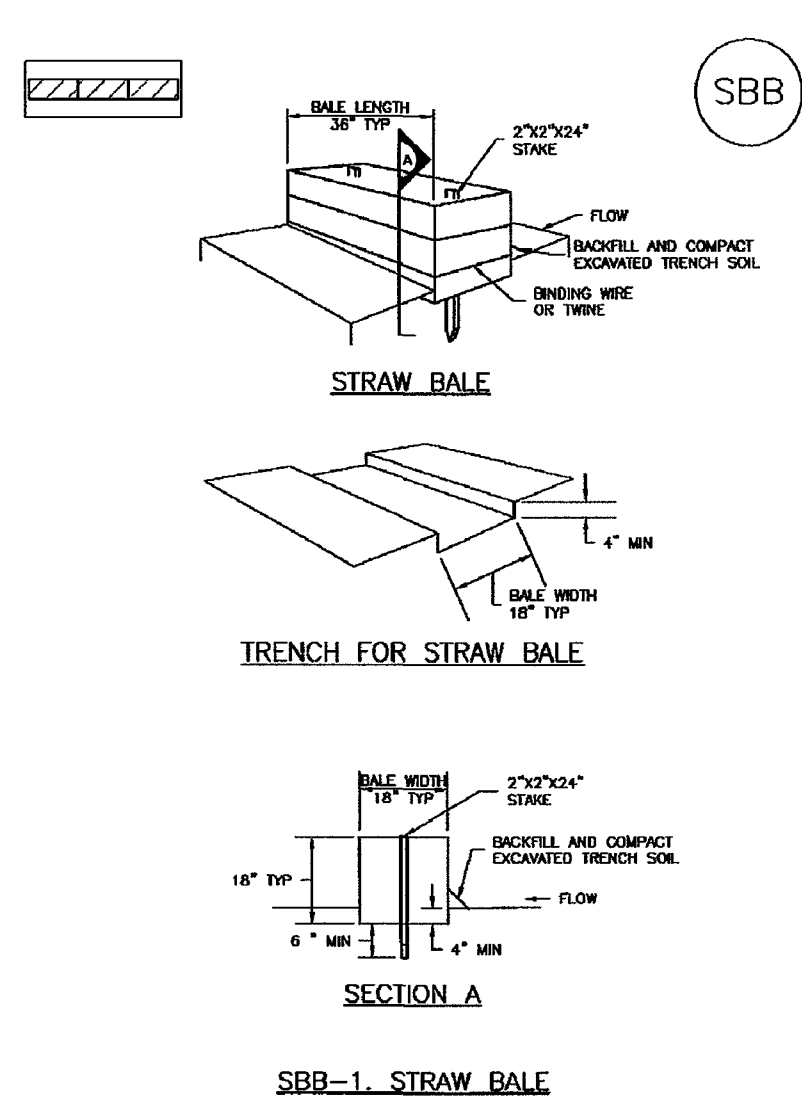
## Straw Bale Barrier (SBB)



November 2010 Urban Drainage and Flood Control District  
Urban Storm Drainage Criteria Manual Volume 3

## MM-1
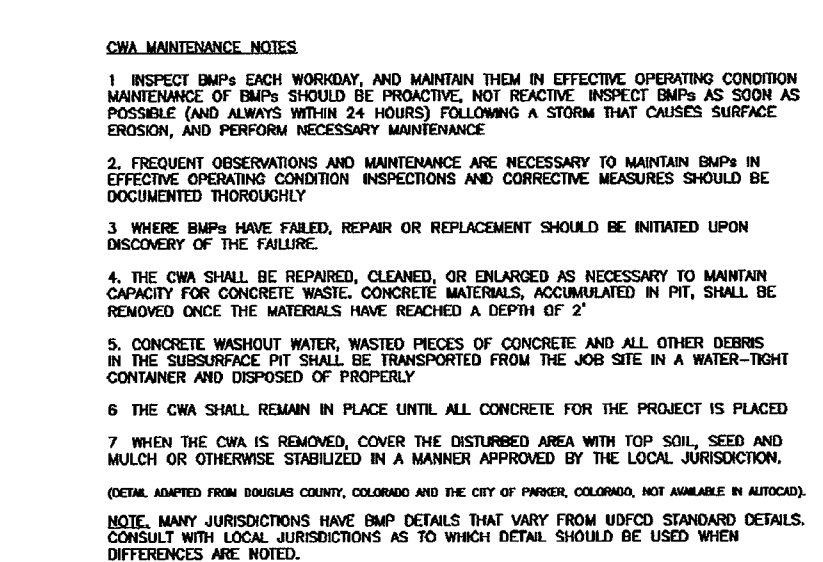
## Concrete Washout Area (CWA)



November 2010 Urban Drainage and Flood Control District  
Urban Storm Drainage Criteria Manual Volume 3

48 HOURS BEFORE YOU DIG,  
CALL UTILITY LOCATORS

# Markup Summary

dsdrice (4)



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Planning and Community Development



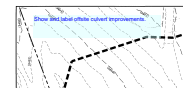
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Show and label offsite culvert improvements.