# FILE NO.: PPR-2254

# CHEROKEE METROPOLITAN DISTRICT LIFT STATION NO. 1 ADDITIONS

6657 E PLATTE AVE, PARCEL NO. 5418000080

COLORADO SPRINGS, COLORADO

SITE DEVELOPMENT PERMIT: PPR-2254

## CONTACTS

CHEROKEE METROPOLITAN DISTRICT 6250 PALMER BARK BOULEVARD

COLORADO SPRINGS, CO 80915

(719) 597-7411

NATHAN SKALAK, P.E.

CIVIL ENGINEER (PLAN PREPARER):

CONTRACTOR:

SURVEYOR:

JVA, INC 1319 SPRUCE STREET BOULDER, CO 80302

ENVIRONMENTAL ENGINEER: JVA, INC

1319 SPRUCE STREET BOULDER, CO 80302

STANEK CONSTRUCTORS, INC.

651 CORPORATE CIRCLE SUITE 108 GOLDEN, CO 80401

EDWARD-JAMES SURVEYING, INC. 926 ELKTON DRIVE

COLORADO SPRINGS, CO 80907


JMUNGER@CHEROKEEMETRO.ORG

(303) 565-4930 NSKALAK@JVAJVA.COM MICHAEL KATALINICH, P.E.

(303) 565-4952MKATALINICH@JVAJVA.COM

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THOMAS SHAUGHNESSY, PLS (719) 304 - 4480TOMS@EJSURVEYING.COM

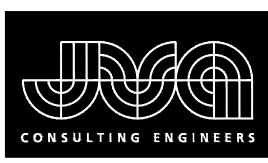

1319 Spruce Street 303.444.1951 Boulder, CO 80302

Boulder • Fort Collins • Winter Park Glenwood Springs . Denver

www.jvajva.com

**APRIL 2023** 

# LEGAL DESCRIPTION:

THAT PT W2NE2 SEC 18-14-65 DESC AS FOLS: COM AT N4 COR SD SEC DESC BY REC 212137112. TH N 00<46'59" E 129.52 FT, N 26<10'54" E 873.59 FT, TH ALG ARC OF CUR TO THE R HAVING A RAD OF 3452.20 F A C/A OF 6<33'34" AN ARC DIST OF 395.22 FT, TH N 32<44'28" E 9.33 FT TO A PT ON THE SLY R/W LN O US HWY 24, TH S 89<55'03" E 296.95 FT TO NW COR OF TR DESC BY BK (3156-91), TH CONT S 89<55'03" E 127.67 FT TO A PT ON E LN W2NE4 SD SEC 18 & NE COR OF TR DESC BY BK (3156-91), TH S 00<47'32" W 2317.14 FT TO A PT ON N LN OF TR C DESC BY REC 206167022, TH 88<51'08" W 1259.94 FT, S 39<23'57" W 103.54 FT, TH N 00<46'48" E 1108.57 TO POB

## **ZONING:**

THE PROPERTY IS ZONED AS RR-5 (RESIDENTIAL RURAL DISTRICT) AND CAD-0 (COMMERCIAL AIRPORT OVERLAY DISTRICT). THE PROPOSED PROJECT WILL NOT CHANGE THE ZONING DESIGNATION.

SPACE VILLAGE AVE

DRAWING INDEX

TITLE

COVER SHEET

CIVIL DETAILS

LEGEND, NOTES, AND ABBREVIATIONS

53.38 ACRES

782 SF

5.387 SF

20,000 SF

272,000 SF

46.44 ACRES

4,000 SF

POLITICAL SUBDIVISION

SITE DEVELOPMENT PLAN

SITE DEVELOPMENT PLAN

SHEET NO.

SITE DATA:

LOT/PARCEL SIZE:

BUILDING FOOTPRINT:

LAGOON COVERAGE:

WET WELL FOOTPRINT:

EXISTING/PROPOSED LAND USE:

EXISTING BUILDINGS TOTAL AREA:


OPEN/LANDSCAPED AREA COVERAGE

IMPERMEABLE SURFACE COVERAGE:

C0.0

CO.1


C2.0

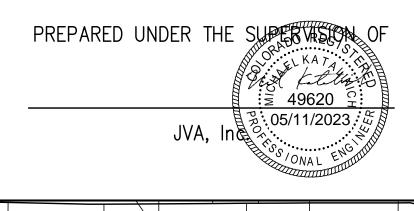


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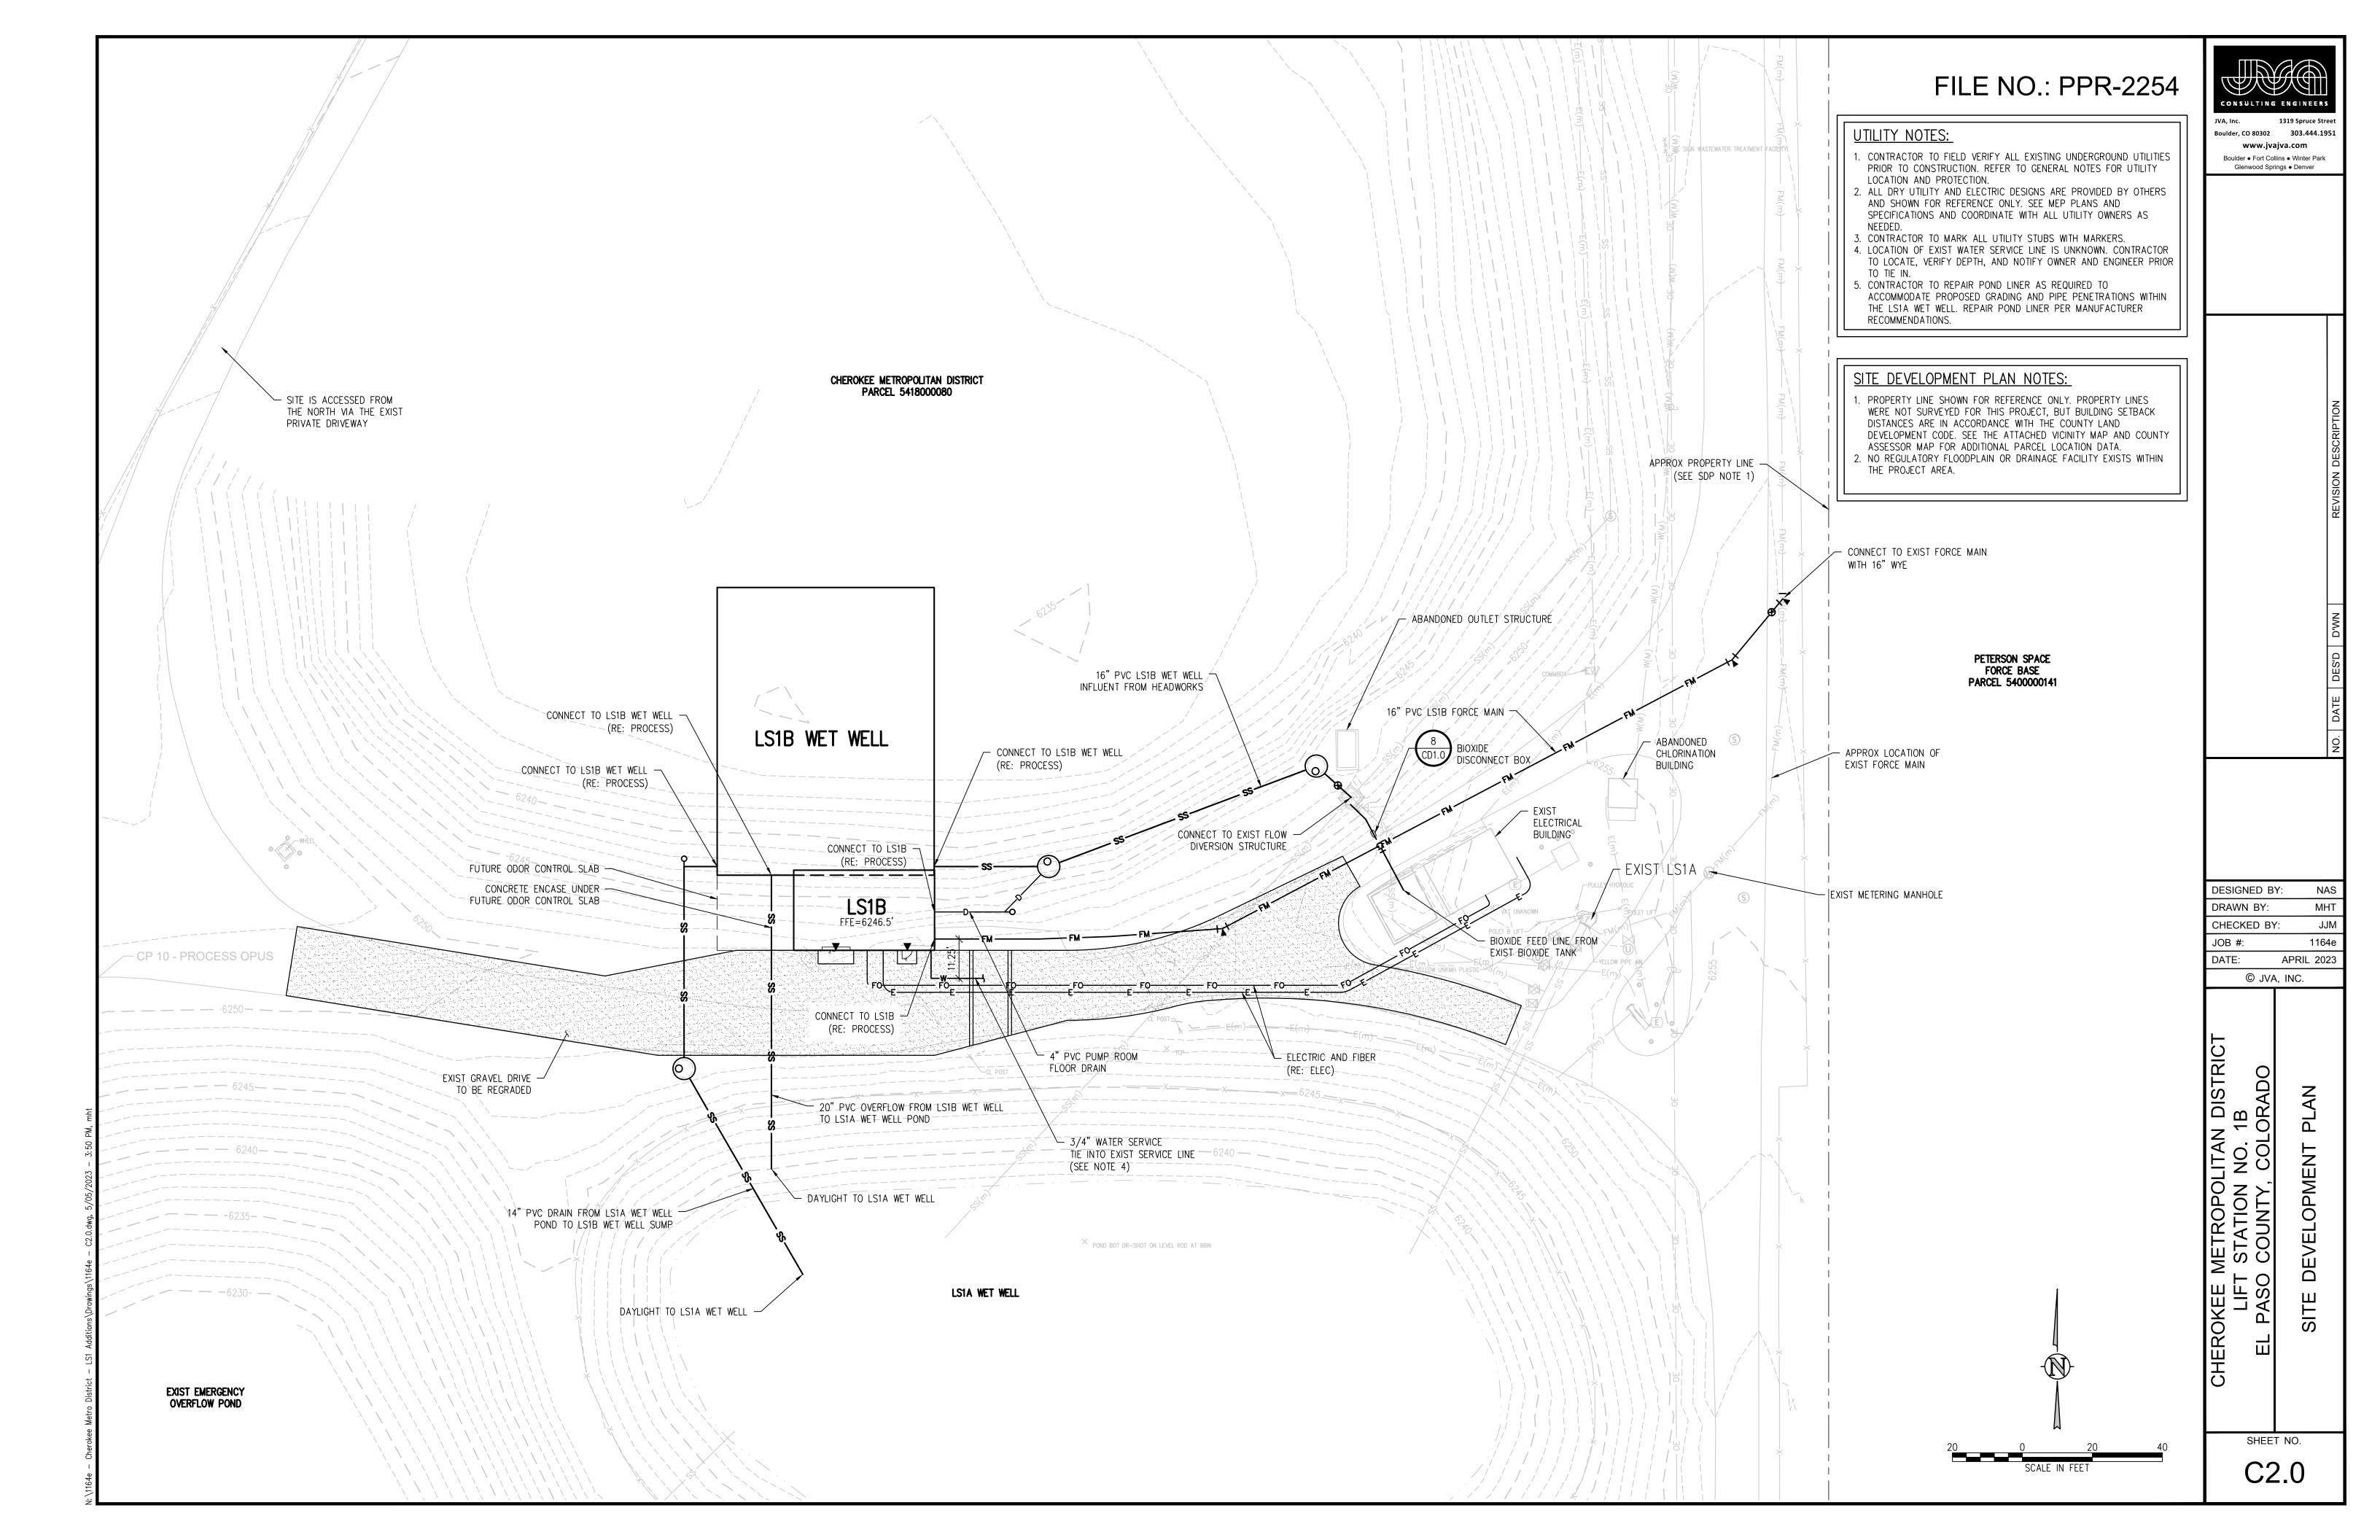
Approved By: Justin Kilgore Date:07/11/2023 El Paso County Planning & Community Development


Planning Manager

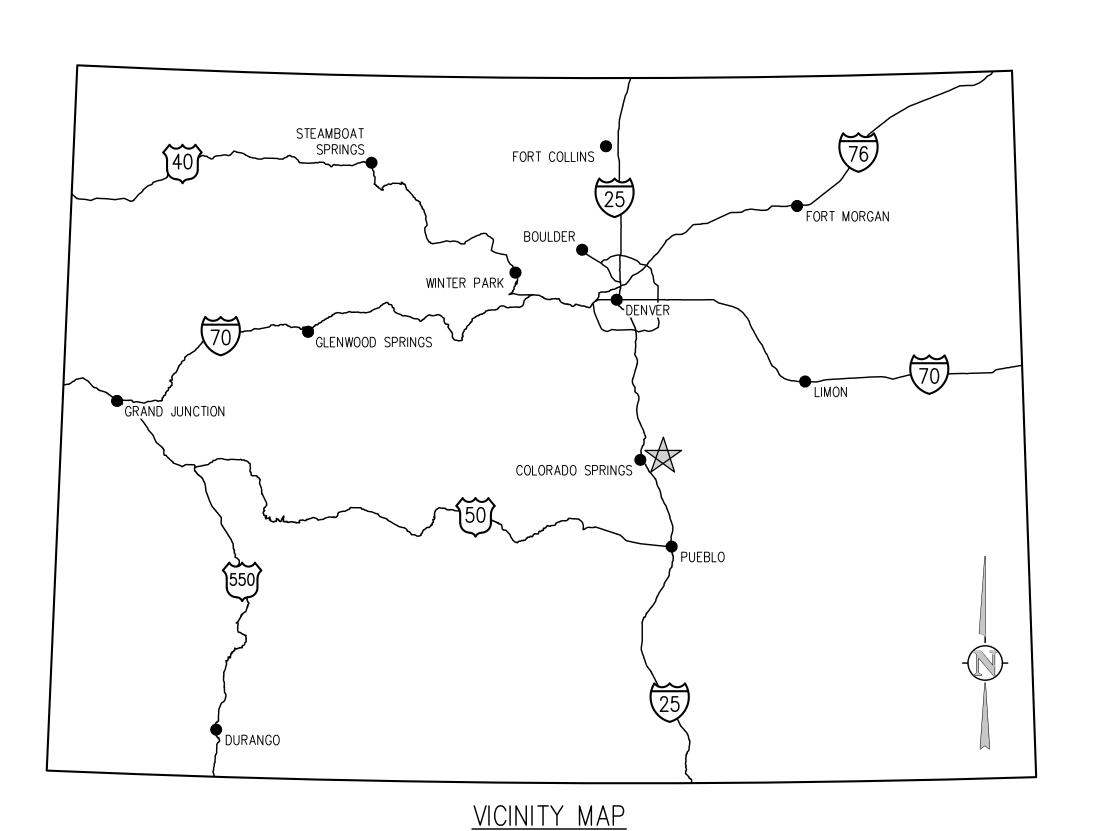

PROJECT LOCATION MAP



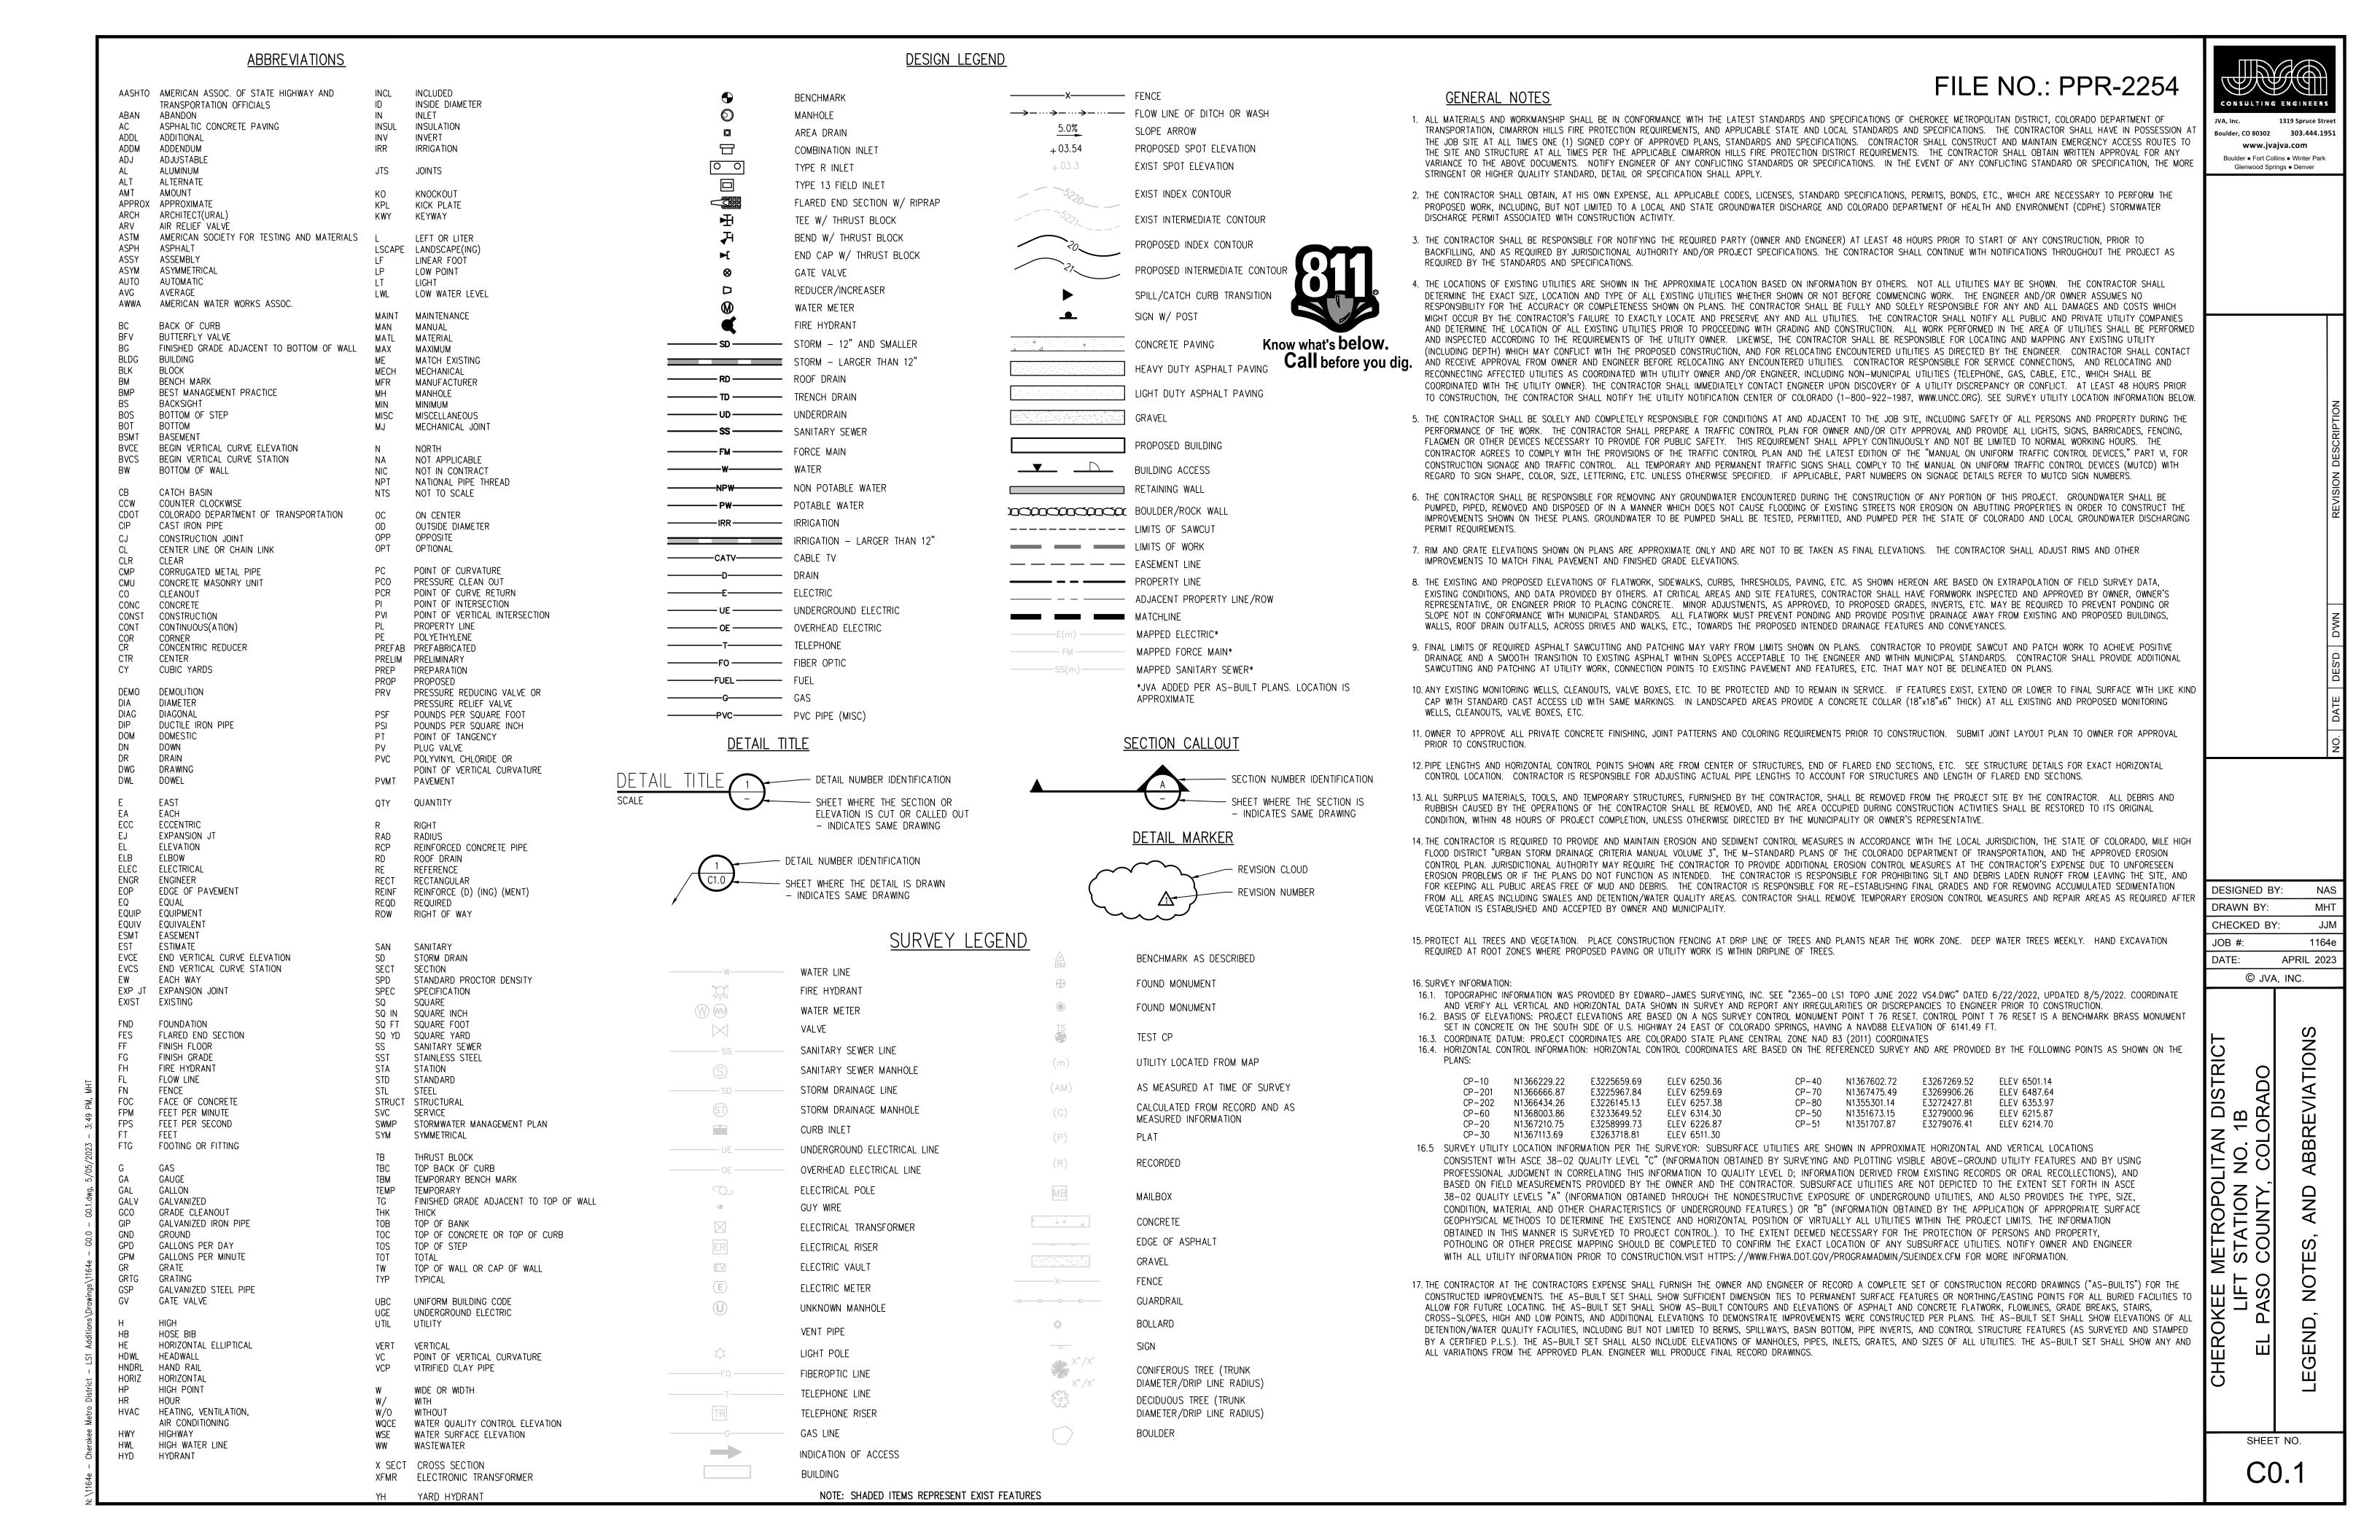

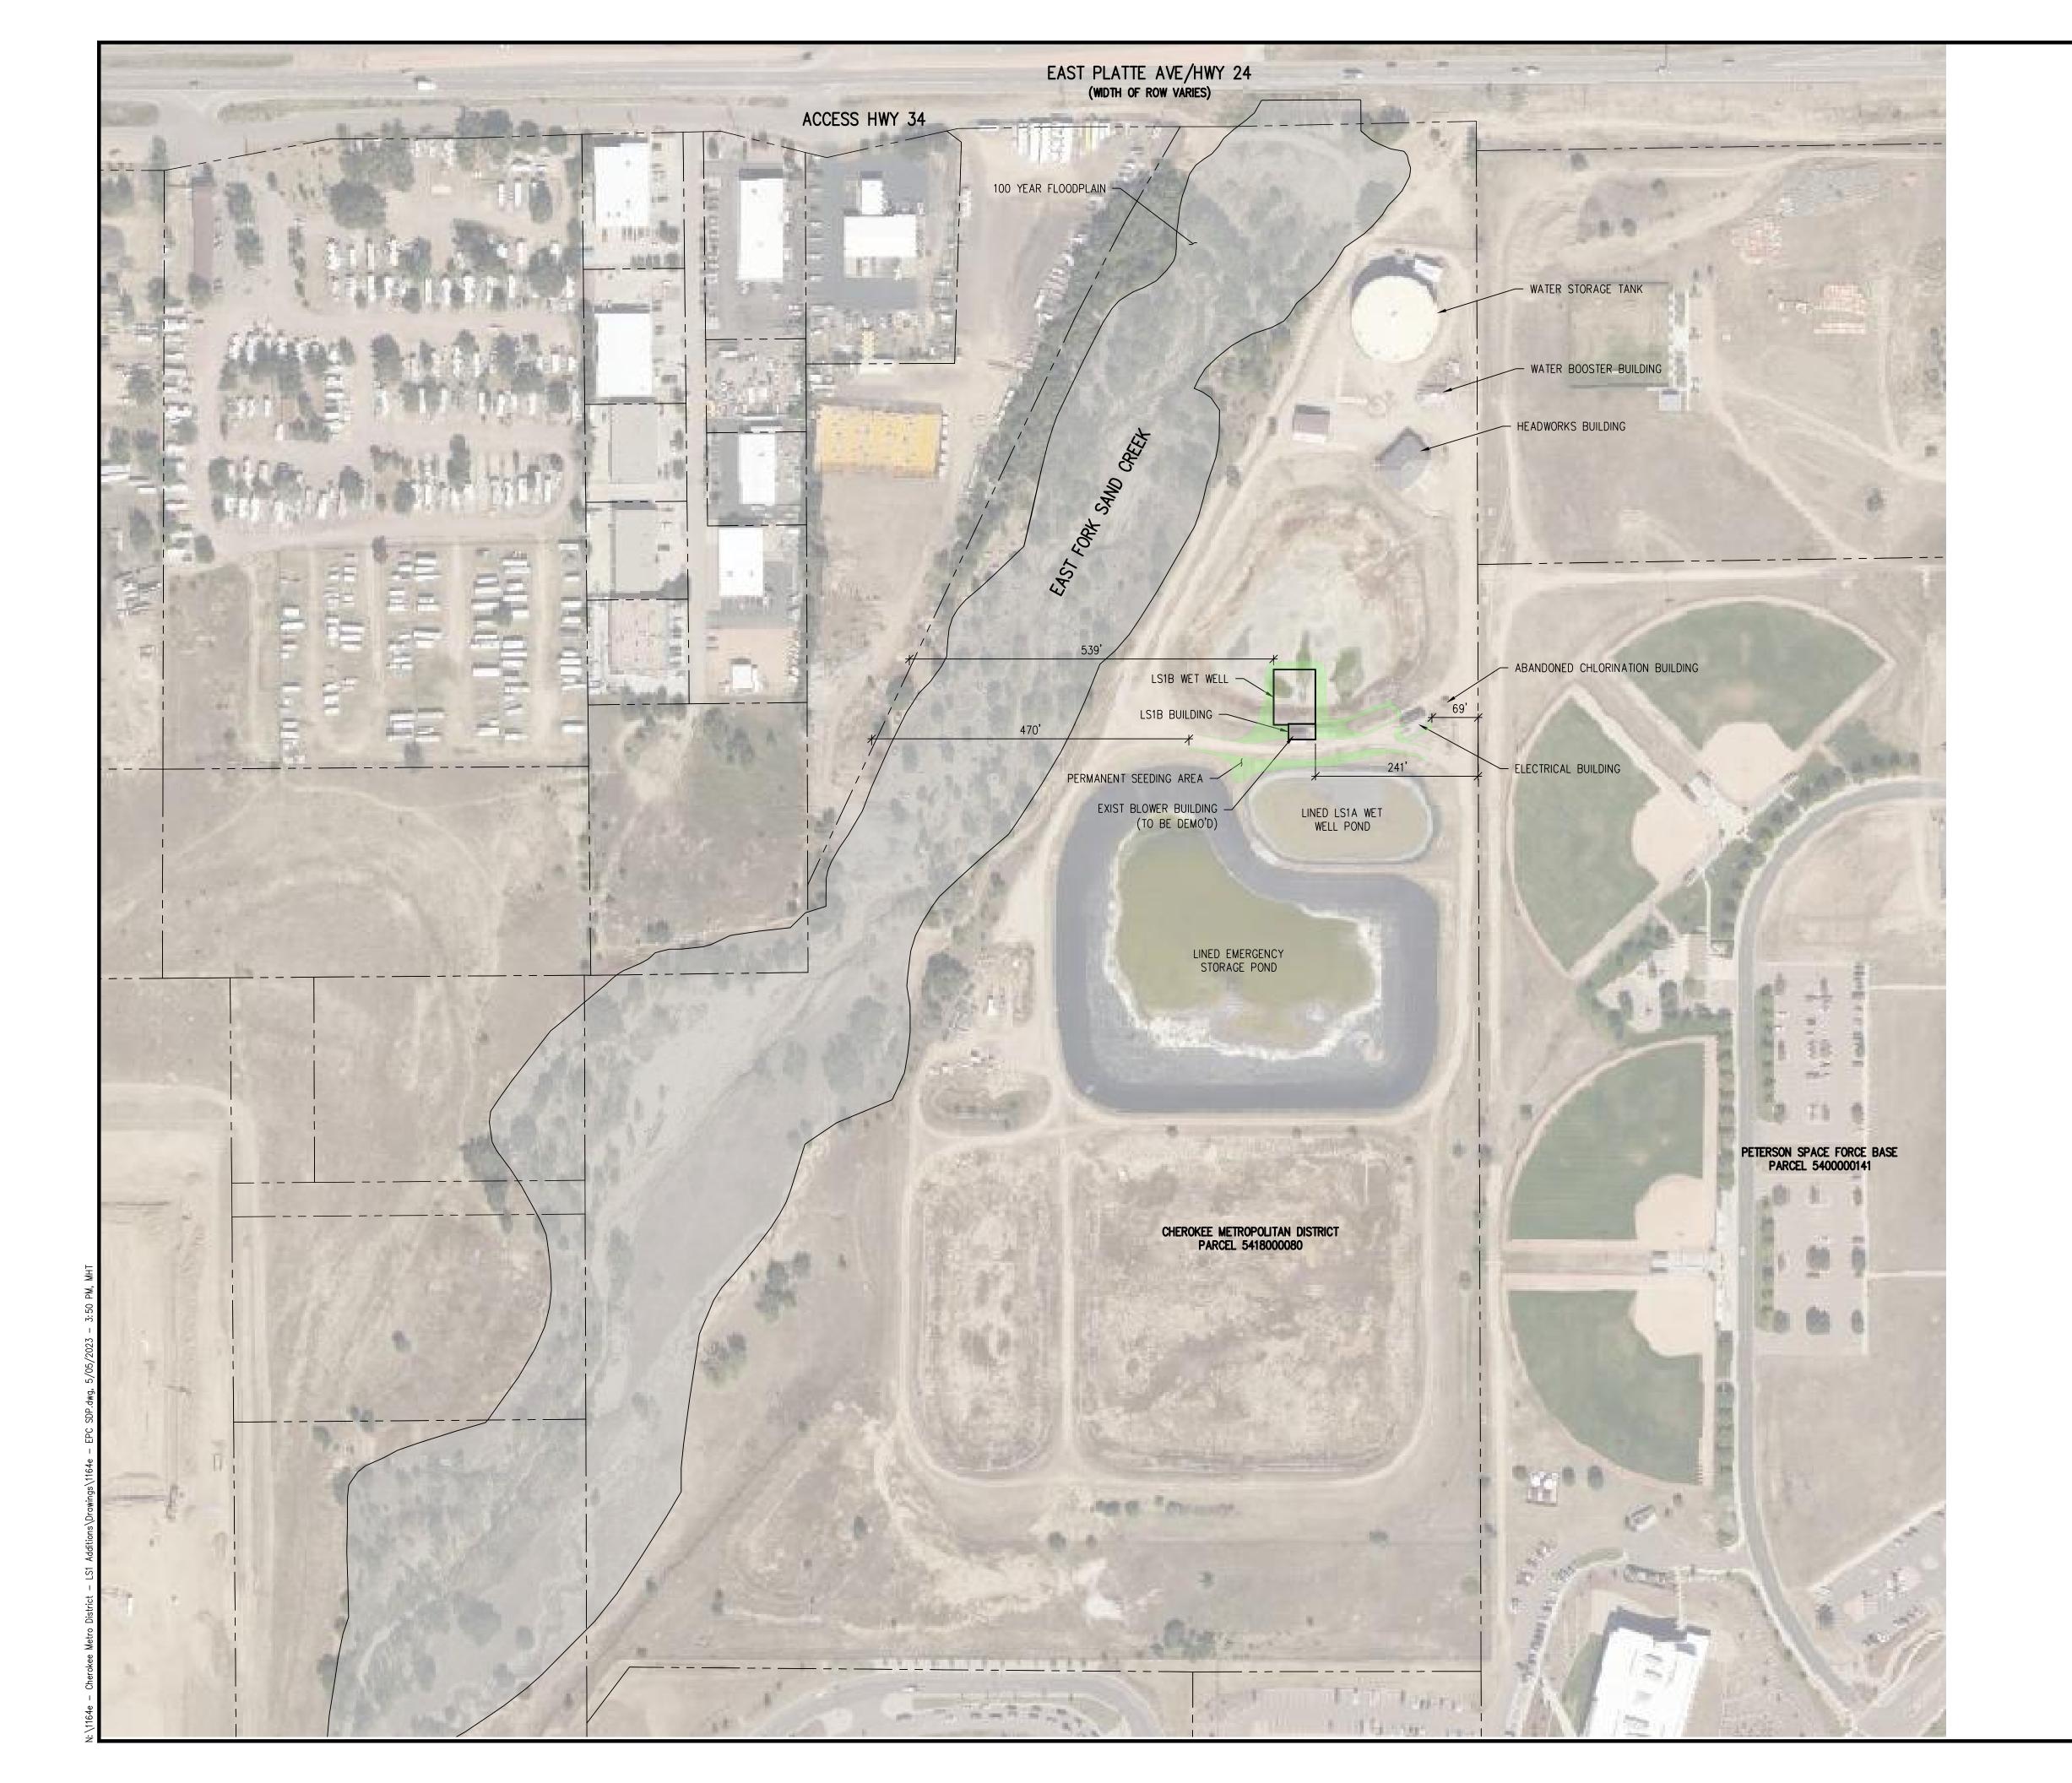

# FILE NO.: PPR-2254

# CONSULTING ENGINEERS

Boulder, CO 80302 303.444.1951 www.jvajva.com Boulder ● Fort Collins ● Winter Park Glenwood Springs ● Denver

# SITE DEVELOPMENT PLAN NOTES:

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PROPERTY LINE SHOWN FOR REFERENCE ONLY. PROPERTY LINES
WERE NOT SURVEYED FOR THIS PROJECT, BUT BUILDING SETBACK
DISTANCES ARE IN ACCORDANCE WITH THE COUNTY LAND
DEVELOPMENT CODE. SEE THE ATTACHED VICINITY MAP AND COUNTY
ASSESSOR MAP FOR ADDITIONAL PARCEL LOCATION AND SIZE DATA.
 VEHICLES WILL ENTER THE SITE NEAR THE NORTHWEST PROPERTY
CORNER VIA ACCESS HWY 34.
 DEPMANENT SEEDING AREA IS SHOWN IN CREEN SEE LANDSCAPE


J. PERMANENT SEEDING AREA IS SHOWN IN GREEN. SEE LANDSCAPE PLAN FOR DETAILED LANDSCAPING INFORMATION.

4. THE PROPOSED DEVELOPMENT DOES NOT NEED TO BE CONTAINED WITHIN UTILITY EASEMENTS BECAUSE THE PROPERTY IS DISTRICT—OWNED. NO KNOWN EASEMENTS ARE LOCATED WITHIN THE PROPERTY.

DESIGNED BY	: NAS
DRAWN BY:	MHT
CHECKED BY:	JJM
JOB #:	1164e
DATE:	APRIL 2023
© 1\/Δ	INC

ETROPOLITAN DISTRICT STATION NO. 1B COUNTY, COLORADO CHEROKEE N LIFT EL PASO

SHEET NO. C2.1

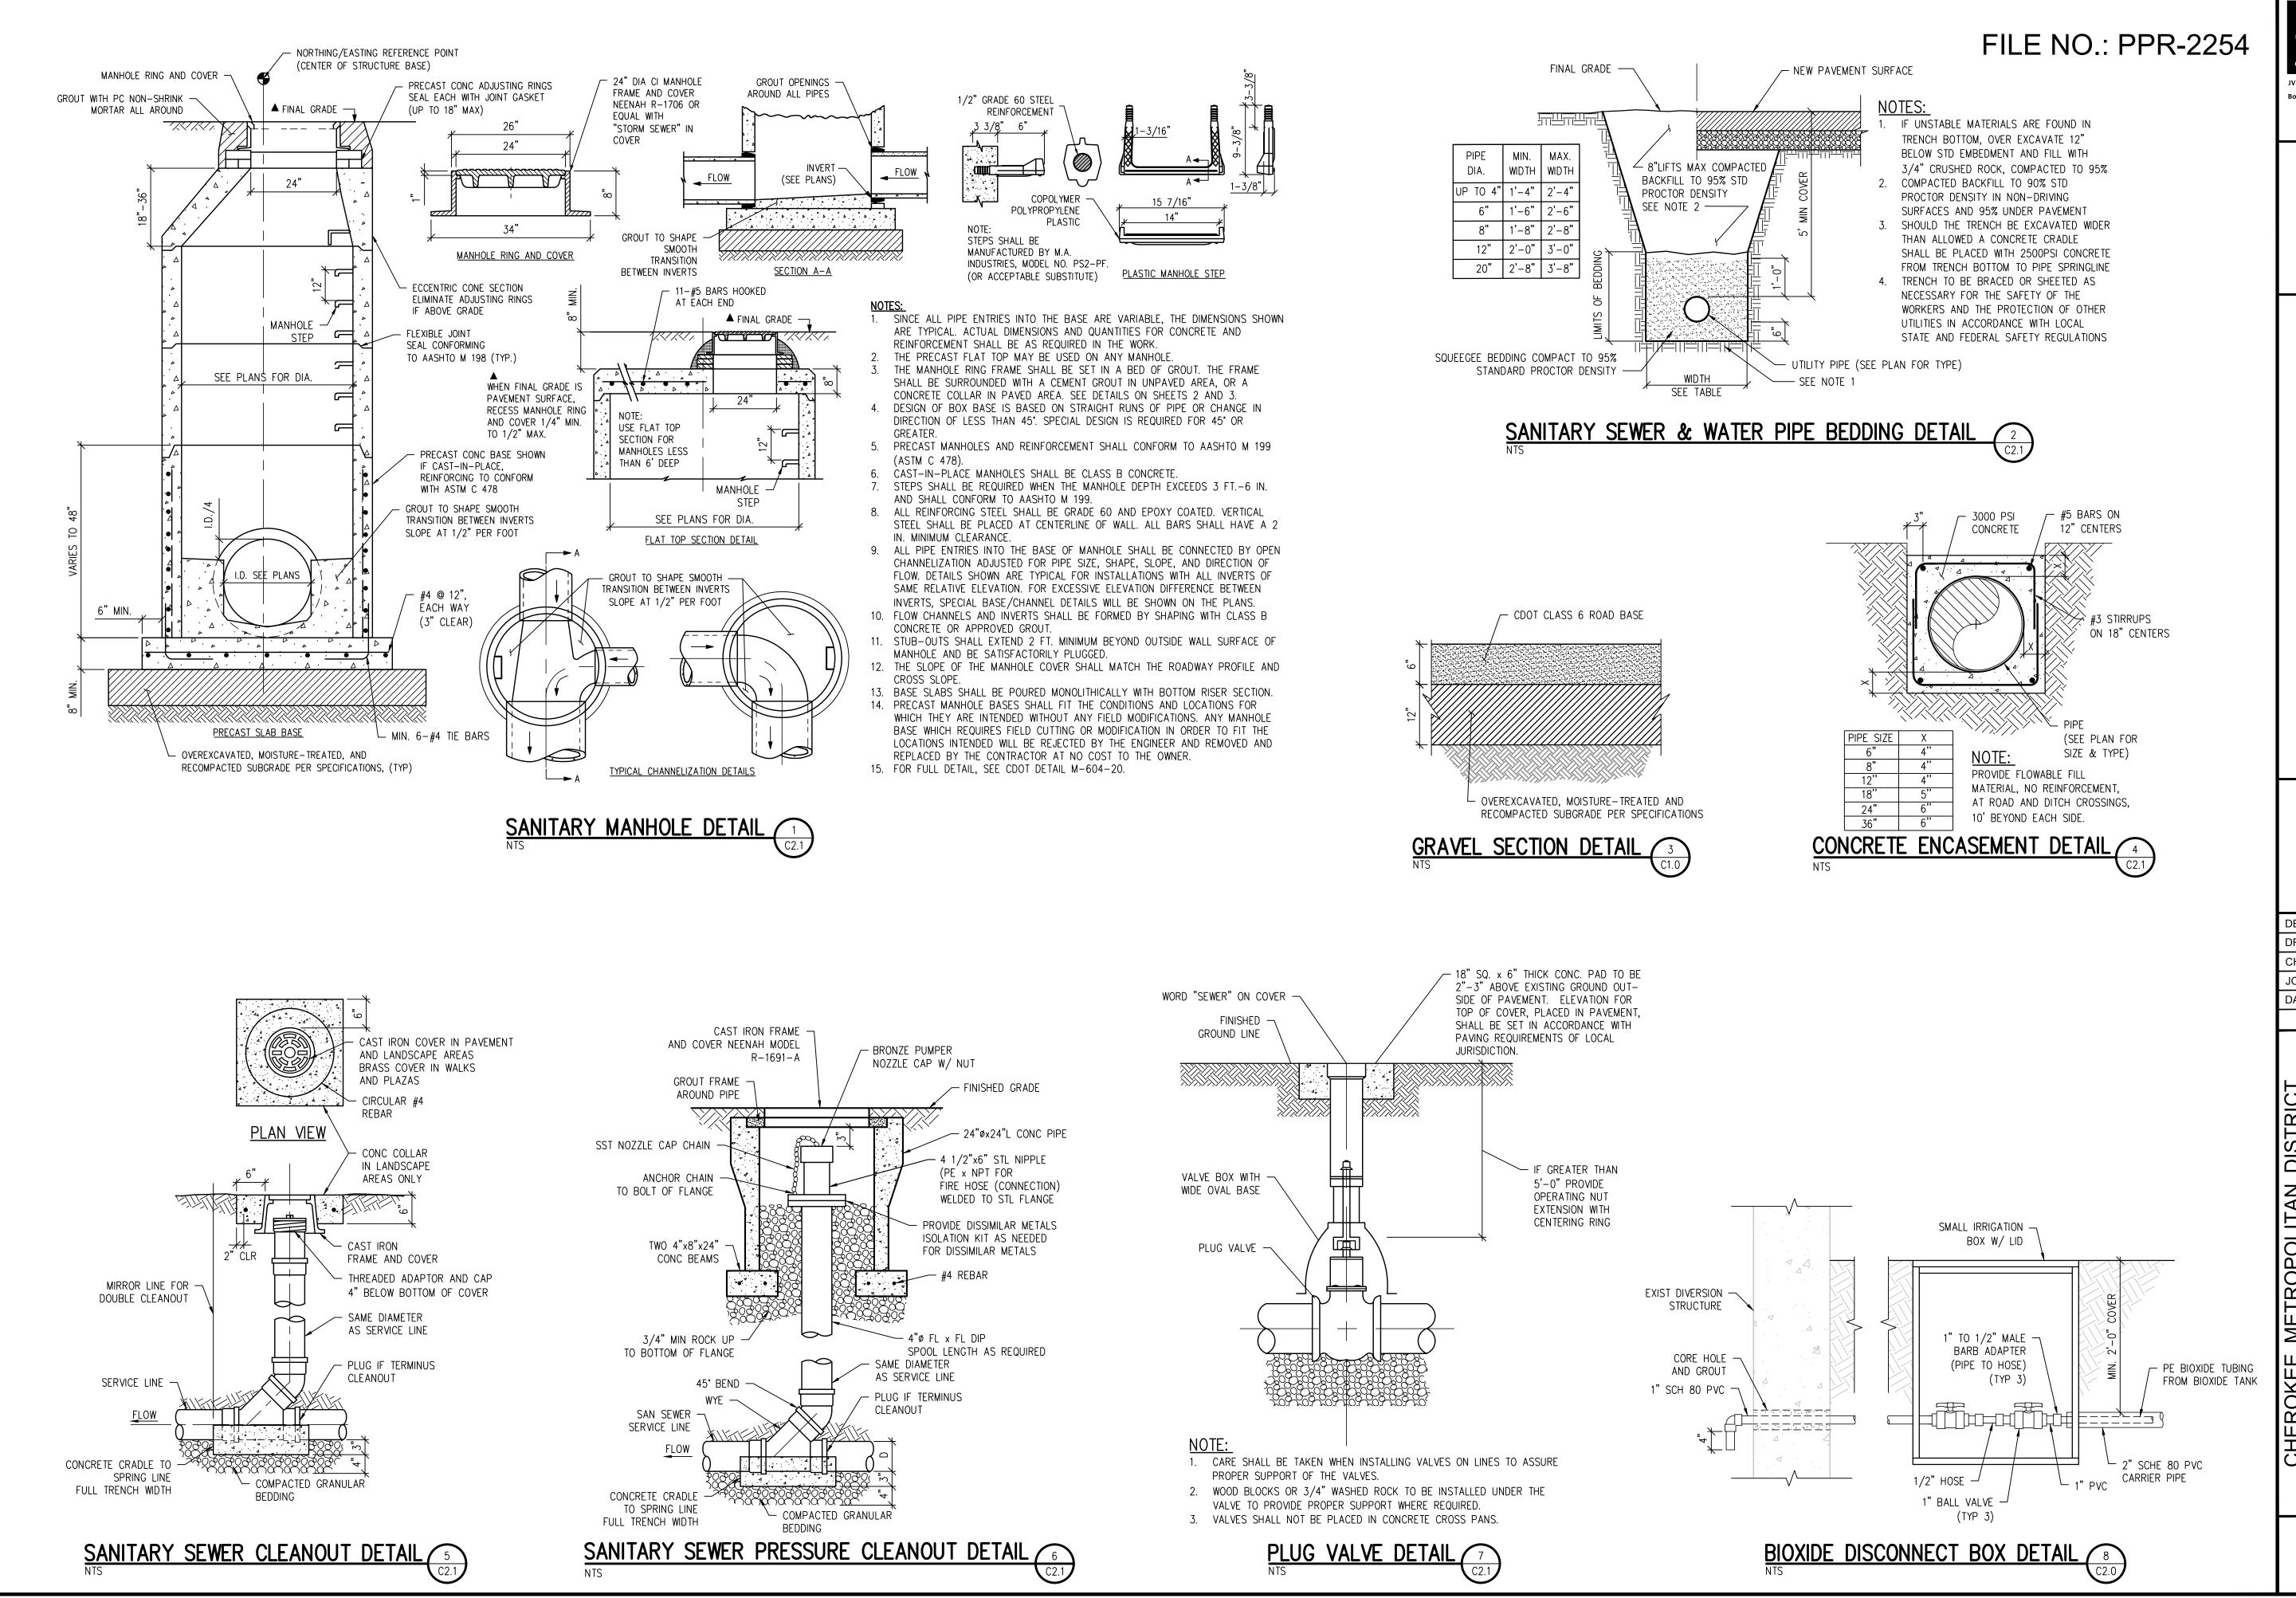

CONSULTING ENGINEERS

JVA, Inc. 1319 Spruce Street

Boulder, CO 80302 303.444.1951

www.jvajva.com

Boulder • Fort Collins • Winter Park
Glenwood Springs • Denver

DESIGNED BY: NAS
DRAWN BY: MHT
CHECKED BY: JJM
JOB #: 1164e
DATE: APRIL 2023
© JVA, INC.


EL PASO COUNTY, COLORADO


CIVIL DETAILS

CIVIL DETAILS

SHEET NO.

CD2.0

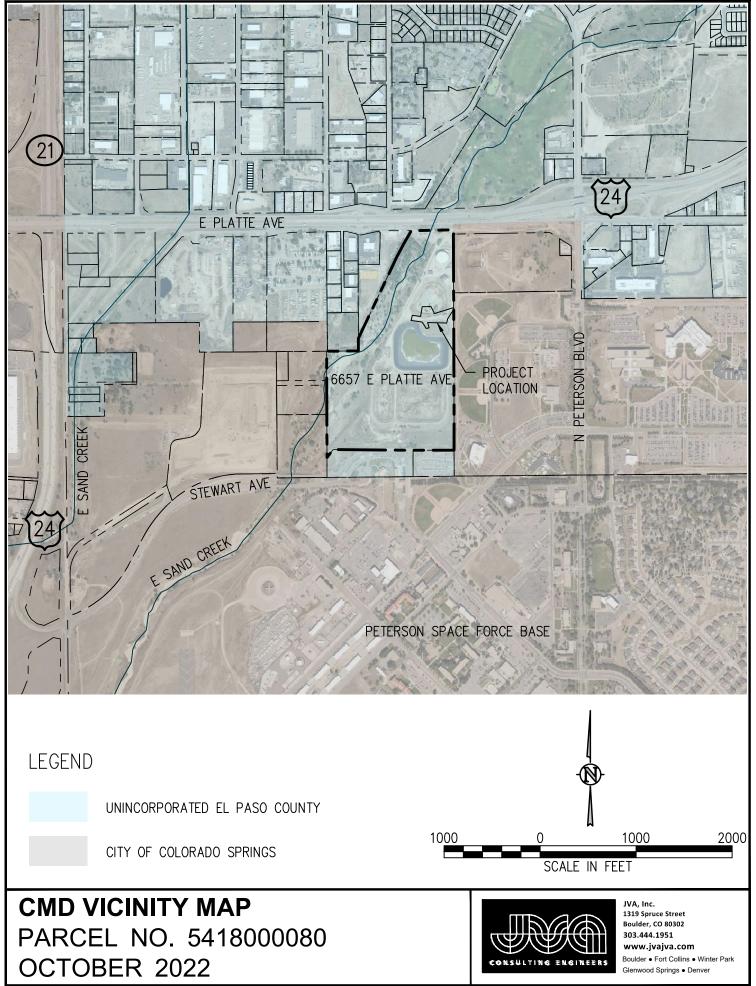

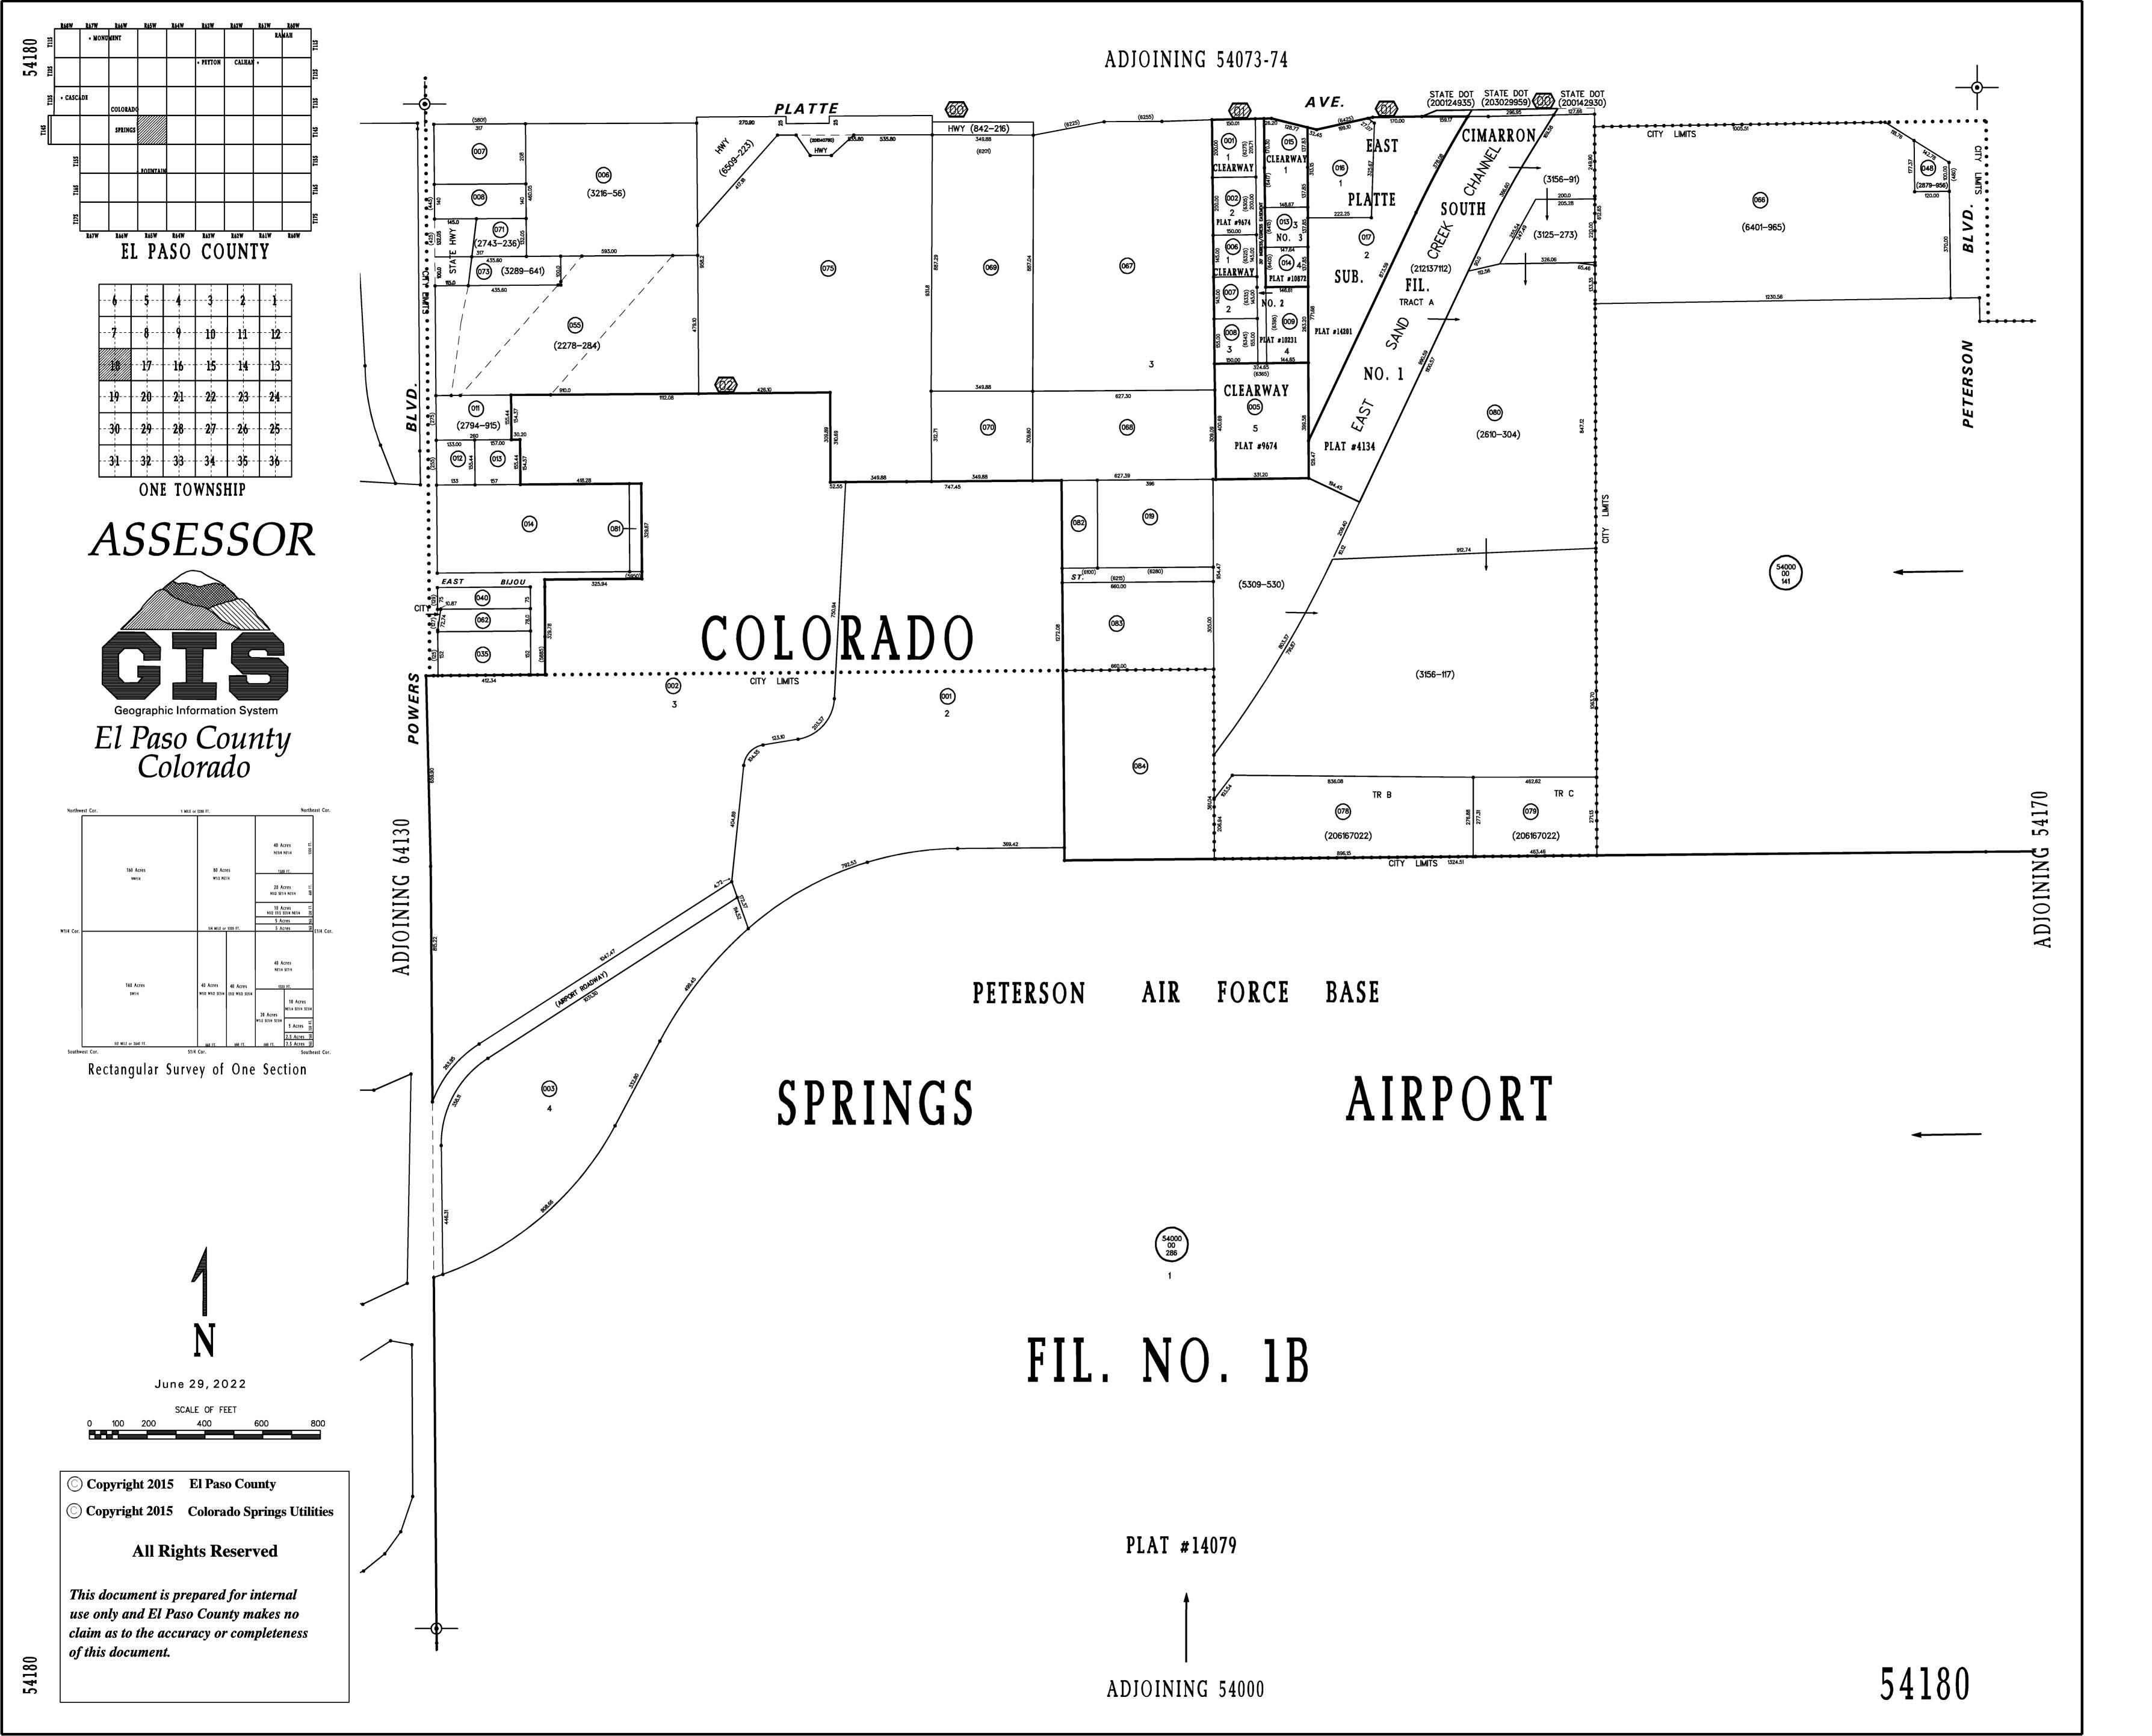



March 9, 2023

JVA, Incorporated
1319 Spruce Street

Boulder, CO 80302 303.444.1951

info@jvajva.com

www.jvajva.com

#### El Paso County Planning & Community Development

2880 International Circle, Suite 110 Colorado Springs, CO 80910-3127

Attn: Kari Parsons

RE: Cherokee Metropolitan District

Lift Station No. 1 Additions

Site Development Plan – Letter of Intent: PPR-2254

#### Dear Kari:

As a representative of the Applicant, Cherokee Metropolitan District (CMD, the District), we are preparing the submittal requirements for an administrative Site Development Plan to construct a lift station and wet well to replace the existing system located at CMD's Sand Creek Facility. The project is located on **Parcel No. 5418000080.** 

The Consultant/Applicant and Owner information is as follows:

#### **Consultant/Applicant:** Owner:

JVA, Inc.

Cherokee Metropolitan District
1319 Spruce Street

Boulder, CO 80302

Colorado Springs, CO 80915

Contact: Nathan Skalak, P.E. Contact: Amy Lathen Telephone: (303) 565-4930 Telephone: (719) 597-7411

Email: NSkalak@jvajva.com Email: ALathen@cherokeemetro.org

#### **General Information**

Cherokee Metropolitan District (CMD) provides water, sewer, parks, and street lighting services to an approximately 6,300-acre area of unincorporated El Paso County. CMD operates a wastewater collection system that terminates at the existing lift station (LS1A) headworks and pump station. This location was formerly the District's wastewater treatment lagoon and has several unlined and lined lagoons, as well as a headworks facility. From the headworks, the flow enters a 1.7-million-gallon equalization pond and wet well. Wastewater is pumped from this wet well by two lift stations in series: LS1A and LS1B approximately six miles east. LS1A and LS1B typically deliver 900 to 1,200 gpm through a force main to a manhole at the Schriever Space Force Base, where it then flows by gravity to a Water Reclamation Facility approximately 15-miles to the east.

The current equalization pond functions as the wet well for LS1A. It is open to the air and oversized, which results in a long retention time and odor issues. The existing LS1A is an underground vault-type lift station and is a confined space that is difficult to access and maintain. The District has decided to replace the existing LS1A with a new equalization wet well and lift station Lift Station 1B (LS1B).



#### **Purpose**

The proposed improvements are located at the District's Sand Creek Facility at 6657, 6677 East Platte Avenue in unincorporated El Paso County and at approximately 38°N 50' 10.5" latitude, 104°W 42' 24.7" longitude. The 53.38-acre property (parcel 5418000080) is immediately south of Platte Avenue on the east bank of East Sand Creek and is bordered by the Peterson Space Force Base on its south and west sides. The Sand Creek Facility property is a Political Subdivision with zoning designations of RR-5 (residential rural district) and CAD-0 (commercial airport overlay district).

The improvements consist of clearing and grubbing, construction of a new lift station building and covered wet well, utility connections, site grading, and demo of an accessory structure. No public right-of-way exists within the project limits.

This project falls under the classification of a minor site development and complies with the standards detailed in Chapter 6 – General Development Standards of the El Paso County Land Development Code (LDC). Utility design is in accordance with CMD standards as well as County standards. The County determined that a 1041 was not required for this project per County Administrative Determination No. 22-021.

#### **Transportation & Access**

Due to the nature of the project, the existing site access and circulation do not change. The proposed lift station does not change the function of the site. The existing internal access road will be restored post construction to account for site grading and site disturbance for construction efforts. The proposed facility is an unmanned facility requiring no additional personnel or changes to current site configuration. There are no other access points to the site which would require additional construction fencing, signage, or barricades. All site traffic enters from the north and will remain that way for the duration of construction.

#### Parking, Signage, and Trash Enclosures

The lift station (LS1B) will not be a maned facility, therefore, there are no planned parking spaces, signage, or a trash enclosure to support the facility. There is an existing facility on the property located just north of the lagoon where primary operations take place. This location will serve to support operations throughout the site.

#### **Grading & Drainage**

No impact to current drainage patterns is anticipated with this project. All drainage at the new lift station will be diverted into the pond, where runoff currently flows, to maintain the historic patterns. No permanent BMPs will be installed. Construction of the new lift station involves grading within the limits of the Sand Creek Facility.



#### Landscaping

Landscaping is intended to be minimal at the site except for preventing erosion. An Alternative Landscape Plan has been provided to show the intent. Due to the nature of the facility, trees and shrubs are known to interfere with operation. Roots and maintenance needs create issues for operations efforts, piping, and infrastructure, therefore, the District prefers keep all vegetation to a minimum. All disturbed areas will be reseeded and stabilized with an approved El Paso County seed mixtures to prevent erosion on the site.

#### **Lighting Plan**

A lighting plan is included as part of the site design. Lighting is limited to providing required lights at access points into the proposed lift station facility and several areas around the lift station to illuminate the area. It was noted during the initial submittal that the photometric values registered too high. This was a result of the electrical designer to use the maximum lumens (7000) to prepare drawings, which is not the case. Lighting will be set at a lower level (around 3000 lumens).

#### **Structural Design and Geotechnical Considerations**

Based on the geotechnical report prepared for the project, the facility will require over excavation and placement of structural fill to support the reinforced base slab and footings for the facility. Special inspections will be required during installation of concrete and rebar. All disturbed and final grading require temporary and permanent seeding and mulching throughout construction to minimize erosion around proposed facility.

#### **Schedule**

Construction of the new lift station and wet well is planned to start in Summer of 2023 and is expected to be completed in Spring of 2024.

#### **Utility Information**

The new wet well and pump station will be connected to the existing infrastructure already installed on site. Site piping is limited to the proposed improvements.

For additional information, please refer to the drawings and forms enclosed with this submitted as requested to satisfy the Site Development Plan requirements.

We respectfully request that the County approve this site development plan for said improvements. For questions specific to this project, please do not hesitate to contact one of the project team members.



Cherokee Metropolitan District Lift Station No. 1 Additions Letter of Intent: PPR-2254

March 9, 2023

4 of 4

Sincerely,

JVA, INCORPORATED

By:

Nathan Skalak, P.E. Project Manager

CC: Amy Lathen, Cherokee Metropolitan District

Jeff Munger, Cherokee Metropolitan District

# FILE NO.: PPR-2254

# CHEROKEE METROPOLITAN DISTRICT LIFT STATION NO. 1 ADDITIONS

6657 E PLATTE AVE, PARCEL NO. 5418000080

COLORADO SPRINGS, COLORADO

SITE DEVELOPMENT PERMIT: PPR-2254

CONTACTS

WNER: CHEROKEE METROPOLITAN DISTRICT
6250 PALMER BARK BOULEVARD

COLORADO SPRINGS, CO 80915

(719) 597-7411 JMUNGER@CHEROKEEMETRO.ORG

CIVIL ENGINEER JVA, INC (PLAN PREPARER): 1319 SPRU

1319 SPRUCE STREET BOULDER, CO 80302

(303) 565-4930 NSKALAK@JVAJVA.COM

(303) 565-4952

MICHAEL KATALINICH, P.E.

MKATALINICH@JVAJVA.COM

NATHAN SKALAK, P.E.

ENVIRONMENTAL ENGINEER: JVA, INC

1319 SPRUCE STREET BOULDER, CO 80302

STANEK CONSTRUCTORS, INC.


651 CORPORATE CIRCLE SUITE 108 GOLDEN, CO 80401

(303) 339-2442 DFOSS@STANEKCONSTRUCTORS.COM

SURVEYOR:

CONTRACTOR:

EDWARD-JAMES SURVEYING, INC. 926 ELKTON DRIVE COLORADO SPRINGS, CO 80907 THOMAS SHAUGHNESSY, PLS (719) 304-4480 TOMS@EJSURVEYING.COM

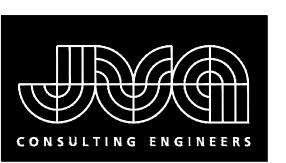

JVA, Inc. 1319 Spruce Street
Boulder, CO 80302 303.444.1951
www.jvajva.com

Boulder ● Fort Collins ● Winter Park Glenwood Springs ● Denver

FEBRUARY 2023

PREPARED UNDER THE SUPERVISION OF

LEGAL DESCRIPTION:

THAT PT W2NE2 SEC 18–14–65 DESC AS FOLS: COM AT N4 COR SD SEC 18, TH S 00<46'48" W 1315.50 FT TO NW COR OF TR DESC BY BK (5309–530) & POB, TH S 89<45'21" E 331.20 FT TO SWLY COR OF TR DESC BY REC 212137112, TH N 00<46'59" E 129.52 FT, N 26<10'54" E 873.59 FT, TH ALG ARC OF CUR TO THE R HAVING A RAD OF 3452.20 FT A C/A OF 6<33'34" AN ARC DIST OF 395.22 FT, TH N 32<44'28" E 9.33 FT TO A PT ON THE SLY R/W LN O US HWY 24, TH S 89<55'03" E 296.95 FT TO NW COR OF TR DESC BY BK (3156–91), TH CONT S 89<55'03" E 127.67 FT TO A PT ON E LN W2NE4 SD SEC 18 & NE COR OF TR DESC BY BK (3156–91), TH S 00<47'32" W 2317.14 FT TO A PT ON N LN OF TR C DESC BY REC 206167022, TH 88<51'08" W 1259.94 FT, S 39<23'57" W 103.54 FT, TH N 00<46'48" E 1108.57 TO POB

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LOT/PARCEL SIZE:

SITE DATA:

DRAWING INDEX

TITLE

COVER SHEET

LANDSCAPE PLAN

LEGEND, NOTES, AND ABBREVIATIONS

53.38 ACRES

SHEET NO.

C0.0

CO.1

CL1.0

EXISTING/PROPOSED LAND USE: POLITICAL SUBDIVISION BUILDING FOOTPRINT: 782 SF

WET WELL FOOTPRINT: 5,387 SF


EXISTING BUILDINGS TOTAL AREA: 20,000 SF


LAGOON COVERAGE: 272,000 SF

OPEN/LANDSCAPED AREA COVERAGE: 46.44 ACRES


IMPERMEABLE SURFACE COVERAGE: 4,000 SF


JVA, Inc.

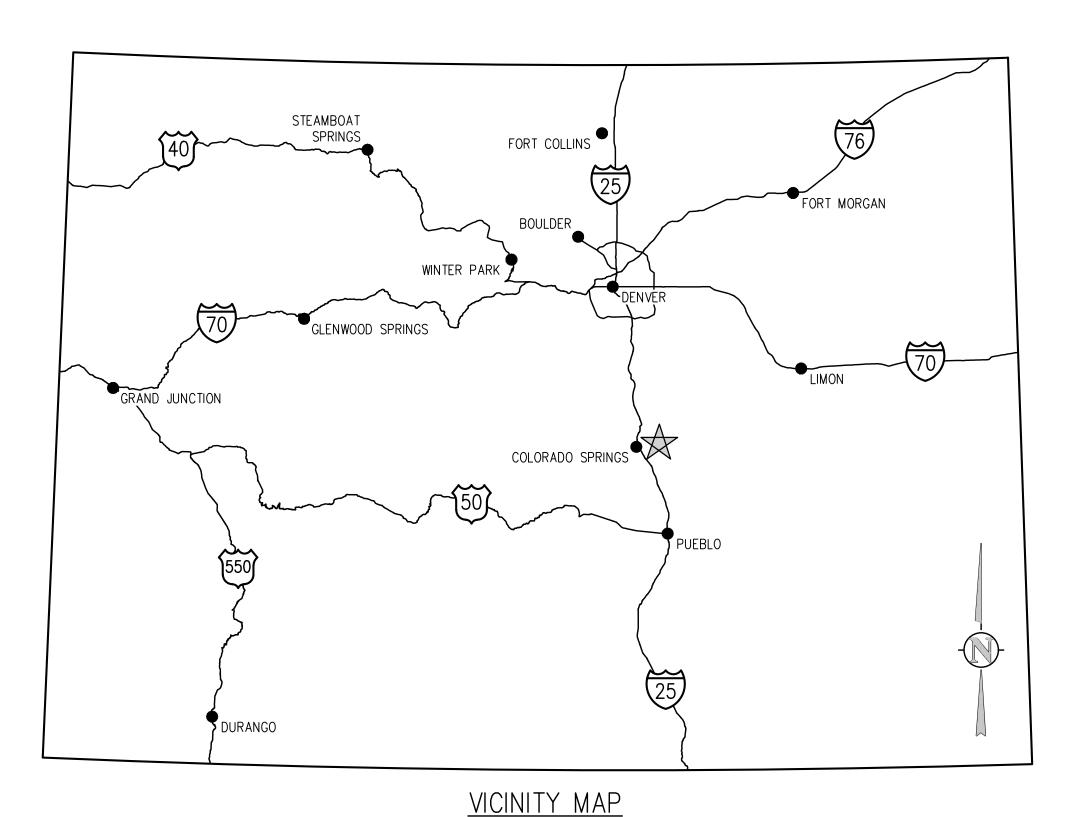

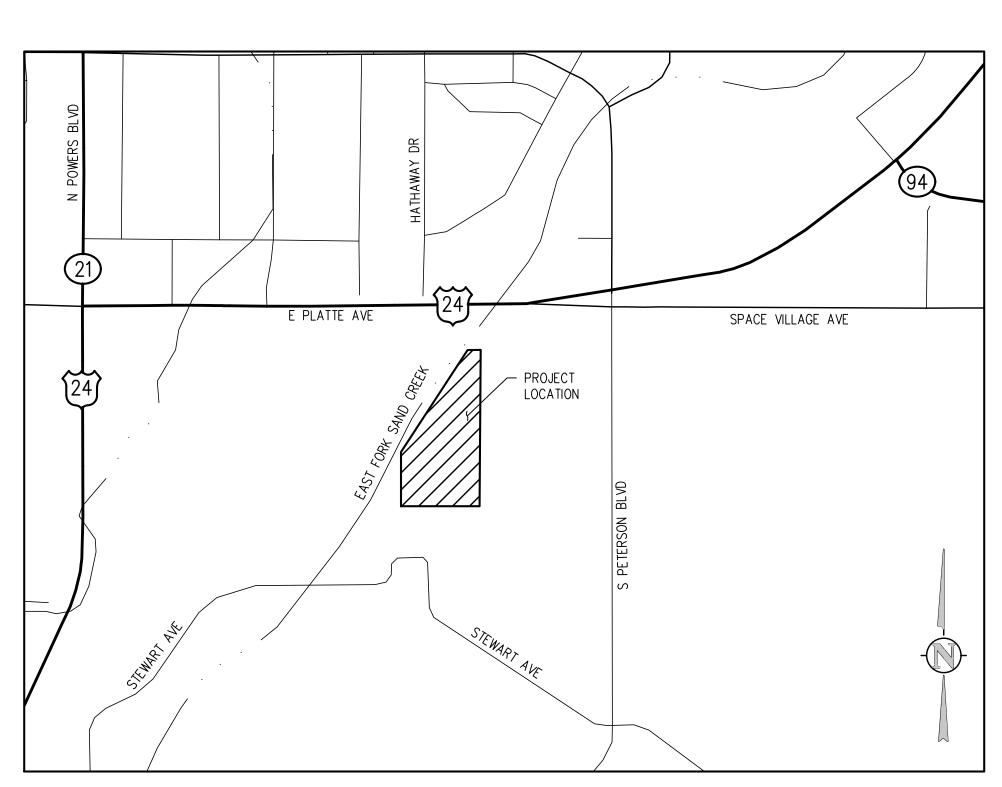

PROJECT LOCATION MAP

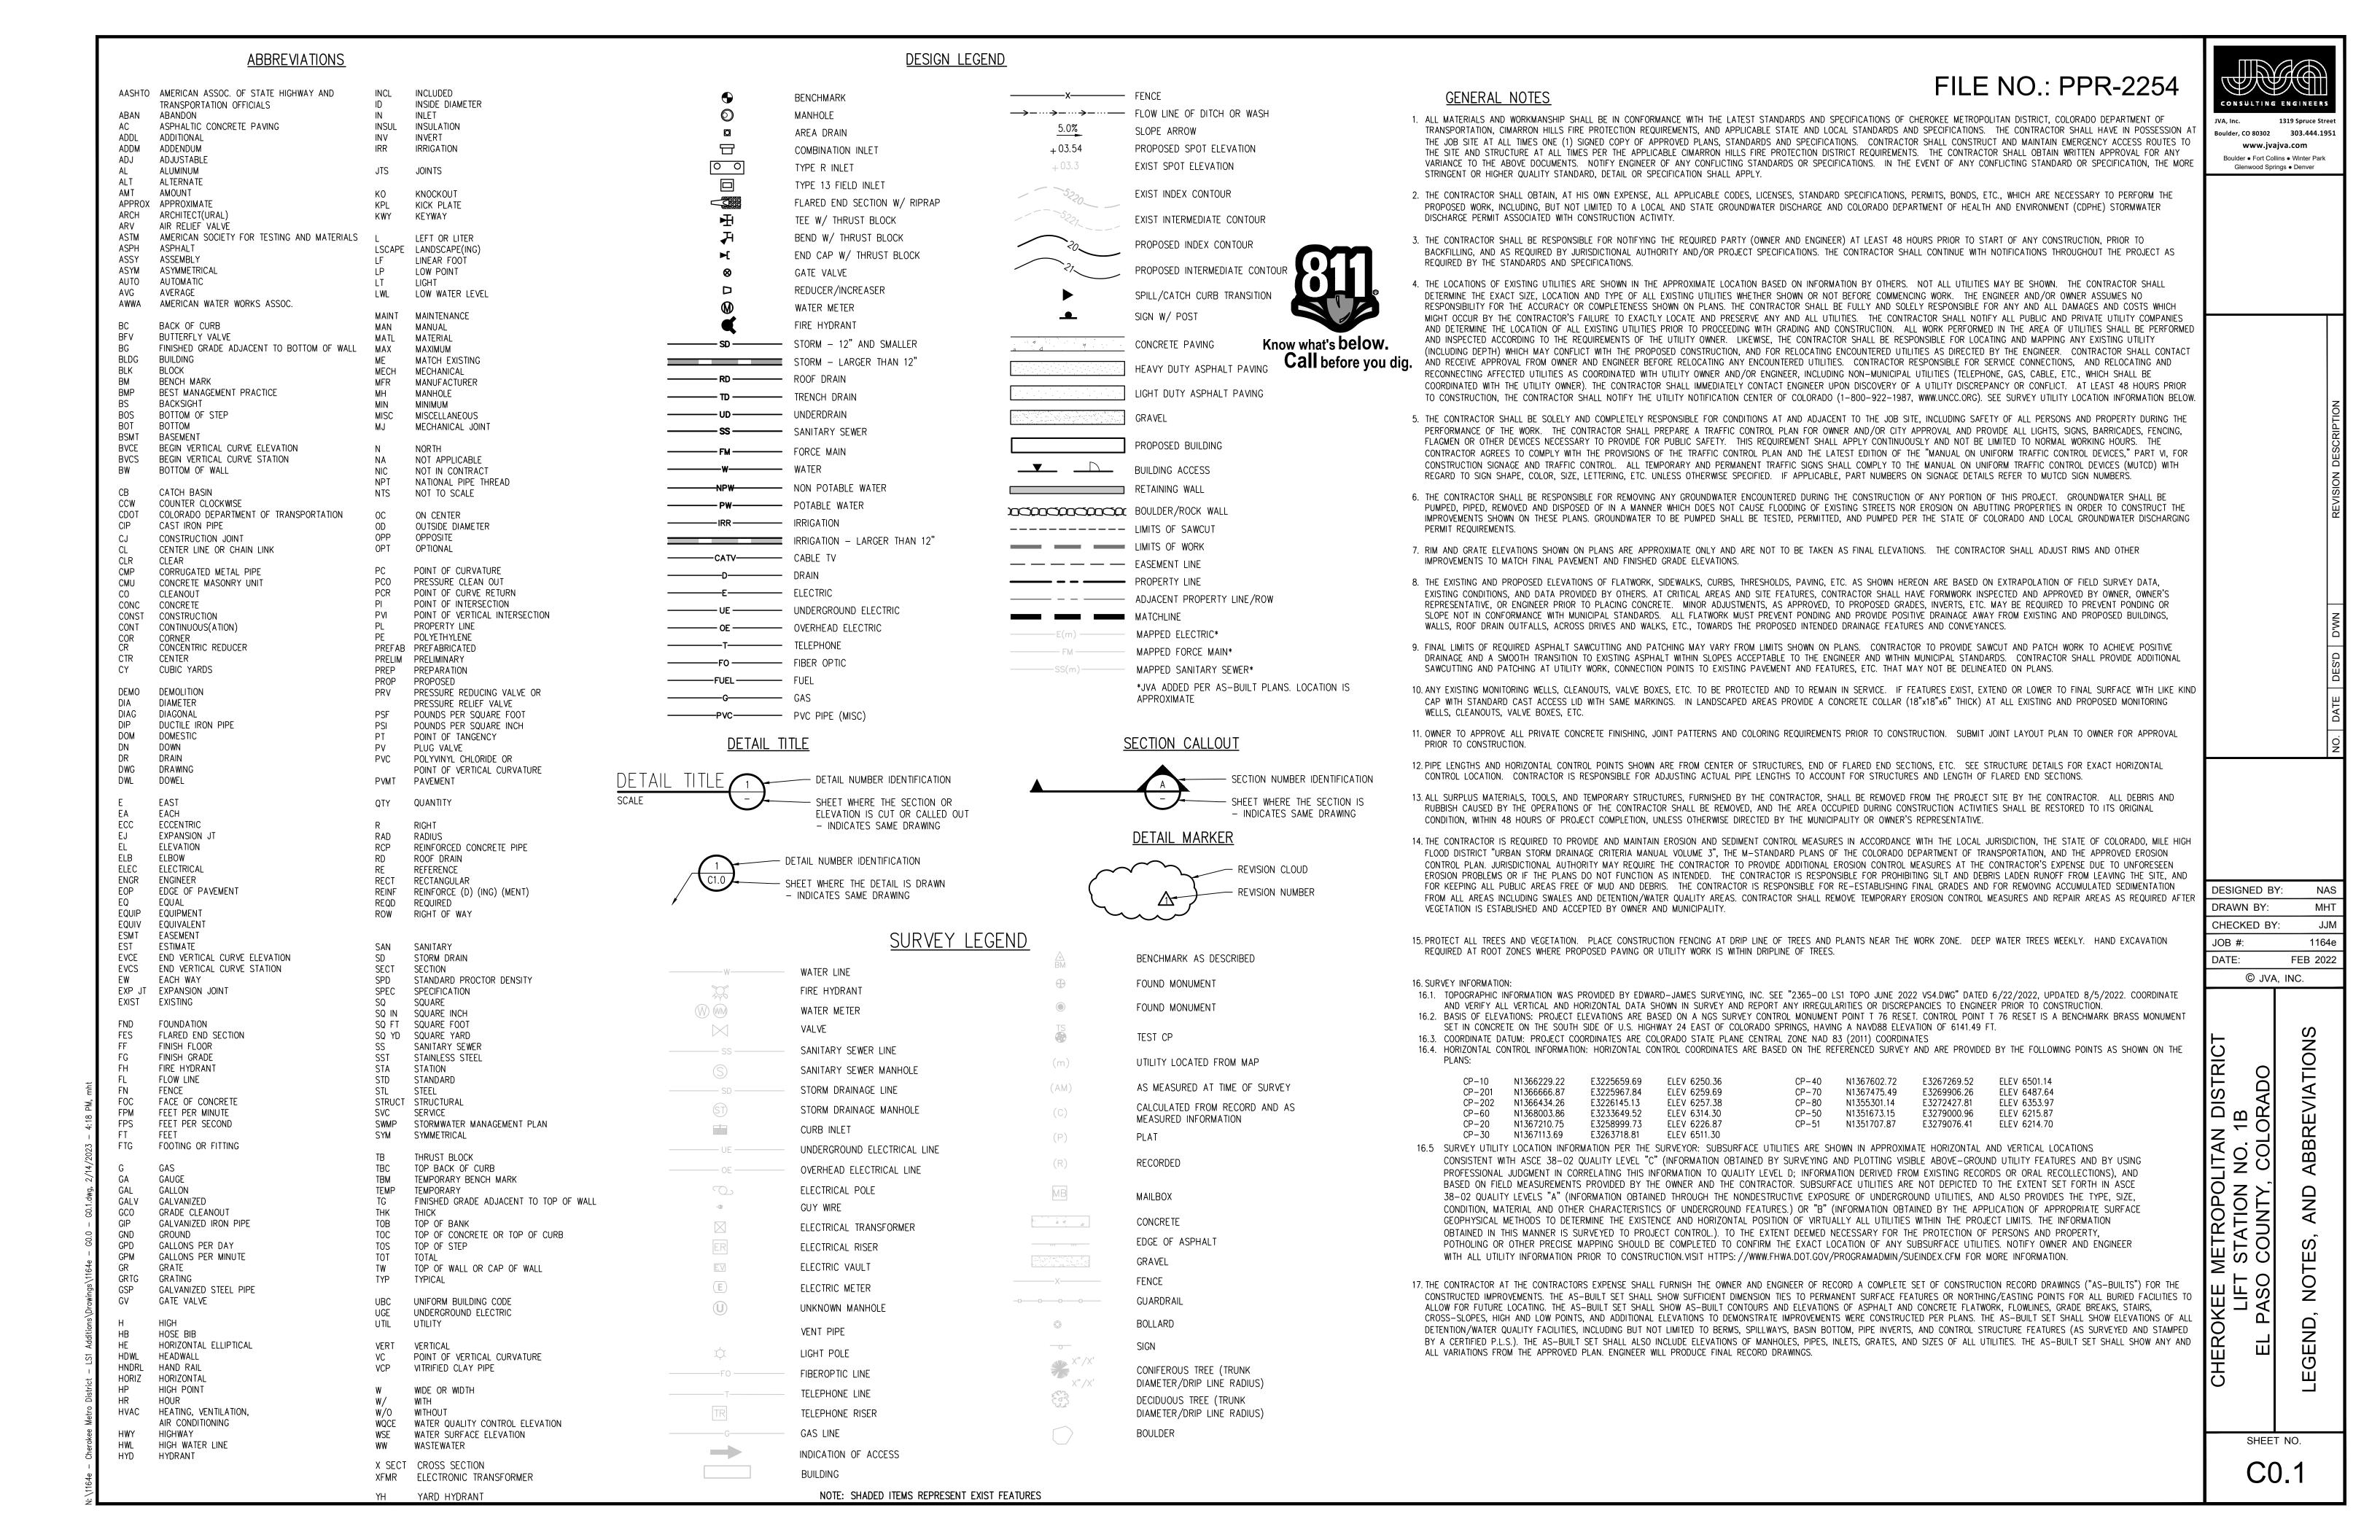

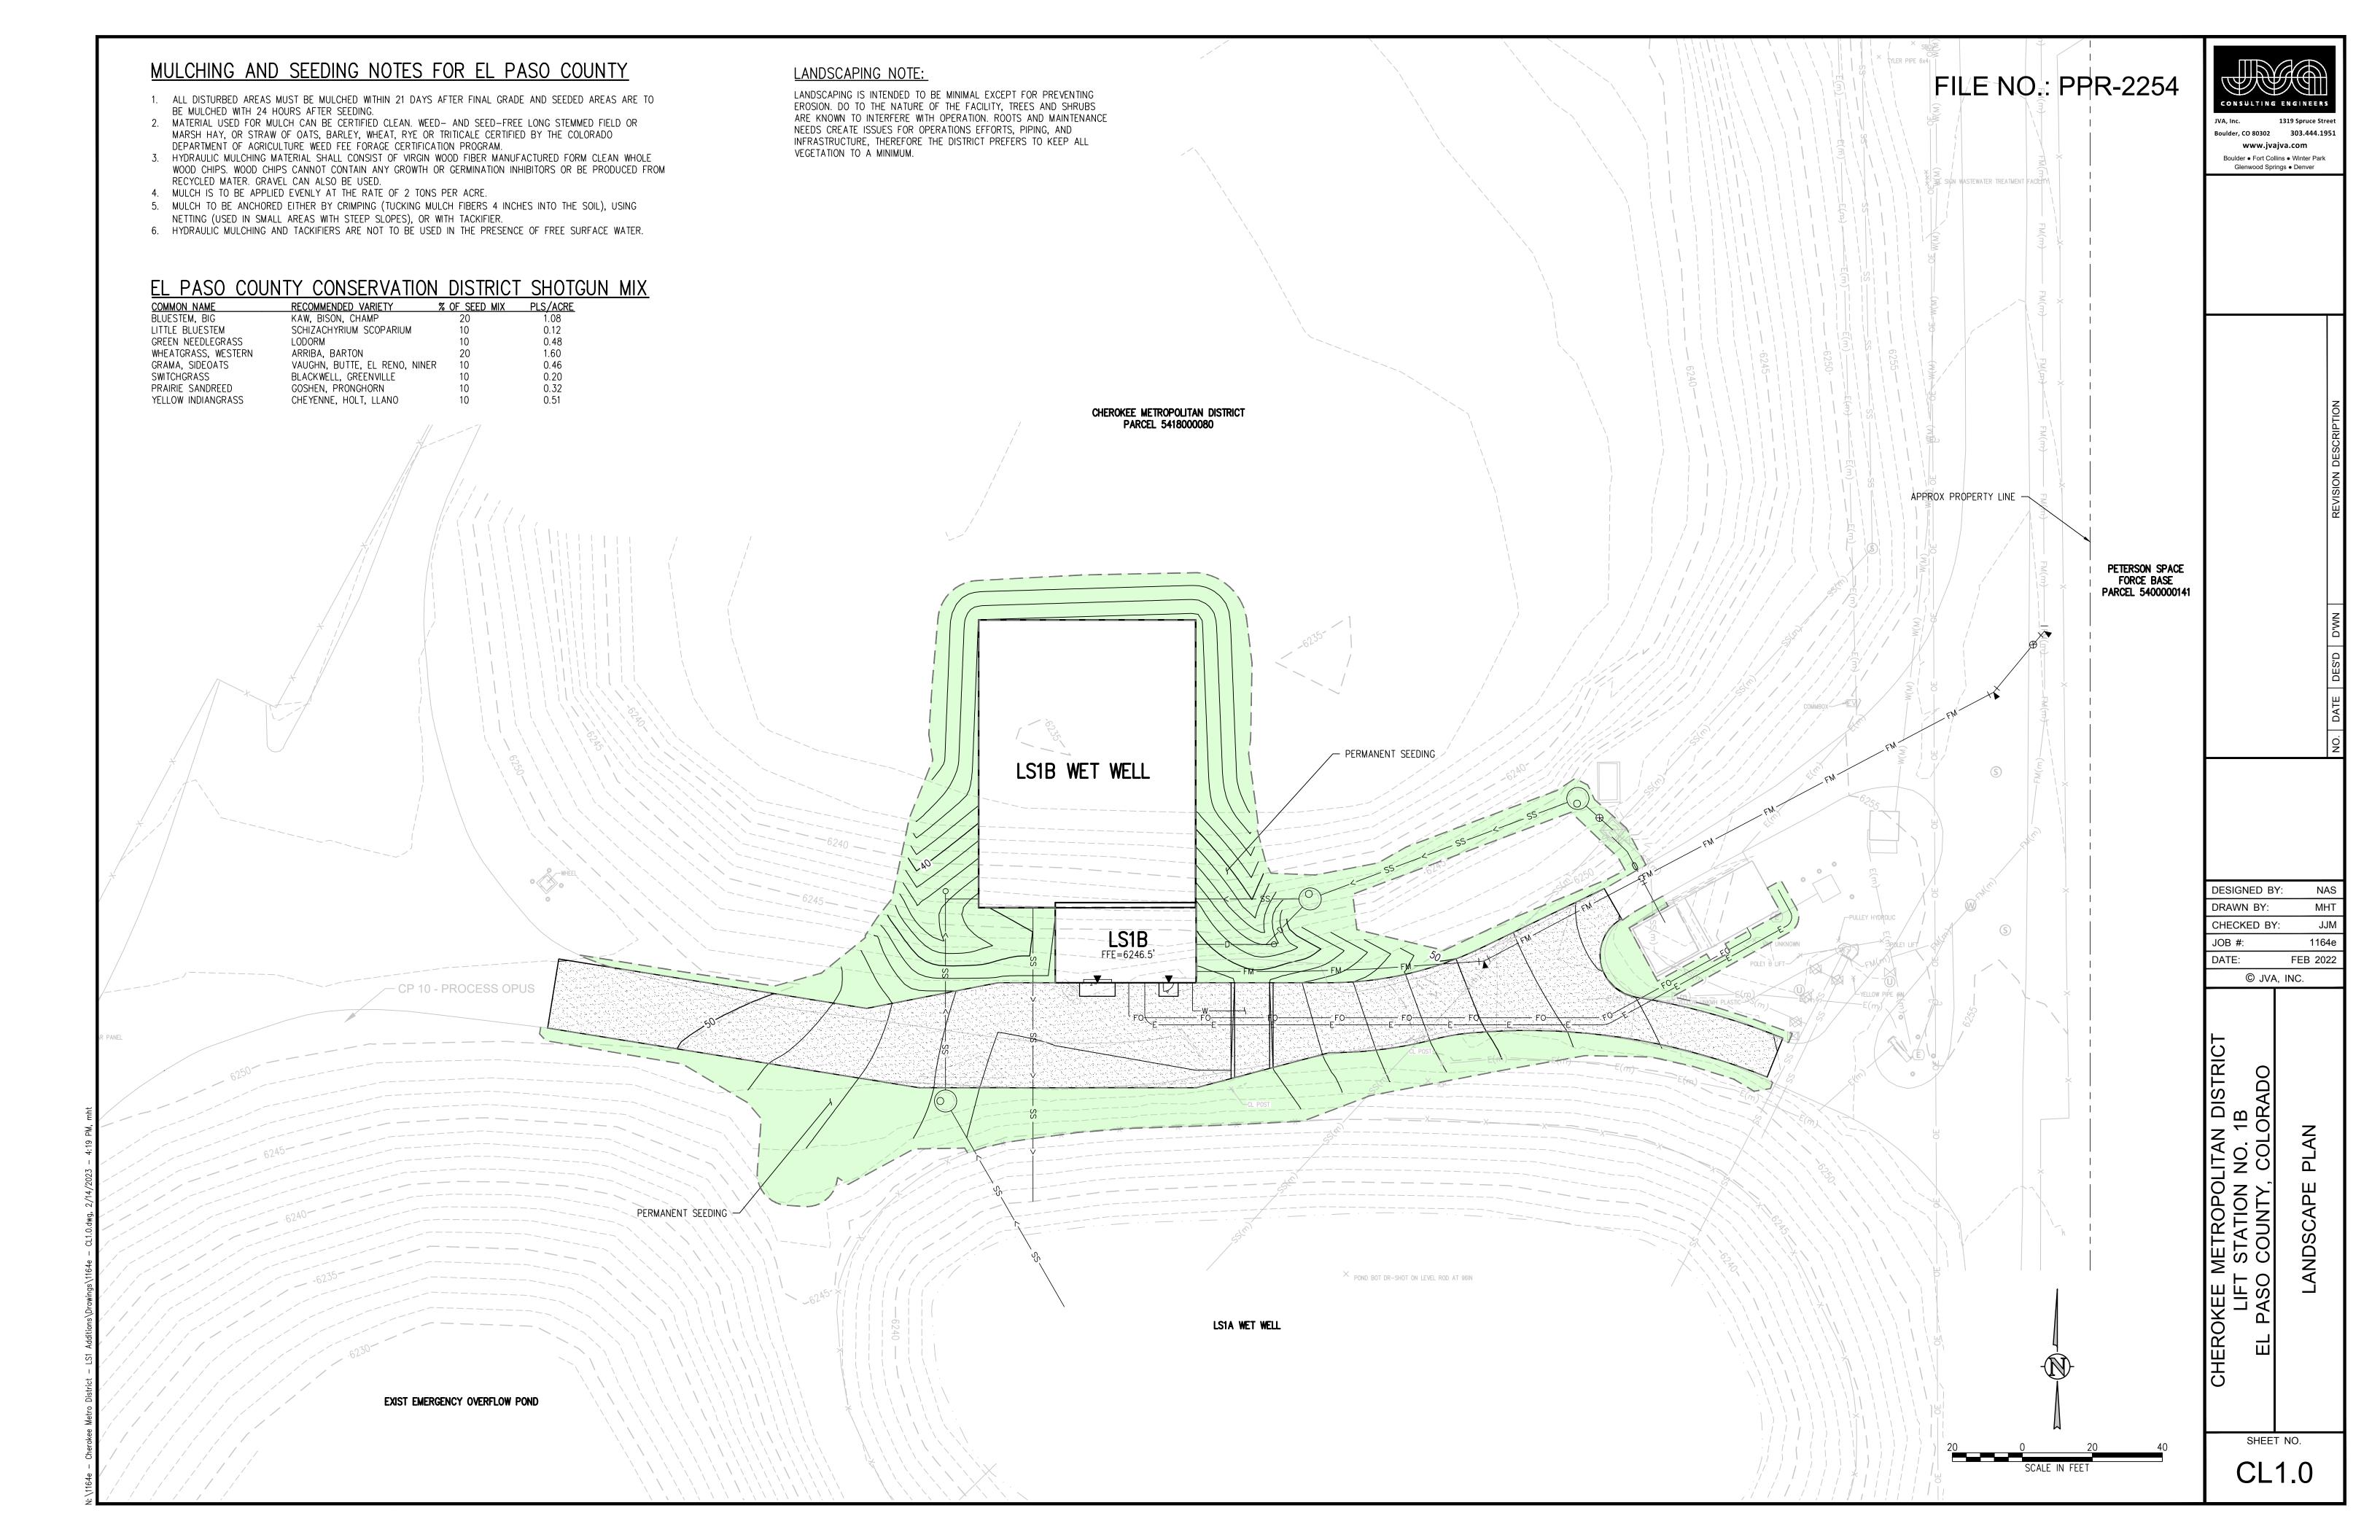

#### **OWNER**

CHEROKEE METROPOLITAN DISTRICT 6250 PALMER BARK BOULEVARD COLORADO SPRINGS, CO 80915

JEFF MUNGER (719) 597-7411 JMUNGER@CHEROKEEMETRO.ORG

#### **APPLICANT**

JVA, INC 1319 SPRUCE STREET BOULDER, CO 80302


NATHAN SKALAK, P.E. (303)565-4930 NSKALAK@JVAJVA.COM

#### **PROPERTY ADDRESS**


6657 E PLATTE AVE COLORADO SPRINGS, CO



	Schedule										
ı	Symbol	Label	QTY	Manufacturer	Number Lamps	Lamp Output	Description	Catalog	Input Power	Polar Plot	Mounting Height
		LT	6	Good Earth Lighting	1	2000	180-Degree 7000- Lumen (2000- Lumen Selectable) Bronze Hardwired LED Outdoor Motion-Activated Flood Light	SE1249-BP2-02LF7-G	79.94	Max: 2923cd	10 FT

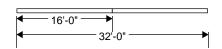

Statistics					
Symbol	Max	Avg	Min		
+	8 fc	0 fc	0 fc		

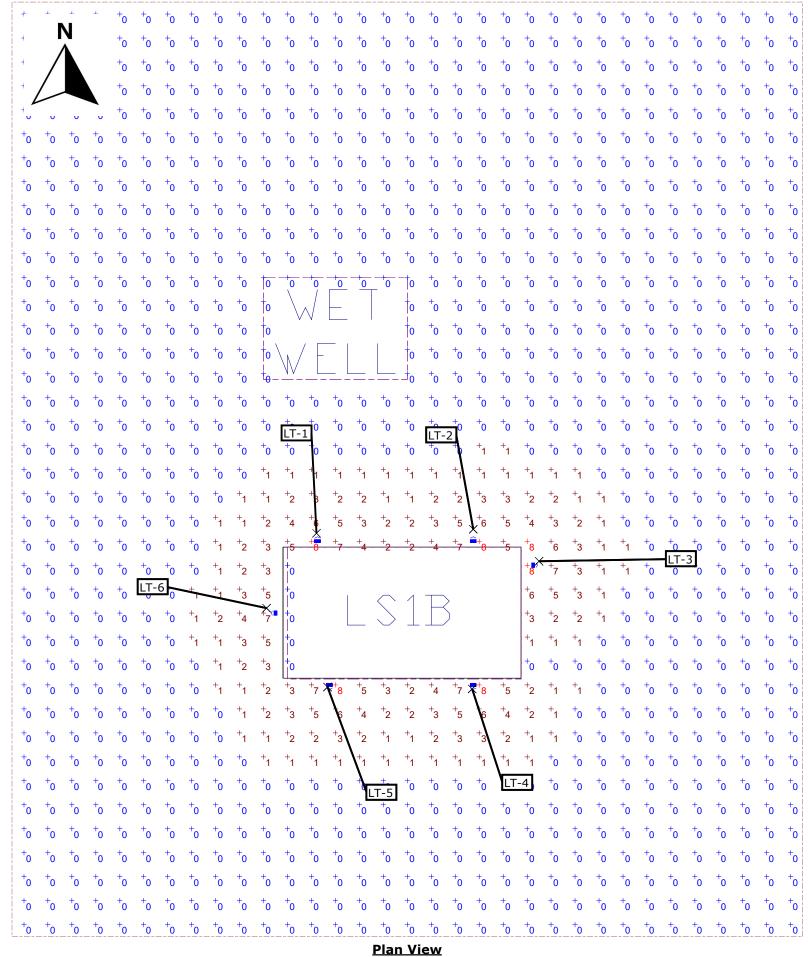

**Designer** Joseph Eaton **Date** 2/22/2023 Scale 1" = 16ft **Drawing No.** 

Summary

Photometric Study 1 of 2

Scale - 1" = 16ft

**OWNER** 

CHEROKEE METROPOLITAN DISTRICT 6250 PALMER BARK BOULEVARD COLORADO SPRINGS, CO 80915


JEFF MUNGER (719) 597-7411 JMUNGER@CHEROKEEMETRO.ORG **APPLICANT** 

JVA, INC 1319 SPRUCE STREET BOULDER, CO 80302

NATHAN SKALAK, P.E. (303)565-4930 NSKALAK@JVAJVA.COM **PROPERTY ADDRESS** 

6657 E PLATTE AVE COLORADO SPRINGS, CO



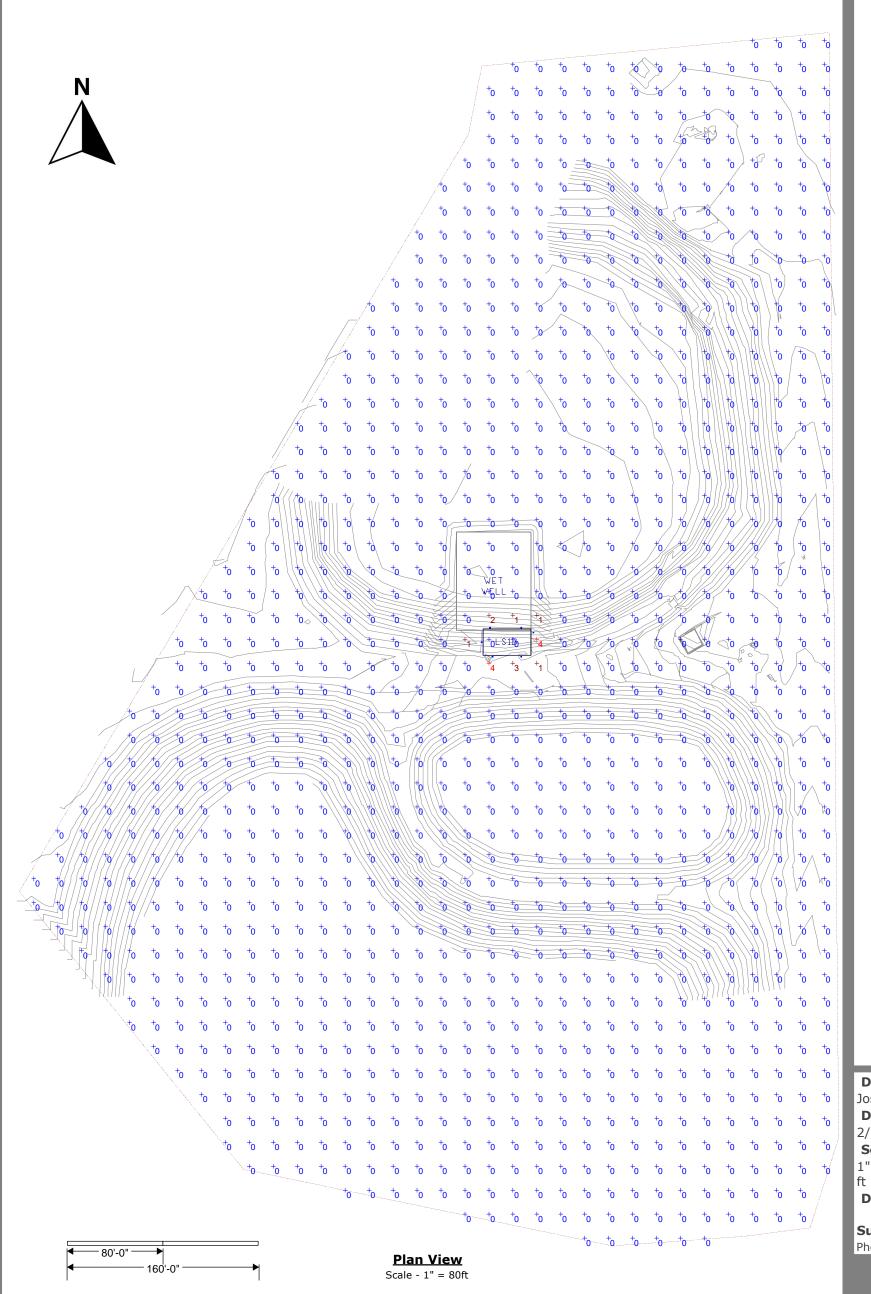


Cherokee Photometric Study Full Site

Designer
Joseph Eaton
Date
2/22/2023
Scale
1" = 80
ft
Drawing No.

**Summary** Photometric Study

2 of 2

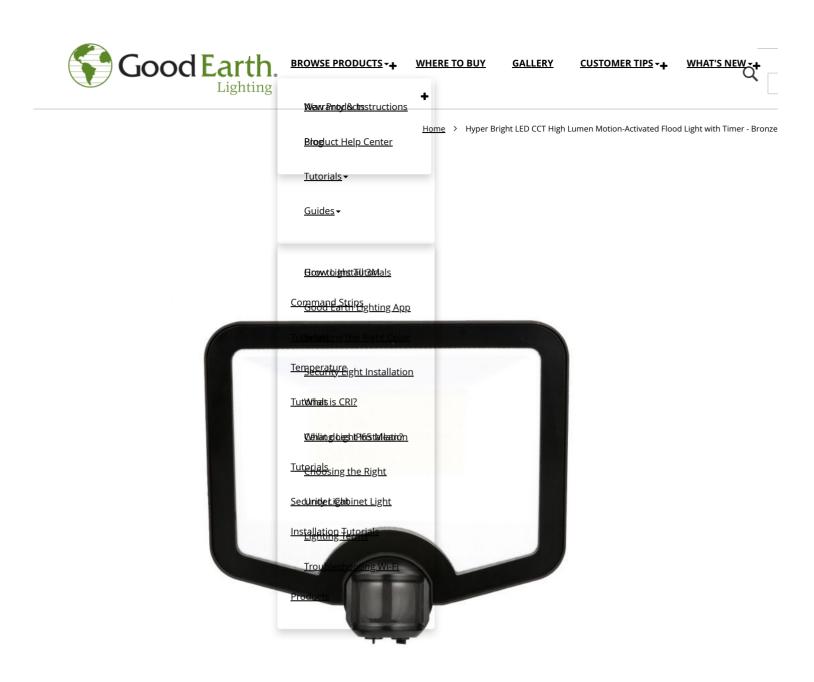

Hyper Bright LED CCT High Lumen Motion-Activated Flood Light with Timer - Bronze

Model SE1249-BP2-02LF7

• Light up your Backyard or Business like a StadiumTM with minimum light coverage of 86 feet outward and 92 feet wide — perfect to light up large areas at night.

- Selectable brightness level 7000 or 2000 lumens.
- Selectable color temperature settings; choose from warm white (3000K), bright white (4000K), or daylight (5000K).

Add to Compare

#### Where to Buy



#### This playlist covers general info about Hyper Bright. This includes:

- 1. Hyper Bright backyard demonstration
- 2. Hyper Bright durability and construction
- 3. <u>Hyper Bright motion sensor explanation and light penetration</u>
- 4. Hyper Bright switch control explanation
- 5. Hyper Bright push control explanation
- 6. Hyper Bright lights a deck

<u>DESCRIPTION</u>

Light up your Backyard or Business like a StadiumTM with a Good Earth Lighting Hyper Bright LED Flood Light. The light is made of sturdy die cast aluminum housing with a shatter-resistant diamond-pattern diffuser lens that provides a smooth and even light distribution. The LED security light features knob joints for easy head positioning and easy wall or eave mount installation. The motion-activated light illuminates as motion is detected and turns off automatically when motion stops during nighttime hours. The built-in timer and distance control settings can be customized to meet a wide variety of lighting customization. Maximize energy savings and discourage intruders from coming near the home or business. This light has a 10-year limited warranty.

- Light up your Backyard or Business like a StadiumTM with minimum light coverage of 86 feet outward and 92 feet wide perfect to light up large areas at night.
- Selectable brightness level 7000 or 2000 lumens.
- Selectable color temperature settings; choose from warm white (3000K), bright white (4000K), or daylight (5000K).
- IP65 rated; water- and dust-proof ideal for outdoors wet locations with sturdy die cast aluminum construction, shatter-resistant lens, and cold weather rated with a minimum cold start temperature of negative 20°F.
- Wall- or eave-mounted for greater flexibility.
- 180-degree adjustable passive infrared (PIR) sensor detects motion up to 100 feet away.
- Time control setting options are test, 1 minute, 5 minute, and 10 minutes to set how long the light will stay on after motion is no longer detected.
- Distance control options are 10, 20, 50, and 100 feet.
- Motion- or switch-controlled settings. Light only operates after dark with Motion Setting. Light operates day or night at switch control setting.

#### <u>SPECIFICATION</u>

**Related Model** SE1249-WH3-02LF7-G

Fixture Material Aluminum

Fixture Color Satin Aged Bronze

Glass/Lens Type Diamond Pattern

Mounting Wall/Eave/Surface/Recessed Mount

**Motion Detection Range** 180 degrees up to 100 ft **Two Level Lighting** No **Two Detection Zone** No **Light Coverage** 86 ft outward, 92 ft side to side **Safety Rated** Wet Location **Safety Listing** ETL **Energy Star** No **Light Included** No **Light Source** LED **LED Qty** 196 **Color Temperature** 3000K/4000K/5000K Selectable **Color-Changing Temperature** Yes Color Rendering Index (CRI) 80 **Rated LED Life** 50,000 hours 7000/2000 Lumens Dimmable Yes **Dimming Type** On Fixture - High/Low/Off Input Voltage 120V, 60Hz Input Wattage 80 **Battery Included** No **Power Cord** None - Direct Wire Linkable No **Power Switch** Wall Switch **Power Source** Direct Wire Warranty 10-Year Limited Warranty **Fixture Dimensions (inches)** 12.17 x 10.86 x 8.07 Fixture Weight (lbs) 3.3

PEVIEWS

QUESTIONS & ANSWERS (12).

DOWNLOADS

+

#### **Related Products**



<u>Hyper Bright LED CCT High Lumen Motion-Activated Flood Light with Timer - White</u>

#### Customers also viewed



Indoor/Outdoor 24-ft Smart Wi-Fi LED RGBW Plug-In Strip Light -White



240-Degree 3-Head LED Motion-Activated Dusk to Dawn Security Flood Light - White




48-in White LED 5CCT Flat Panel Ceiling Light with Brushed Nickel Aluminum Frame




Indoor/Outdoor 24-ft LED R
Plug-In Strip Light with Rem
White






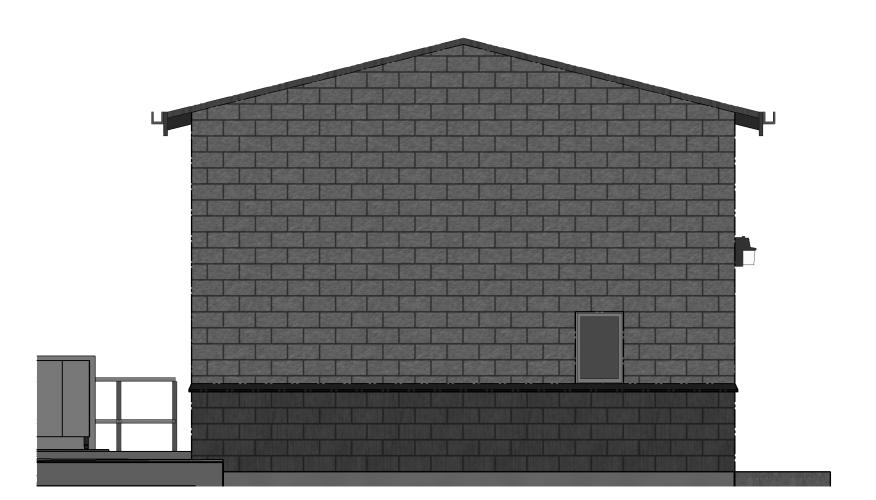



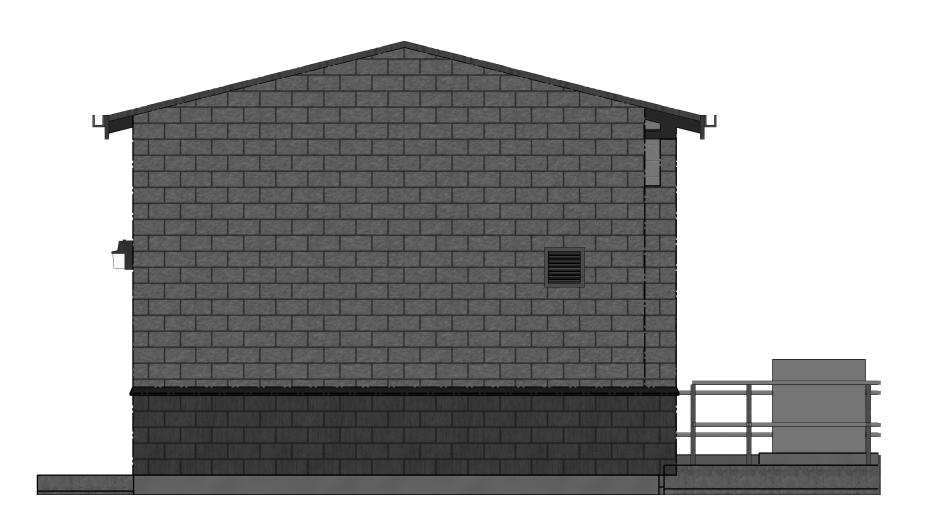

4 EAST ELEVATION A1.1 1/4" = 1'-0"

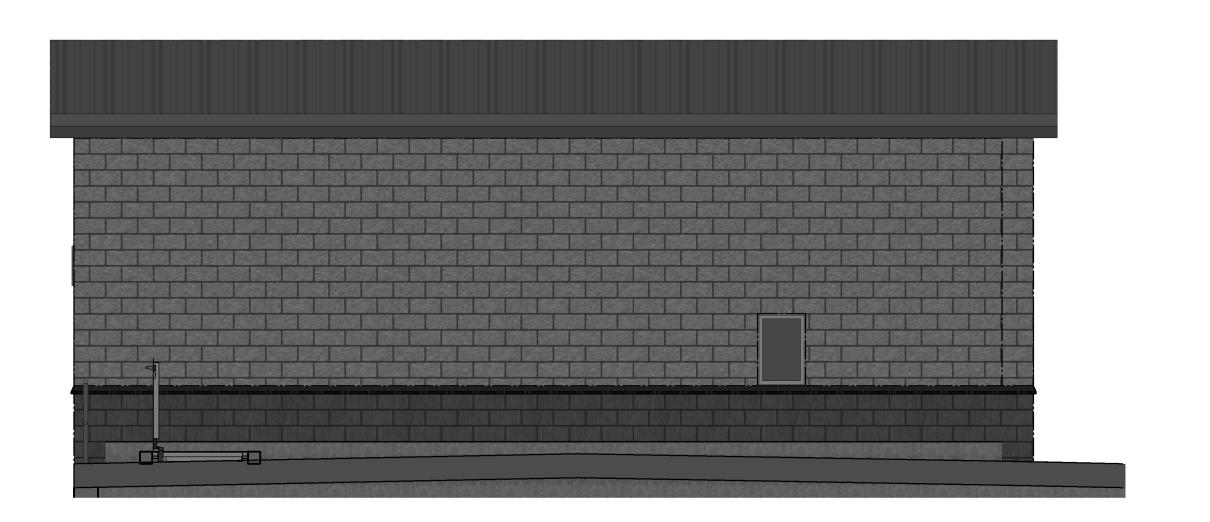

3 NORTH ELEVATION
A1.1 1/4" = 1'-0"

CONSULTING ENGINEERS
JVA, Inc. 213 Linden Street, Suite 200
Fort Collins, CO 80524 970.225.9099
www.jvajva.com
Boulder ● Fort Collins ● Winter Park Glenwood Springs ● Denver

DESCRIPTION	
DATE	
NO.	
SIGNED BY:	KLB
RAWN BY:	KLB
IECKED BY:	AJT
)B #:	1164e
тг.	SEPT 2022
	_

© JVA, INC.

SHEET NO.

A1.1

