AGENCY CONTACTS

<u>COUNTY</u>	EL PASO COUNTY PLANNING & COMMUNITY DEVELOPMEN KARI PARSONS, PROJECT MANAGER/PLANNER II 2880 INTERNATIONAL CIRCLE, SUITE 110 COLORADO SPRINGS, CO 80910 (719) 520-6300
<u>FIRE</u>	FALCON FIRE DEPARTMENT TRENT HARWIG, FIRE CHIEF 7030 OLD MERIDIAN ROAD FALCON, CO 80831 (719)495–4050
<u>WATER</u>	WOODMEN HILLS METROPOLITAN DISTRICT JERRY JACOBSEN, DIRECTOR OF WATER & WASTEWATER 8046 EASTONVILLE ROAD FALCON, CO 80831 (719) 495–2500
<u>WASTEWATER</u>	WOODMEN HILLS METROPOLITAN DISTRICT GENE COZZOLINO, DIRECTOR OF WATER & WASTEWATER 8046 EASTONVILLE ROAD FALCON, CO 8083 (719) 495–2500
<u>ELECTRIC</u>	MOUNTAIN VIEW ELECTRIC ASSOCIATION LES ULFERS 11140 E. WOODMEN ROAD FALCON, CO 80831 (719) 495–2283
<u>GAS</u>	COLORADO SPRINGS UTILITIES TODD STURTEVANT 1521 HANCOCK EXPRESSWAY COLORADO SPRINGS, CO 80947 (719) 668–3556
<u>TELEPHONE</u>	CENTURY LINK SALLY KLEIN (719) 636–4329 (LOCATORS) (719) 597–8418 AT&T (LOCATORS) (719) 635–3674
<u>CABLE</u>	COMCAST DALE STEWART 213 N. UNION BLVD COLORADO SPRINGS, CO 80909 (719) 442–4733
PETROLEUM	NUSTAR CHAD RENSLOW 7810 DRENNAN ROAD COLORADO SPRINGS, CO 80925 (719) 391–0942
<u>OTHER</u>	WOODMEN ROAD METROPOLITAN DISTRICT TERRY SCHOOLER 20 BOULDER CRESCENT, SUITE #200 COLORADO SPRINGS, CO 80903 (719) 447–1777

CONSTRUCTION DOCUMENTS FALCON MARKETPLACE SE 1/4 OF THE SE 1/4 OF SECTION 1, T13S, R65W OF THE 6TH P.M. 11680 E. WOODMEN ROAD

FALCON, COLORADO



VICINITY MAP NOT TO SCALE



BENCHMARK

ELEVATIONS ARE BASED ON COLORADO SPRINGS UTILITIES FACILITIES INFORMATION SYSTEM (FIMS) "BLT 167", A 2" ALUMINUM CAP IN CONCRETE LOCATED ON AN ELECTRIC TRANSFORMER PAD AT THE SOUTHEAST CORNER OF WOODMEN ROAD AND MERIDIAN ROAD, WITH AN ELEVATION OF 6873.18 (NGVD 29).

LEGAL DESCRIPTION

THE SOUTHEAST QUARTER OF THE SOUTHEAST QUARTER OF SECTION 1, TOWNSHIP 13 SOUTH RANGE 65 WEST OF THE SIXTH PRINCIPAL MERIDIAN, TOGETHER WITH THAT PORTION OF BLOCK 1, TOWN OF FALCON, LYING WITHIN THE SOUTHEAST QUARTER OF THE SOUTHEAST QUARTER OF SECTION 1, TOWNSHIP 13 SOUTH, RANGE 65 WEST OF THE SIXTH PRINCIPAL MERIDIAN, COUNTY OF EL PASO, STATE OF COLORADO.

EXCEPT THOSE PORTIONS CONVEYED TO WOODMEN ROAD METROPOLITAN DISTRICT BY WARRANTY DEED RECORDED APRIL 19, 2004 AT RECEPTION NO. 204062427 AND PERSONAL REPRESENTATIVE'S DEED RECORDED SEPTEMBER 7, 2007 AT RECEPTION NO. 207116129, EL PASO COUNTY, COLORADO RECORDS.

FLOODPLAIN STATEMENT

THE EFFECTIVE FLOODPLAIN ZONE A LIMITS ARE DEFINED ON THE FIRM FOR EL PASO COUNTY. COLORADO AND UNINCORPORATED AREAS, MAP NUMBER 08041C0553G, EFFECTIVE DATE DECEMBER 7, 2018.

A CLOMR TO MODIFY THE FLOODPLAIN HAS BEEN SUBMITTED AND APPROVED BY FEMA, CASE NO. 17-08-0074R (MAY 26, 2017).

TIMING

ANTICIPATED STARTING AND COMPLETION TIME PERIOD OF SITE GRADING: SUMMER 2019-SUMMER 2020

AREAS TOTAL AREA OF THE SITE TO BE CLEARED, EXCAVATED OR GRADED: APPROXIMATELY 36.4 ACRES **RECEIVING WATERS**

FALCON WATERSHED - UNNAMED TRIBUTARY TO UPPER BLACK SQUIRREL CREEK

<u>SOILS</u>

HYDROLOGIC TYPE A: BLAKELAND LOAMY SAND (NO. 8) AND BLAKELAND-FLUVAQUENTIC HAPLAQUOLIS (NO. 9)

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C1.11	NOTES
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C3.10	FALCON
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C4.10	SOUTHW
C4.11	SOUTHW
C4.12	SOUTHW
C4.13	NORTHE
C4.14	SW ROU
C4.15	NE ROU

NOTE

C2.12

DEVELOPMENT DIRECTOR'S DISCRETION.

THESE DETAILED PI
SAID PLANS AND S
COUNTY FOR THE I
SPECIFICATIONS, AN
DRAINAGE PLANS A
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CORRECT TO THE E
CAUSED BY ANY N
DETAILED PLANS A

TIM D. MCCONNELL P.E.# 33797

OWNER'S STATEMENT


AND SPECIFICATIONS.

BEN HUMMEL

EL PASO COUNTY

ACCURACY OF THIS DOCUMENT.

JENNIFER IRVINE, P.E. COUNTY ENGINEER

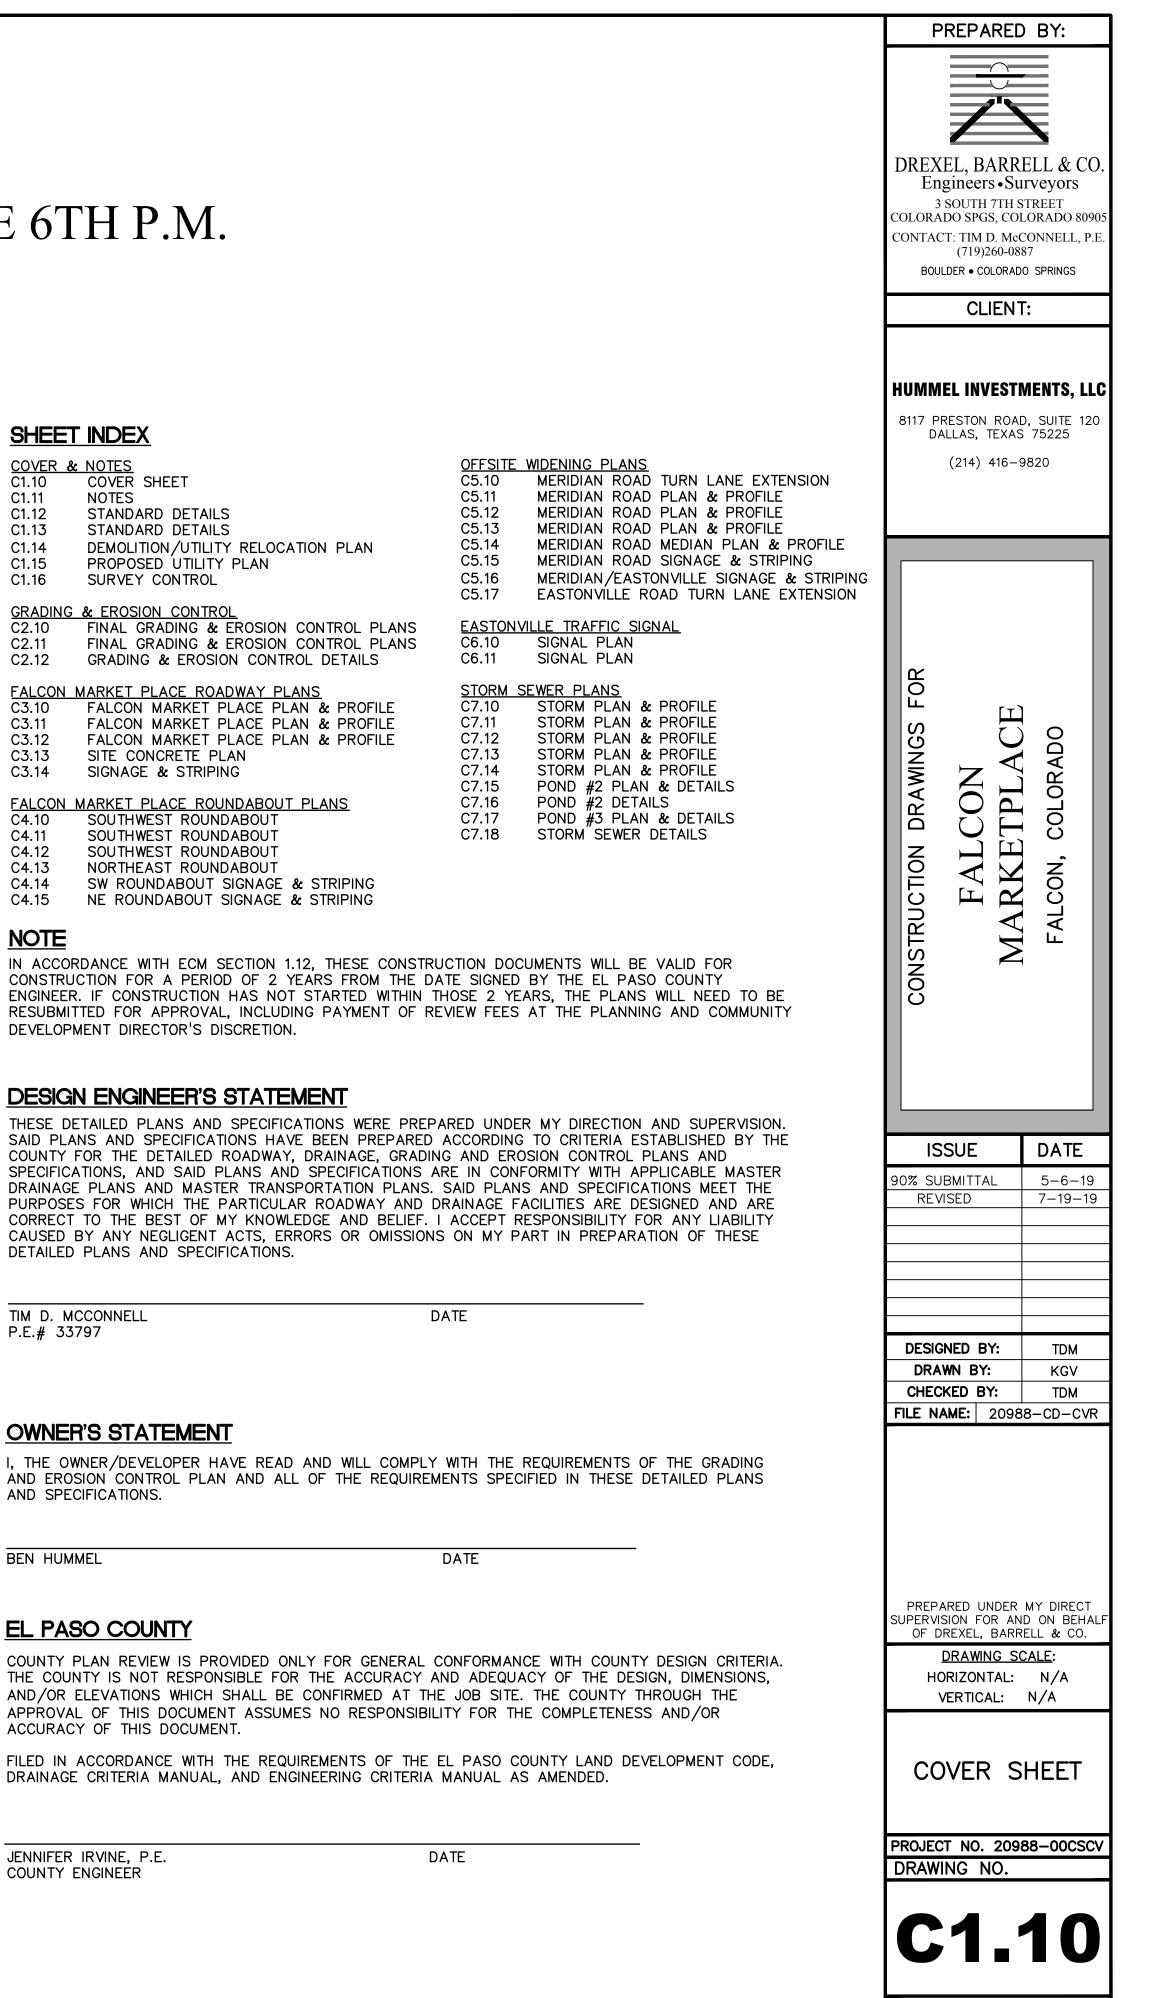


EL PASO COUNTY FILE # SF-19-001

SHEET: 1 OF 39

STANDARD NOTES FOR EL PASO COUNTY GRADING AND EROSION CONTROL PLANS 1. CONSTRUCTION MAY NOT COMMENCE UNTIL A CONSTRUCTION PERMIT IS OBTAINED FROM PLANNING AND COMMUNITY DEVELOPMENT AND A PRECONSTRUCTION CONFERENCE IS HELD WITH PLANNING AND COMMUNITY DEVELOPMENT INSPECTIONS. 2.STORMWATER DISCHARGES FROM CONSTRUCTION SITES SHALL NOT CAUSE OR THREATEN TO CAUSE POLLUTION, CONTAMINATION, OR DEGRADATION OF STATE WATERS. ALL WORK AND EARTH DISTURBANCE SHALL BE DONE IN A MANNER THAT MINIMIZES POLLUTION OF ANY ON-SITE OR OFF SITE WATERS, INCLUDING WETLANDS. 3.NOTWITHSTANDING ANYTHING DEPICTED IN THESE PLANS IN WORDS OR GRAPHIC REPRESENTATION, ALL DESIGN AND CONSTRUCTION RELATED TO ROADS, STORM DRAINAGE AND EROSION CONTROL SHALL CONFORM TO THE STANDARDS AND REQUIREMENTS OF THE MOST RECENT VERSION OF THE RELEVANT ADOPTED EL PASO COUNTY STANDARDS, INCLUDING THE LAND DEVELOPMENT CODE, THE ENGINEERING CRITERIA MANUAL, THE DRAINAGE CRITERIA MANUAL, AND THE DRAINAGE CRITERIA MANUAL VOLUME 2. ANY DEVIATIONS TO REGULATIONS AND STANDARDS MUST BE REQUESTED, AND APPROVED, IN WRITING. 4.A SEPARATE STORMWATER MANAGEMENT PLAN (SWMP) FOR THIS PROJECT SHALL BE COMPLETED AND AN EROSION AND STORMWATER QUALITY CONTROL PERMIT (ESQCP) ISSUED PRIOR TO COMMENCING CONSTRUCTION. DURING CONSTRUCTION THE SWMP IS THE RESPONSIBILITY OF THE DESIGNATED STORMWATER MANAGER, SHALL BE LOCATED ON SITE AT ALL TIMES AND SHALL BE KEPT UP TO DATE WITH WORK PROGRESS AND CHANGES IN THE FIELD. 5. ONCE THE ESQCP HAS BEEN ISSUED, THE CONTRACTOR MAY INSTALL THE INITIAL STAGE EROSION AND SEDIMENT CONTROL BMPS AS INDICATED ON THE GEC. A PRECONSTRUCTION MEETING BETWEEN THE CONTRACTOR, ENGINEER, AND EL PASO COUNTY WILL BE HELD PRIOR TO ANY CONSTRUCTION. IT IS THE RESPONSIBILITY OF THE APPLICANT TO COORDINATE THE MEETING TIME AND PLACE WITH COUNTY PCD INSPECTIONS STAFF. 6.SOIL EROSION CONTROL MEASURES FOR ALL SLOPES, CHANNELS, DITCHES, OR ANY DISTURBED LAND AREA SHALL BE COMPLETED WITHIN 21 CALENDAR DAYS AFTER FINAL GRADING, OR FINAL EARTH DISTURBANCE, HAS BEEN COMPLETED. DISTURBED AREAS AND STOCKPILES WHICH ARE NOT AT FINAL GRADE BUT WILL REMAIN DORMANT FOR LONGER THAN 30 DAYS SHALL ALSO BE MULCHED WITHIN 21 DAYS AFTER INTERIM GRADING. AN AREA THAT IS GOING TO REMAIN IN AN INTERIM STATE FOR MORE THAN 60 DAYS SHALL ALSO BE SEEDED. ALL TEMPORARY SOIL EROSION CONTROL MEASURES AND BMPS SHALL BE MAINTAINED UNTIL PERMANENT SOIL EROSION CONTROL MEASURES ARE IMPLEMENTED AND ESTABLISHED. 7. TEMPORARY SOIL EROSION CONTROL FACILITIES SHALL BE REMOVED AND EARTH DISTURBANCE AREAS GRADED AND STABILIZED WITH PERMANENT SOIL EROSION CONTROL MEASURES PURSUANT TO STANDARDS AND SPECIFICATION PRESCRIBED IN THE DCM VOLUME II AND THE ENGINEERING CRITERIA MANUAL (ECM) APPENDIX I. 8. ALL PERSONS ENGAGED IN EARTH DISTURBANCE SHALL IMPLEMENT AND MAINTAIN ACCEPTABLE SOIL EROSION AND SEDIMENT CONTROL MEASURES INCLUDING BMPS IN CONFORMANCE WITH THE EROSION CONTROL TECHNICAL STANDARDS OF THE DRAINAGE CRITERIA MANUAL (DCM) VOLUME II AND IN ACCORDANCE WITH THE STORMWATER MANAGEMENT PLAN (SWMP). 9.ALL TEMPORARY EROSION CONTROL FACILITIES INCLUDING BMPS AND ALL PERMANENT FACILITIES INTENDED TO CONTROL EROSION OF ANY EARTH DISTURBANCE OPERATIONS, SHALL BE INSTALLED AS DEFINED IN THE APPROVED PLANS, THE SWMP AND THE DCM VOLUME II AND MAINTAINED THROUGHOUT THE DURATION OF THE EARTH DISTURBANCE OPERATION. 10. ANY EARTH DISTURBANCE SHALL BE CONDUCTED IN SUCH A MANNER SO AS TO EFFECTIVELY REDUCE ACCELERATED SOIL EROSION AND RESULTING SEDIMENTATION. ALL DISTURBANCES SHALL BE DESIGNED, CONSTRUCTED, AND COMPLETED SO THAT THE EXPOSED AREA OF ANY DISTURBED LAND SHALL BE LIMITED TO THE SHORTEST PRACTICAL PERIOD OF TIME. 11. ANY TEMPORARY OR PERMANENT FACILITY DESIGNED AND CONSTRUCTED FOR THE CONVEYANCE OF STORMWATER AROUND, THROUGH, OR FROM THE EARTH DISTURBANCE AREA SHALL BE DESIGNED TO LIMIT THE DISCHARGE TO A NON-EROSIVE VELOCITY 12. CONCRETE WASH WATER SHALL BE CONTAINED AND DISPOSED OF IN ACCORDANCE WITH THE SWMP. NO WASH WATER SHALL BE DISCHARGED TO OR ALLOWED TO RUNOFF TO STATE WATERS, INCLUDING ANY SURFACE OR SUBSURFACE STORM DRAINAGE SYSTEM OR FACILITIES. 13. EROSION CONTROL BLANKETING IS TO BE USED ON SLOPES STEEPER THAN 3:1. 14. BUILDING, CONSTRUCTION, EXCAVATION, OR OTHER WASTE MATERIALS SHALL NOT BE TEMPORARILY PLACED OR STORED IN THE STREET, ALLEY, OR OTHER PUBLIC WAY, UNLESS IN ACCORDANCE WITH AN APPROVED TRAFFIC CONTROL PLAN. BMP'S MAY BE REQUIRED BY EL PASO COUNTY ENGINEERING IF DEEMED NECESSARY, BASED ON SPECIFIC CONDITIONS AND CIRCUMSTANCES VEHICLE TRACKING OF SOILS AND CONSTRUCTION DEBRIS OFF-SITE SHALL BE MINIMIZED. MATERIALS TRACKED OFFSITE SHALL BE CLEANED UP AND PROPERLY DISPOSED OF IMMEDIATELY. 16. CONTRACTOR SHALL BE RESPONSIBLE FOR THE REMOVAL OF ALL WASTES FROM THE CONSTRUCTION SITE FOR DISPOSAL IN ACCORDANCE WITH LOCAL AND STATE REGULATORY REQUIREMENTS. NO CONSTRUCTION DEBRIS, TREE SLASH, BUILDING MATERIAL WASTES OR UNUSED BUILDING MATERIALS SHALL BE BURIED, DUMPED, OR DISCHARGED AT THE SITE. 17. THE OWNER, SITE DEVELOPER, CONTRACTOR, AND/OR THEIR AUTHORIZED AGENTS SHALL BE RESPONSIBLE FOR THE REMOVAL OF ALL CONSTRUCTION DEBRIS, DIRT, TRASH, ROCK, SEDIMENT, AND SAND THAT MAY ACCUMULATE IN THE STORM SEWER OR OTHER DRAINAGE CONVEYANCE SYSTEM AND STORMWATER APPURTENANCES AS A RESULT OF SITE DEVELOPMENT. 18. THE QUANTITY OF MATERIALS STORED ON THE PROJECT SITE SHALL BE LIMITED, AS MUCH AS PRACTICAL, TO THAT QUANTITY REQUIRED TO PERFORM THE WORK IN AN ORDERLY SEQUENCE. ALL MATERIALS STORED ON-SITE SHALL BE STORED IN A NEAT, ORDERLY MANNER, IN THEIR ORIGINAL CONTAINERS, WITH ORIGINAL MANUFACTURER'S LABELS. 19. NO CHEMICALS ARE TO BE USED BY THE CONTRACTOR, WHICH HAVE THE POTENTIAL TO BE RELEASED IN STORMWATER UNLESS PERMISSION FOR THE USE OF A SPECIFIC CHEMICAL IS GRANTED IN WRITING BY THE ECM ADMINISTRATOR. IN GRANTING THE USE OF SUCH CHEMICALS, SPECIAL CONDITIONS AND MONITORING MAY BE REQUIRED. 20. BULK STORAGE STRUCTURES FOR PETROLEUM PRODUCTS AND OTHER CHEMICALS SHALL HAVE ADEQUATE PROTECTION SO AS TO CONTAIN ALL SPILLS AND PREVENT ANY SPILLED MATERIAL FROM ENTERING STATE WATERS, INCLUDING ANY SURFACE OR SUBSURFACE STORM DRAINAGE SYSTEM OR FACILITIES. 21. NO PERSON SHALL CAUSE THE IMPEDIMENT OF STORMWATER FLOW IN THE FLOW LINE OF THE CURB AND GUTTER OR IN THE DITCHLINE. 22. INDIVIDUALS SHALL COMPLY WITH THE "COLORADO WATER QUALITY CONTROL ACT" (TITLE 25, ARTICLE 8, CRS), AND THE "CLEAN WATER ACT" (33 USC 1344), IN ADDITION TO THE REQUIREMENTS INCLUDED IN THE DCM VOLUME II AND THE ECM APPENDIX I. ALL APPROPRIATE PERMITS MUST BE OBTAINED BY THE CONTRACTOR PRIOR TO CONSTRUCTION (NPDES, FLOODPLAIN, 404, FUGITIVE DUST, ETC.). IN THE EVENT OF CONFLICTS BETWEEN THESE REQUIREMENTS AND LAWS, RULES, OR REGULATIONS OF OTHER FEDERAL, STATE, OR COUNTY AGENCIES, THE MORE RESTRICTIVE LAWS, RULES, OR REGULATIONS SHALL APPLY. 23. ALL CONSTRUCTION TRAFFIC MUST ENTER/EXIT THE SITE AT APPROVED CONSTRUCTION ACCESS POINTS. 24. PRIOR TO ACTUAL CONSTRUCTION THE PERMITEE SHALL VERIFY THE LOCATION OF EXISTING UTILITIES. 25. A WATER SOURCE SHALL BE AVAILABLE ON SITE DURING EARTHWORK OPERATIONS AND UTILIZED AS REQUIRED TO MINIMIZE DUST FROM EARTHWORK EQUIPMENT AND WIND. 26. THIS PROPERTY IS SUBJECT TO THE FINDINGS, SUMMARY, AND CONCLUSIONS OF THE PRELIMINARY GEOTECHNICAL INVESTIGATION BY GROUND ENGINEERING, DATED AUGUST 25, 2015, WITH ADDENDA #1, DATED MARCH 17, 2017. 27. AT LEAST TEN DAYS PRIOR TO THE ANTICIPATED START OF CONSTRUCTION, FOR PROJECTS THAT WILL DISTURB 1 ACRE OR MORE, THE OWNER OR OPERATOR OF CONSTRUCTION ACTIVITY SHALL SUBMIT A PERMIT APPLICATION FOR STORMWATER DISCHARGE TO THE COLORADO DEPARTMENT OF PUBLIC HEALTH AND ENVIRONMENT, WATER QUALITY DIVISION. THE APPLICATION CONTAINS CERTIFICATION OF COMPLETION OF A STORMWATER MANAGEMENT PLAN (SWMP), OF WHICH THIS GRADING AND EROSION CONTROL PLAN MAY BE A PART. FOR INFORMATION OR APPLICATION MATERIALS CONTACT: COLORADO DEPARTMENT OF PUBLIC HEALTH AND ENVIRONMENT WATER QUALITY CONTROL DIVISION WOCD - PERMITS 4300 CHERRY CREEK DRIVE SOUTH DENVER, CO 80246-1530 ATTN: PERMITS UNIT Update notes

STANDARD NOTES FOR EL PASO COUNTY CONSTRUCTION PLANS

- 1. ALL DRAINAGE AND ROADWAY CONSTRUCTION SHALL MEET THE STANDARDS AND SPECIFICATIONS OF THE CITY OF COLORADO SPRINGS/EL PASO COUNTY DRAINAGE CRITERIA MANUAL, VOLUMES 1 AND 2, AND THE EL PASO COUNTY ENGINEERING CRITERIA MANUAL
- 2.CONTRACTOR SHALL BE RESPONSIBLE FOR THE NOTIFICATION AND FIELD NOTIFICATION OF ALL EXISTING UTILITIES, WHETHER SHOWN ON THE PLANS OR NOT, BEFORE BEGINNING CONSTRUCTION. LOCATION OF EXISTING UTILITIES SHALL BE VERIFIED BY THE CONTRACTOR PRIOR TO CONSTRUCTION. CALL 811 TO CONTACT THE UTILITY NOTIFICATION CENTER OF COLORADO (UNCC).
- 3. CONTRACTOR SHALL KEEP A COPY OF THESE APPROVED PLANS, THE GRADING AND EROSION CONTROL PLAN, THE STORMWATER MANAGEMENT PLAN (SWMP), THE SOILS AND GEOTECHNICAL REPORT, AND THE APPROPRIATE DESIGN AND CONSTRUCTION STANDARDS AND SPECIFICATIONS AT THE JOB SITE AT ALL TIMES, INCLUDING THE FOLLOWING: a.EL PASO COUNTY ENGINEERING CRITERIA MANUAL (ECM) b.CITY OF COLORADO SPRINGS/EL PASO COUNTY DRAINAGE CRITERIA MANUAL, VOLUMES 1 AND 2 C.COLORADO DEPARTMENT OF TRANSPORTATION (CDOT) STANDARD SPECIFICATIONS FOR ROAD AND BRIDGE CONSTRUCTION d.CDOT M & S STANDARDS
- 4. NOTWITHSTANDING ANYTHING DEPICTED IN THESE PLANS IN WORDS OR GRAPHIC REPRESENTATION, ALL DESIGN AND CONSTRUCTION RELATED TO ROADS, STORM DRAINAGE AND EROSION CONTROL SHALL CONFORM TO THE STANDARDS AND REQUIREMENTS OF THE MOST RECENT VERSION OF THE RELEVANT ADOPTED EL PASO COUNTY STANDARDS, INCLUDING THE LAND DEVELOPMENT CODE, THE ENGINEERING CRITERIA MANUAL, THE DRAINAGE CRITERIA MANUAL, AND THE DRAINAGE CRITERIA MANUAL VOLUME 2. ANY DEVIATIONS FROM REGULATIONS AND STANDARDS MUST BE REQUESTED, AND APPROVED, IN WRITING. ANY MODIFICATIONS NECESSARY TO MEET CRITERIA AFTER-THE-FACT WILL BE ENTIRELY THE DEVELOPER'S RESPONSIBILITY TO RECTIFY.
- 5.IT IS THE DESIGN ENGINEER'S RESPONSIBILITY TO ACCURATELY SHOW EXISTING CONDITIONS, BOTH ONSITE AND OFFSITE, ON THE CONSTRUCTION PLANS. ANY MODIFICATIONS NECESSARY DUE TO CONFLICTS, OMISSIONS, OR CHANGED CONDITIONS WILL BE ENTIRELY THE DEVELOPER'S RESPONSIBILITY TO RECTIFY.
- 6.CONTRACTOR SHALL SCHEDULE A PRE-CONSTRUCTION MEETING WITH EL PASO COUNTY PLANNING AND COMMUNITY DEVELOPMENT (PCD) - INSPECTIONS, PRIOR TO STARTING CONSTRUCTION.
- 7.IT IS THE CONTRACTOR'S RESPONSIBILITY TO UNDERSTAND THE REQUIREMENTS OF ALL JURISDICTIONAL AGENCIES AND TO OBTAIN ALL REQUIRED PERMITS, INCLUDING BUT NOT LIMITED TO EL PASO COUNTY EROSION AND STORMWATER QUALITY CONTROL PERMIT (ESQCP), REGIONAL BUILDING FLOODPLAIN DEVELOPMENT PERMIT, U.S. ARMY CORPS OF ENGINEERS-ISSUED 401 AND/OR 404 PERMITS, AND COUNTY AND STATE FUGITIVE DUST PERMITS.
- 8. CONTRACTOR SHALL NOT DEVIATE FROM THE PLANS WITHOUT FIRST OBTAINING WRITTEN APPROVAL FROM THE DESIGN ENGINEER AND PCD. CONTRACTOR SHALL NOTIFY THE DESIGN ENGINEER IMMEDIATELY UPON DISCOVERY OF ANY ERRORS OR INCONSISTENCIES.
- 9. ALL STORM DRAIN PIPE SHALL BE CLASS III RCP UNLESS OTHERWISE NOTED AND APPROVED BY PCD. 10. CONTRACTOR SHALL COORDINATE GEOTECHNICAL TESTING PER ECM STANDARDS. PAVEMENT DESIGN SHALL BE APPROVED
- BY EL PASO COUNTY PCD PRIOR TO PLACEMENT OF CURB AND GUTTER AND PAVEMENT. 11. ALL CONSTRUCTION TRAFFIC MUST ENTER/EXIT THE SITE AT APPROVED CONSTRUCTION ACCESS POINTS.
- 12. SIGHT VISIBILITY TRIANGLES AS IDENTIFIED IN THE PLANS SHALL BE PROVIDED AT ALL INTERSECTIONS. OBSTRUCTIONS GREATER THAN 18 INCHES ABOVE FLOWLINE ARE NOT ALLOWED WITHIN SIGHT TRIANGLES.
- 13. SIGNING AND STRIPING SHALL COMPLY WITH EL PASO COUNTY DOT AND MUTCD CRITERIA. [IF APPLICABLE, ADDITIONAL SIGNING AND STRIPING NOTES WILL BE PROVIDED.]
- 14. CONTRACTOR SHALL OBTAIN ANY PERMITS REQUIRED BY EL PASO COUNTY DOT, INCLUDING WORK WITHIN THE RIGHT-OF-WAY AND SPECIAL TRANSPORT PERMITS.
- 15. THE LIMITS OF CONSTRUCTION SHALL REMAIN WITHIN THE PROPERTY LINE UNLESS OTHERWISE NOTED. THE OWNER/DEVELOPER SHALL OBTAIN WRITTEN PERMISSION AND EASEMENTS, WHERE REQUIRED, FROM ADJOINING PROPERTY OWNER(S) PRIOR TO ANY OFF-SITE DISTURBANCE, GRADING, OR CONSTRUCTION.

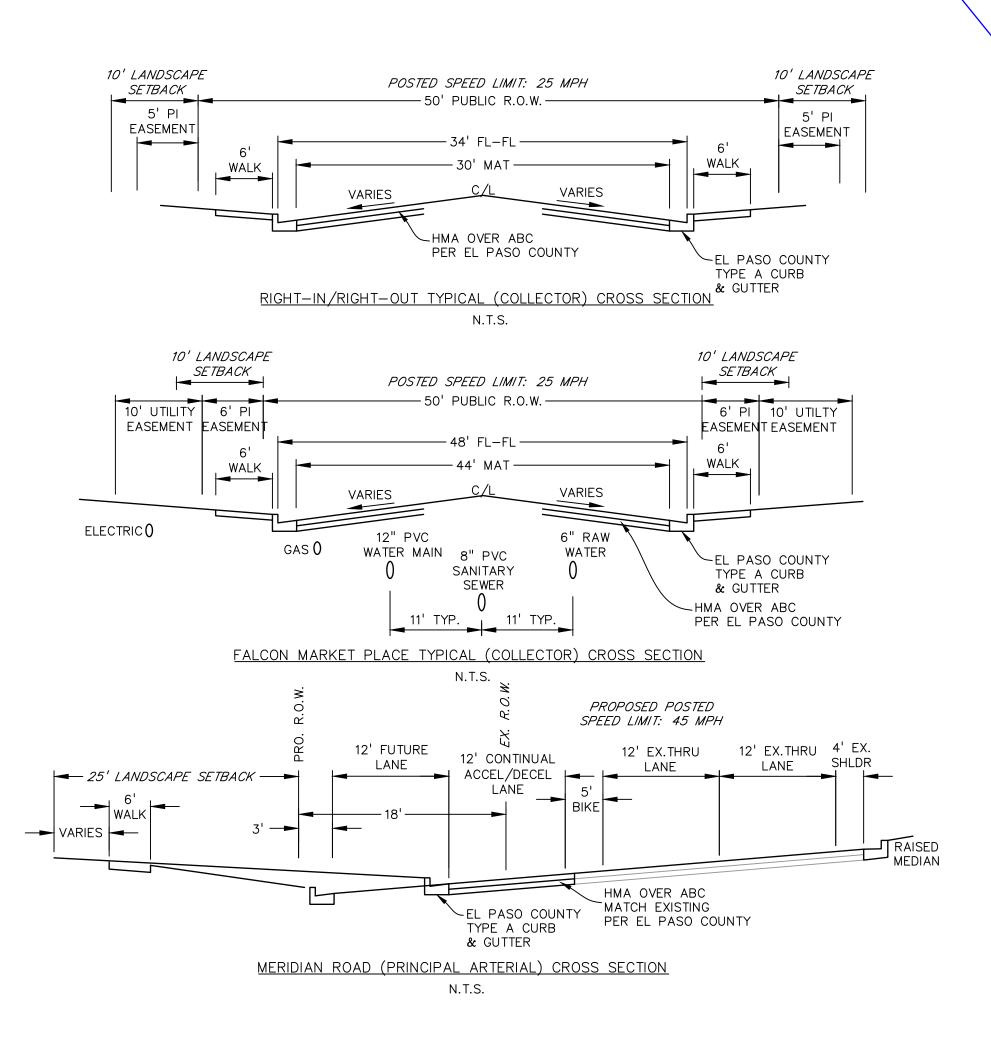

SIGNAGE AND STRIPING NOTES

SIGNING AND STRIPING NOTES: DEVICES (MUTCD).

2. REMOVAL OF EXISTING PAVEMENT MARKINGS SHALL BE ACCOMPLISHED BY A METHOD THAT DOES NOT MATERIALLY DAMAGE THE PAVEMENT. THE PAVEMENT MARKINGS SHALL BE REMOVED TO THE EXTENT THAT THEY WILL NOT BE VISIBLE UNDER DAY OR NIGHT CONDITIONS. AT NO TIME WILL IT BE ACCEPTABLE TO PAINT OVER EXISTING PAVEMENT MARKINGS.

3. ANY DEVIATION FROM THE STRIPING AND SIGNING PLAN SHALL BE APPROVED BY EL PASO COUNTY PLANNING AND COMMUNITY DEVELOPMENT.

4. ALL SIGNS SHOWN ON THE SIGNING AND STRIPING PLAN SHALL BE NEW SIGNS. EXISTING SIGNS MAY REMAIN OR BE REUSED IF THEY MEET CURRENT EL PASO COUNTY AND MUTCD STANDARDS.

5. STREET NAME AND REGULATORY STOP SIGNS SHALL BE ON THE SAME POST AT INTERSECTIONS.

6. ALL REMOVED SIGNS SHALL BE DISPOSED OF IN A PROPER MANNER BY THE CONTRACTOR.

7. ALL STREET NAME SIGNS SHALL HAVE 'D' SERIES LETTERS, WITH LOCAL ROADWAY SIGNS BEING 4" UPPER-LOWER CASE LETTERING ON 8" BLANK AND NON-LOCAL ROADWAY SIGNS BEING 6" LETTERING, UPPER-LOWER CASE ON 12" BLANK, WITH A WHITE BORDER THAT IS NOT RECESSED. MULTI-LANE ROADWAYS WITH SPEED LIMITS OF 40 MPH OR HIGHER SHALL HAVE 8" UPPER-LOWER CASE LETTERING ON 18" BLANK WITH A WHITE BORDER THAT IS NOT RECESSED. THE WIDTH OF THE NON-RECESSED WHITE BORDERS SHALL MATCH PAGE 255 OF THE 2012 MUTCD "STANDARD HIGHWAY SIGNS"

8. ALL TRAFFIC SIGNS SHALL HAVE A MINIMUM HIGH INTENSITY PRISMATIC GRADE SHEETING.

SLIPBASE DESIGN.

11. ALL LIMIT LINES/STOP LINES, CROSSWALK LINES, PAVEMENT LEGENDS, AND ARROWS SHALL BE A MINIMUM 125 MIL THICKNESS PREFORMED THERMOPLASTIC PAVEMENT MARKINGS WITH TAPERED LEADING EDGES PER CDOT STANDARD S-627-1. WORD AND SYMBOL MARKINGS SHALL BE THE NARROW TYPE. STOP BARS SHALL BE 24" IN WIDTH. CROSSWALKS LINES SHALL BE 12" WIDE AND 8' LONG PER CDOT S-627-1.

12. ALL LONGITUDINAL LINES SHALL BE A MINIMUM 15MIL THICKNESS EPOXY PAINT. ALL NON-LOCAL RESIDENTIAL ROADWAYS SHALL INCLUDE BOTH RIGHT AND LEFT EDGE LINE STRIPING AND ANY ADDITIONAL STRIPING AS REQUIRED BY CDOT S-627-1.

13. THE CONTRACTOR SHALL NOTIFY EL PASO COUNTY PLANNING AND COMMUNITY DEVELOPMENT (719) 520-6819 PRIOR TO AND UPON COMPLETION OF SIGNING AND STRIPING.

14. THE CONTRACTOR SHALL OBTAIN A WORK IN THE RIGHT OF WAY PERMIT FROM THE EL PASO COUNTY DEPARTMENT OF PUBLIC WORKS (DPW) PRIOR TO ANY SIGNAGE OR STRIPING WORK WITHIN AN EXISTING EL PASO COUNTY ROADWAY.

1. ALL SIGNS AND PAVEMENT MARKINGS SHALL BE IN COMPLIANCE WITH THE CURRENT MANUAL ON UNIFORM TRAFFIC CONTROL


9. ALL LOCAL RESIDENTIAL STREET SIGNS SHALL BE MOUNTED ON A 1.75" X 1.75" SQUARE TUBE SIGN POST AND STUB POST BASE. FOR OTHER APPLICATIONS, REFER TO THE CDOT STANDARD S-614-8 REGARDING USE OF THE P2 TUBULAR STEEL POST


10. ALL SIGNS SHALL BE SINGLE SHEET ALUMINUM WITH 0.100" MINIMUM THICKNESS.


Watertight joints shall - be provided on the specified pipes.


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CONSTRUCTION DRAWINGS FOR	FALCON MARKETPLACE	FALCON, COLORADO
	SUE	DATE
	BMITTAL ISED	5–6–19 7–19–19
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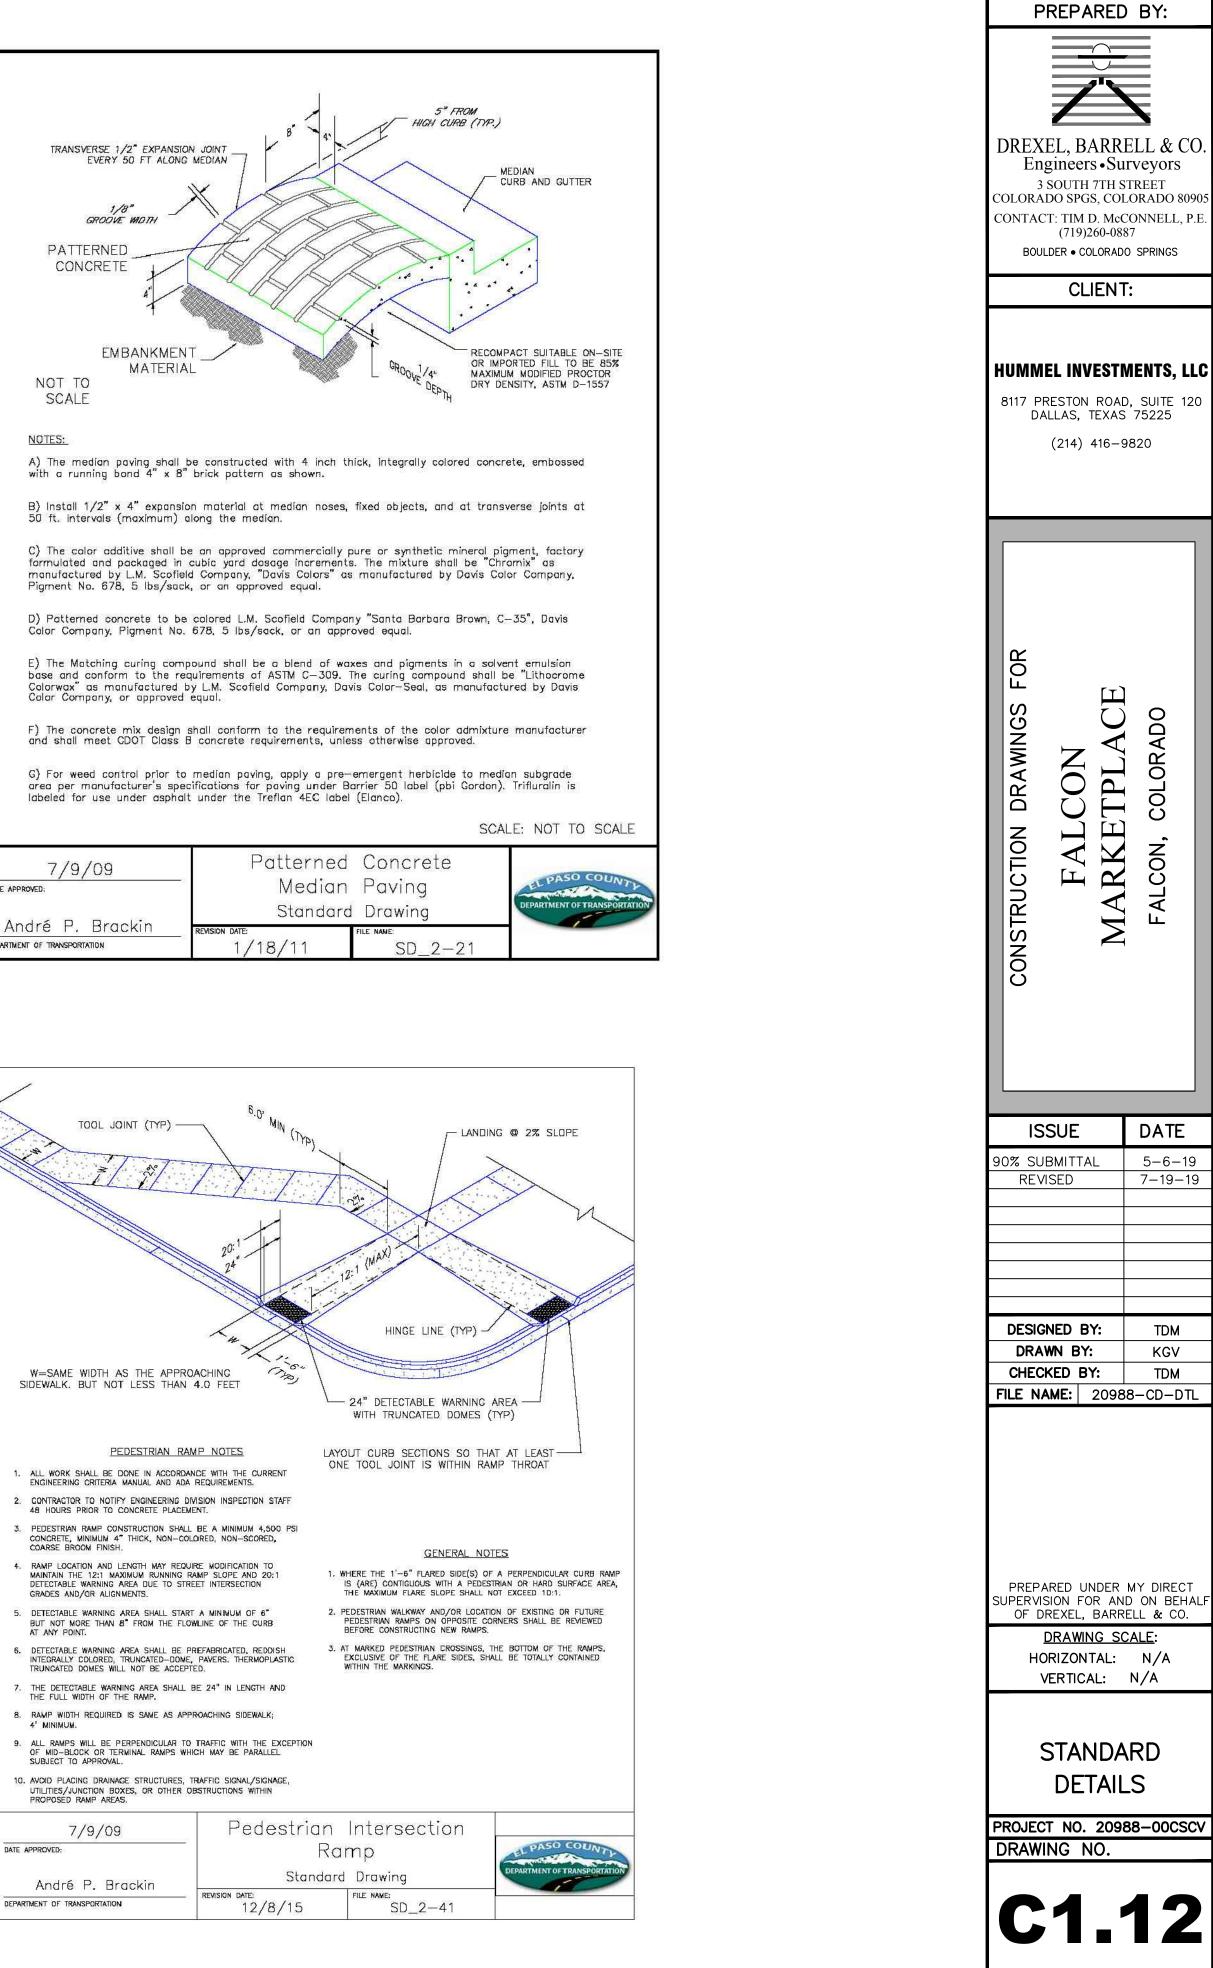
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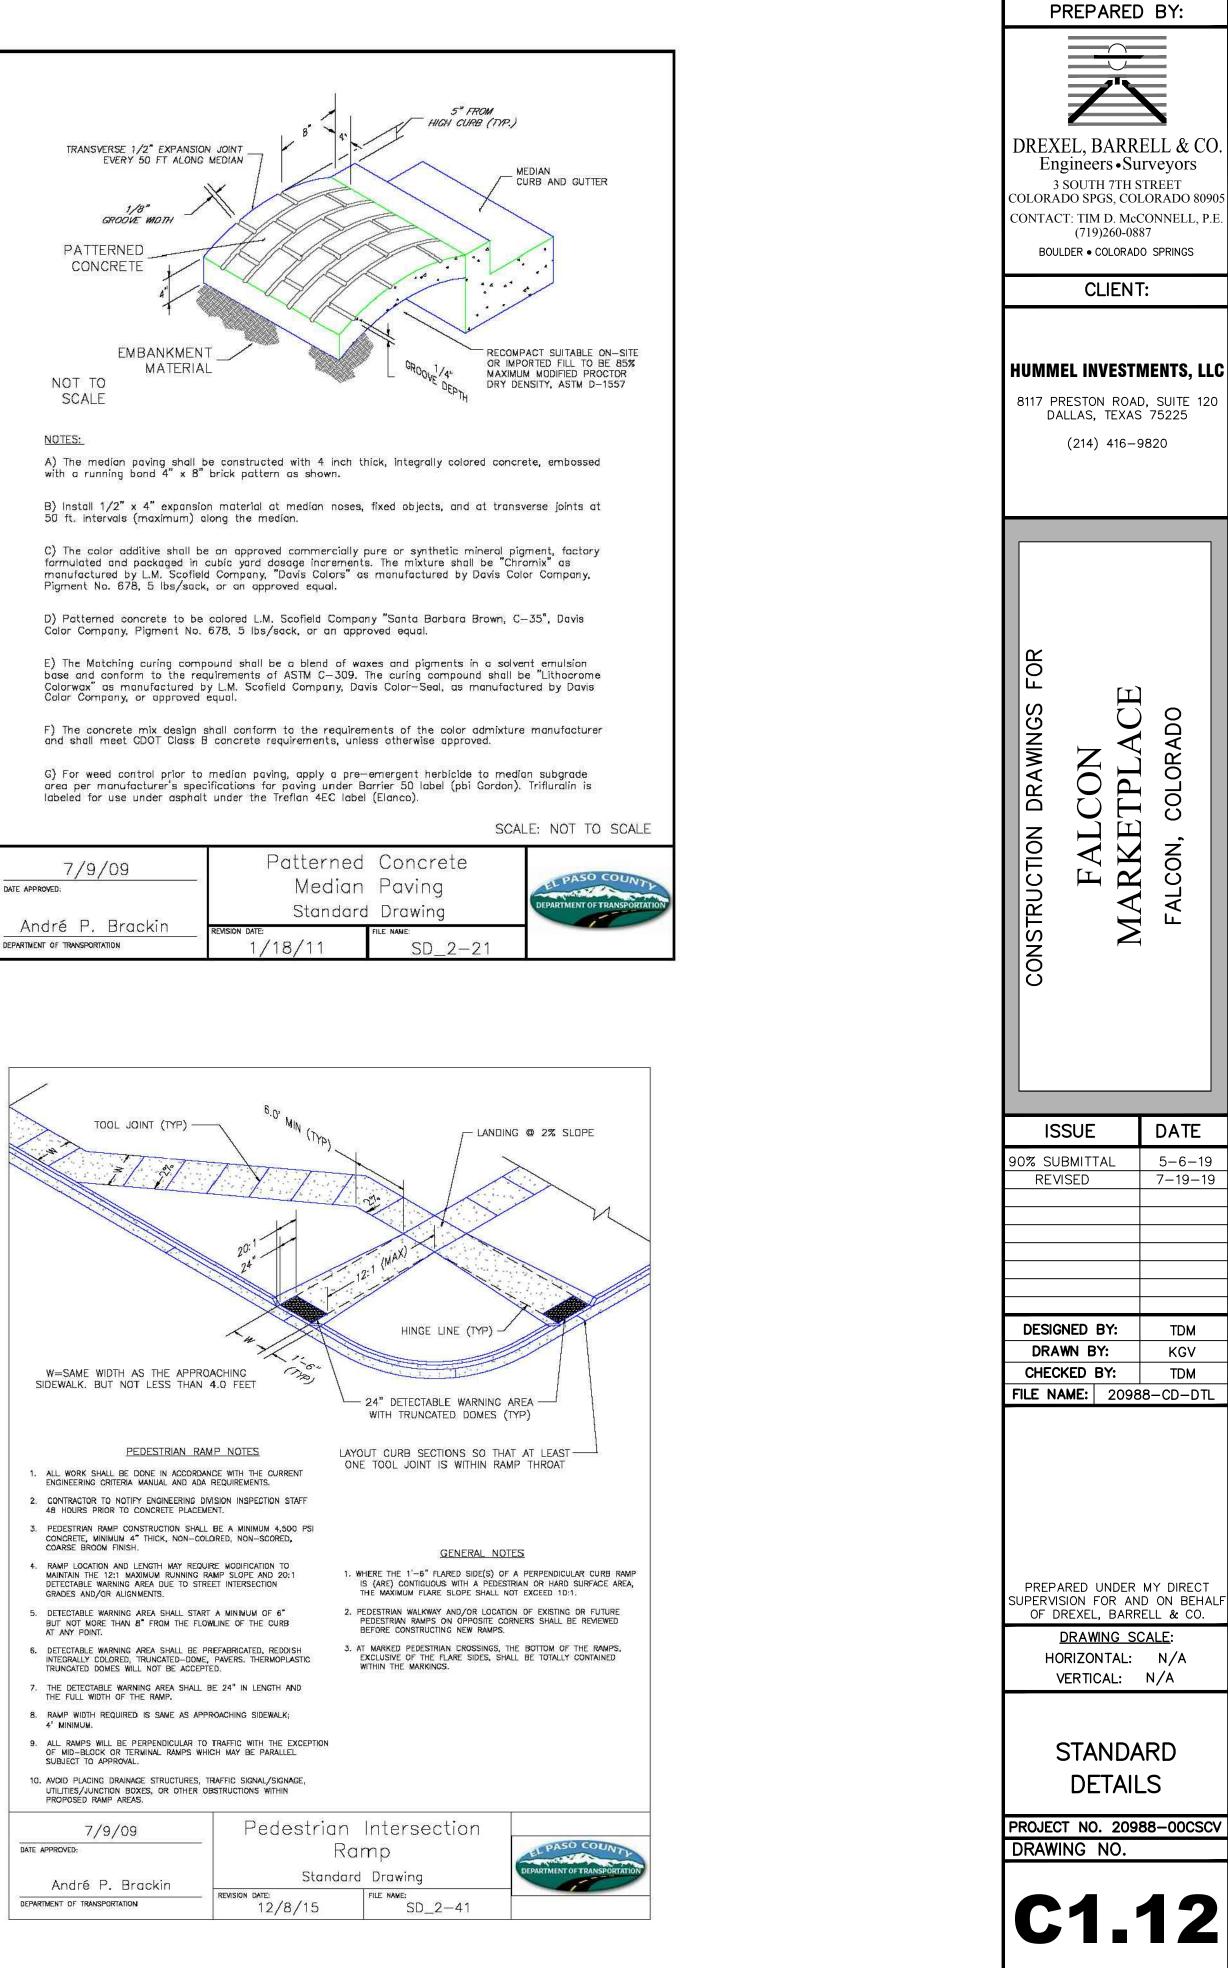




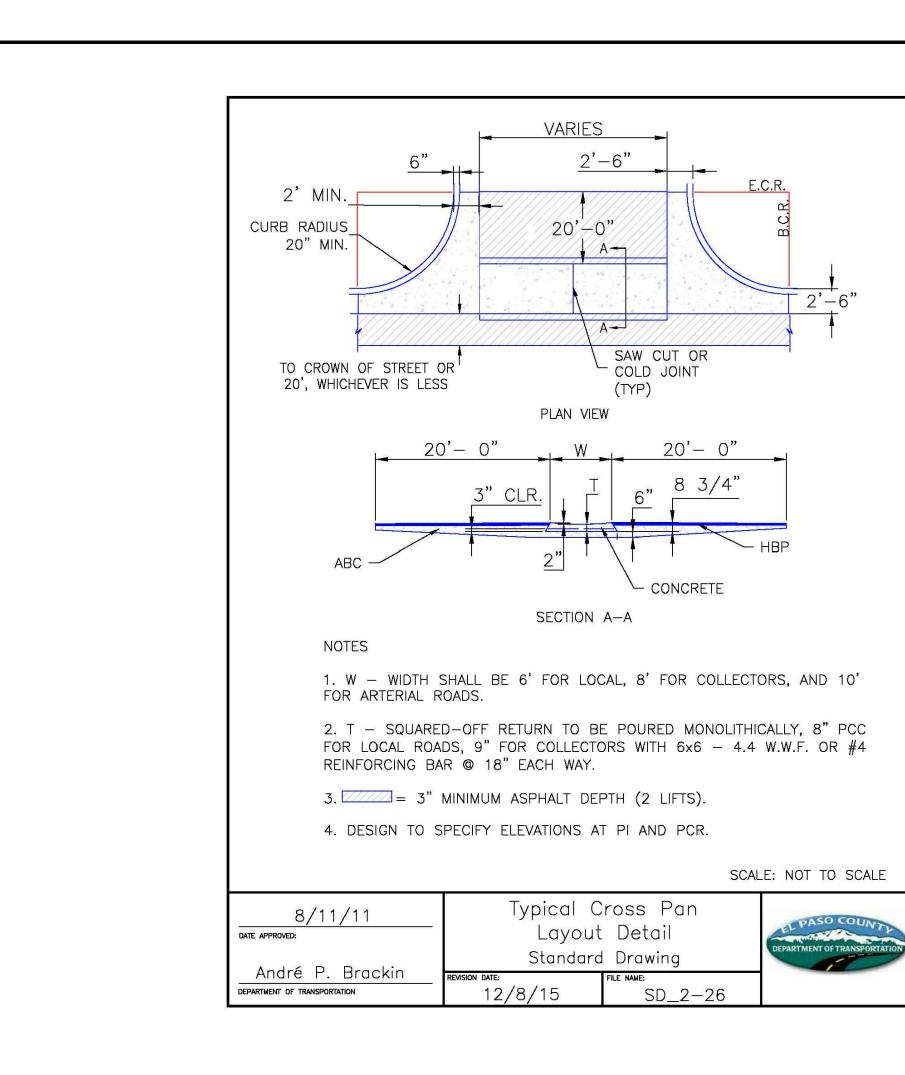


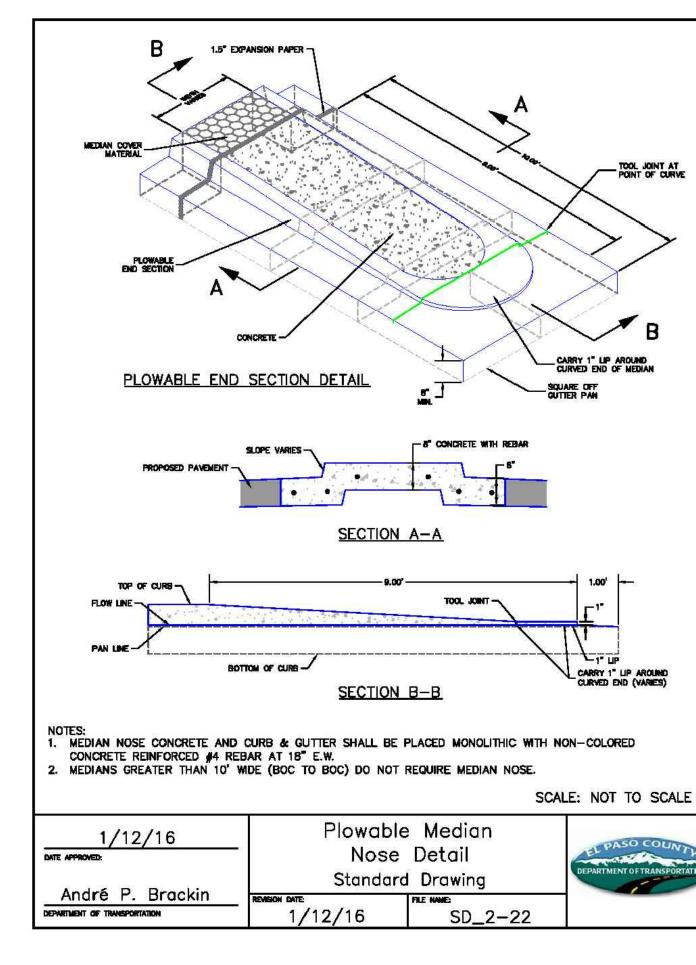


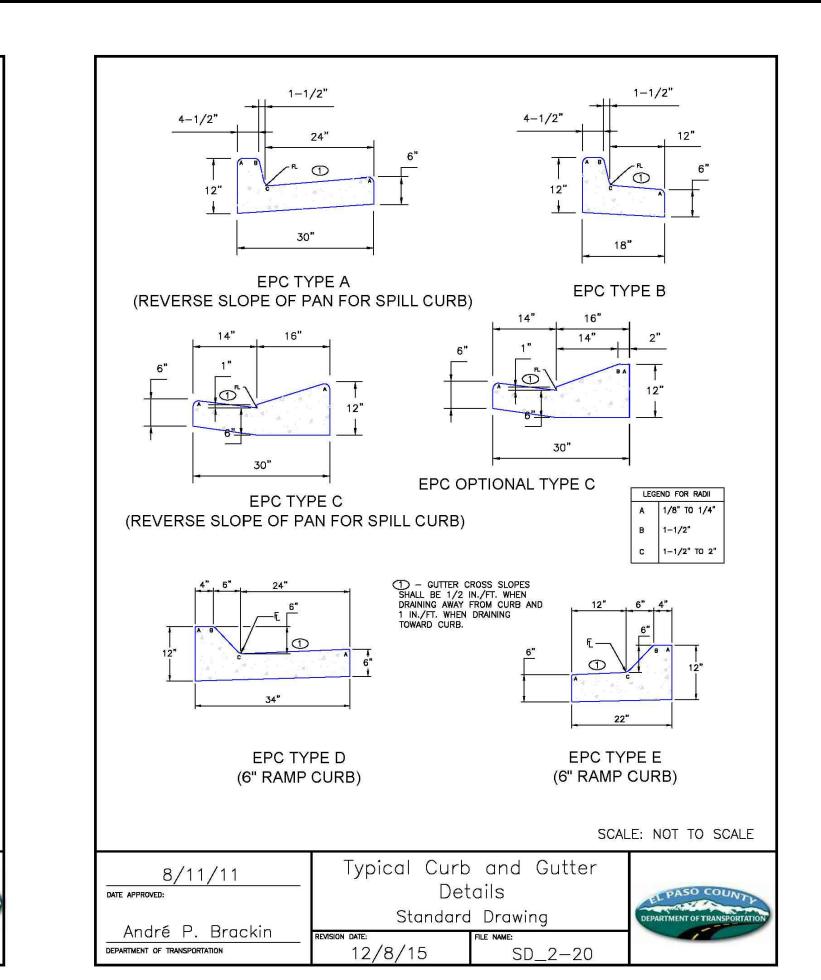


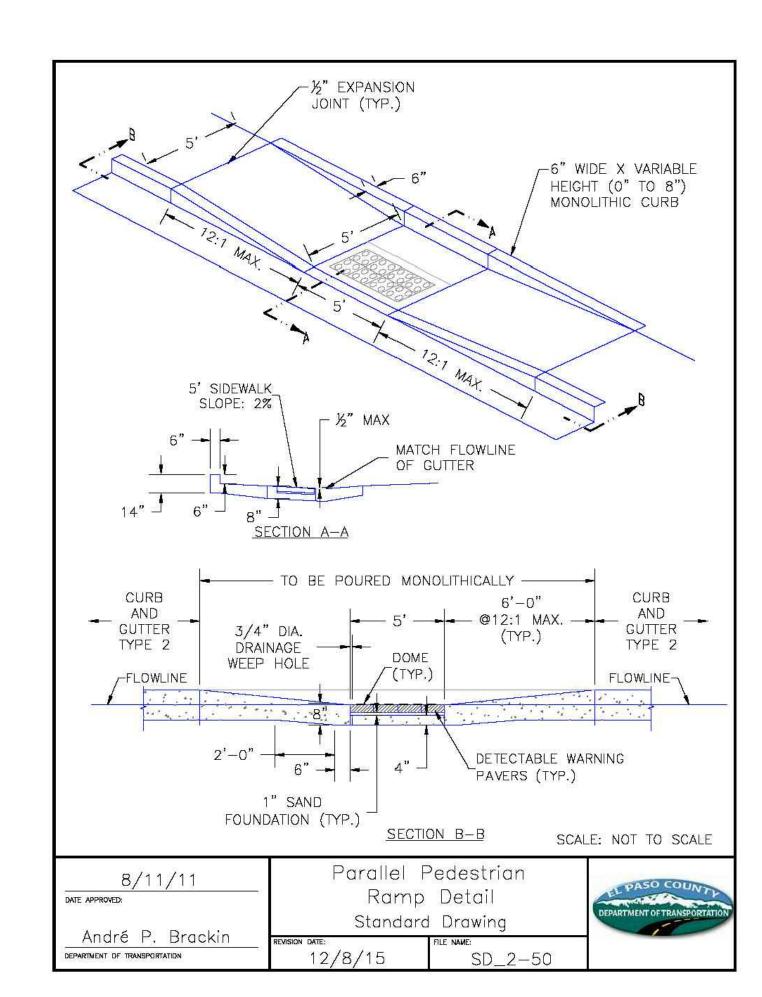


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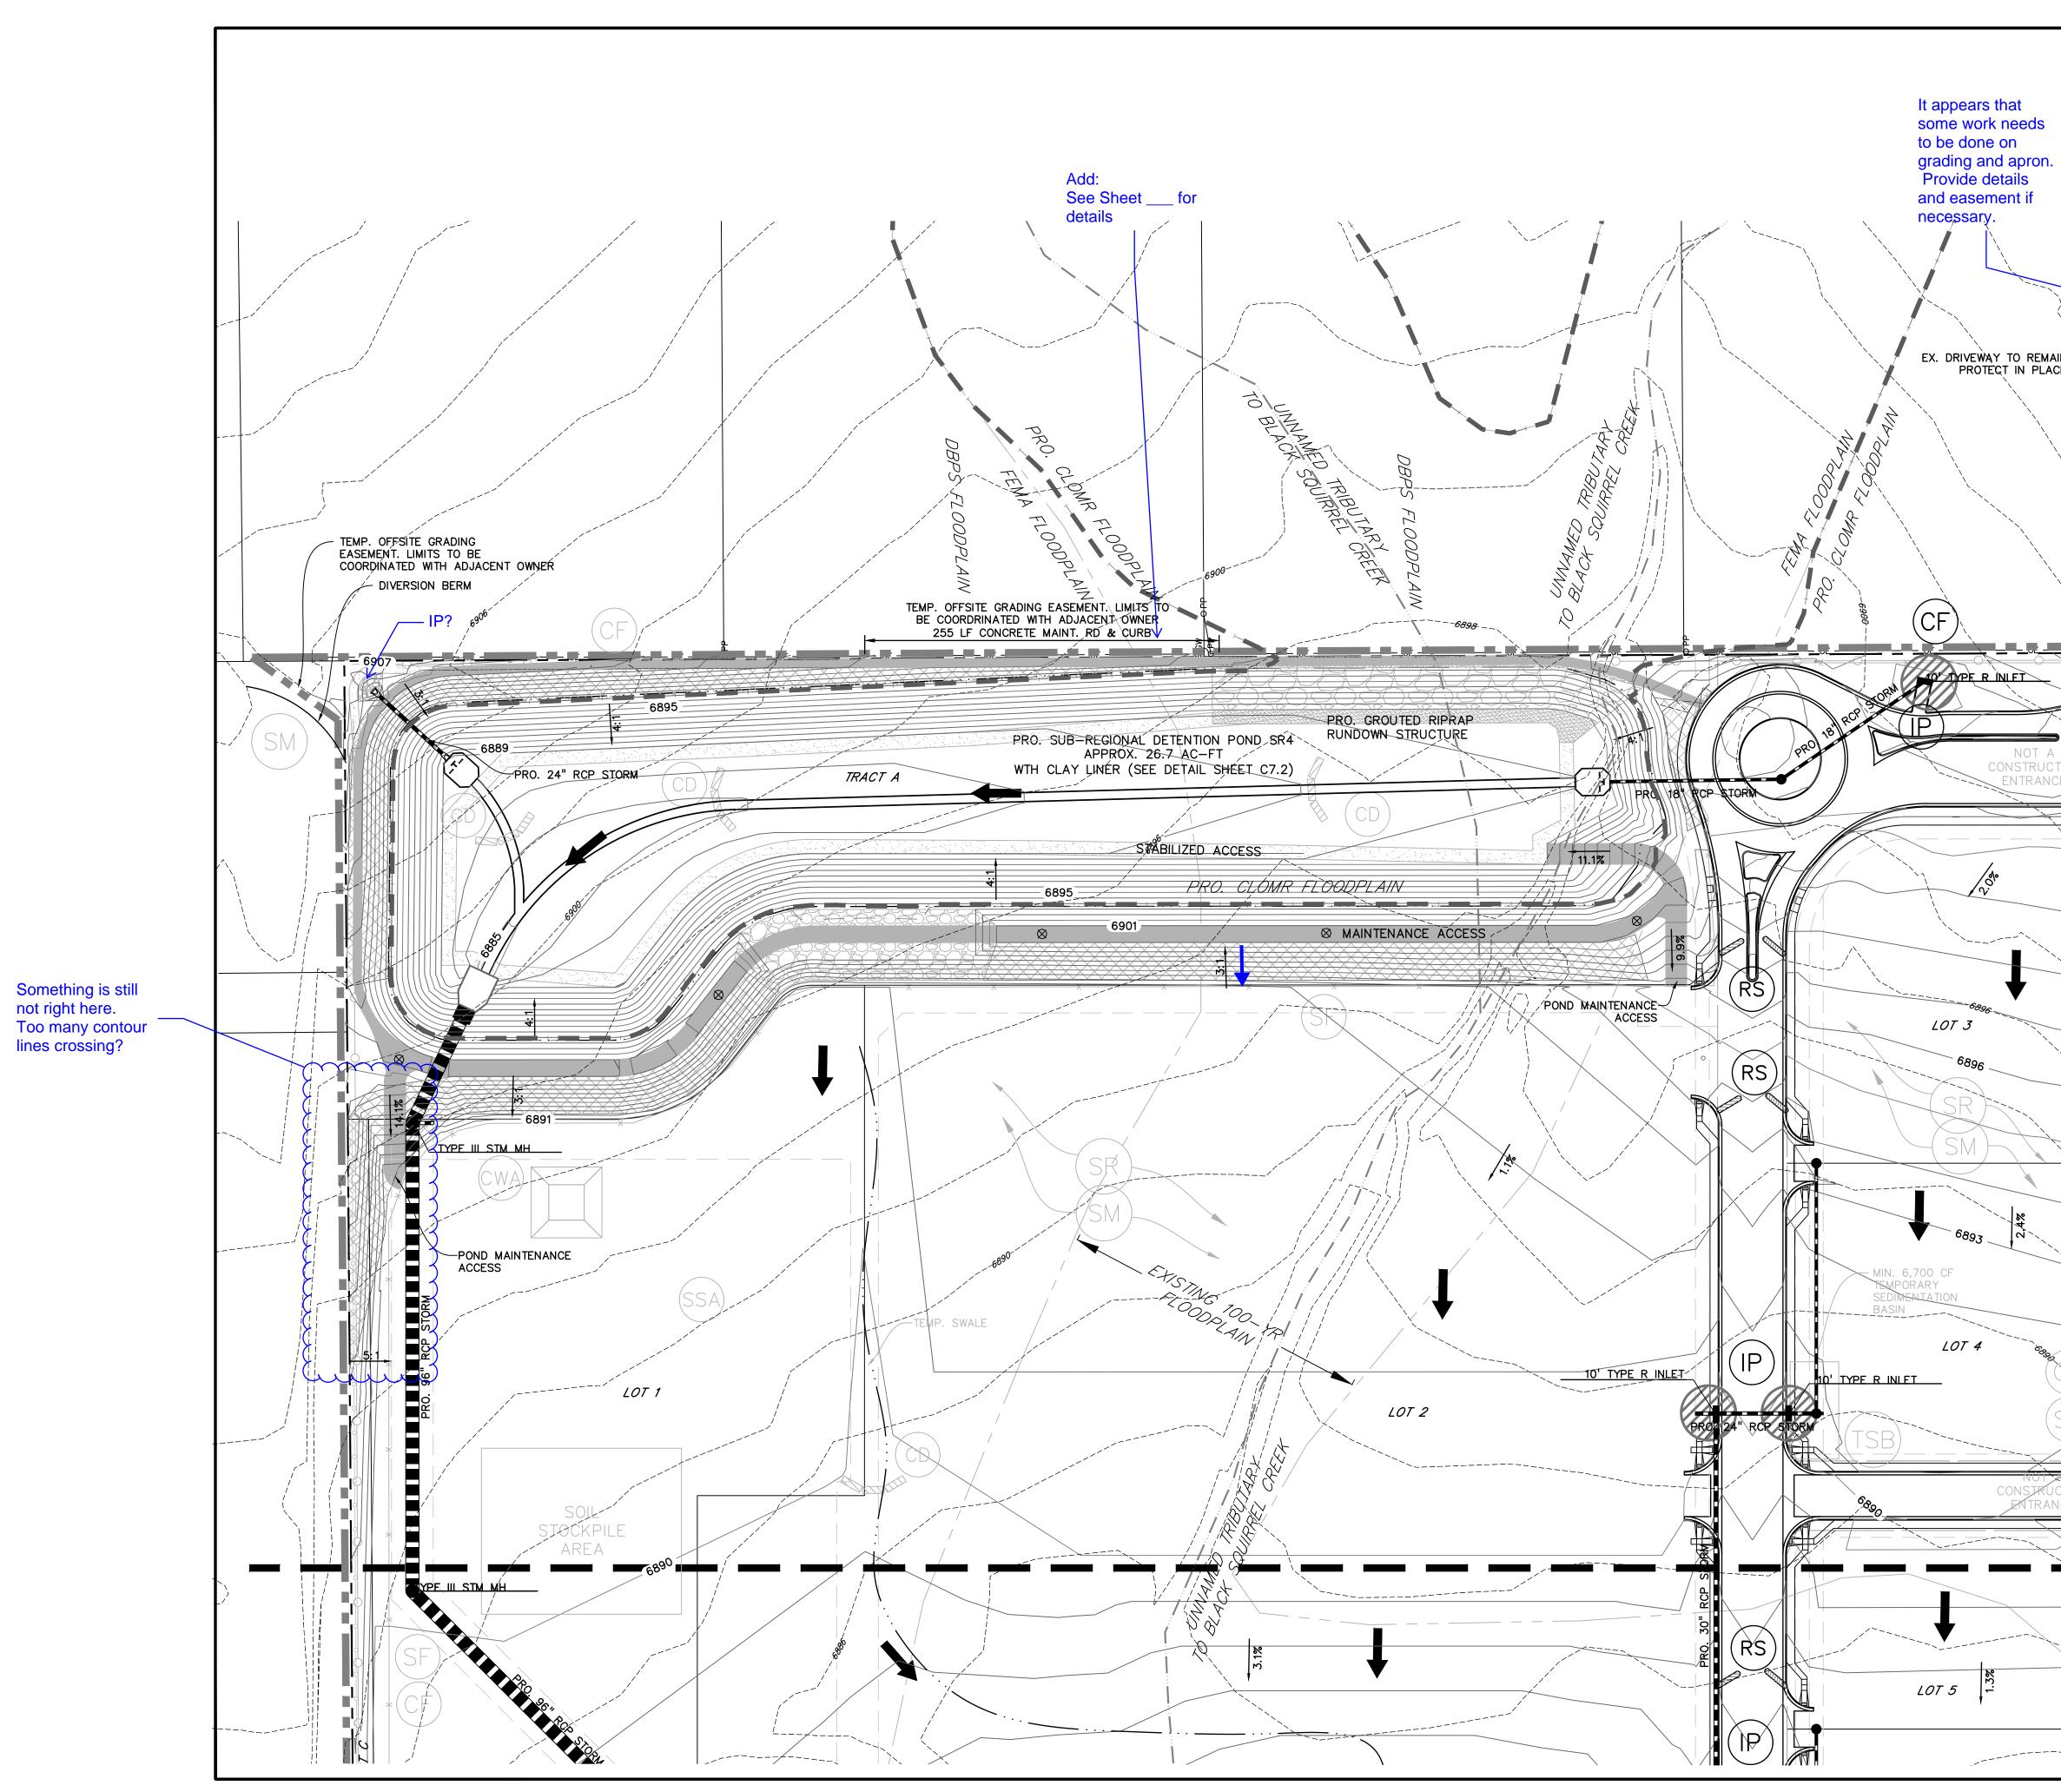


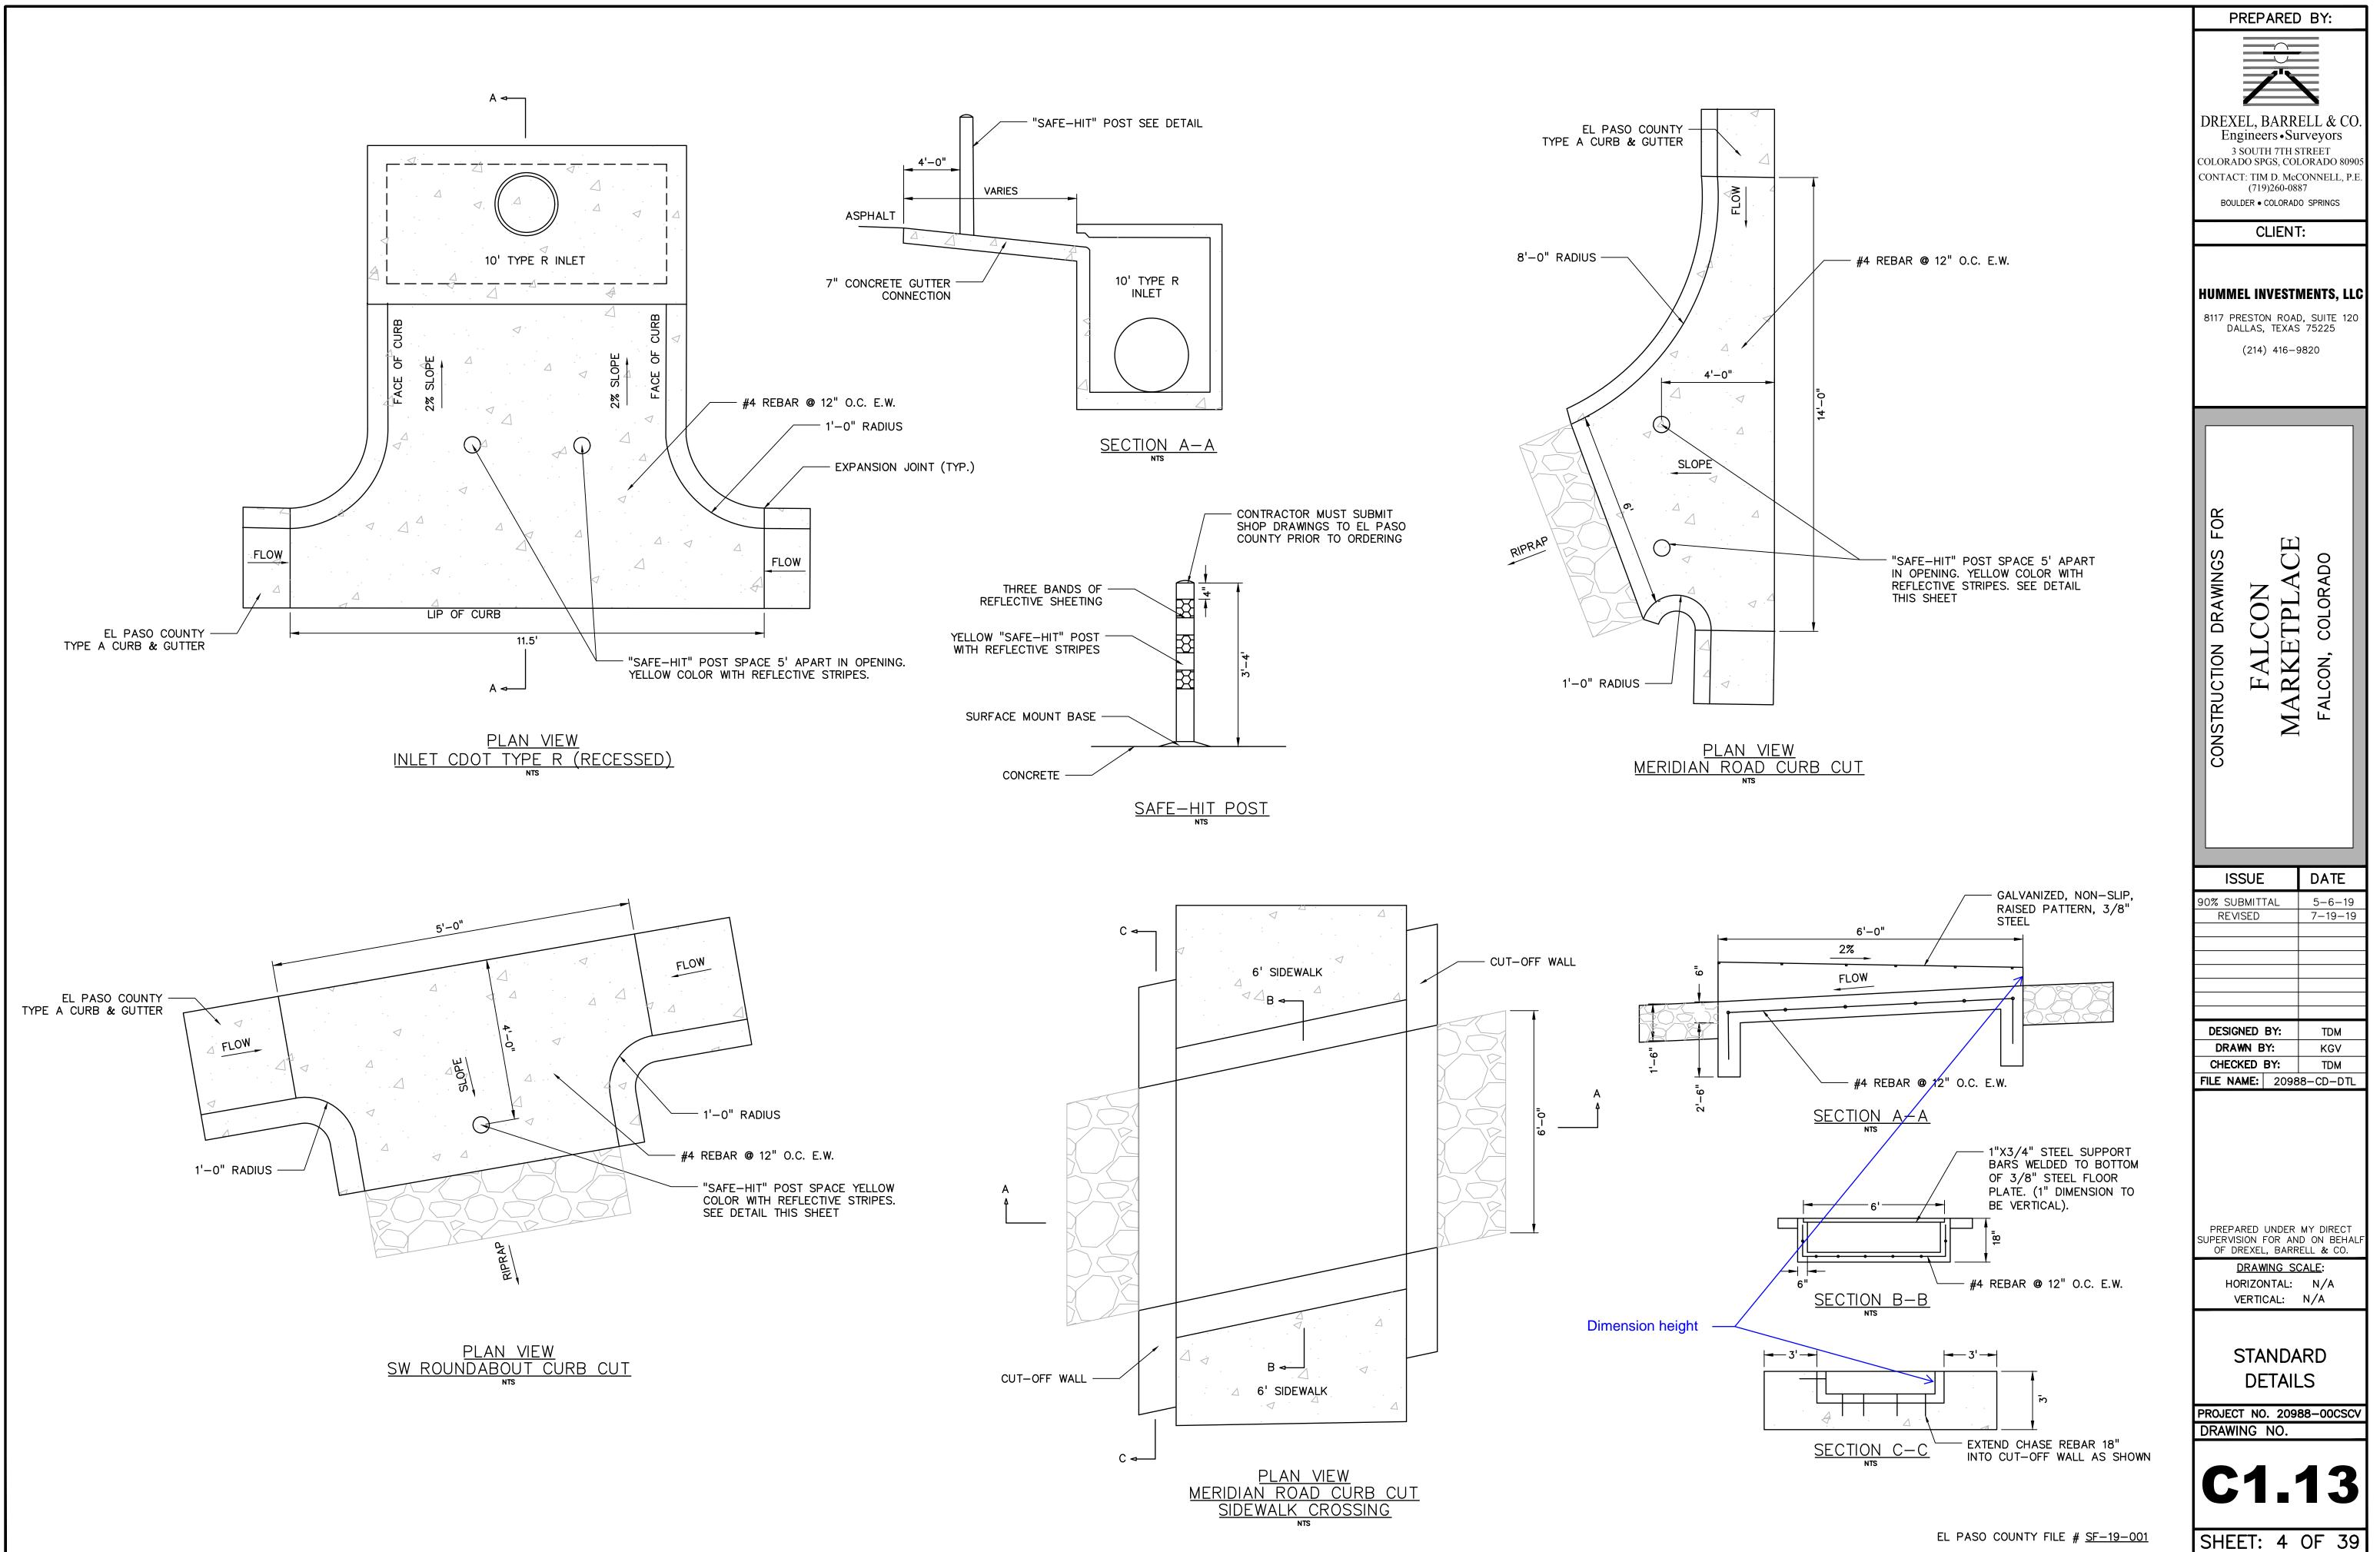

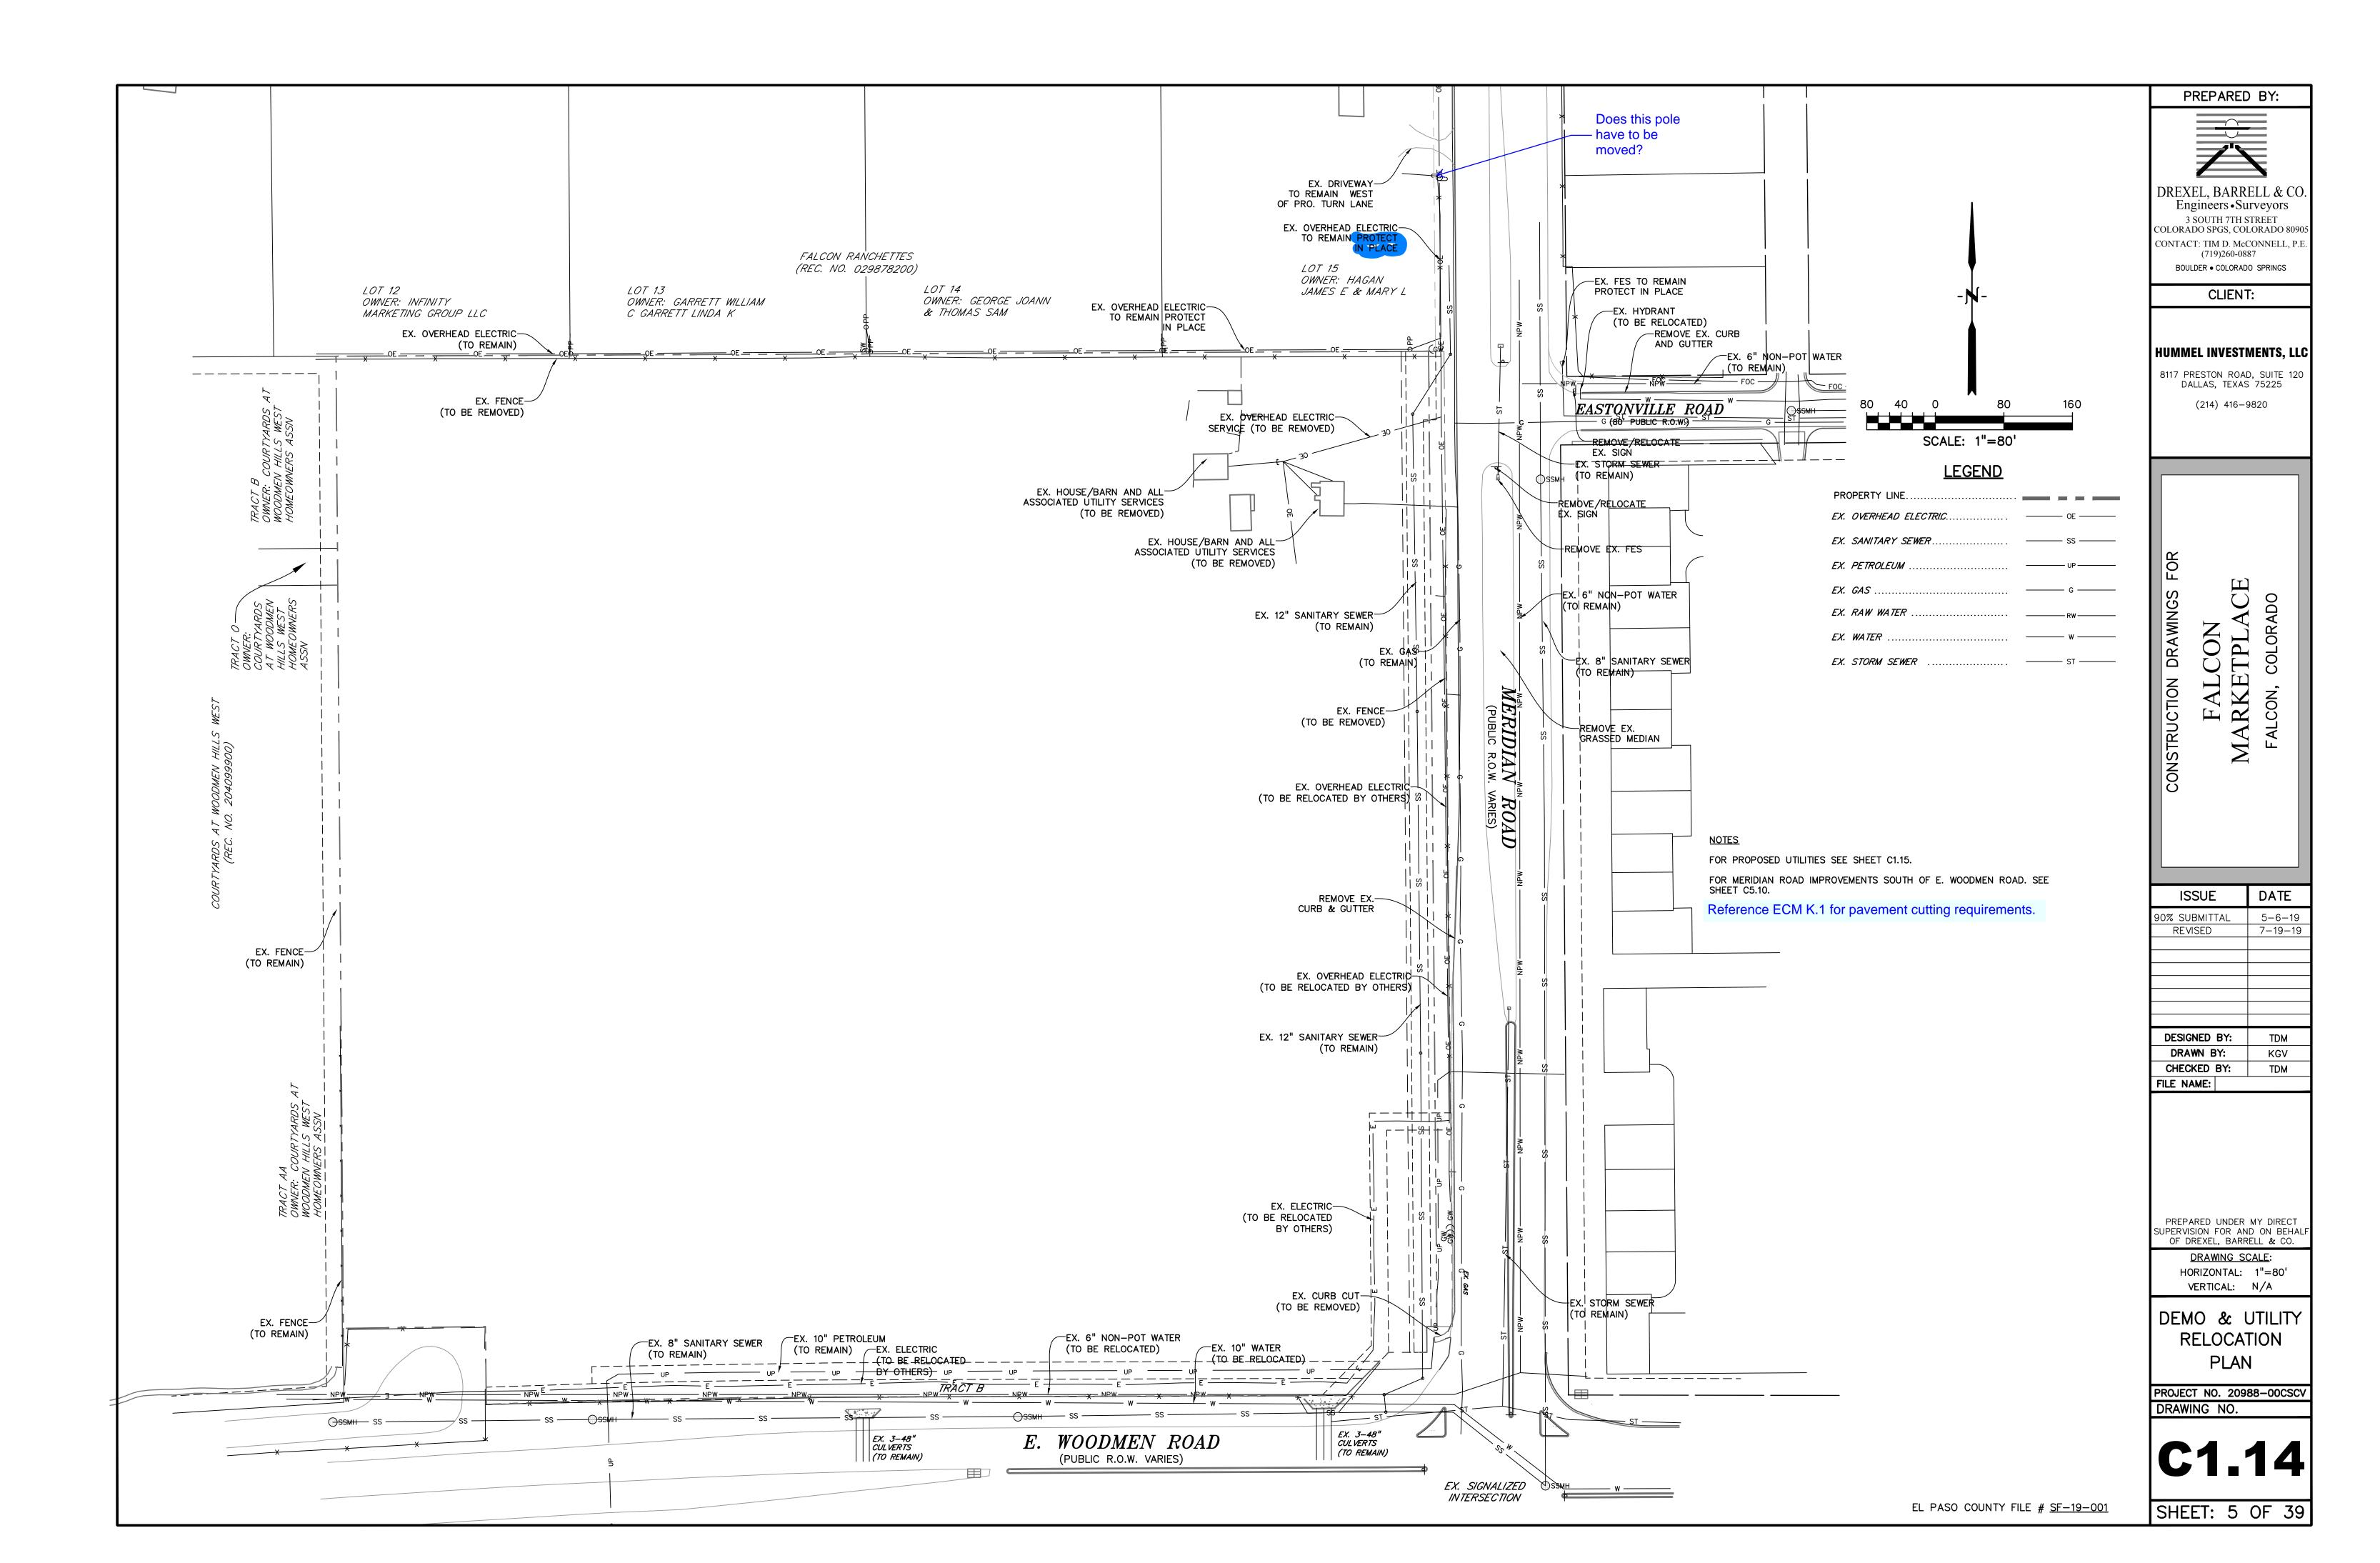


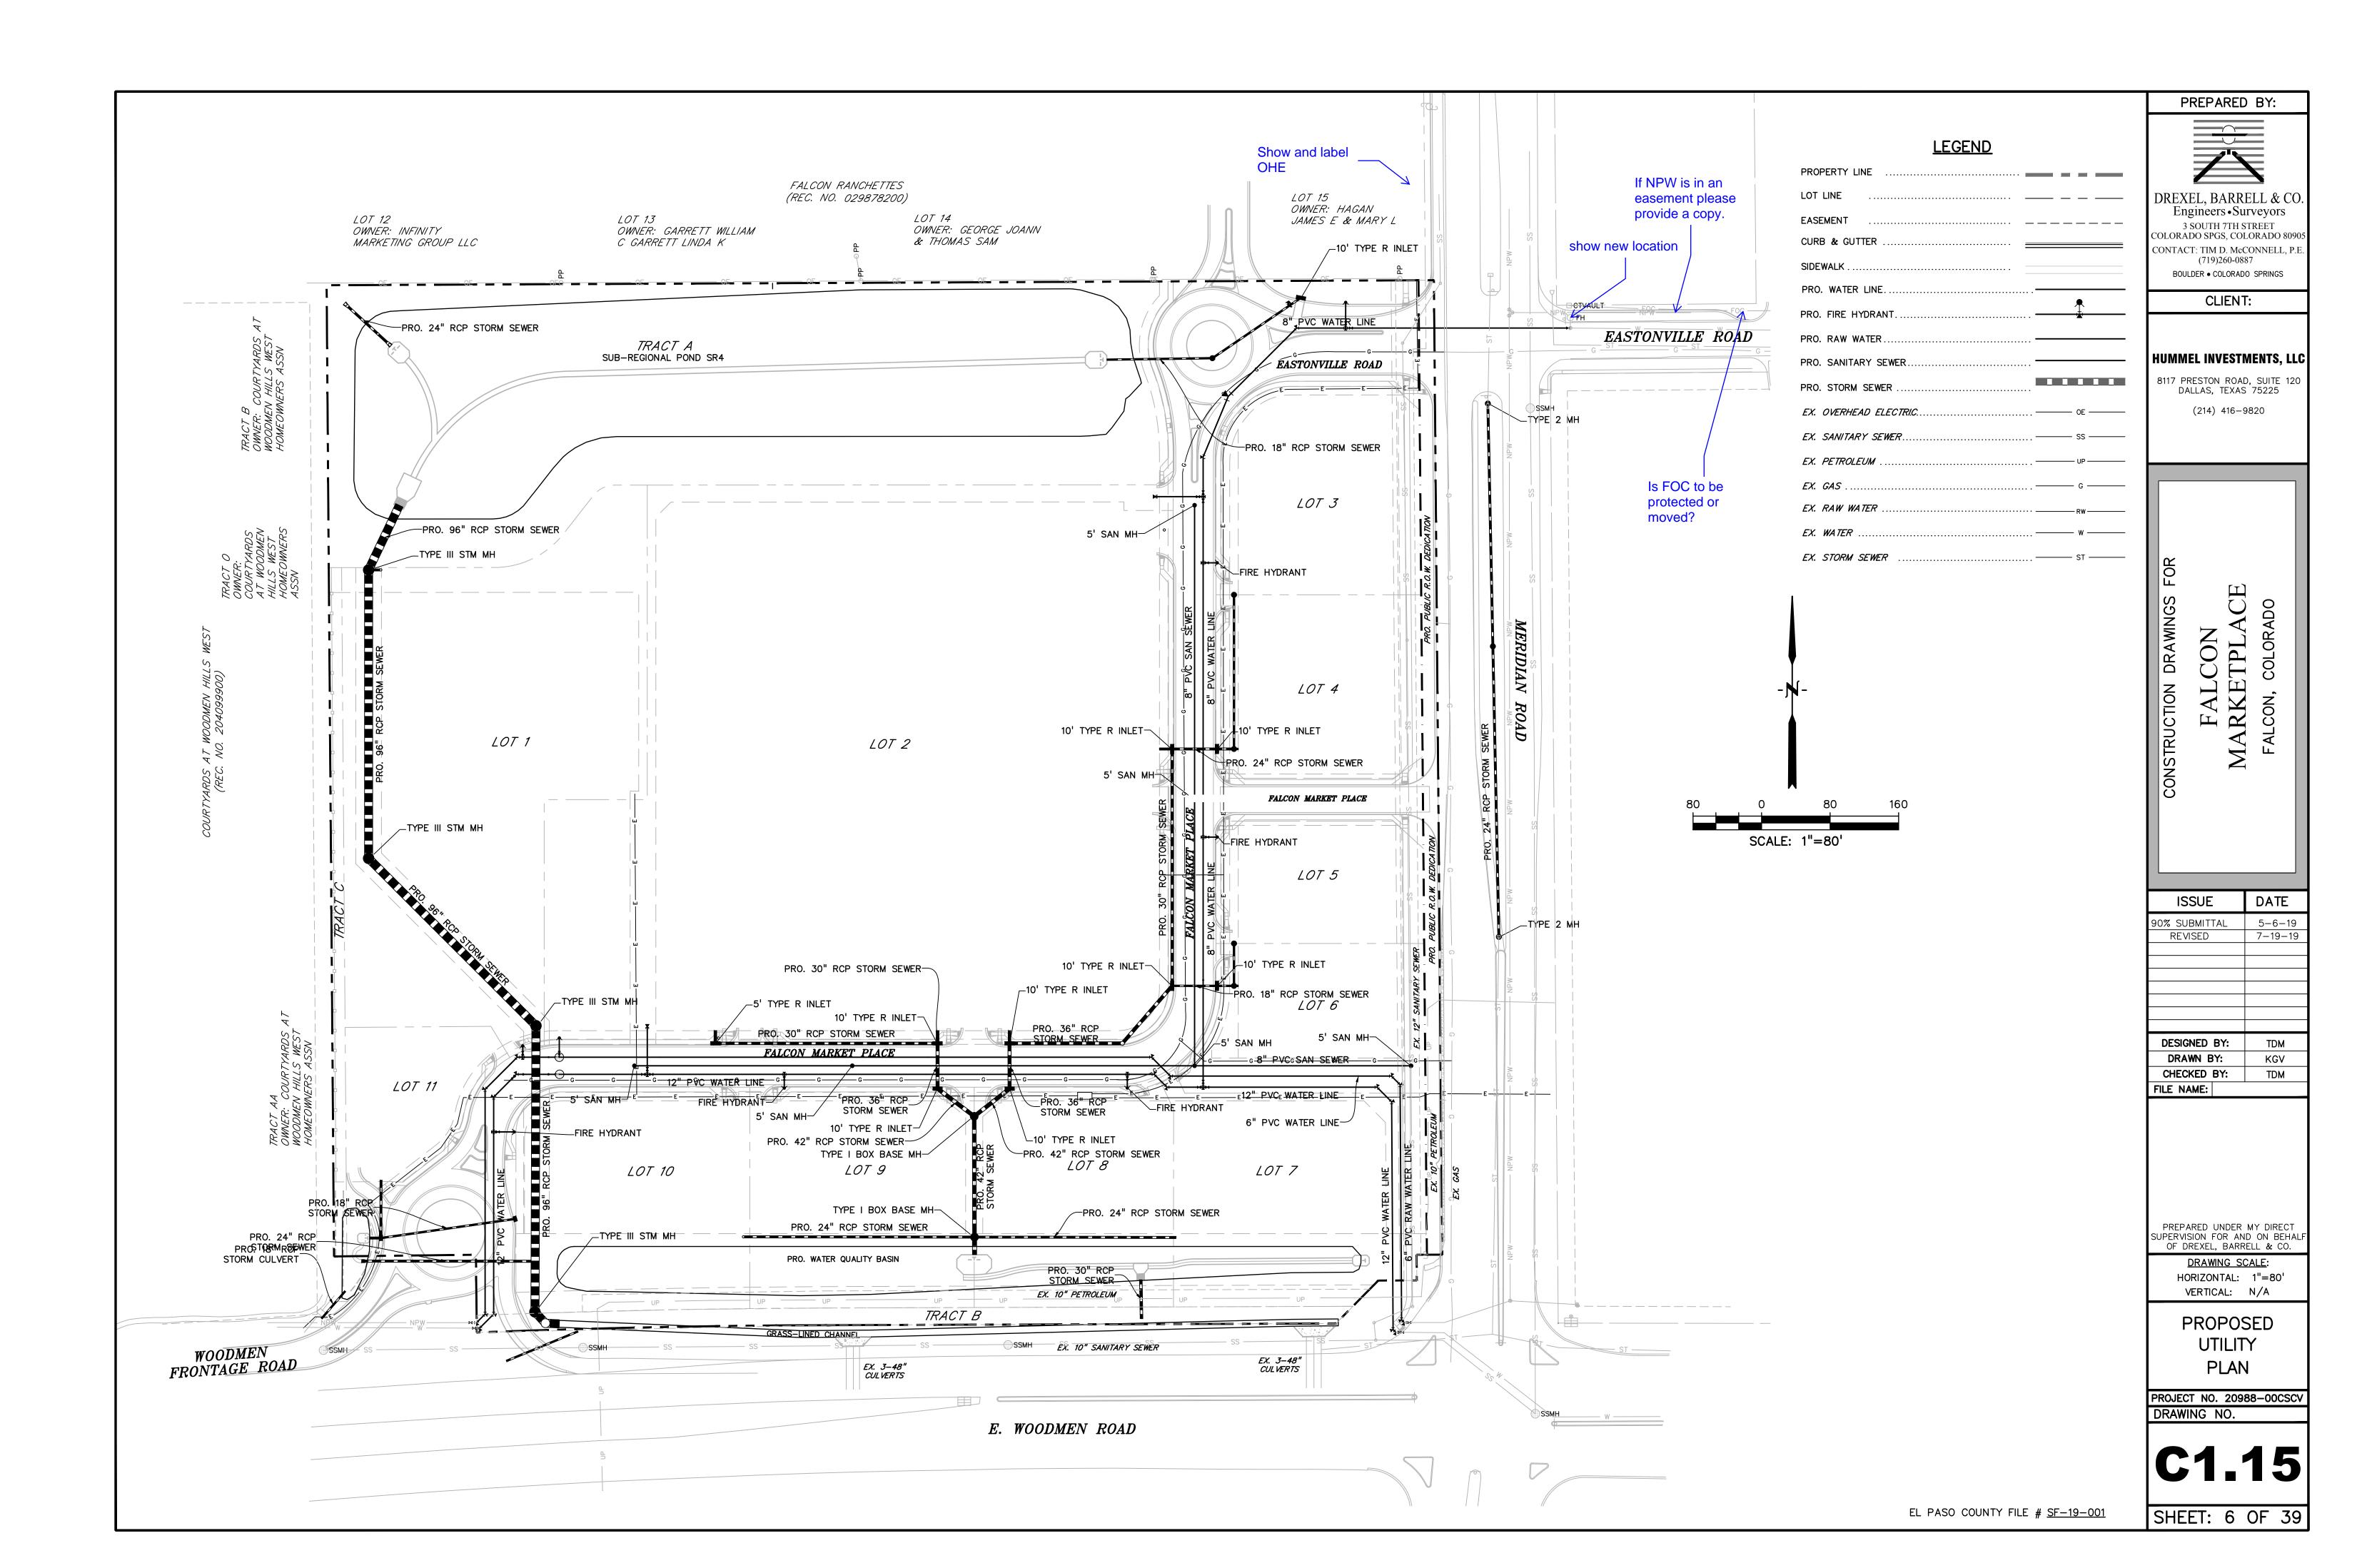
D.B.& CO. T13S 14 R65W R64W S1		PREPARED BY:
<i>NW CORNER, SE</i> 1/4, SE 1/4 <i>SECTION 1</i> 509 N 16248.60 E 9959.23	EASTONVILLE ROAD	COLORADO SPGS, COLORADO 80905 CONTACT: TIM D. McCONNELL, P.E. (719)260-0887 BOULDER • COLORADO SPRINGS CLIENT:
18' DEDICATED TO EL PASO COUNTY FOR R.O.W. PURPOSES	Image: Second system Image: Second system Image: Second system Image: Second system 300 (80' PUBLIC R.O.W.) (80' PUBLIC R.O.W.) Image: Second system Image: Second system Image: Second system<	HUMMEL INVESTMENTS, LLC 8117 PRESTON ROAD, SUITE 120 DALLAS, TEXAS 75225 (214) 416–9820
MERIDIAN ROAD (PUBLIC R.O.W. VARIES) (PUBLIC R.O.W. VARIES) 510 N 15716.17 E 9963.82	$ \begin{array}{ c c c c c c c c c c c c c c c c c c c$	CONSTRUCTION DRAWINGS FOR EALCON FALCON FALCON FALCON FALCON FALCON FALCON FALCON FALCON FALCON FALCON
18' TO EL PASO	C18 18.47' 68.00' 15*33'47" S07*56'32"W 18.41' R.O.W. A. page 78 FOUND #5 REBAR WITH 1.5" YELLOW PLASTIC Image 78 FOUND MIL FOUND NAIL WITH 1.5" YELLOW PLASTIC Image 78 FOUND NAIL WITH 1.5" WASHER PLS 31548 Image 78 FOUND 3.25" ALUMINUM CAP Image 78 Image 78 FOUND 1" DIAMETER PLS 35585 2005 Image 78 Image 78 FOUND 1" DIAMETER PIPE, SET 2.5" ALUMINUM Image 78 FOUND 1" DIAMETER PIPE, SET 2.5" ALUMINUM Image 78 FOUND 1" DIAMETER PIPE, SET 2.5" ALUMINUM Image 78 FOUND 1" DIAMETER PIPE, SET 2.5" ALUMINUM Image 78 FOUND 1" DIAMETER PIPE, SET 2.5" ALUMINUM Image 78	90% SUBMITTAL 5-6-19 REVISED 7-19-19 DESIGNED BY: JCD DRAWN BY: KGV CHECKED BY: TDM FILE NAME:
COUNTY FOR R.O.W. PURPOSES <i>R.O.W.</i> <i>Rec. No.</i> 207116129	CALCULATED 1/16 CORNER, NOT SET, FALLS INTO TRAFFIC LANE CALCULATED CL ROW POINT X SURVEY CONTROL-SET #5 REBAR WITH 2" ALUMINUM CAP BENCHMARK ELEVATIONS ARE BASED ON COLORADO SPRINGS UTILITIES FACILITIES INFORMATION SYSTEM (FIMS) "BLT 167", A 2" ALUMINUM CAP IN CONCRETE LOCATED ON AN ELECTRIC TRANSFORMER PAD AT THE SOUTHEAST CORNER OF WOODMEN ROAD AND MERIDIAN ROAD, WITH AN ELEVATION OF 6873.18 (NGVD 29). LOCAL PROJECT COORDINATES = N: 14851.96, E: 10104.91 Corner, Section 1, W, Sixth P.M. falls into traffic coulated)See Monuments North	PREPARED UNDER MY DIRECT SUPERVISION FOR AND ON BEHALF OF DREXEL, BARRELL & CO. DRAWING SCALE: HORIZONTAL: N/A VERTICAL: N/A SURVEY CONTROL PROJECT NO. 20988–00CSCV DRAWING NO.

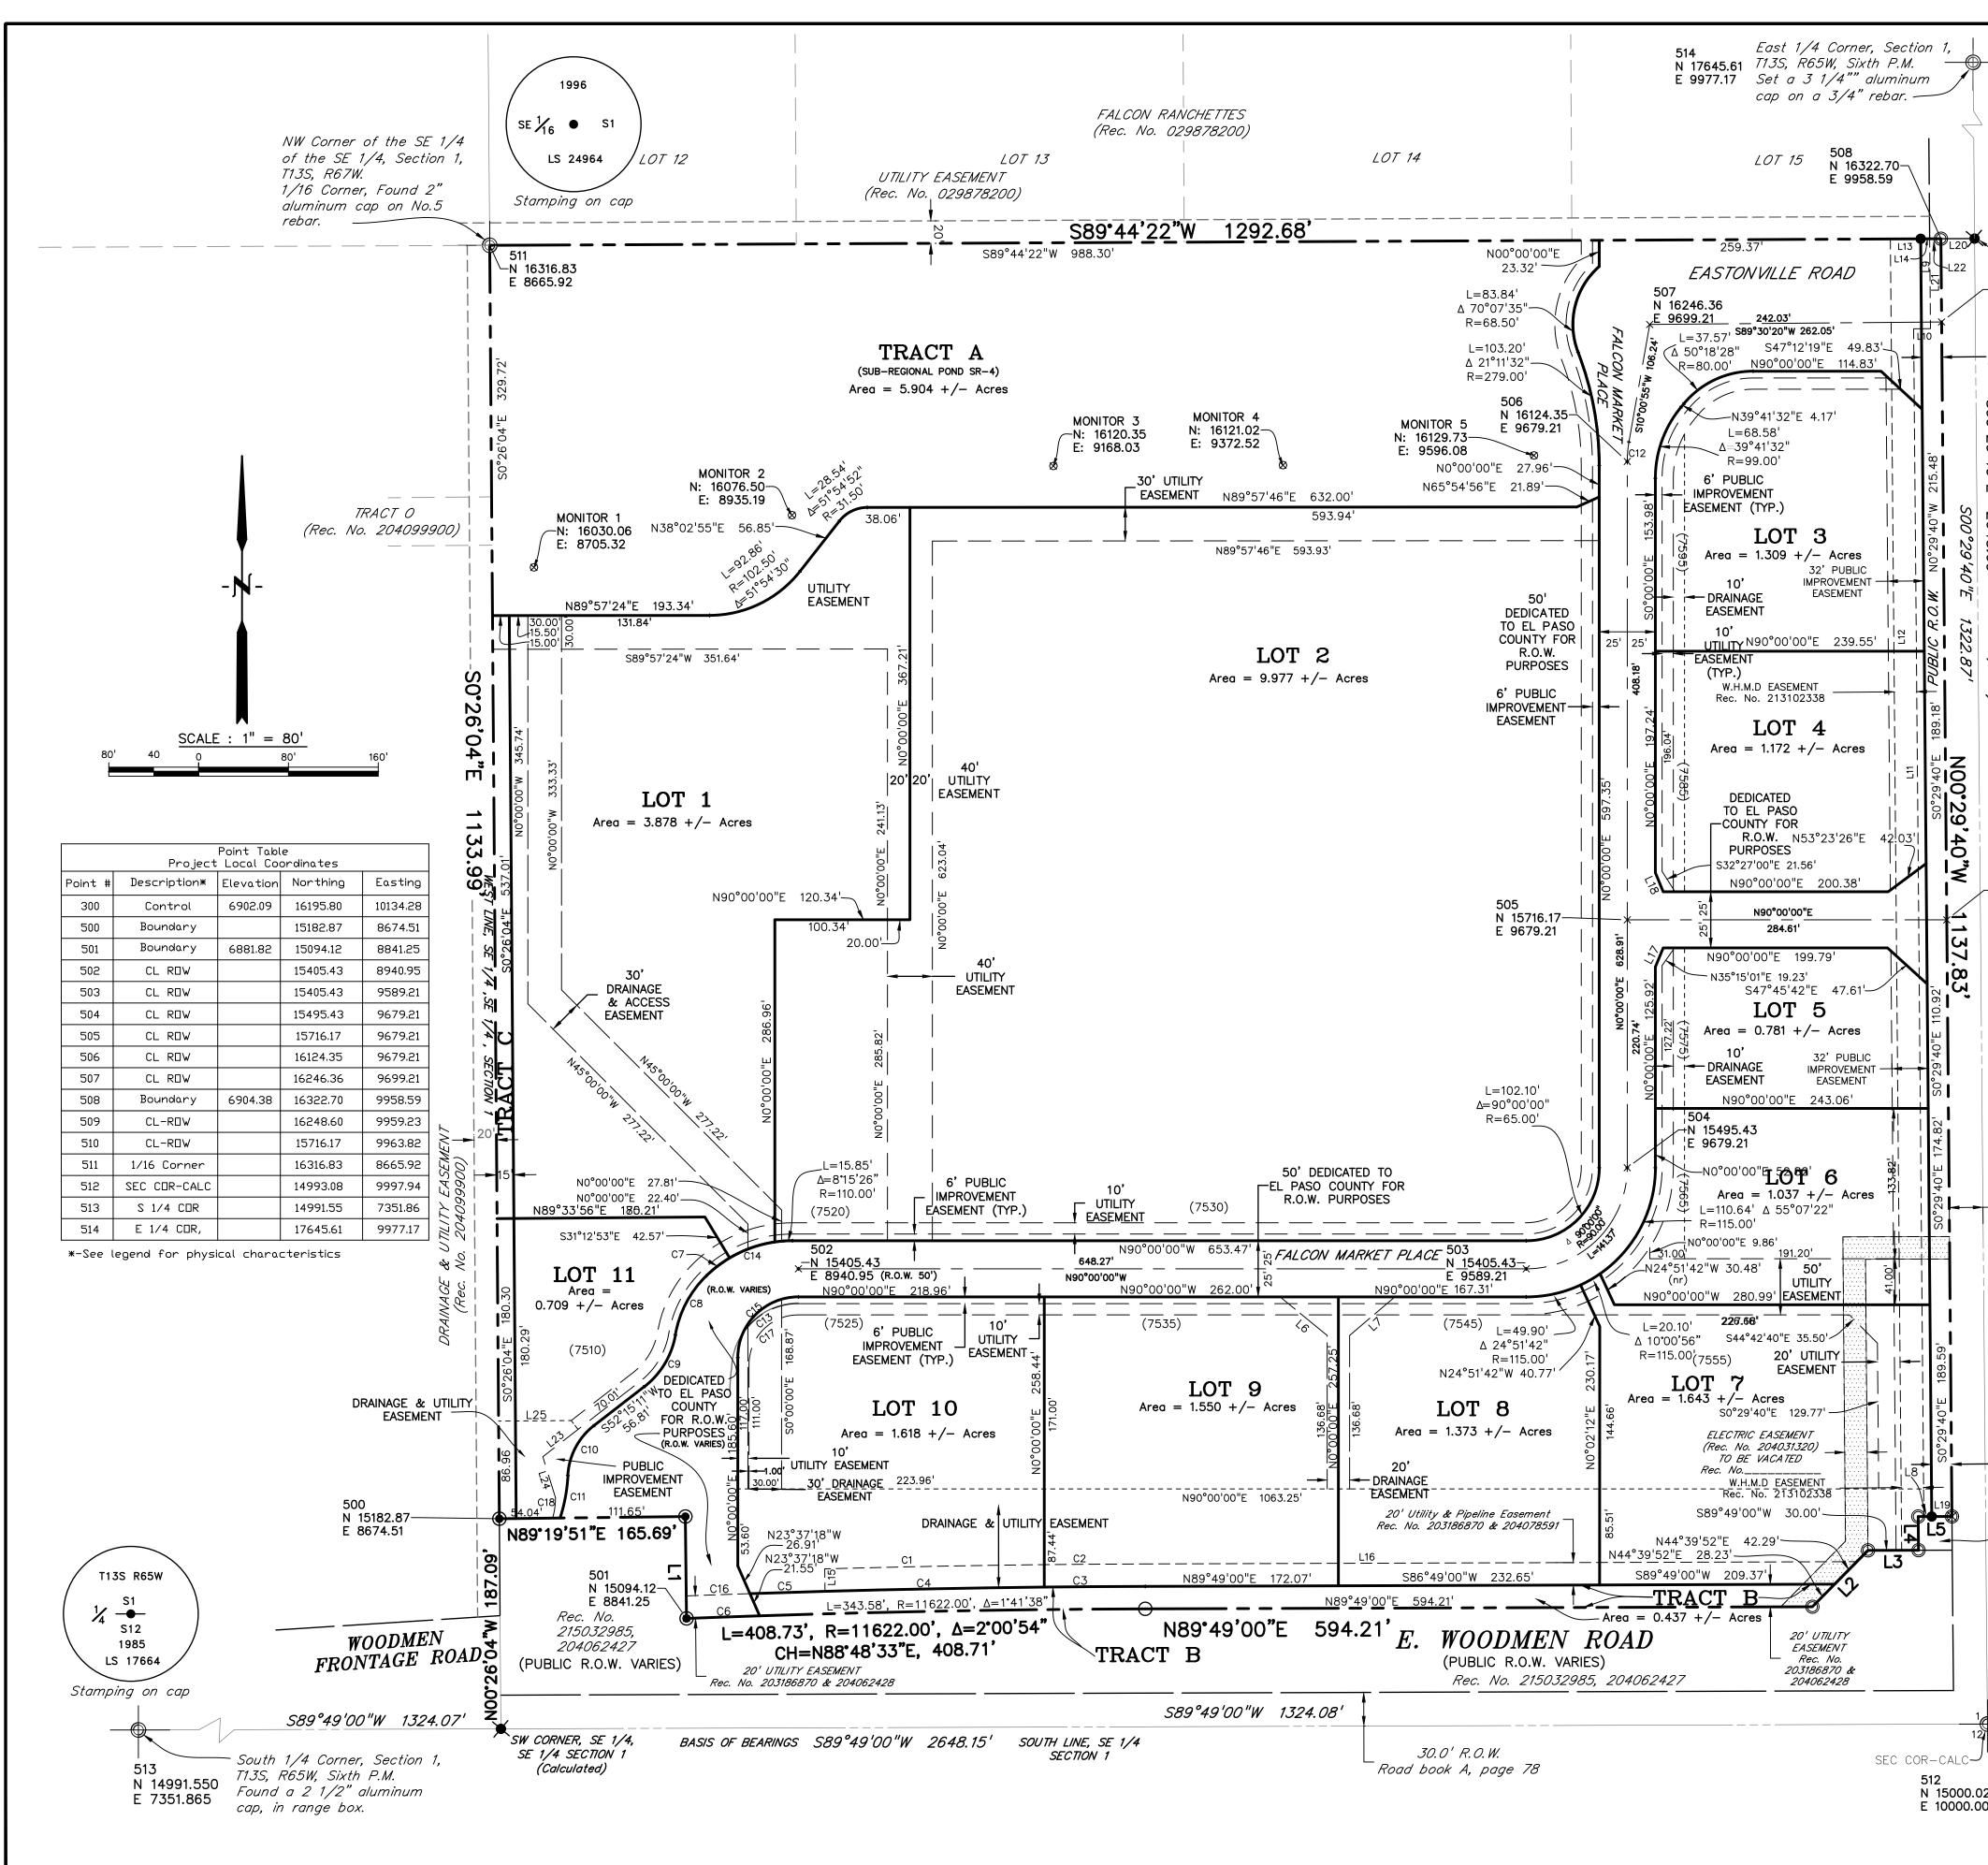
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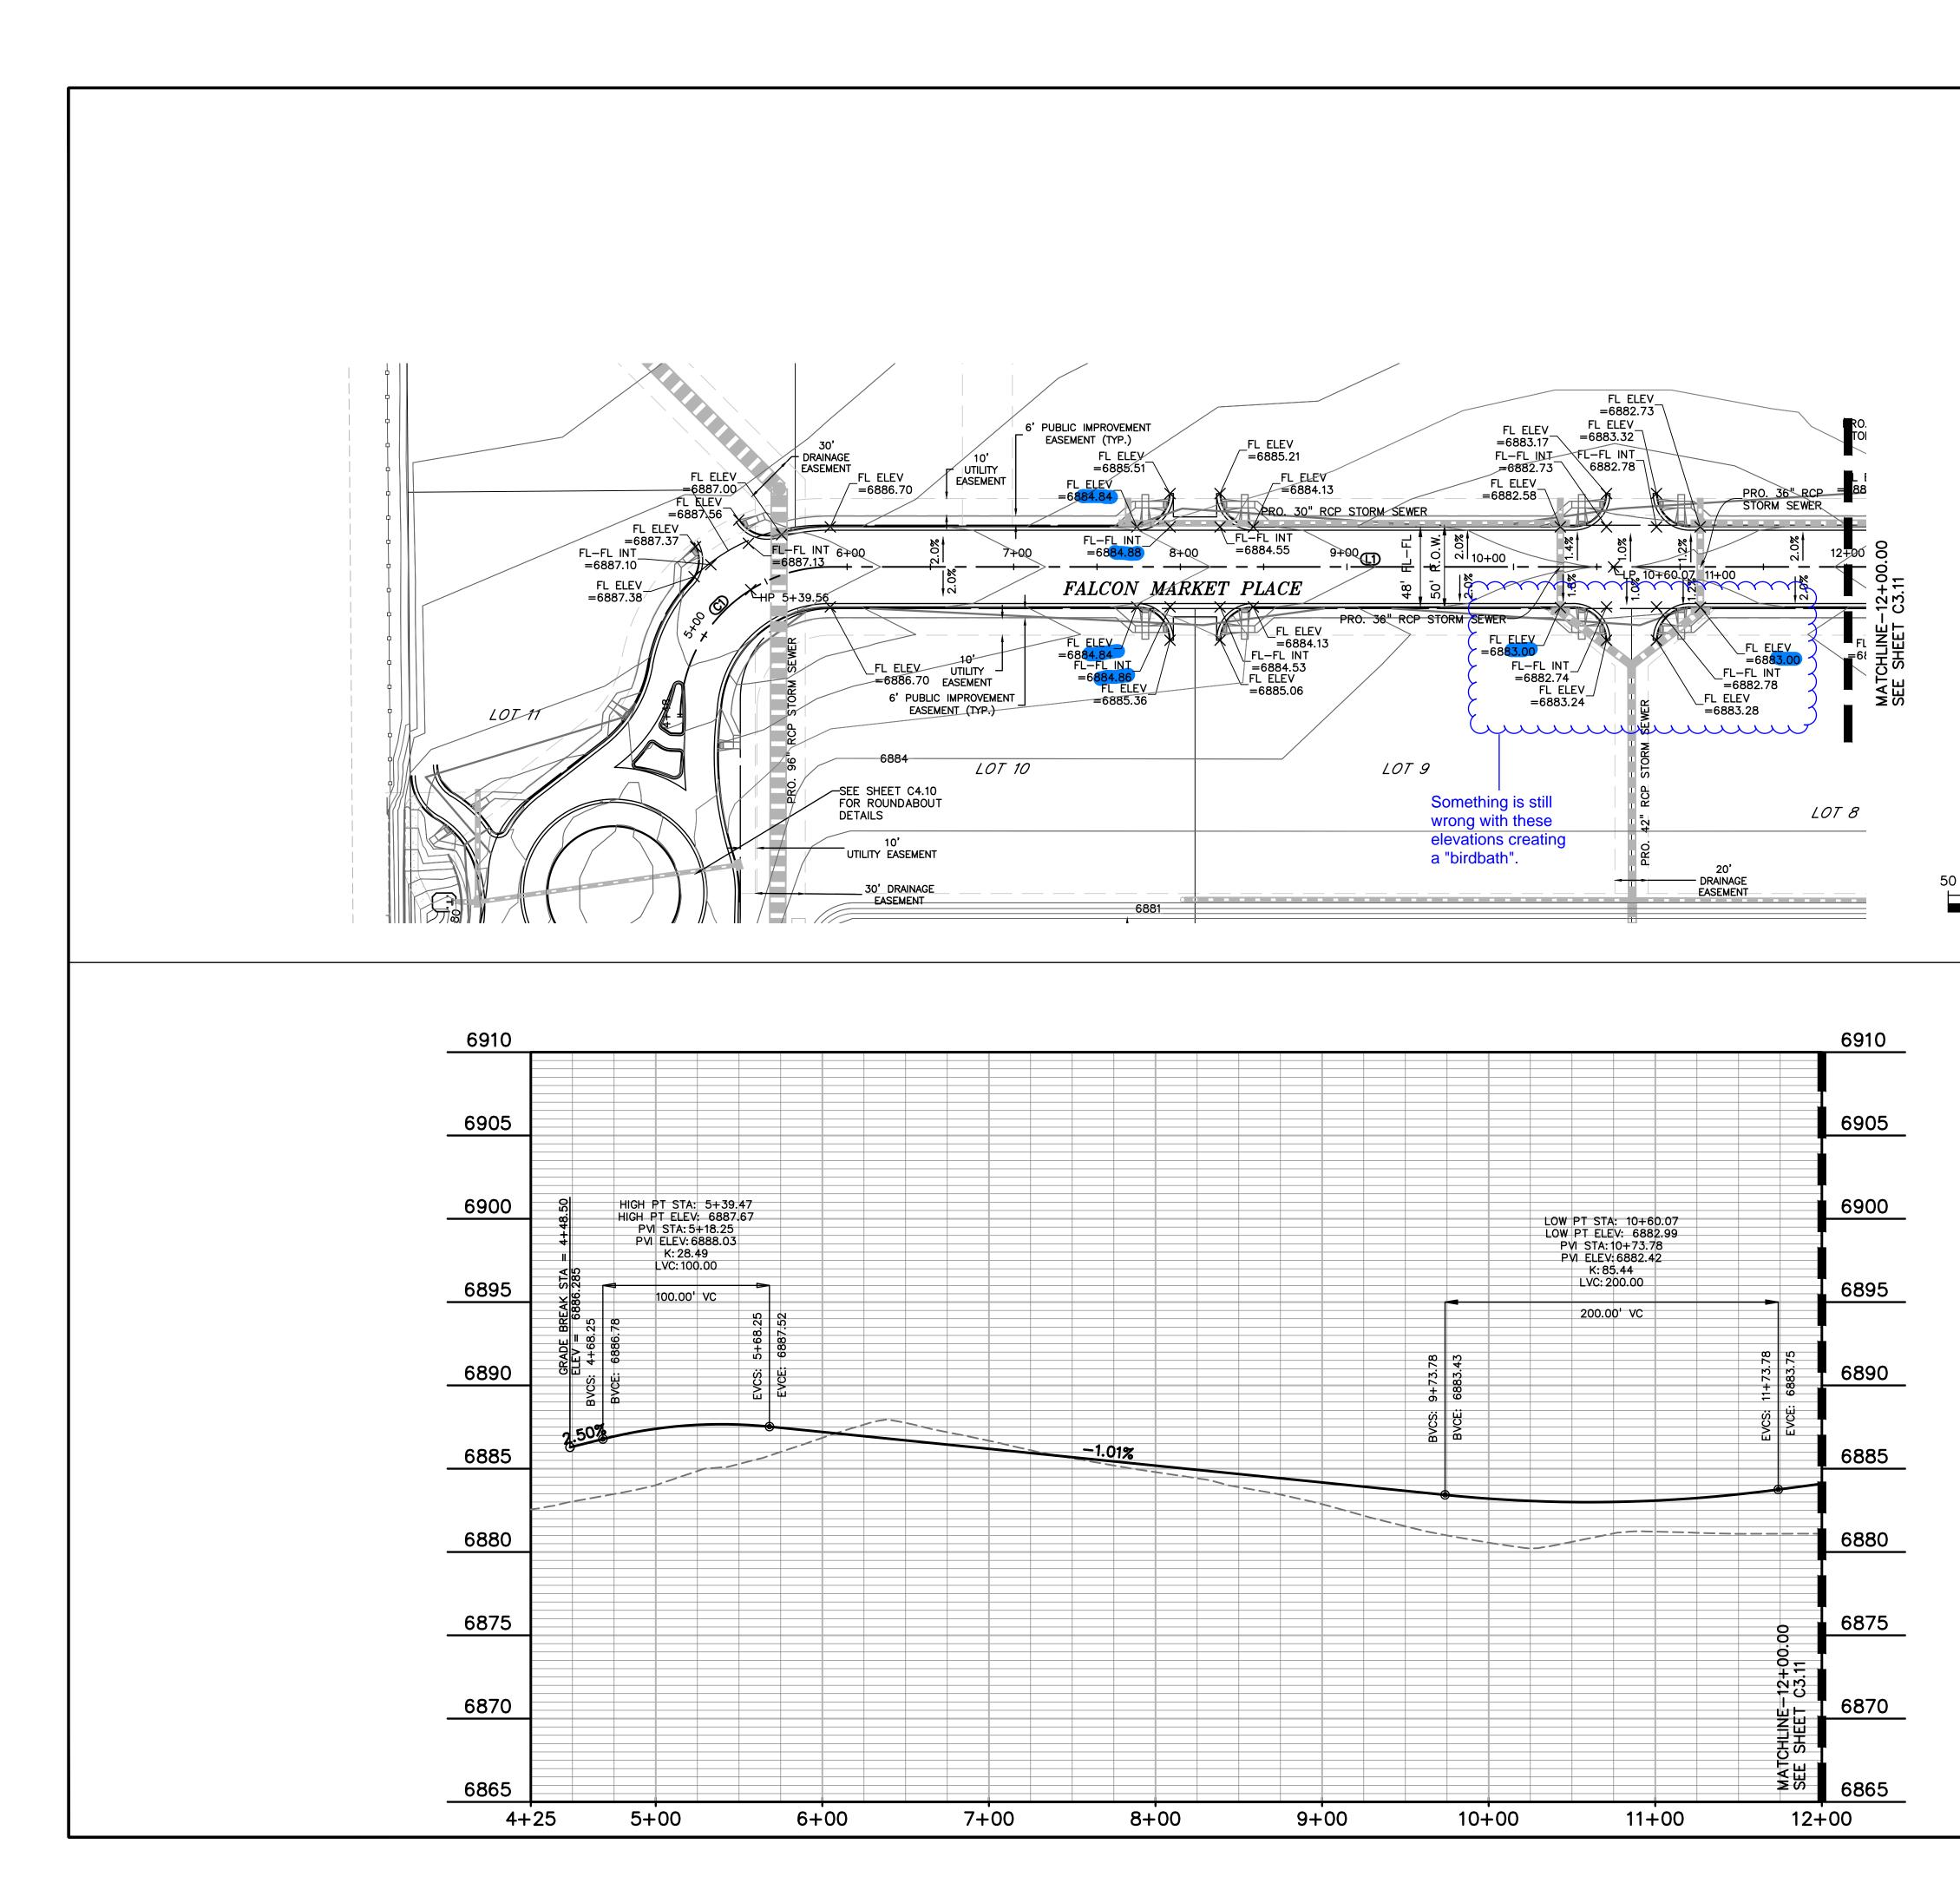



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			COLORADO SPGS, COLORADO 80905
	<u>K</u> E	EY MAP NTS	(719)260-0887
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	MAIN		HUMMEL INVESTMENTS, LLC
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EL PASO COUNTY FILE # <u>SF-19-001</u> SHEET: 8 OF 39		ROCK SOCKSRS	
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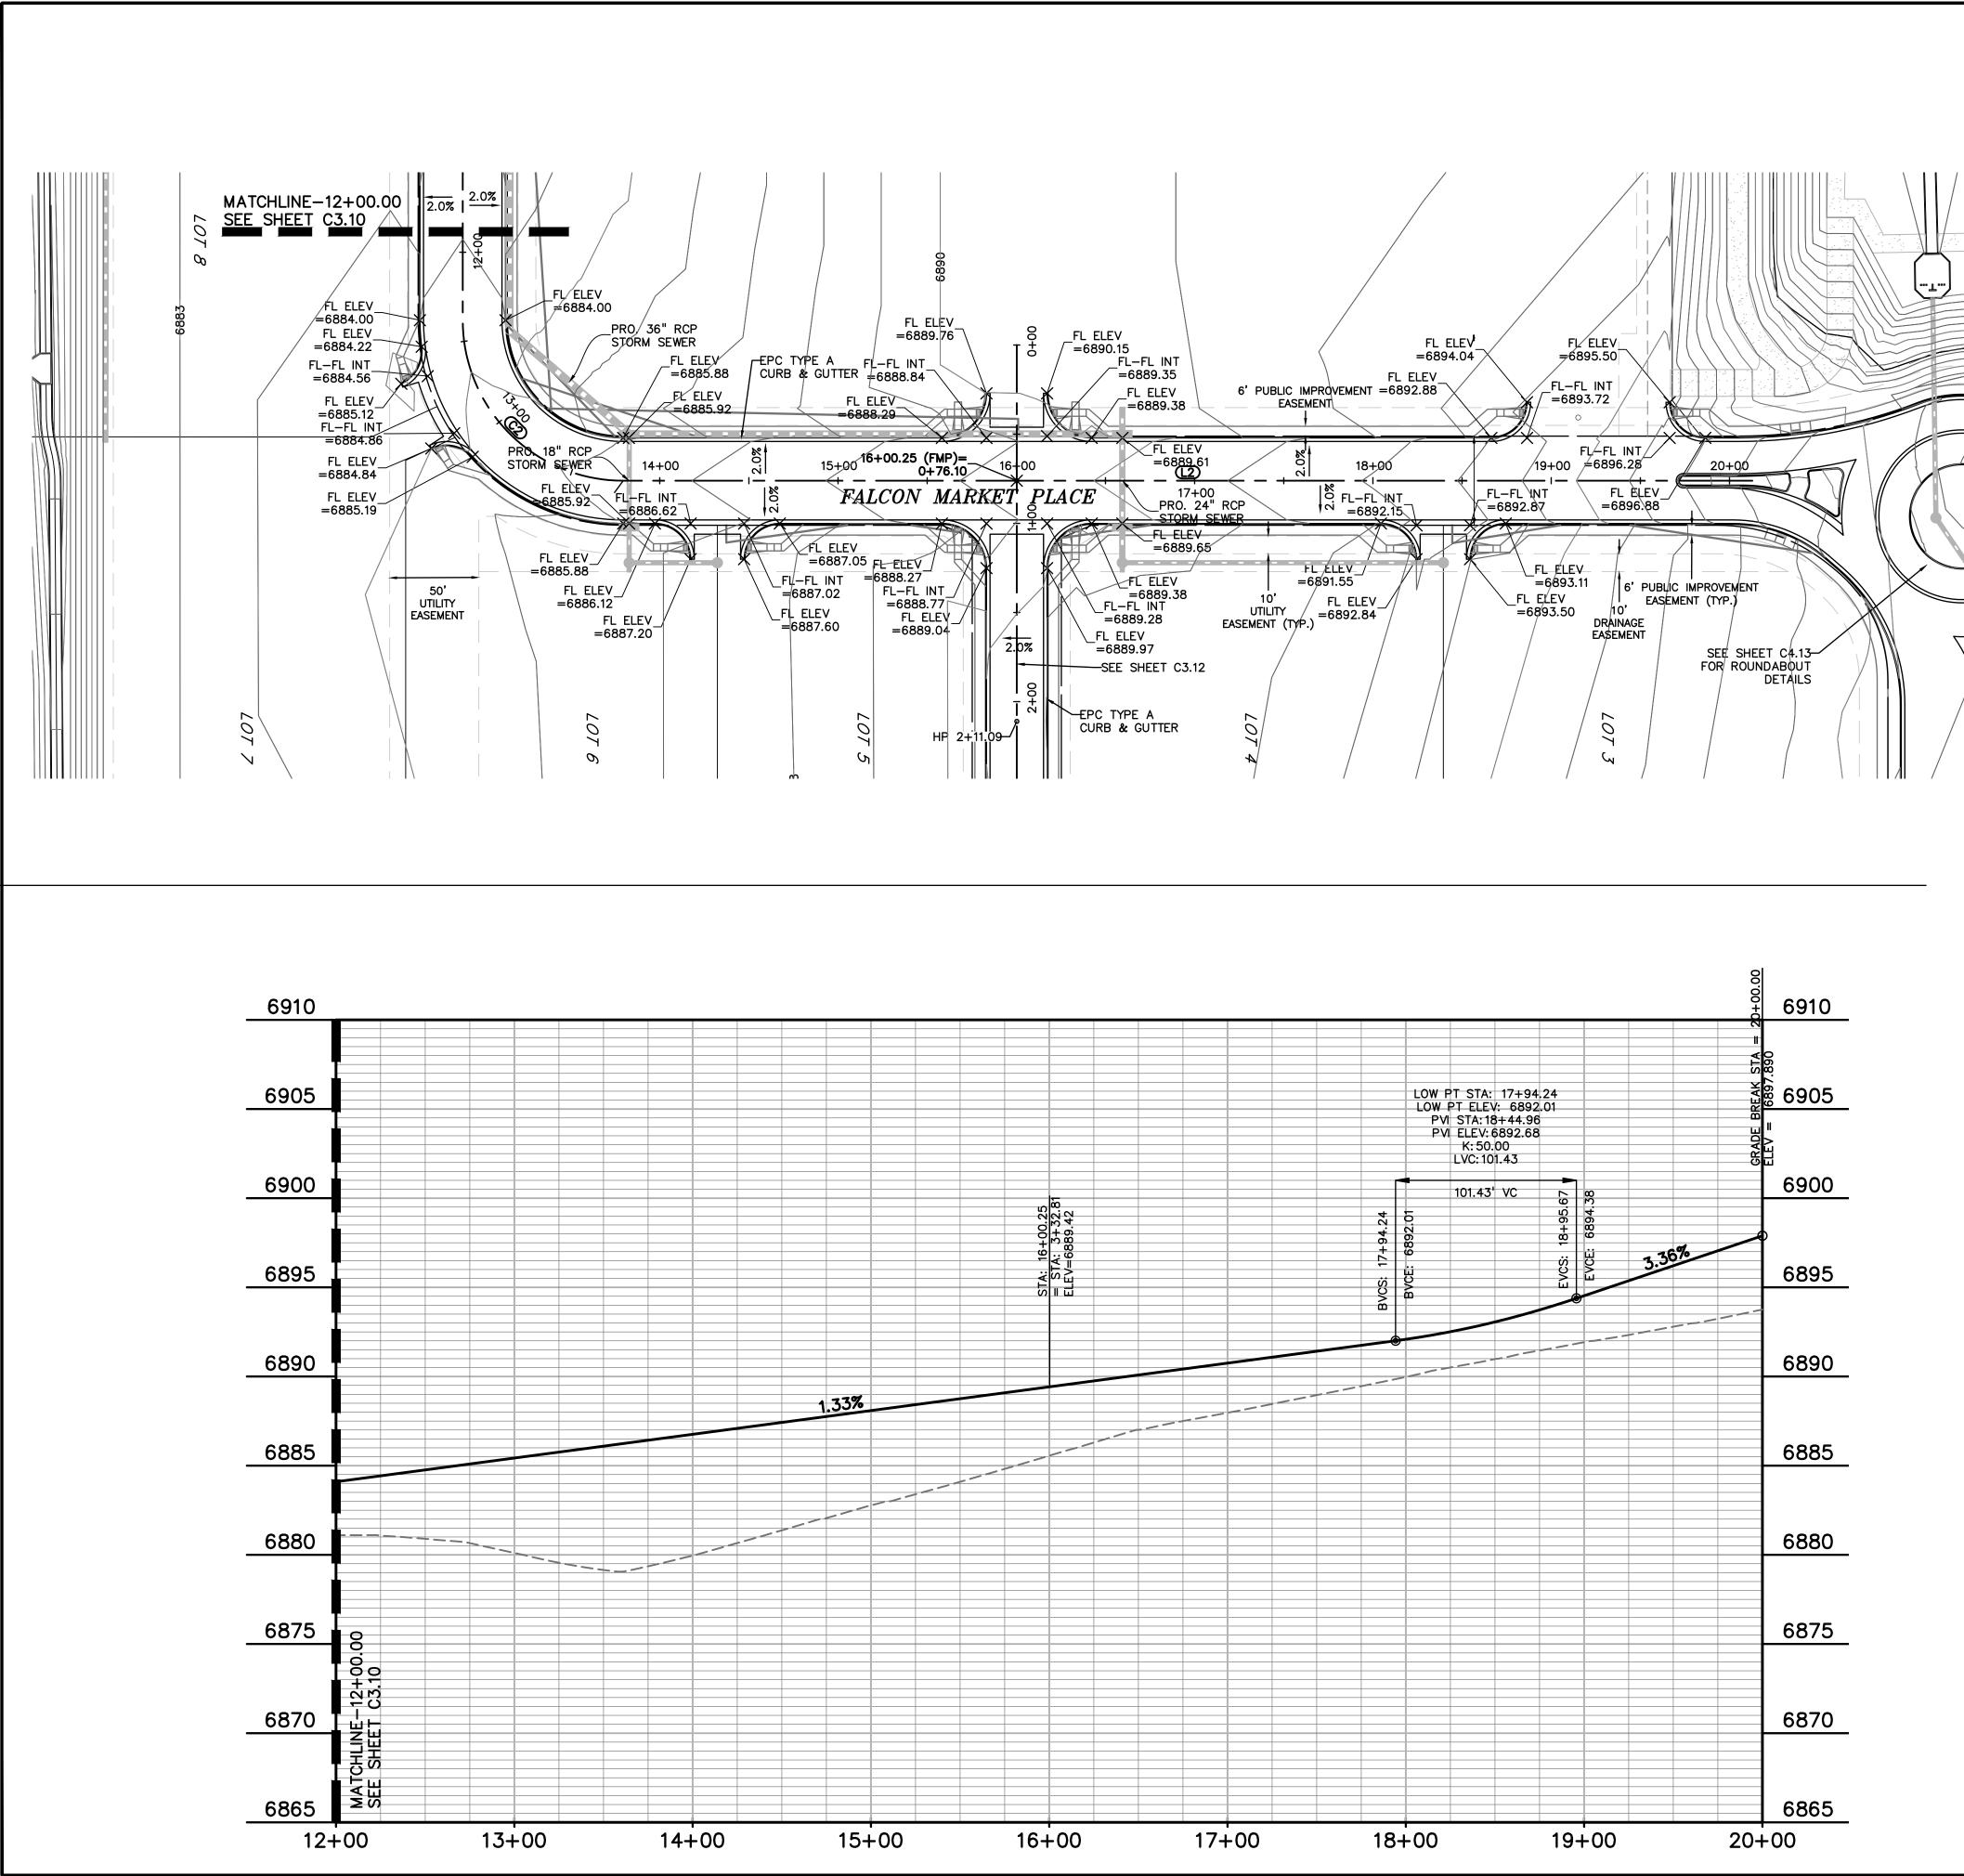




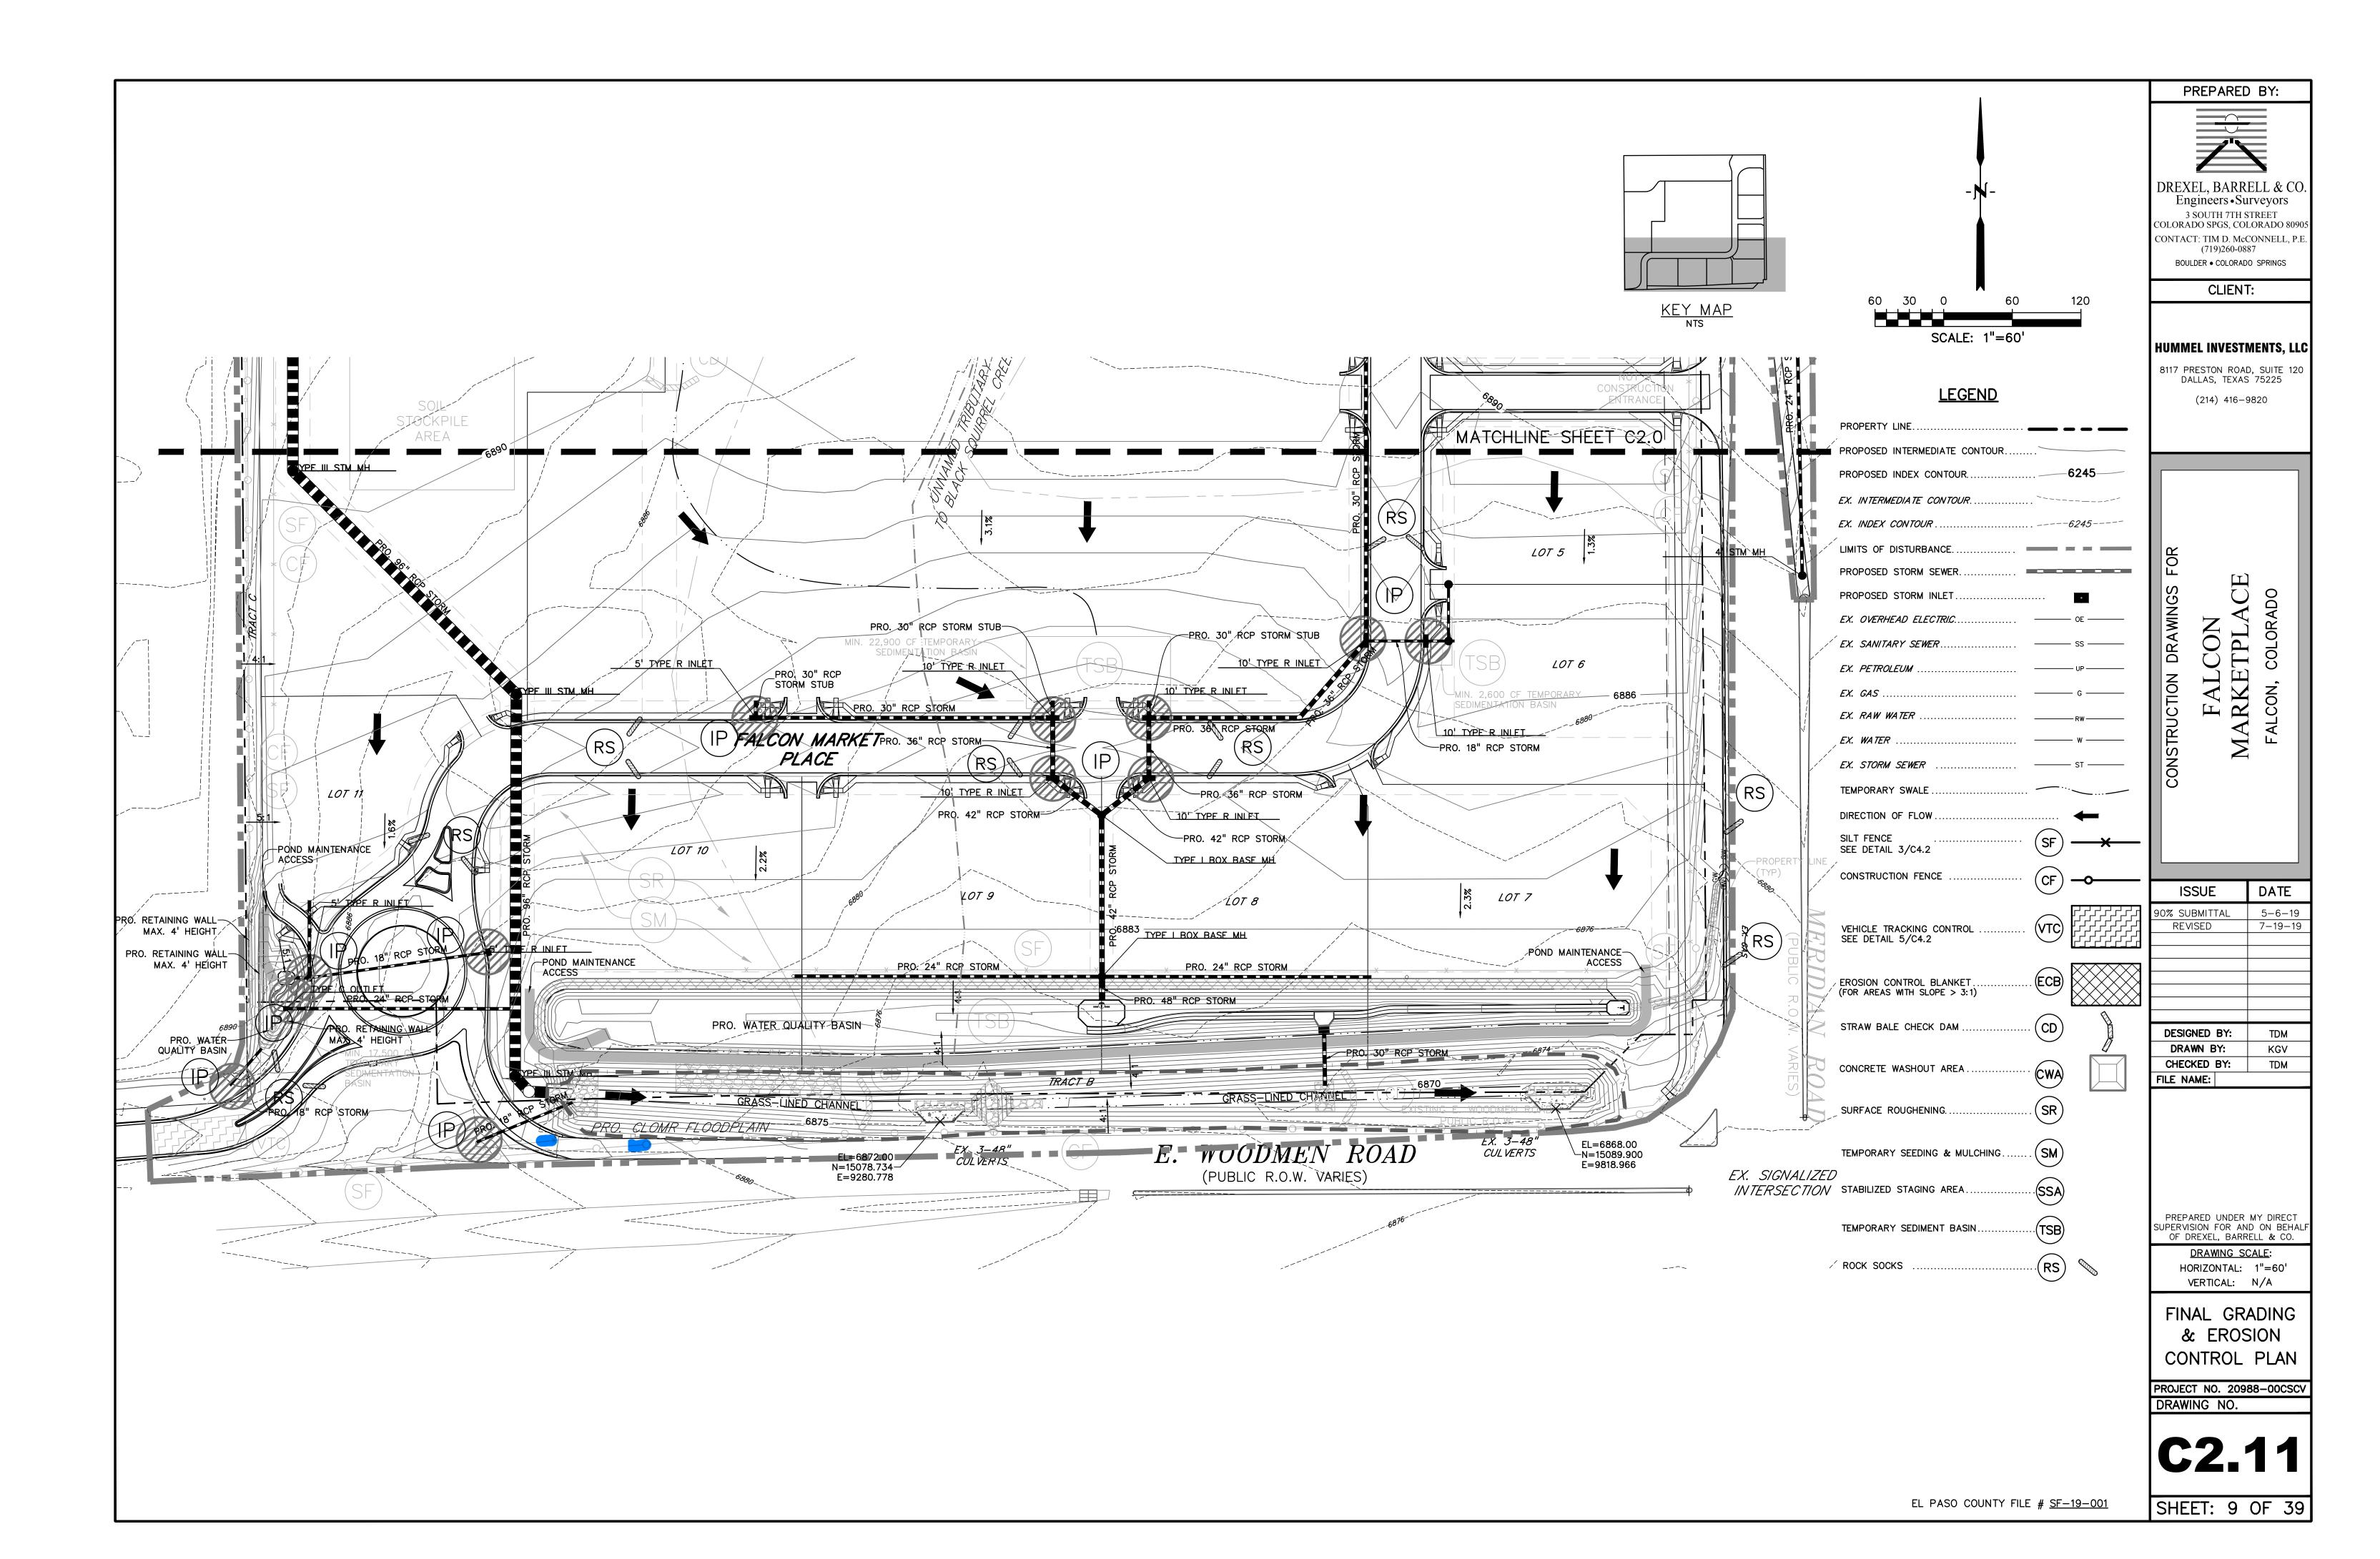

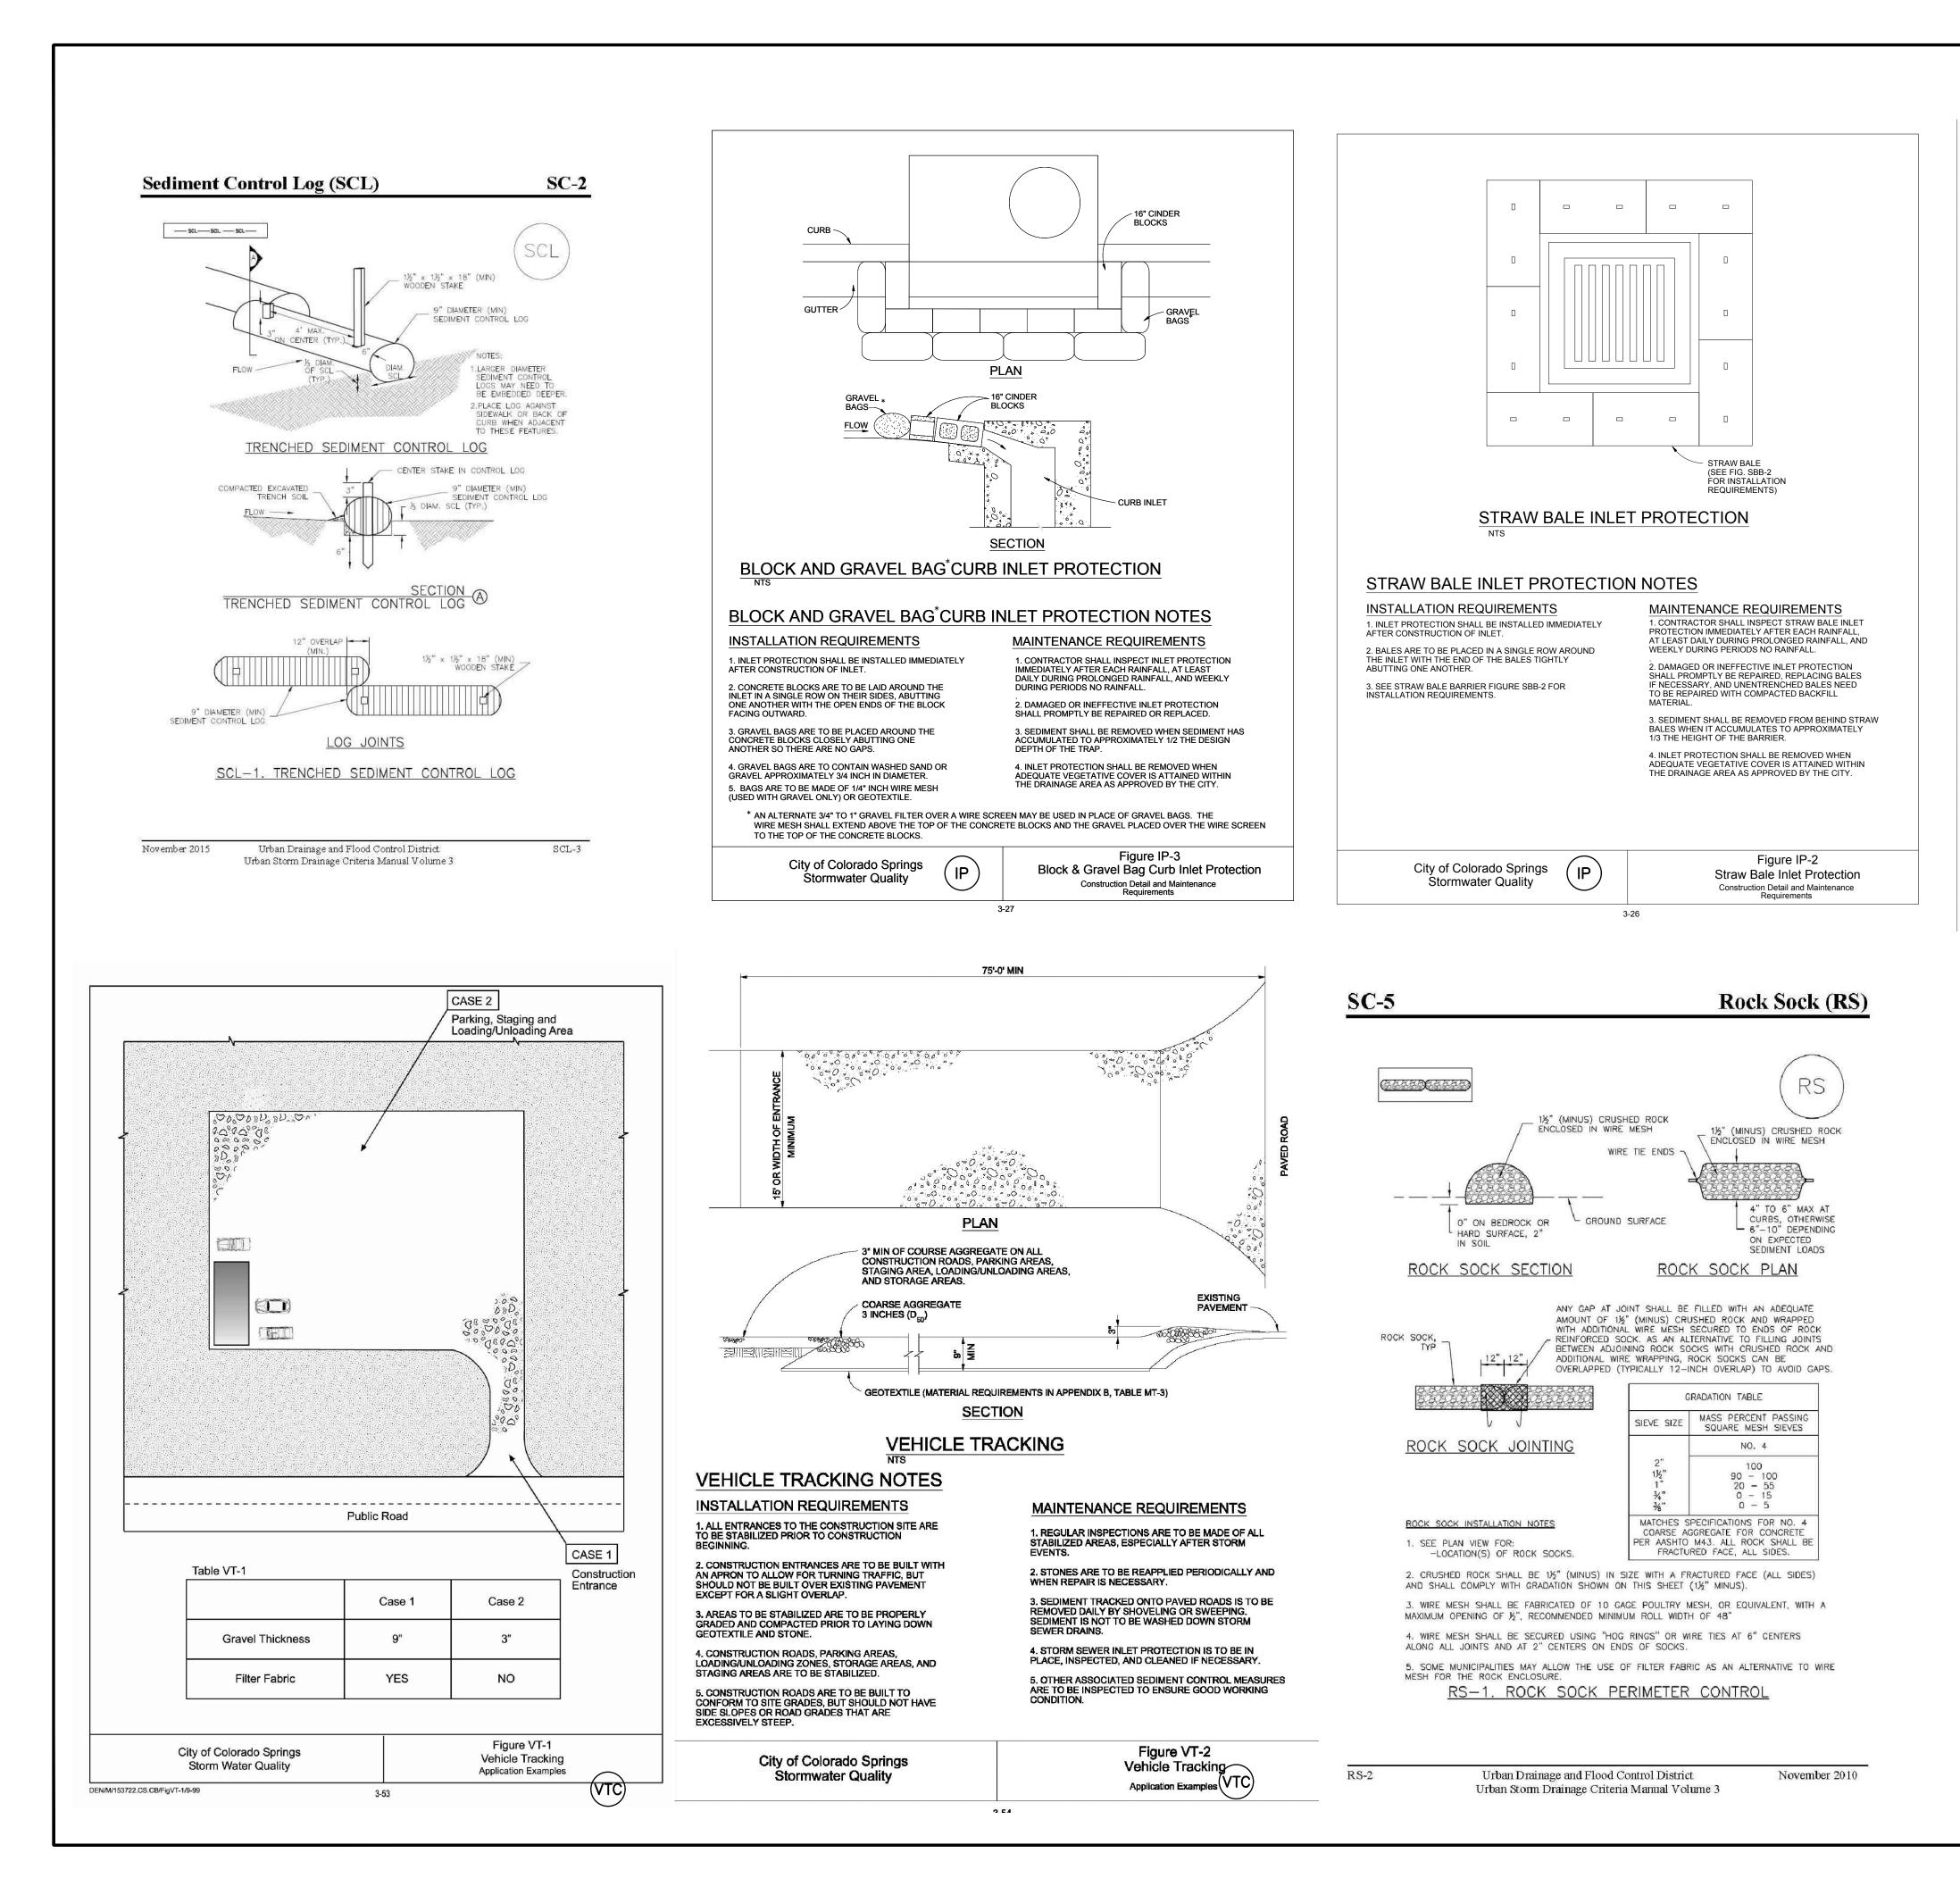


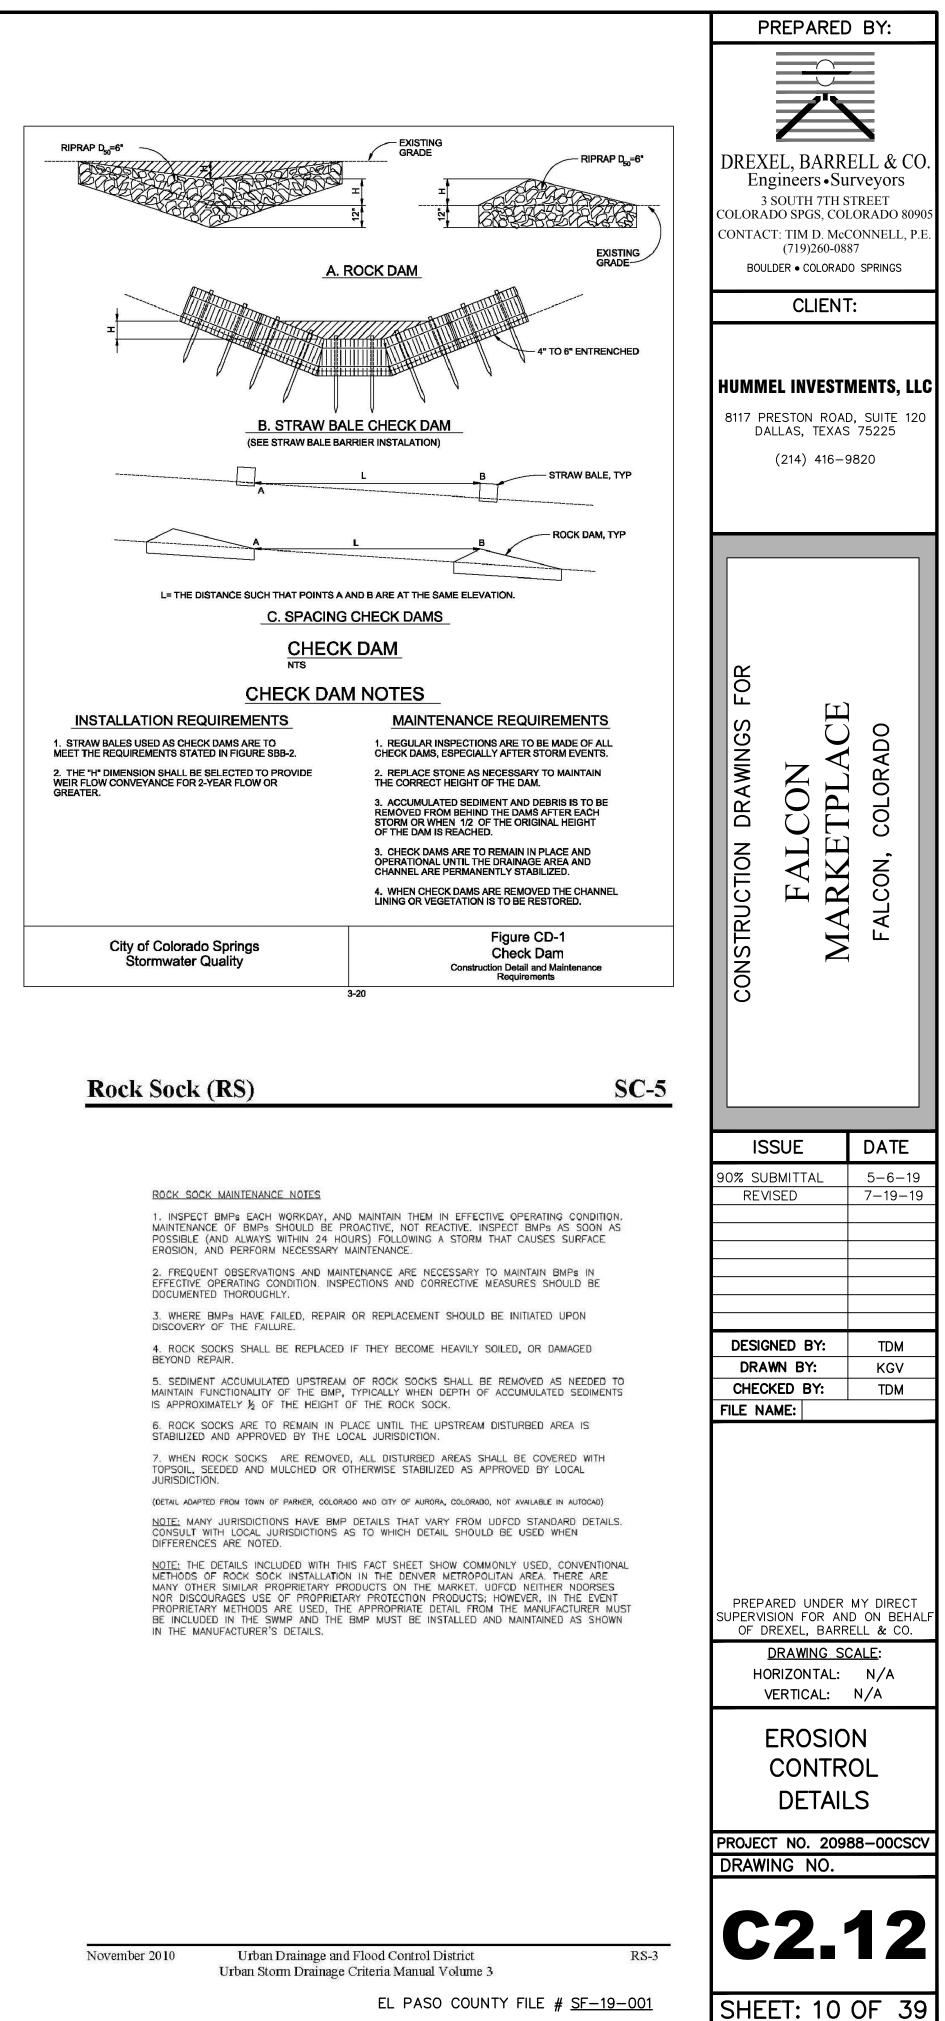


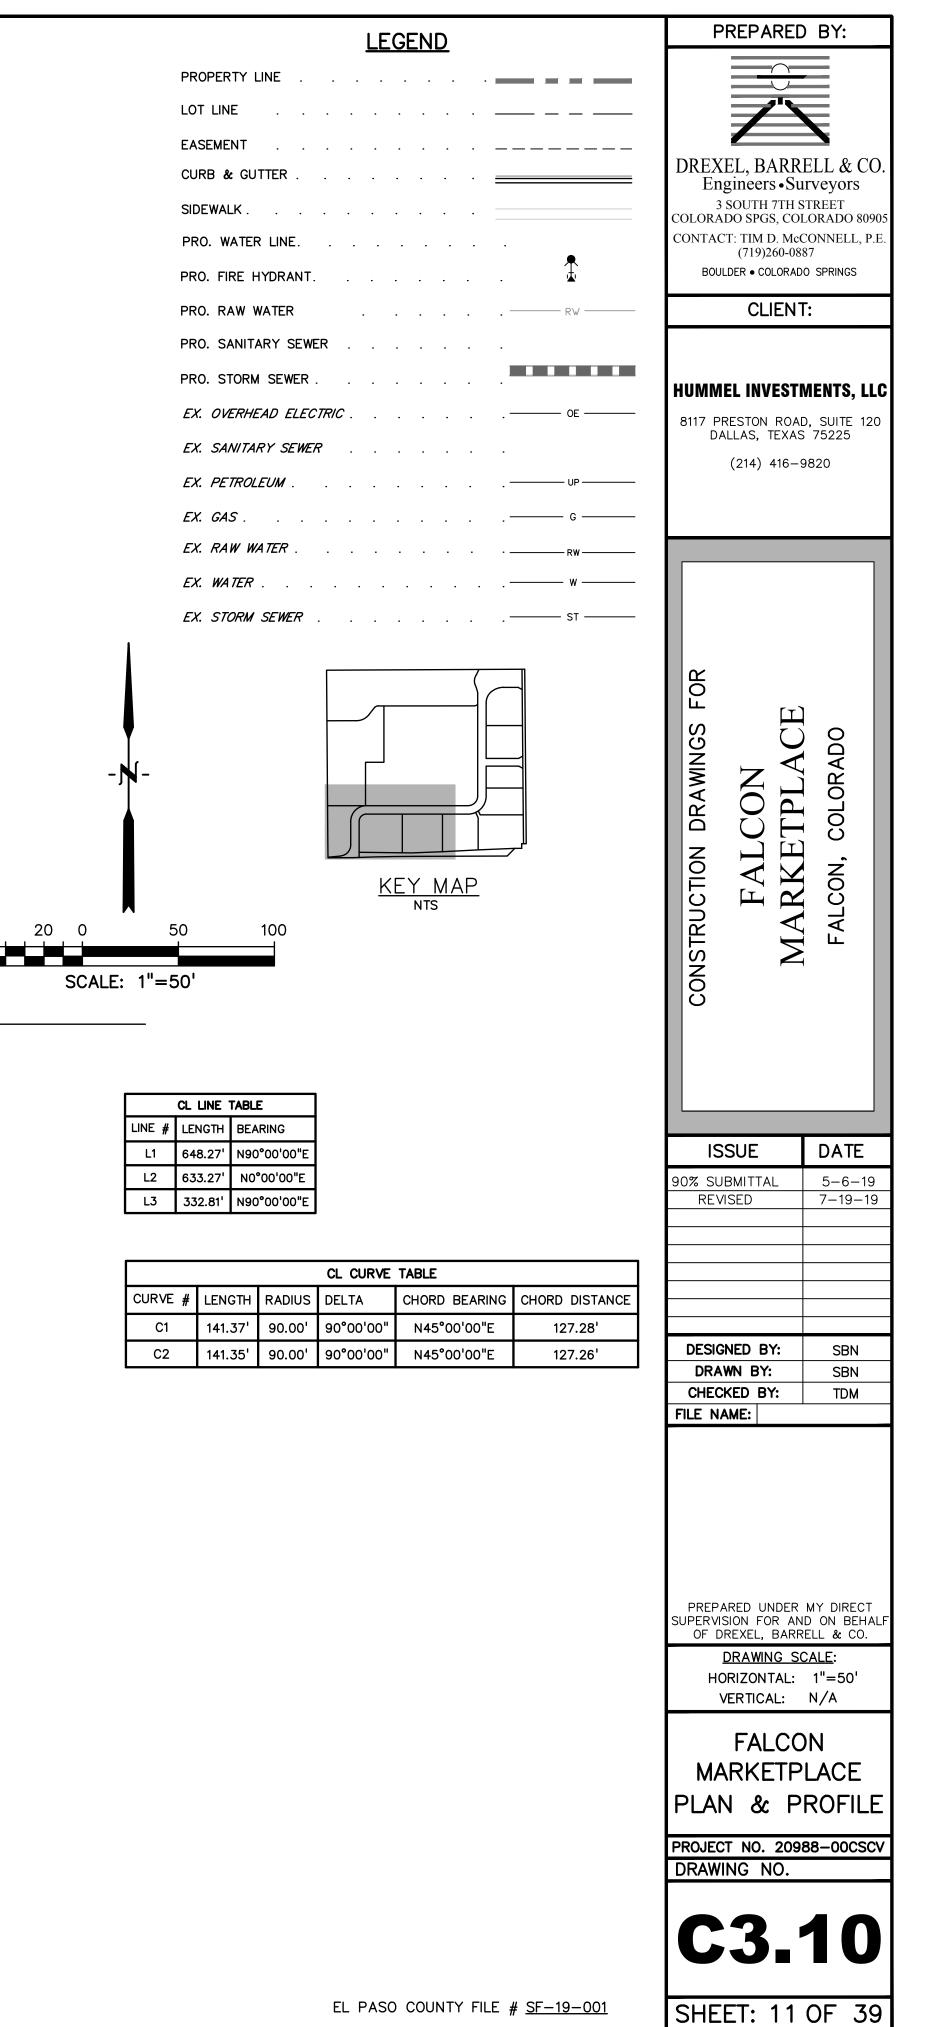


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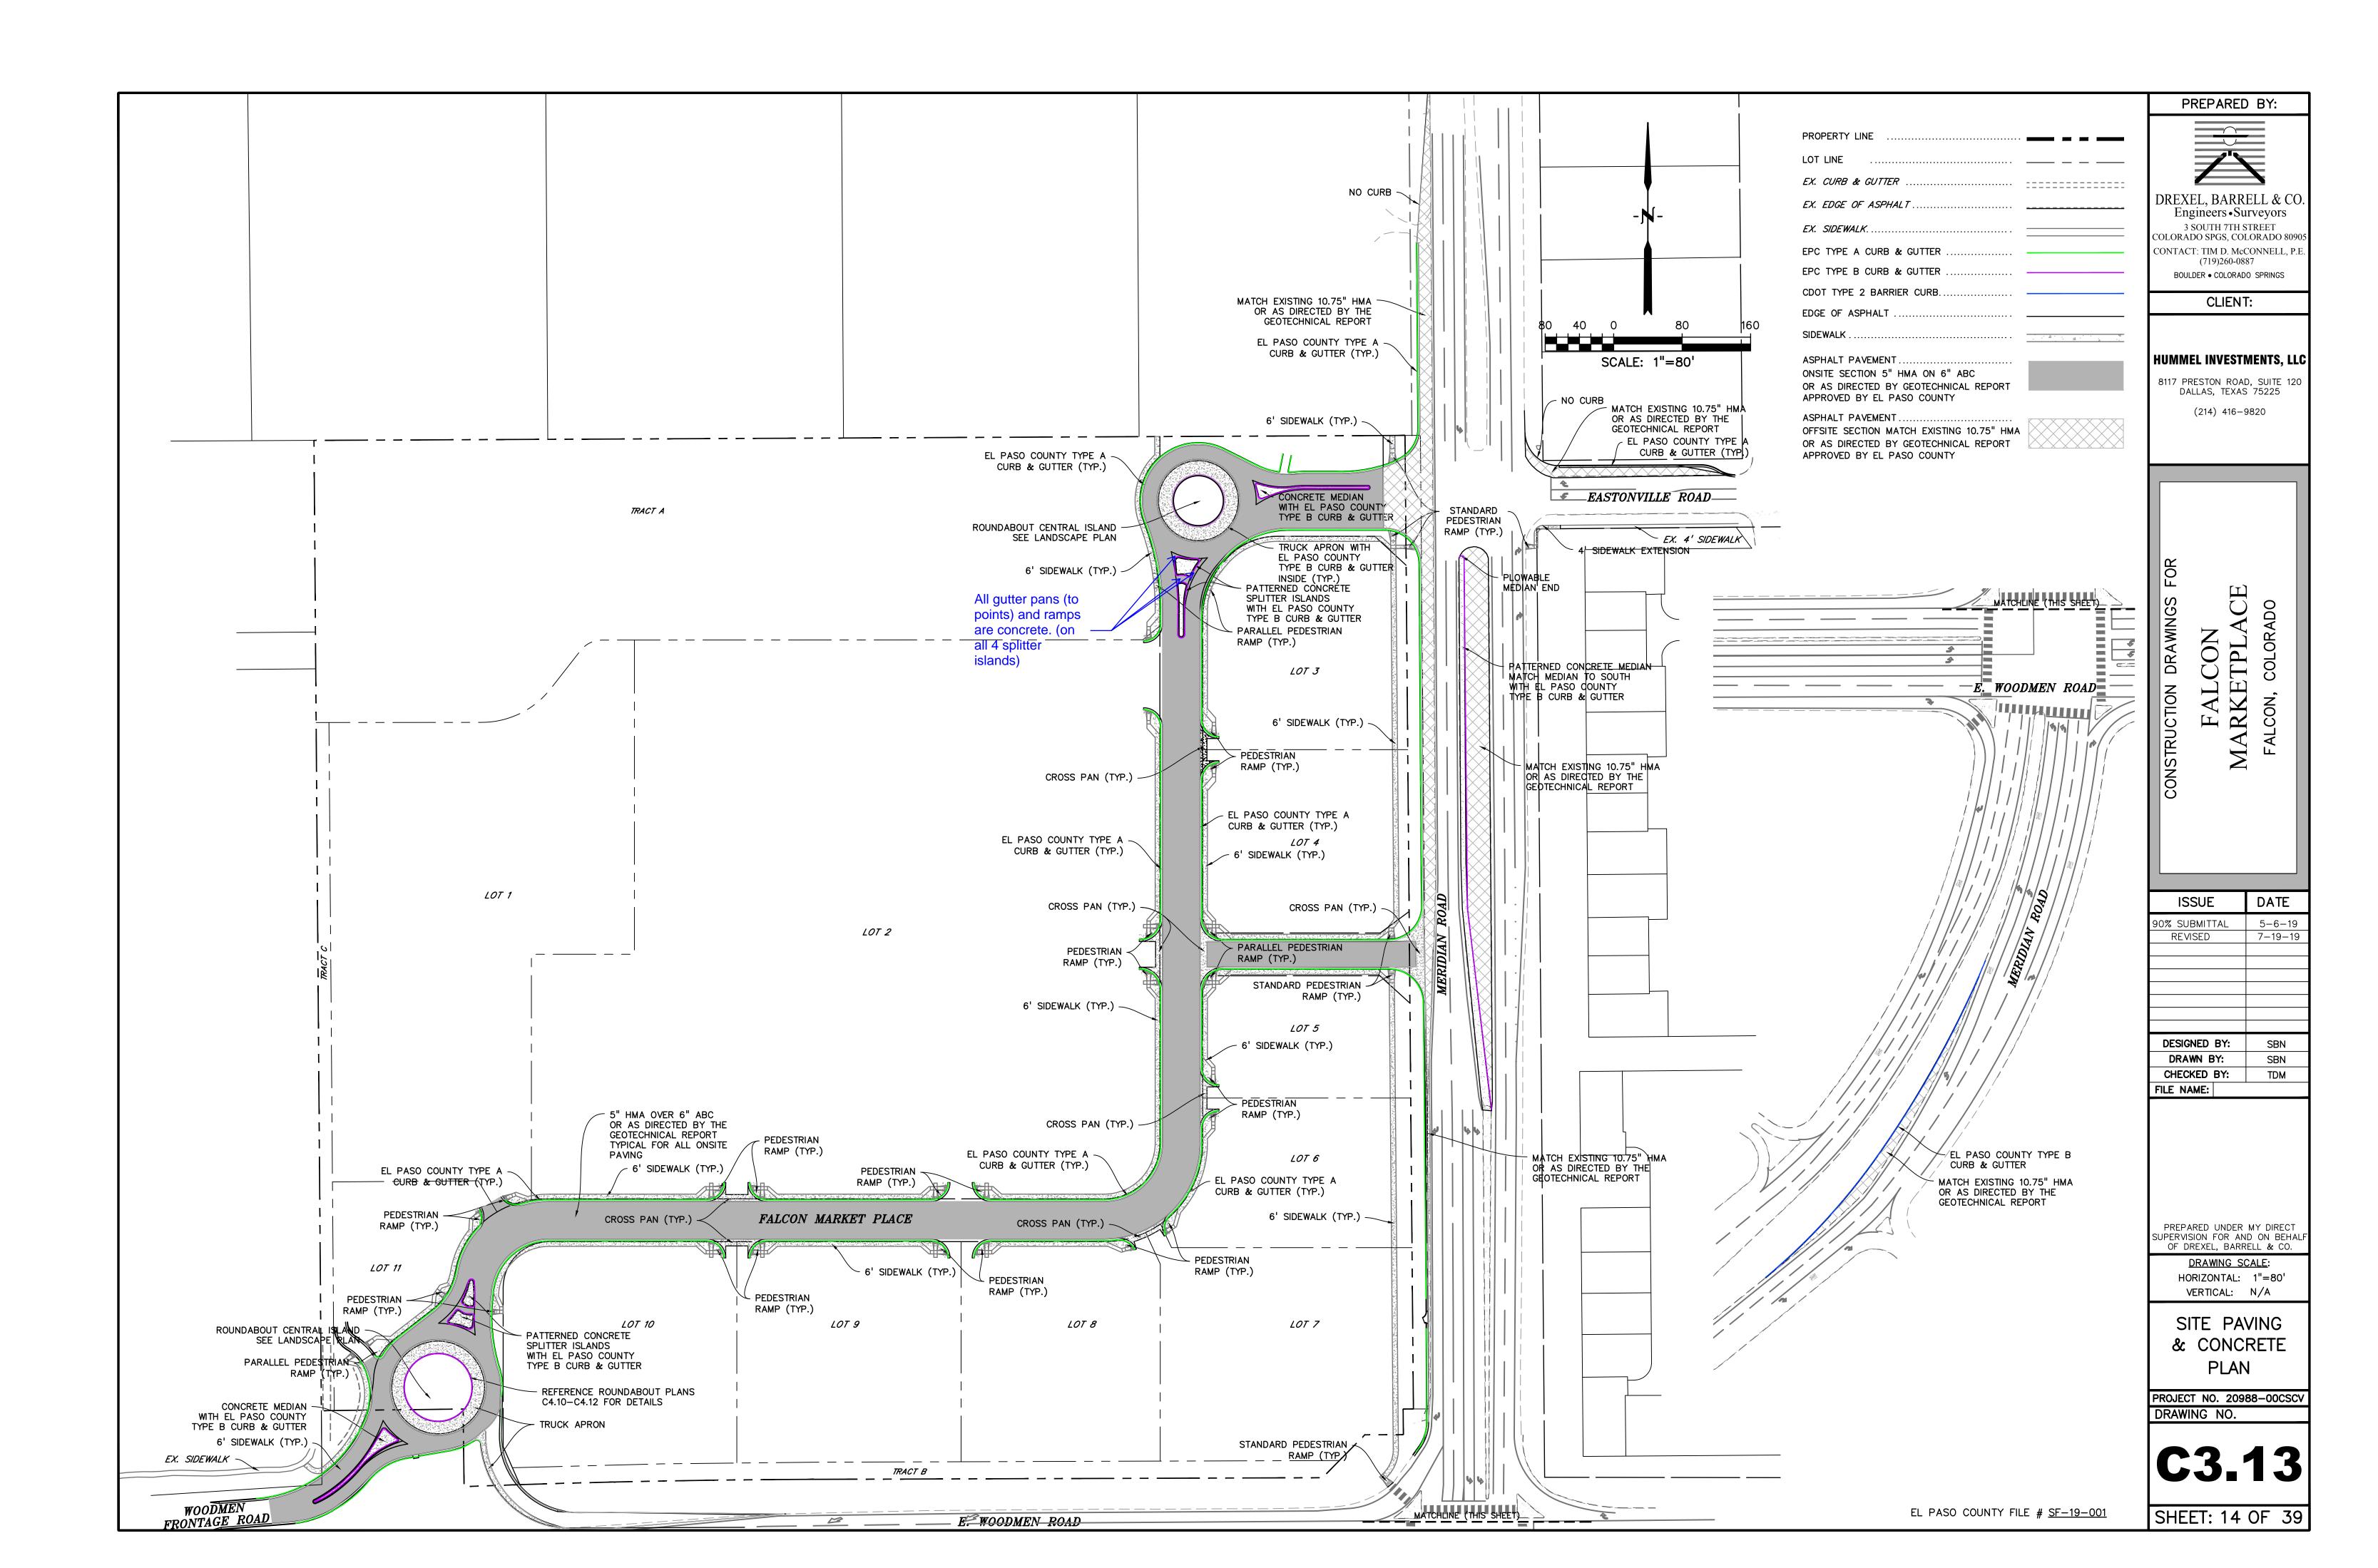





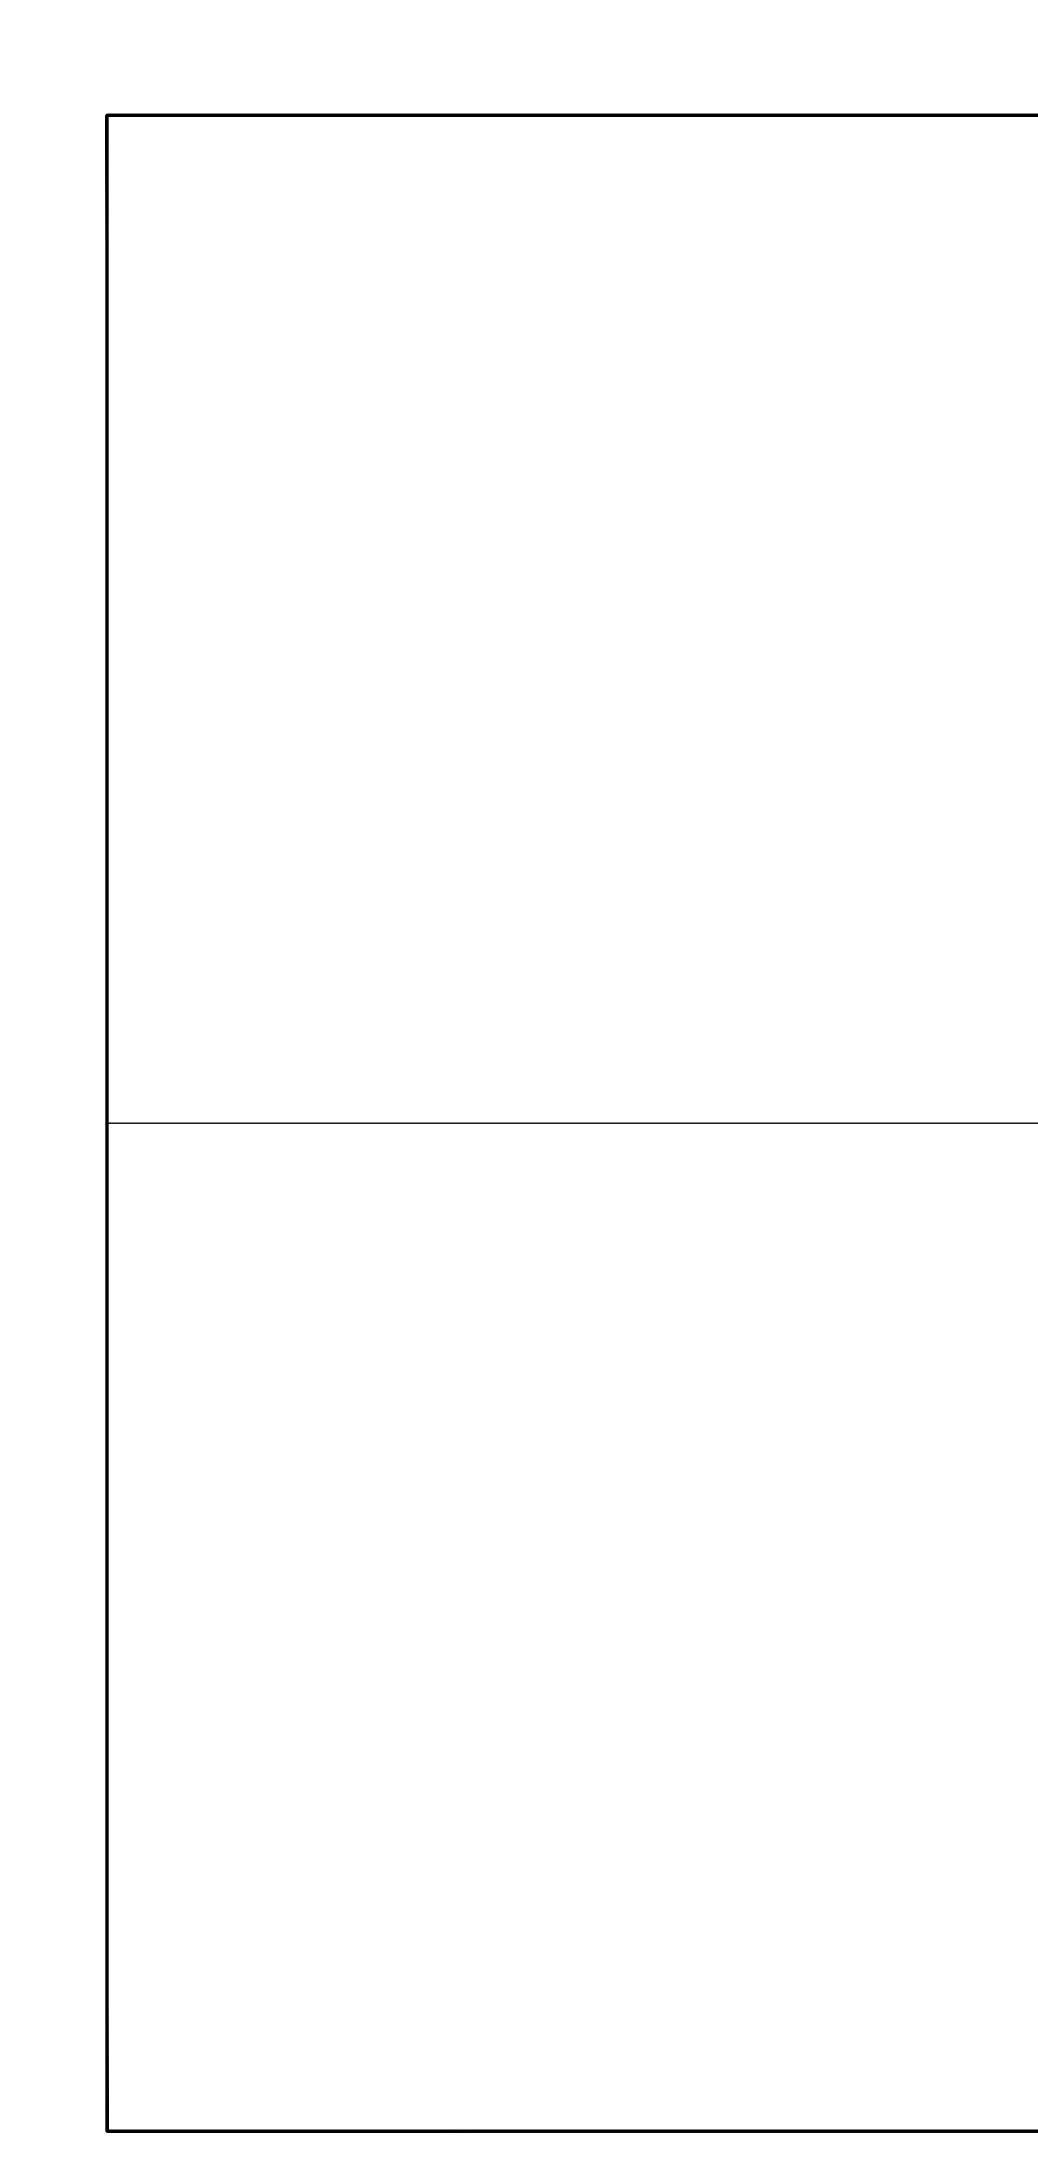

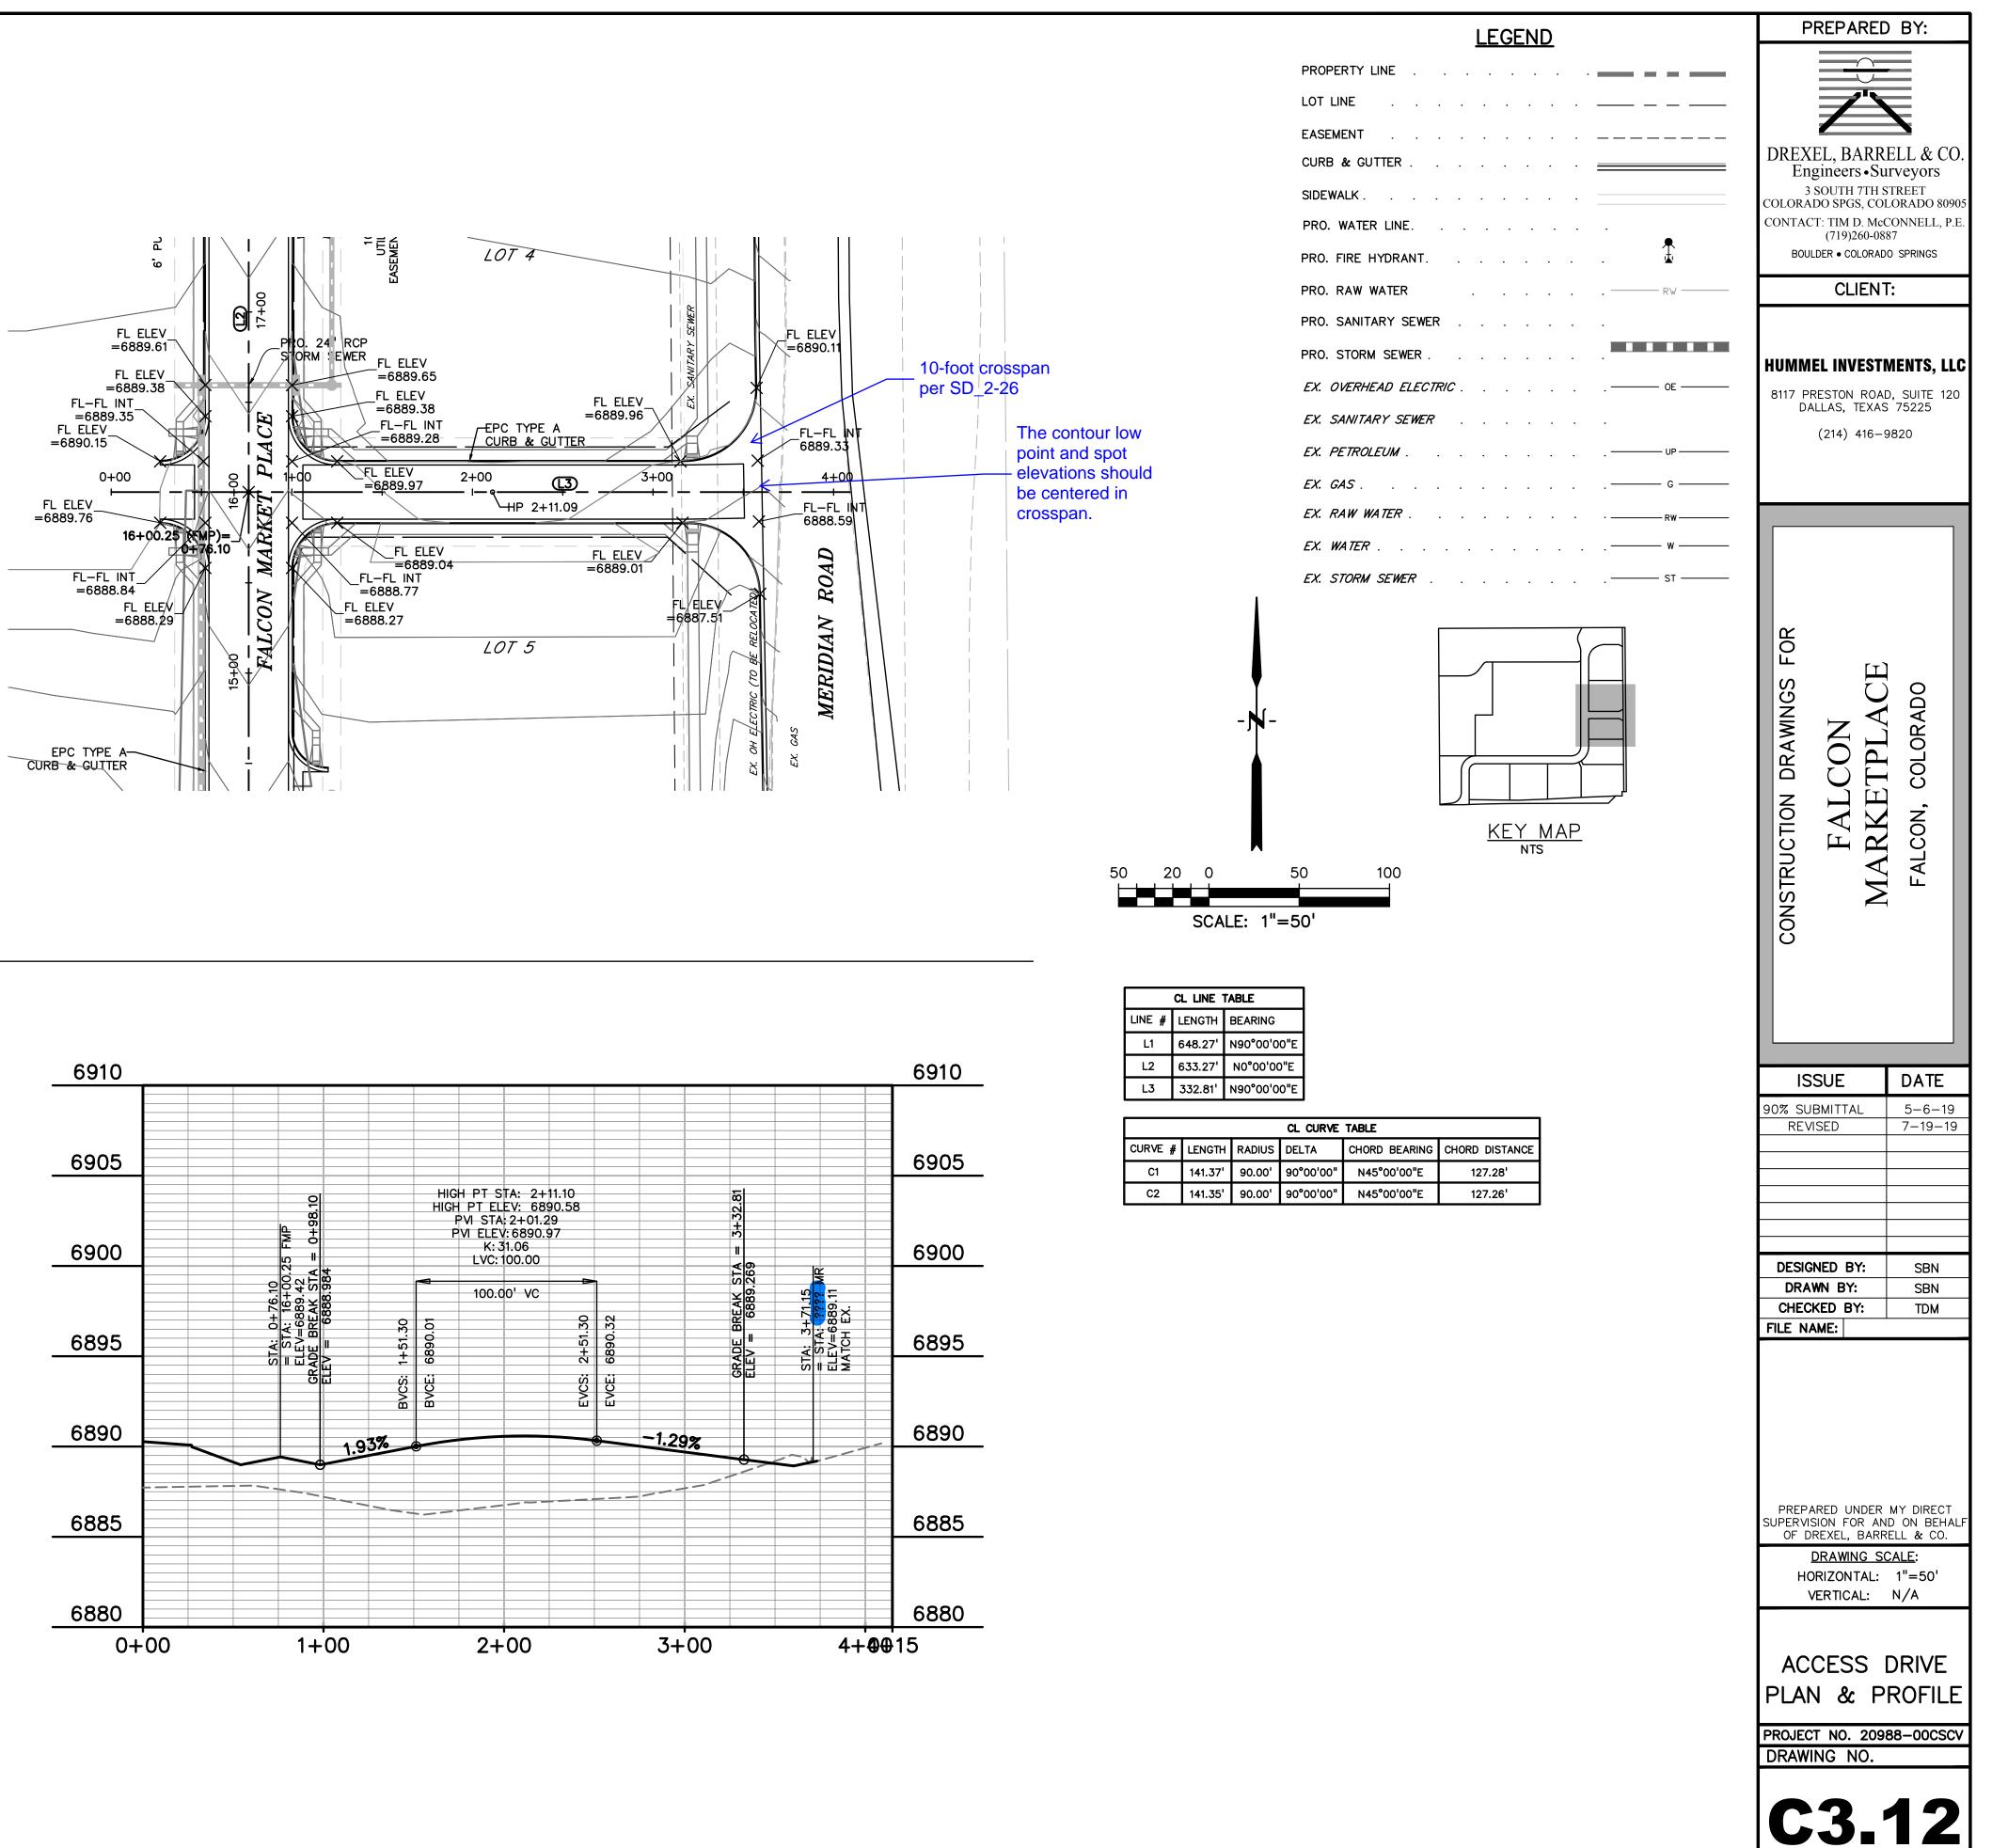
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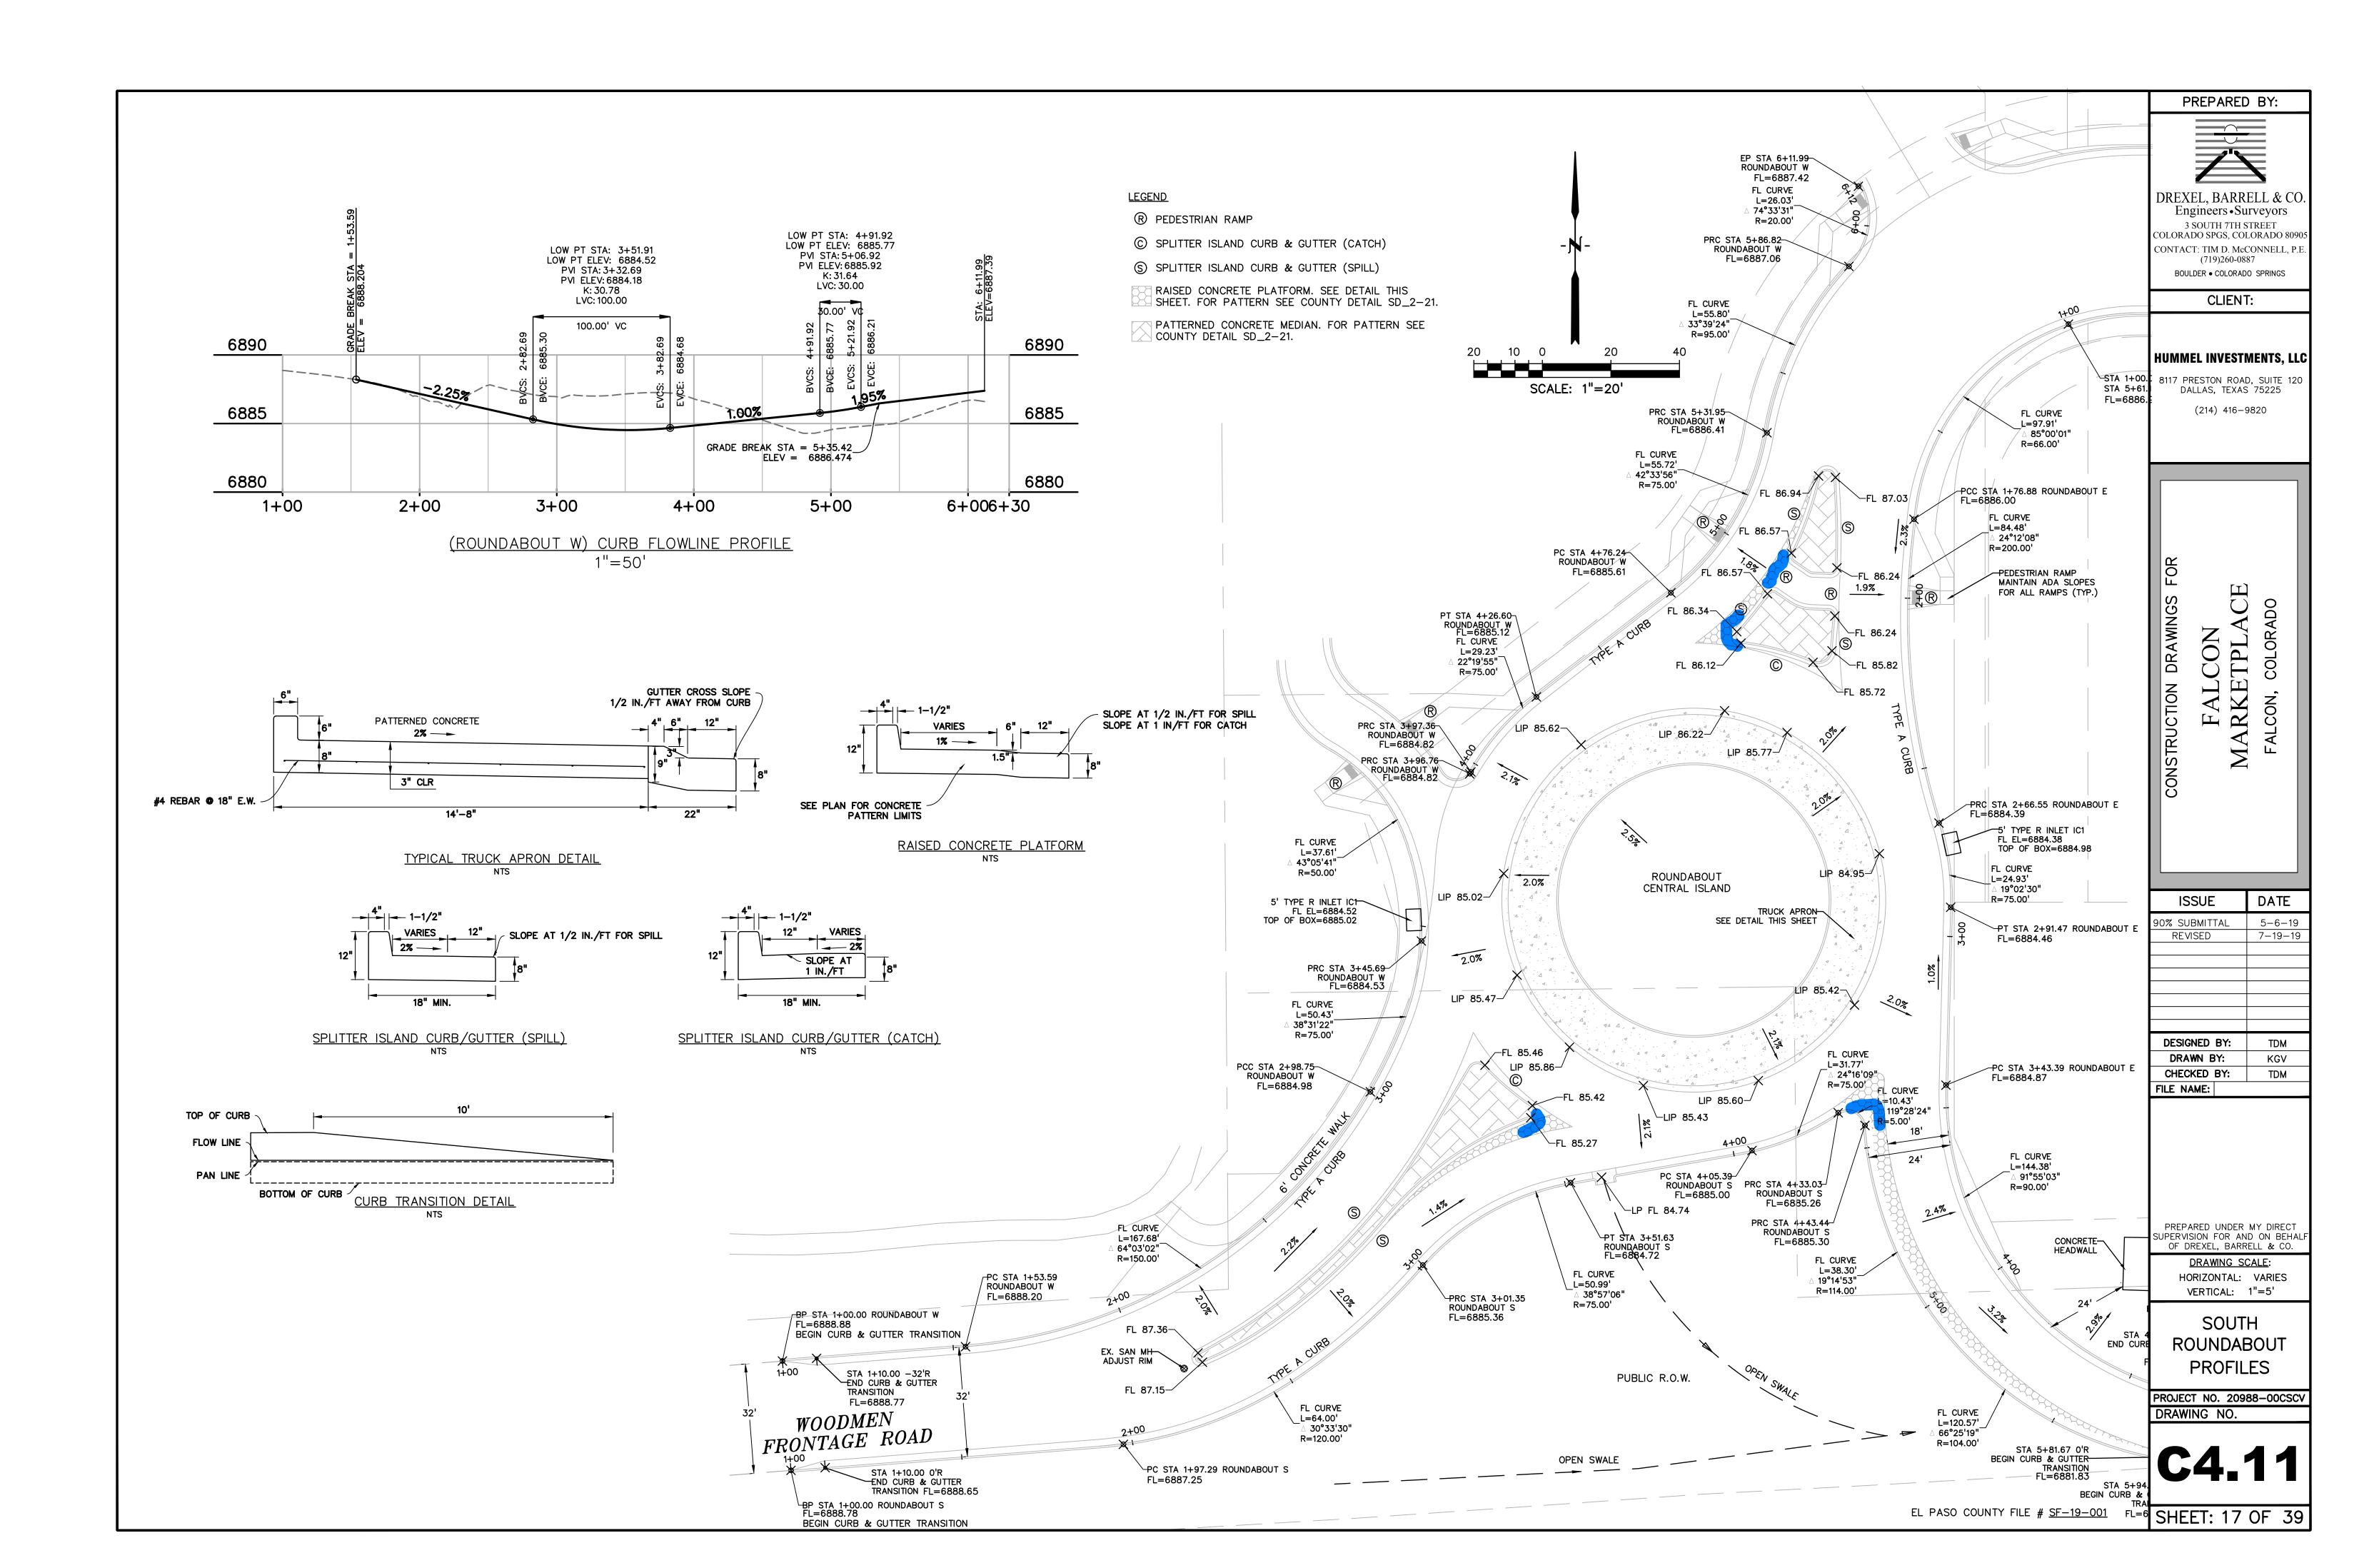
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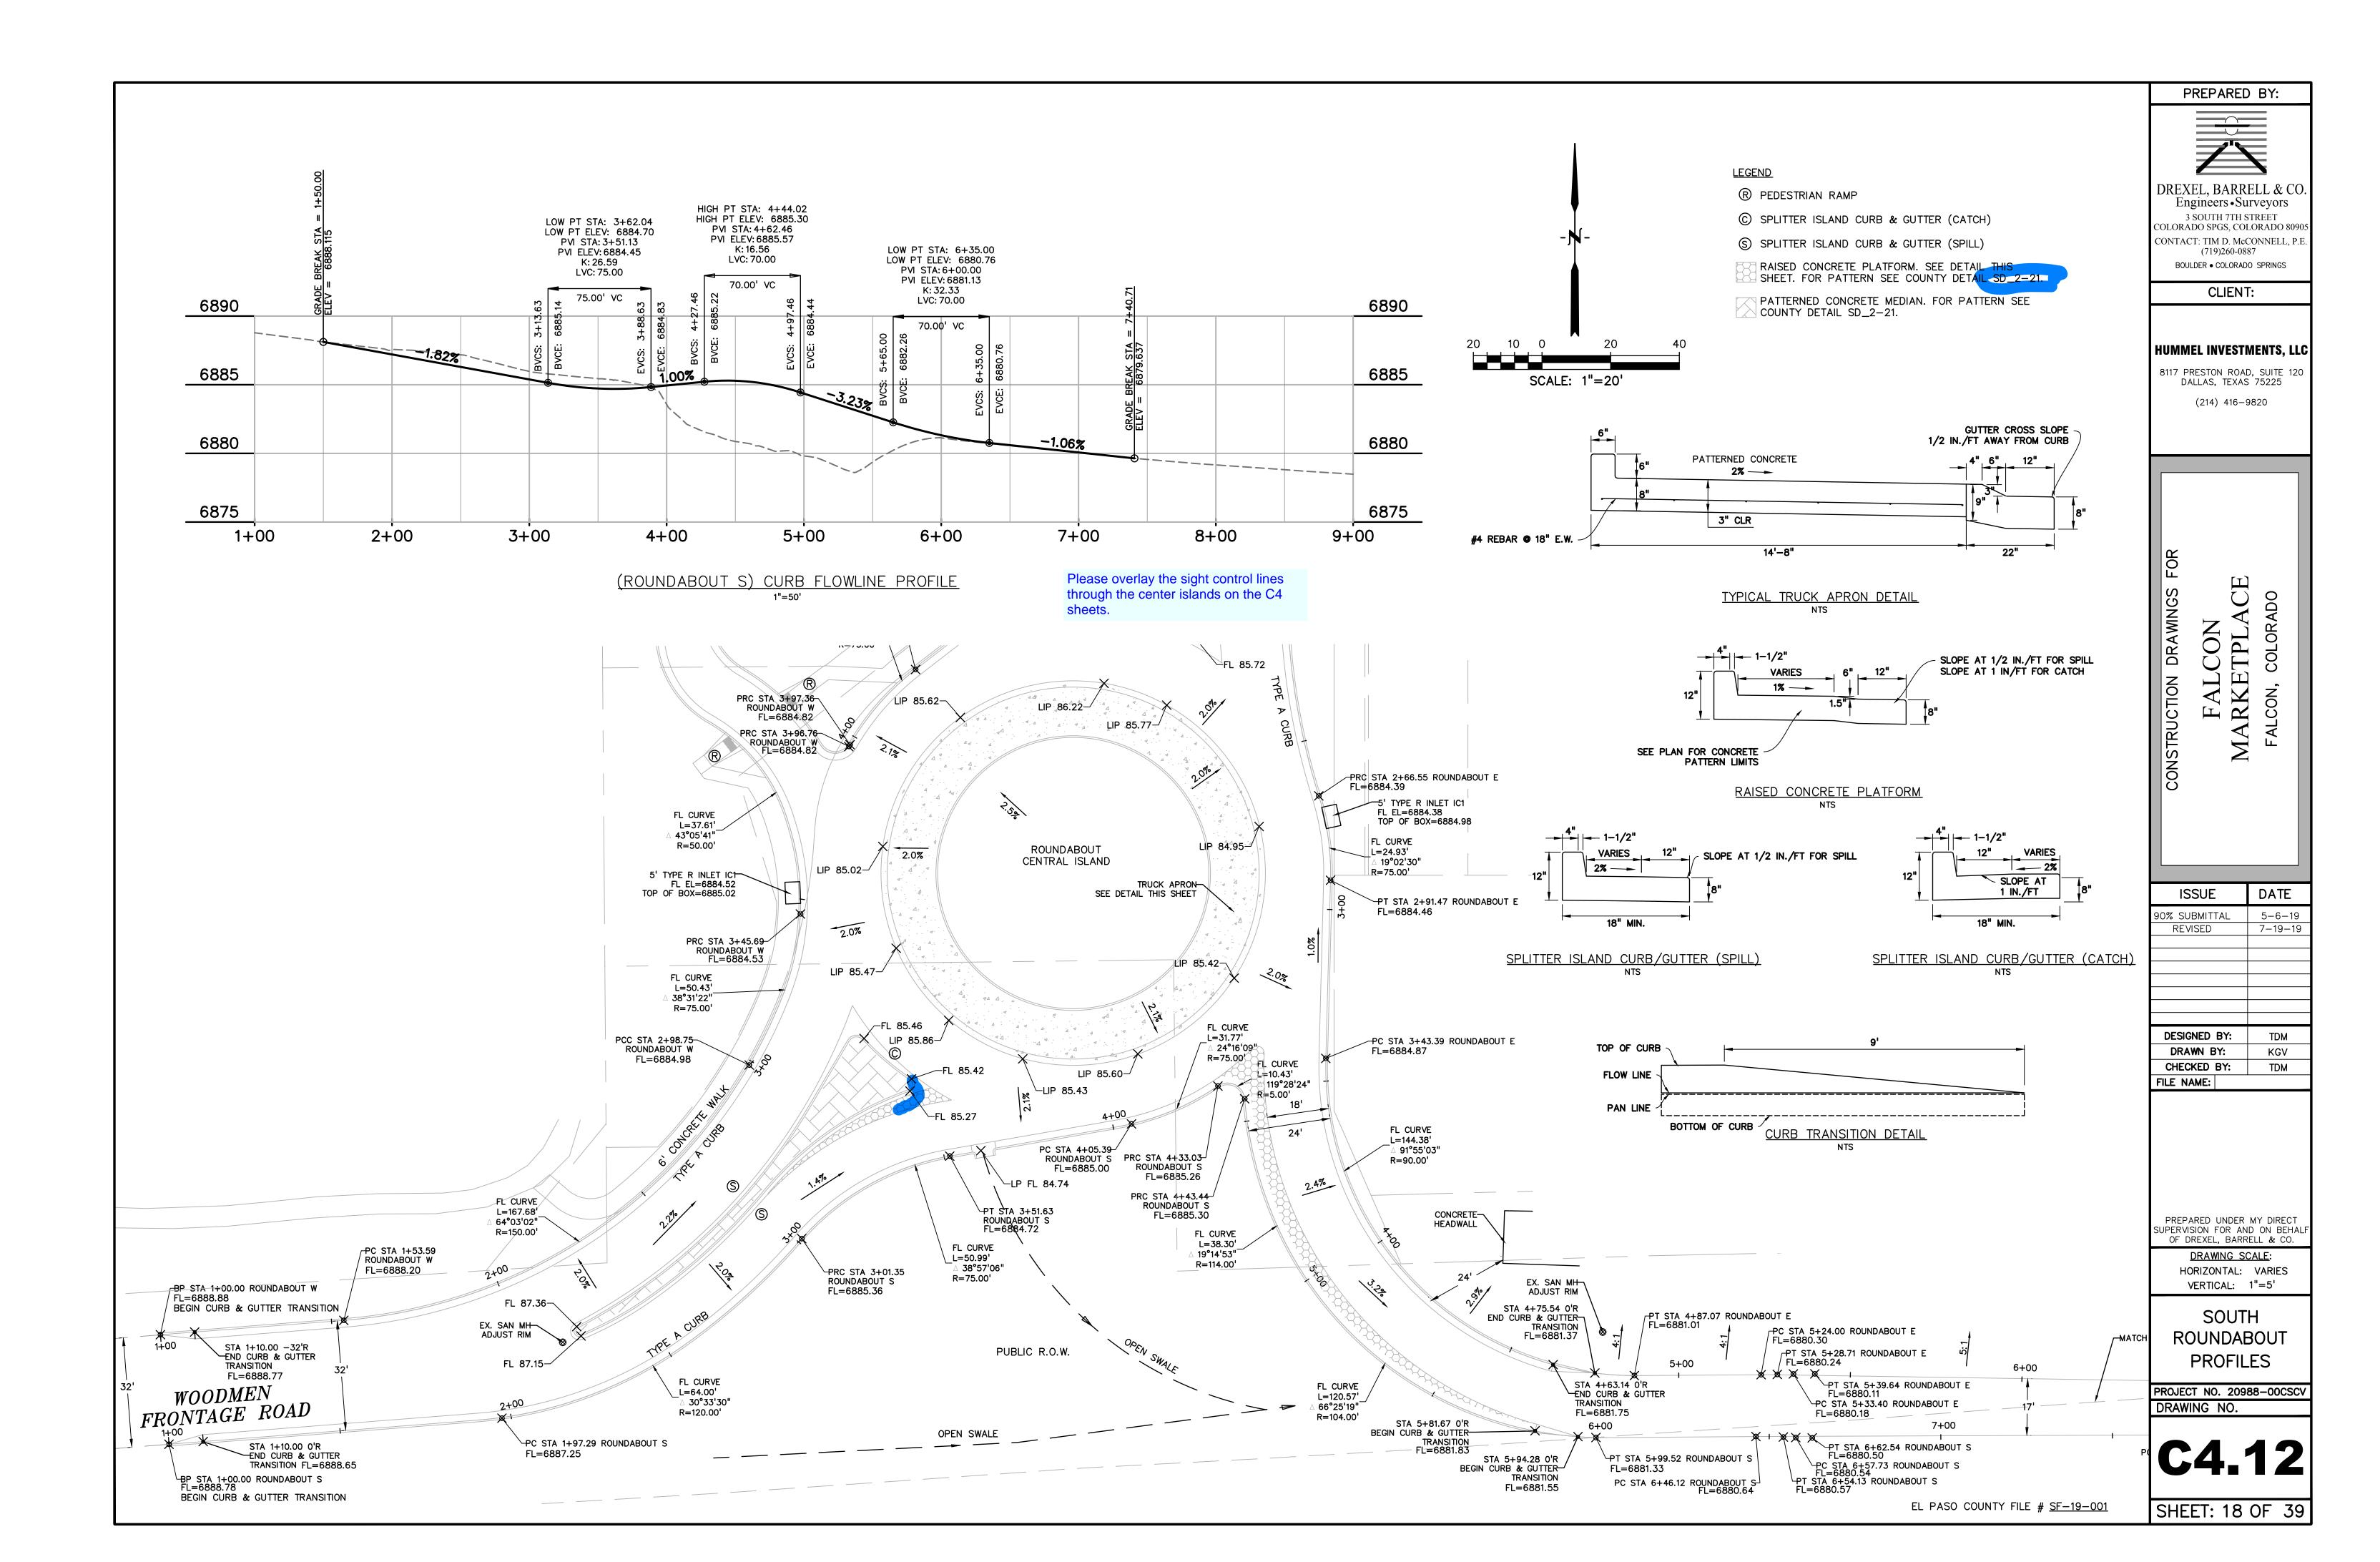


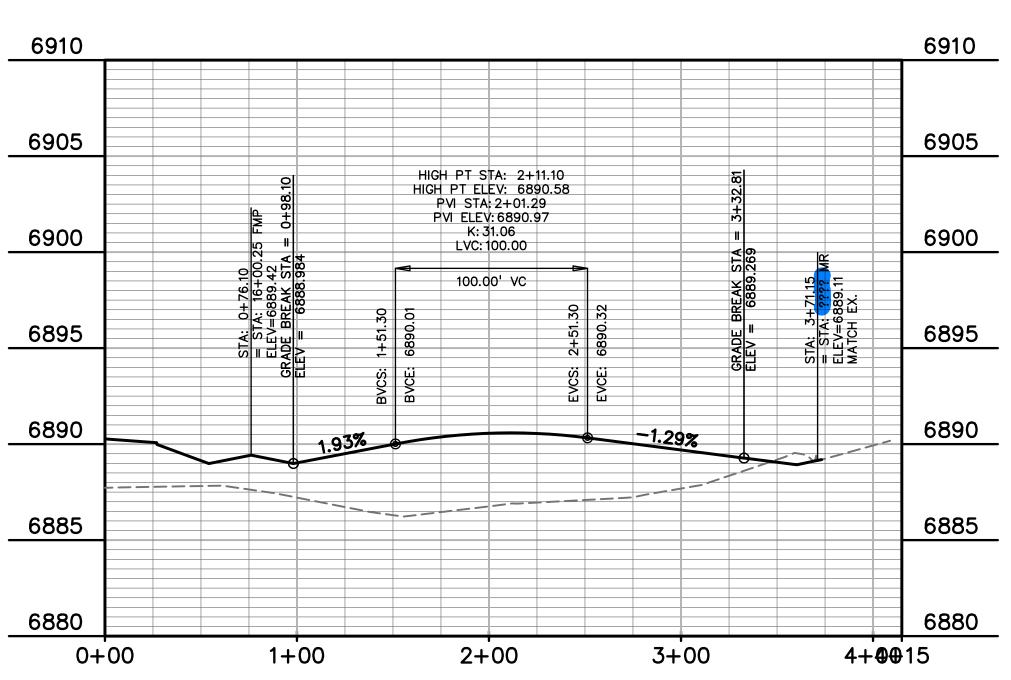



CURE & GUTTER
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CONTACT: THE ACCONNELL, P.E. (79)2640835 BOULDER • COLORADO SPRINGS CLIENT: HUMMEL INVESTMENTS, LLC B117 PRESTON ROAD, SUIT: 120 DALAS, TEXAS 75225 (214) 416-9820 USAN COLORADO EATE 902 SUBMITAL 5-6-19
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90% SUBMITTAL 5-6-19
90% SUBMITTAL 5-6-19
REVISED 7-19-19
DESIGNED BY: SBN
DRAWN BY: SBN
CHECKED BY: TDM FILE NAME:
PREPARED UNDER MY DIRECT
SUPERVISION FOR AND ON BEHALF OF DREXEL, BARRELL & CO.
DRAWING SCALE: HORIZONTAL: 1"=60'
VERTICAL: N/A
SIGNAGE & STRIPING
PLAN
PROJECT NO. 20988-00CSCV
70 0 70 140 DRAWING NO.
SCALE: 1"=60'
EL PASO COUNTY FILE # SF-19-001 SHEET: 15 OF 39

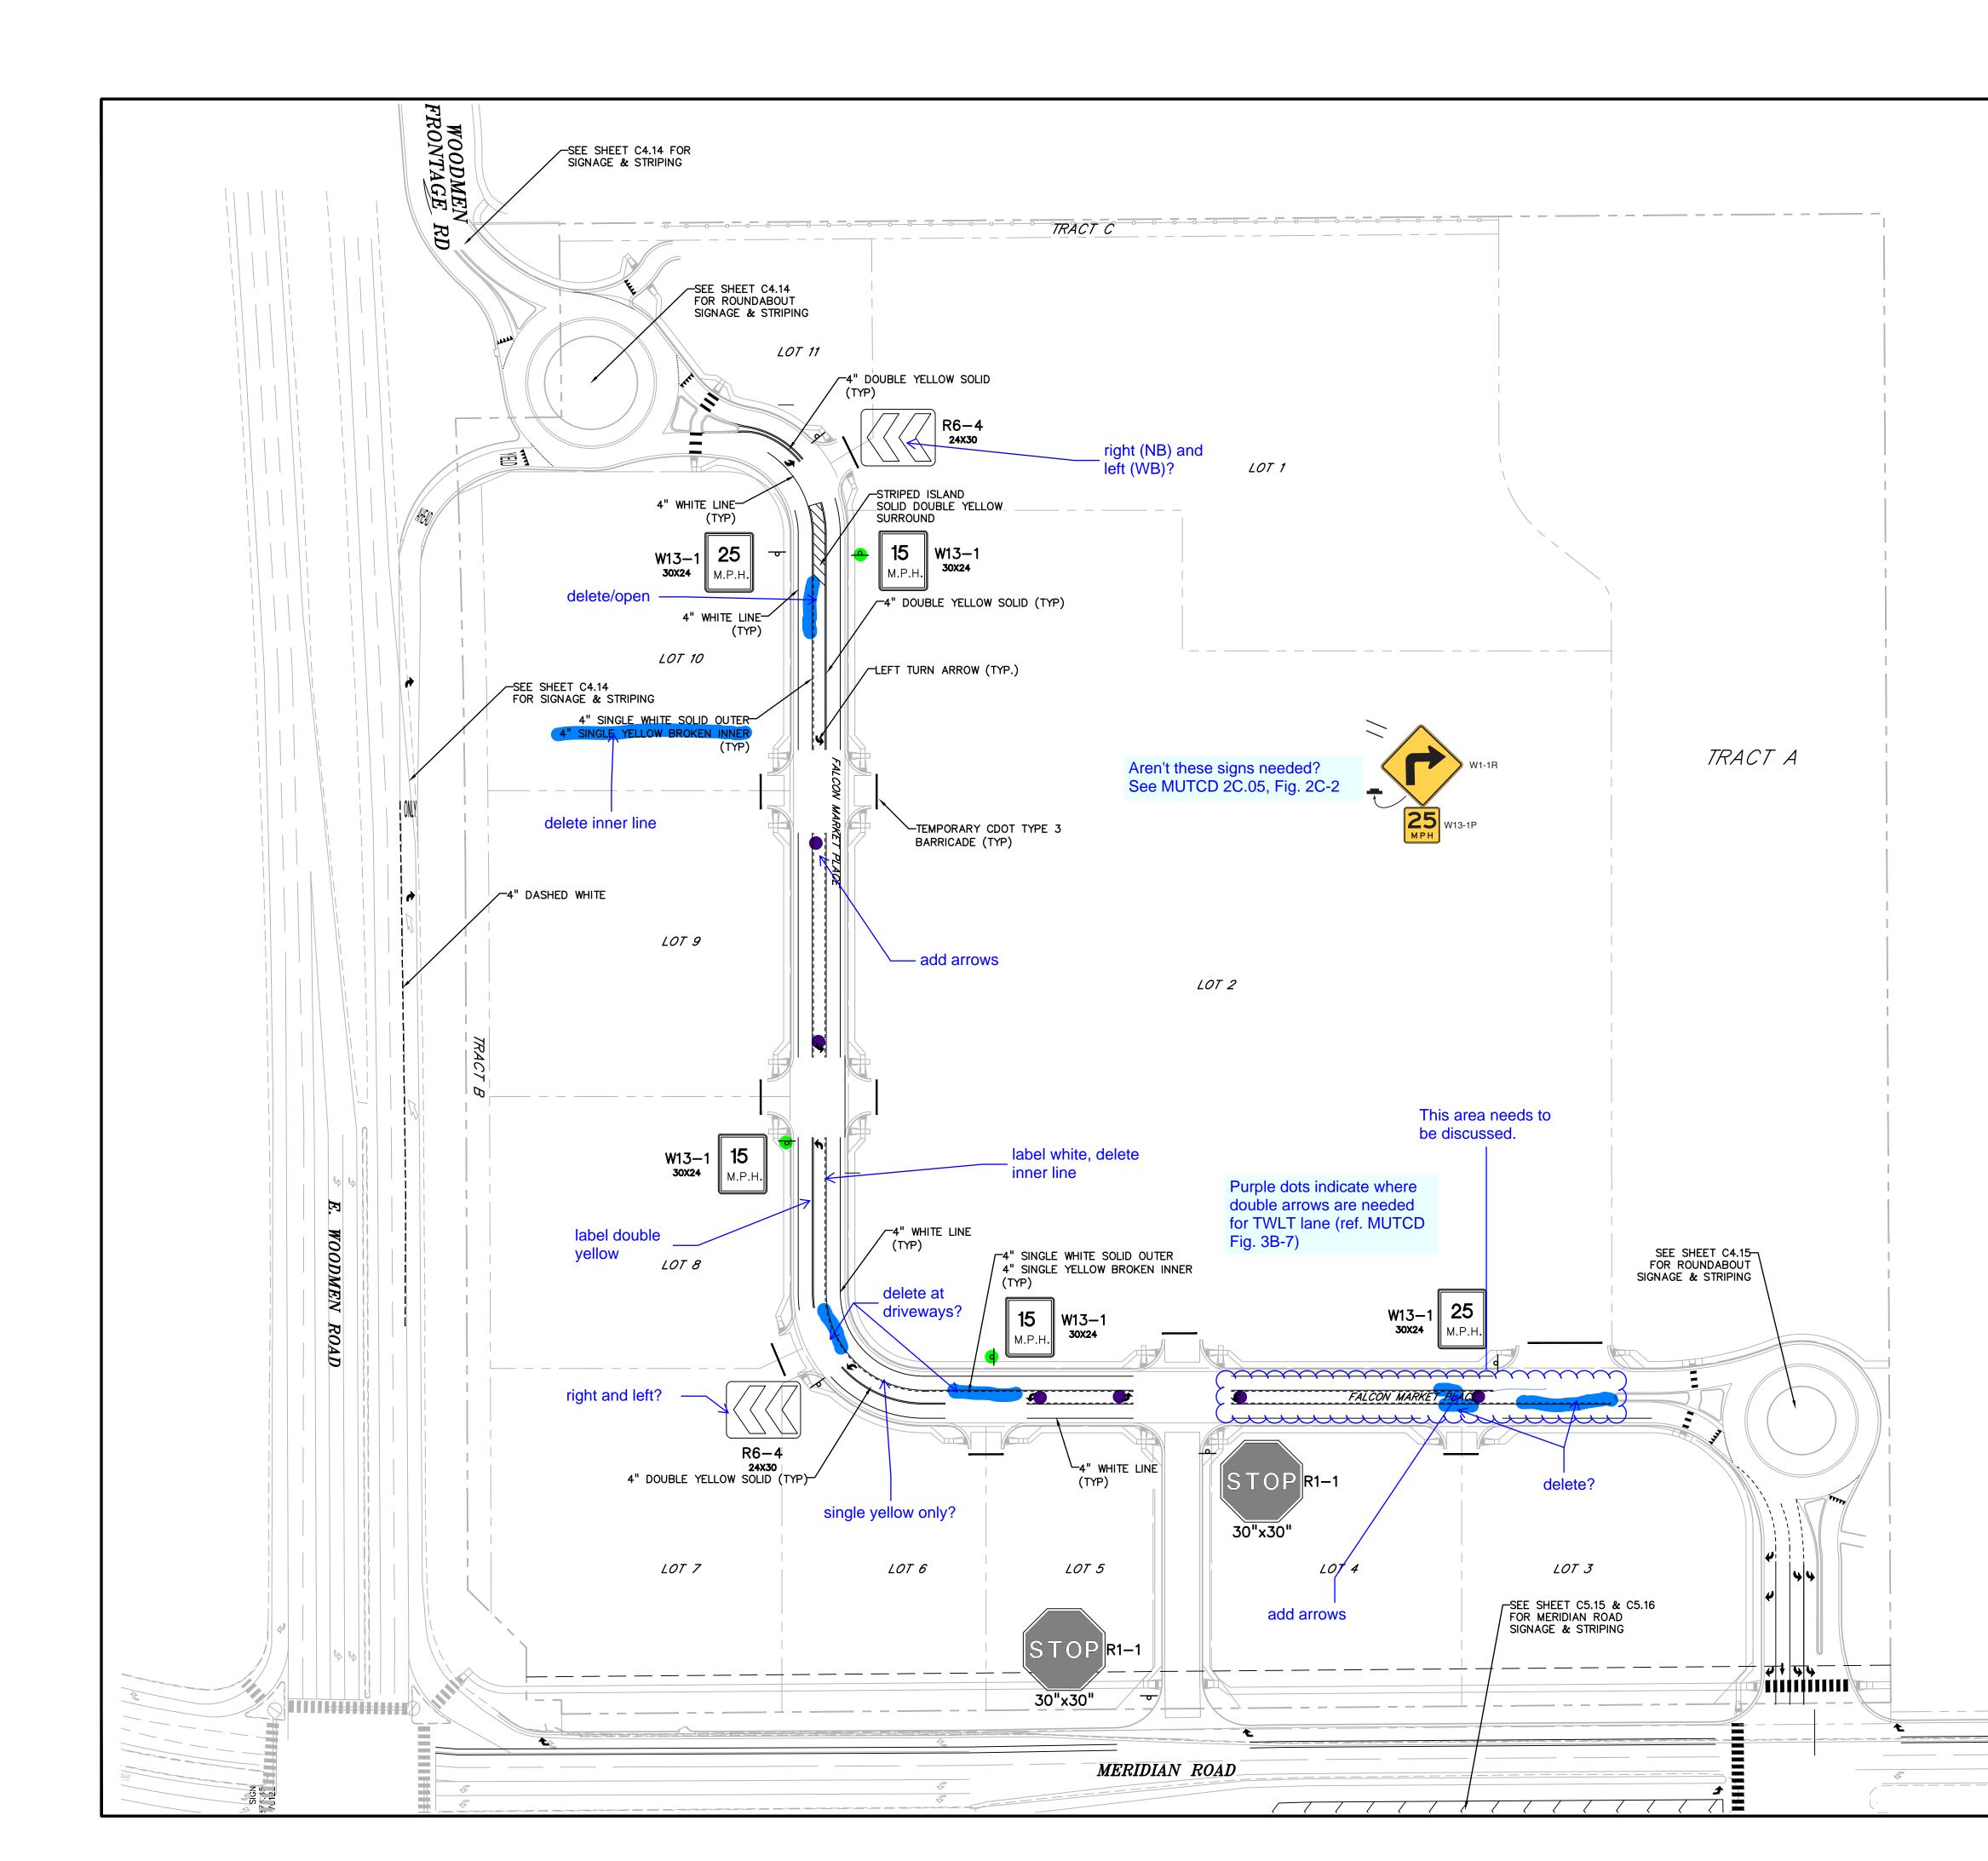




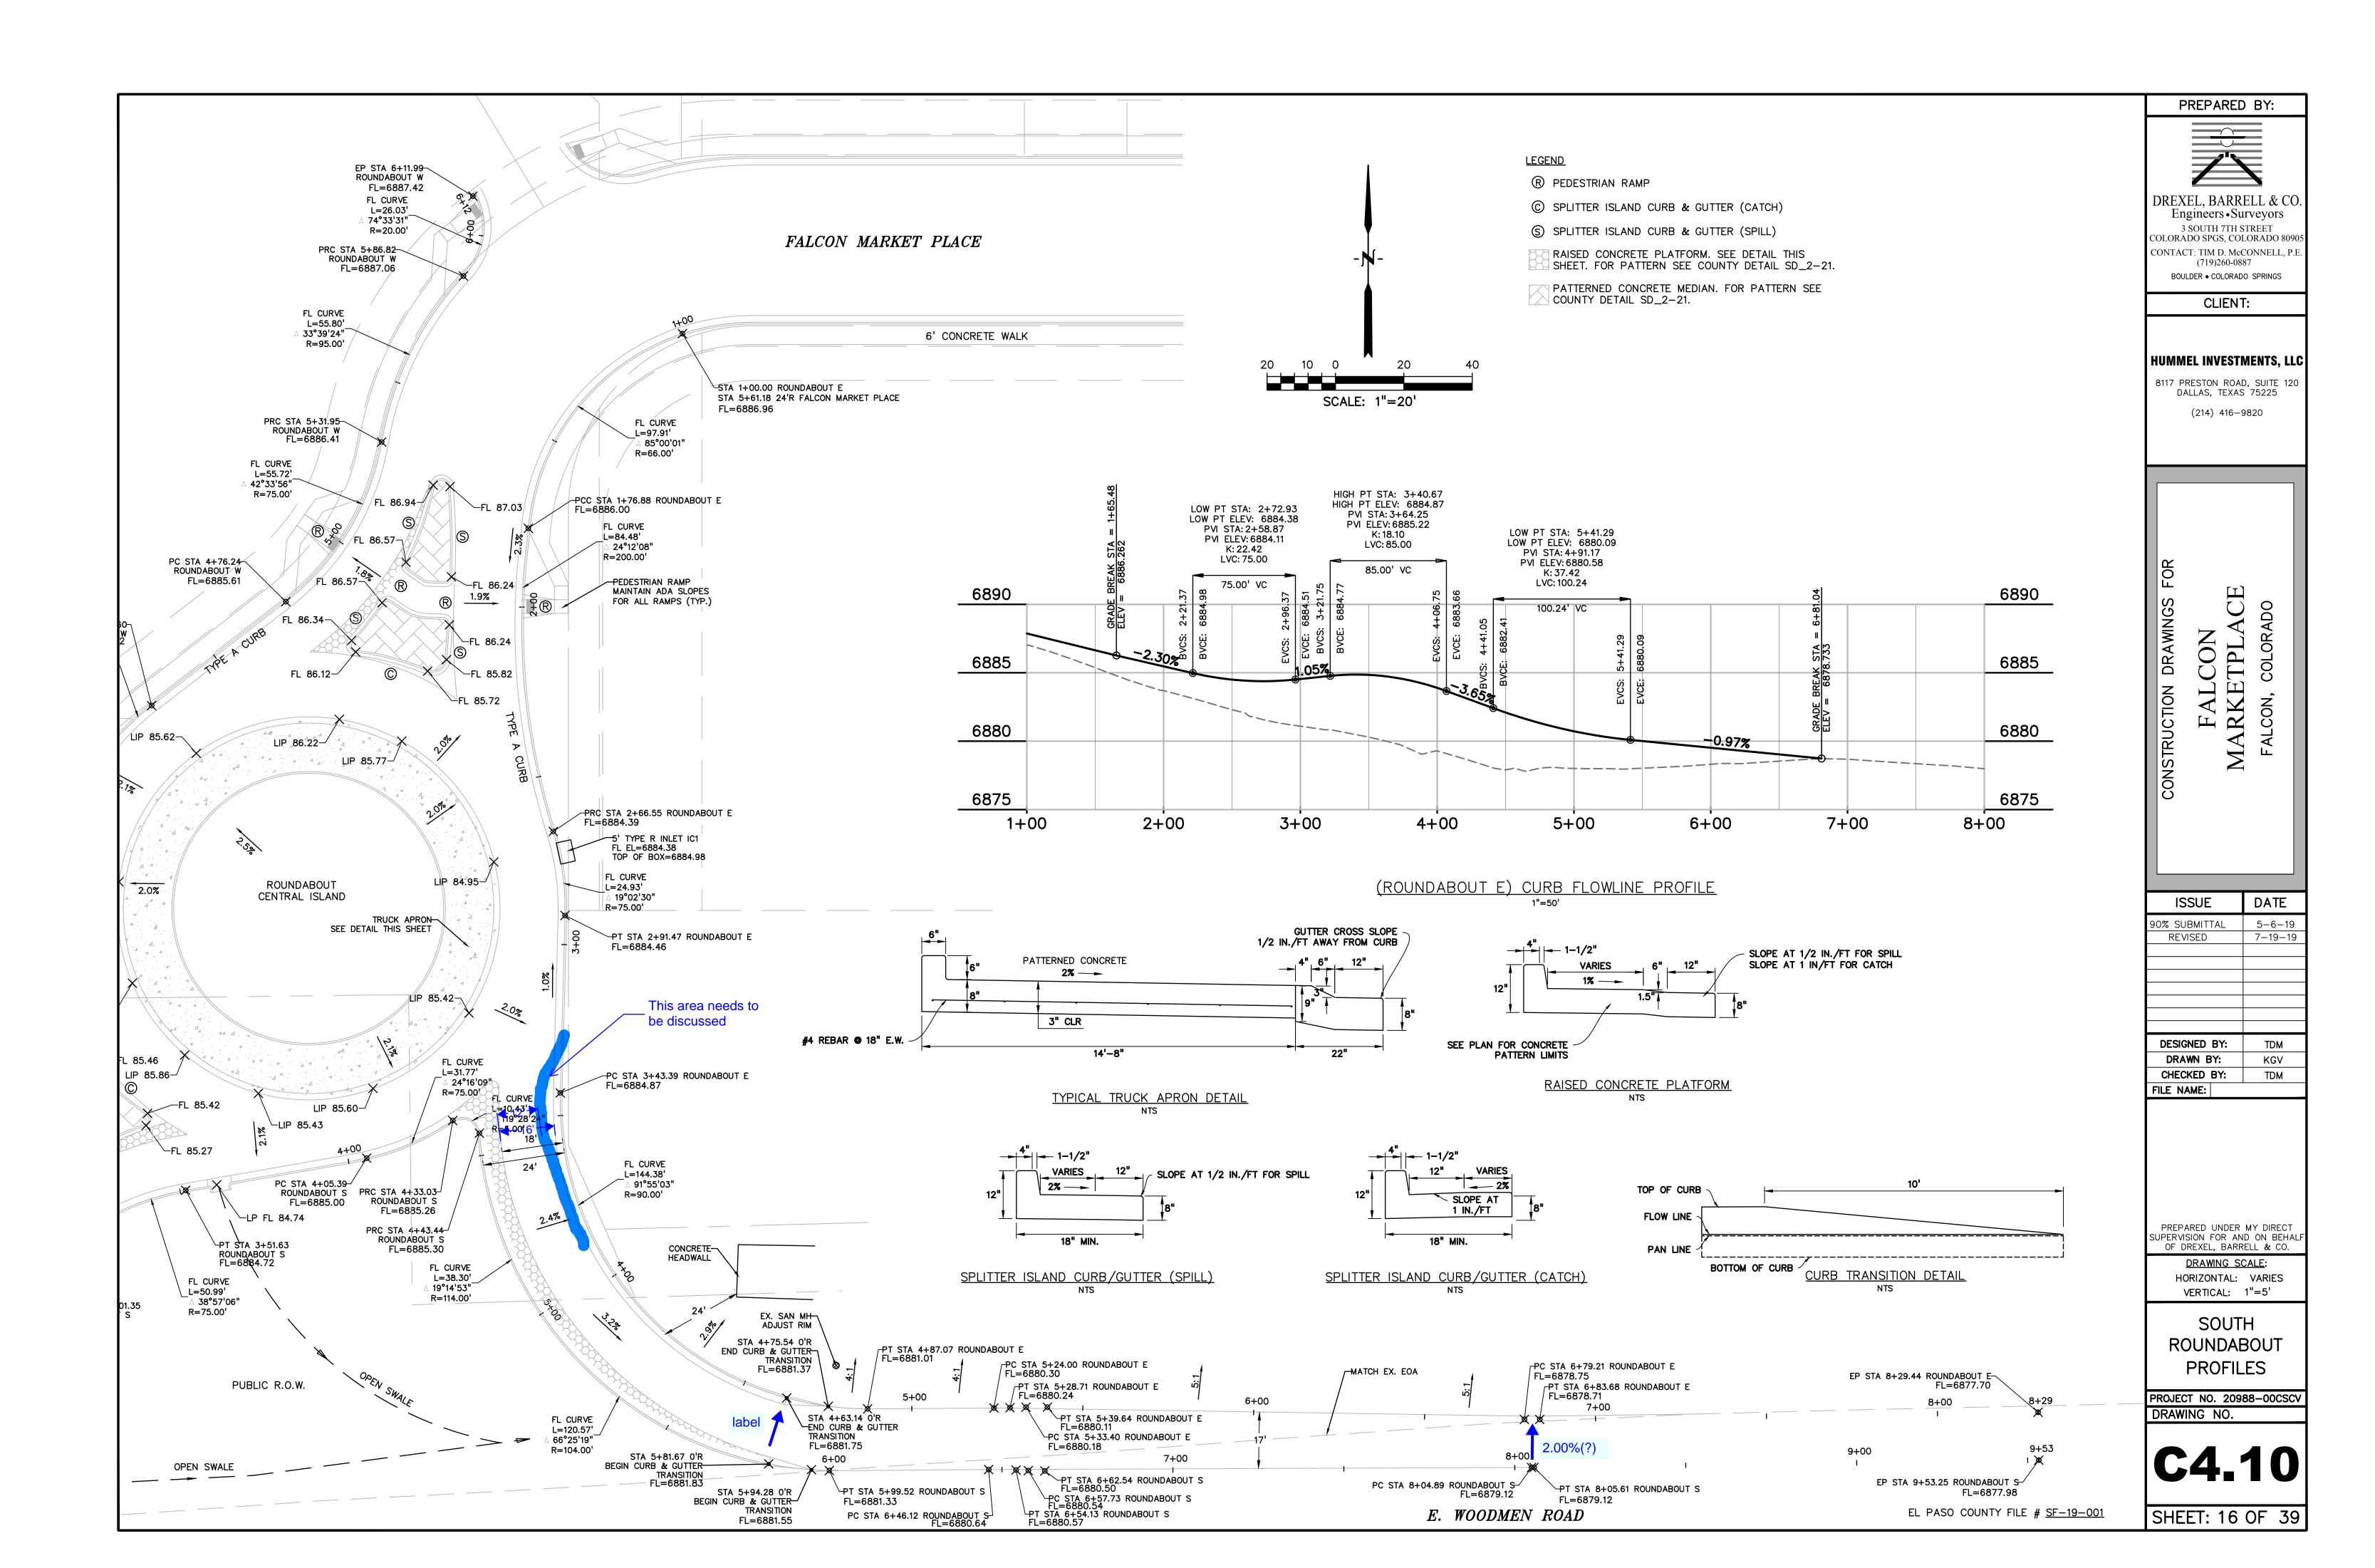


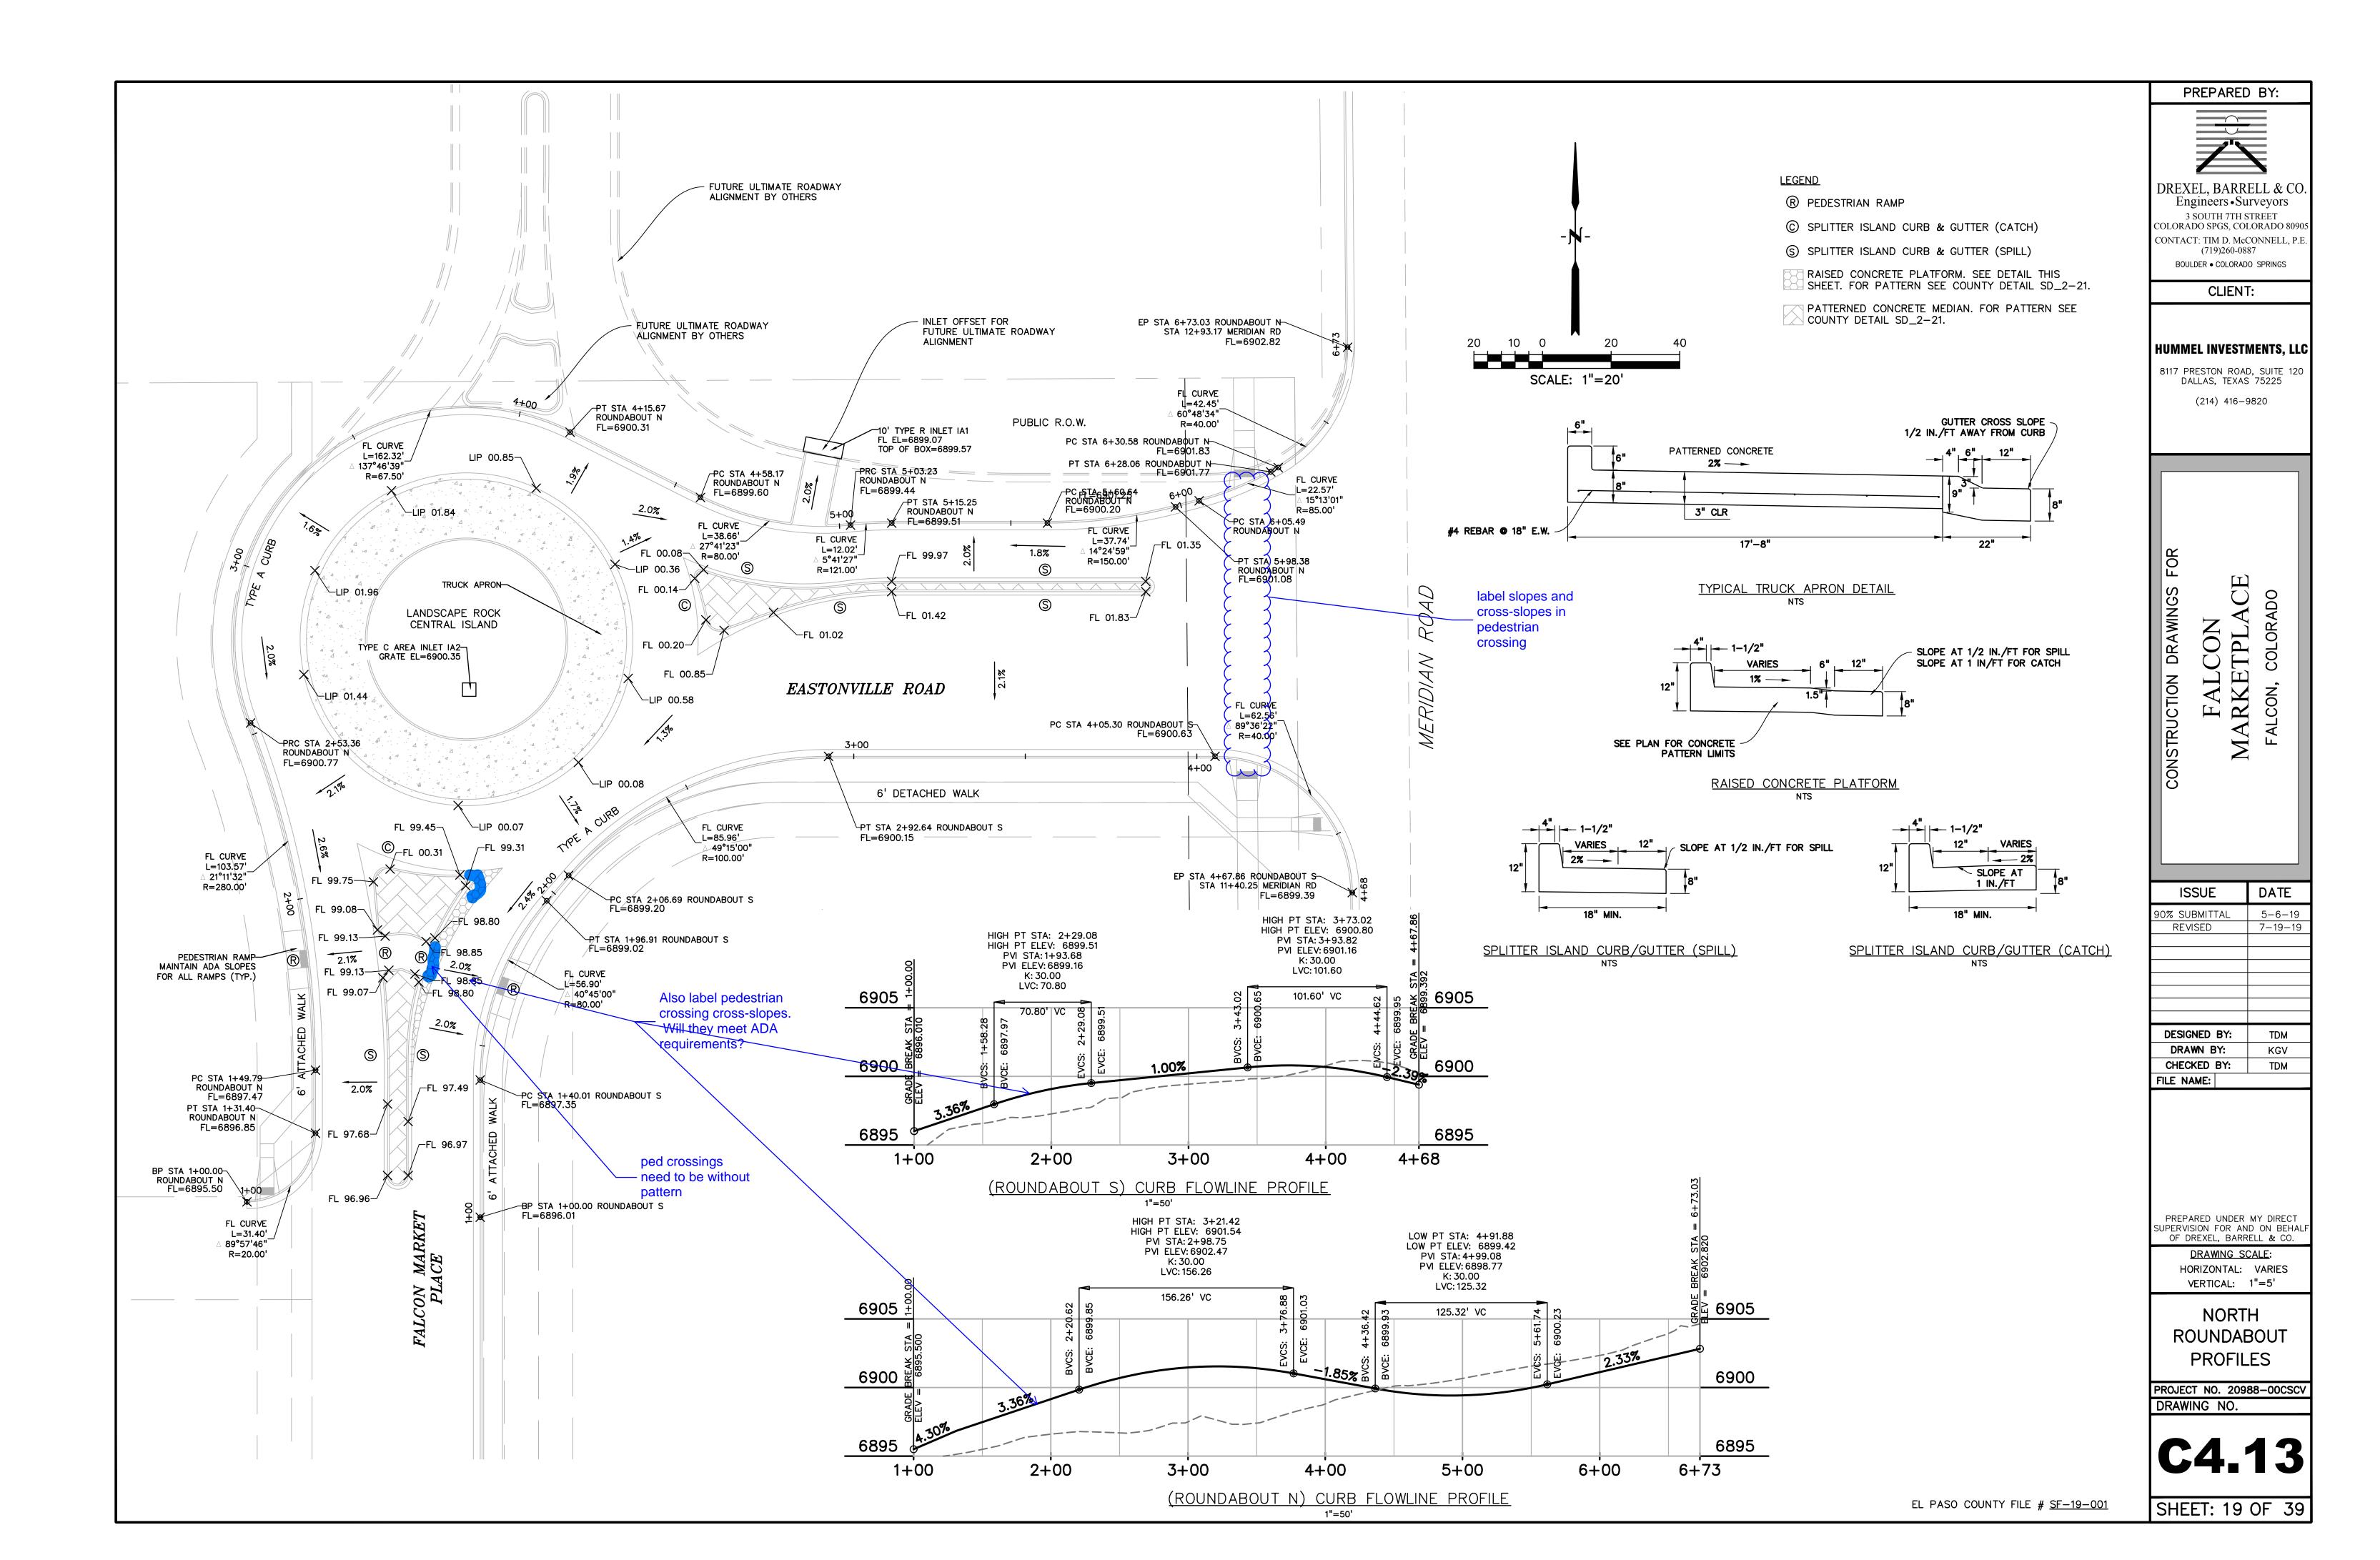

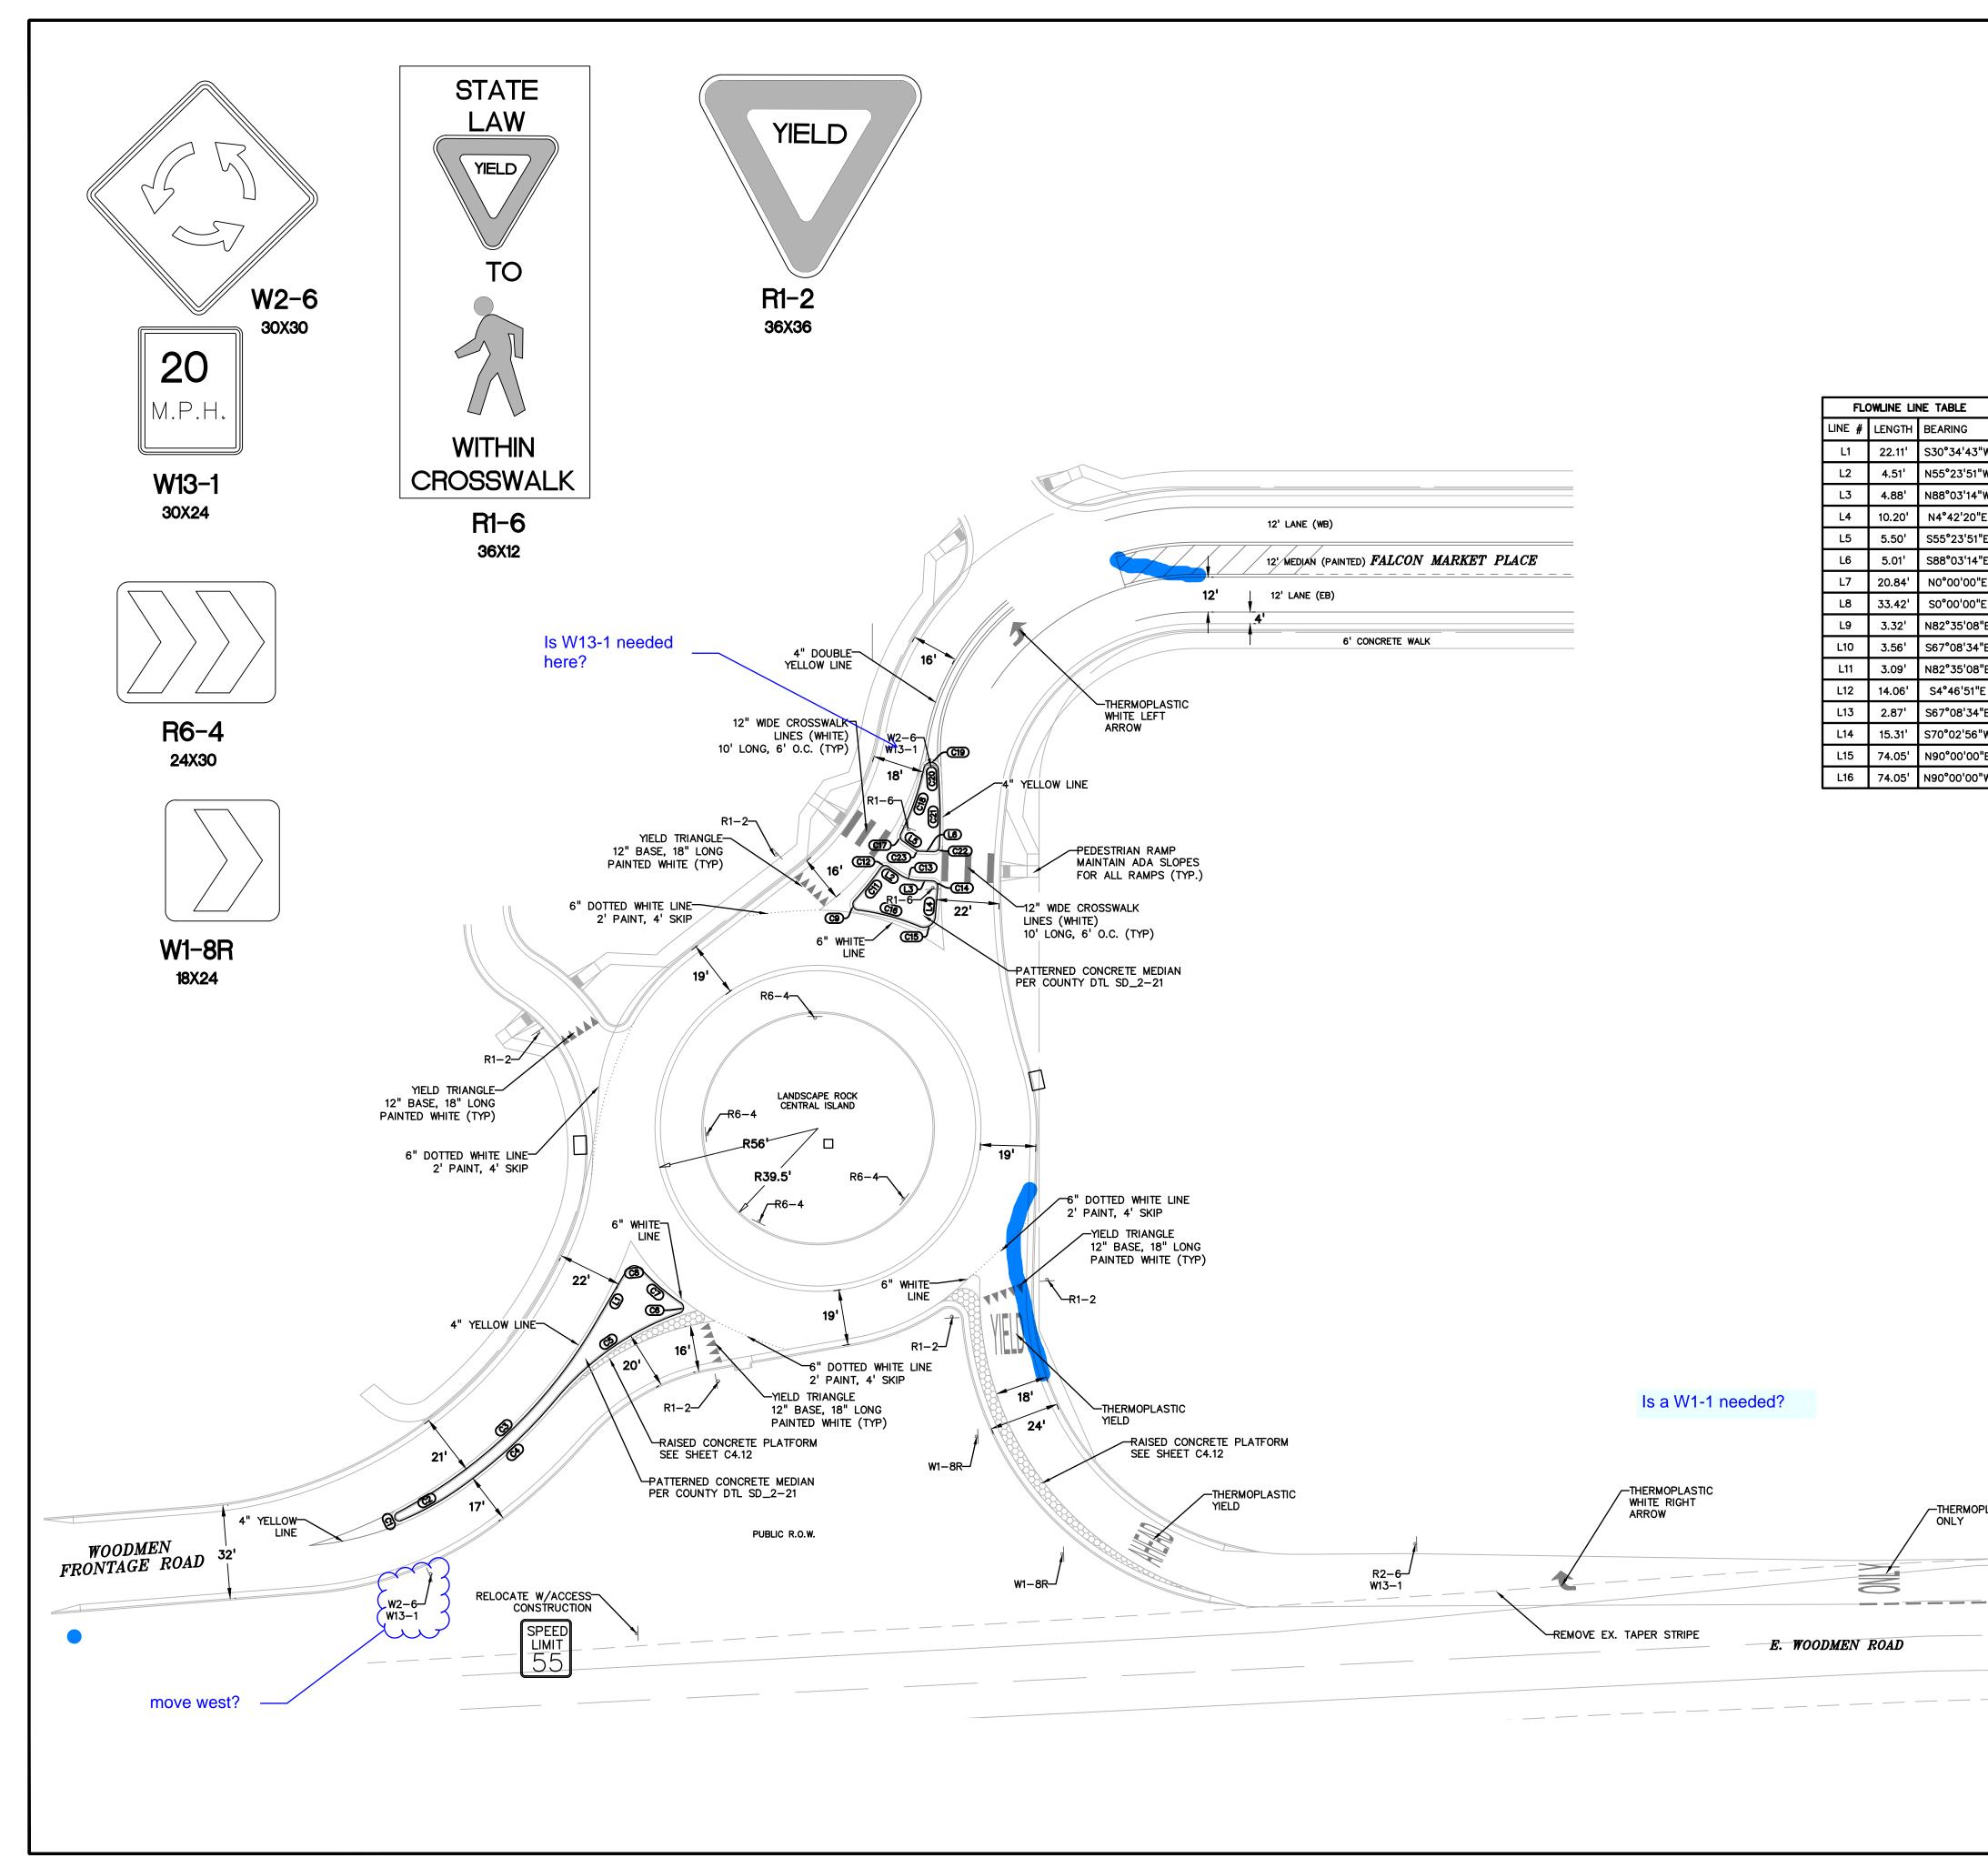

	-) (-	PREPARED BY:
FLOWLINE CURVE TABLE CURVE # LENGTH RADIUS DELTA 3"W C1 4.58' 1.50' 174°49'13"	30 15 0 30 60 SCALE: 1"=30' FLOWLINE CURVE TABLE CURVE # LENGTH RADIUS DELTA C24 9.42' 3.00' 180°00'00"	HUMMEL INVESTMENTS, LLC 8117 PRESTON ROAD, SUITE 120 DALLAS, TEXAS 75225 (214) 416–9820
3.*W C1 4.38 1.30 174 49 13 61"W C2 22.46' 103.00' 12°29'30" 0"E 31°42'07" C4 46.23' 175.00' 15°08'10" 0"E C5 52.07' 97.00' 30°45'18" 0"E C6 4.43' 2.00' 126°49'25" 0"E C7 18.20' 79.00' 13°12'01" 0"E C1 14.24' 97.00' 8°24'31" C11 14.24' 97.00' 8°24'31" C13 6.84' 12.00' 32°39'23" C14 3.24' 2.00' 92°45'34" C16 21.83' 79.00' 15°49'58" 0"W C16 21.83' 79.00' </th <th>C24 9.42 3.00' 180'00'00' C25 36.89' 301.00' 7°01'20" C26 3.08' 2.00' 88°13'15" C27 1.06' 2.00' 82°37'04" C28 2.88' 2.00' 82°37'04" C29 23.23' 86.00' 15°28'30" C30 3.23' 2.00' 92°38'00" C31 7.62' 4.00' 109°10'07" C32 4.49' 2.00' 128°29'26" C33 3.08' 2.00' 88°14'47" C34 6.34' 12.00' 30°16'18" C35 20.42' 71.00' 16°28'50" C36 17.69' 86.00' 11°47'13" C37 6.96' 4.00' 99°39'40" C38 12.55' 76.00' 9°27'39" C39 4.53' 2.00' 129°40'24" C40 41.50' 86.00' 27°38'45" C41 14.02' 104.00' 7°43'24" C42 4.75' 1.50' 181°16'00" C4</th> <th>CONSTRUCTION DRAMINGS FOR CONSTRUCTION DRAMINGS FOR FALCON FALCON FALCON FALCON FALCON CONSTRUCTION FALCON 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71.00' 16°28'50" C36 17.69' 86.00' 11°47'13" C37 6.96' 4.00' 99°39'40" C38 12.55' 76.00' 9°27'39" C39 4.53' 2.00' 129°40'24" C40 41.50' 86.00' 27°38'45" C41 14.02' 104.00' 7°43'24" C42 4.75' 1.50' 181°16'00" C4	CONSTRUCTION DRAMINGS FOR CONSTRUCTION DRAMINGS FOR FALCON FALCON FALCON FALCON FALCON CONSTRUCTION FALCON FALCON 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		DESIGNED BY: TDM DRAWN BY: KGV CHECKED BY: TDM FILE NAME:
OPLASTIC OPLASTIC 4" DASHED WHITE	(500-FT)	PREPARED UNDER MY DIRECT SUPERVISION FOR AND ON BEHALF OF DREXEL, BARRELL & CO. DRAWING SCALE: HORIZONTAL: 1"=30' VERTICAL: N/A SOUTH ROUNDABOUT SIGNAGE PROJECT NO. 20988–00CSCV DRAWING NO.
	EL PASO COUNTY FILE # <u>SF—19—001</u>	C4.14 SHEET: 20 OF 39

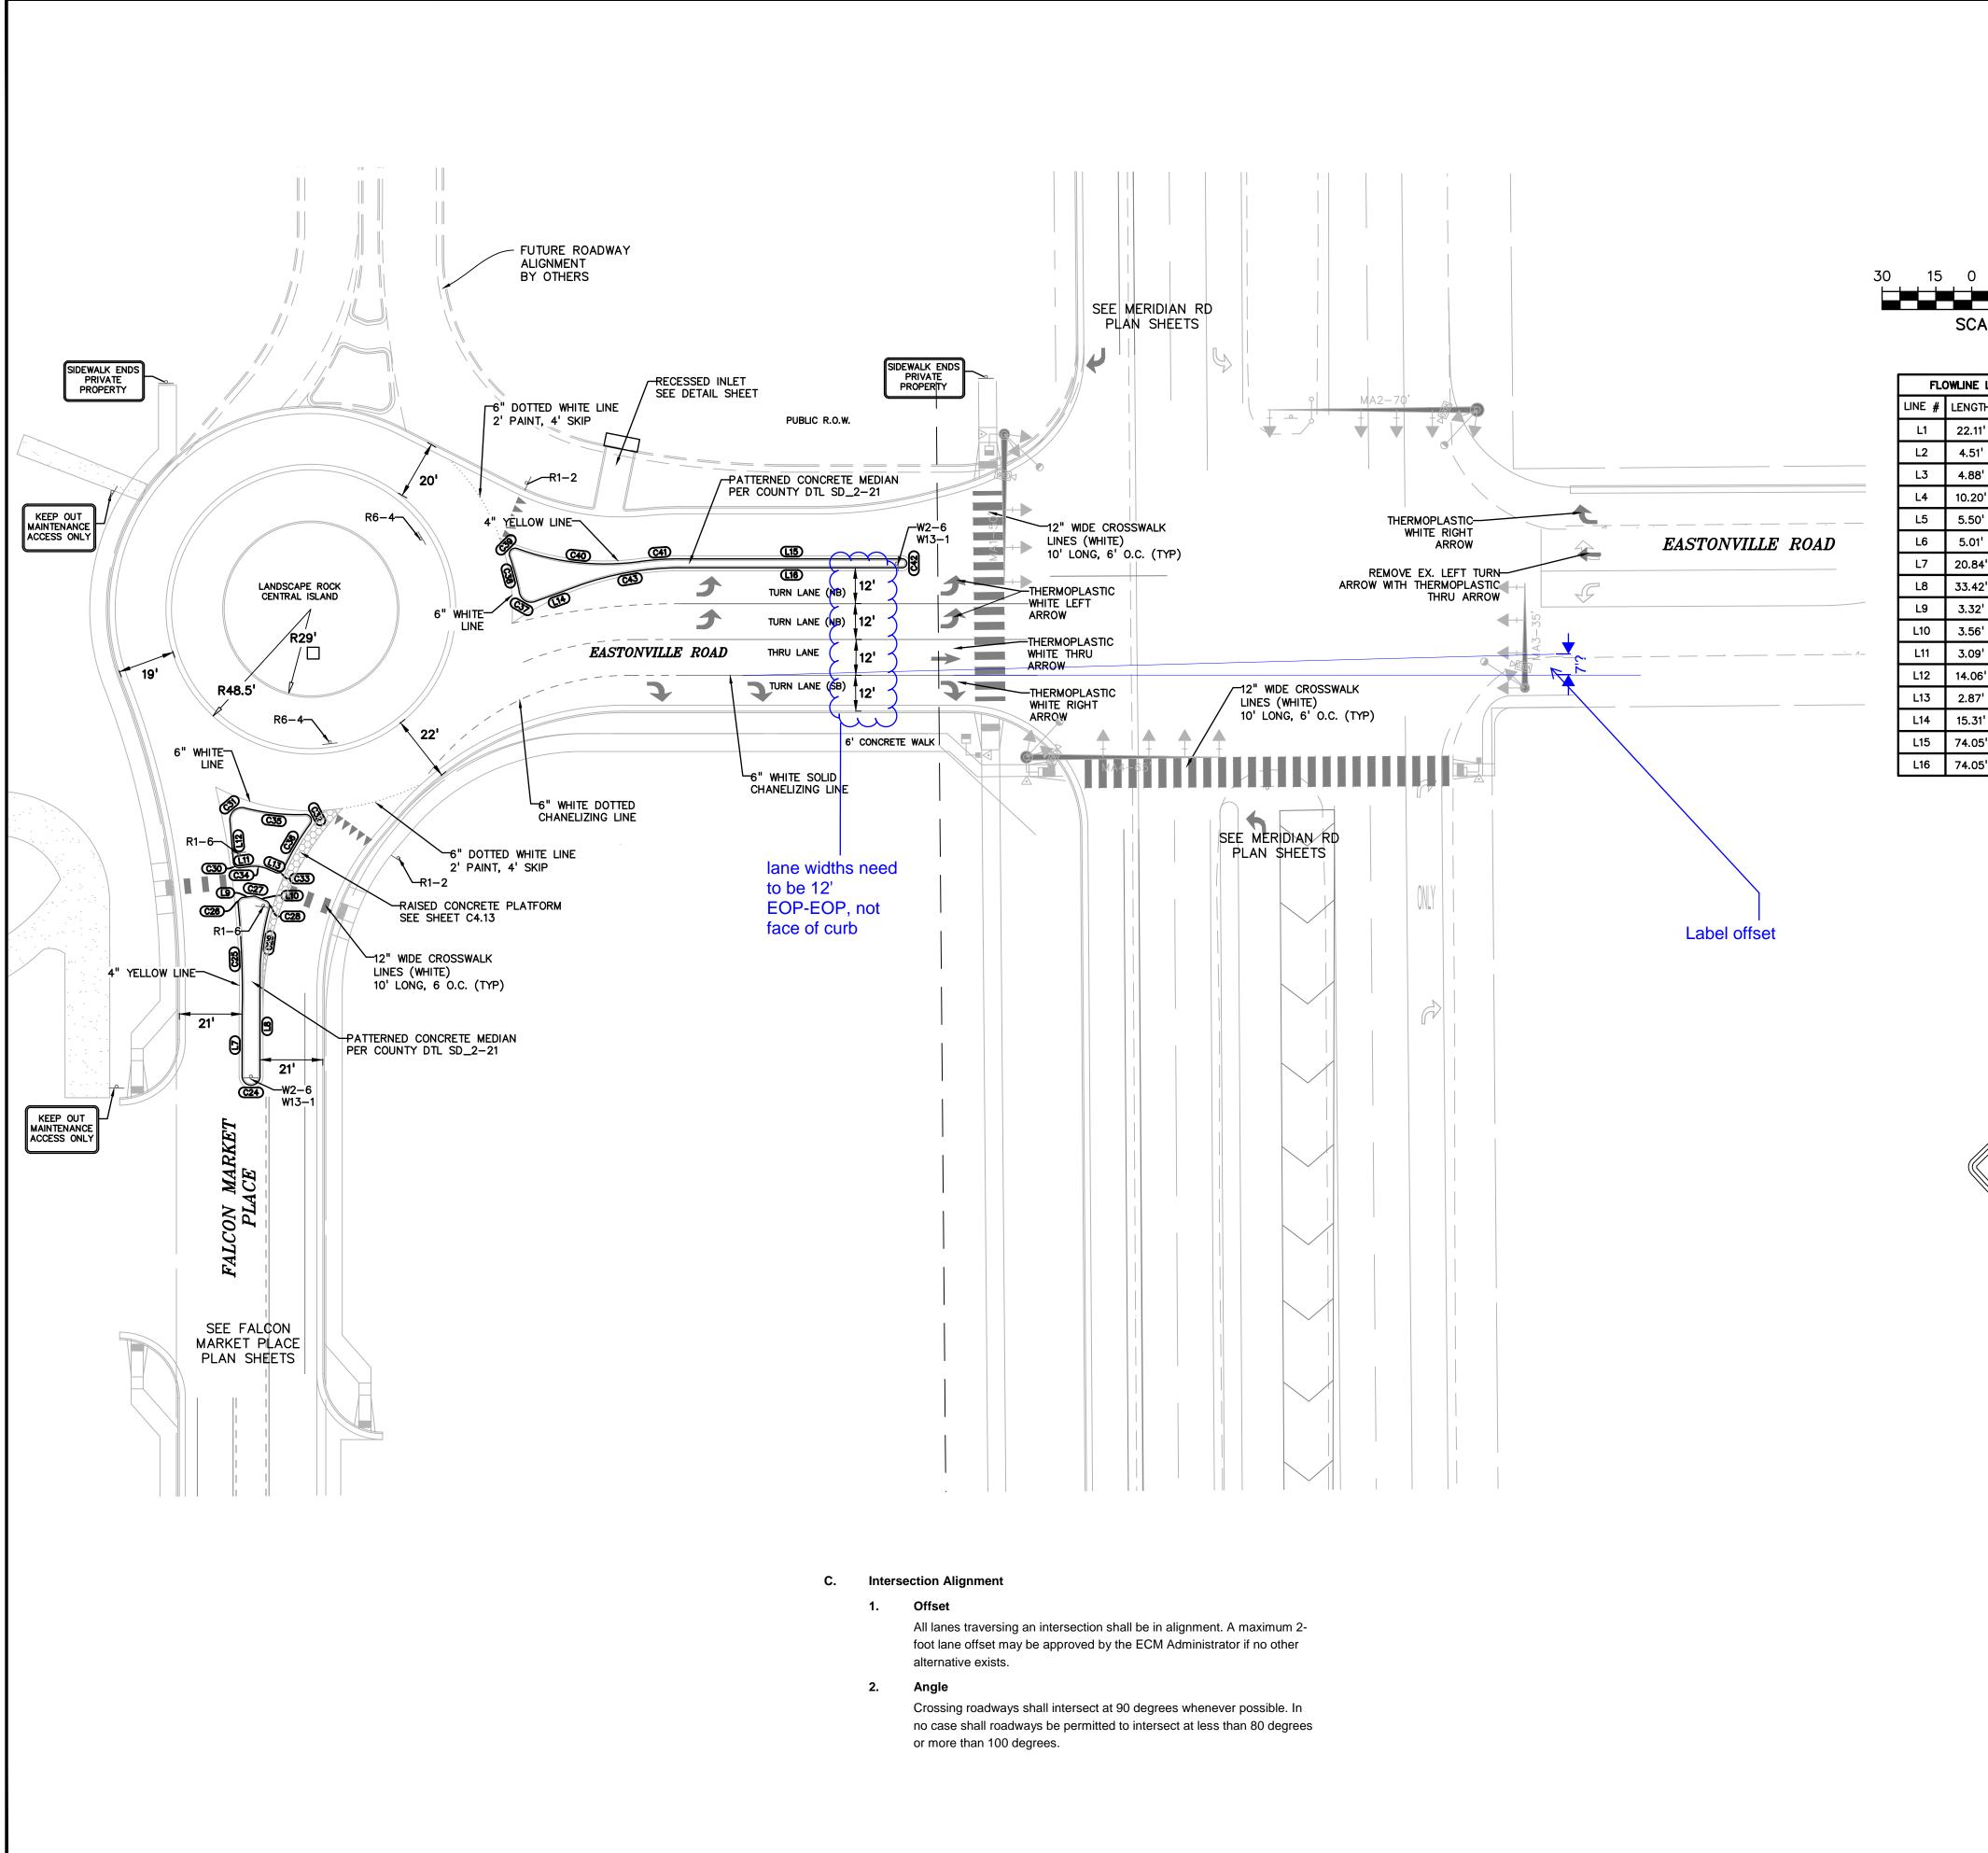

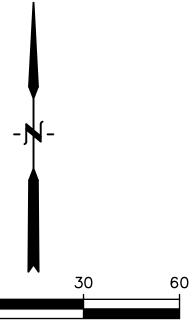

SCALE: 1"=30'


	NE TABLE
TH	BEARING
1'	S30°34'43"W
l '	N55°23'51"W
3'	N88°03'14"W
0'	N4°42'20"E
י'	S55°23'51"E
l'	S88°03'14"E
4'	N0°00'00"E
2'	S0°00'00"E
2'	N82°35'08"E
6'	S67°08'34"E
€'	N82°35'08"E
6'	S4°46'51"E
7'	S67°08'34"E
1'	S70°02'56"W
5'	N90°00'00"E
5'	N90°00'00"W


FLOWLINE CURVE TABLE					
CURVE #	LENGTH	RADIUS	DELTA		
C1	4.58'	1.50'	174°49'13"		
C2	22.46'	103.00'	12°29'30"		
С3	94.62'	171.00'	31°42'07"		
C4	46.23'	175.00'	15°08'10"		
C5	52.07'	97.00'	30°45'18"		
C6	4.43'	2.00'	126°49'25"		
C7	18.20'	79.00'	13°12'01"		
C8	5.57'	3.00'	106°23'08"		
C9	4.40'	2.00'	126°04'44"		
C11	14.24'	97.00'	8°24'31"		
C12	3.14'	2.00'	89°57'31"		
C13	6.84'	12.00'	32°39'23"		
C14	3.24'	2.00'	92°45'34"		
C15	7.55'	4.00'	108°06'03"		
C16	21.83'	79.00'	15°49'58"		
C17	2.86'	2.00'	81°54'44"		
C18	23.94'	97.00'	14°08'23"		
C19	7.19'	2.50'	164°46'53"		
C20	6.22'	1017.00'	0°21'01"		
C21	20.18'	199.00'	5°48'34"		
C22	3.12'	2.00'	89°19'50"		
C23	1.14'	2.00'	32°39'23"		

FLOWLINE CURVE TABLE							
CURVE #	LENGTH	RADIUS	DELTA				
C24	9.42'	3.00'	180°00'00"				
C25	36.89'	301.00'	7°01'20"				
C26	3.08'	2.00'	88°13'15"				
C27	1.06'	2.00'	30°16'18"				
C28	2.88'	2.00'	82°37'04"				
C29	23.23'	86.00'	15°28'30"				
C30	3.23'	2.00'	92°38'00"				
C31	7.62'	4.00'	109 ° 10'07"				
C32	4.49'	2.00'	128°29'26"				
C33	3.08'	2.00'	88°14'47"				
C34	6.34'	12.00'	30°16'18"				
C35	20.42'	71.00'	16°28'50"				
C36	17.69'	86.00'	11°47'13"				
C37	6.96'	4.00'	99°39'40"				
C38	12.55'	76.00'	9°27'39"				
C39	4.53'	2.00'	129°40'24"				
C40	41.50'	86.00'	27°38'45"				
C41	14.02'	104.00'	7°43'24"				
C42	4.75'	1.50'	181°16'00"				
C43	35.17'	101.00'	19°57'04"				

 \frown DREXEL, BARRELL & CO. Engineers • Surveyors 3 SOUTH 7TH STREET COLORADO SPGS, COLORADO 80905 CONTACT: TIM D. McCONNELL, P.E (719)260-0887 BOULDER • COLORADO SPRINGS CLIENT: HUMMEL INVESTMENTS, LLC 8117 PRESTON ROAD, SUITE 120 DALLAS, TEXAS 75225 (214) 416-9820 FOR FALCON MARKETPLACE DRAWINGS COLORADO NSTRUCTION FALCON, C ISSUE DATE 90% SUBMITTAL 5-6-19 REVISED 7-19-19 DESIGNED BY: TDM DRAWN BY: KGV CHECKED BY: TDM FILE NAME: PREPARED UNDER MY DIRECT SUPERVISION FOR AND ON BEHAL OF DREXEL, BARRELL & CO. DRAWING SCALE: HORIZONTAL: 1"=30' VERTICAL: N/A NORTH ROUNDABOUT SIGNAGE PROJECT NO. 20988-00CSCV

PREPARED BY:

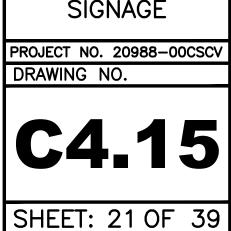


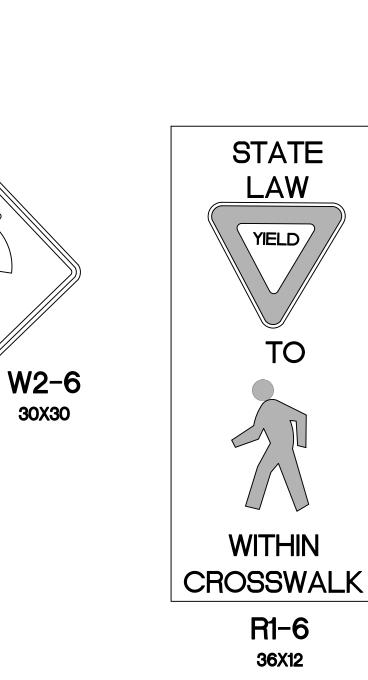

YIELD

R1-2

36X36

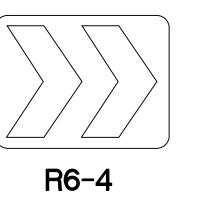

24X30


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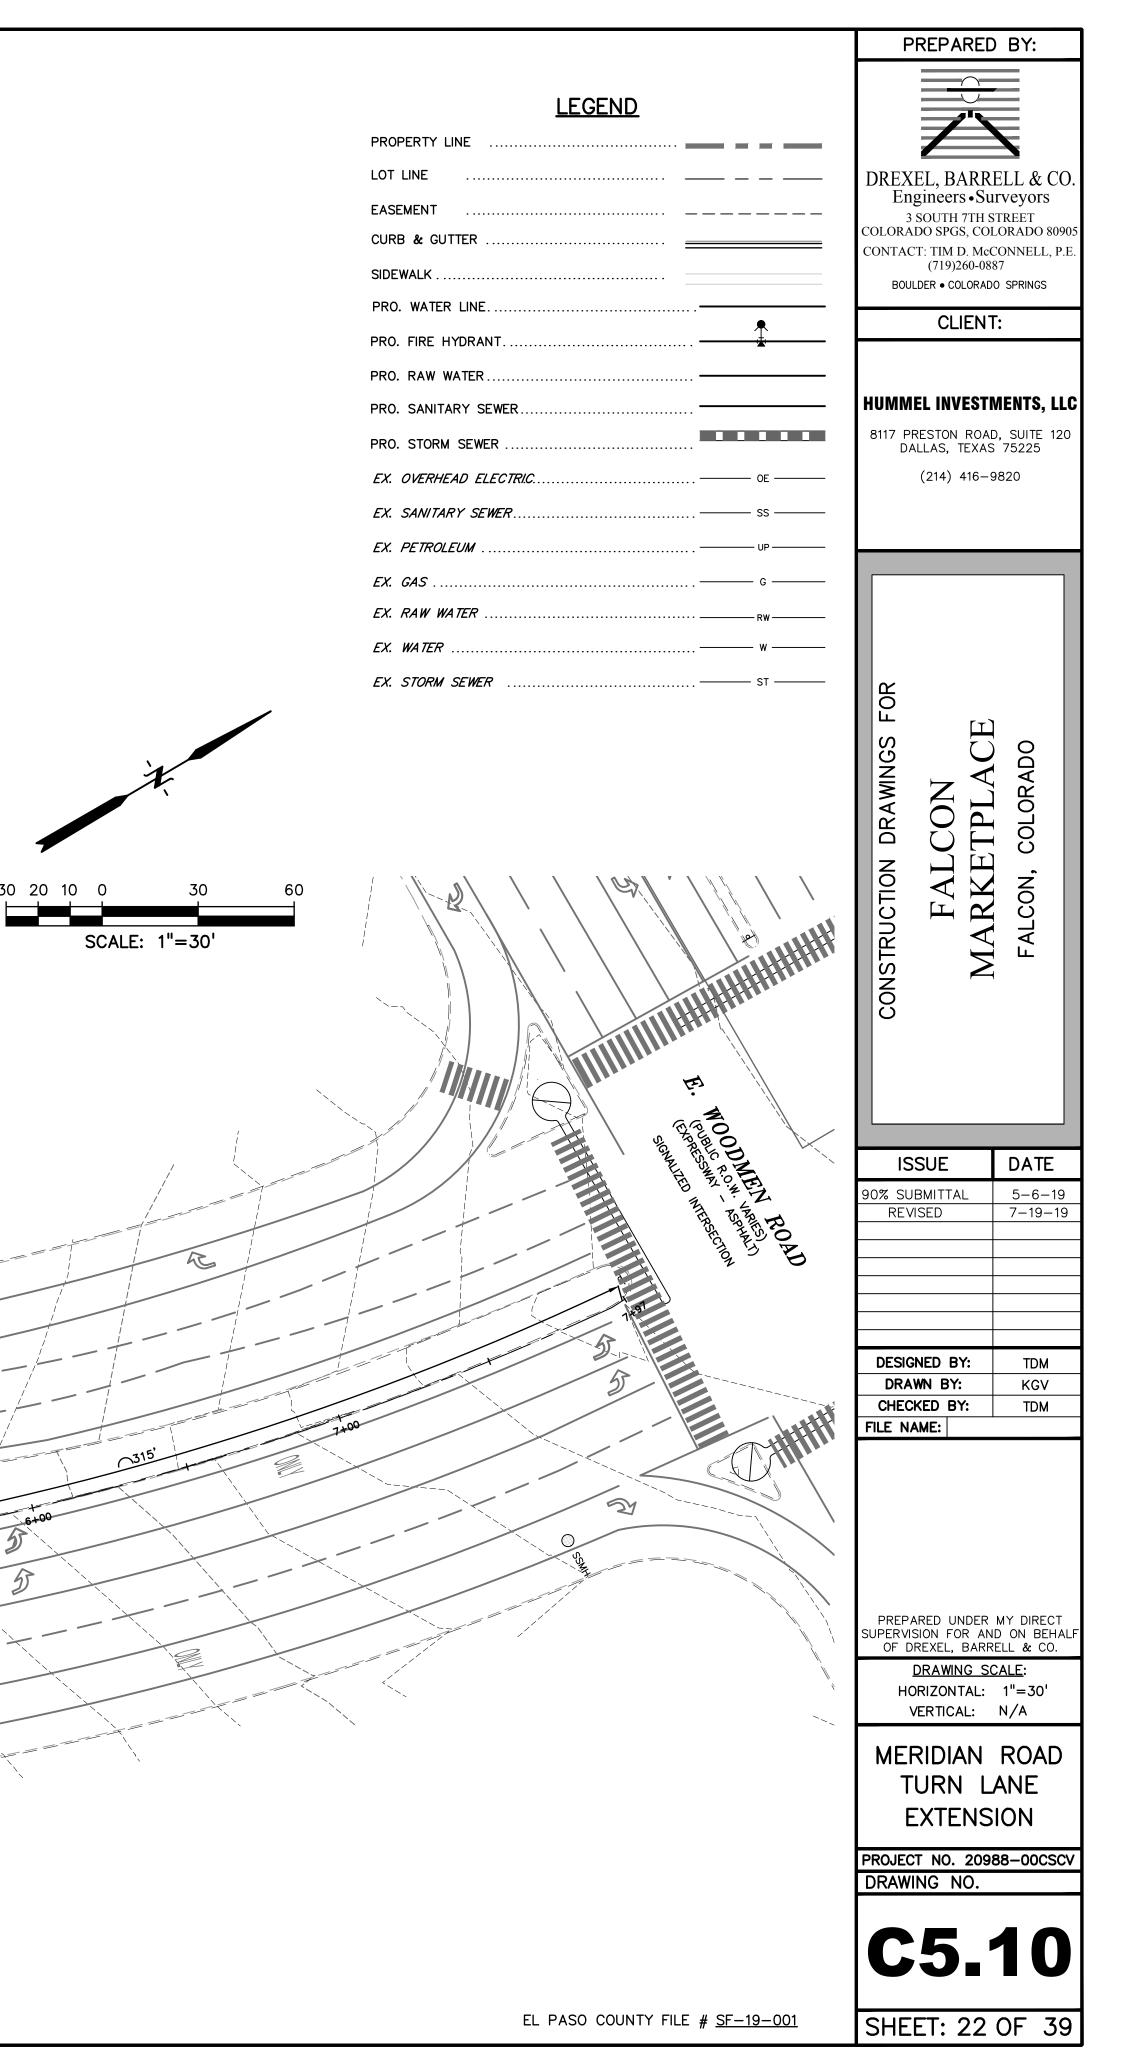
M.P.H.


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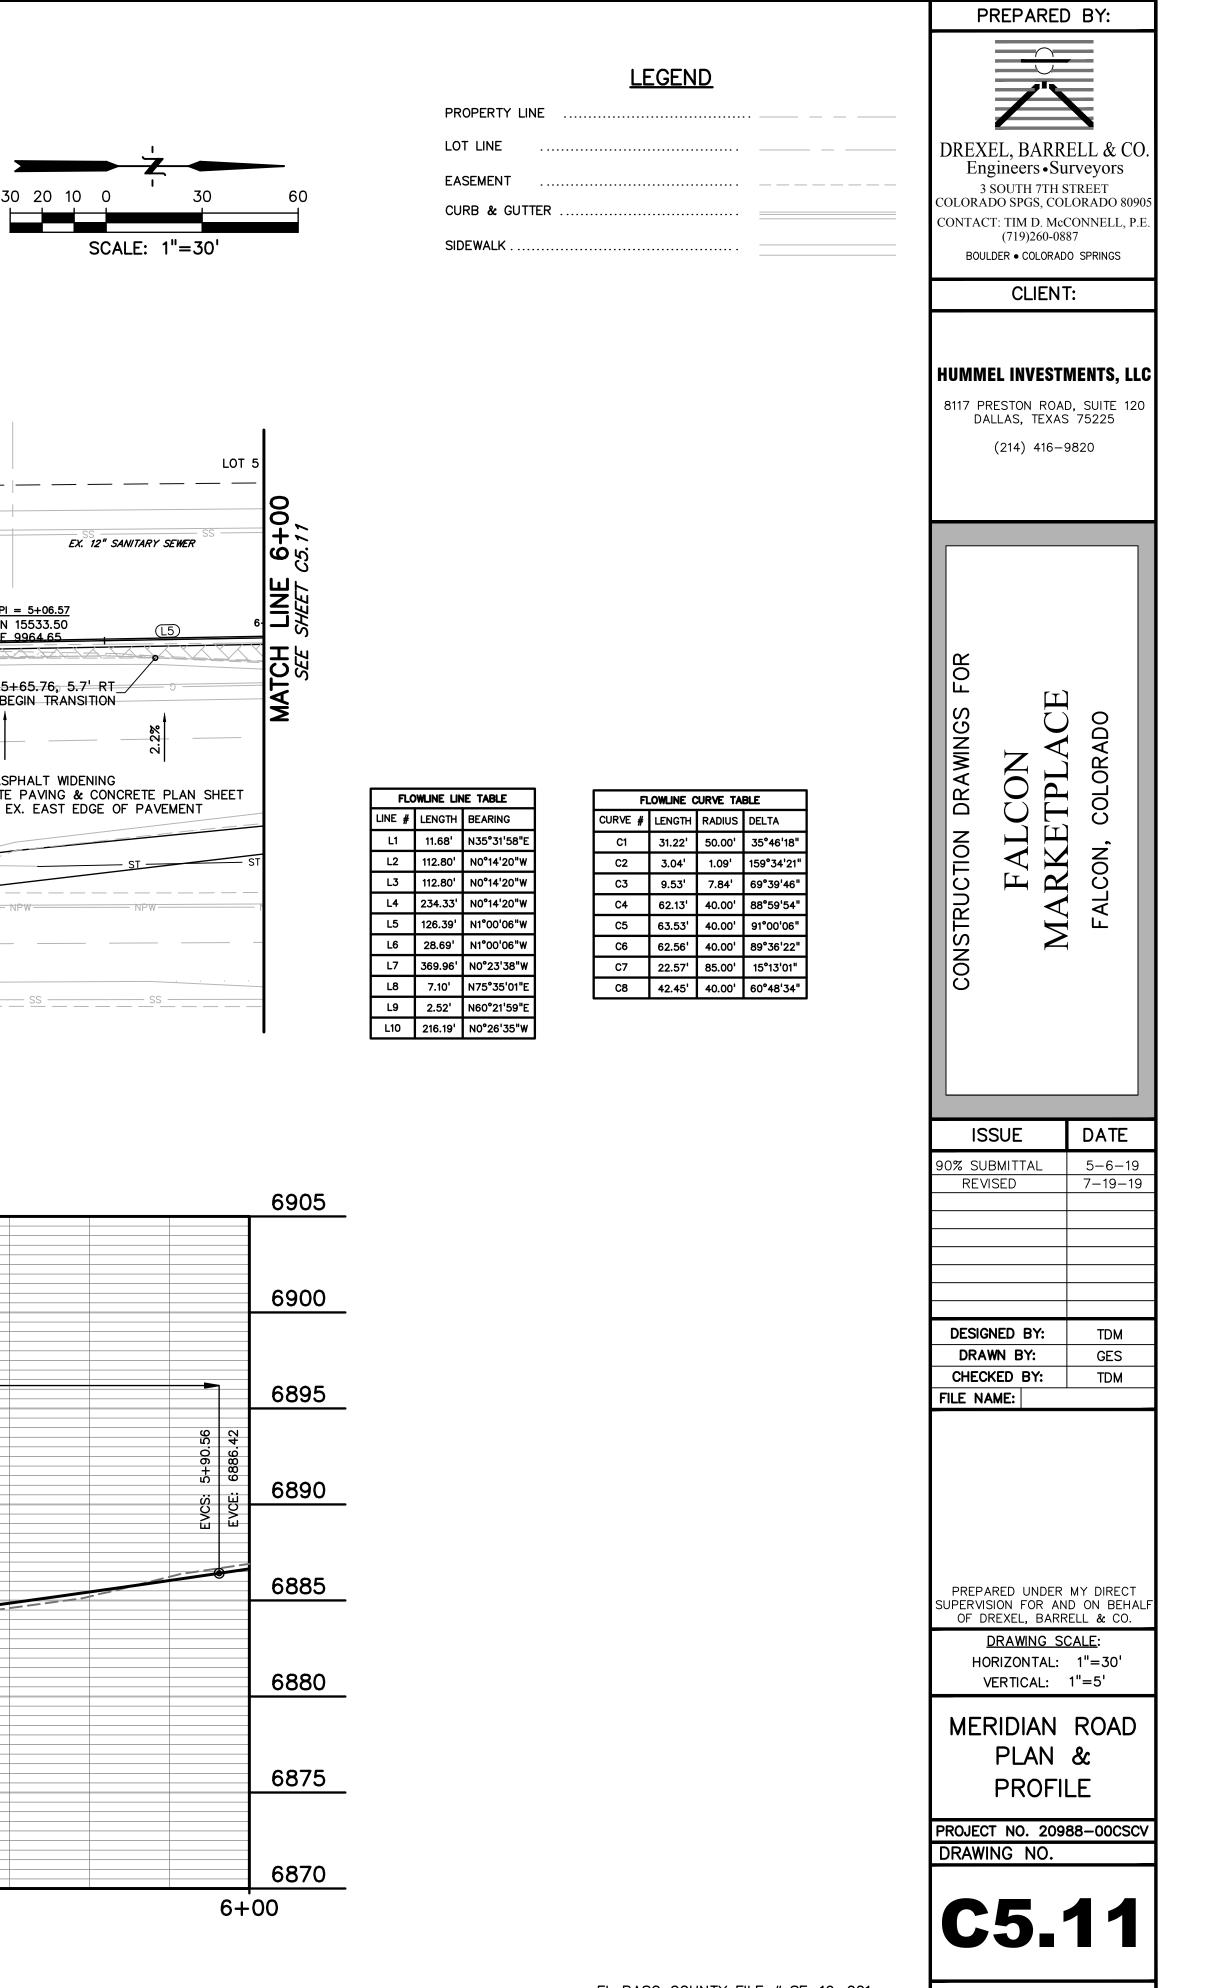
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EL PASO COUNTY FILE # <u>SF-19-001</u>








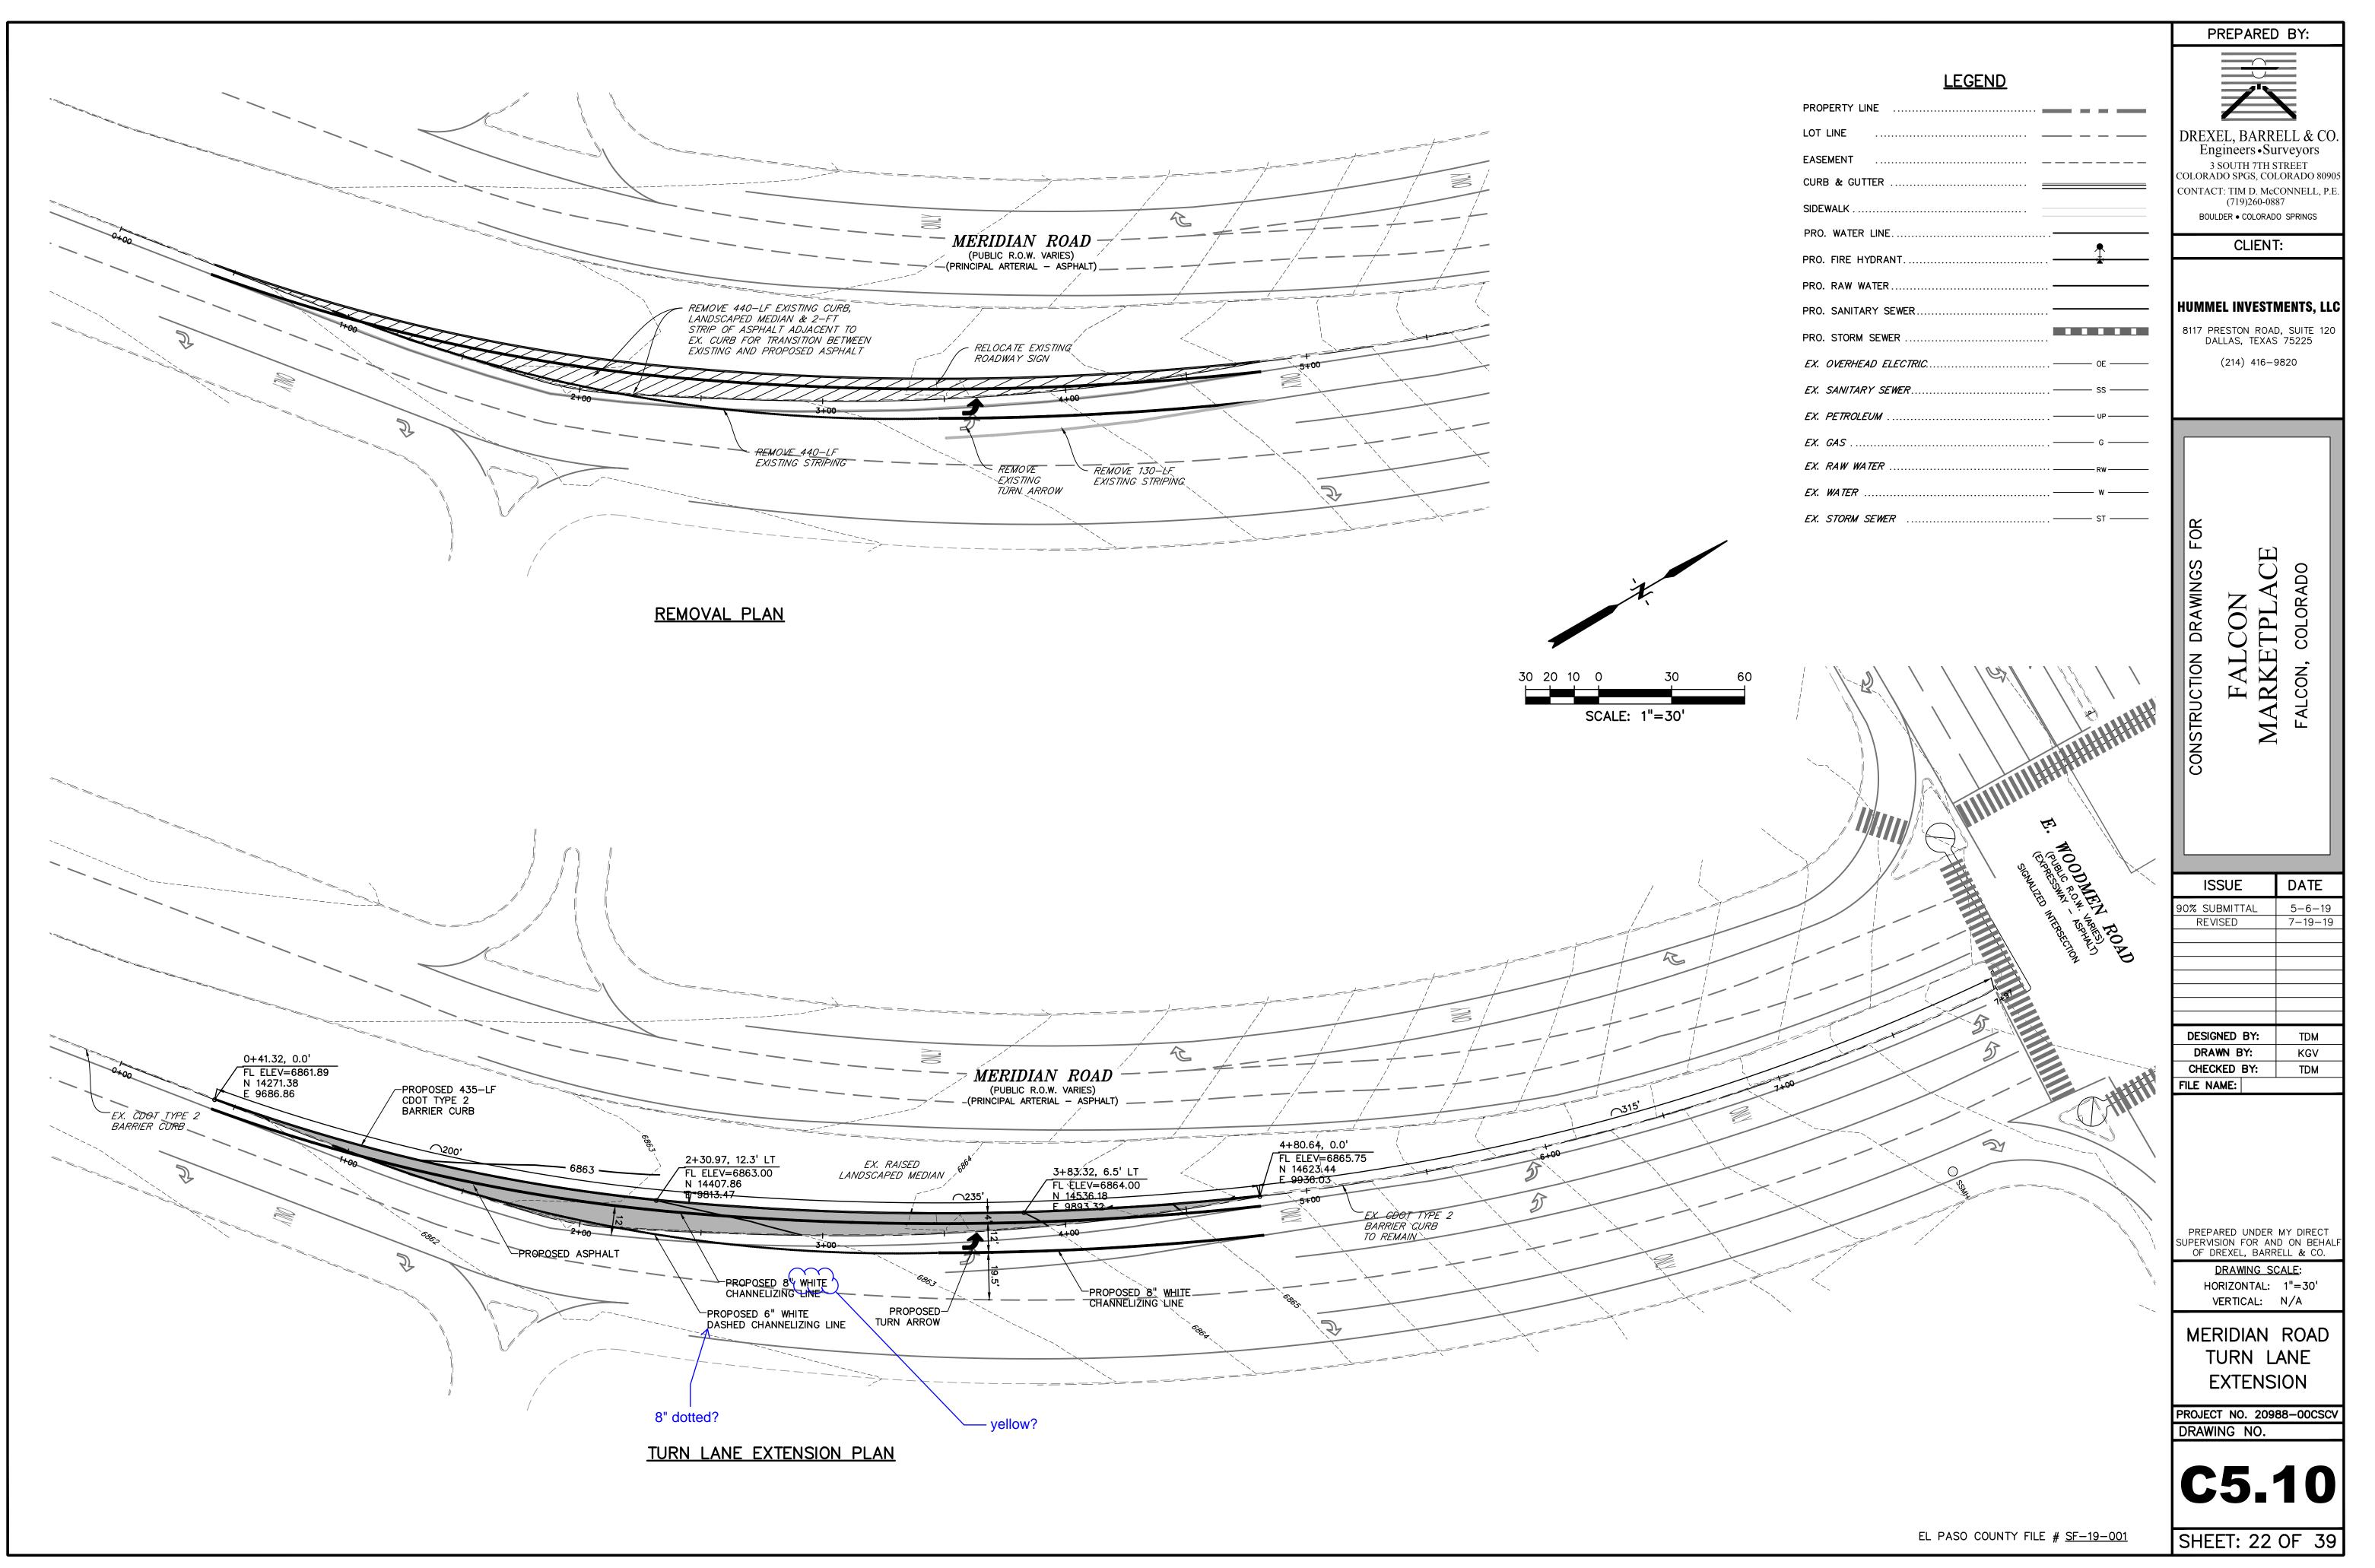
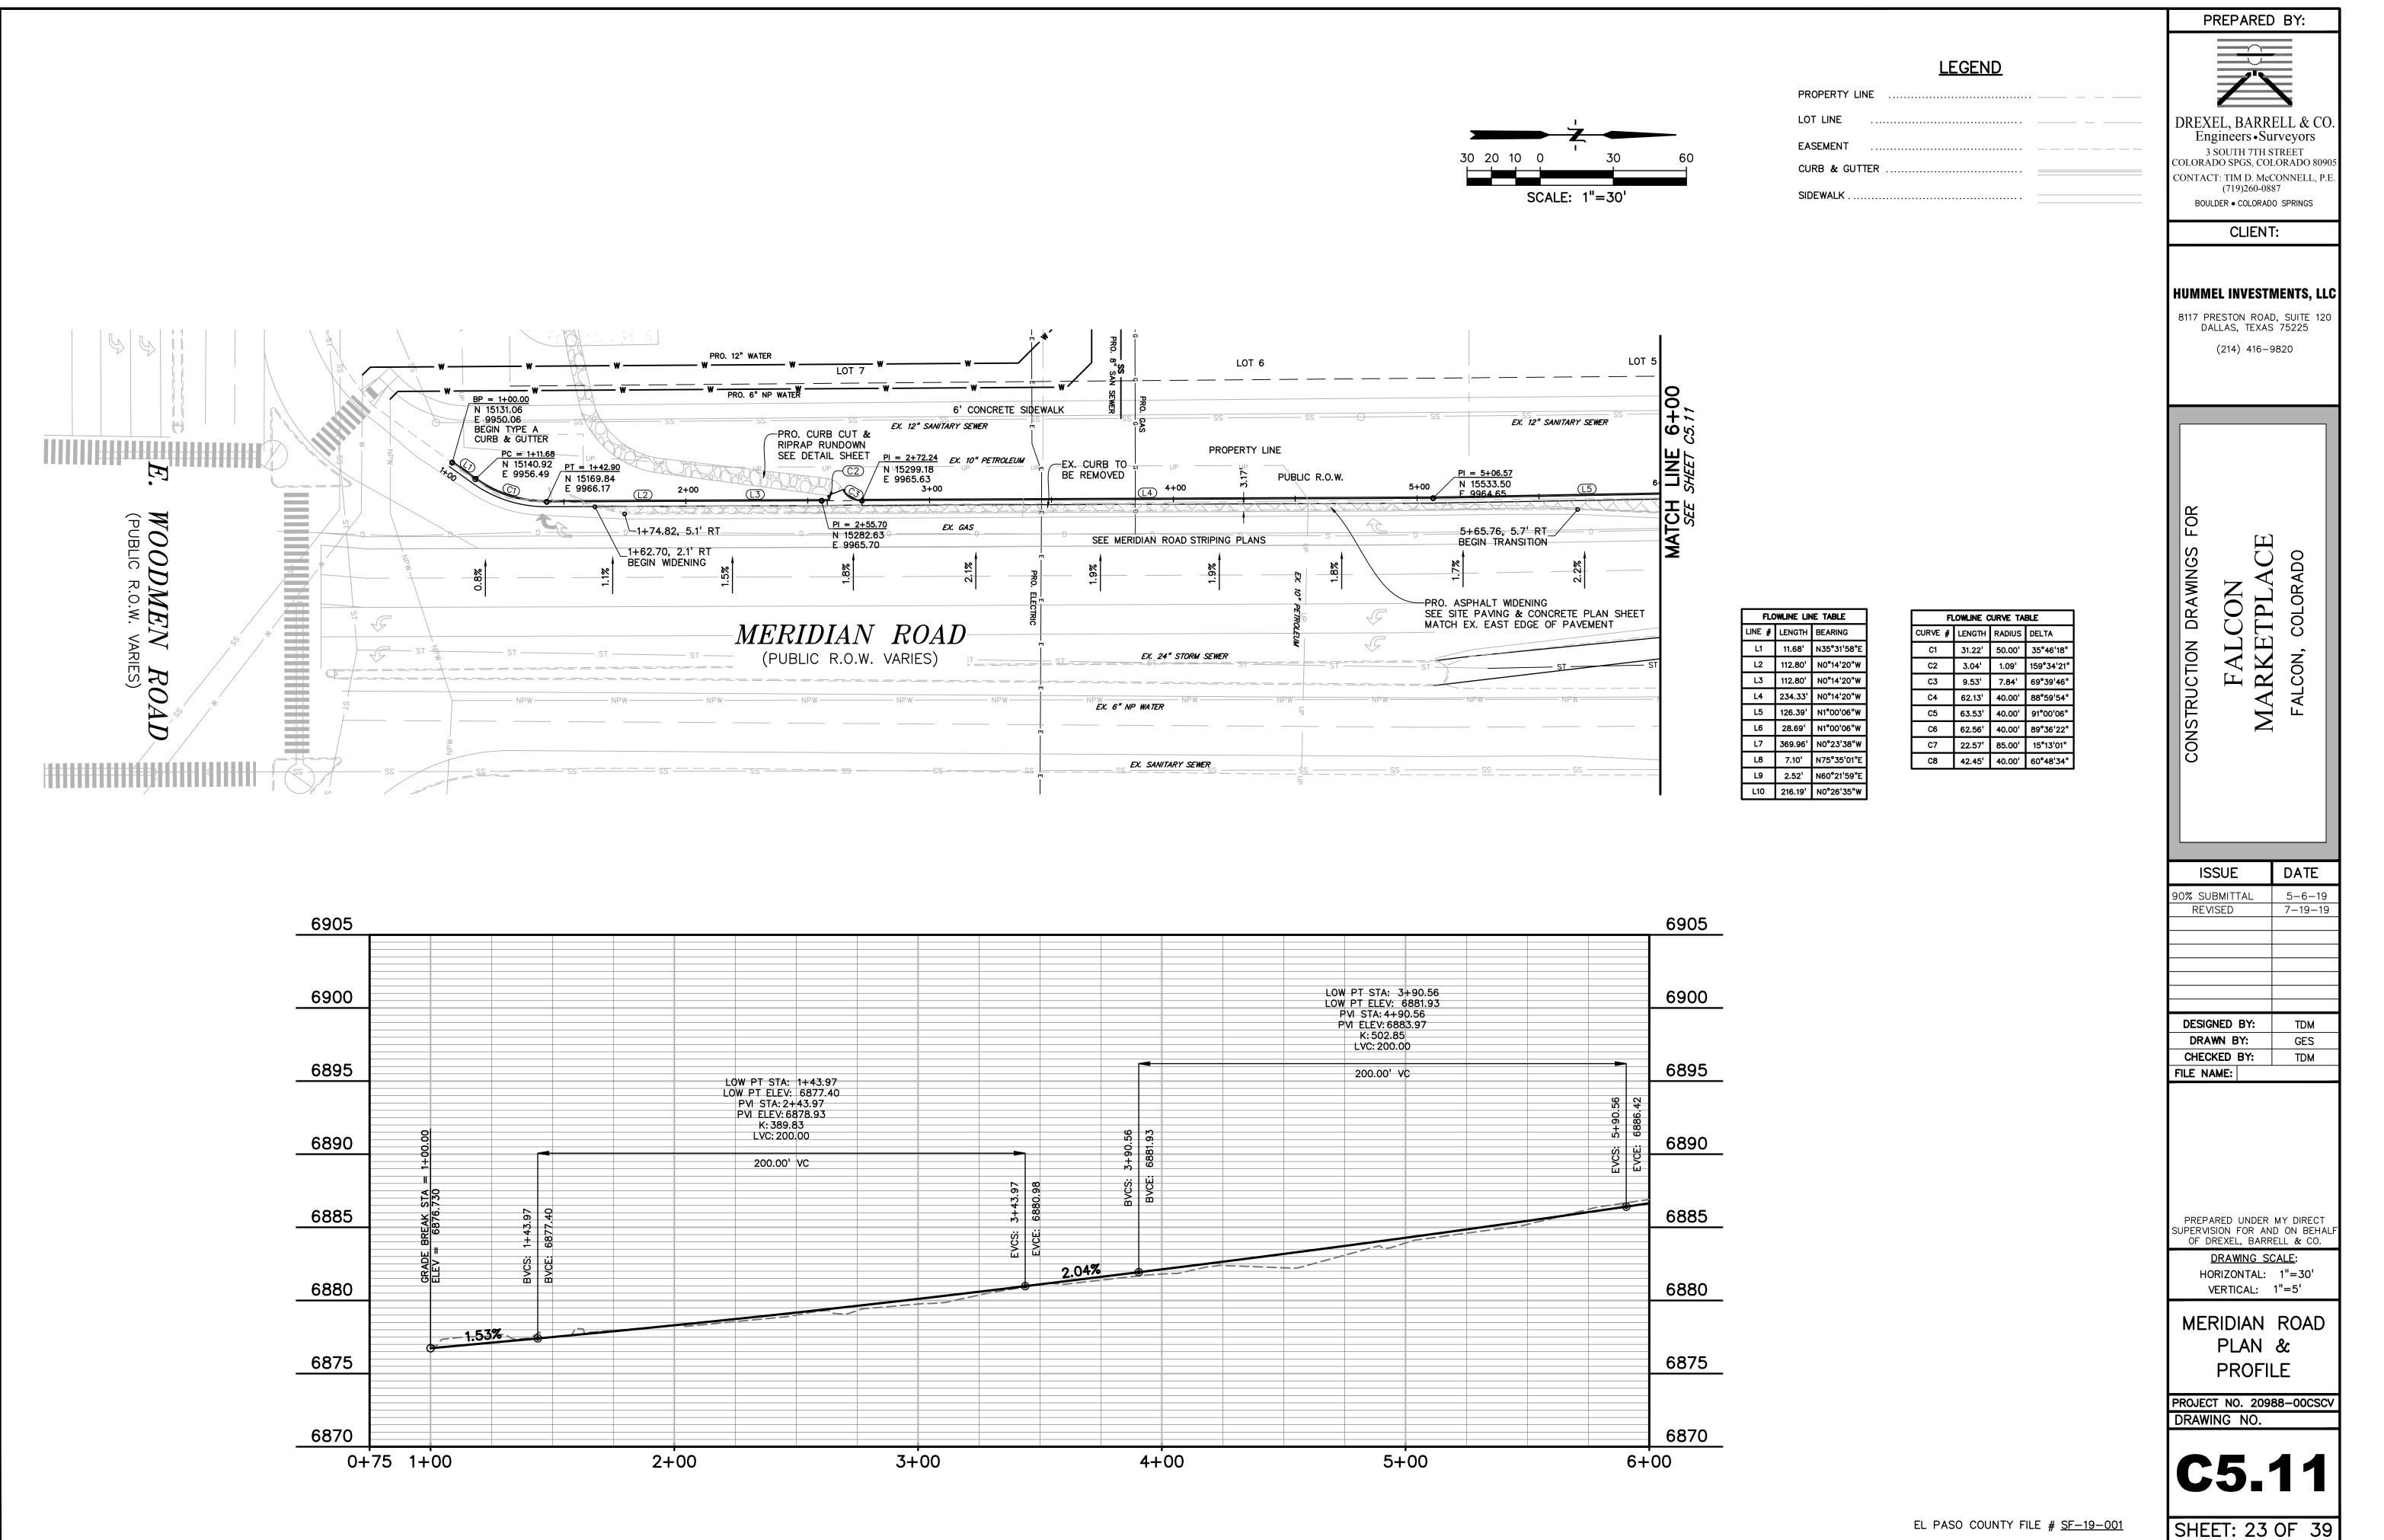
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0'	

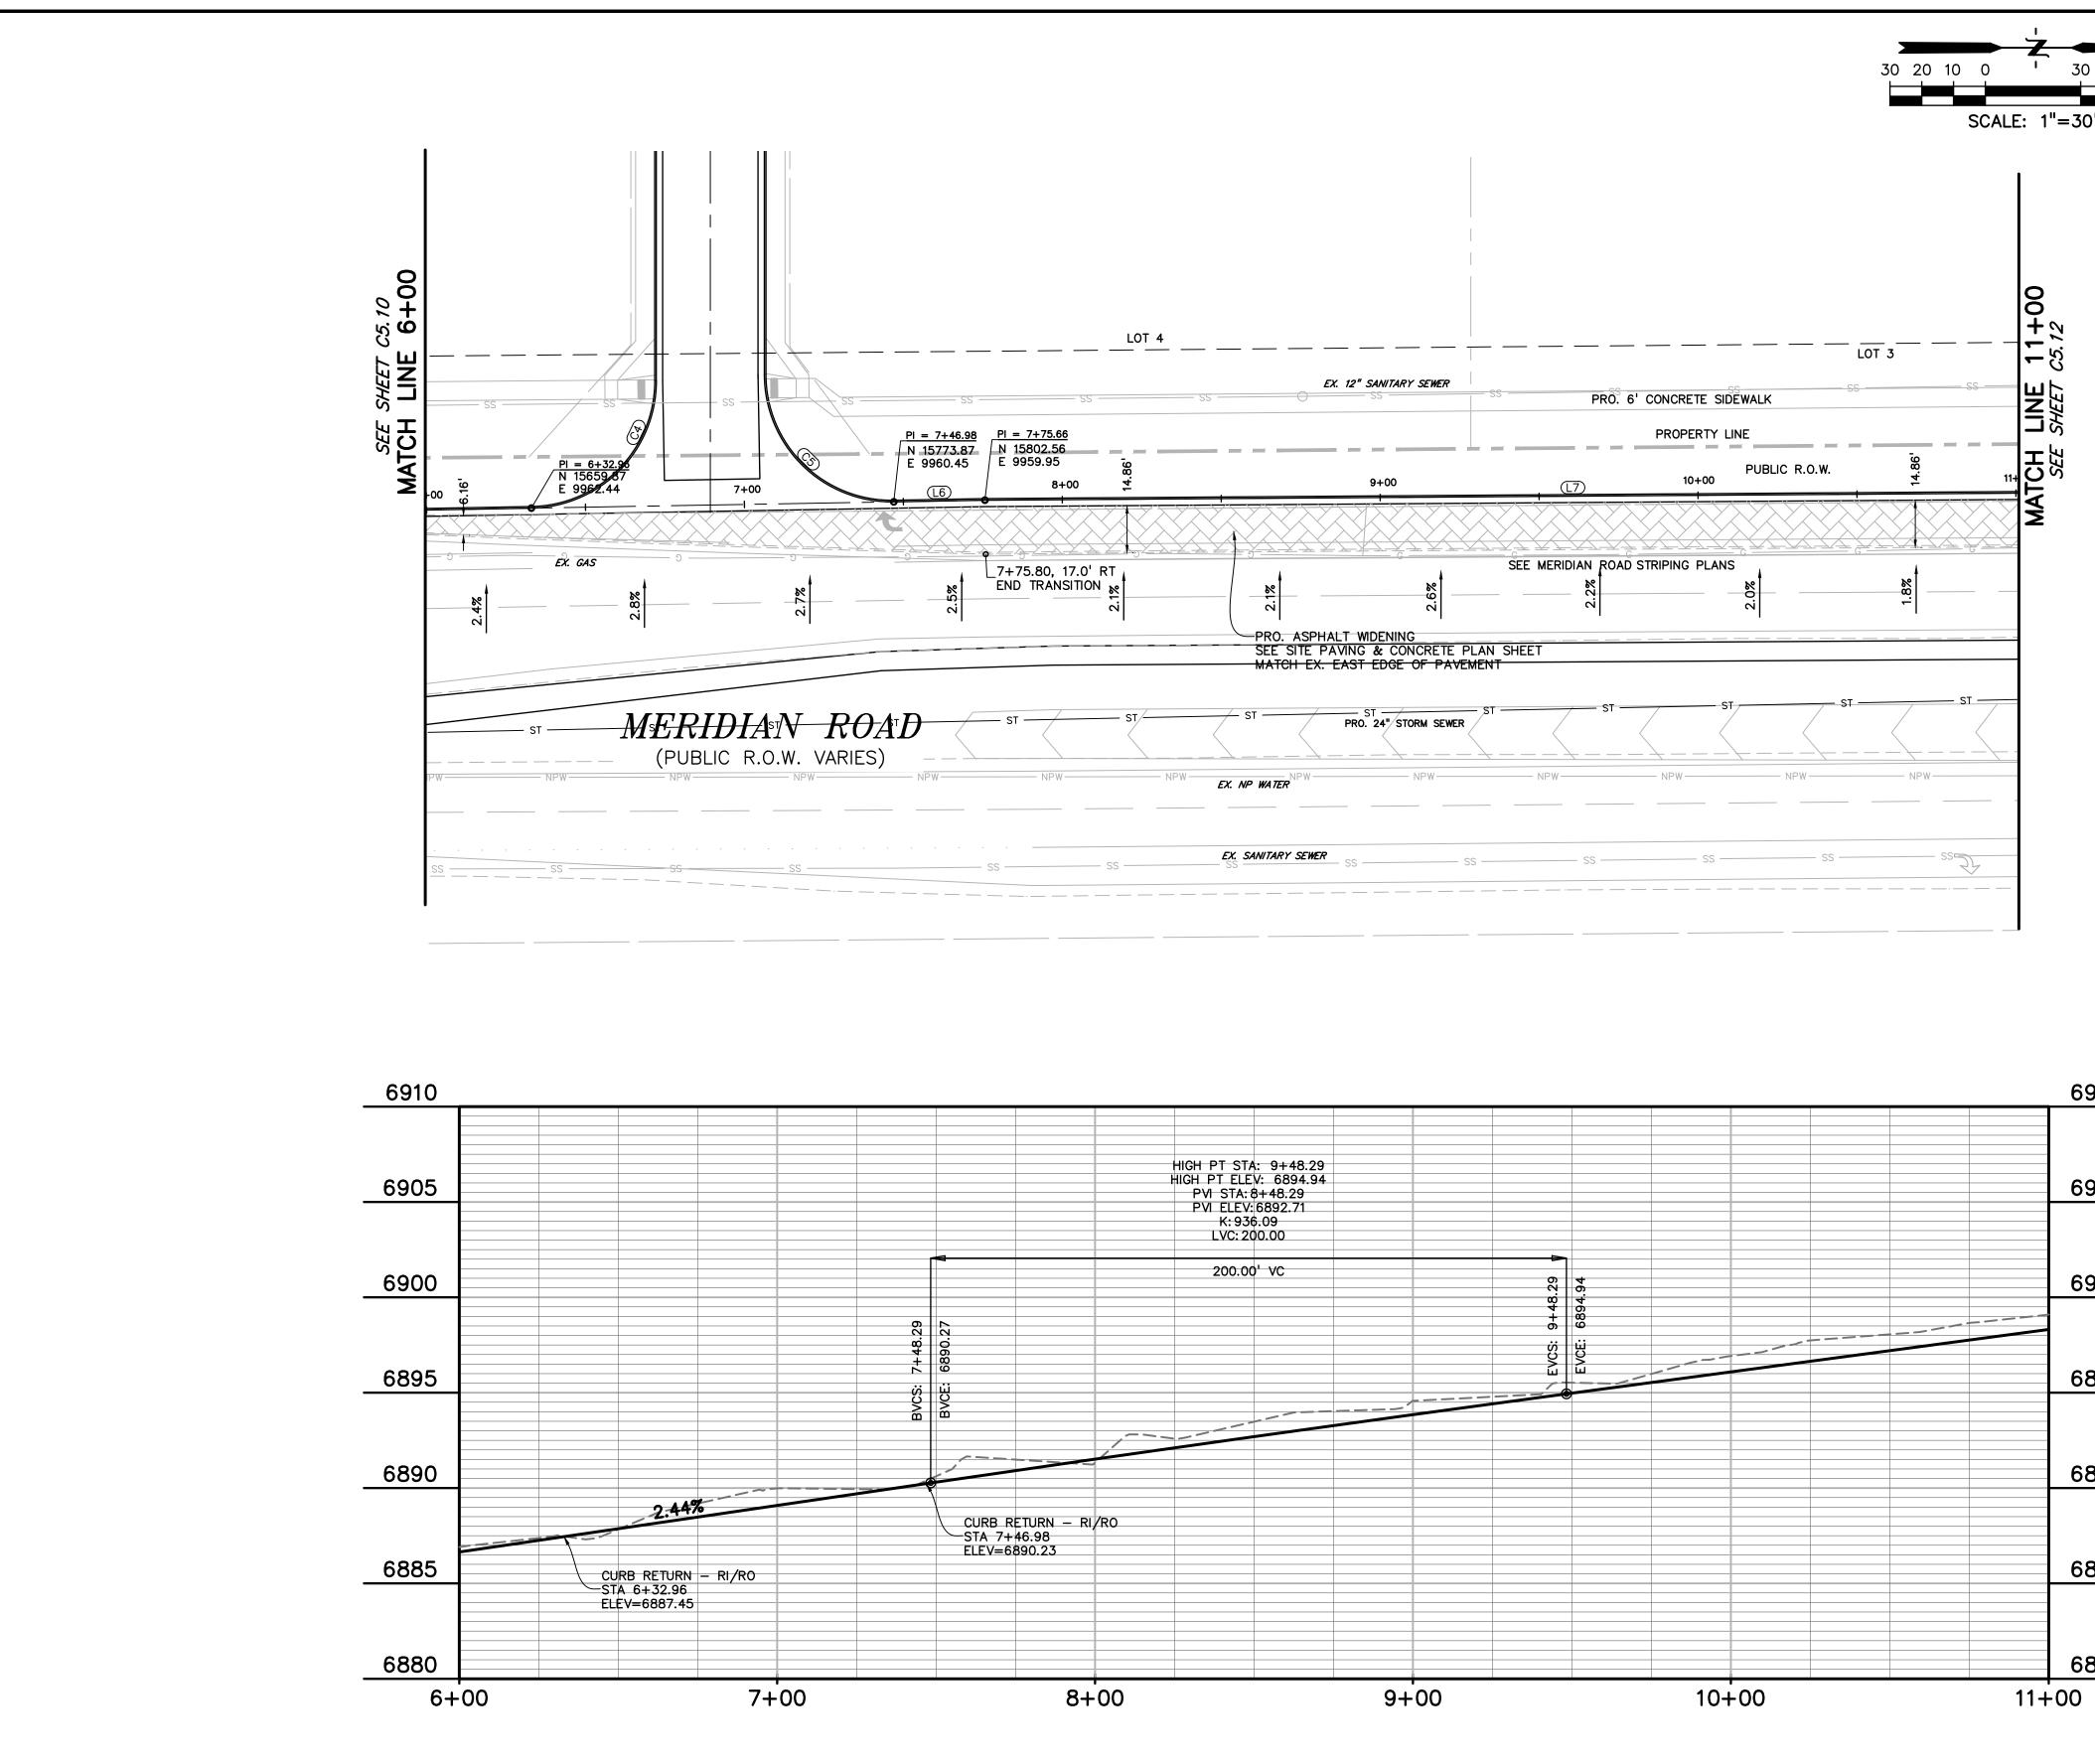LEGEND
PROPERTY LINE
LOT LINE
EASEMENT
CURB & GUTTER
SIDEWALK

PREPARED	ELL & CO. TVEYOTS TREET LORADO 80905 CONNELL, P.E. 87 0 SPRINGS WENTS, LLC 0, SUITE 120 5, 75225
CONSTRUCTION DRAWINGS FOR FALCON MARKETPLACE	FALCON, COLORADO
	DATE
90% SUBMITTAL REVISED	5-6-19 7-19-19
DESIGNED BY: DRAWN BY: CHECKED BY:	TDM GES TDM
FILE NAME:	
PREPARED UNDER SUPERVISION FOR AN OF DREXEL, BARR DRAWING SC HORIZONTAL:	D ON BEHALF ELL & CO. CALE: 1"=30'
VERTICAL: MERIDIAN PLAN PROFII	ROAD &
PROJECT NO. 2098 DRAWING NO.	88-00CSCV
C5 .	12

SHEET: 24 OF 39

FLOWLINE LINE TABLE						
LINE #	LENGTH	BEARING				
L1	11.68'	N35°31'58"E				
L2	112.80'	N0°14'20"W				
L3	112.80'	N0°14'20"W				
L4	234.33'	N0°14'20"W				
L5	126.39'	N1°00'06"W				
L6	28.69'	N1°00'06"W				
L7	369.96'	N0°23'38"W				
L8	7.10'	N75°35'01"E				
L9	2.52'	N60°21'59"E				
L10	216.19'	N0°26'35"W				

FI.	FLOWLINE CURVE TABLE						
CURVE #	LENGTH	RADIUS	DELTA				
C1	31.22'	50.00'	35°46'18"				
C2	3.04'	1.09'	159°34'21"				
C3	9.53'	7.84'	69°39'46"				
C4	62.13'	40.00'	88°59'54"				
C5	63.53'	40.00'	91°00'06"				
C6	62.56'	40.00'	89°36'22"				
C7	22.57'	85.00'	15°13'01"				
C8	42.45'	40.00'	60°48'34"				

6910

6905


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6895


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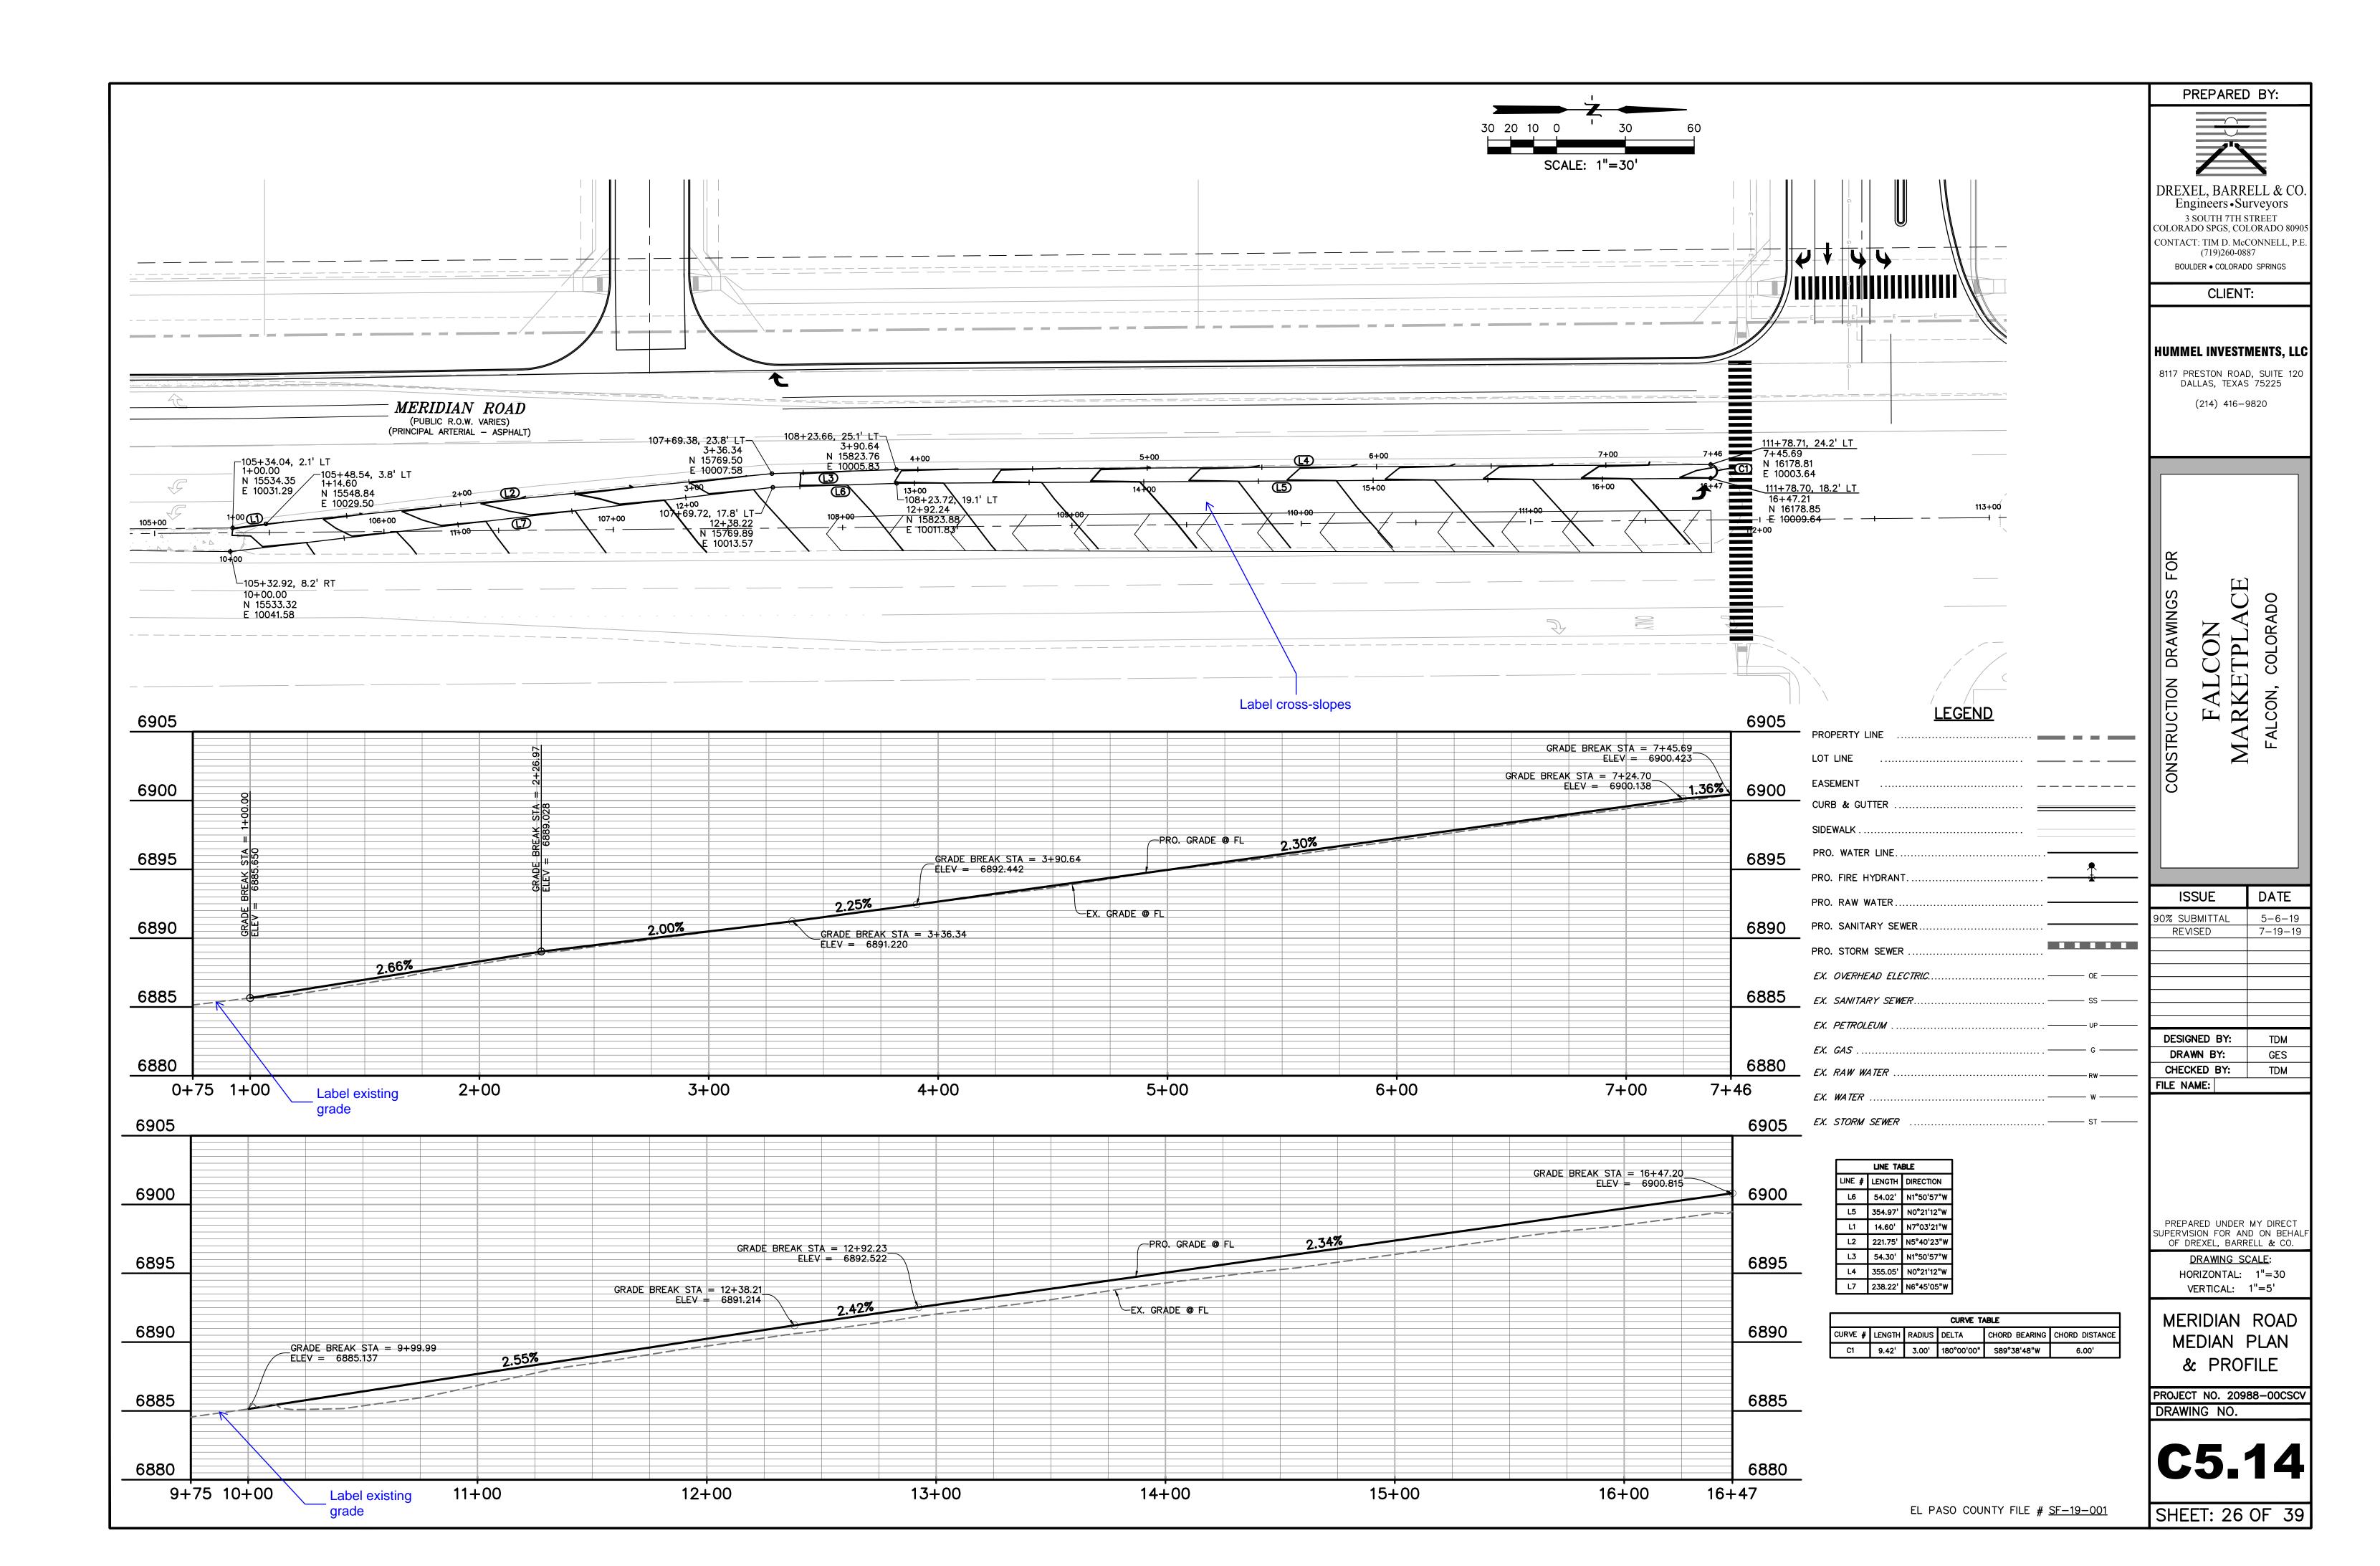
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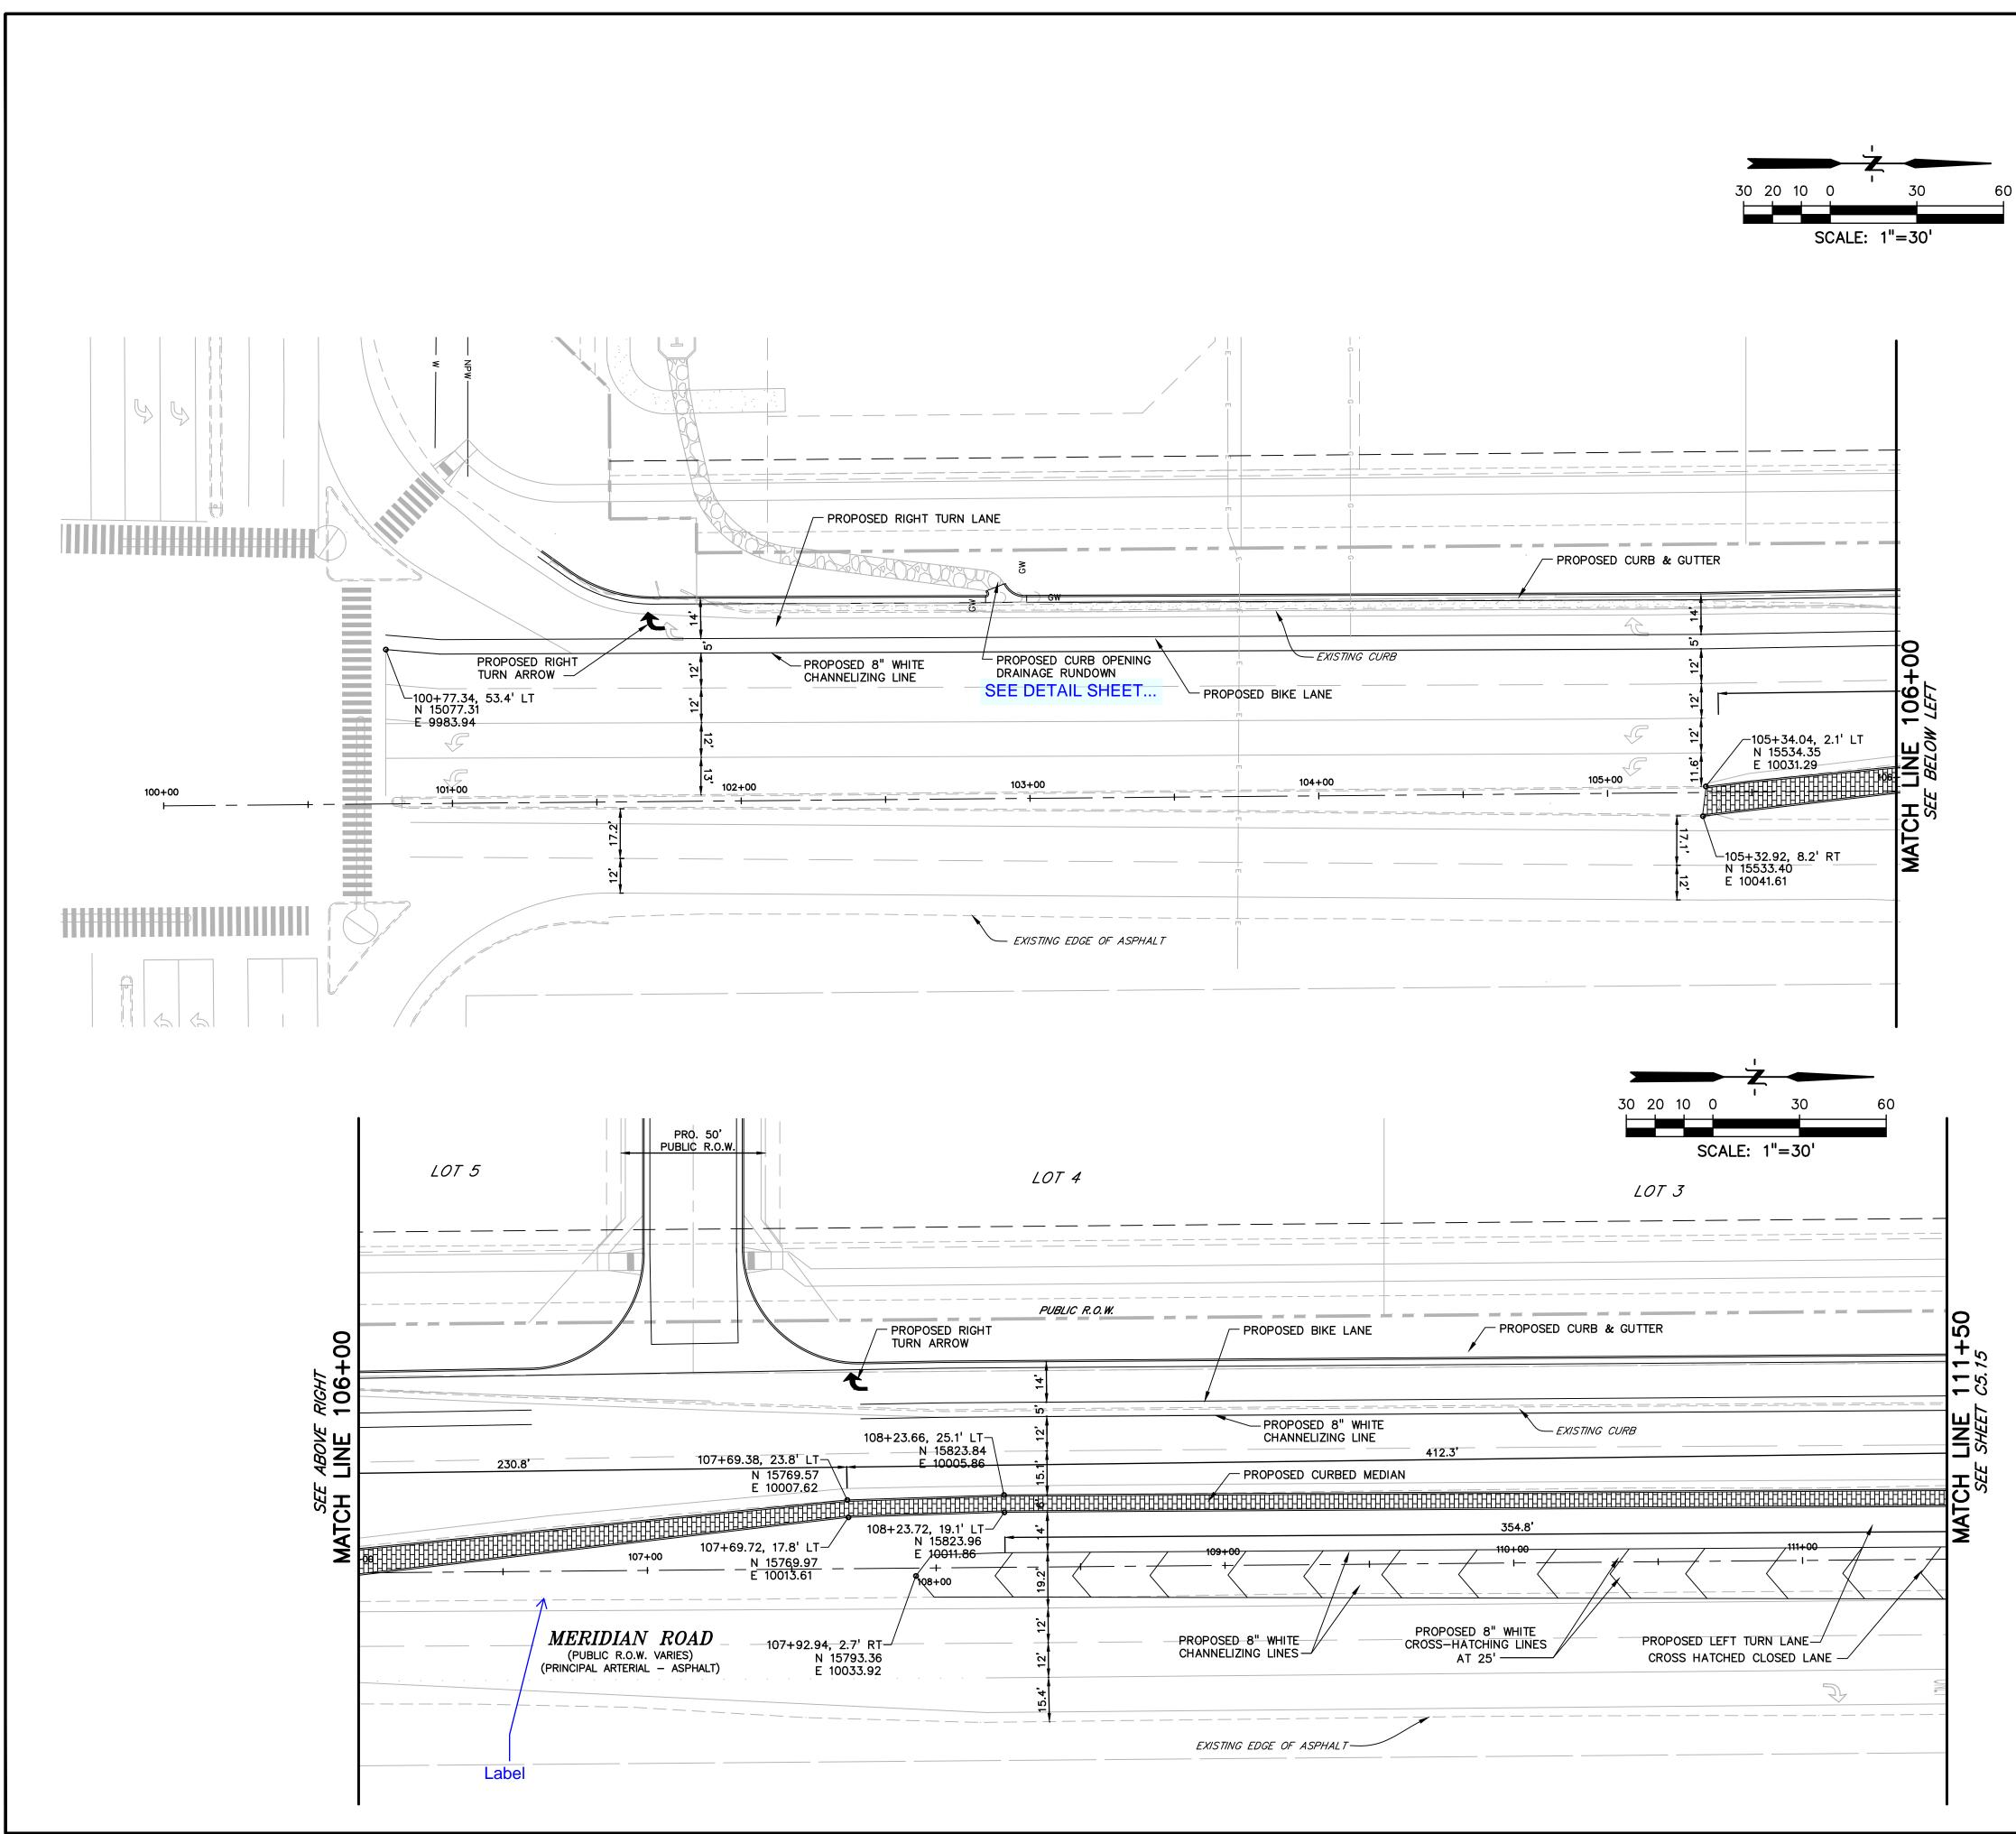
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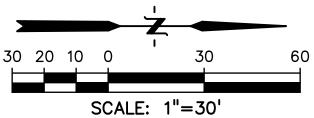


						30 20 10	
	ξ	Show and label utilitie	es.	It appears th need to be r to meet drive requirement detail and ea	s. Provide		SCALE: 1"=:
PROPERTY LI	INE	LOT 15 FALCON RANCHETTES	PI = 15+ N 16543 E 9954. END TYL CURB_&		/AY DTECTED 16+00		
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ROAD VARIES) NPW SS							
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	200.00' VC		EVCE: 6906.88		1.88%		
RN – EASTONVIL 62 .87			Image: Constraint of the sector of				
	14+00		15+00		16+00		17+00





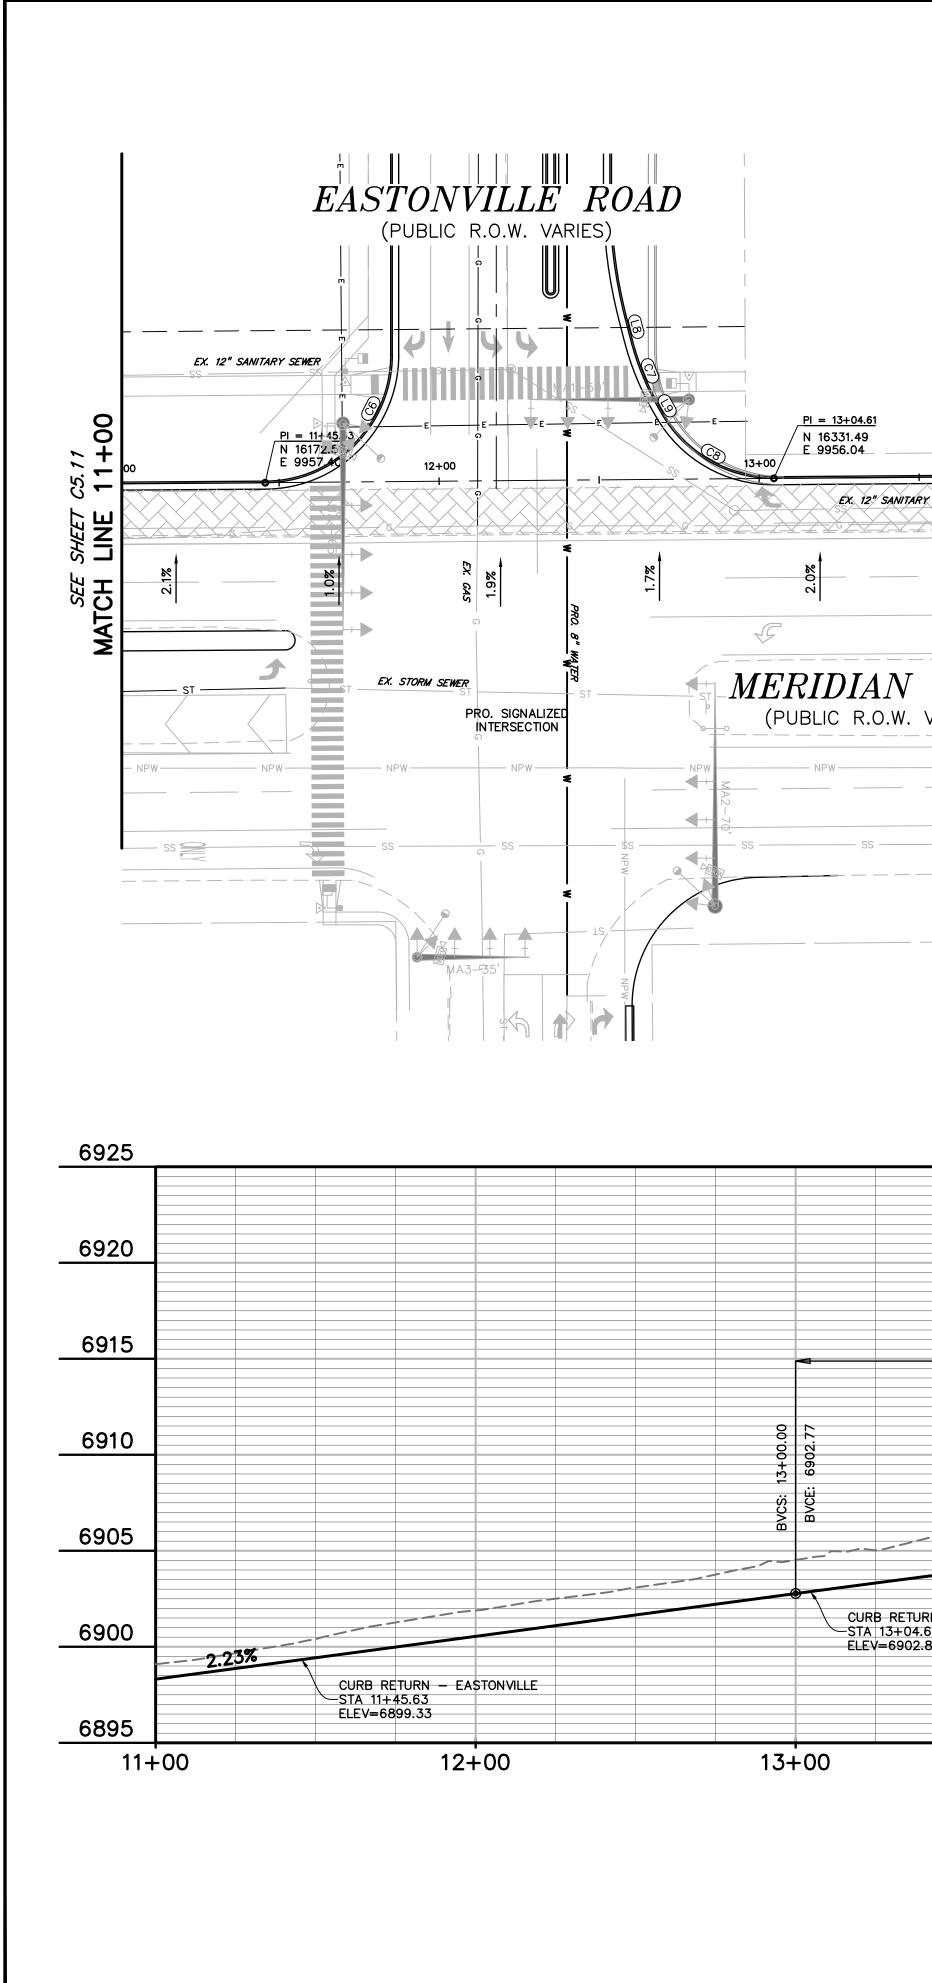


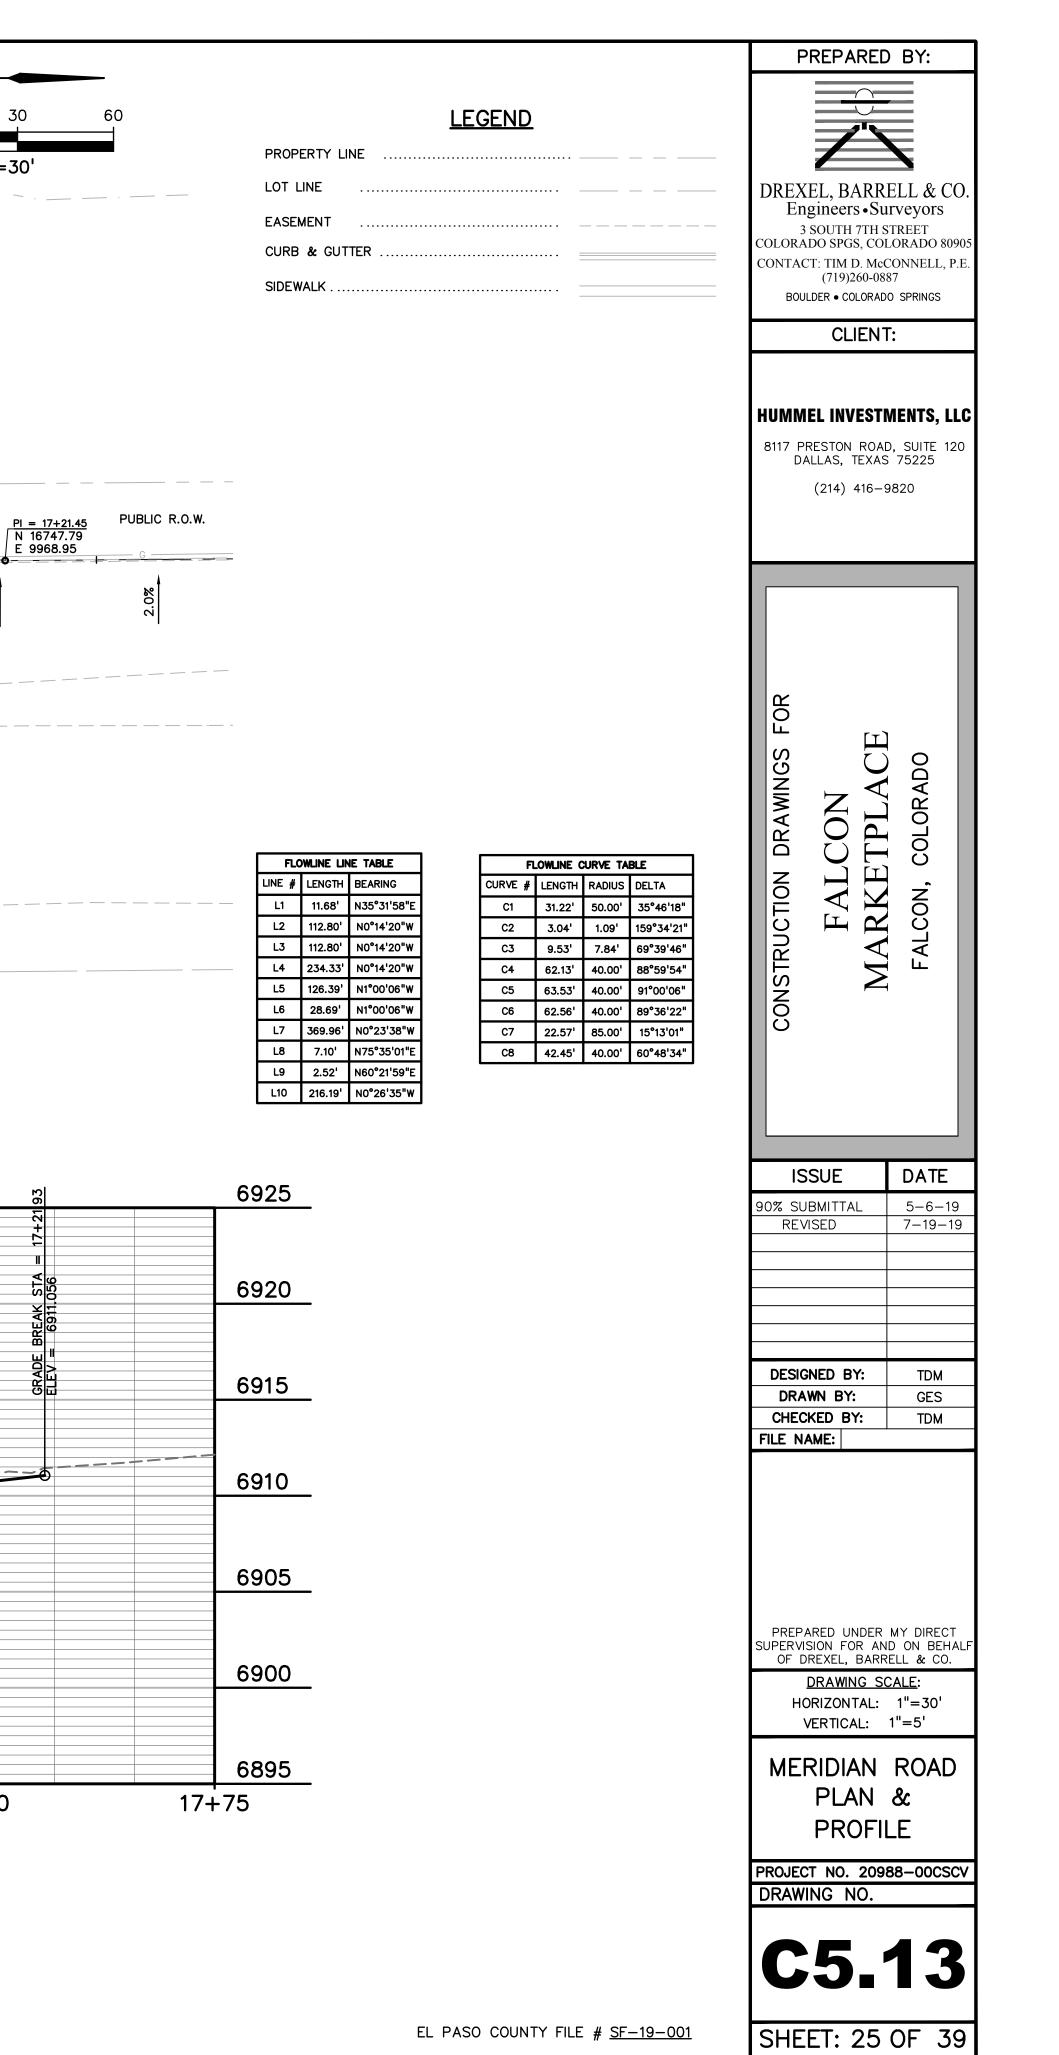





PROPERTY LINE


LOT LINE	
EASEMENT	
CURB & GUTTER	
SIDEWALK	
PRO. WATER LINE	
PRO. FIRE HYDRANT	
PRO. RAW WATER	
PRO. SANITARY SEWER	
PRO. STORM SEWER	
PRO. STORM SEWER	• • • • • • • • • • • • • • • • • • •
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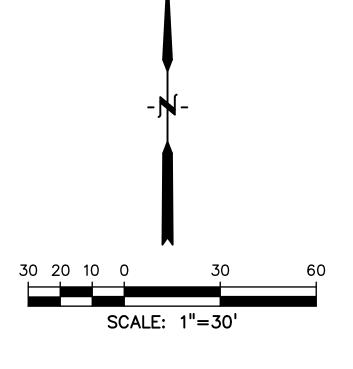


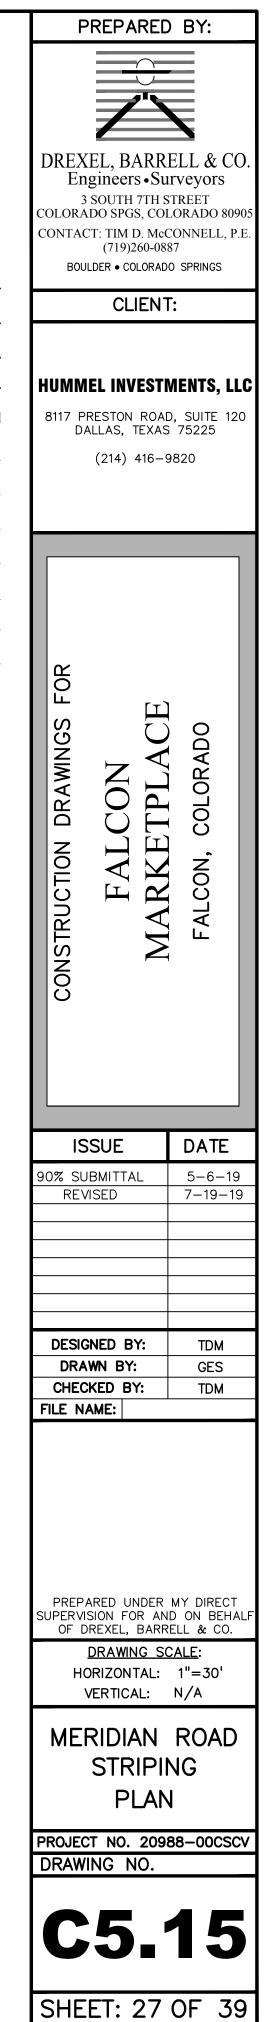
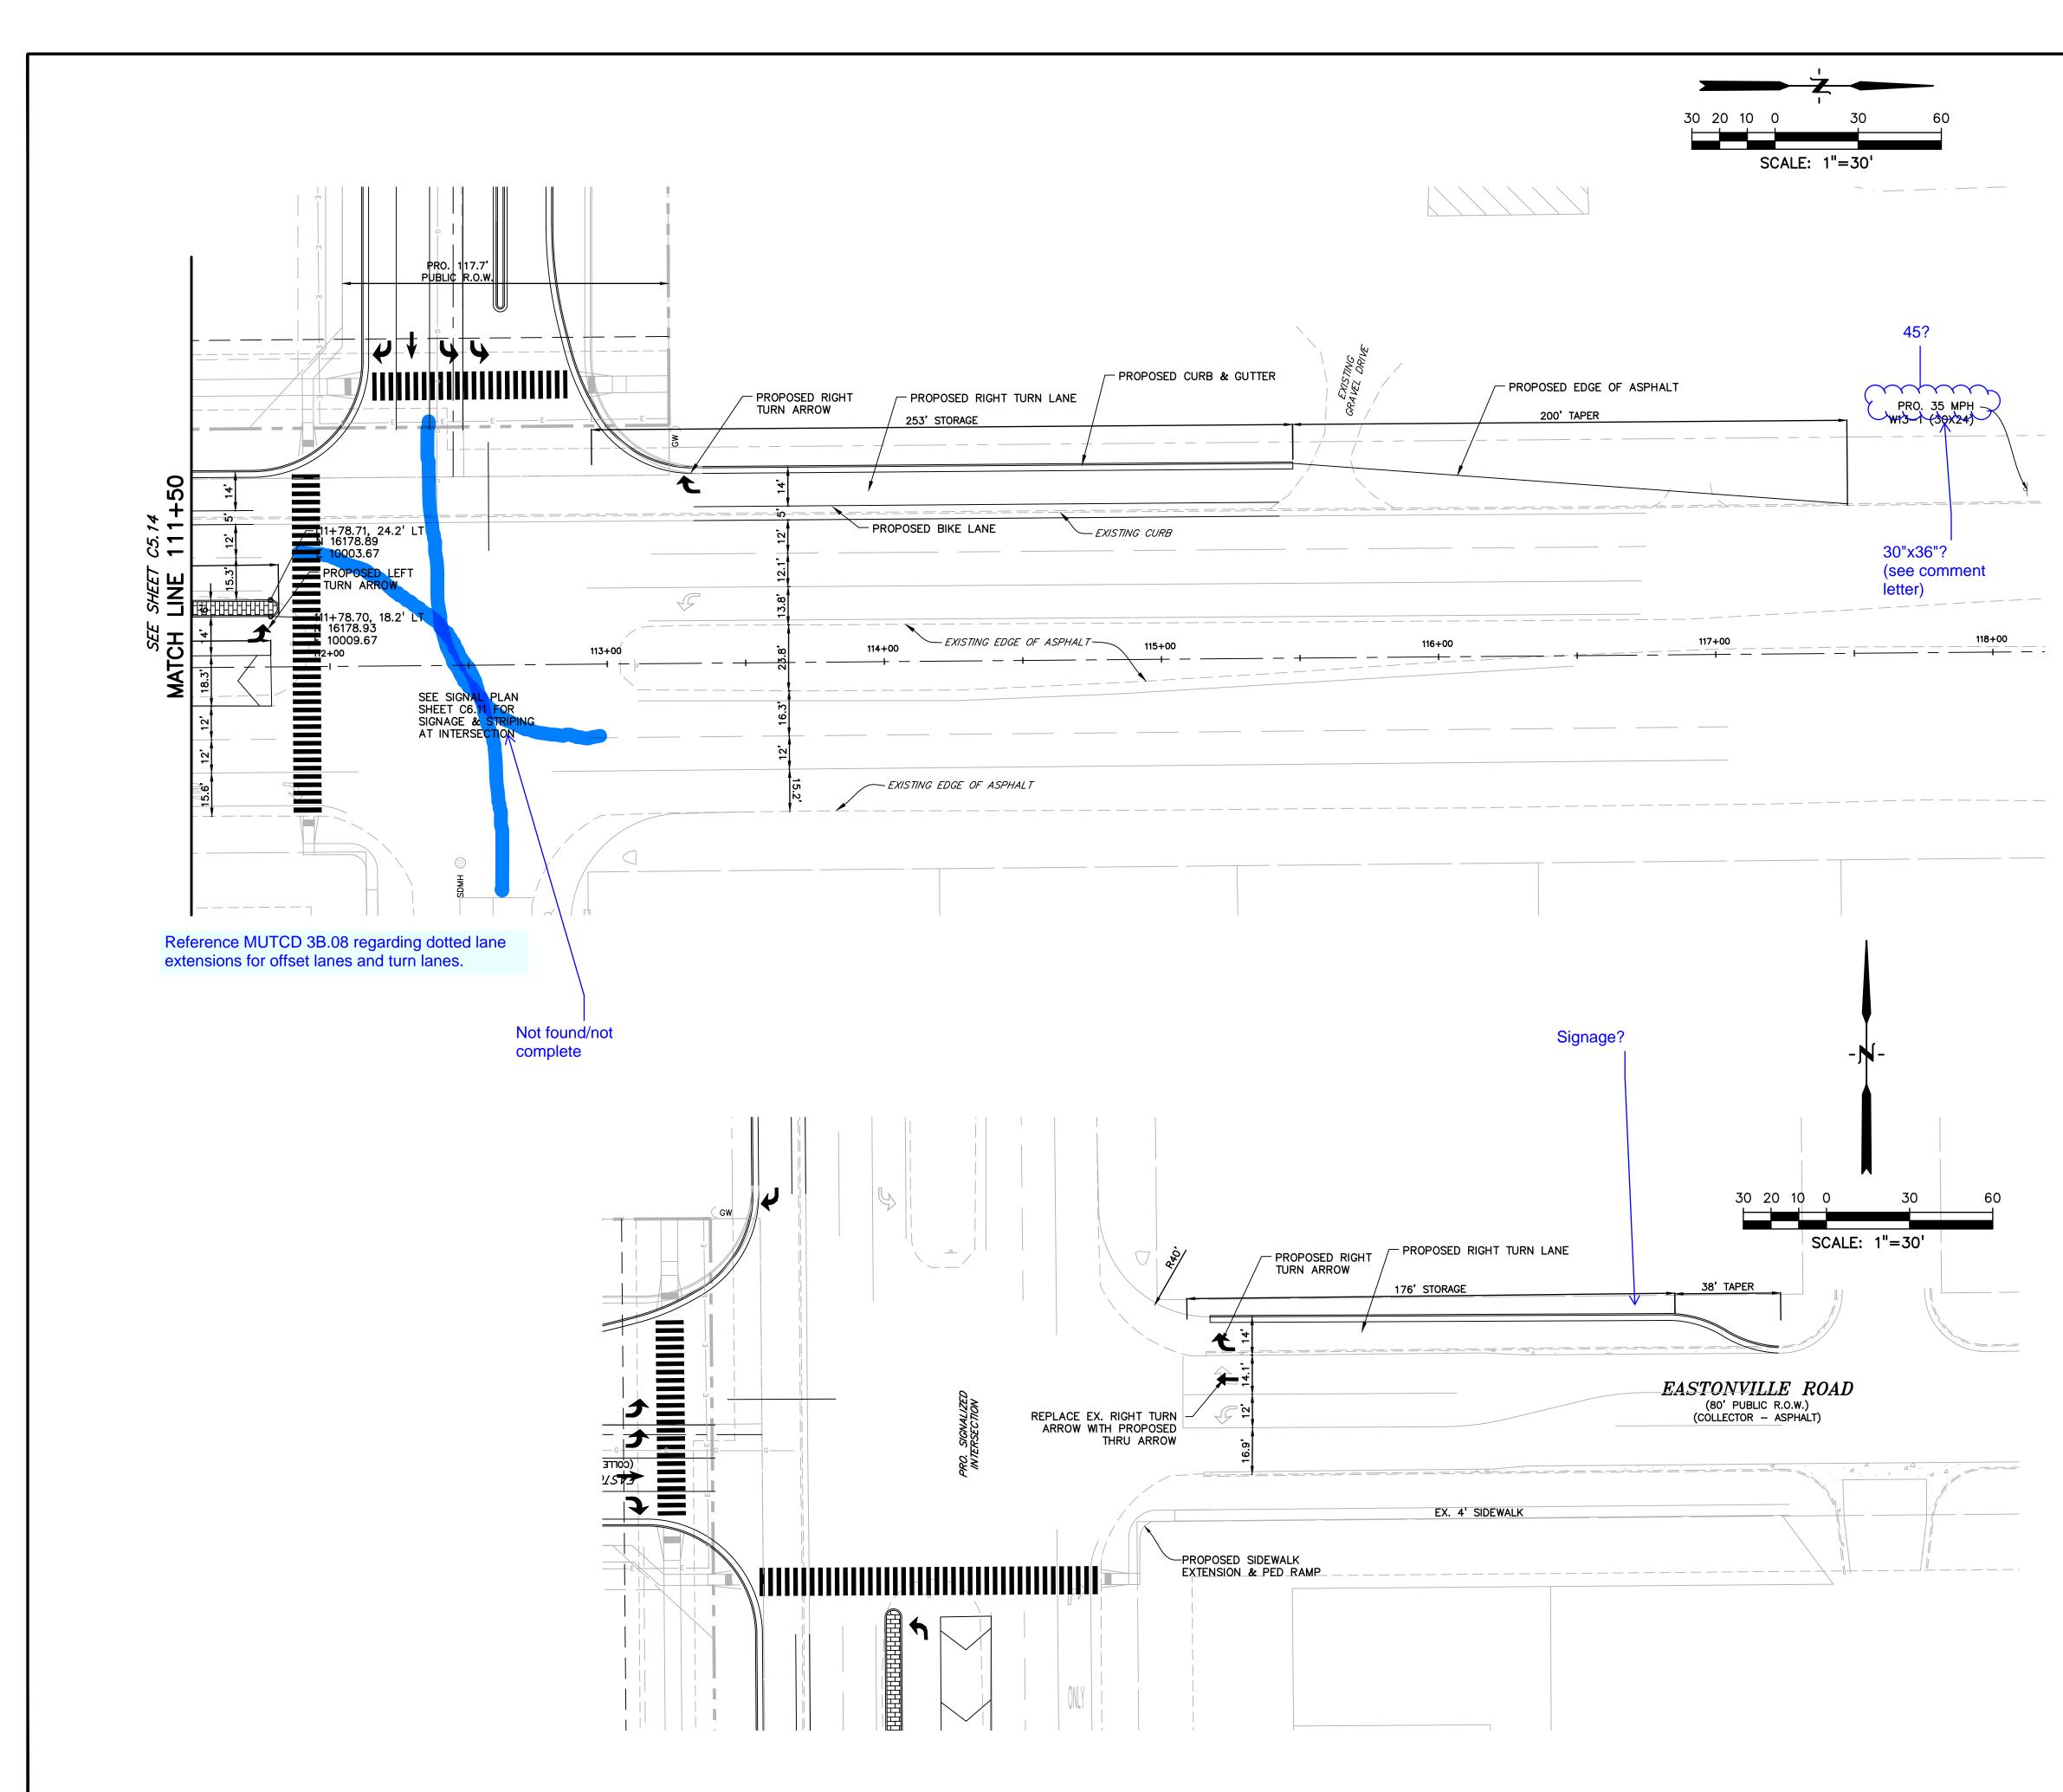
<u>LEGEND</u>	
PROPERTY LINE	
LOT LINE	
EASEMENT	
CURB & GUTTER	
SIDEWALK	
PRO. WATER LINE	
PRO. FIRE HYDRANT	
PRO. RAW WATER	
PRO. SANITARY SEWER	
PRO. STORM SEWER	
EX. OVERHEAD ELECTRIC	— OE ———
EX. SANITARY SEWER	— ss ———
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EX. GAS	— G ———
EX. RAW WATER	RW
EX. WATER	— w ——
EX. STORM SEWER	— st ———



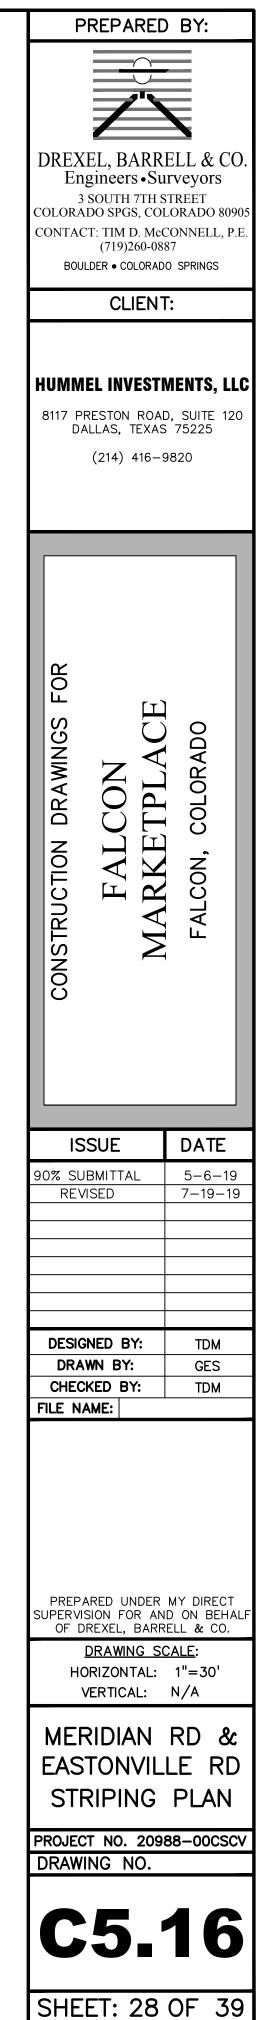


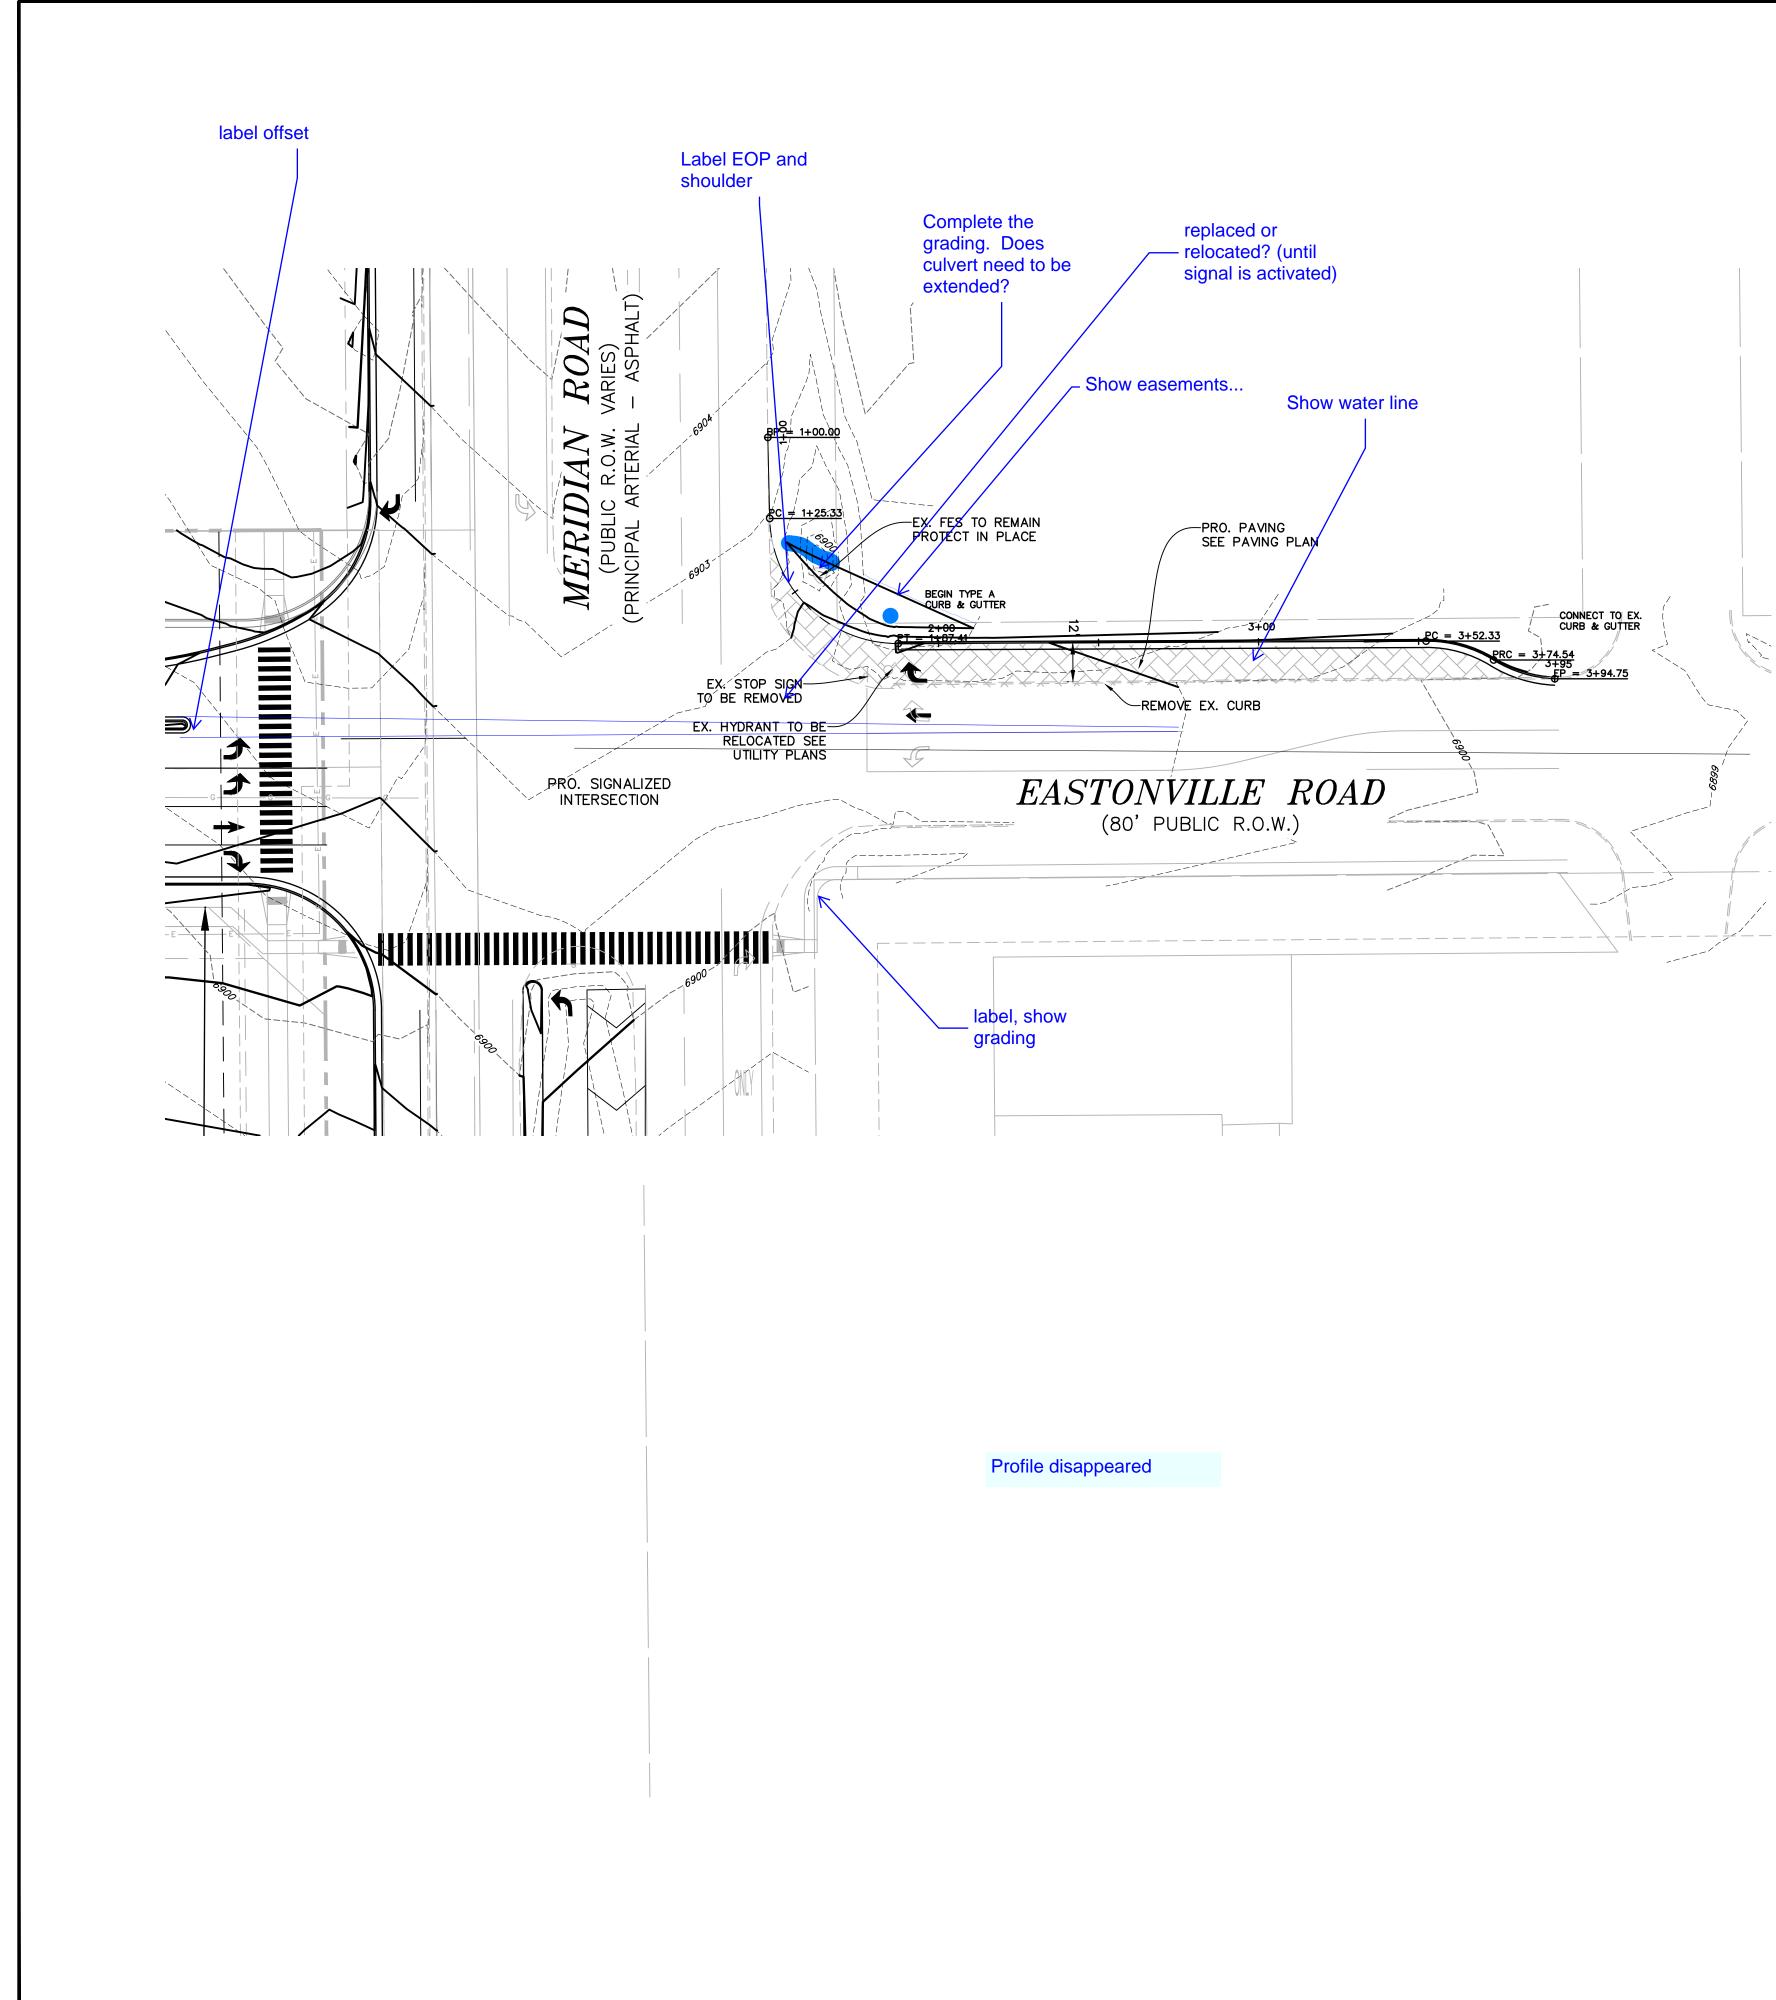

<u>LEGEND</u>

PROPERTY LINE
LOT LINE
EASEMENT
CURB & GUTTER
SIDEWALK

Engineers • Su 3 SOUTH 7TH S COLORADO SPGS, COI CONTACT: TIM D. McC (719)260-08: BOULDER • COLORAD CLIENT HUMMEL INVESTI 8117 PRESTON ROAI DALLAS, TEXAS	DREXEL, BARRELL & CO. Engineers • Surveyors 3 SOUTH 7TH STREET COLORADO SPGS, COLORADO 80905 CONTACT: TIM D. McCONNELL, P.E. (719)260-0887 BOULDER • COLORADO SPRINGS CLIENT: HUMMEL INVESTMENTS, LLC 8117 PRESTON ROAD, SUITE 120 DALLAS, TEXAS 75225 (214) 416–9820			
CONSTRUCTION DRAWINGS FOR FALCON MARKETPLACE	FALCON, COLORADO			
ISSUE 90% SUBMITTAL REVISED DESIGNED BY: DRAWN BY: CHECKED BY: FILE NAME:	DATE 5-6-19 7-19-19 7-19-19			
PREPARED UNDER SUPERVISION FOR AN OF DREXEL, BARR DRAWING SO HORIZONTAL: VERTICAL: EASTONVIL TURN LANE & PROF PROJECT NO. 2098 DRAWING NO.	D ON BEHALF ELL & CO. 2ALE: 1"=30 1"=5' LE RD E PLAN FILE			
C5.	17			

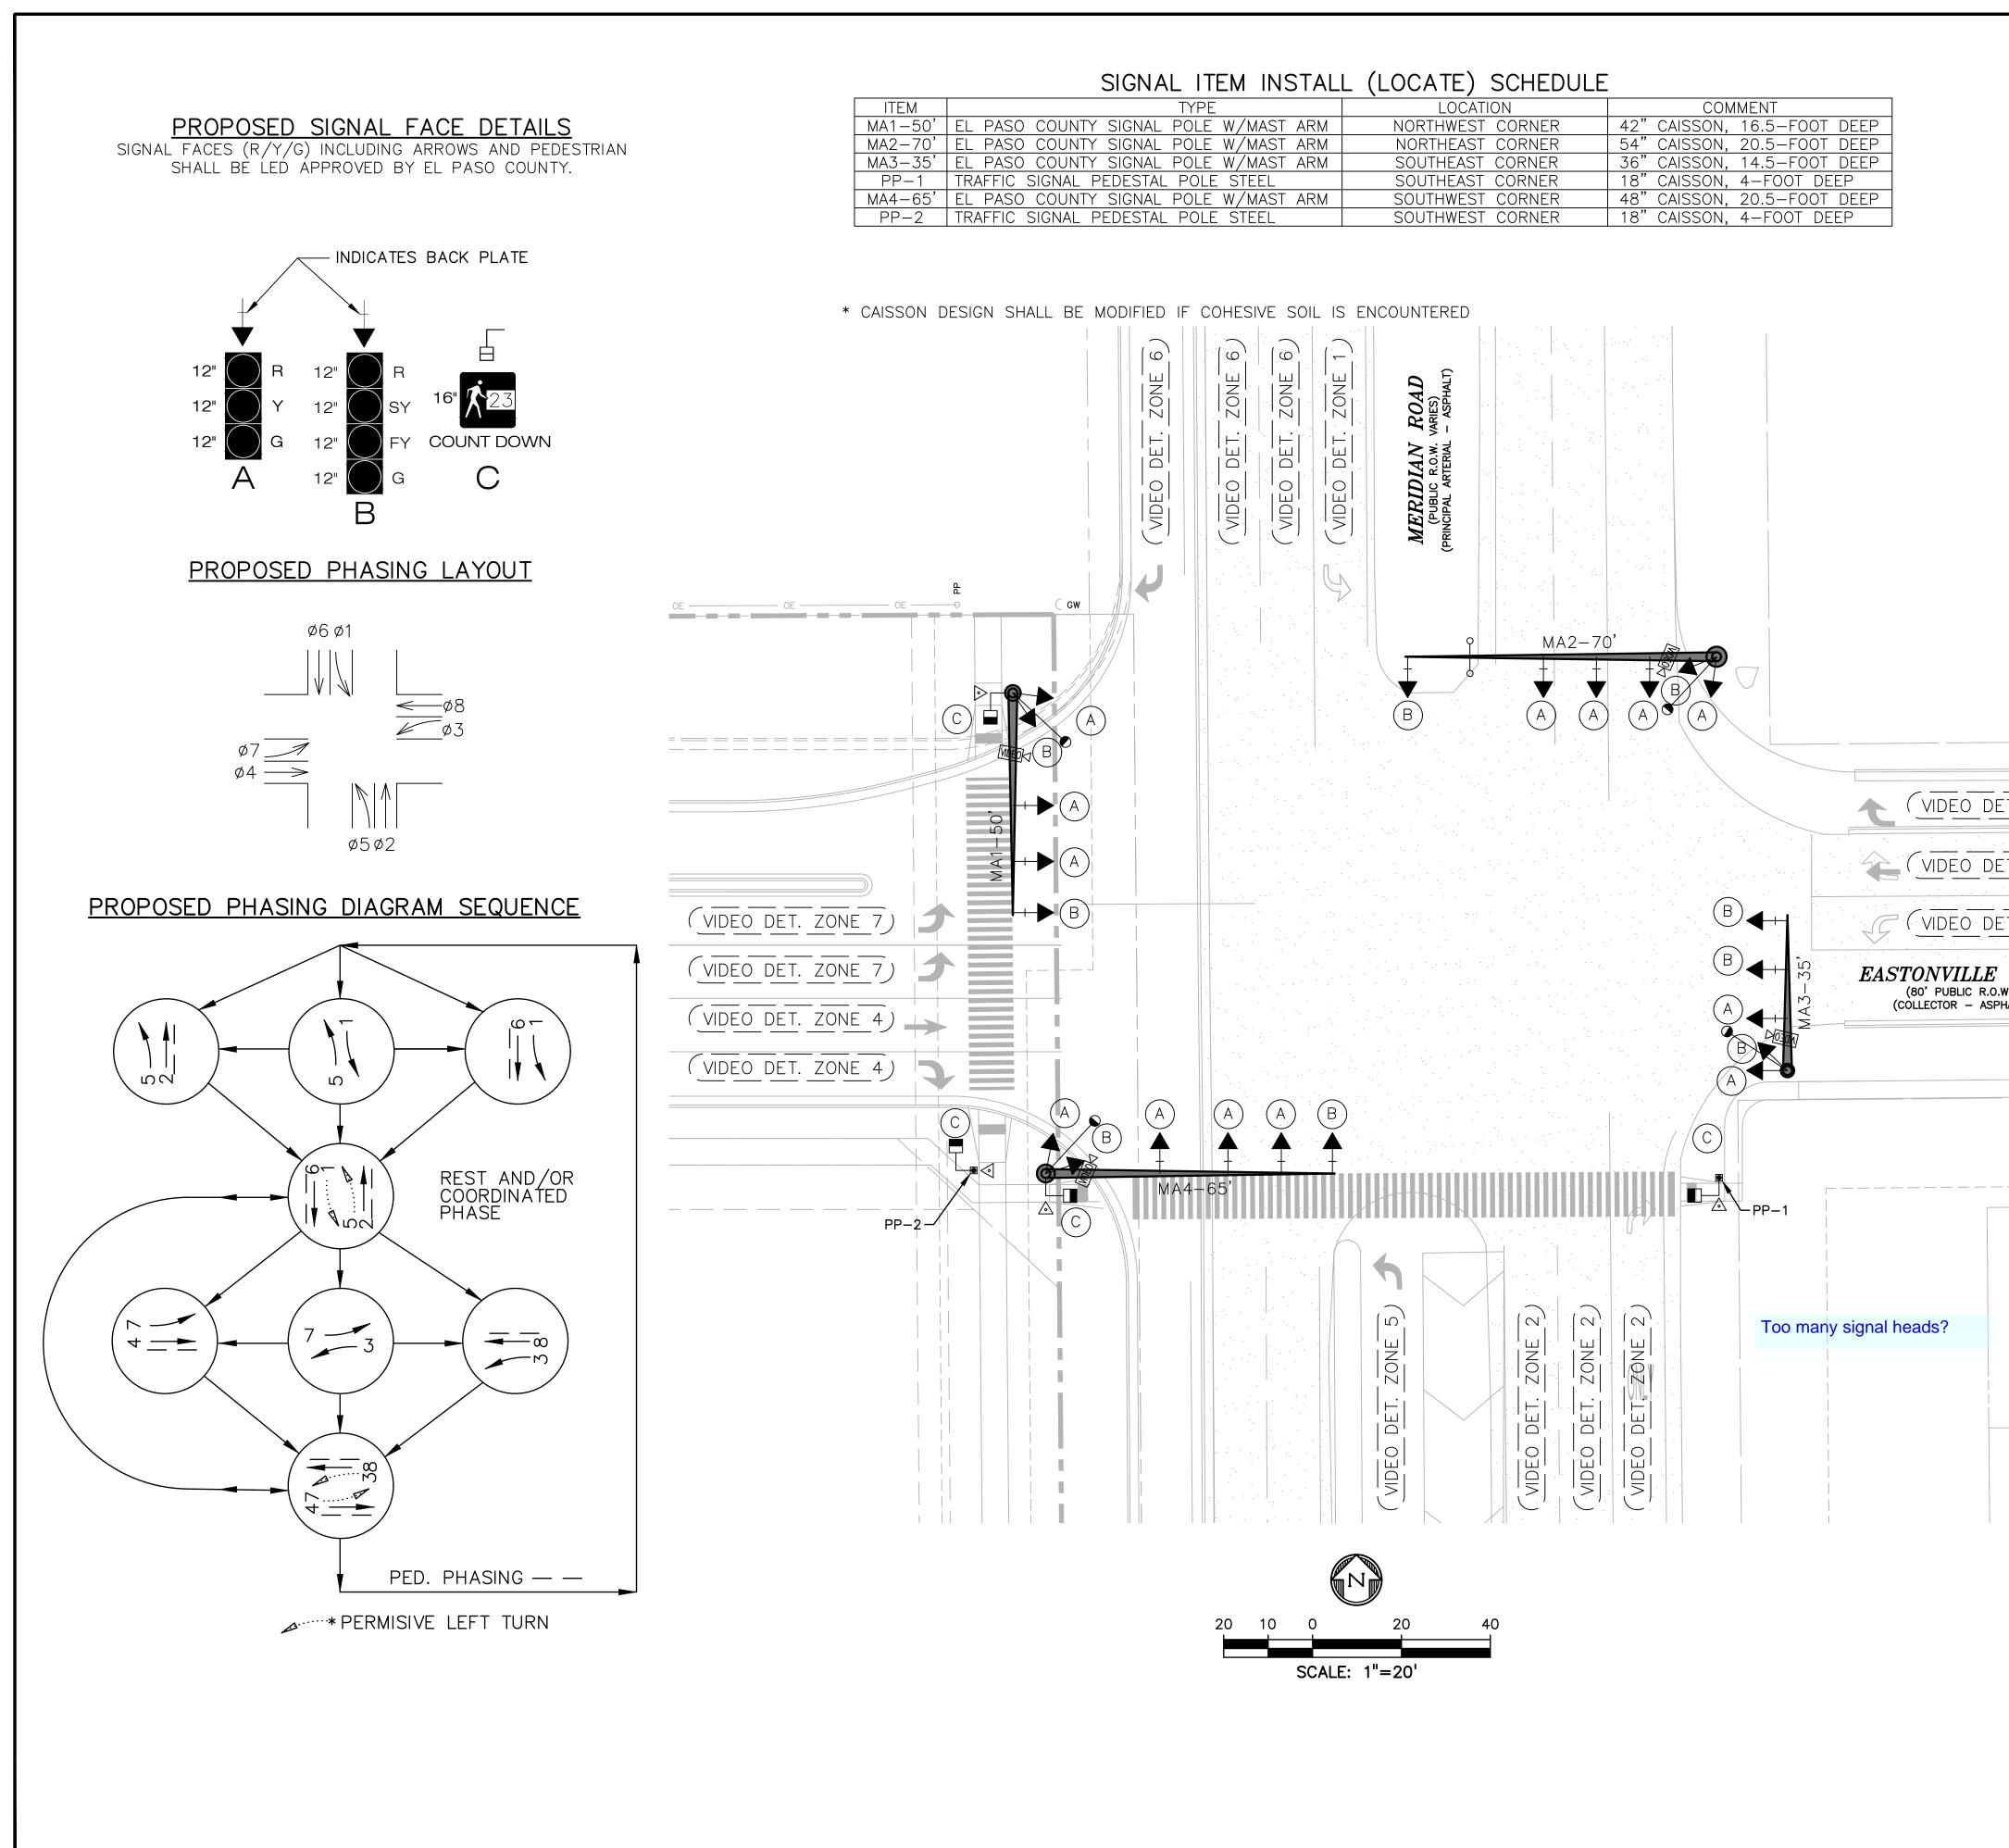


ITEM	TYPE	LOCATION	COMMENT
MA1-50'	EL PASO COUNTY SIGNAL POLE W/MAST ARM	NORTHWEST CORNER	42" CAISSON, 16.5-FOOT DEEP
MA2-70'	EL PASO COUNTY SIGNAL POLE W/MAST ARM	NORTHEAST CORNER	54" CAISSON, 20.5-FOOT DEEP
MA3-35'	EL PASO COUNTY SIGNAL POLE W/MAST ARM	SOUTHEAST CORNER	36" CAISSON, 14.5-FOOT DEEP
PP-1	TRAFFIC SIGNAL PEDESTAL POLE STEEL	SOUTHEAST CORNER	18" CAISSON, 4-FOOT DEEP
MA4-65'	EL PASO COUNTY SIGNAL POLE W/MAST ARM	SOUTHWEST CORNER	48" CAISSON, 20.5-FOOT DEEP
PP-2	TRAFFIC SIGNAL PEDESTAL POLE STEEL	SOUTHWEST CORNER	18" CAISSON, 4-FOOT DEEP



			PREPARED BY:
			DREXEL, BARRELL & CO. Engineers • Surveyors 3 SOUTH 7TH STREET COLORADO SPGS, COLORADO 80905 CONTACT: TIM D. McCONNELL, P.E. (719)260-0887 BOULDER • COLORADO SPRINGS CLIENT:
	<u>SIGNAL EQUIPM</u> prop. signal pole w/ mast a		HUMMEL INVESTMENTS, LLC 8117 PRESTON ROAD, SUITE 120 DALLAS, TEXAS 75225 (214) 416–9820
(VIDEO DET. ZONE 8) (VIDEO DET. ZONE 8) (VIDEO DET. ZONE 3) (VIDEO DET. ZONE 3) (VIDEO DET. ZONE 3) (STONVILLE ROAD (80' PUBLIC R.O.W.) (COLLECTOR - ASPHALT)	PROP. OPTICOM DETECTOR \sim	EAD \rightarrow (A) $-$ 16"x24"x12") \bullet $-$ 24"x36"x24") \bullet (A) $-$ 24"x36"x24") \bullet (A) $-$ 24"x36"x24") \bullet (A) $-$ 24"x36"x24") \bullet (A) $-$ 24"x36"x24") \bullet (A) $-$ 24"x36"x24") \bullet (A) $-$ 24"x36"x24") \bullet (A) (A) $-$ 24"x36"x24") \bullet (A) (A) CONSTRUCTION DRAMNGS FOR CONSTRUCTION DRAMNGS FOR FALCON FALCON FALCON CONSTRUCTION DRAMNGS FOR FALCON CONSTRUCTION DRAMNGS FOR FALCON CONSTRUCTION DRAMNGS FOR FALCON FOR SUBMITTAL SUBMITTAL neads?	EXISTING ROW LINE EXISTING EASEMENT LINE EXISTING GAS LINE EXISTING ELECTRIC LINE EXISTING STORM SEWER EXISTING CABLE TV LINE EXISTING TELEPHONE LINE EXISTING IRRIGATION LINE EXISTING WATER LINE EXISTING FIBER OPTIC LINE EXISTING FIBER OPTIC LINE	G E E SS CTV T IRR W FOC	DESIGNED BY: PDM DRAWN BY: KRC CHECKED BY: PDM FILE NAME: 20988-CD-SIG1
			PREPARED UNDER MY DIRECT SUPERVISION FOR AND ON BEHALI OF DREXEL, BARRELL & CO. DRAWING SCALE: HORIZONTAL: 1" = 40' VERTICAL: N/A TRAFFIC SIGNAL PLAN PROJECT NO. 20988–00CSCV DRAWING NO.

EL PASO COUNTY FILE # <u>SF-19-001</u>

SHEET: 30 OF 39

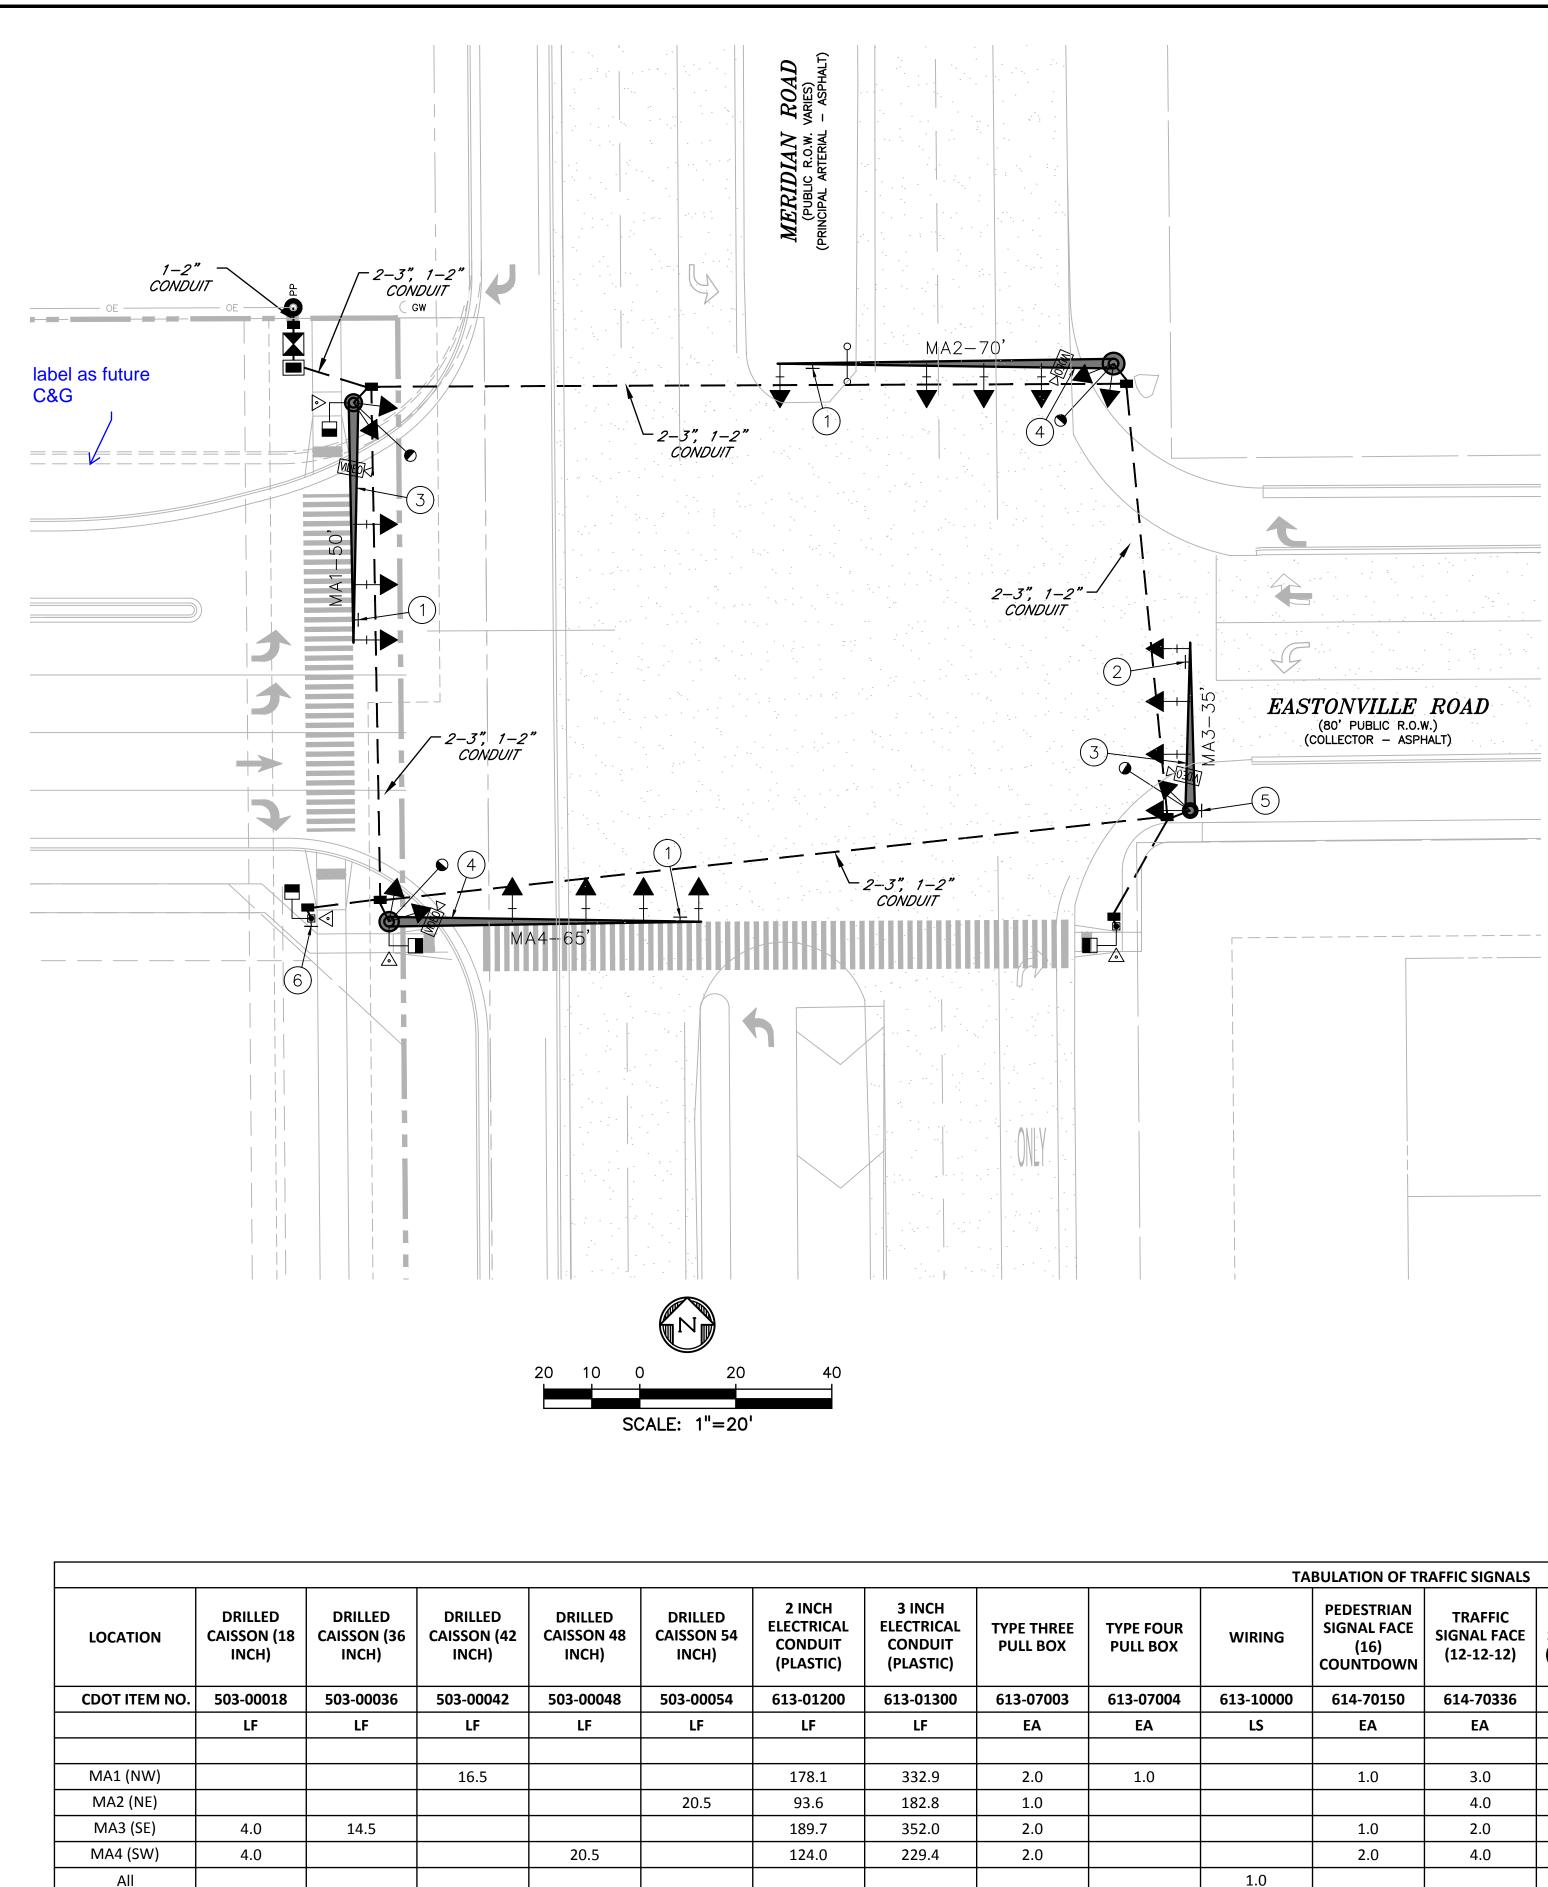

TOTAL

17

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586

1098


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NOTES:

- 1. ALL WORK PERFORMED SHALL COMPLY WITH STANDARD SPECIFICATIONS FOR ROAD AND BRIDGE CONSTRUCTION (COLORADO DEPARTMENT OF TRANSPORTATION, 2011), STANDARD PLANS M&S STANDARDS (COLORADO DEPARTMENT OF TRANSPORTATION, JULY 2012) INCLUDING ALL REVISIONS, AND EL PASO COUNTY ENGINEERING CRITERIA MANUAL (ADOPTED JANUARY 9, 2006 – REVISED JULY 29, 2015 – REVISION 5).
- 2 POTHOLING SHALL BE COMPLETED AT THE FOUR SIGNAL POLE LOCATIONS TO VERIFY THERE ARE NO UTILITY CONFLICTS. TWO HOURS FOR EACH POLE LOCATION HAS BEEN ASSUMED.
- ALL TRAFFIC SIGNAL HEADS SHALL BE ALIGNED WITH THE MIDDLE OF THE TRAFFIC LANES THAT ARE INTENDED FOR, BUT NOT CLOSER THAN 6-INCHES FROM THE END OF THE MAST FOR THE LEFT TURN SIGNAL. ALL SIGNAL HEAD LOCATIONS SHALL BE APPROVED BY THE ENGINEER. ASTRO-BRAC OR SKY-BRAC TYPE MOUNTING HARDWARE SHALL BE USED TO ATTACH ALL TRAFFIC SIGNAL HEADS MOUNTED ON MAST ARMS. ALL SIGNAL HEADS SHALL BE BLACK IN COLOR. ALL MAST ARM MOUNTED SIGNAL HEADS SHALL HAVE LOUVERED BACKPLATES WITH HIGH CONTRAST REFLECTIVE YELLOW BORDERS.
- 4. ALL SIGNAL EQUIPMENT, CONDUIT, AND PULL BOXES SHALL BE INSTALLED WITHIN THE PUBLIC RIGHT-OF-WAY.
- 5. THE CONTRACTOR SHALL SUPPLY SHOP DRAWINGS OF ALL SIGNAL EQUIPMENT TO THE ENGINEER AND OBTAIN APPROVAL PRIOR TO ORDERING.
- 6. THE EXACT PLACEMENT OF ALL TRAFFIC SIGNAL EQUIPMENT, SIGNING, AND STRIPING SHALL BE APPROVED BY THE ENGINEER PRIOR TO INSTALLATION. 7. ALL POLES, MAST ARMS, AND LUMINAIRE ARMS SHALL BE GALVANIZED PER ASTM A123 and A153. ANY SURFACE AREAS DAMAGED DURING HANDLING
- OR INSTALLATION SHALL BE TOUCHED UP IMMEDIATELY PER MANUFACTURERS SPECIFICATIONS.
- 8. THE CAISSONS SHALL BE INSTALLED ACCORDING TO EL PASO COUNTY STANDARDS.
- 9. THE NEW SIGNAL CABINET SHALL BE A P44 PLUG-N-GO TS2 TYPE CABINET DESIGNED FOR COMPATIBILITY WITH THE COUNTY'S ECONOLITE SIGNAL SYSTEM. THE CABINET SHALL BE UNPAINTED ALUMINUM, SIZE 6, AND INCLUDE ALL SPECIFIED PLUG-INS. A NEW ECONOLITE ASC/3 CONTROLLER SHALL BE INSTALLED AND PROGRAMMED.
- 10. THE CONTRACTOR SHALL FURNISH AND INSTALL ECONOLITE SOLO-PRO VIDEO DETECTION AS SPECIFIED.
- 11. ALL CONDUIT SHALL BE SCHEDULED 80 PVC UNLESS OTHERWISE NOTED. 1-2" AND 1-3" CONDUIT SHALL BE INSTALLED FROM EACH SIGNAL POLE TO THE NEAREST PULL BOX.
- 12. THE FIRE PREEMPTION UNIT AND TIMER (OPTICOM) SYSTEM SHALL BE FURNISHED AND INSTALLED BASED ON THE MANUFACTURER'S RECOMMENDATIONS.
- 13. PEDESTRIAN PUSH BUTTONS SHALL BE PELCO MODEL SE-2005-08 (ADA PEDESTRIAN PUSH BUTTON), OR ENGINEER APPROVED EQUAL. THE BUTTON HOUSING SHALL BE BLACK IN COLOR. THE PEDESTRIAN PUSH BUTTON SIGN SHALL BE R10-3E AS DESCRIBED IN THE MUTCD.
- 14. THE PEDESTRIAN SIGNALS SHALL BE LED COUNTDOWN. ALL VEHICLE SIGNAL INDICATIONS SHALL BE 12 INCH LED.
- 15. XCEL WILL FURNISH AND INSTALL STREET LIGHTS. THE CONTRACTOR SHALL INSTALL WIRING FROM THE POWER SOURCE TO THE END OF EACH STREET LIGHT MAST ARM.
- 16. THE CONTRACTOR SHALL COORDINATE WITH XCEL ENERGY TO PROVIDE POWER TO THE SIGNAL AND LUMINAIRES. POWER TO THE SIGNAL WILL BE METERED AND SEPARATE FROM THE LUMINAIRE POWER.
- 17. THE CONTRACTOR SHALL PROVIDE CONSTRUCTION SURVEYING TO CONFIRM THE RIGHT-OF-WAY AND ESTABLISH SIGNAL POLE LOCATIONS. THE CONTRACTOR SHALL REPLACE SURVEY MONUMENTS THAT ARE DISTURBED DURING CONSTRUCTION.



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MeridianRD 72" BLANK (3)

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INTERSECTION FIRE TRAFFIC TRAFFIC PEDESTRIAN | PREEMPTION DETECTION SIGNAL FACE CONTROLLER SYSTEM PUSH BUTTON UNIT AND (12-12-12-12) CABINET (CAMERA) TIMER 614-70448 614-72854 614-72860 614-72886 614-72866 EA EA EA EA EA 2.0 1.0 1.0 1.0 2.0 1.0 1.0 3.0 1.0 1.0 2.0 2.0 1.0 1.0
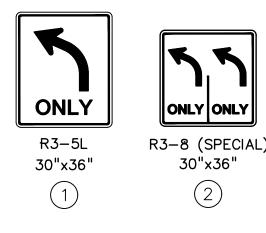
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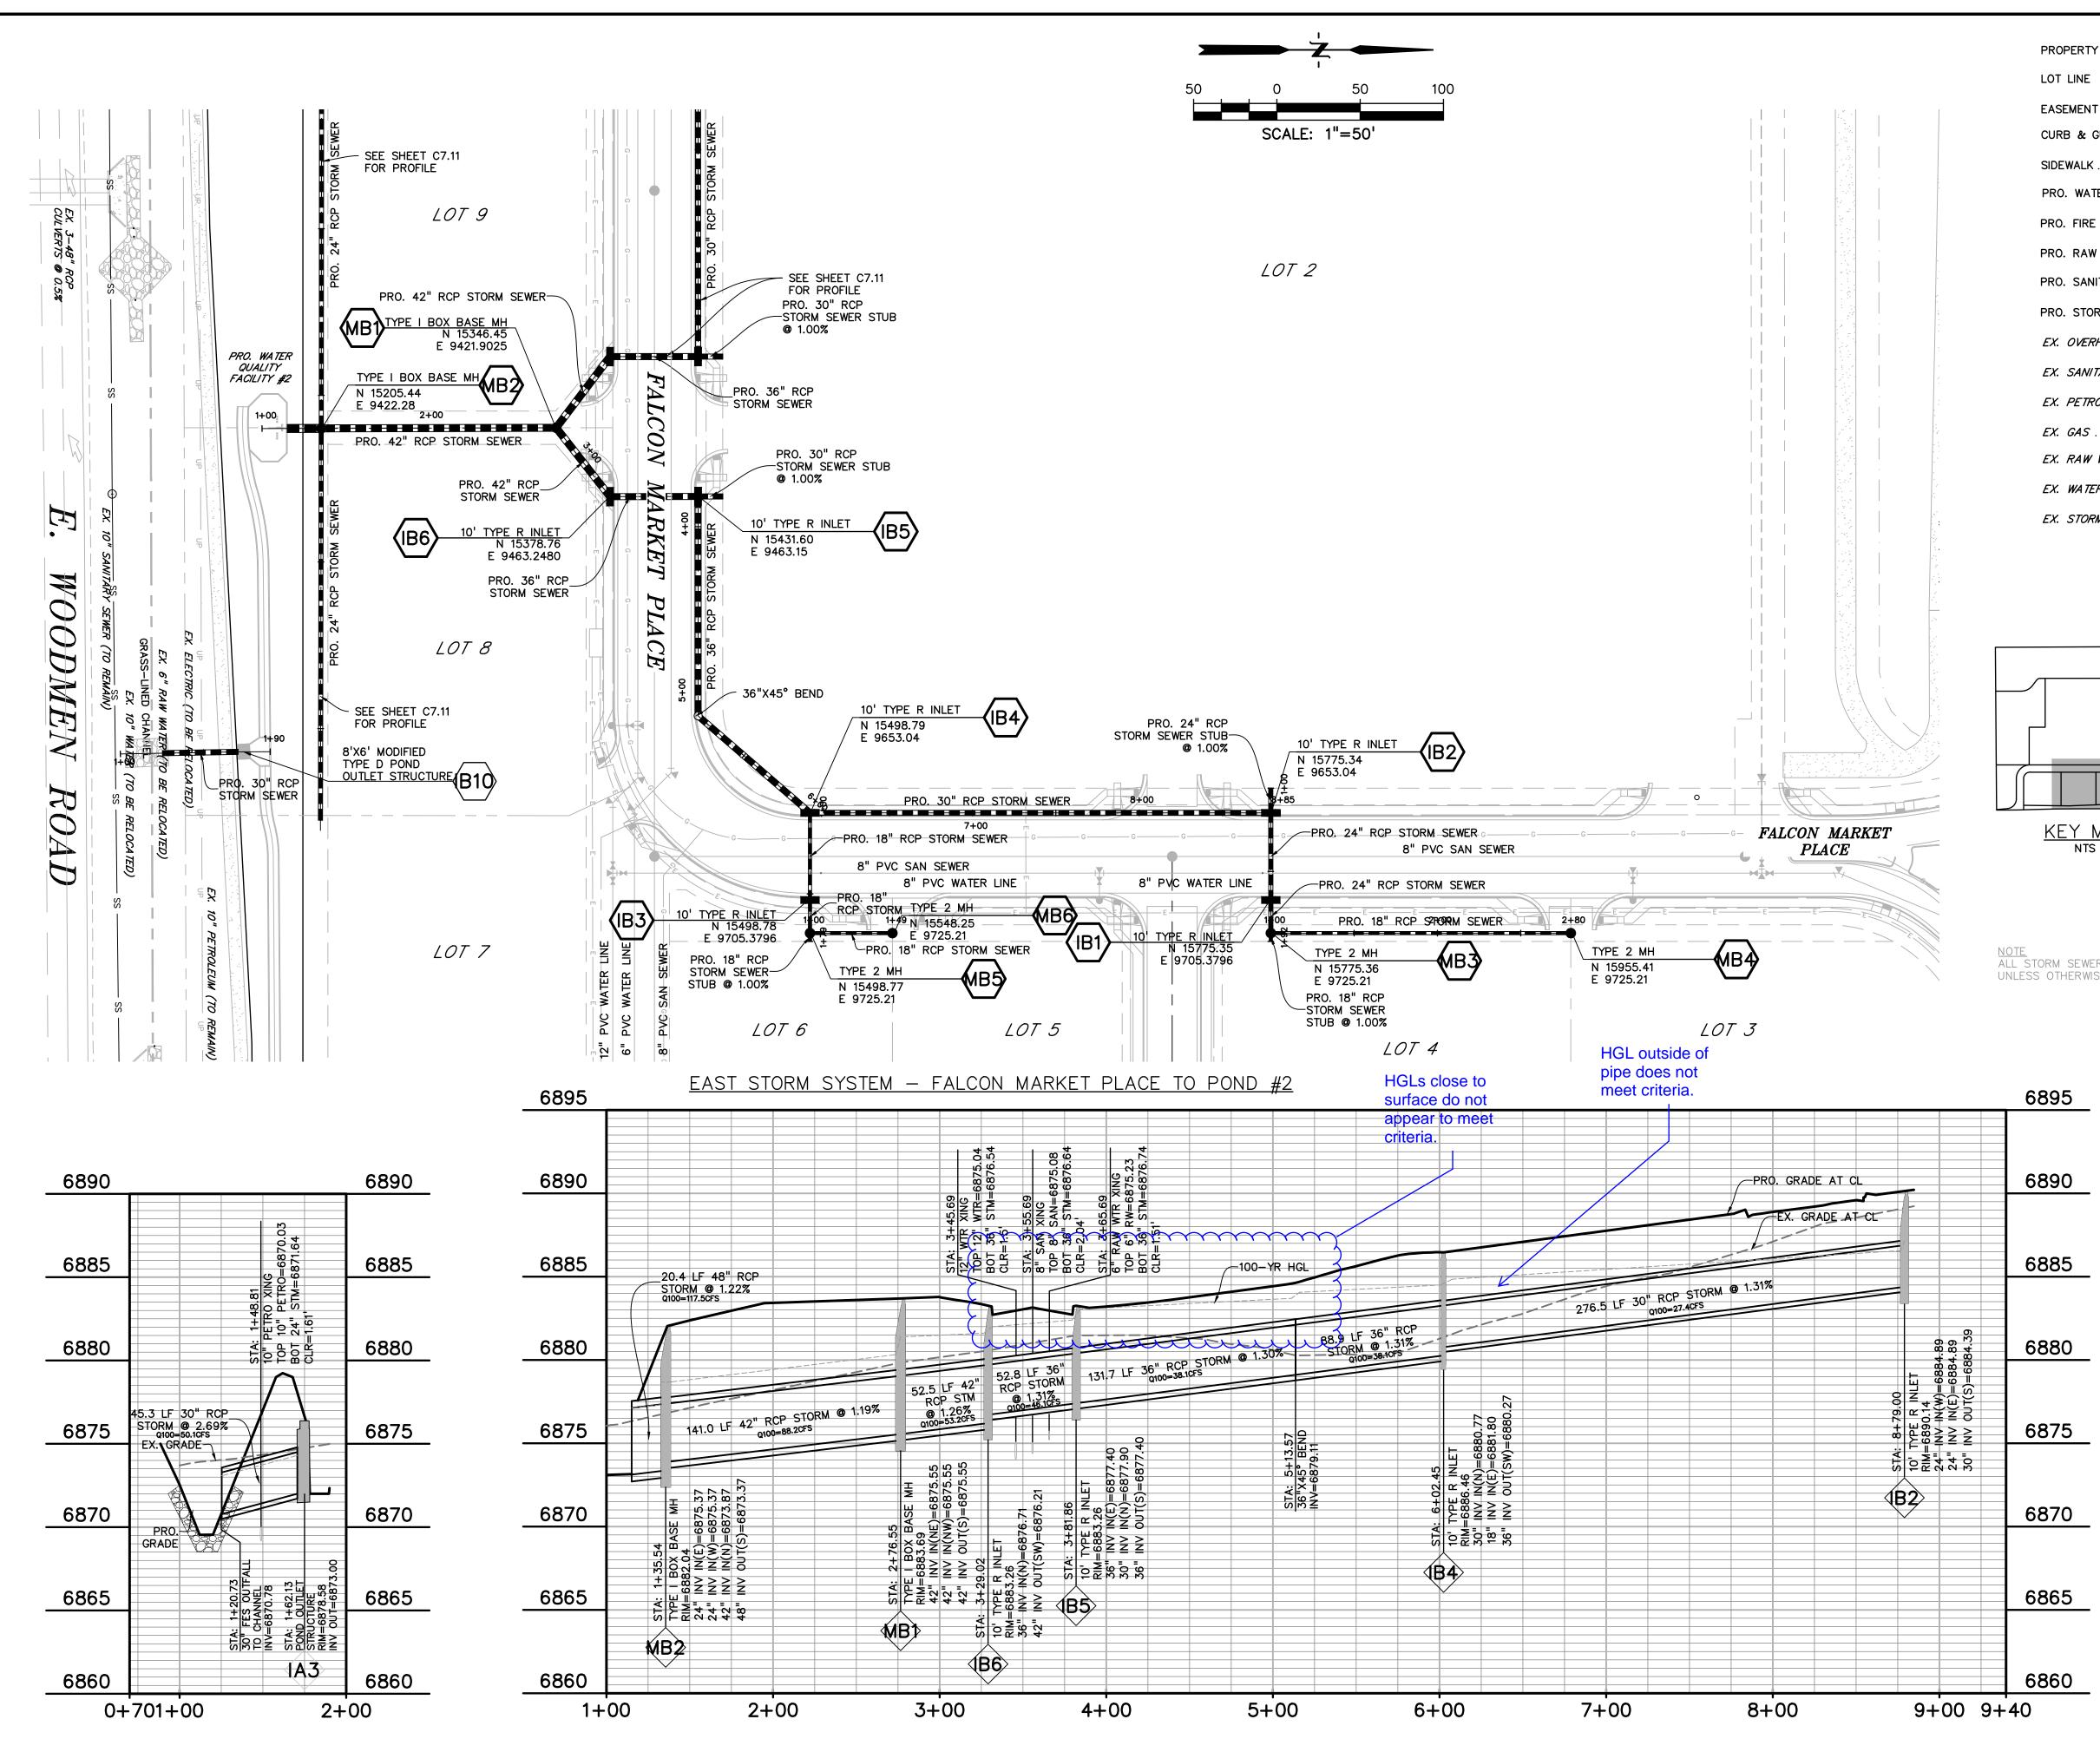
84" BLANK R9-3bP (L) R9-3bP (R) 18"x12" 18"x12" (4)(5) 6 TRAFFIC TRAFFIC TRAFFIC TRAFFIC

IRAFFIC SIGNAL-LIGHT POLE STEEL (1-35 FOOT MAST ARM)	SIGNAL-LIGHT POLE STEEL (1-50 FOOT MAST ARM)	SIGNAL-LIGHT POLE STEEL (1-65 FOOT MAST ARM)	SIGNAL-LIGHT POLE STEEL (1-70 FOOT MAST ARM)	TRAFFIC SIGNAL PEDESTAL POLE STEEL	FURNISH AND INSTALL ELECTRICAL SERVICE
614-81135	614-81150	614-81165	614-81170	614-84000	700-70082
EA	EA	EA	EA	EA	EA
	1.0				1.0
			1.0		
1.0				1.0	
		1.0		1.0	
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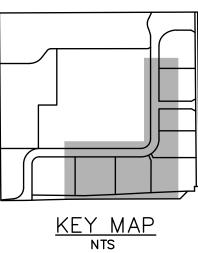
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CONSTRUCTION DRAWINGS FOR FALCON MARKETPLACE	FALCON, COLORADO
ISSUE 90% SUBMITTAL REVISED	DATE 5-6-19 7-19-19
DESIGNED BY: DRAWN BY: CHECKED BY: FILE NAME: 2098	PDM KRC PDM 8-CD-SIG2
PREPARED UNDER SUPERVISION FOR AN OF DREXEL, BARF <u>DRAWING S</u> HORIZONTAL: VERTICAL:	ID ON BEHALF Rell & CO. CALE: 1" = 20'
TRAFF SIGNA PLAN PROJECT NO. 209 DRAWING NO.	TIC NL N
C6 . SHEET: 31	11 OF 39

PREPARED BY:


- 5" LETTER HEIGHT Eastonville CROSSWALK
 - 🗇 USE 📗 CROSSWALK




LEGEND				
PROPERTY LINE				
LOT LINE				
EASEMENT				
CURB & GUTTER				
SIDEWALK				
PRO. WATER LINE				
PRO. FIRE HYDRANT.				
PRO. RAW WATER				
PRO. SANITARY SEWER				
PRO. STORM SEWER				
EX. OVERHEAD ELECTRIC	— OE ———			
EX. SANITARY SEWER	— ss ———			
EX. PETROLEUM	— UP ———			
EX. GAS	— G ———			
EX. RAW WATER				
EX. WATER	— w ———			
EX. STORM SEWER	— st ———			




NOTE ALL STORM SEWER TO BE PRIVATELY OWNED AND MAINTAINED UNLESS OTHERWISE NOTED

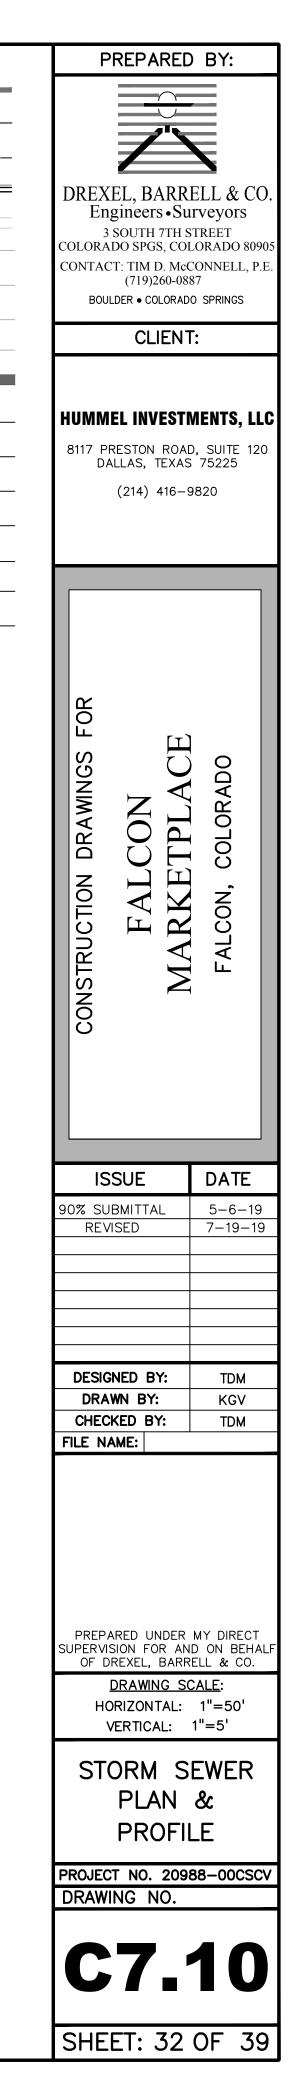


EL PASO COUNTY FILE # <u>SF-19-001</u>

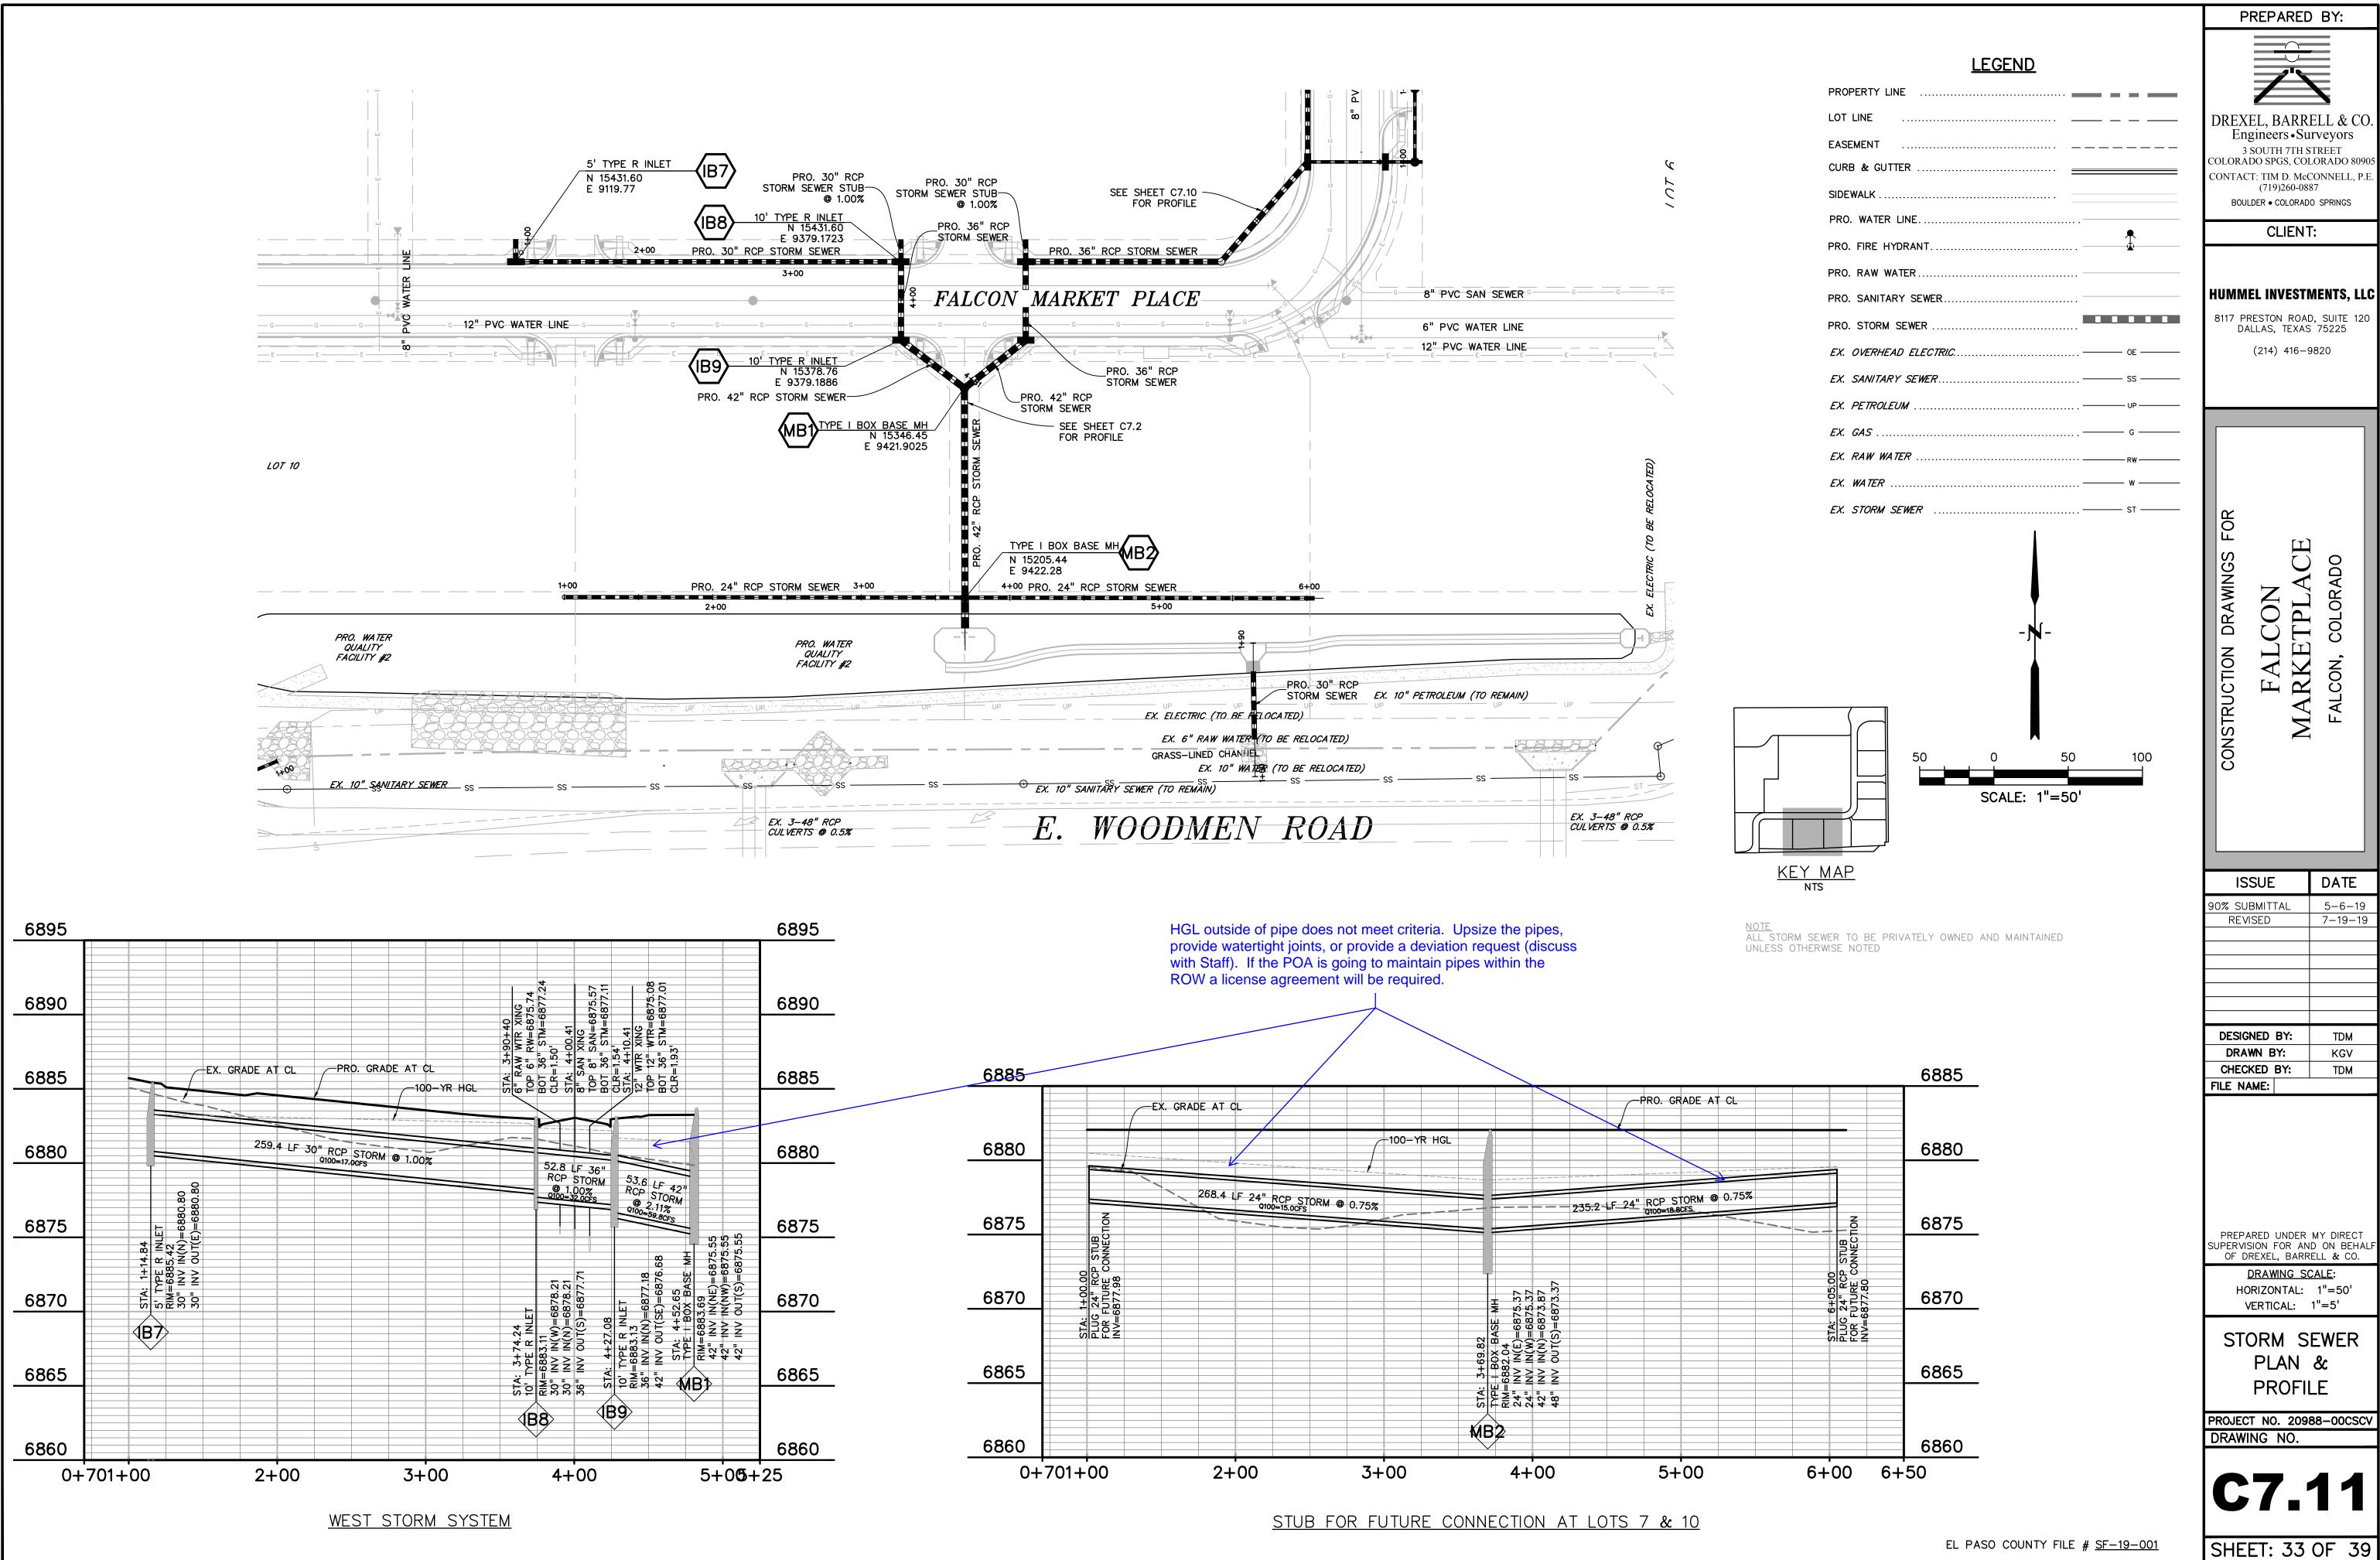

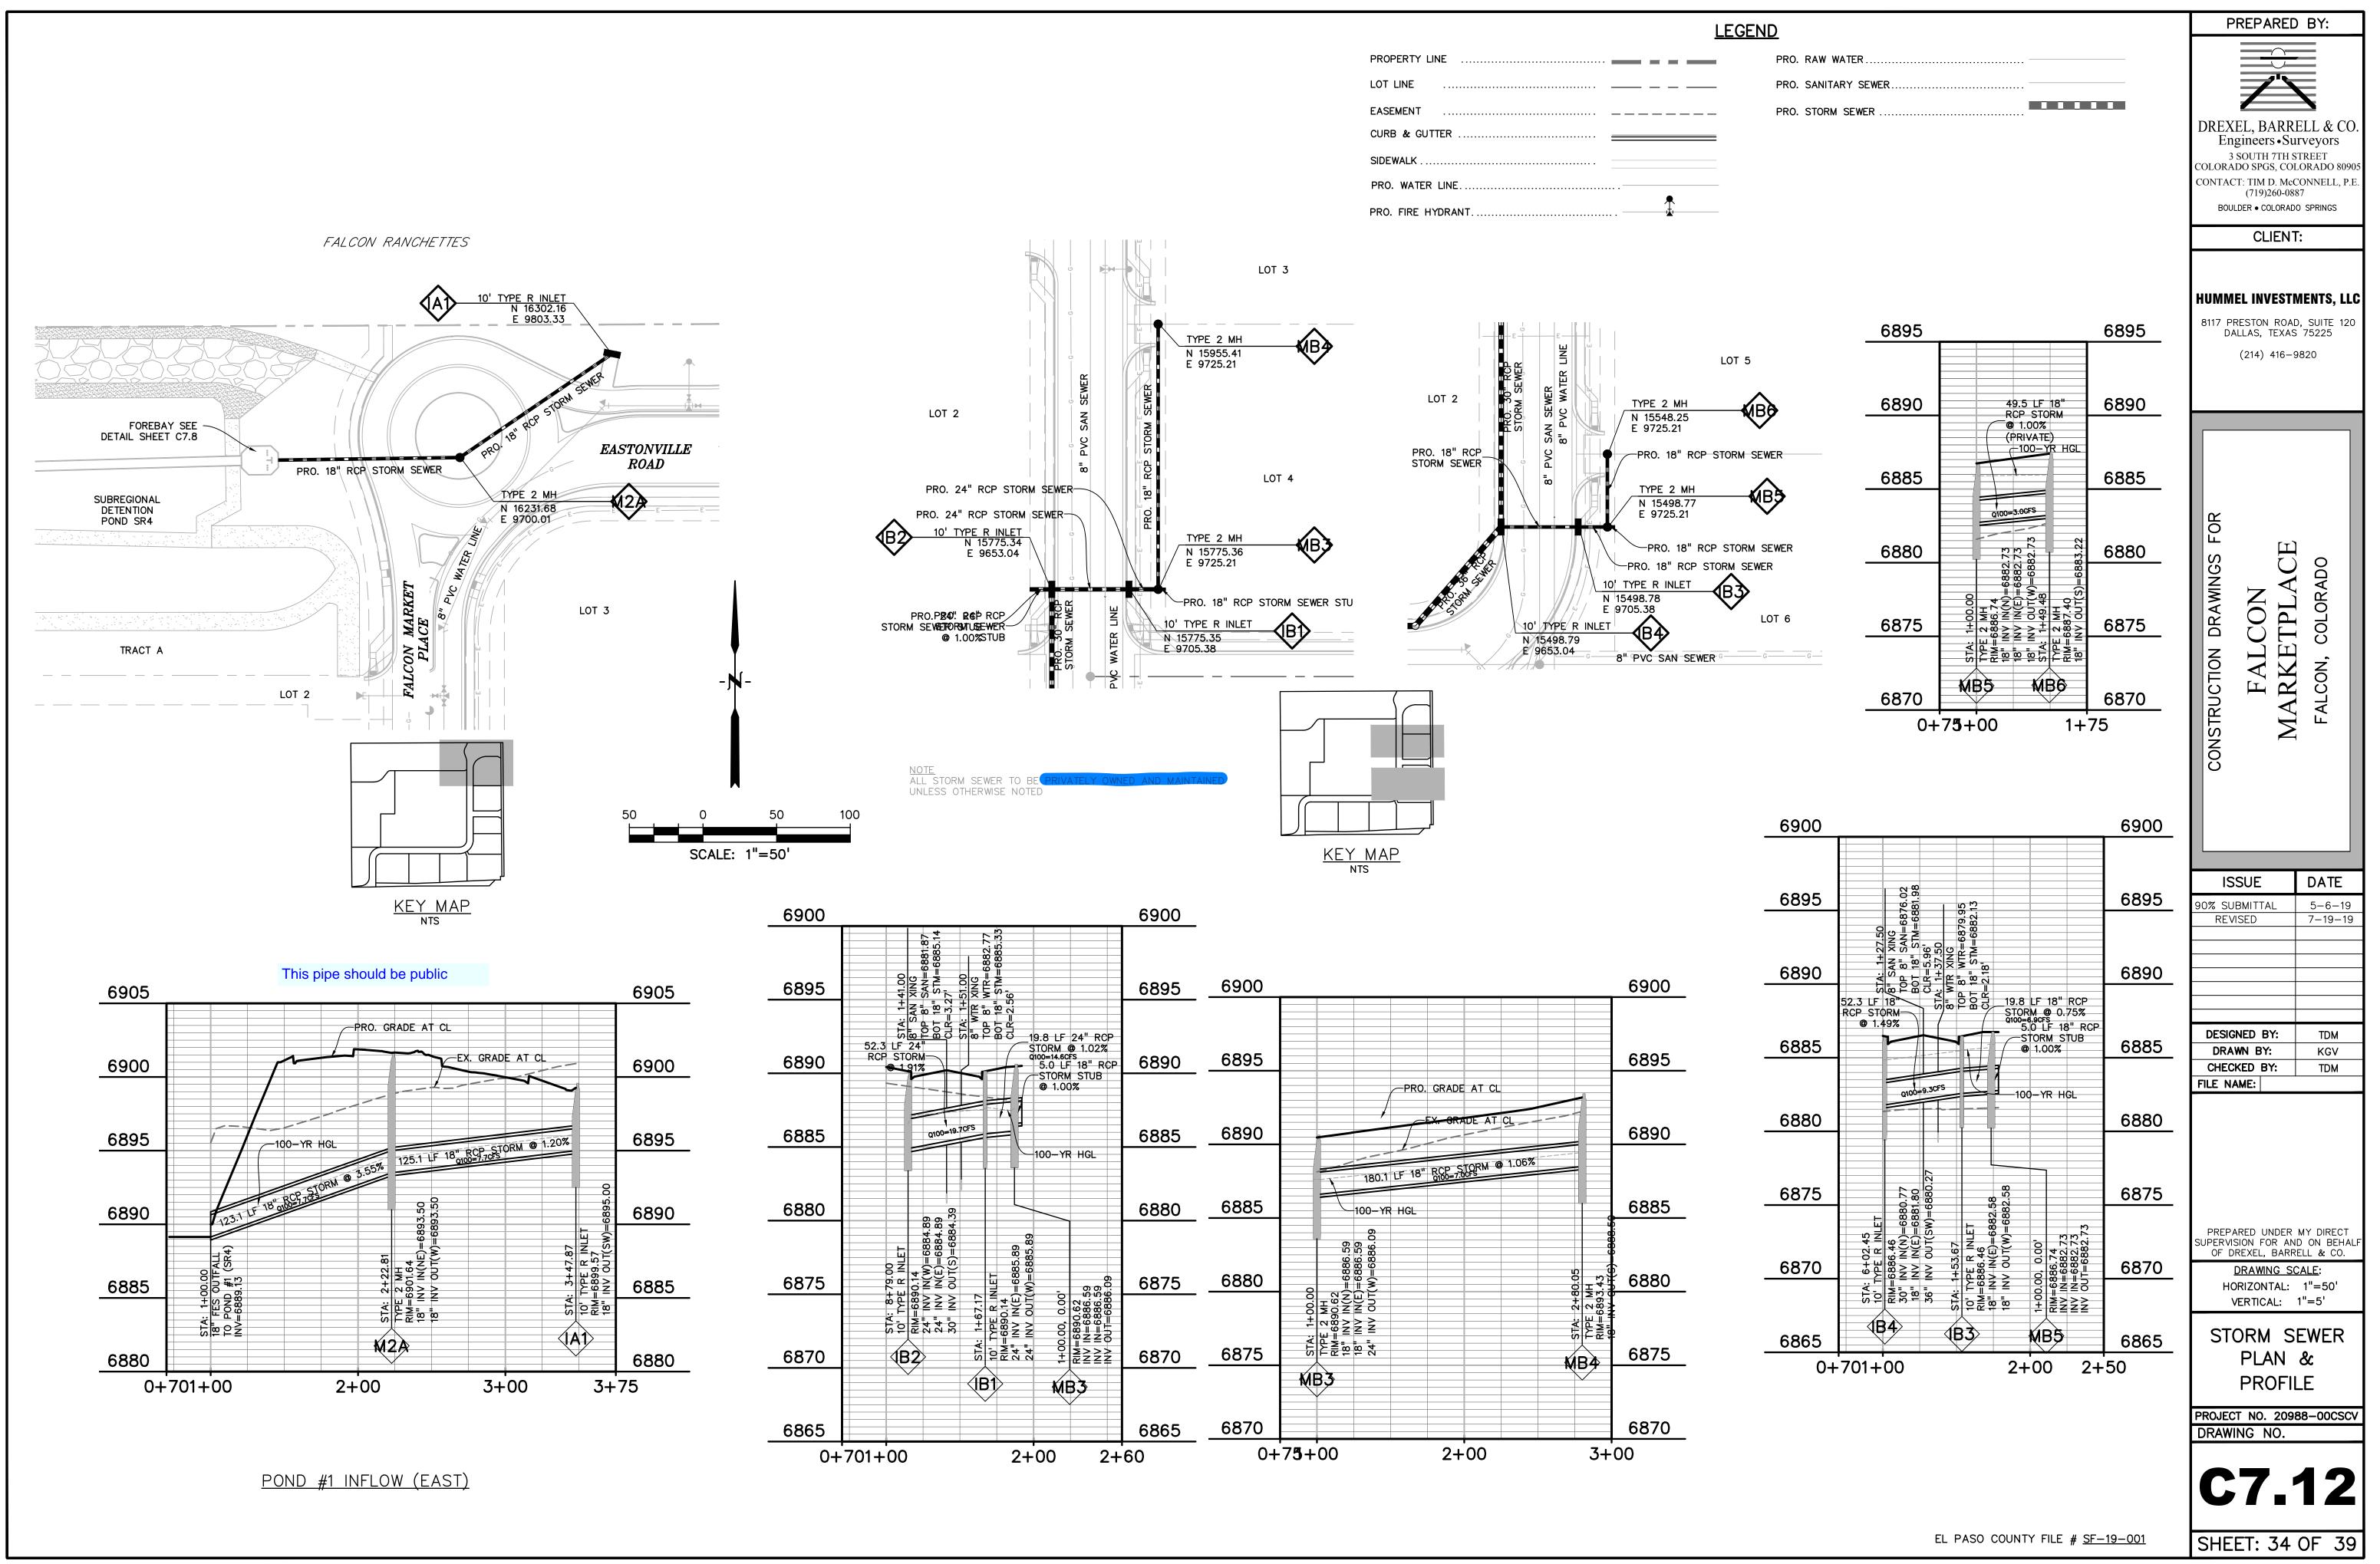



PROPERTY LINE	_
LOT LINE	
EASEMENT	-
CURB & GUTTER	
SIDEWALK	
PRO. WATER LINE	
PRO. FIRE HYDRANT.	

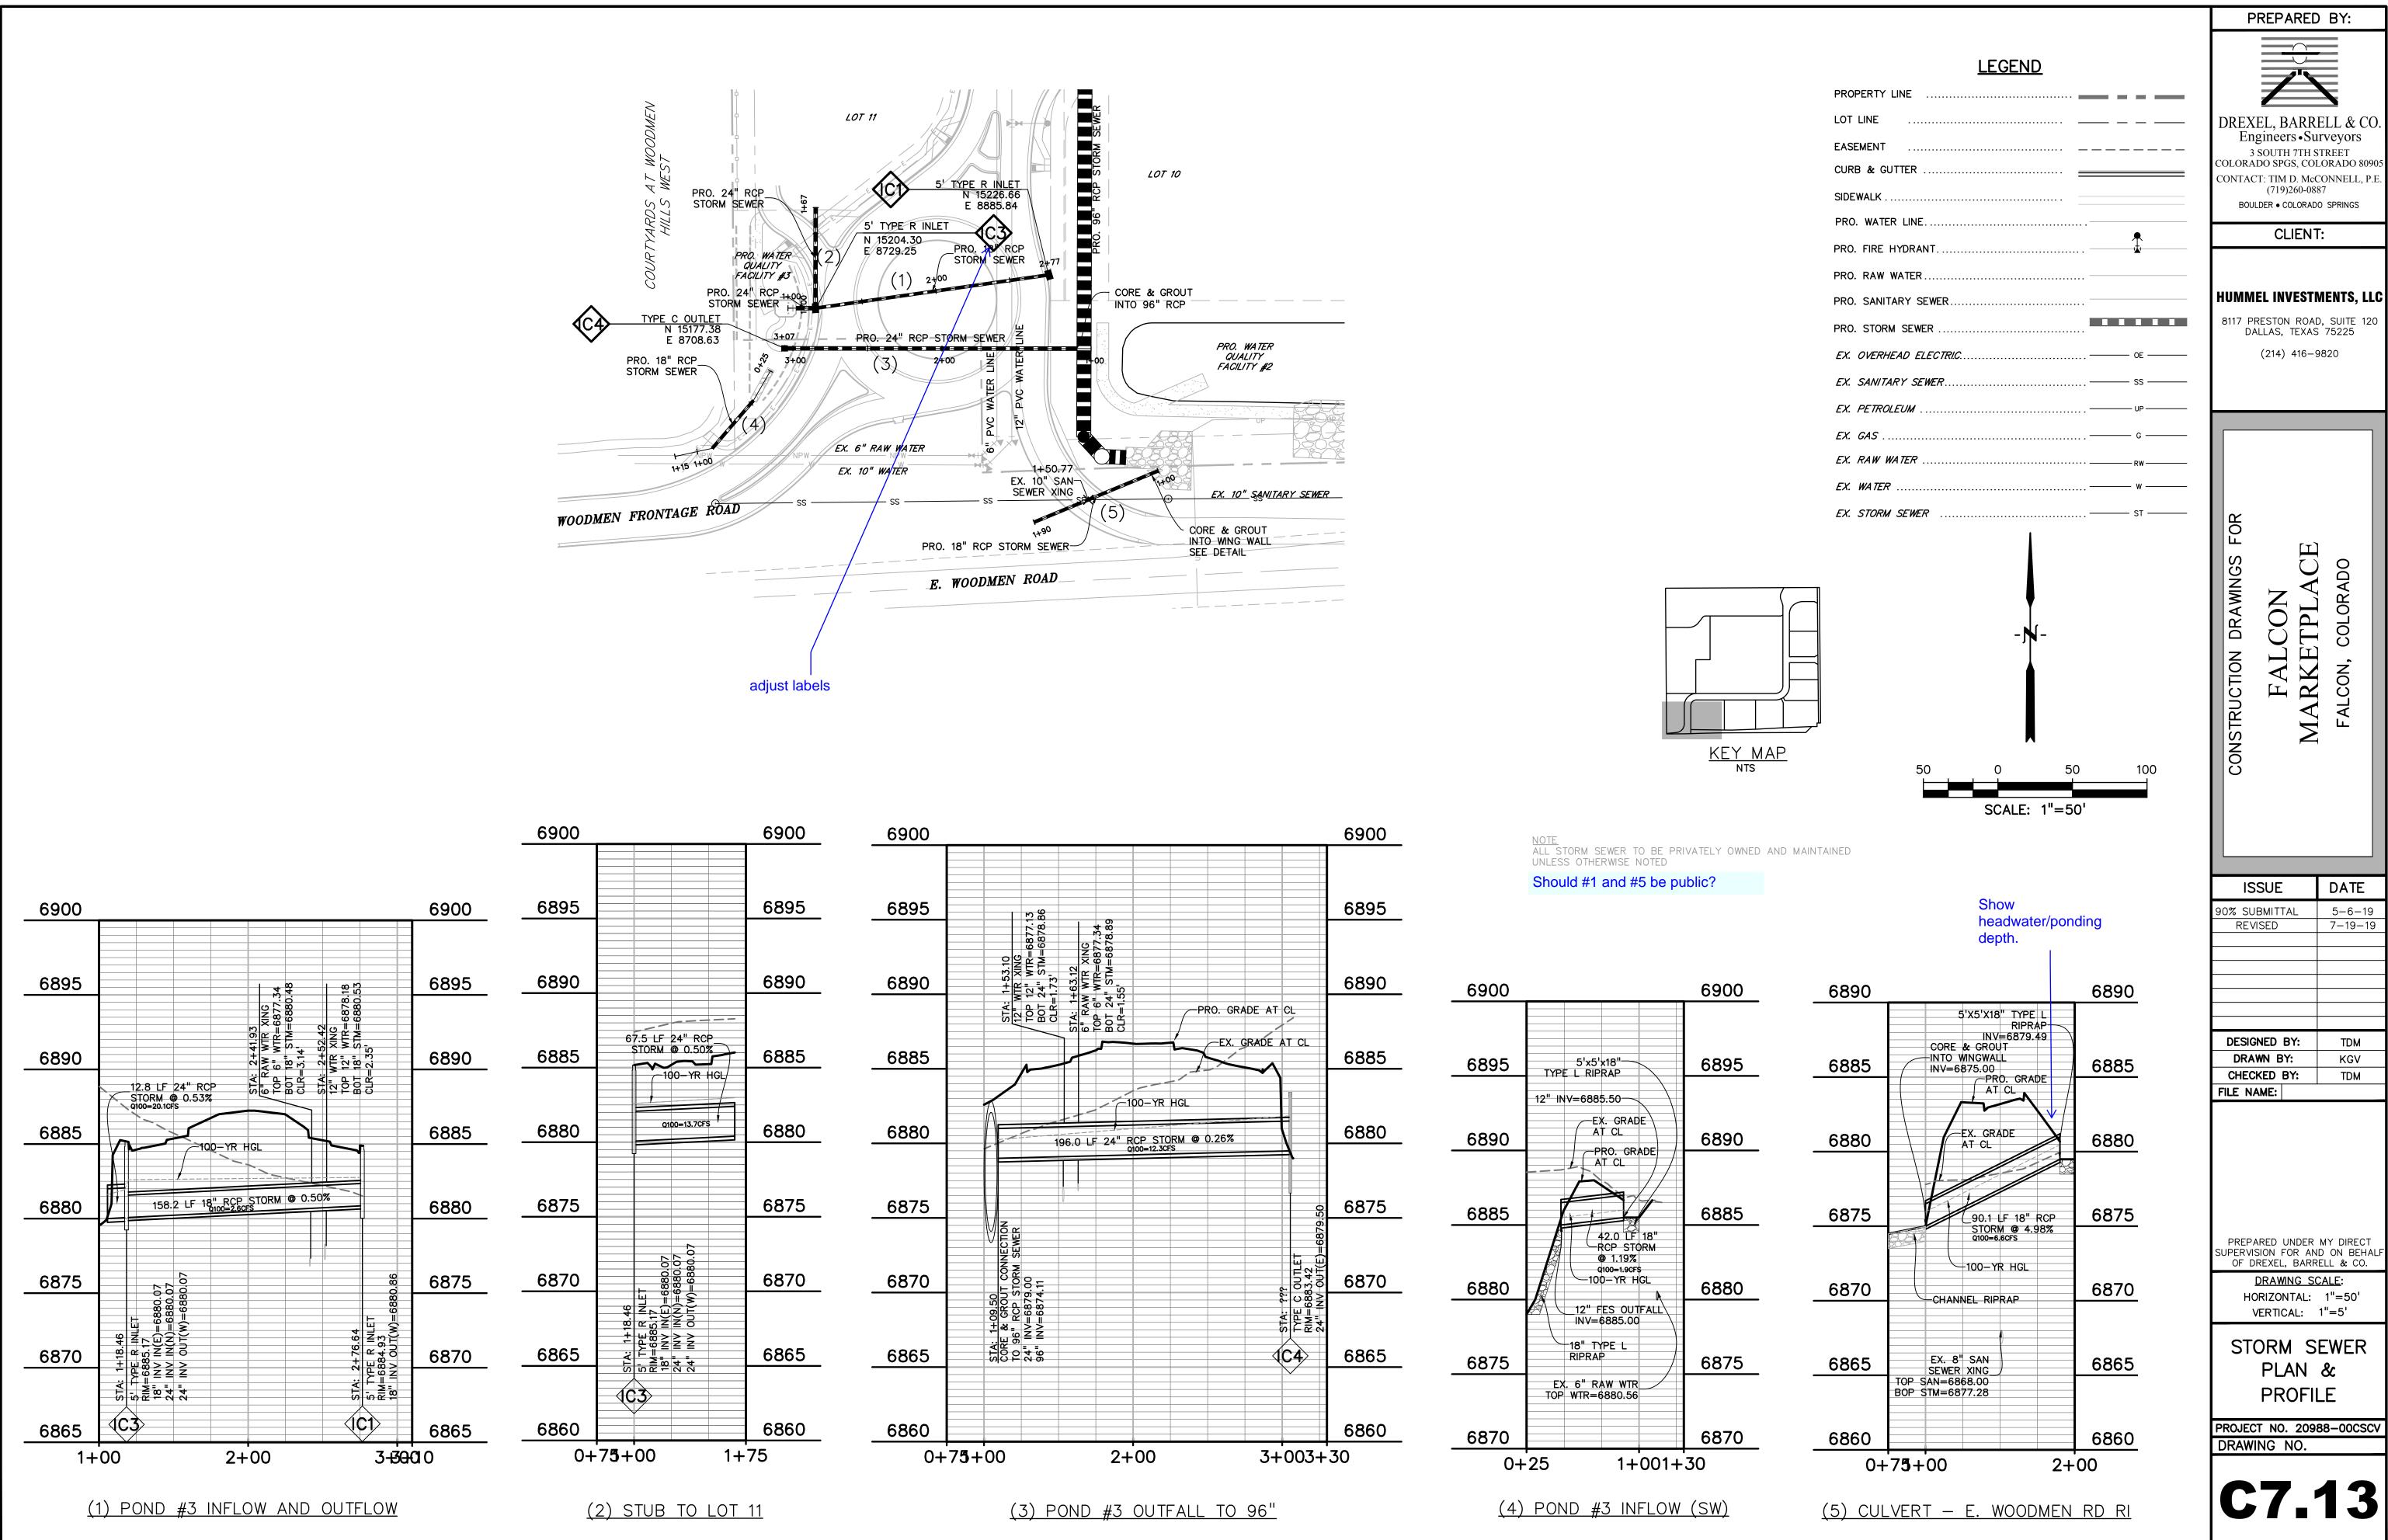






SHEET: 35 OF 39

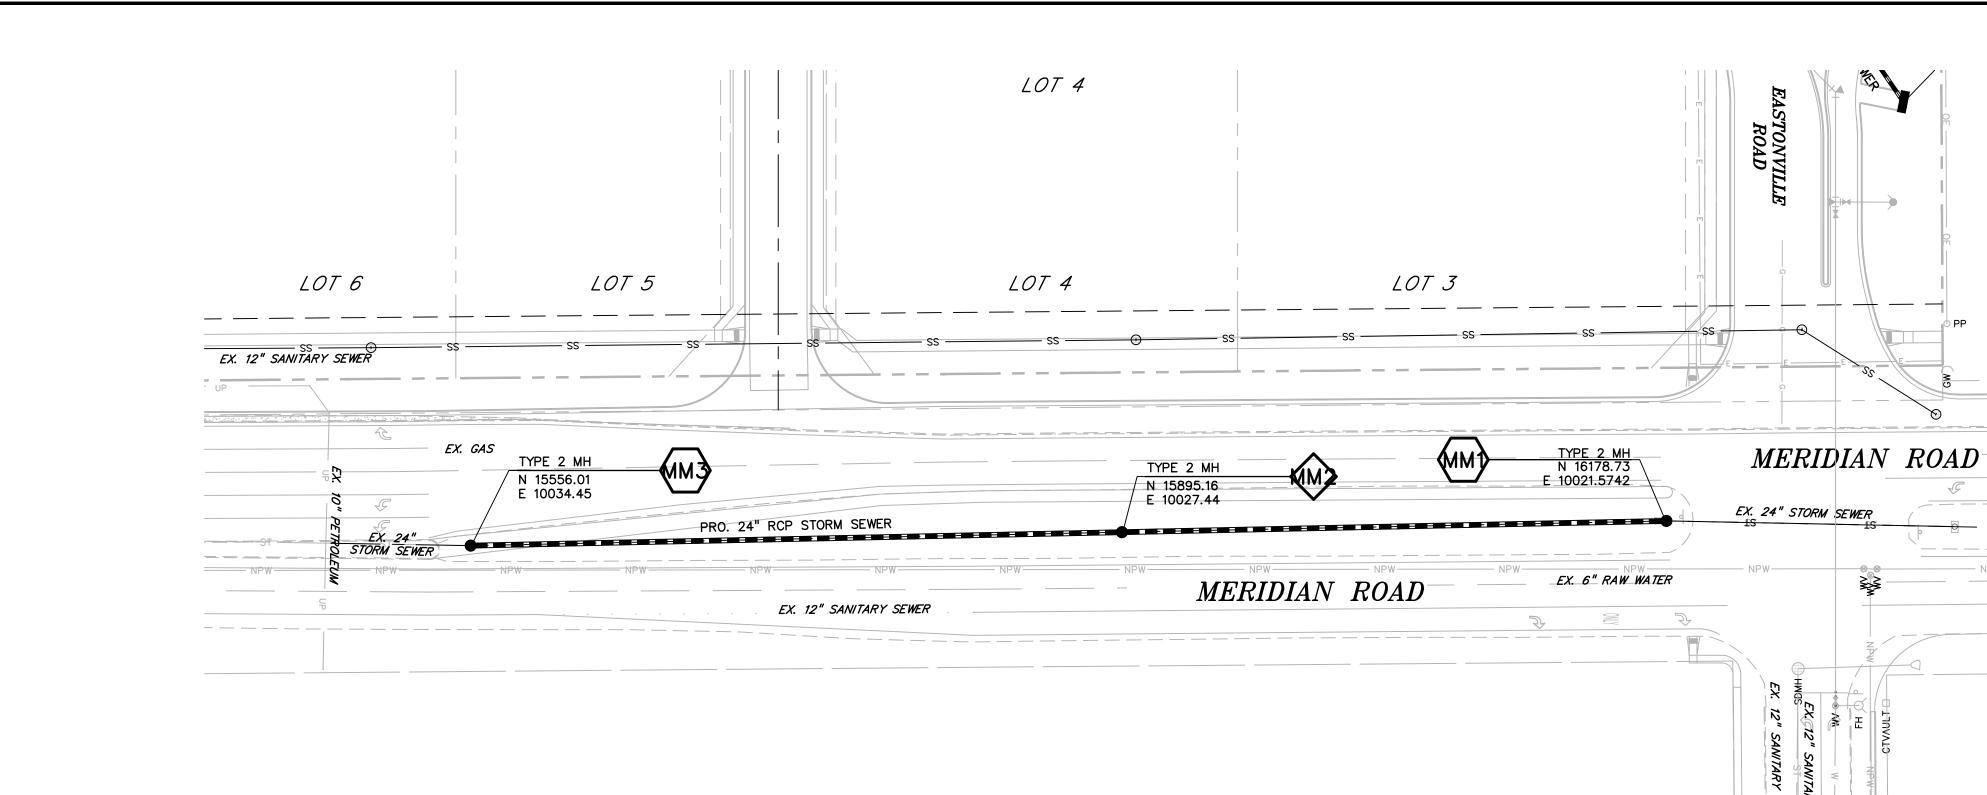


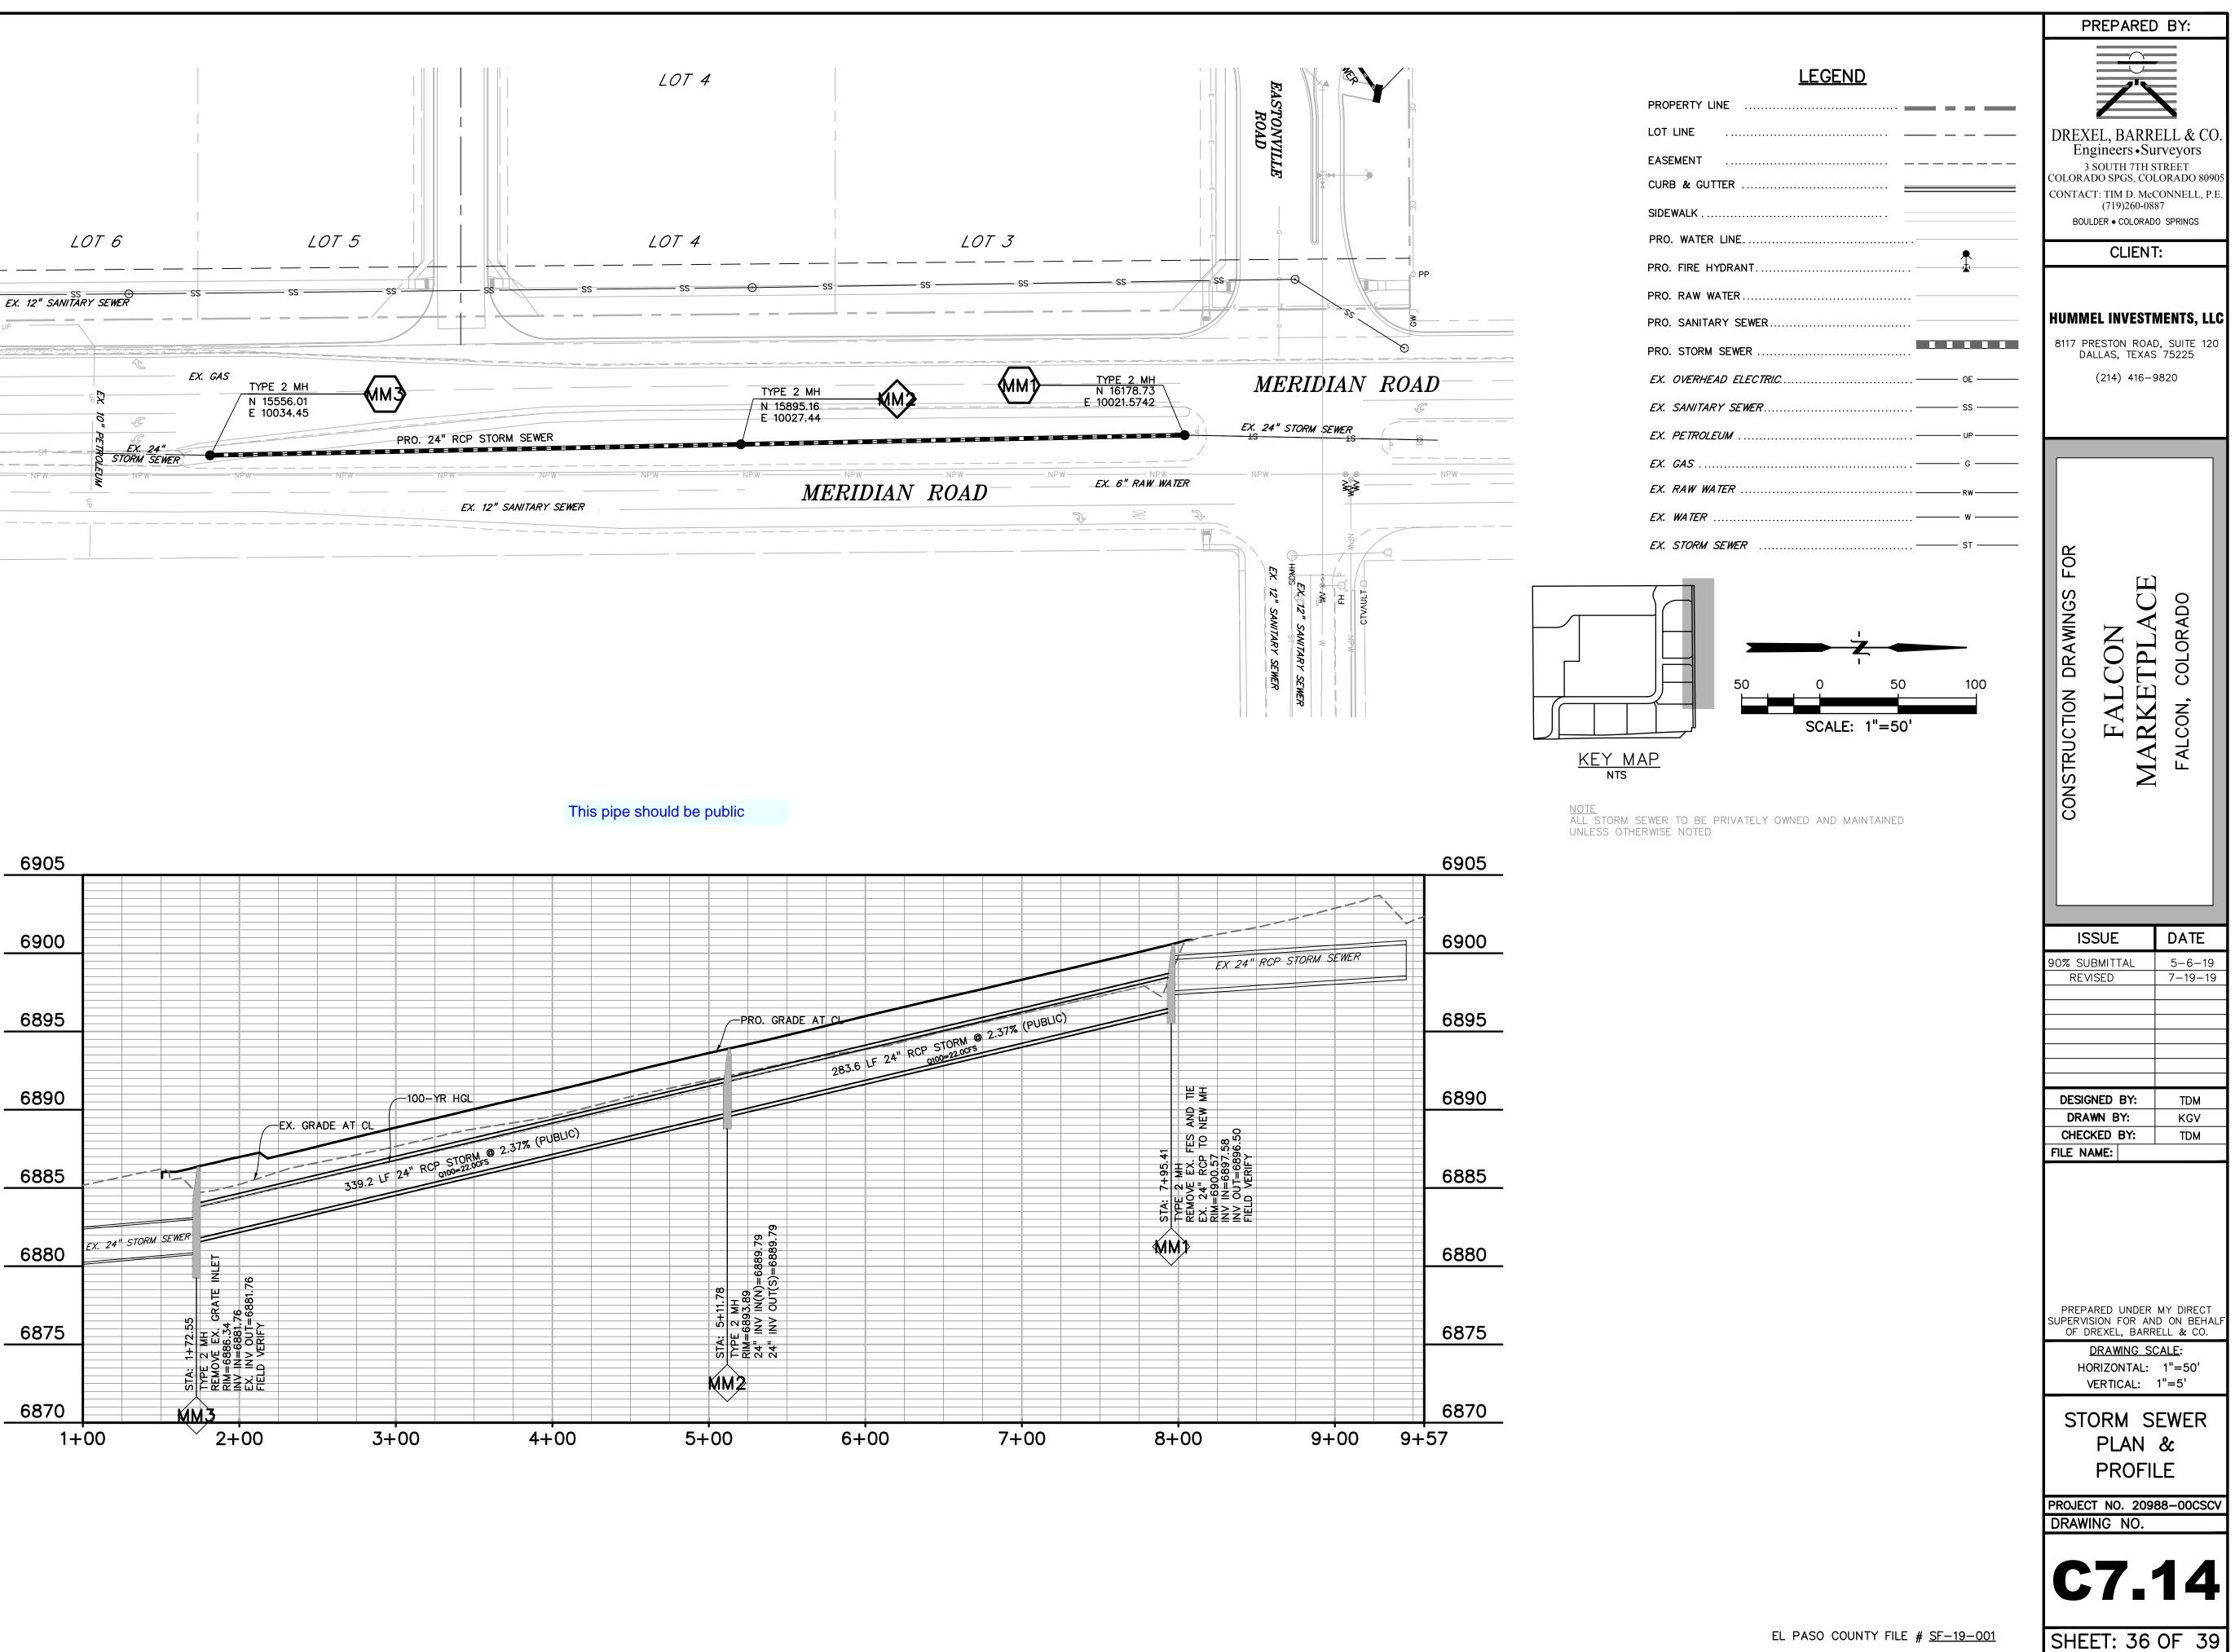

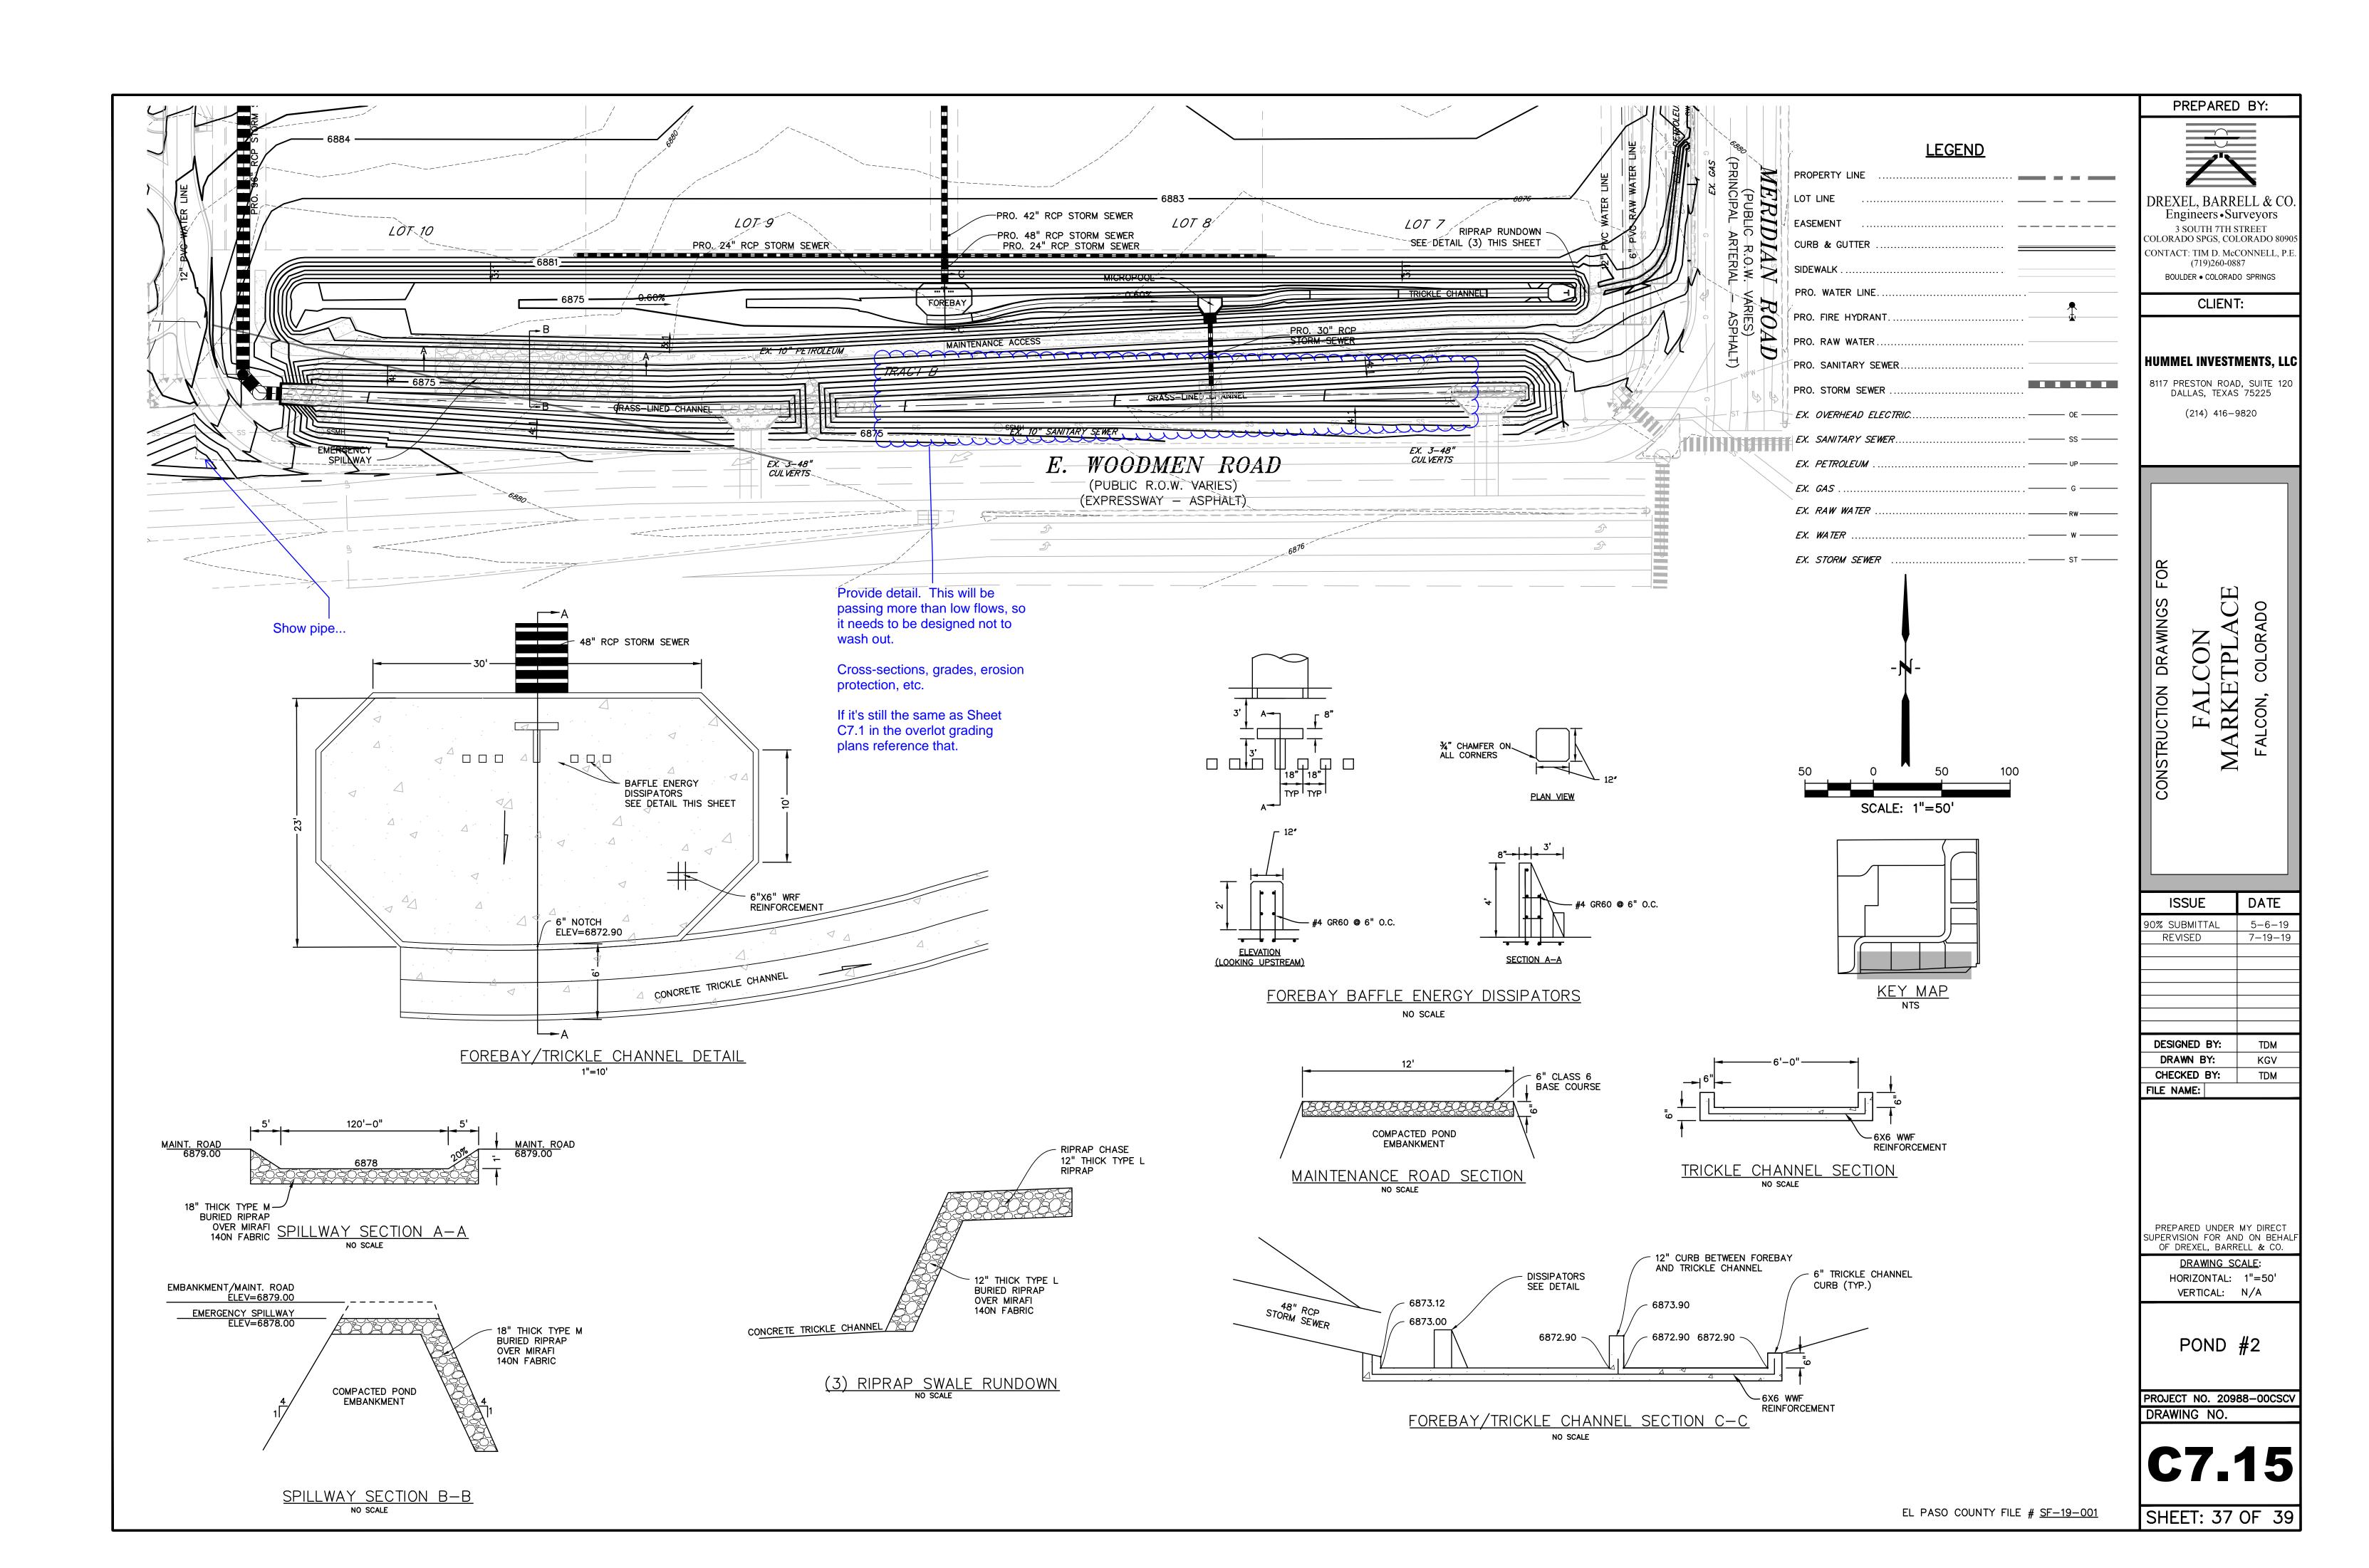


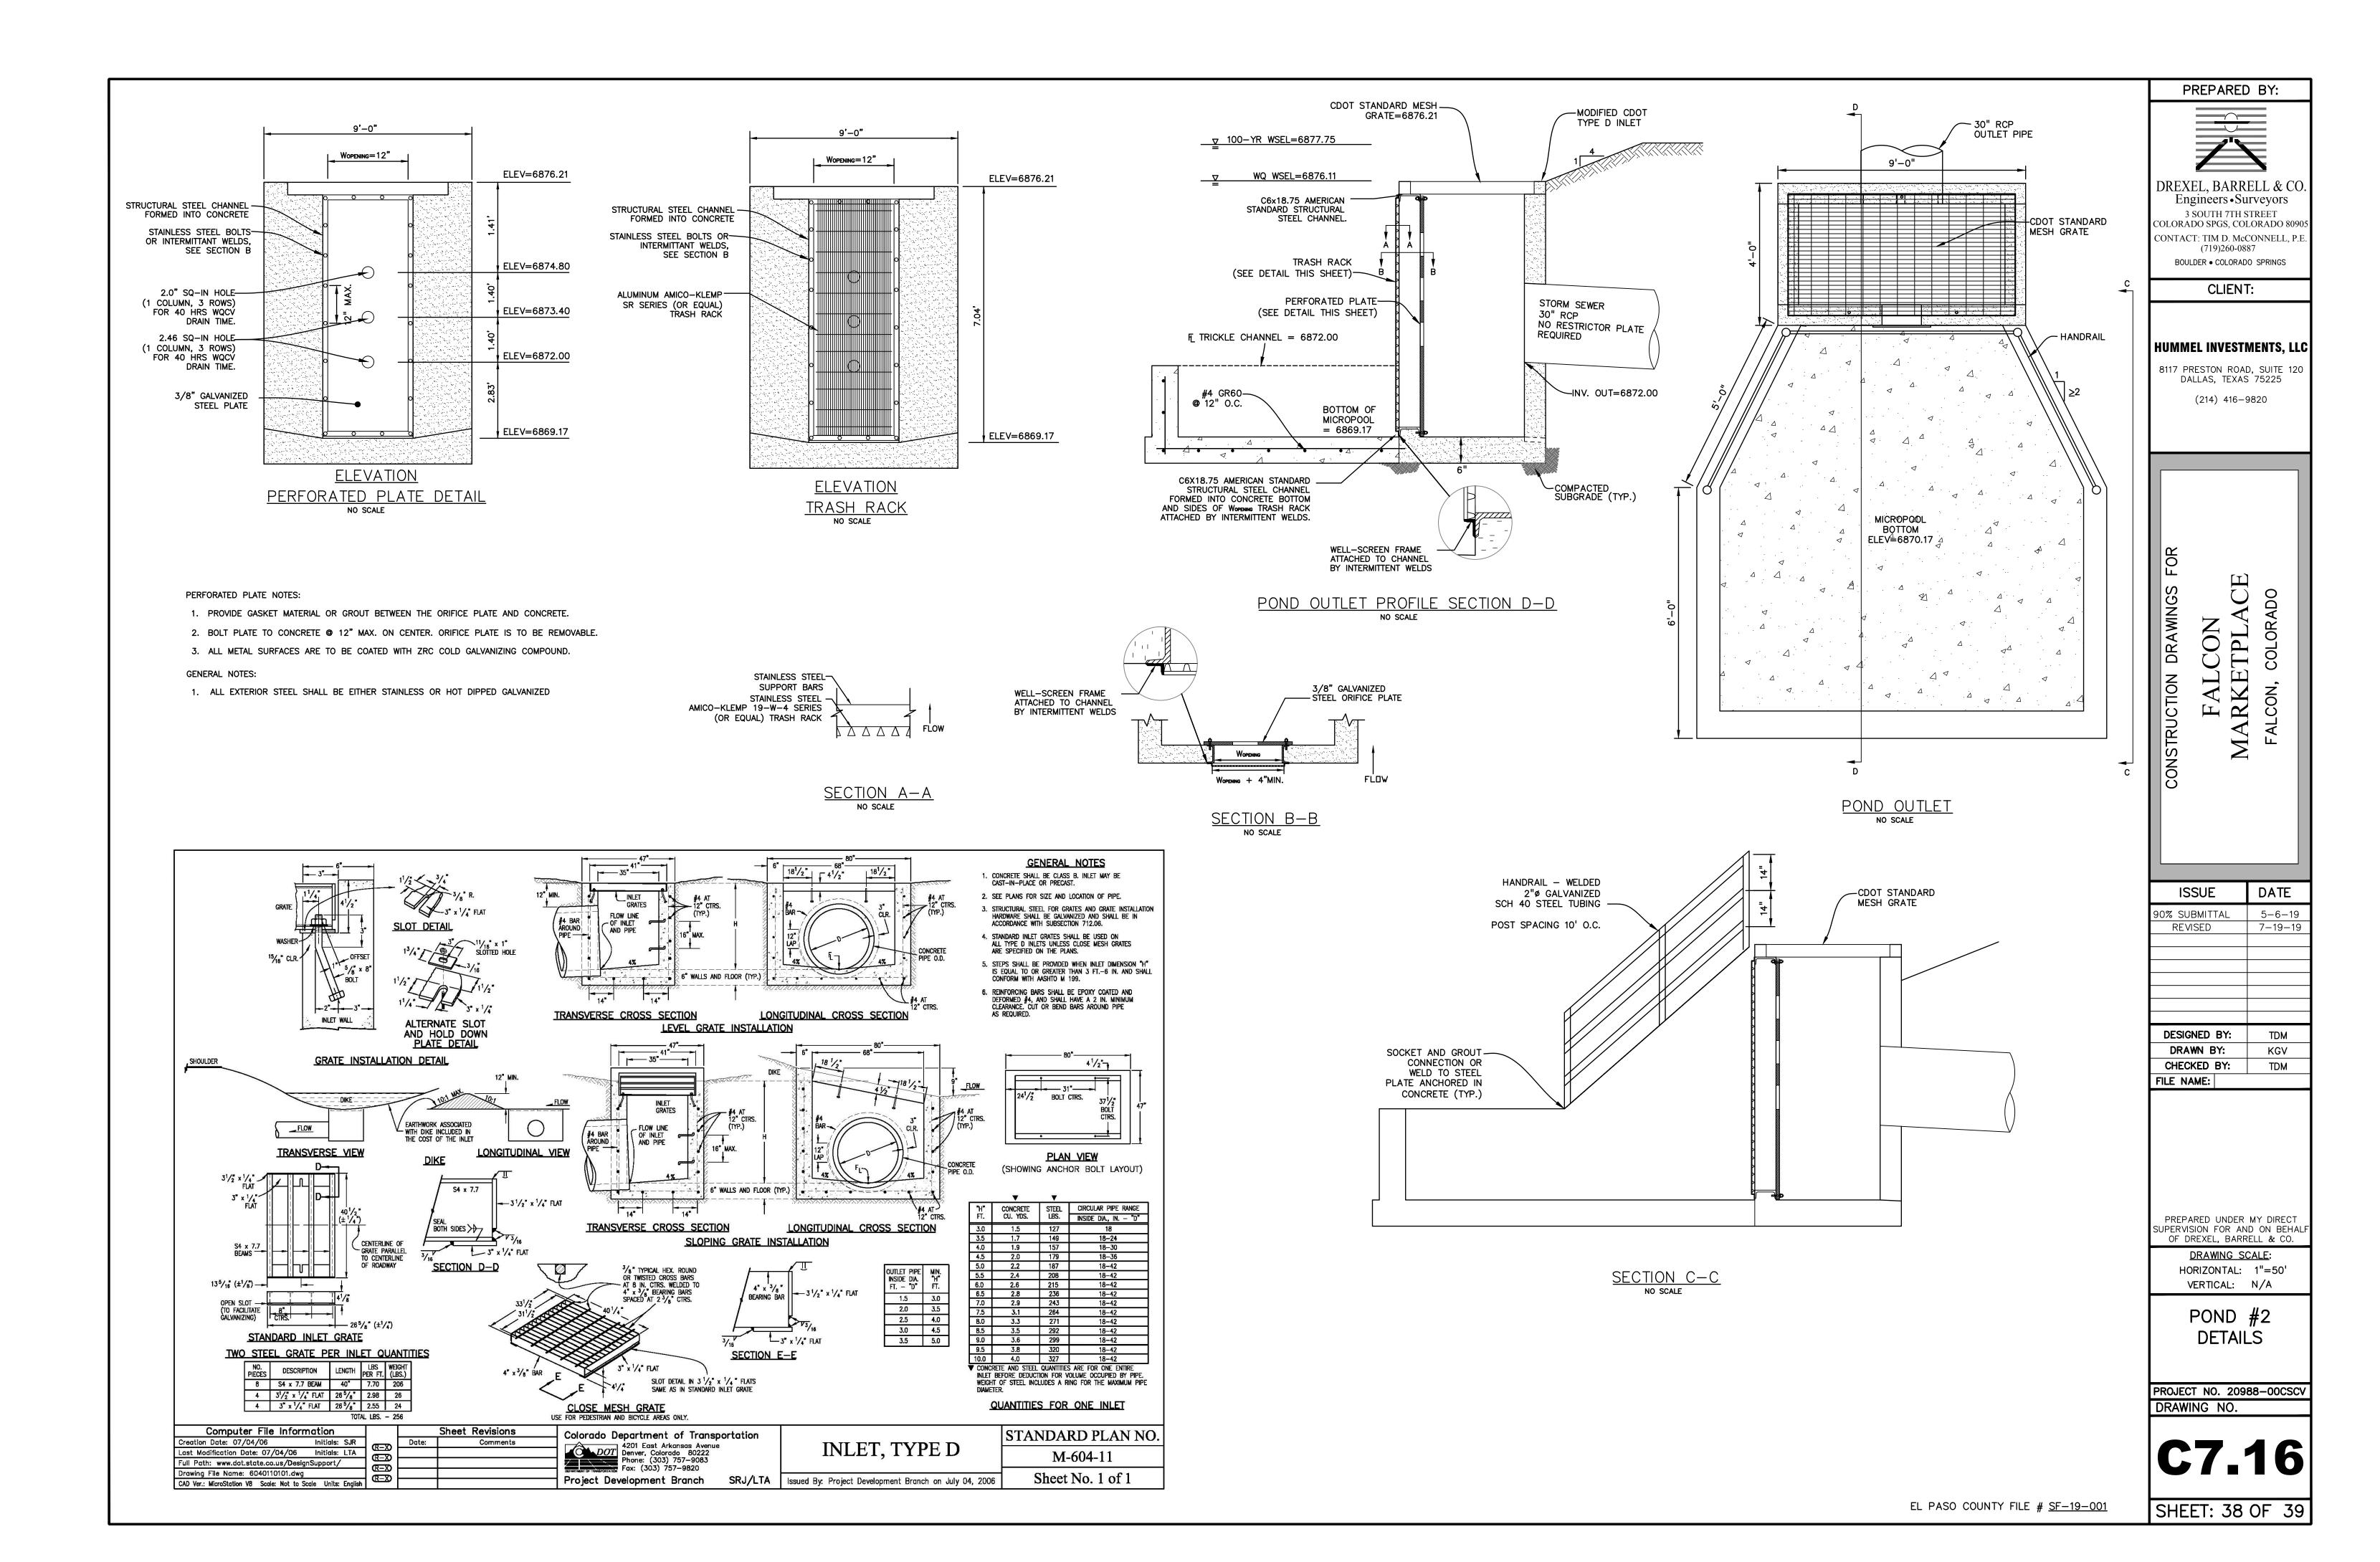


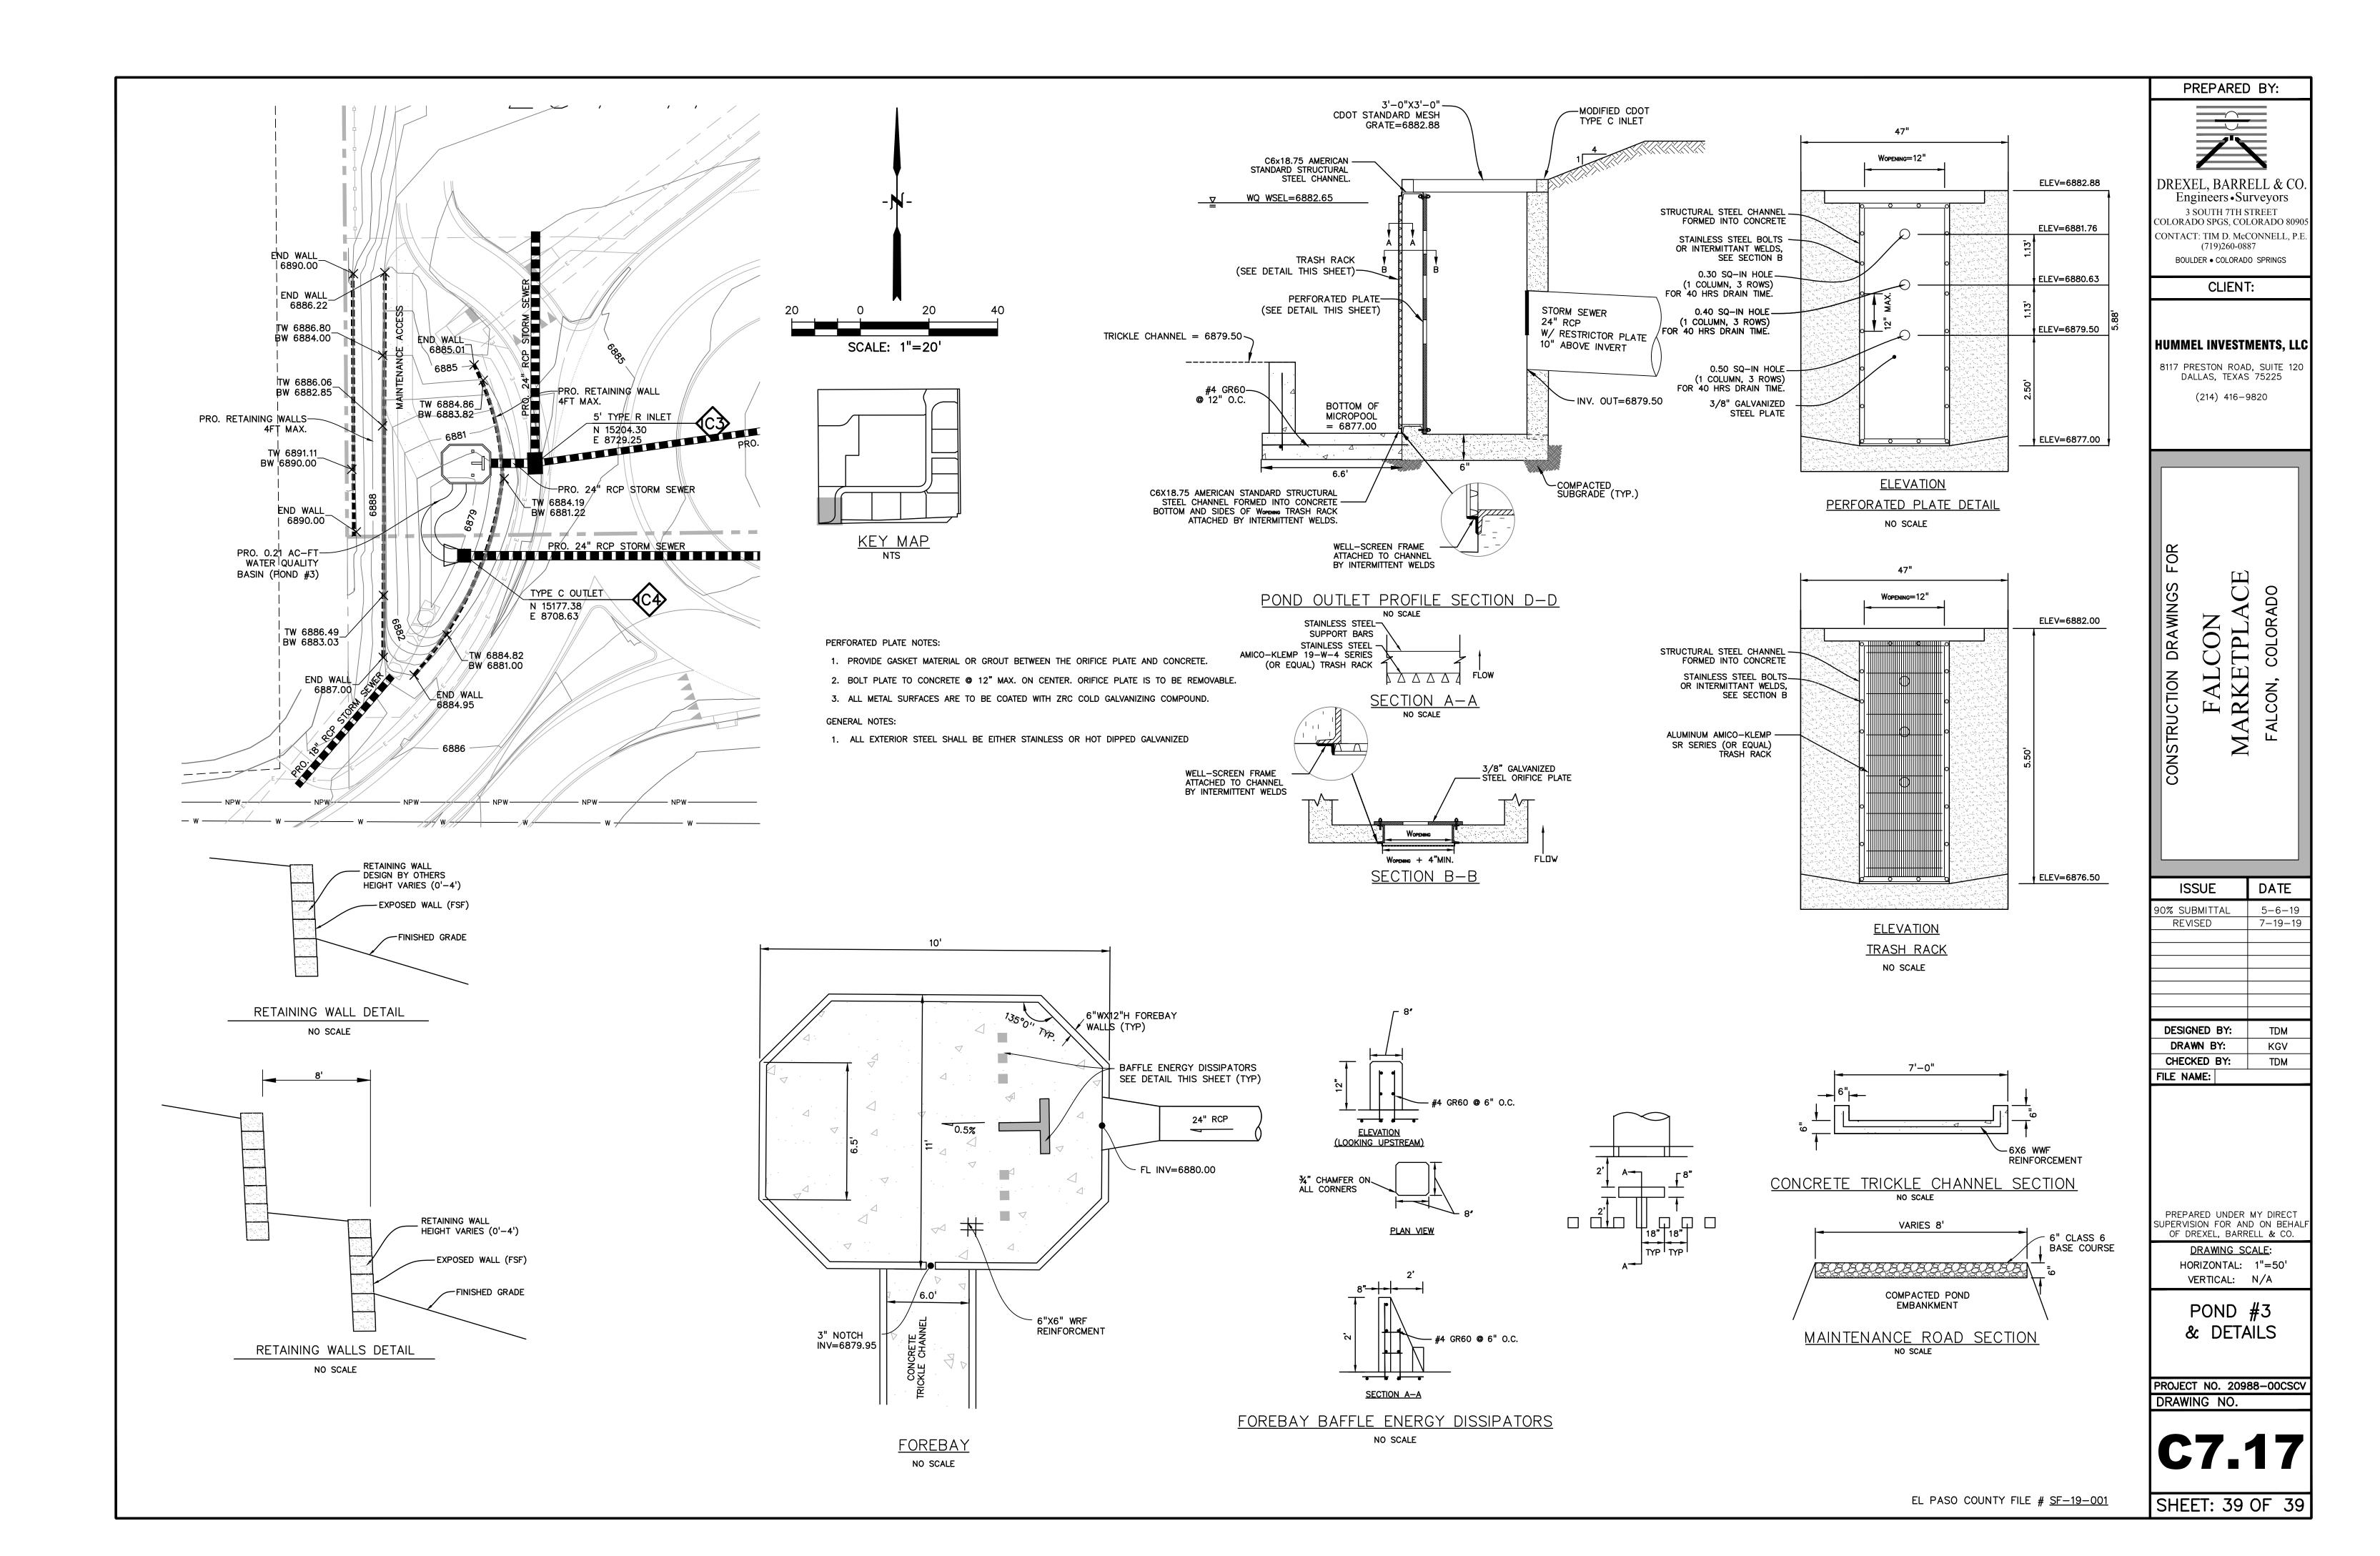

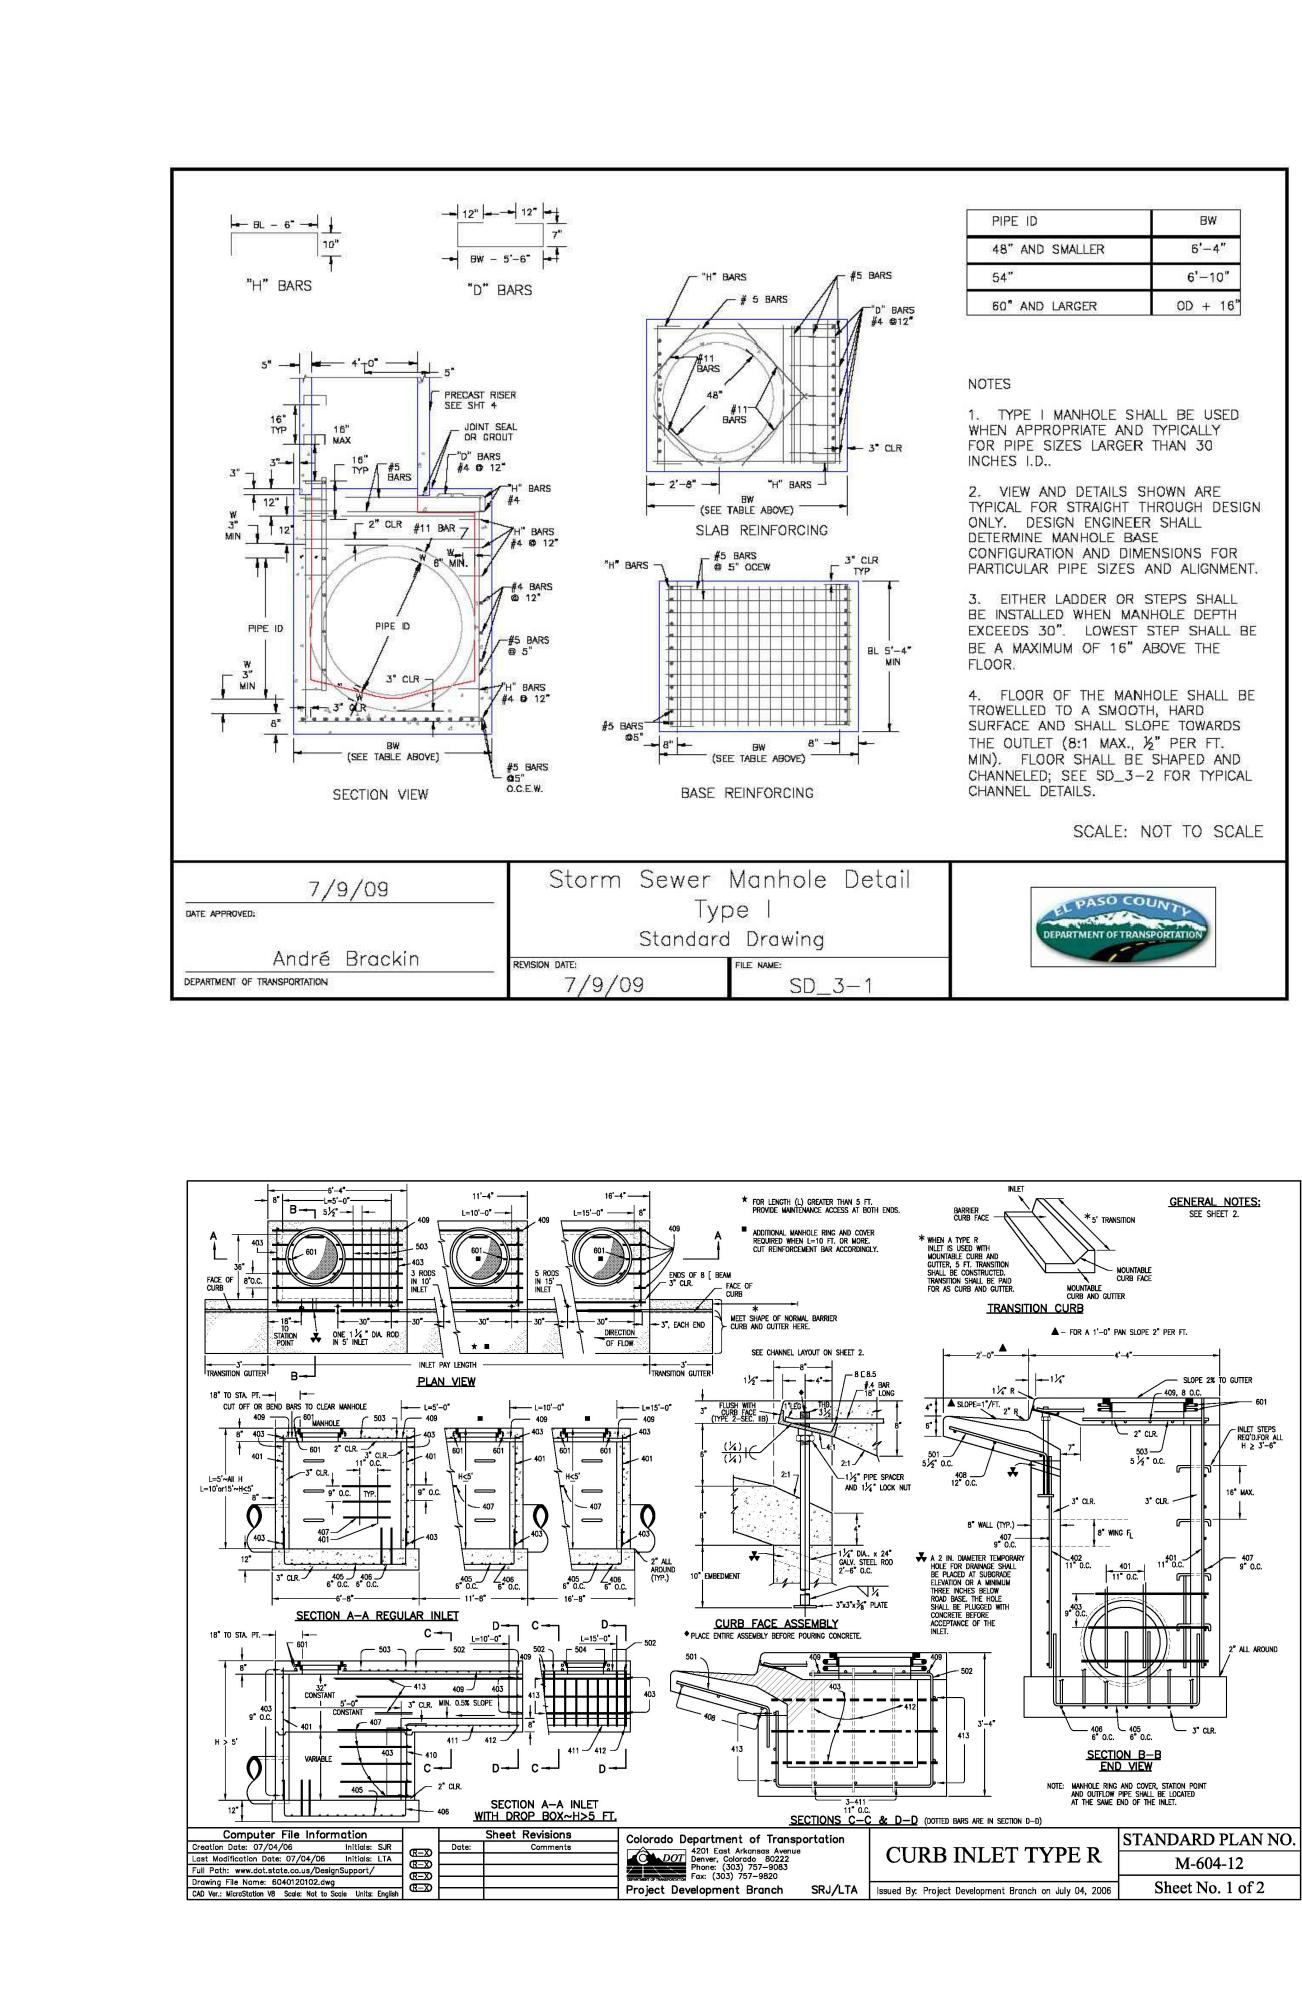

PIPE ID	BW
48" AND SMALLER	6'-4"
54"	6'-10"
60" AND LARGER	OD + 16

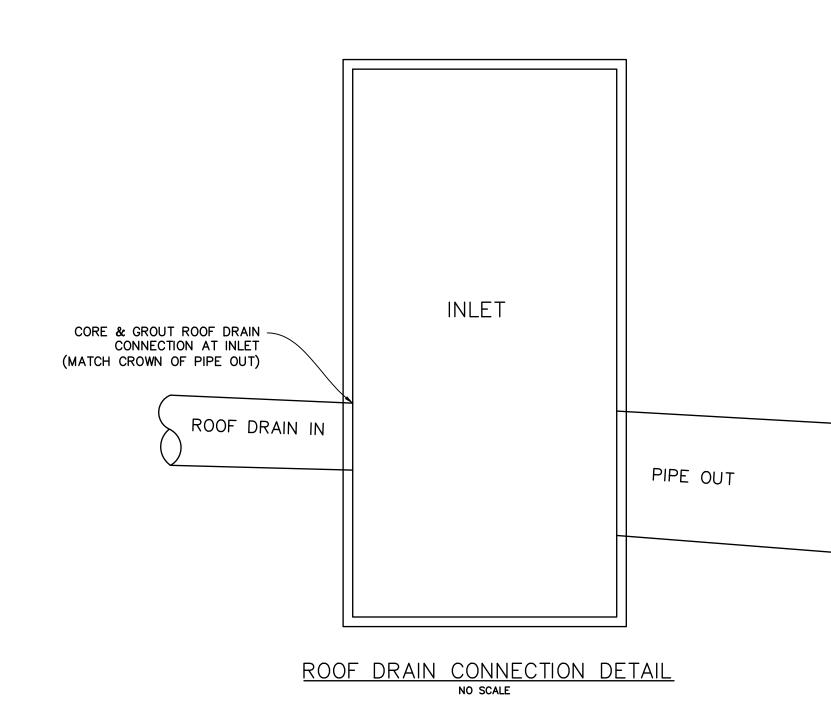

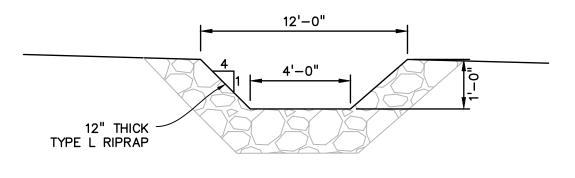

CURB CUT CHASE SECTION NO SCALE

DREXEL, BARRELL & CO. Engineers - Surveyors 3 SOUTH 7TH STREET COLORADO SPGS, COLORADO SPOS CONTACT: TIM D. MCCONNELL, P.E. (19)260-0357 BOULDER - COLORADO SPRINGS CLIENT: HUMMEL INVESTMENTS, LLC 8117 PRESTON ROAD, SUITE 120 DALLAS, TEXAS 75225 (214) 416–9520 NOOTHY NOOTHY PREPAR	ED BY:	
ISSUE DATE 90% SUBMITTAL 5-6-19 REVISED 7-19-19 DESIGNED BY: TDM DRAWN BY: KGV CHECKED BY: TDM FILE NAME: FILE NAME: PREPARED UNDER MY DIRECT SUPERVISION FOR AND ON BEHALF OF DREXEL, BARRELL & CO. DRAWING SCALE: HORIZONTAL: N/A VERTICAL: N/A STORM SEWER DETAILS PROJECT NO. 20988-00CSCV DRAWING NO. CT18	Engineers • Surveyors 3 SOUTH 7TH STREET COLORADO SPGS, COLORADO 80905 CONTACT: TIM D. McCONNELL, P.E. (719)260-0887 BOULDER • COLORADO SPRINGS CLIENT: HUMMEL INVESTMENTS, LLC 8117 PRESTON ROAD, SUITE 120 DALLAS, TEXAS 75225		
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90% SUBMITTAL 5-6-19 REVISED 7-19-19 DESIGNED BY: TDM DRAWN BY: KGV CHECKED BY: TDM FILE NAME:			
REVISED 7-19-19	ISSUE	DATE	
DRAWN BY: KGV CHECKED BY: TDM FILE NAME: PREPARED UNDER MY DIRECT SUPERVISION FOR AND ON BEHALF OF DREXEL, BARRELL & CO. DRAWING SCALE: HORIZONTAL: N/A VERTICAL: N/A VERTICAL: N/A STORM SEWER DETAILS PROJECT NO. 20988–00CSCV DRAWING NO.			
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PROJECT NO. 20988-00CSCV DRAWING NO.	SUPERVISION FOR AND ON BEHALF OF DREXEL, BARRELL & CO. DRAWING SCALE: HORIZONTAL: N/A VERTICAL: N/A STORM SEWER		
C7.18	PROJECT NO. 2	0988-00CSCV	
SHEET: 40 OF 39	C7 .	18	

ENG-SF19001-R3-CDs.pdf Markup Summary

2 (2)		
Update notes	Subject: Text Box Page Index: 2 Date: 8/7/2019 3:38:43 PM Author: dsdrice Color: Layer: Space: Page Label: [2] 2 C1.11	Update notes
	Subject: Callout Page Index: 2 Date: 8/8/2019 1:37:53 PM Author: dsdrice Color: Layer: Space: Page Label: [2] 2 C1.11	Watertight joints shall be provided on the specified pipes.
4 (1)		
	Subject: Callout Page Index: 4 Date: 8/6/2019 11:22:49 AM Author: dsdrice Color: Layer: Space: Page Label: [4] 4 C1.13	Dimension height
5 (3)		
	Subject: Callout Page Index: 5 Date: 8/8/2019 11:15:12 AM Author: dsdrice Color: Layer: Space: Page Label: [5] 5 C1.14	Does this pole have to be moved?
EAD ELECTRIC JAIN PROTECT IN PLACE	Subject: Page Index: 5 Date: 8/8/2019 11:15:30 AM Author: dsdrice Color: Layer: Space: Page Label: [5] 5 C1.14	
	Subject: Text Box Page Index: 5 Date: 8/8/2019 8:42:43 AM Author: dsdrice Color: Layer: Space: Page Label: [5] 5 C1.14	Reference ECM K.1 for pavement cutting requirements.

6 (4)		
show new location	Subject: Callout Page Index: 6 Date: 8/6/2019 12:02:03 PM Author: dsdrice Color: Layer: Space: Page Label: [6] 6 C1.15	show new location
II NOV is in an estemat please provide a copy. Lease composition of the composition of th	Subject: Callout Page Index: 6 Date: 8/6/2019 12:02:55 PM Author: dsdrice Color: Layer: Space: Page Label: [6] 6 C1.15	If NPW is in an easement please provide a copy.
	Subject: Callout Page Index: 6 Date: 8/6/2019 12:03:40 PM Author: dsdrice Color: Layer: Space: Page Label: [6] 6 C1.15	Is FOC to be protected or moved?
Show and label OHE LOT IS UNES I MAGN UNES I & WAY I	Subject: Callout Page Index: 6 Date: 8/8/2019 12:20:52 PM Author: dsdrice Color: Layer: Space: Page Label: [6] 6 C1.15	Show and label OHE
8 (6)		
DORENO EN	Subject: Callout Page Index: 8 Date: 8/6/2019 1:25:48 PM Author: dsdrice Color: Layer: Space: Page Label: [8] 8 C2.10	IP?
	Subject: Cloud+ Page Index: 8 Date: 8/6/2019 12:06:56 PM Author: dsdrice Color: Layer: Space: Page Label: [8] 8 C2.10	It appears that some work needs to be done on grading and apron. Provide details and easement if necessary.



Subject: Arrow Page Index: 8 Date: 8/6/2019 12:08:06 PM Author: dsdrice Color: Layer: Space: Page Label: [8] 8 C2.10



Subject: Cloud+ Page Index: 8 Date: 8/6/2019 12:10:19 PM Author: dsdrice Color: Layer: Space: Page Label: [8] 8 C2.10

Something is still not right here. Too many contour lines crossing?



Subject: Callout Page Index: 8 Date: 8/6/2019 3:45:28 PM Author: dsdrice Color: Layer: Space: Page Label: [8] 8 C2.10

Add: See Sheet ____ for details



Subject: Callout Page Index: 8 Date: 8/8/2019 11:16:23 AM Author: dsdrice Color: Layer: Space: Page Label: [8] 8 C2.10

label OHE

9 (2)




Subject: Page Index: 9 Date: 8/9/2019 1:26:23 PM Author: dsdrice Color: Layer: Space: Page Label: [9] 9 C2.11



Page Index: 9 Date: 8/9/2019 1:26:25 PM Author: dsdrice Color: Layer: Space: Page Label: [9] 9 C2.11

11 (7)

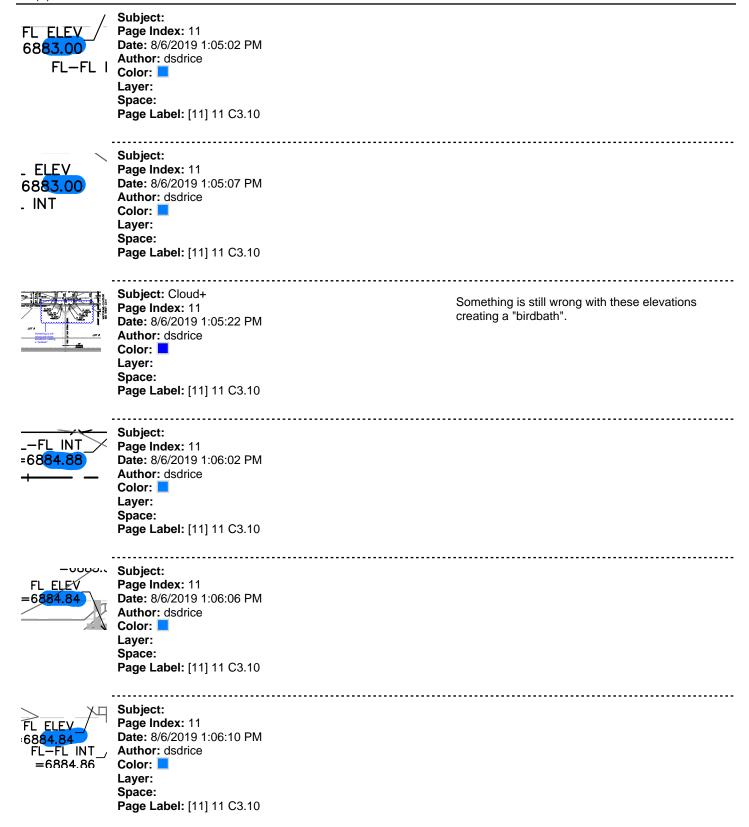

384.84 -L-FL INT =6884.86 FL ELEV =6885.36 Subject: Page Index: 11 Date: 8/6/2019 1:06:14 PM Author: dsdrice Color: Layer: Space: Page Label: [11] 11 C3.10

13 (3)



Subject: Callout Page Index: 13 Date: 8/6/2019 1:19:01 PM Author: dsdrice Color: Layer: Space: Page Label: [13] 13 C3.12

The contour low point and spot elevations should be centered in crosspan.



Subject: Callout Page Index: 13 Date: 8/6/2019 1:22:31 PM Author: dsdrice Color: Layer: Space: Page Label: [13] 13 C3.12

10-foot crosspan per SD_2-26

3+71.15 74. ???? MR =6889.11

Subject: Page Index: 13 Date: 8/6/2019 1:23:16 PM Author: dsdrice Color: Layer: Space: Page Label: [13] 13 C3.12

14 (1)



Subject: Callout Page Index: 14 Date: 8/7/2019 10:50:11 AM Author: dsdrice Color: Layer: Space: Page Label: [14] 14 C3.13

All gutter pans (to points) and ramps are concrete. (on all 4 splitter islands)

15 (32)



Subject: Page Index: 15 Date: 8/7/2019 1:52:58 PM Author: dsdrice Color: Layer: Space: Page Label: [15] 15 C3.14

Subject: Callout 4" SINGLE WHITE SOLID (4" SINGLE YELLOW BROKEN delete inner line Page Index: 15 Date: 8/7/2019 1:53:14 PM Author: dsdrice delete inner line Color: Layer: Space: Page Label: [15] 15 C3.14 Subject: Callout label double yellow Page Index: 15 Date: 8/7/2019 1:55:26 PM Author: dsdrice Color: Layer: Space: Page Label: [15] 15 C3.14 Subject: Callout label white, delete inner line Page Index: 15 Date: 8/7/2019 1:55:49 PM Author: dsdrice Color: Layer: Space: Page Label: [15] 15 C3.14 -----Subject: Highlight Page Index: 15 Date: 8/7/2019 2:18:53 PM Author: dsdrice Color: Layer: Space: Page Label: [15] 15 C3.14 Subject: Highlight Page Index: 15 Date: 8/7/2019 2:18:57 PM Author: dsdrice Color: Laver: Space: Page Label: [15] 15 C3.14 Subject: Highlight Page Index: 15 Date: 8/7/2019 2:19:00 PM Author: dsdrice Color: Layer: Space: Page Label: [15] 15 C3.14

LACE

Subject: Highlight Page Index: 15 Date: 8/7/2019 2:19:07 PM Author: dsdrice Color: Layer: Space: Page Label: [15] 15 C3.14



.....



Subject: Callout Page Index: 15 Date: 8/7/2019 2:19:16 PM Author: dsdrice Color: Layer: Space: Page Label: [15] 15 C3.14



Subject: Page Index: 15 Date: 8/7/2019 2:19:49 PM Author: dsdrice Color: Layer: Space: Page Label: [15] 15 C3.14

.....

.....



Subject: Page Index: 15 Date: 8/7/2019 2:19:52 PM Author: dsdrice Color: Layer: Space: Page Label: [15] 15 C3.14

single yellow only?

.....



Subject: Callout Page Index: 15 Date: 8/7/2019 2:20:16 PM Author: dsdrice Color: Layer: Space: Page Label: [15] 15 C3.14

delete at driveways?



Subject: Callout Page Index: 15 Date: 8/7/2019 2:20:56 PM Author: dsdrice Color: Layer: Space: Page Label: [15] 15 C3.14

Subject: Highlight Page Index: 15 Date: 8/7/2019 2:21:12 PM Author: dsdrice Color: 📕 Layer: Space: Page Label: [15] 15 C3.14 Subject: Highlight Page Index: 15 Date: 8/7/2019 2:21:15 PM Author: dsdrice Color: Layer: Space: Page Label: [15] 15 C3.14 Subject: Callout -TEMPORARY CDOT TYPE BARRICADE (TYP) add arrows Page Index: 15 Date: 8/7/2019 2:21:24 PM Author: dsdrice Color: Layer: Space: Page Label: [15] 15 C3.14 Subject: Callout delete/open Page Index: 15 Date: 8/7/2019 2:22:00 PM Author: dsdrice Color: Layer: Space: Page Label: [15] 15 C3.14 Subject: Page Index: 15 Date: 8/7/2019 2:22:04 PM Author: dsdrice Color: Laver: Space: Page Label: [15] 15 C3.14 Subject: Text Box Purple dots indicate where double arrows are Page Index: 15 needed for TWLT lane (ref. MUTCD Fig. 3B-7) Date: 8/7/2019 2:28:08 PM Author: dsdrice Color: Layer: Space: Page Label: [15] 15 C3.14

KET PLACE	Subject: Page Index: 15 Date: 8/7/2019 2:32:15 PM Author: dsdrice Color: Layer: Space: Page Label: [15] 15 C3.14	
<u>KET PLACE</u>	Subject: Page Index: 15 Date: 8/7/2019 2:32:19 PM Author: dsdrice Color: Layer: Space: Page Label: [15] 15 C3.14	
	Subject: Cloud+ Page Index: 15 Date: 8/7/2019 2:35:26 PM Author: dsdrice Color: Layer: Space: Page Label: [15] 15 C3.14	This area needs to be discussed.
	Subject: Page Index: 15 Date: 8/7/2019 2:37:41 PM Author: dsdrice Color: Layer: Space: Page Label: [15] 15 C3.14	
delete?	Subject: Callout Page Index: 15 Date: 8/7/2019 2:37:53 PM Author: dsdrice Color: Layer: Space: Page Label: [15] 15 C3.14	delete?
	Subject: Highlight Page Index: 15 Date: 8/7/2019 2:47:43 PM Author: dsdrice Color: Layer: Space: Page Label: [15] 15 C3.14	extend?

Subject: Callout right and left? Page Index: 15 Date: 8/7/2019 3:46:35 PM right and left Author: dsdrice Color: 🗖 Layer: Space: Page Label: [15] 15 C3.14 Subject: Callout right (NB) and left (WB)? Page Index: 15 Date: 8/7/2019 3:47:31 PM Author: dsdrice Color: Layer: Space: Page Label: [15] 15 C3.14 Subject: Snapshot Page Index: 15 Date: 8/7/2019 4:07:00 PM Author: dsdrice Color: 📕 Layer: Space: Page Label: [15] 15 C3.14 Subject: Highlight Page Index: 15 Date: 8/7/2019 4:07:41 PM Author: dsdrice Color: Layer: Space: Page Label: [15] 15 C3.14 Subject: Highlight Page Index: 15 Date: 8/7/2019 4:08:11 PM Author: dsdrice Color: Laver: Space: Page Label: [15] 15 C3.14 Subject: Highlight Page Index: 15 Date: 8/7/2019 4:08:43 PM Author: dsdrice Color: Layer: Space: Page Label: [15] 15 C3.14

_____ Subject: Text Box Page Index: 15 Date: 8/7/2019 4:09:21 PM Author: dsdrice Color: Layer: Space:

Aren't these signs needed? See MUTCD 2C.05, Fig. 2C-2

Aren't these signs needed? See MUTCD 2C.05, Fig. 2C-2

	Page Label: [15] 15 C3.14	
16 (8)		
8+00 1 X	Subject: Arrow Page Index: 16 Date: 8/7/2019 1:20:11 PM Author: dsdrice Color: Layer: Space: Page Label: [16] 16 C4.10	
; ×	Subject: Text Box Page Index: 16 Date: 8/7/2019 1:20:30 PM Author: dsdrice Color: Layer: Space: Page Label: [16] 16 C4.10	 2.00%(?)
FL	Subject: Arrow Page Index: 16 Date: 8/7/2019 1:23:33 PM Author: dsdrice Color: Layer: Space: Page Label: [16] 16 C4.10	
label	Subject: Text Box Page Index: 16 Date: 8/7/2019 1:23:45 PM Author: dsdrice Color: Layer: Space: Page Label: [16] 16 C4.10	 label
The state and to be discussed to be discussed to the discussed to the discussed to the discussed to the discussed to the discussed to the discussed to the discussed to the discussed to the disc	Subject: Callout Page Index: 16 Date: 8/7/2019 3:03:44 PM Author: dsdrice Color: Layer: Space: Page Label: [16] 16 C4.10	 This area needs to be discussed



Subject: Dimension Page Index: 16 Date: 8/7/2019 3:04:11 PM Author: dsdrice Color: Layer: Space: Page Label: [16] 16 C4.10

12'

16'



Subject: Dimension Page Index: 16 Date: 8/7/2019 3:05:09 PM Author: dsdrice Color: Layer: Space: Page Label: [16] 16 C4.10



Subject: Highlight Page Index: 16 Date: 8/7/2019 3:05:30 PM Author: dsdrice Color: Layer: Space: Page Label: [16] 16 C4.10

17 (4)




Subject: Page Index: 17 Date: 8/7/2019 3:34:30 PM Author: dsdrice Color: Layer: Space: Page Label: [17] 17 C4.11



Subject: Page Index: 17 Date: 8/7/2019 3:34:36 PM Author: dsdrice Color: Layer: Space: Page Label: [17] 17 C4.11



Subject: Page Index: 17
Date: 8/7/2019 3:34:54 PM
Author: dsdrice
Color: Layer:
Space:
Page Label: [17] 17 C4.11

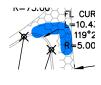

Subject: Page Index: 17 Date: 8/7/2019 3:35:33 PM Author: dsdrice Color: Layer: Space: Page Label: [17] 17 C4.11

18 (3)

(SPILL)

Page Index: 18 DETAIL THIS DETAIL SD_2-21. Date: 8/7/2019 1:26:18 PM PATTERN SEE Author: dsdrice Color: Laver: Space: Page Label: [18] 18 C4.12

Subject:



Subject: Page Index: 18 Date: 8/7/2019 3:21:00 PM Author: dsdrice Color: 📕 Layer: Space: Page Label: [18] 18 C4.12



..... Subject: Text Box Page Index: 18 Date: 8/7/2019 3:33:28 PM Author: dsdrice Color: 📘 Layer: Space: Page Label: [18] 18 C4.12

Please overlay the sight control lines through the center islands on the C4 sheets.

19 (5)



Subject: Cloud+ Page Index: 19 Date: 8/7/2019 3:11:09 PM Author: dsdrice Color: Layer: Space: Page Label: [19] 19 C4.13

.

label slopes and cross-slopes in pedestrian crossing

Subject: Callout Page Index: 19 Date: 8/7/2019 3:18:14 PM Author: dsdrice Color: Layer: Space: Page Label: [19] 19 C4.13

Also label pedestrian crossing cross-slopes. Will they meet ADA requirements?



Subject: Highlight Page Index: 19 Date: 8/7/2019 3:18:55 PM Author: dsdrice Color: Layer: Space: Page Label: [19] 19 C4.13



Subject: Highlight Page Index: 19 Date: 8/7/2019 3:19:14 PM Author: dsdrice Color: Layer: Space: Page Label: [19] 19 C4.13

Date: 8/7/2019 3:20:02 PM

Page Label: [19] 19 C4.13


.

Subject: Callout

Page Index: 19

Author: dsdrice Color: Layer: Space: -----

.

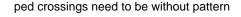

20 (6)



Subject: Cloud+ Page Index: 20 Date: 8/7/2019 1:45:15 PM Author: dsdrice Color: Layer: Space: Page Label: [20] 20 C4.14

move west?

Is W13-1 needed here?

 Subject: Callout Page Index: 20 Date: 8/7/2019 1:46:46 PM Author: dsdrice Color: Layer: Space: Page Label: [20] 20 C4.14



Subject: Highlight Page Index: 20 Date: 8/7/2019 3:42:13 PM Author: dsdrice Color: Layer: Space: Page Label: [20] 20 C4.14

Subject: Page Index: 20 Date: 8/7/2019 3:48:05 PM Author: dsdrice Color: Layer: Space: Page Label: [20] 20 C4.14 _____ Subject: Page Index: 20 Date: 8/7/2019 3:49:24 PM Author: dsdrice 12' Color: Layer: Space: Page Label: [20] 20 C4.14 _____ Subject: Text Box Is a W1-1 needed? Page Index: 20 Date: 8/7/2019 4:11:49 PM Is a W1-1 needed? Author: dsdrice Color: Layer: Space: Page Label: [20] 20 C4.14 Subject: Line Page Index: 21 Date: 8/7/2019 3:50:50 PM Author: dsdrice Color: 📘 Layer: Space: Page Label: [21] 21 C4.15 _____ Subject: Callout 3588588 Label offset Page Index: 21 Date: 8/7/2019 3:50:50 PM

21 (6)

Page Label: [21] 21 C4.15 Subject: Line Page Index: 21 Date: 8/7/2019 4:16:36 PM Author: dsdrice Color: Layer: Space: Page Label: [21] 21 C4.15

Author: dsdrice Color: Layer: Space:

MA3-35	Subject: Dimension Page Index: 21 Date: 8/7/2019 4:36:56 PM Author: dsdrice Color: Layer: Space: Page Label: [21] 21 C4.15	7'?
Image:	Subject: Snapshot Page Index: 21 Date: 8/7/2019 4:42:10 PM Author: dsdrice Color: Layer: Space: Page Label: [21] 21 C4.15	
	Subject: Cloud+ Page Index: 21 Date: 8/7/2019 4:48:22 PM Author: dsdrice Color: Layer: Space: Page Label: [21] 21 C4.15	lane widths need to be 12' EOP-EOP, not face of curb
22 (2)		
	Subject: Cloud+ Page Index: 22 Date: 8/6/2019 11:44:02 AM Author: dsdrice Color: Layer: Space: Page Label: [22] 22 C5.10	yellow?
B' dotted?	Subject: Callout Page Index: 22 Date: 8/6/2019 11:52:28 AM Author: dsdrice Color: Layer: Space: Page Label: [22] 22 C5.10	8" dotted?
25 (2)		
F append for spore of each be accounted in made be accounted in made for accounted in made for accounted accounted for accounted accounted for accounted accounted Subject: Cloud+ Page Index: 25 Date: 8/8/2019 7:53:21 AM	It appears that apron will need to be reconstructed to meet driveway grade requirements. Provide

Author: dsdrice Color: Layer: Space: Page Label: [25] 25 C5.13

detail and easement.

Subject: Text Box Page Index: 25 Date: 8/8/2019 7:54:02 AM Author: dsdrice Color: Layer: Space: Page Label: [25] 25 C5.13

Show and label utilities.

26 (3)



Subject: Callout Page Index: 26 Date: 8/8/2019 10:15:41 AM Author: dsdrice Color: Layer: Space: Page Label: [26] 26 C5.14

Date: 8/8/2019 8:00:21 AM

Page Label: [26] 26 C5.14

Subject: Callout

Page Index: 26

Author: dsdrice Color: Layer: Space: Label cross-slopes

Label existing grade

5 0+75 1+00 1-1-1-0 existing 2+ Subject: Callout Page Index: 26 Date: 8/8/2019 8:01:12 AM Author: dsdrice Color: Layer: Space: Page Label: [26] 26 C5.14

Label existing grade

27 (2)



Subject: Text Box Page Index: 27 Date: 8/8/2019 8:02:44 AM Author: dsdrice Color: Layer: Space: Page Label: [27] 27 C5.15

SEE DETAIL SHEET ...

Libel


Subject: Callout Page Index: 27 Date: 8/8/2019 8:05:40 AM Author: dsdrice Color: Layer: Space: Page Label: [27] 27 C5.15

.....

Label

28 (7)

45?	Subject: Cloud+ Page Index: 28 Date: 8/6/2019 11:12:33 AM Author: dsdrice Color: Layer: Space: Page Label: [28] 28 C5.16	45?
105.13.07% 101-10200 2000 2000 2000 2000 2000 2000	Subject: Callout Page Index: 28 Date: 8/7/2019 11:02:44 AM Author: dsdrice Color: Layer: Space: Page Label: [28] 28 C5.16	30"x36"? (see comment letter)
	Subject: Highlight Page Index: 28 Date: 8/8/2019 12:02:36 PM Author: dsdrice Color: Layer: Space: Page Label: [28] 28 C5.16	
	Subject: Highlight Page Index: 28 Date: 8/8/2019 12:02:36 PM Author: dsdrice Color: Layer: Space: Page Label: [28] 28 C5.16	
	Subject: Text Box Page Index: 28 Date: 8/8/2019 12:02:51 PM Author: dsdrice Color: Layer: Space: Page Label: [28] 28 C5.16	Reference MUTCD 3B.08 regarding dotted lane extensions for offset lanes and turn lanes.
	Subject: Callout Page Index: 28 Date: 8/8/2019 12:02:58 PM Author: dsdrice Color: Layer: Space: Page Label: [28] 28 C5.16	Not found/not complete

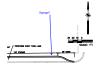

Subject: Callout Page Index: 28 Date: 8/8/2019 12:16:05 PM Author: dsdrice Color: Layer: Space: Page Label: [28] 28 C5.16

Signage?





Subject: Highlight Page Index: 29 Date: 8/6/2019 11:15:11 AM Author: dsdrice Color: Laver: Space: Page Label: [29] 29 C5.17

6903?



Subject: Page Index: 29 Date: 8/6/2019 11:15:59 AM Author: dsdrice Color: Layer: Space: Page Label: [29] 29 C5.17



_____ Subject: Callout Page Index: 29 Date: 8/6/2019 11:17:11 AM Author: dsdrice Color: 📘 Layer: Space: Page Label: [29] 29 C5.17

Complete the grading. Does culvert need to be extended?

..... Subject: Callout Page Index: 29 Date: 8/6/2019 11:20:26 AM Author: dsdrice Color: Layer: Space: Page Label: [29] 29 C5.17

.

Label EOP and shoulder



Subject: Page Index: 29 Date: 8/6/2019 11:31:06 AM Author: dsdrice Color: Layer: Space: Page Label: [29] 29 C5.17

Show w	nor ine
	5 mm

Page Label: [29] 29 C5.17

Subject: Callout Show water line Page Index: 29 Date: 8/6/2019 11:31:31 AM Author: dsdrice Color: Layer: Space: Page Label: [29] 29 C5.17 -----Subject: Text Box Profile disappeared Page Index: 29 Date: 8/8/2019 12:04:24 PM Author: dsdrice Color: Layer: Space: Page Label: [29] 29 C5.17 Subject: Callout label offset Page Index: 29 Date: 8/8/2019 12:09:57 PM Author: dsdrice Color: 📘 Layer: Space: Page Label: [29] 29 C5.17 Subject: Line Page Index: 29 Date: 8/8/2019 12:10:16 PM Author: dsdrice Color: Layer: Space: Page Label: [29] 29 C5.17 Subject: Line Page Index: 29 Date: 8/8/2019 12:11:29 PM Author: dsdrice Color: Laver: Space: Page Label: [29] 29 C5.17 -----Subject: Callout Show easements... Page Index: 29 Date: 8/8/2019 12:13:15 PM Author: dsdrice Color: Layer: Space:

	Subject: Callout Page Index: 29 Date: 8/8/2019 12:13:54 PM Author: dsdrice Color: Layer: Space: Page Label: [29] 29 C5.17	replaced or relocated? (until signal is activated)
(80' PUBL	Subject: Callout Page Index: 29 Date: 8/8/2019 12:15:06 PM Author: dsdrice Color: Layer: Space: Page Label: [29] 29 C5.17	label, show grading
30 (2)		
(This sheat not checked in data) yet.)	Subject: Text Box Page Index: 30 Date: 8/8/2019 12:17:44 PM Author: dsdrice Color: Layer: Space: Page Label: [30] 30 C6.10	(This sheet not checked in detail yet.)
Too mary signal heads?	Subject: Text Box Page Index: 30 Date: 8/8/2019 12:18:39 PM Author: dsdrice Color: Layer: Space: Page Label: [30] 30 C6.10	Too many signal heads?
31 (2)		
(This sheer nor chacked in detail yer.)	Subject: Text Box Page Index: 31 Date: 8/8/2019 12:22:01 PM Author: dsdrice Color: Layer: Space: Page Label: [31] 31 C6.11	(This sheet not checked in detail yet.)
label as future C&G	Subject: Callout Page Index: 31 Date: 8/8/2019 12:22:27 PM Author: dsdrice Color: Layer: Space: Page Label: [31] 31 C6.11	label as future C&G

32 (3)

107 J Figure and a the second the	Subject: Callout Page Index: 32 Date: 8/8/2019 12:24:59 PM Author: dsdrice Color: Layer: Space: Page Label: [32] 32 C7.10	HGL outside of pipe does not meet criteria.
	Subject: Cloud+ Page Index: 32 Date: 8/8/2019 12:25:17 PM Author: dsdrice Color: Layer: Space: Page Label: [32] 32 C7.10	HGLs close to surface do not appear to meet criteria.
(This shear not chucked in datal yer.)	Subject: Text Box Page Index: 32 Date: 8/8/2019 12:25:46 PM Author: dsdrice Color: Layer: Space: Page Label: [32] 32 C7.10	(This sheet not checked in detail yet.)
33 (2)		
	Subject: Callout Page Index: 33 Date: 8/8/2019 1:39:52 PM Author: dsdrice Color: Layer: Space: Page Label: [33] 33 C7.11	HGL outside of pipe does not meet criteria. Upsize the pipes, provide watertight joints, or provide a deviation request (discuss with Staff). If the POA is going to maintain pipes within the ROW a license agreement will be required.
(This sheet not checked in detail yet.)	Subject: Text Box Page Index: 33 Date: 8/8/2019 12:26:13 PM Author: dsdrice Color: Layer: Space: Page Label: [33] 33 C7.11	(This sheet not checked in detail yet.)
34 (2)		
This pipe should be public	Subject: Text Box Page Index: 34 Date: 8/8/2019 1:41:09 PM Author: dsdrice Color: Layer: Space: Page Label: [34] 34 C7.12	This pipe should be public

Subject: Page Index: 34 Date: 8/9/2019 1:51:43 PM Author: dsdrice Color: Layer: Space: Page Label: [34] 34 C7.12

35 (3)

TO BE

Subject: Callout Page Index: 35 Date: 8/8/2019 1:28:53 PM Author: dsdrice Color: Layer: Space: Page Label: [35] 35 C7.13

Show headwater/ponding depth.

adjust labels

Subject: Text Box Page Index: 35 Date: 8/8/2019 1:31:38 PM Author: dsdrice Color: Layer: Space: Page Label: [35] 35 C7.13

Subject: Callout

Page Index: 35

Author: dsdrice Color: Layer: Space:

Date: 8/8/2019 1:30:00 PM

Page Label: [35] 35 C7.13

Should #1 and #5 be public?

36 (1)

This pipe should be public

ORM SEWER TO BE PP 5 OTHERWISE NOTED

> Subject: Text Box Page Index: 36 Date: 8/8/2019 1:41:55 PM Author: dsdrice Color: Layer: Space: Page Label: [36] 36 C7.14

This pipe should be public

37 (2)



Subject: Callout Page Index: 37 Date: 8/8/2019 2:33:13 PM Author: dsdrice Color: Layer: Space: Page Label: [37] 37 C7.15

Show pipe...



Subject: Cloud+ Page Index: 37 Date: 8/8/2019 2:45:50 PM Author: dsdrice Color: Layer: Space: Page Label: [37] 37 C7.15

.....

Provide detail. This will be passing more than low flows, so it needs to be designed not to wash out.

Cross-sections, grades, erosion protection, etc.

If it's still the same as Sheet C7.1 in the overlot grading plans reference that.