# CROSSROADS MIXED USE FILING NO. 2

# GENERAL CONSTRUCTION NOTES:

- 1. IT SHALL BE THE RESPONSIBILITY OF THE CONTRACTOR TO VERIFY THE EXISTENCE AND LOCATION OF ALL UNDERGROUND UTILITIES ALONG THE ROUTE OF THE WORK. THE OMISSION FROM OR THE INCLUSION OF UTILITY LOCATIONS ON THE PLANS IS NOT TO BE CONSIDERED AS THE NONEXISTENCE OF OR A DEFINITE LOCATION OF EXISTING UNDERGROUND UTILITIES.
- 2. THE CONTRACTOR WILL TAKE THE NECESSARY PRECAUTIONS TO PROTECT EXISTING UTILITIES FROM DAMAGE DUE TO THIS OPERATION. ANY DAMAGE TO THE UTILITIES WILL BE REPAIRED AT THE CONTRACTOR'S EXPENSE, AND ANY SERVICE DISRUPTION WILL BE SETTLED BY THE CONTRACTOR.
- ADDITIONAL EROSION CONTROL STRUCTURES MAY BE REQUIRED AT THE TIME OF CONSTRUCTION.
- 4. ALL BACKFILL, SUB-BASE, AND/OR BASE COURSE (CLASS 6) MATERIAL SHALL BE COMPACTED PER THE SOILS ENGINEER'S RECOMMENDATIONS, AND APPROVED BY EL PASO COUNTY PCD.
- 5. ALL STATIONING IS CENTERLINE OF IMPROVEMENTS UNLESS OTHERWISE INDICATED. ALL ELEVATIONS ARE FLOW LINE UNLESS OTHERWISE INDICATED AS TOP BACK OF CURB (TBC), ASPHALT (ASP), OR TOP OF INLET OR BOX (TOB).
- 6. ALL DISTURBED PAVEMENT EDGES SHALL BE CUT TO NEAT LINES. REPAIR SHALL CONFORM TO EPC ECM APPENDIX K 1.2C.
- 7. ALL INTERSECTION ACCESSES TO BE CONSTRUCTED WITH A 25 FOOT SIGHT VISIBILITY TRIANGLES IS REQUIRED AND THERE SHALL BE NO OBSTRUCTIONS GREATER THAN 18" VERTICAL IN THIS AREA.
- 8. ALL CULVERTS AND STORM DRAIN PIPES SHALL BE SMOOTH INTERIOR CORRUGATED POLYETHYLENE PIPE (HDPE), REINFORCED CONCRETE PIPE (RCP). ALL CULVERTS SHALL BE PLACED COMPLETE WITH FLARED END SECTIONS. ADEQUACY OF MATERIAL THICKNESS FOR ANY CSP INSTALLED SHALL BE VERIFIED BY OWNER'S GEOTECHNICAL ENGINEER TO SUPPORT MINIMUM 50 YEAR DESIGN LIFE. CULVERTS MUST CONFORM TO EPC ECM SECTION 3.32 - CULVERTS.
- 9. ASPHALT THICKNESS AND BASE COURSE THICKNESS (COMPACTED) FOR ROADS SHALL BE PER DESIGN REPORT BY OWNER'S GEOTECHNICAL ENGINEER. OWNER'S GEOTECHNICAL ENGINEER TO BE ON SITE AT THE TIME OF ROAD CONSTRUCTION TO EVALUATE SOIL CONDITIONS AND DETERMINE IF ADDITIONAL MEASURES ARE NECESSARY TO ASSURE STABILITY OF THE NEW ROADS. PAVEMENT DESIGN SHALL BE APPROVED BY EL PASO COUNTY PCD PRIOR TO CONSTRUCTION.

# STANDARD NOTES FOR EL PASO COUNTY CONSTRUCTION PLANS

- 1. ALL DRAINAGE AND ROADWAY CONSTRUCTION SHALL MEET THE STANDARDS AND SPECIFICATIONS OF THE CITY OF COLORADO SPRINGS/EL PASO COUNTY DRAINAGE CRITERIA MANUAL, VOLUMES 1 AND 2, AND THE EL PASO COUNTY ENGINEERING CRITERIA MANUAL.
- 2. CONTRACTOR SHALL BE RESPONSIBLE FOR THE NOTIFICATION AND FIELD NOTIFICATION OF ALL EXISTING UTILITIES, WHETHER SHOWN ON THE PLANS OR NOT, BEFORE BEGINNING CONSTRUCTION. LOCATION OF EXISTING UTILITIES SHALL BE VERIFIED BY THE CONTRACTOR PRIOR TO CONSTRUCTION. CALL 811 TO CONTACT THE UTILITY NOTIFICATION CENTER OF COLORADO (UNCC).
- 3. CONTRACTOR SHALL KEEP A COPY OF THESE APPROVED PLANS, THE GRADING AND EROSION CONTROL PLAN, THE STORMWATER MANAGEMENT PLAN (SWMP), THE SOILS AND GEOTECHNICAL REPORT, AND THE APPROPRIATE DESIGN AND CONSTRUCTION STANDARDS AND SPECIFICATIONS AT THE JOB SITE AT ALL TIMES, INCLUDING THE FOLLOWING:
  - a. EL PASO COUNTY ENGINEERING CRITERIA MANUAL (ECM)
  - b. CITY OF COLORADO SPRINGS/EL PASO COUNTY DRAINAGE CRITERIA MANUAL, VOLUMES 1 AND 2 c. COLORADO DEPARTMENT OF TRANSPORTATION (CDOT) STANDARD SPECIFICATIONS FOR ROAD AND BRIDGE CONSTRUCTION
  - d. CDOT M & S STANDARDS.
- 4. NOTWITHSTANDING ANYTHING DEPICTED IN THESE PLANS IN WORDS OR GRAPHIC REPRESENTATION, ALL DESIGN AND CONSTRUCTION RELATED TO ROADS, STORM DRAINAGE AND EROSION CONTROL SHALL CONFORM TO THE STANDARDS AND REQUIREMENTS OF THE MOST RECENT VERSION OF THE RELEVANT ADOPTED EL PASO COUNTY STANDARDS, INCLUDING THE LAND DEVELOPMENT CODE, THE ENGINEERING CRITERIA MANUAL, THE DRAINAGE CRITERIA MANUAL, AND THE DRAINAGE CRITERIA MANUAL VOLUME 2. ANY DEVIATIONS FROM REGULATIONS AND STANDARDS MUST BE REQUESTED, AND APPROVED, IN WRITING. ANY MODIFICATIONS NECESSARY TO MEET CRITERIA AFTER-THE-FACT WILL BE ENTIRELY THE DEVELOPER'S RESPONSIBILITY TO RECTIFY.
- 5. IT IS THE DESIGN ENGINEER'S RESPONSIBILITY TO ACCURATELY SHOW EXISTING CONDITIONS, BOTH ON-SITE AND OFF-SITE, ON THE CONSTRUCTION PLANS. ANY MODIFICATIONS NECESSARY DUE TO CONFLICTS, OMISSIONS, OR CHANGED CONDITIONS WILL BE ENTIRELY THE DEVELOPER'S RESPONSIBILITY TO RECTIFY.
- 6. CONTRACTOR SHALL SCHEDULE A PRE-CONSTRUCTION MEETING WITH EL PASO COUNTY PLANNING AND COMMUNITY DEVELOPMENT DEPARTMENT INSPECTIONS, PRIOR TO STARTING CONSTRUCTION.
- 7. IT IS THE CONTRACTOR'S RESPONSIBILITY TO UNDERSTAND THE REQUIREMENTS OF ALL JURISDICTIONAL AGENCIES AND TO OBTAIN ALL REQUIRED PERMITS, INCLUDING BUT NOT LIMITED TO EL PASO COUNTY EROSION AND STORMWATER QUALITY CONTROL PERMIT (ESQCP), REGIONAL BUILDING FLOODPLAIN DEVELOPMENT PERMIT. U.S. ARMY CORPS OF ENGINEERS-ISSUED 401 AND/OR 404 PERMITS. AND COUNTY AND STATE FUGITIVE DUST PERMITS.
- 8. CONTRACTOR SHALL NOT DEVIATE FROM THE PLANS WITHOUT FIRST OBTAINING WRITTEN APPROVAL FROM THE DESIGN ENGINEER AND PCD. CONTRACTOR SHALL NOTIFY THE DESIGN ENGINEER IMMEDIATELY UPON DISCOVERY OF ANY ERRORS OR INCONSISTENCIES.
- 9. ALL STORM DRAIN PIPE SHALL BE CLASS III RCP UNLESS OTHERWISE NOTED AND APPROVED BY PCD.
- 10. CONTRACTOR SHALL COORDINATE GEOTECHNICAL TESTING PER ECM STANDARDS. PAVEMENT DESIGN SHALL BE APPROVED BY EL PASO COUNTY PCD PRIOR TO PLACEMENT OF CURB AND GUTTER AND PAVEMENT.
- 11. ALL CONSTRUCTION TRAFFIC MUST ENTER/EXIT THE SITE AT APPROVED CONSTRUCTION ACCESS POINTS.
- 12. SIGHT VISIBILITY TRIANGLES AS IDENTIFIED IN THE PLANS SHALL BE PROVIDED AT ALL INTERSECTIONS. OBSTRUCTIONS GREATER THAN 18 INCHES ABOVE FLOWLINE ARE NOT ALLOWED WITHIN SIGHT TRIANGLES.
- 13. SIGNING AND STRIPING SHALL COMPLY WITH EL PASO COUNTY DEPARTMENT OF PUBLIC WORKS AND MUTCD CRITERIA.
- 14. CONTRACTOR SHALL OBTAIN ANY PERMITS REQUIRED BY EL PASO COUNTY DEPARTMENT OF PUBLIC WORKS, INCLUDING WORK WITHIN THE RIGHT-OF-WAY AND SPECIAL TRANSPORT PERMITS.
- 15. THE LIMITS OF CONSTRUCTION SHALL REMAIN WITHIN THE PROPERTY LINE UNLESS NOTED. THE OWNER/DEVELOPER SHALL OBTAIN WRITTEN PERMISSION AND EASEMENTS. WHERE REQUIRED, FROM ADJOINING PROPERTY OWNER(S) PRIOR TO ANY OFF-SITE DISTURBANCE, GRADING, OR CONSTRUCTION.

# BASIS OF BEARINGS

THE EAST LINE OF TRACT C "CROSSROADS MIXED USE FILING NO. 2" RECORDED UNDER RECEPTION NO 22714975 IN THE RECORDS OF EL PASO COUNTY, COLORADO, BEING MONUMENTED AT EACH END WITH A SET NO. 5 REBAR WITH AN ORANGE PLASTIC CAP STAMPED "M&S CIVIL PLS 25966", WHICH BEARS N007'07'04"E A DISTANCE OF 871.79

# **BENCHMARK:**

FEET.

- 1. NATIONAL GEODETIC VERTICAL DATUM OF 1929, MONUMENT R76 SET IN TOP OF CONCRETE MONUMENT ELEVATION = 6286.32'
- 2. NATIONAL GEODETIC VERTICAL DATUM OF 1929, FOUND #5 REBAR AND ORANGE CAP PLS 32820 ELEVATION = 6325.50'


# <u>SHEET INDEX</u>

SHEET	1	TITLE	SHEET

- SHEET 2 DETAILS SHEET 3 STREET IMPROVEMENT PLANS
- SHEET 4 SIGNAGE & STRIPING PLAN
- SHEET 5 PED & BIKE RAMP DETAILS
- SHEET 6 STORM SEWER PLAN AND PROFILES
- SHEET 7 STORM SEWER DETAILS SHEET 8 STORM SEWER DETAILS
- SHEET 9 PERMANENT BMP DETAILS

- S-627-1.

COUNTY OF EL PASO, STATE OF COLORADO **CONSTRUCTION PLANS** 

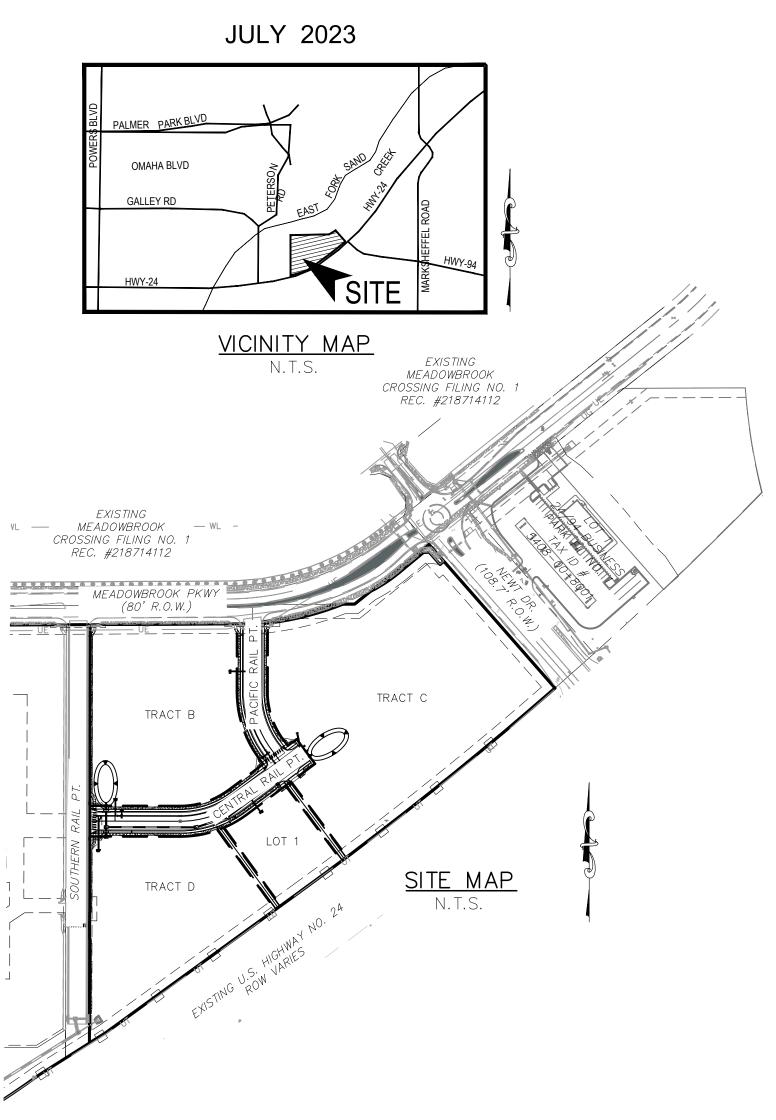

# SIGNAGE AND STRIPING NOTES:

1. ALL SIGNS AND PAVEMENT MARKINGS SHALL BE IN COMPLIANCE WITH THE CURRENT MANUAL ON UNIFORM TRAFFIC CONTROL DEVICES (MUTCD).

2. REMOVAL OF EXISTING PAVEMENT MARKINGS SHALL BE ACCOMPLISHED BY A METHOD THAT DOES NOT MATERIALLY DAMAGE THE PAVEMENT. THE PAVEMENT MARKINGS SHALL BE REMOVED TO THE EXTENT THAT THEY WILL NOT BE VISIBLE UNDER DAY OR NIGHT CONDITIONS. AT NO TIME WILL IT BE ACCEPTABLE TO PAINT OVER EXISTING PAVEMENT MARKINGS.

3. ANY DEVIATION FROM THE STRIPING AND SIGNING PLAN SHALL BE APPROVED BY EL PASO COUNTY PLANNING AND COMMUNITY DEVELOPMENT.

4. ALL SIGNS SHOWN ON THE SIGNING AND STRIPING PLAN SHALL BE NEW SIGNS. EXISTING SIGNS MAY REMAIN OR BE REUSED IF THEY MEET CURRENT EL PASO COUNTY AND MUTCD STANDARDS.

5. STREET NAME AND REGULATORY STOP SIGNS SHALL BE ON THE SAME POST AT INTERSECTIONS.

6. ALL REMOVED SIGNS SHALL BE DISPOSED OF IN A PROPER MANNER BY THE CONTRACTOR.

7. ALL STREET NAME SIGNS SHALL HAVE "D" SERIES LETTERS, WITH LOCAL ROADWAY SIGNS BEING 4" UPPER-LOWER CASE LETTERING ON 8" BLANK AND NON-LOCAL ROADWAY SIGNS BEING 6" LETTERING, UPPER-LOWER CASE ON 12" BLANK, WITH A WHITE BORDER THAT IS NOT RECESSED. MULTI-LANE ROADWAYS WITH SPEED LIMITS OF 40 MPH OR HIGHER SHALL HAVE 8" UPPER-LOWER CASE LETTERING ON 18" BLANK WITH A WHITE BORDER THAT IS NOT RECESSED. THE WIDTH OF THE NON-RECESSED WHITE BORDERS SHALL MATCH PAGE 255 OF THE 2012 MUTCD "STANDARD HIGHWAY SIGNS"

8. ALL TRAFFIC SIGNS SHALL HAVE A MINIMUM HIGH INTENSITY PRISMATIC GRADE SHEETING.

9. ALL LOCAL RESIDENTIAL STREET SIGNS SHALL BE MOUNTED ON A 1.75" X 1.75" SQUARE TUBE SIGN POST AND STUB POST BASE. FOR OTHER APPLICATIONS, REFER TO THE CDOT STANDARD S-614-8 REGARDING USE OF THE P2 TUBULAR STEEL POST SLIPBASE DESIGN.

10. ALL SIGNS SHALL BE SINGLE SHEET ALUMINUM WITH 0.100" MINIMUM THICKNESS.

11. ALL LIMIT LINES/STOP LINES, CROSSWALK LINES, PAVEMENT LEGENDS, AND ARROWS SHALL BE A MINIMUM 125 MIL THICKNESS PREFORMED THERMOPLASTIC PAVEMENT MARKINGS WITH TAPERED LEADING EDGES PER CDOT STANDARD S-627-1. WORD AND SYMBOL MARKINGS SHALL BE THE NARROW TYPE. STOP BARS SHALL BE 24" IN WIDTH. CROSSWALKS LINES SHALL BE 12" WIDE AND 8' LONG PER CDOT S-627-1.

12. ALL LONGITUDINAL LINES SHALL BE A MINIMUM 15MIL THICKNESS EPOXY PAINT. ALL NON-LOCAL RESIDENTIAL ROADWAYS SHALL INCLUDE BOTH RIGHT AND LEFT EDGE LINE STRIPING AND ANY ADDITIONAL STRIPING AS REQUIRED BY CDOT

13. THE CONTRACTOR SHALL NOTIFY EL PASO COUNTY PLANNING AND COMMUNITY DEVELOPMENT (719) 520-6819 PRIOR TO AND UPON COMPLETION OF SIGNING AND STRIPING.

14. THE CONTRACTOR SHALL OBTAIN A WORK IN THE RIGHT OF WAY PERMIT FROM THE EL PASO COUNTY DEPARTMENT OF PUBLIC WORKS (DPW) PRIOR TO ANY SIGNAGE OR STRIPING WORK WITHIN AN EXISTING EL PASO COUNTY ROADWAY.

AGENCIES:		N0.2			SI01
OWNER/DEVELOPER:	CROSSROADS DEVELOPMENT COMPANY, LLC 90 S. CASCADE AVE., SUITE 1500 COLORADO SPRINGS, CO 80903 DANNY MIENTKA (719) 448–4034	FILING		/26/2023	0F 9
CIVIL ENGINEER:	M & S CIVIL CONSULTANTS, INC. 212 N. WAHSATCH, SUITE 305 COLORADO SPRINGS, CO 80903 VIRGIL A. SANCHEZ P.E. (719) 955–5485	USE F	SHEET	DATE: 07/2	SHEET 1 (
COUNTY ENGINEERING:	EL PASO COUNTY PLANNING AND COMMUNITY DEVELOPMENT 2880 INTERNATIONAL CIRCLE, SUITE 110 COLORADO SPRINGS, CO 80910 GILBERT LAFORCE, P.E. (719) 520–6300	MIXED (	LE SH		 ;
TRAFFIC ENGINEERING:	EL PASO COUNTY DEPARTMENT OF PUBLIC WORKS 3275 AKERS DRIVE COLORADO SPRINGS, CO 80922 JENNIFER IRVINE, P.E. (719) 520–6460		CROSSROADS M TIT	SCALE:	1"=200" VERTICAL 1"=5'
WATER RESOURCES:	CHEROKEE METROPOLITAN DISTRICT 6250 PALMER PARK BOULEVARD COLORADO SPRINGS, CO 80915–1721 JEFF MUNGER (719) 597–5080	SSR0/		18–	<ul><li>TAU</li><li>TAU</li><li>VAS</li></ul>
FIRE DISTRICT:	CIMARRON HILLS FIRE DEPARTMENT 1835 TUSKEGEE PLACE COLORADO SPRINGS, CO 80915 (719) 591–0960	CRO		ROJECT NO.	DESIGNED BY: DRAWN BY: CHECKED BY:
GAS DEPARTMENT:	COLORADO SPRINGS UTILITIES 7710 DURANT DR. COLORADO SPRINGS, CO 80947 TIM WENDT (719) 668–3556	= 305	80903	4 L	DF CF
ELECTRIC DEPARTMENT:	COLORADO SPRINGS UTILITIES 7710 DURANT DR. COLORADO SPRINGS, CO 80947 TIM WENDT (719) 668–3556	TCH AVE., STI	COLORADO SPRINGS, CO 80903 PHONE: 719.955.5485		
COMMUNICATIONS:	QWEST COMMUNICATIONS (U.N.C.C. LOCATORS) (800) 922–1987 AT&T (LOCATORS) (719) 635–3674	2 N. WAHSA	OLORADO SF HONE: 719.95		
SAID PLANS AND SPECIFICATIONS HAVE BE THE COUNTY FOR DETAILED ROADWAY, DRA SPECIFICATIONS, AND SAID PLANS AND SP DRAINAGE PLANS AND MASTER TRANSPOR PURPOSES FOR WHICH THE PARTICULAR R CORRECT TO THE BEST OF MY KNOWLEDGE	EMENT: NS WERE PREPARED UNDER MY DIRECTION AND SUPERVISION. EXAMPLE ACCORDING TO THE CRITERIA ESTABLISHED BY AINAGE, GRADING AND EROSION CONTROL PLANS AND ECIFICATIONS ARE IN CONFORMITY WITH APPLICABLE MASTER TATION PLANS. SAID PLANS AND SPECIFICATIONS MEET THE OADWAY AND DRAINAGE FACILITIES ARE DESIGNED AND ARE E AND BELIEF. I ACCEPT RESPONSIBILITY FOR ANY LIABILITY S OR OMISSIONS ON MY PART IN PREPARATION OF THESE MOT-31-2023				CIVIL CONSULTANTS, INC.
VIRGIL A. SANCHEZ, COLORADO P.E. #37160 FOR AND ON BEHALF OF M & S CIVIL CON OWNER/DEVELOPER'S STA	D DATE ISULTANTS, INC.	160	FOR AND ON BEHALF OF	M&S CIVIL CONSULTANTS, INC.	
		RADO P.E. NO. 37	I I I	D	UNING AND

07-31-2023 DATE

EL PASO COUNTY:

CROSSROADS DEVELOPMENT COMPANY, LLC

DANNY MIENTKA (MANAGER)

COUNTY PLAN REVIEW IS PROVIDED ONLY FOR GENERAL CONFORMANCE WITH COUNTY DESIGN CRITERIA. THE COUNTY IS NOT RESPONSIBLE FOR THE ACCURACY AND ADEQUACY OF THE DESIGN, DIMENSIONS, AND/OR ELEVATIONS WHICH SHALL BE CONFIRMED AT THE JOB SITE. THE COUNTY THROUGH THE APPROVAL OF THIS DOCUMENT ASSUMES NO RESPONSIBILITY FOR COMPLETENESS AND/OR ACCURACY OF THIS DOCUMENT.


FILED IN ACCORDANCE WITH THE REQUIREMENTS OF THE EL PASO COUNTY LAND DEVELOPMENT CODE, DRAINAGE CRITERIA MANUAL, VOLUMES 1 AND 2, AND ENGINEERING CRITERIA MANUAL AS AMENDED.

IN ACCORDANCE WITH ECM SECTION 1.12, THESE CONSTRUCTION DOCUMENTS WILL BE VALID FOR CONSTRUCTION FOR A PERIOD OF 2 YEARS FROM THE DATE SIGNED BY THE EL PASO COUNTY ENGINEER. IF CONSTRUCTION HAS NOT STARTED WITHIN THOSE 2 YEARS, THE PLANS WILL NEED TO BE RESUBMITTED FOR APPROVAL, INCLUDING PAYMENT OF REVIEW FEES AT THE PLANNING AND COMMUNITY DEVELOPMENT DIRECTORS DISCRETION.


JOSHUA PALMER, P.E. COUNTY ENGINEER/ECM ADMINISTRATOR

DATE


# EL PASO COUNTY FILE NO. SF2238

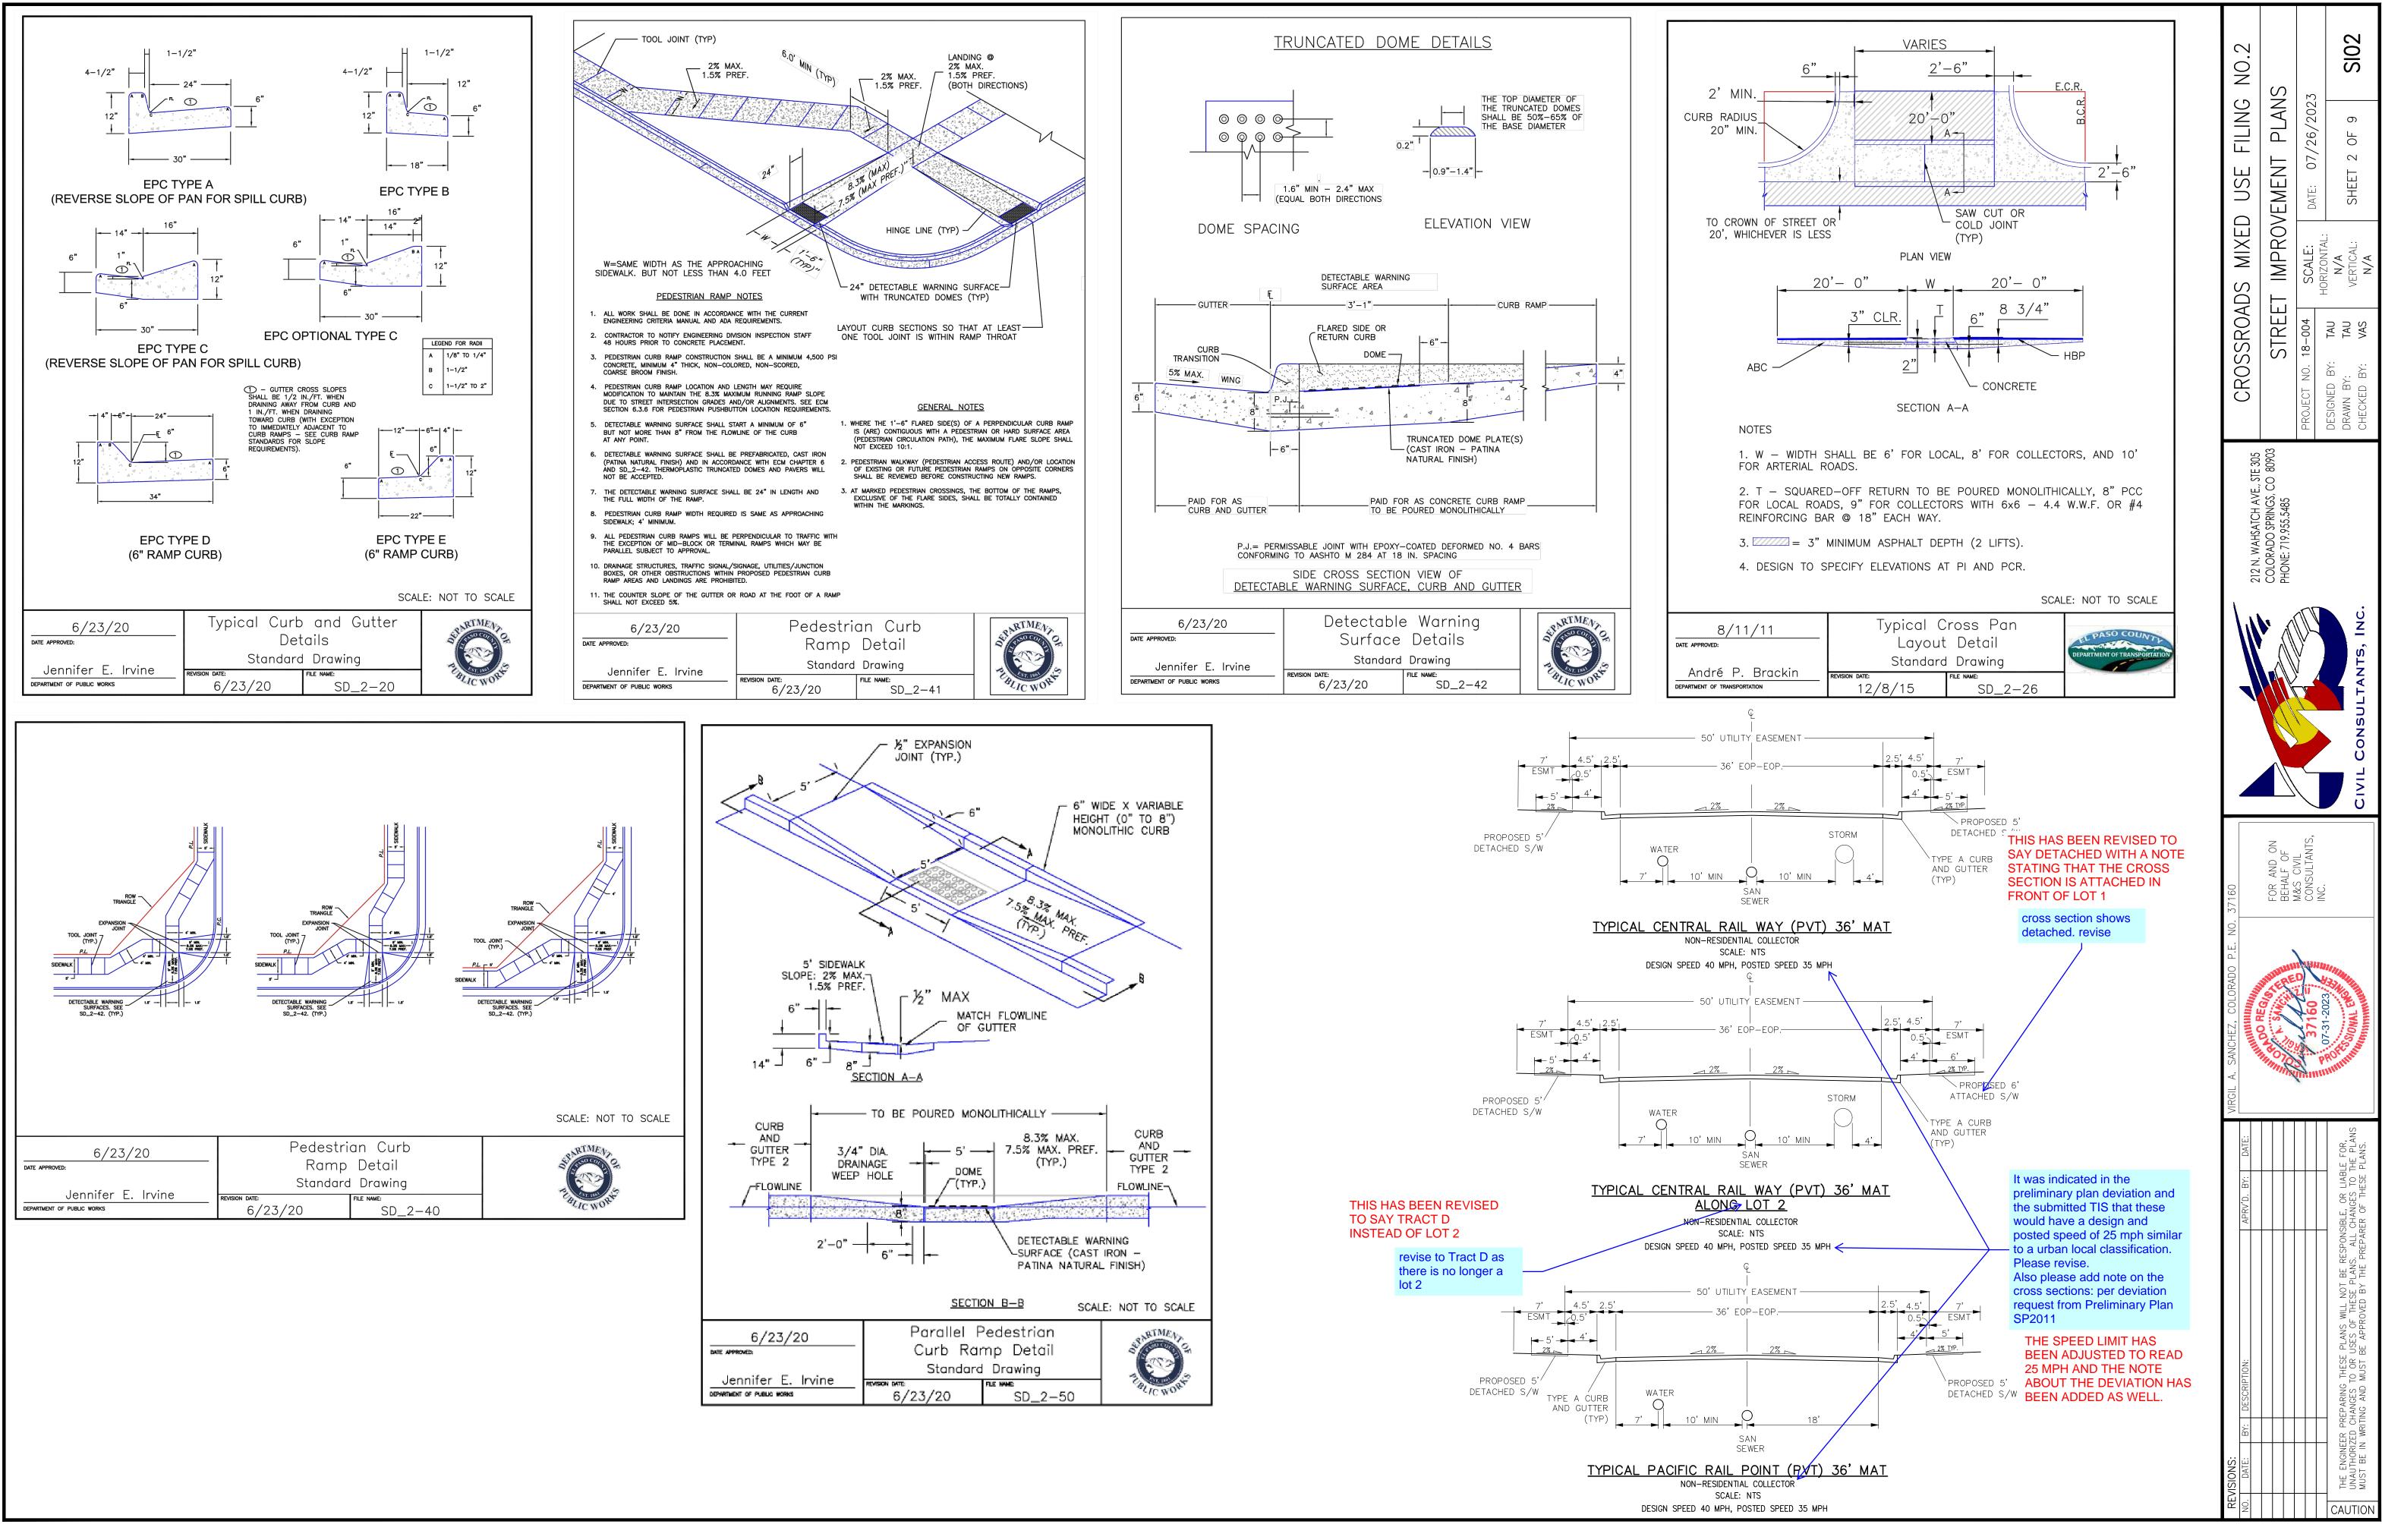

/11	Typical Cross Pan Layout Detail Standard Drawing		DEPARTMENT OF TRANSPORTATION
Brackin	REVISION DATE:	FILE NAME:	
TION	12/8/15	SD_2-26	

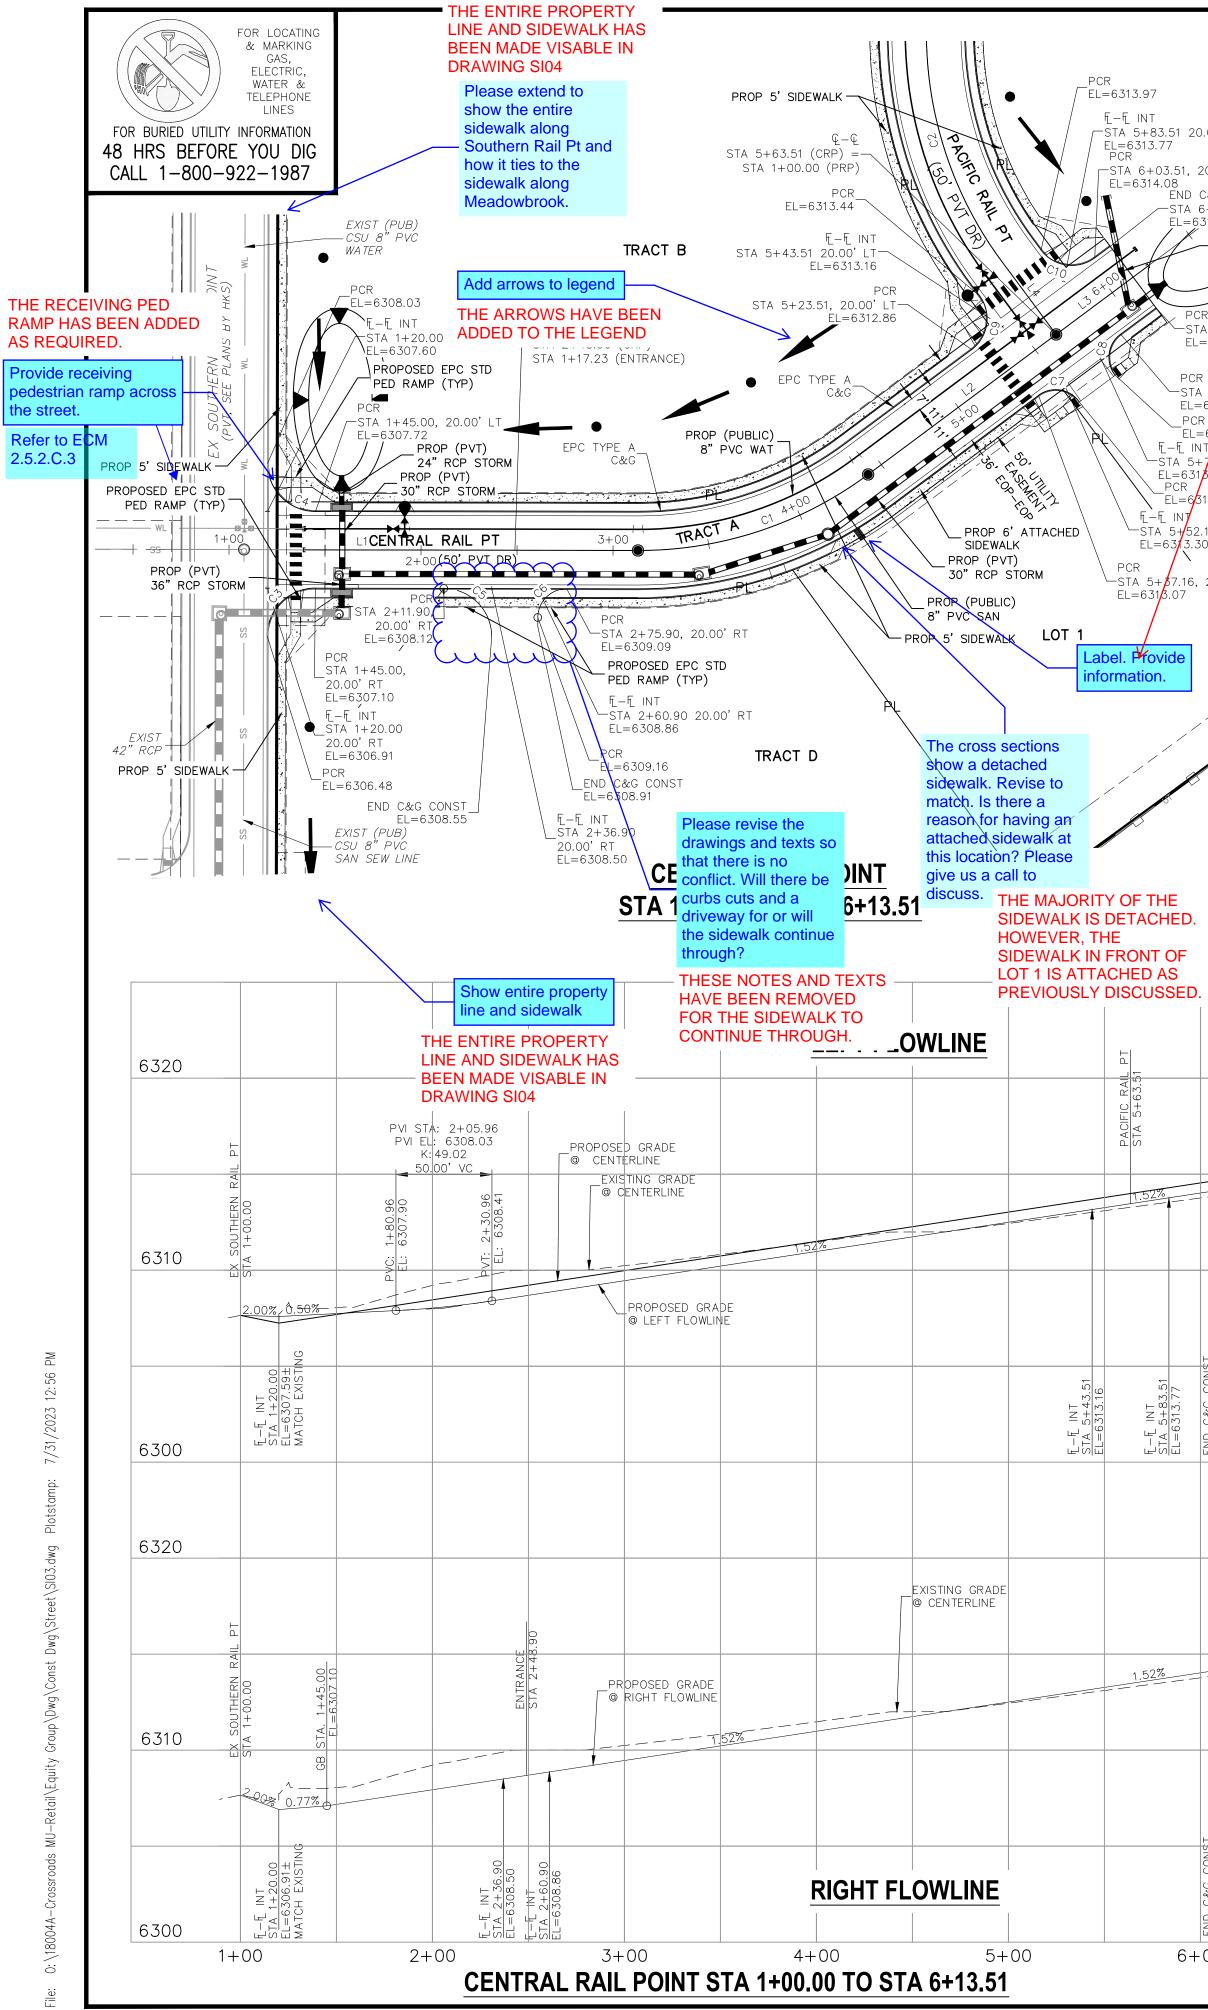

CHASE"	BEL "SIDEW HAS BEEN DRAWING		EPC TYPE A C&G PROP 5' SIDEWALK	TRACT B	F EL=6313 Ē-Ē INT STA 4+32.44 20.00' LT	
20.00' LT C&G CONST. 6+13.51, 20.00 314.23 			PCR EL=6312.86 PROPOSED EPC PED RAMP (TYP EE_INT STA 1+20.00 2 EL=6313.16 PCR STA 1+40.0	20.00' LT STA 2+75.26,	EL=6314.18 <i>EX (PUB)</i> <i>CHEROKEE METRO DISTRICT 8" PVC</i> <i>WATER LINE</i> <i>EX EPC STD PED</i>	
CR A 6+13.51, 20. =6314.25 R A 5+90.53, 20. =6313.88 R	<ul> <li>sidew match</li> <li>THE MA</li> <li>SIDEWA</li> <li>SIDEWA</li> <li>SIDEWA</li> <li>LOT 1 IS</li> </ul>	JORITY OF THE ALK IS DETACHED. VER, THE ALK IN FRONT OF S ATTACHED AS	R         STA 1+4           20.00' L'         EL=6313           P         F           D         F           D         F           D         F	EL=6314.79 6.83, T PROP (PUBLIC) 51 8" PVC WAT DEMONSTRATE PT C2 E	RAMP (TYP) PCR STA 4+05.50, 20.00' LT EL=6314.64 PROP 5' SIDEWALK	
=6314.15 NT +75.54 20.00' F 15.65 313.27 2.15 20.00' RT 30		USLY DISCUSSED.       313.07         IL-E       INT         STA       5+52.15       20.00' RT         EL=6313.30       PCR         EL=6313.27       Q-Q         STA       1+00.00 (PRP) =         STA       5+63.51 (CRP)		RAIL PT c2       PT         2+00       TRACT A         0       TRACT A         3+0         PT         STA 2+75.26, 20.00' RT         EL=6315.25         PC         STA 1+46.83, 20.00' RT         EL=6314.03         PCR	(50' PVT DR)	
20.00' RT		PCR EL=6314.15 FL-FL IN STA 5+75.54 20.00' F EL=6313.6 STA 5+90.53, 20.00 EL=631 PROP (PUBL	RT	STA 1+40.00, 20.00' RT EL=6313.97 EE_INT STA 1+20.00 20.00' RT EL=6313.77 PCR STA 1+20.00, 40.00' RT EL=6314.08 EX	EL=6314.89 FF_ INT STA 4+37.30 20.00' RT EL=6314.50 PCR STA 4+40.01, 41.60' RT EL=6314.68 (ISTING (PUB) CHEROKEE METRO DISTRICT 8" PVC	SS UL SS
		30" RCP ST MATCHLINES HAVE BEEN PROVIDED ON ALL OF THE DRAWINGS. Provide matchlines on all drawings.	ORM	THE LABEL "PROP TEN THE LABEL "PROP TEN TSB" HAS BEEN ADDE TO THE DRAWING	SANITARY LINE C MP D	
		Show and label running slope and cross slope on sidewalks. SIDEWALK SLOPES WILL MATCH THE STREET SLOPES (PROVIDED BELOW)			IC RAIL POINT 00 TO STA 4+58	<u>.87</u>
	6320	ÀND CROSS SECTIÓN SLOPES (PN SI02) 6320	CENTRAL RAIL WY STA 1+00.00 8 STA. 1+40.00 EL=6313.44	_EXISTING GRADE @ CENTERLINE PROPOSED GRADE \[ @ CENTERLINE	HP EL:=6315.42 HP STA: 3+46.70 PVI STA: 3+53.97 PVI EL:=6315.58 K=17.86 50.27' VC 48.95 80.95 00.27' VC 10.07 1	
	6310	6310	2.00% 1.37%	PROPOSED GRADE @ LEFT FLOWLINE		
END C&G CONST. STA 6+13.51 EL=6314.23	6300	6300	ЕL=6313.16 EL=6313.16	LEFT FL	OWLINE	Е-Е INT STA 4+32,444 EL=6314.18
	6320	6320	CENTRAL RAIL WY STA 1+73.46 STA. 1+20.00 EL=6313.77	EXISTING GRADE	HP EL:=6315.83 HP STA: 3+45.95 PVI STA: 3+53.97 PVI EL:=6315.99 K=18.74 51.41' VC K K K K K K K K K K K K K K K K K K K	EL=6315.06 EL=6315.06 B STA. 4+37.31 EL=6314.50
	6310	6310	2.00% 1.00%			-1.80% -1.76%
END C&G CONST. STA 6+13.51 EL=6314.23	6300	6300	E-E INT STA 1+20.00 EL=6313.77			EL=6314.50
-00			1+00 <b>P</b>	2+00 3- ACIFIC RAIL POINT ST	+00 <b>A 1+00.00 TO ST</b>	4+00 <b>A 4+58.87</b>

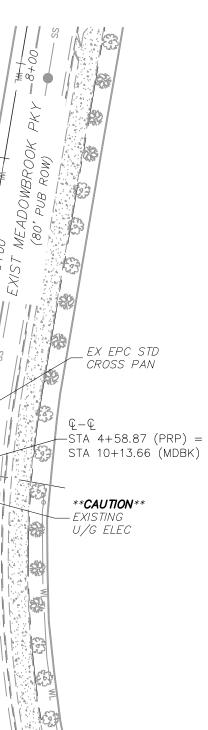


	<u>ABBR</u>
CLCENTERLINELTLEFTRTRIGHTC&GCURB AND GUTTERELELEVATIONWWESTCONSTCONSTRUCTIONNNORTHWTRWATERSSOUTHSTMSTORM SEWERPUBPUBLICEXEXISTINGSTASTATIONNTSNOT TO SCALEPROPPROPOSEDSANSANITARY SEWERCMDCHEROKEE METROPOLITAN DISTRICTCDSCUL DE SACPLPROPERTY LINE	RT C&G EL W CONST N WTR S STM PUB EX STA NTS PROP SAN CMD CDS

NOTES:

THE CONTRACTOR SHALL FIELD VERIFY THE ELEVATION OF ALL EXISTING UTILITIES PRIOR TO COMMENCEMENT OF CONSTRUCTION. ANY DISCREPANCIES FROM THE SHOWN UTILITIES SHALL BE COORDINATED TO THE ENGINEER.


CONTRACTOR SHALL ADJUST ALL EXISTING VALVE COVERS, SANITARY AND STORM SEWER MANHOLE RIMS, ELECTRIC VAULTS THAT LAY WITHIN THE PROPOSED PAVEMENT, CONCRETE CURB AND SIDEWALKS. ANY CONFLICTS SHALL BE COORDINATED WITH THE ENGINEER.

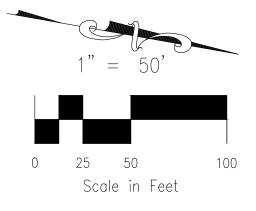


CENTERLINE CURVE TABLE				
CURVE	LENGTH	RADIUS	DELTA	
C1	128.44	199.77	36.84	
C2	128.43	200.00	36.79	


PARCEL LINE TABLE				
LINE	LENGTH	DIRECTION		
L1	212.95	S89°51'36.69"E		
L2	122.08	N53°19'30.67"E		
L3	50.00	N53°19'30.67"E		
L4	46.83	N36°40'29.33"W		
L5	130.24	NO° 07' 03.14"E		

D			F		
PCR CURVE TABLE					
CURVE	LENGTH	RADIUS	DELTA		
C3	39.27	25.00	90.00		
C4	39.27	25.00	90.00		
C5	39.29	24.95	90.24		
C6	23.56	15.00	89.99		
C7	23.97	15.00	91.58		
C8	23.97	15.00	91.55		
C9	31.42	20.00	90.00		
C10	31.42	20.00	90.00		

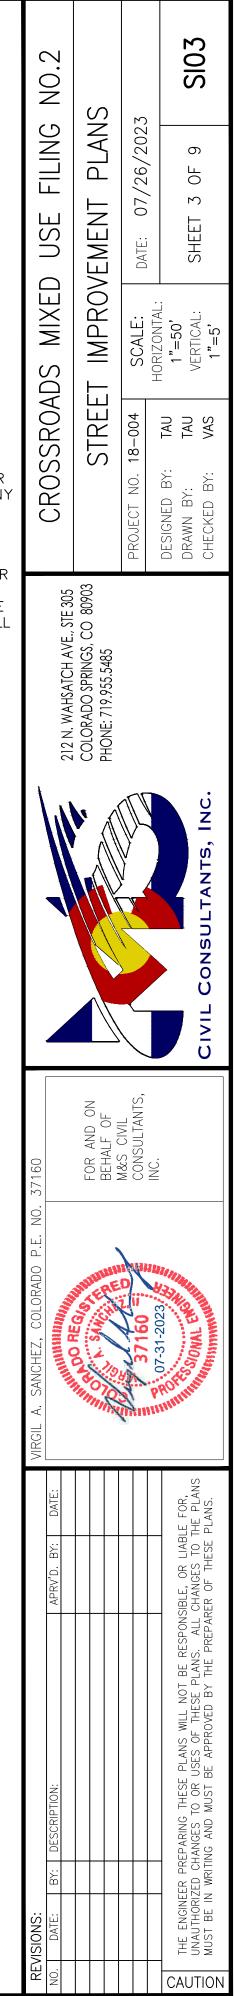


6320	
6310	
6300	
6320	
6310	
6300	

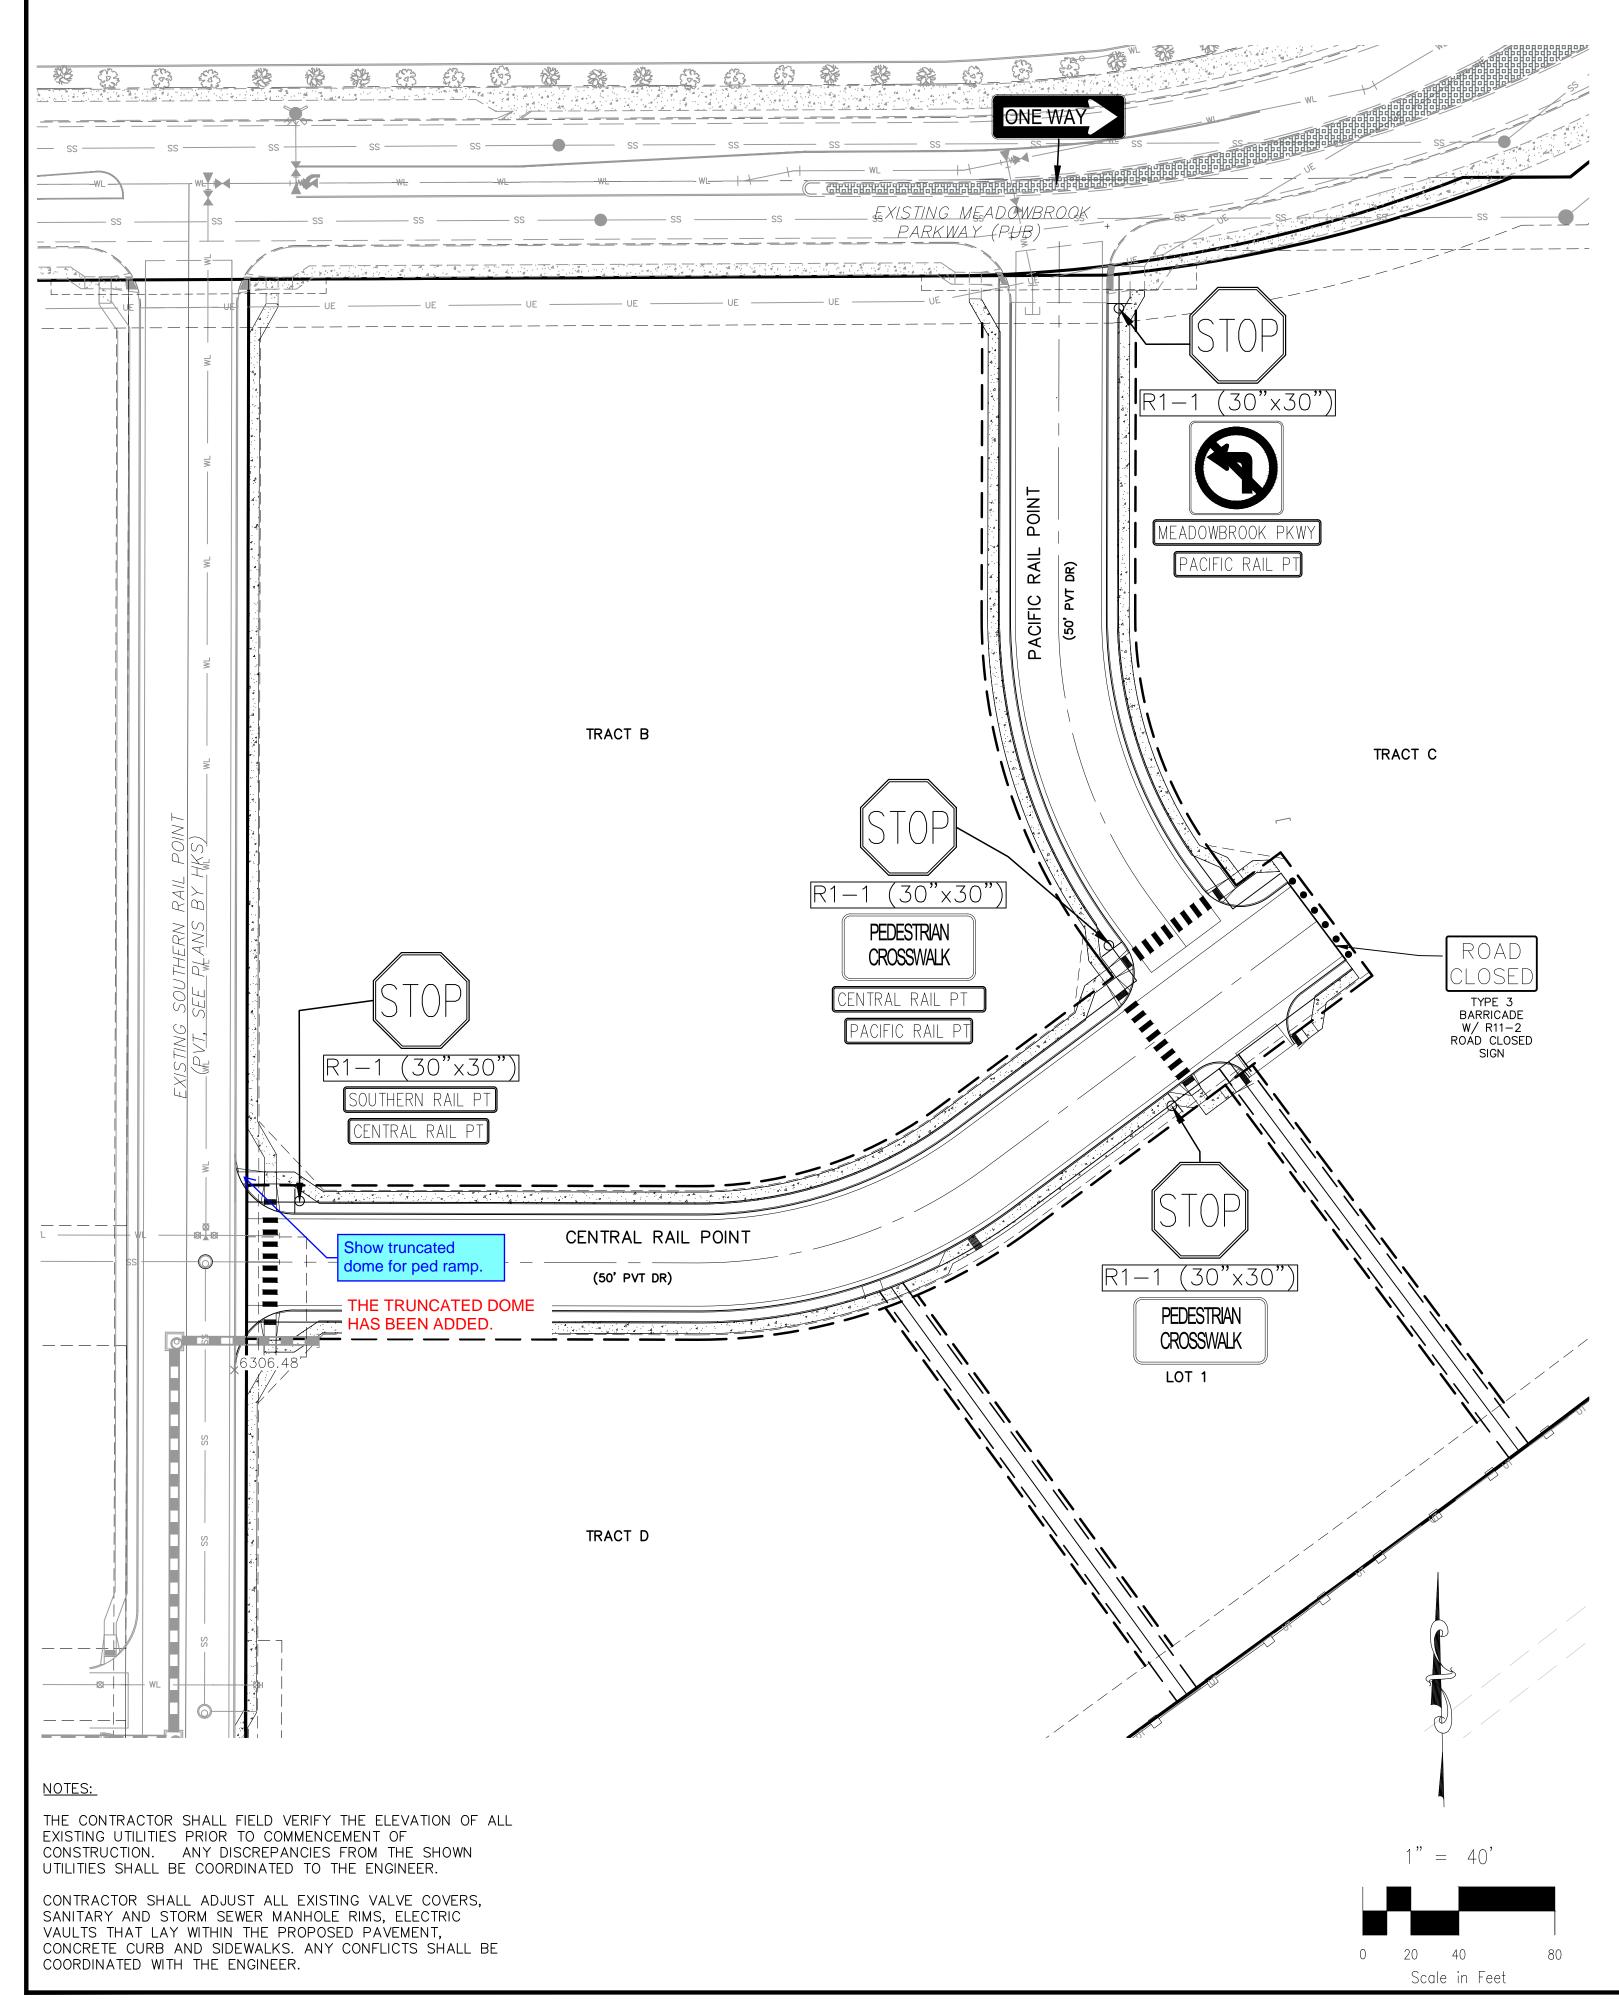


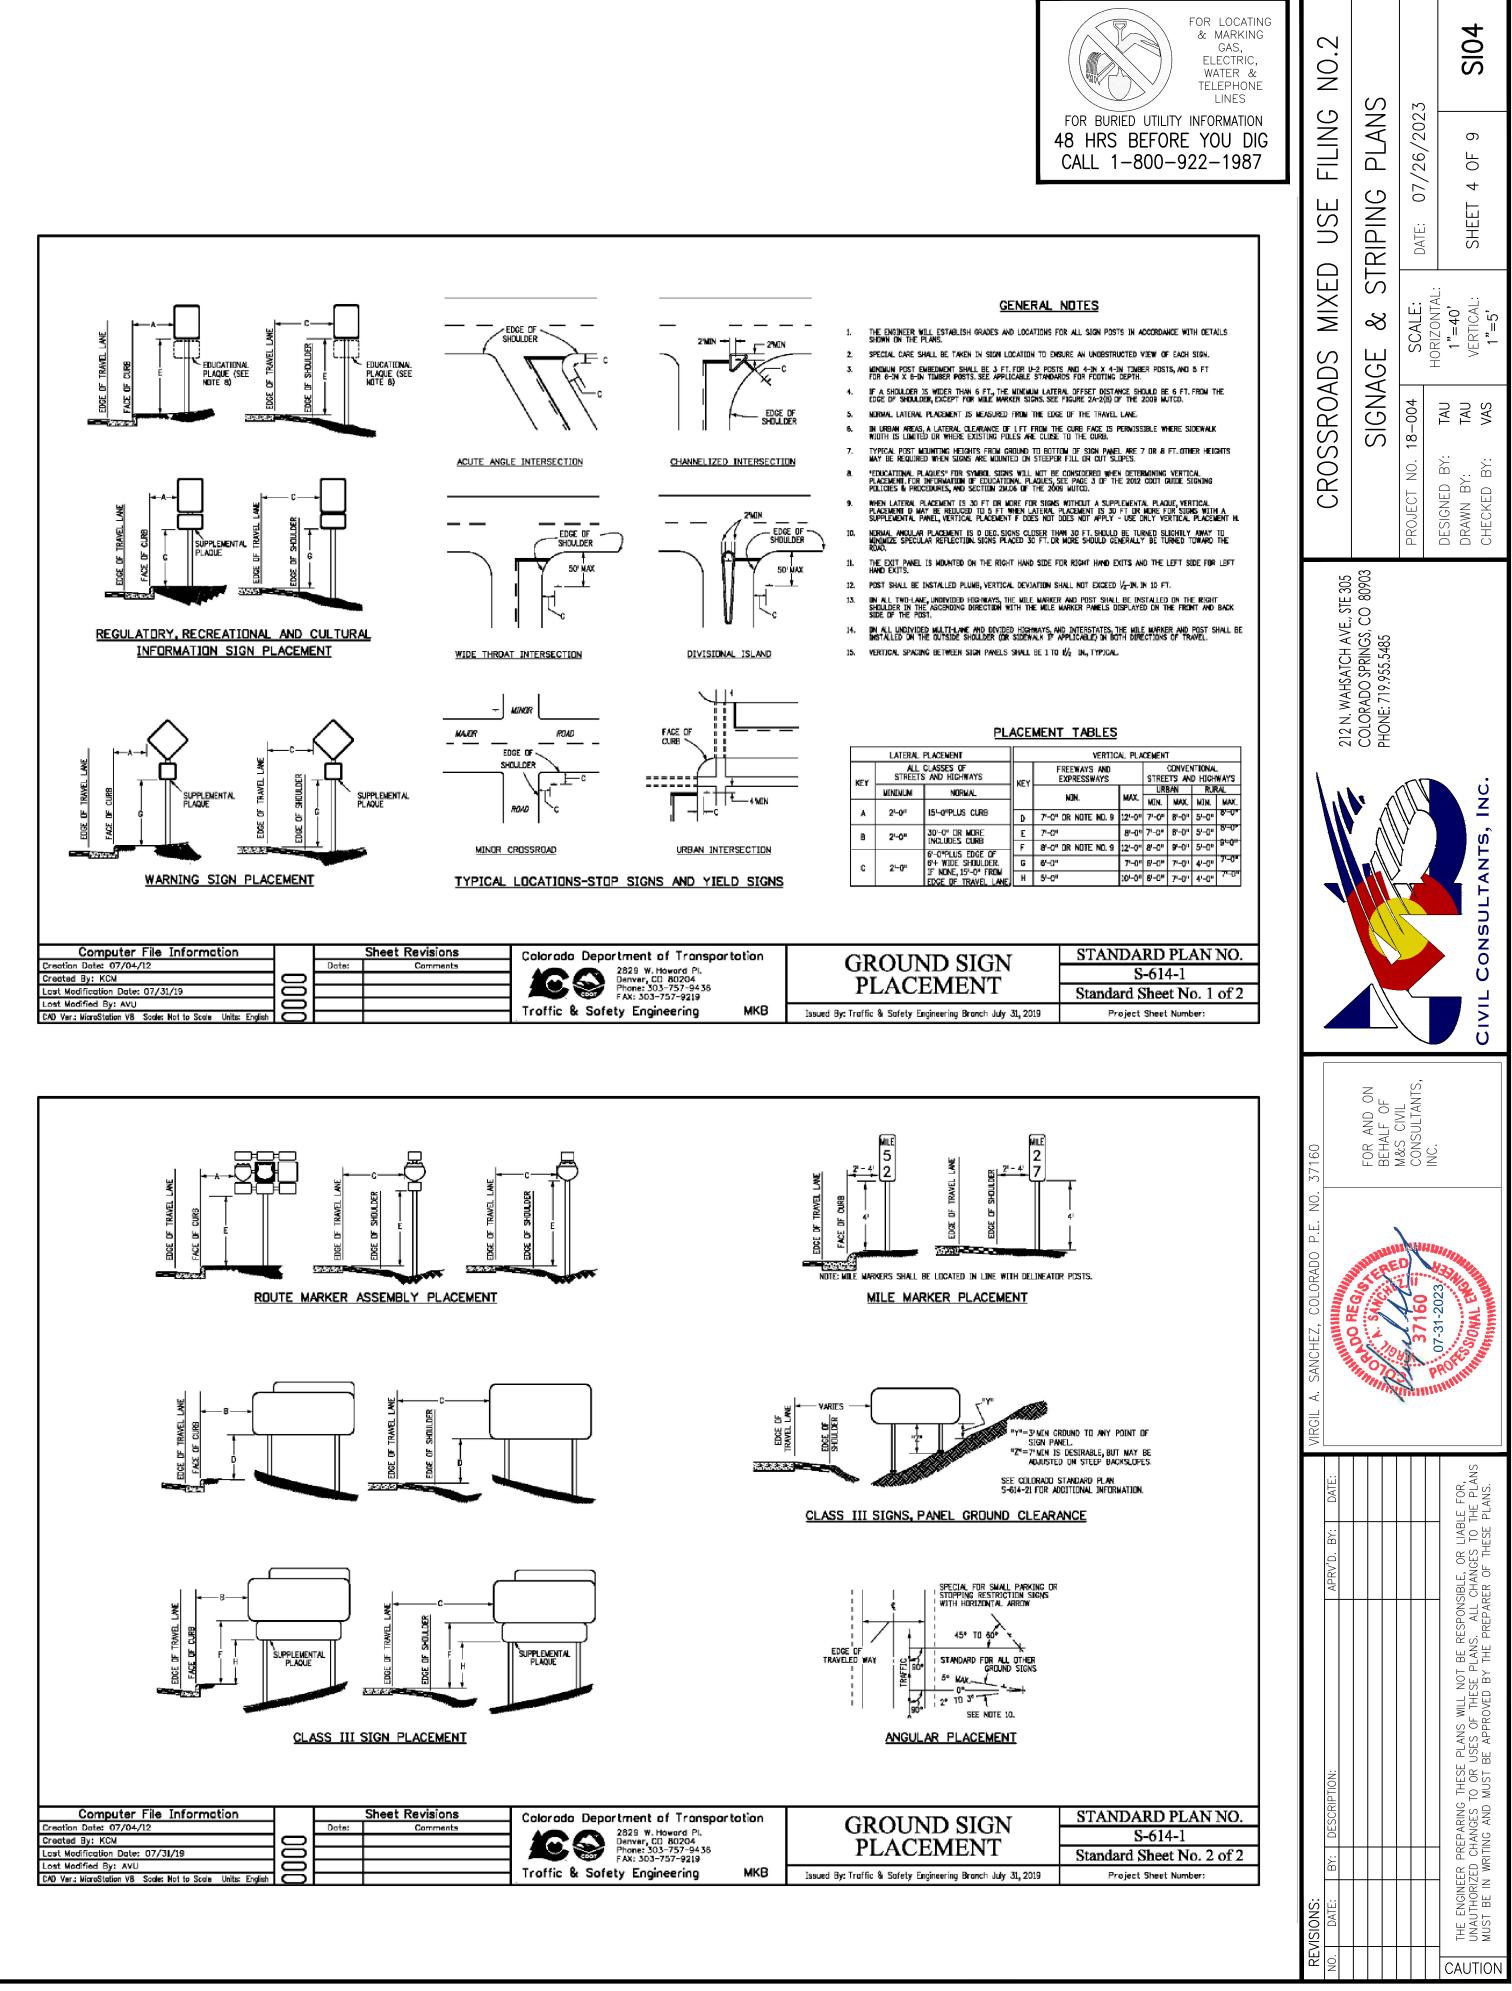





ansportation	GROUND SIGN	STANDARD PLAN NO.
PL 4		S-614-1
9436 19	PLACEMENT	Standard Sheet No. 1 of 2
ng MKB	Issued By: Traffic & Safety Engineering Branch July 31, 2019	Project Sheet Number:

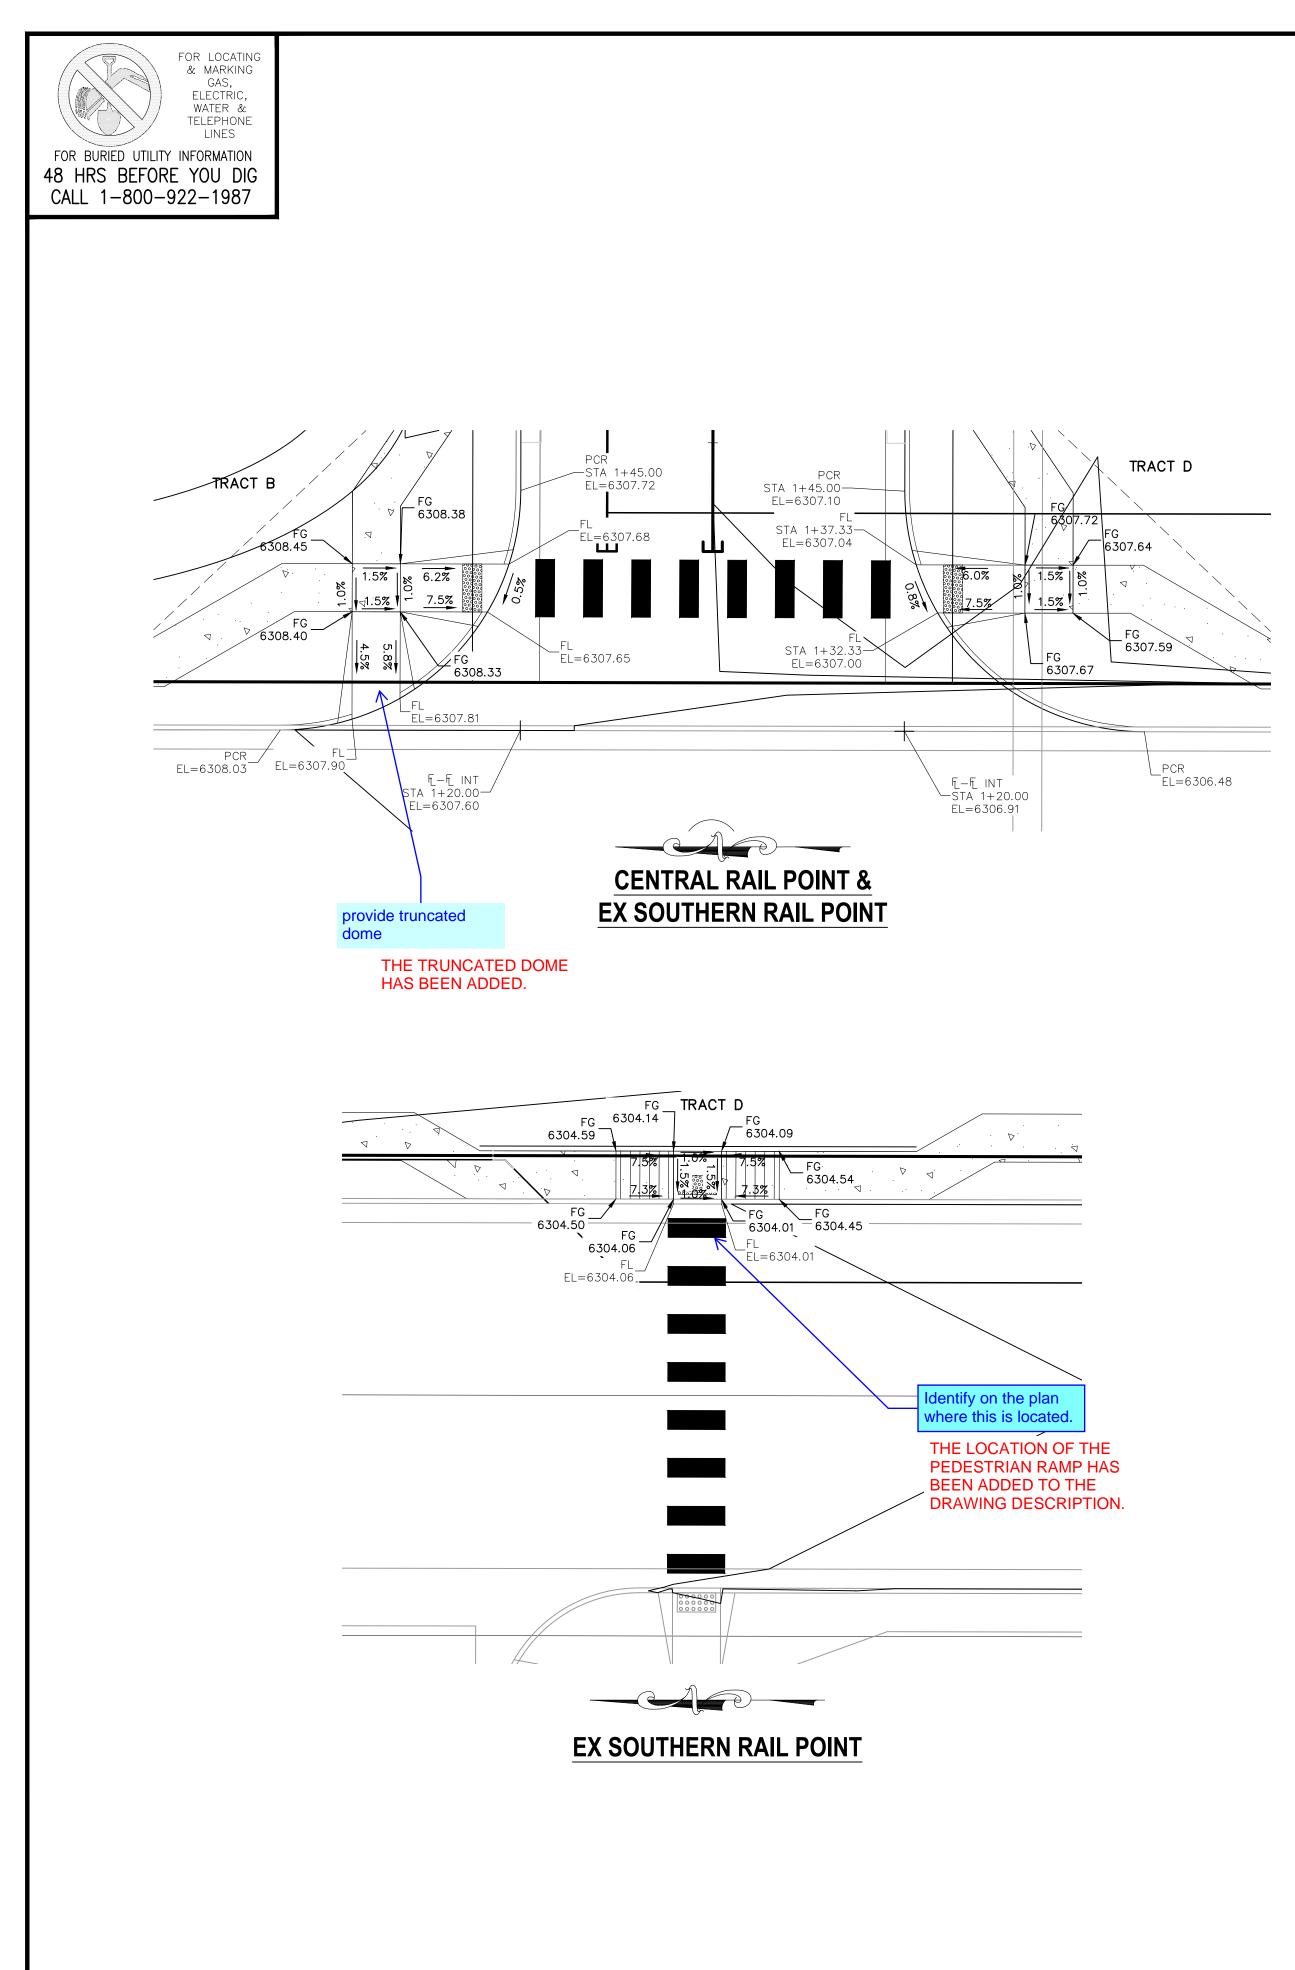

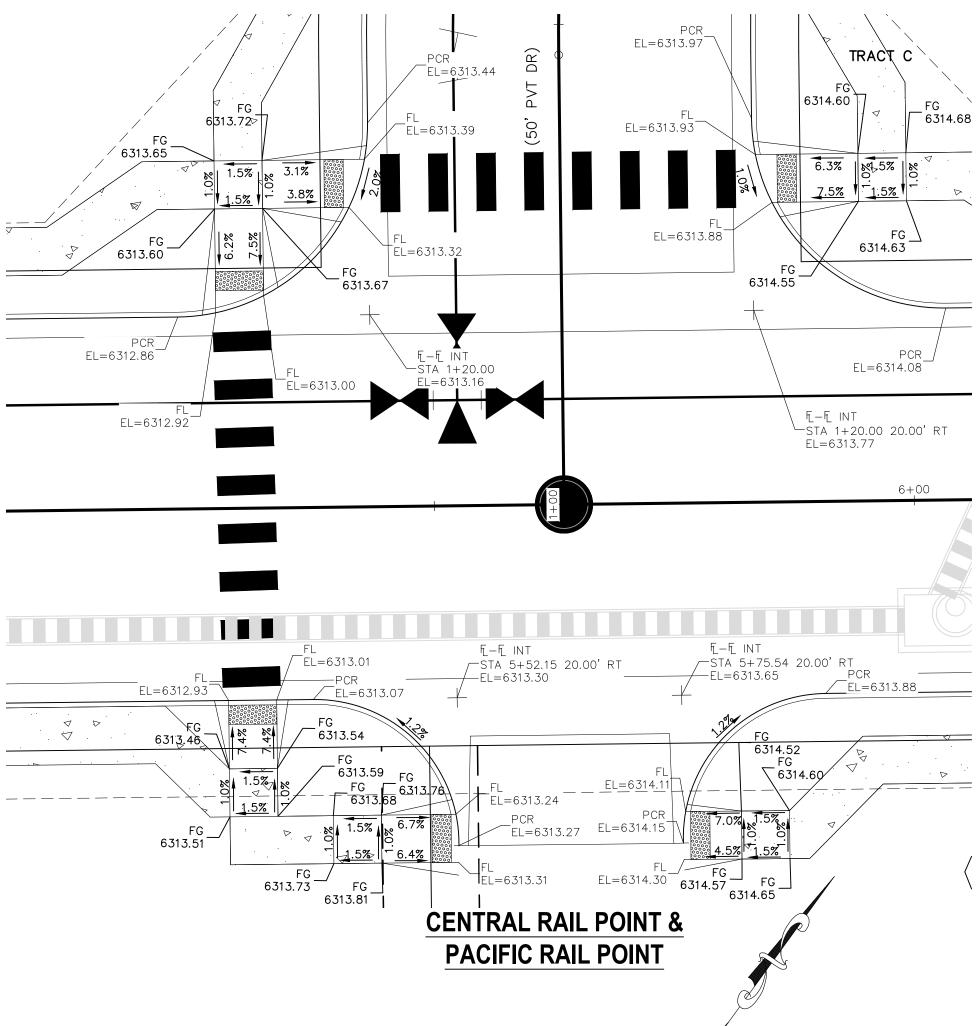


ABBREVIATION LEGEND         CL       CENTERLINE         LT       LEFT         RT       RIGHT         C&G       CURB AND GUTTER         EL       ELEVATION         W       WEST         CONST       CONSTRUCTION         N       NORTH         WTR       WATER         S       SOUTH         STM       STORM SEWER         PUB       PUBLIC         EX       EXISTING         STA       STATION         NTS       NOT TO SCALE         PROP       PROPOSED         SAN       SANITARY SEWER         CMD       CHEROKEE METROPOLITAN DISTRICT         CDS       CUL DE SAC	CROSSROADSMIXEDUSEFILINGNO.2PROJECT NO. 18-004PROJECT NO. 18-004DATE:07/26/2023DRAWN BY:TAU1"=10"DATE:07/26/2023DRAWN BY:TAU1"=10"SHEET 5 OF 9SIO5CHECKED BY:VANN/ASHEET 5 OF 9SIO5
ELEVATION OF ALL EXISTING UTILITIES PRIOR TO COMMENCEMENT OF CONSTRUCTION. ANY DISCREPANCIES FROM THE SHOWN UTILITIES SHALL BE COORDINATED TO THE ENGINEER. CONTRACTOR SHALL ADJUST ALL EXISTING VALVE COVERS, SANITARY AND STORM SEWER MANHOLE RIMS, ELECTRIC VAULTS THAT LAY WITHIN THE PROPOSED PAVEMENT, CONCRETE CURB AND SIDEWALKS. ANY CONFLICTS SHALL BE COORDINATED WITH THE ENGINEER.	212 N. WAHSATCH AVE., STE 305 COLORADO SPRINGS, CO 80903 PHONE: 719.955.5485
1" = 10' 0 5 10 20 Scale in Feet	CIVIL CONSULTANTS, INC.
	NO. 37160 FOR AND ON BEHALF OF M&S CIVIL CONSULTANTS, INC.
	VIRGIL A. SANCHEZ, COLORADO P.E.
	TION: APRV'D. BY: DATE: APRV'D. BY: DATE: HESE PLANS WILL NOT BE RESPONSIBLE, OR LIABLE FOR, O OR USES OF THESE PLANS. ALL CHANGES TO THE PLANS MUST BE APPROVED BY THE PREPARER OF THESE PLANS.
	REVISIONS: NO. DATE: BY: DESCRIPTION: DESCRIPTION: THE ENGINEER PREPARING THESE UNAUTHORIZED CHANGES TO OR MUST BE IN WRITING AND MUST F

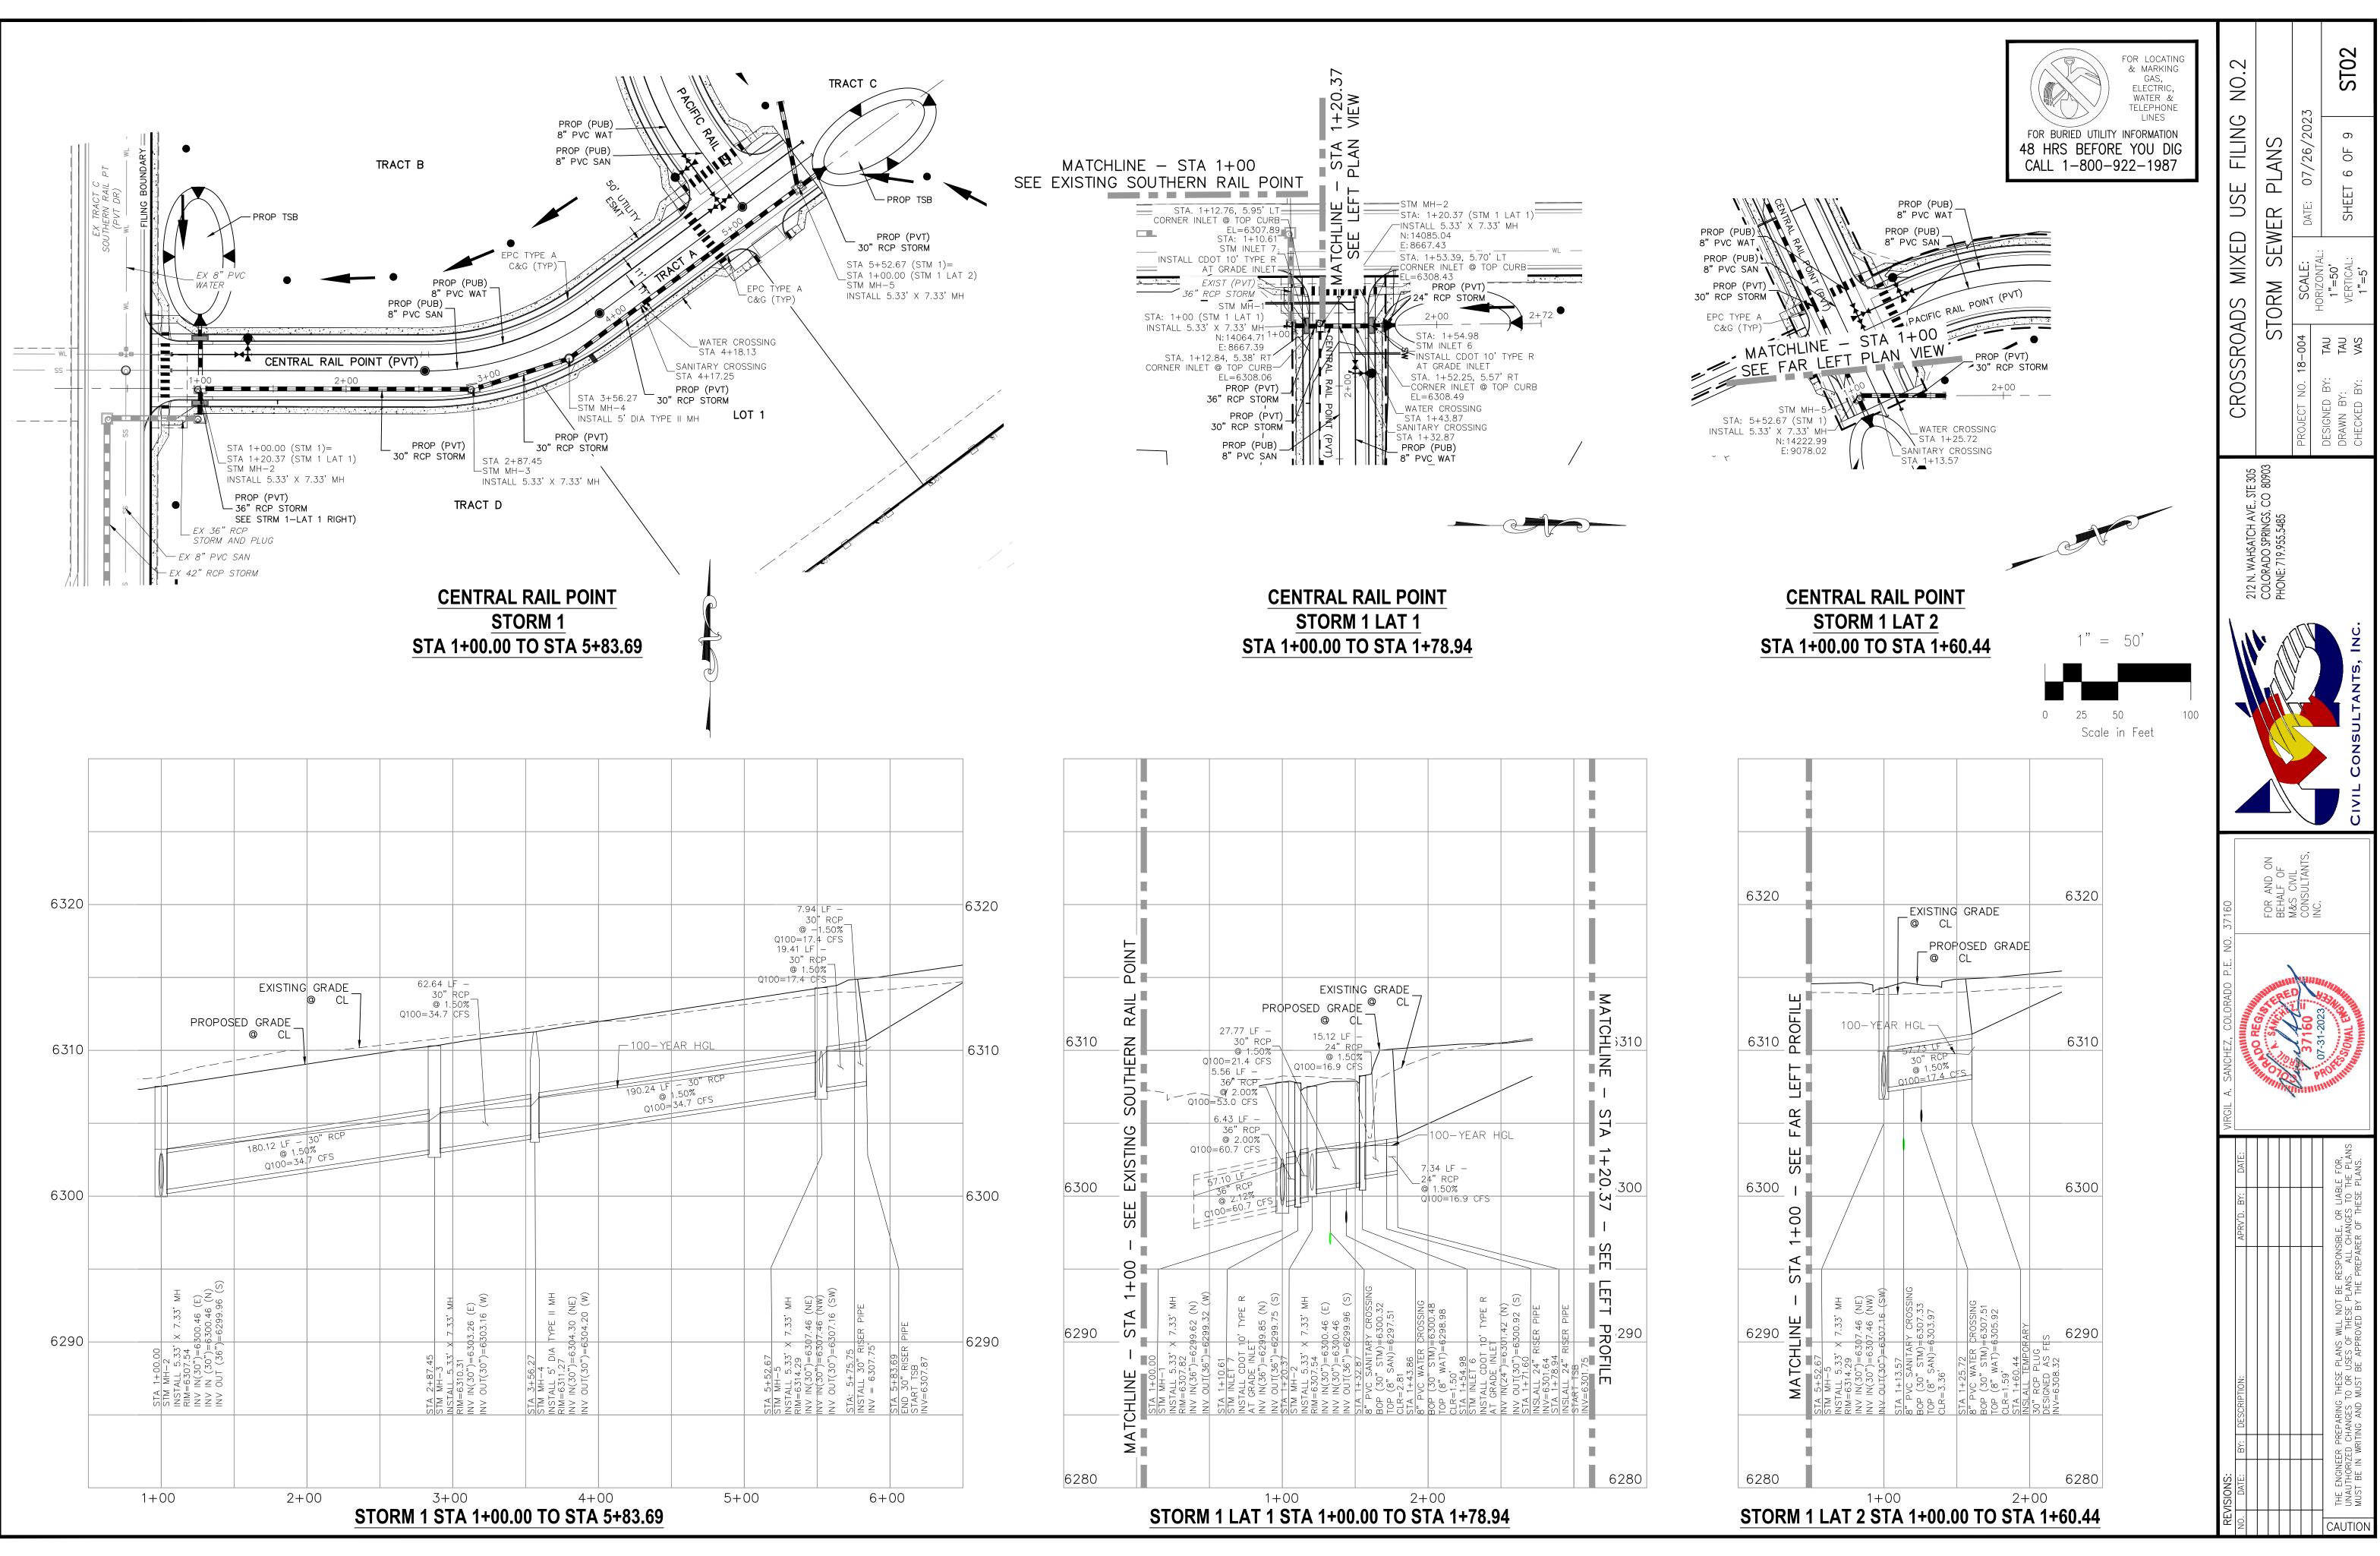

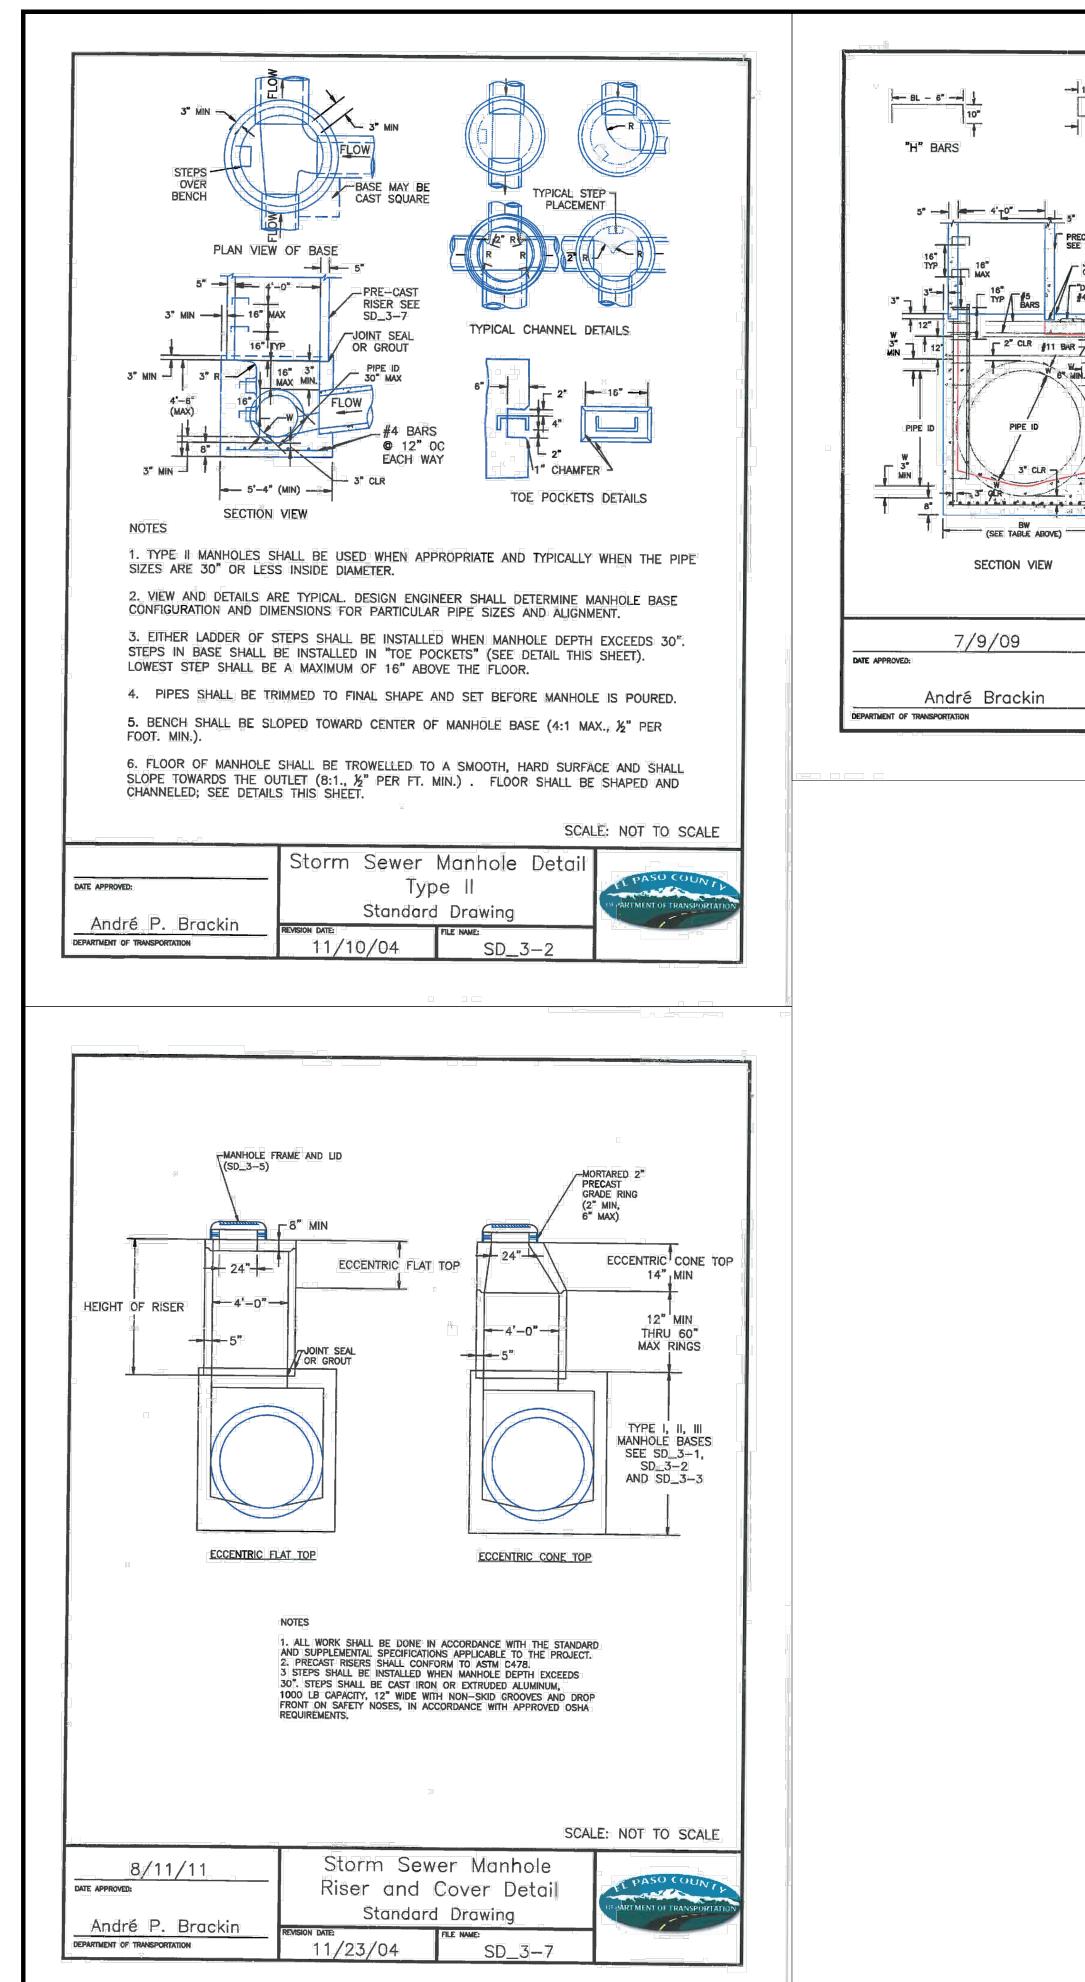




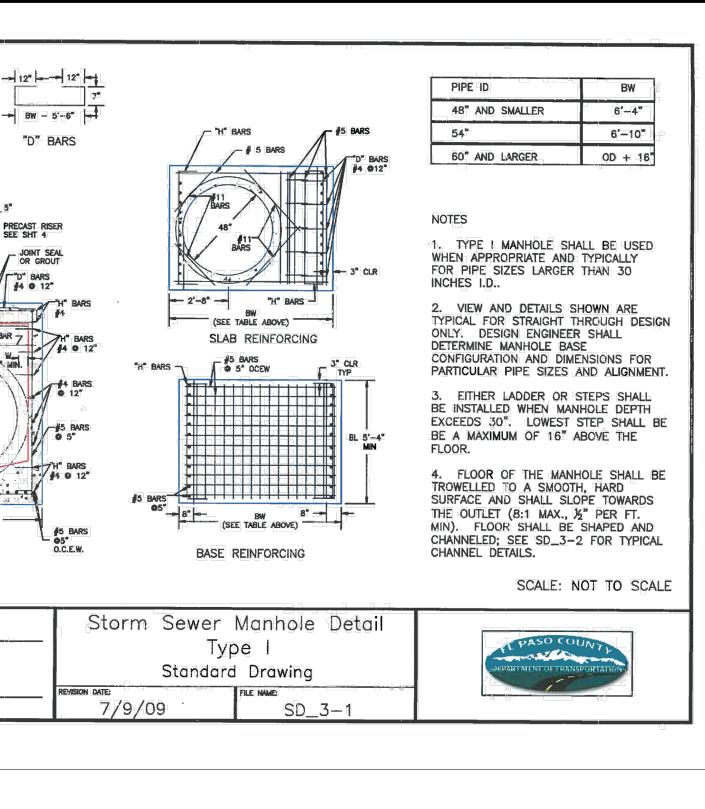


#11 BAR -7


3" CLR

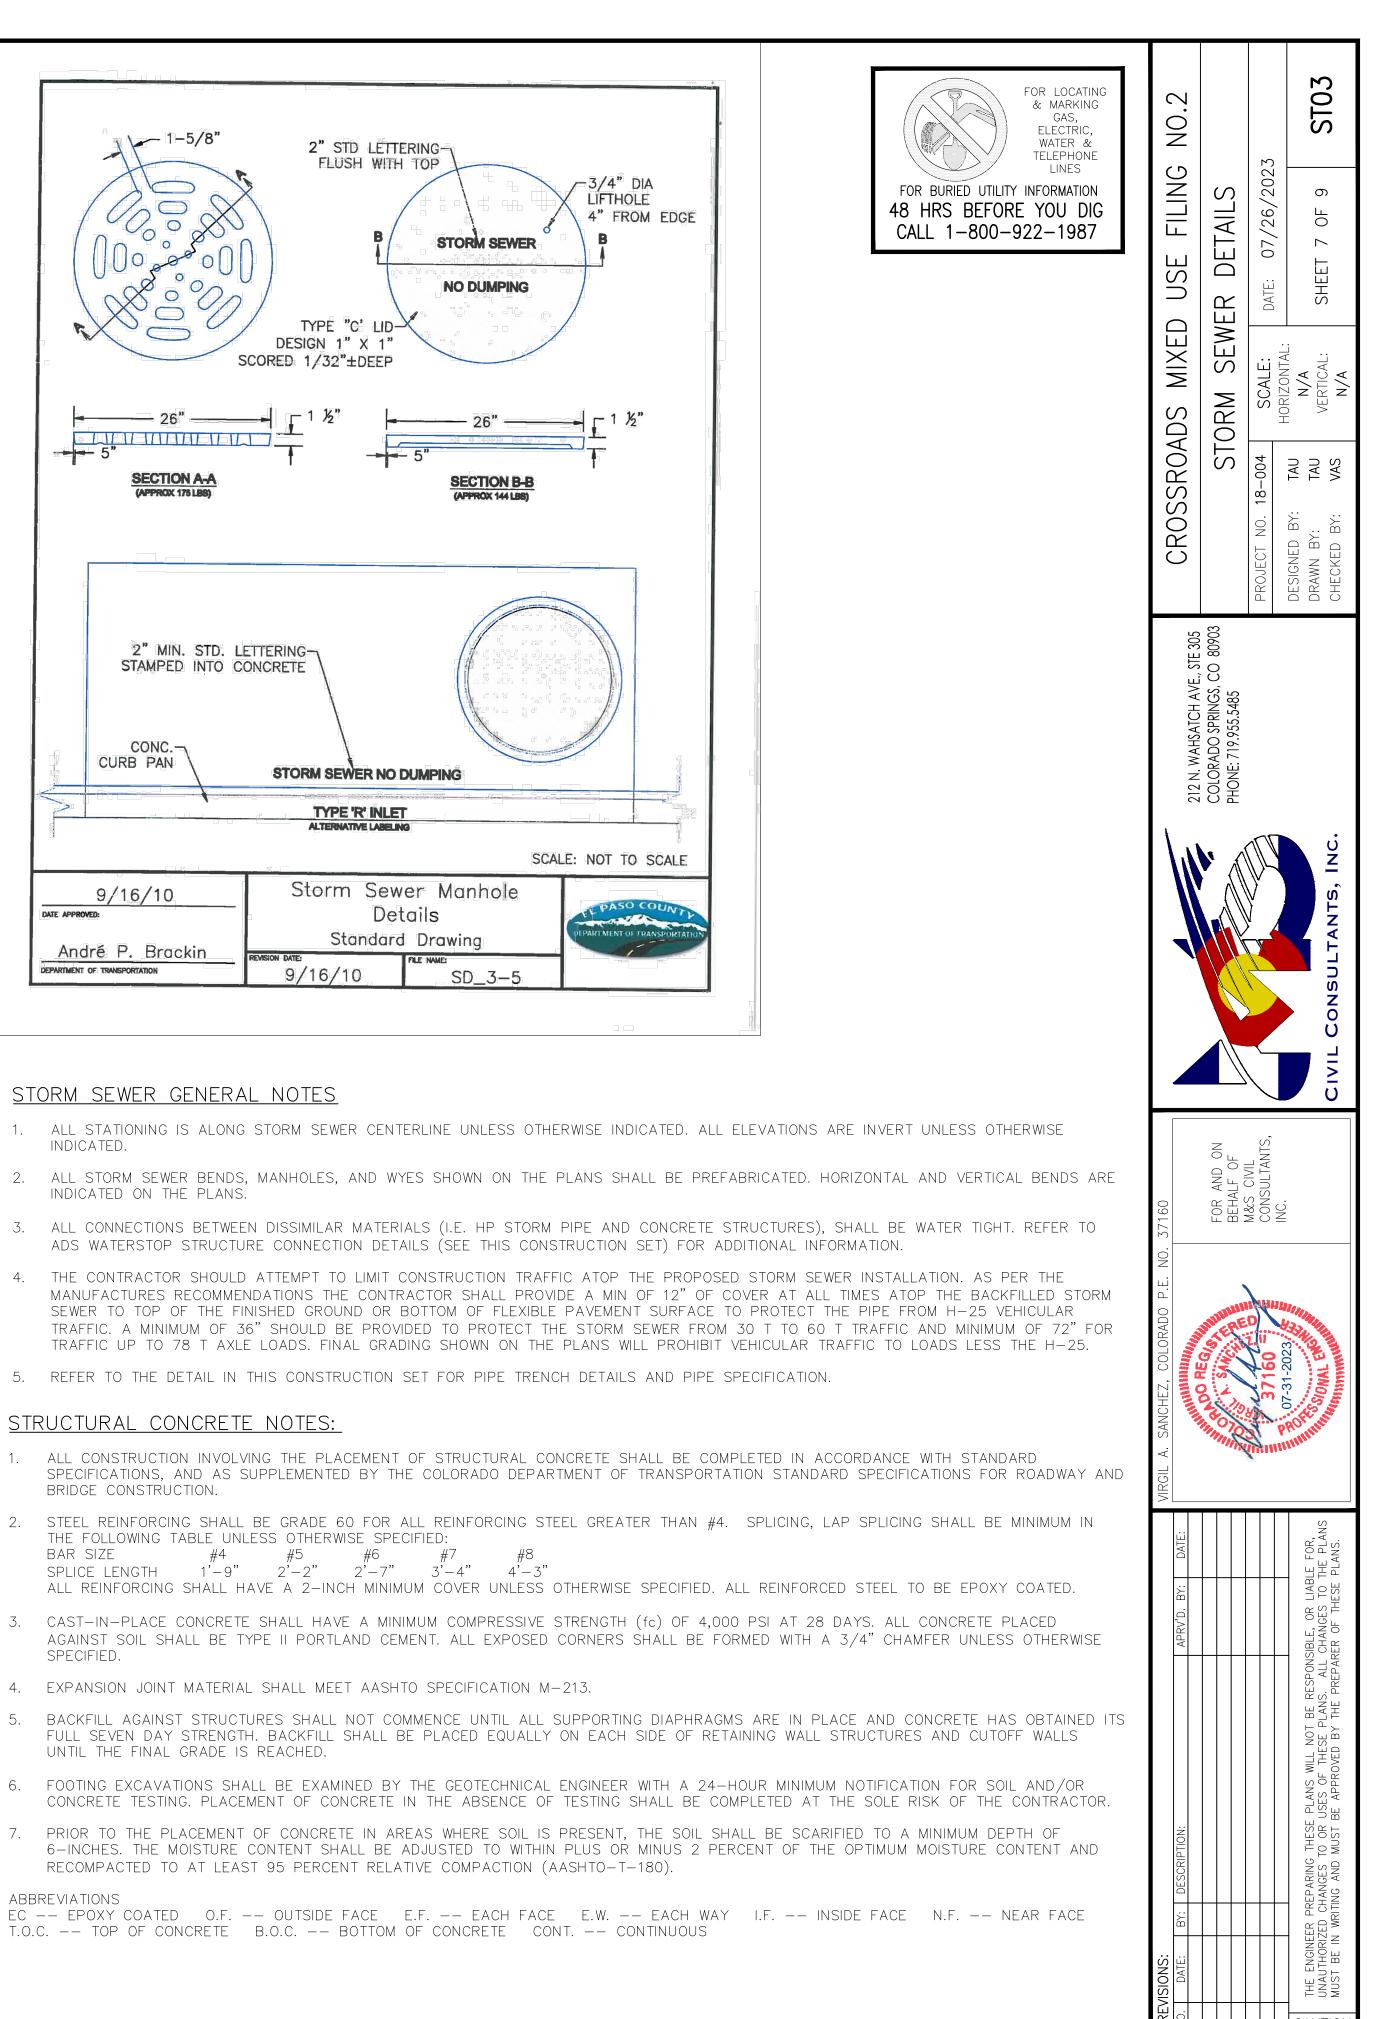


# STORM SEWER GENERAL NOTES

# STRUCTURAL CONCRETE NOTES:

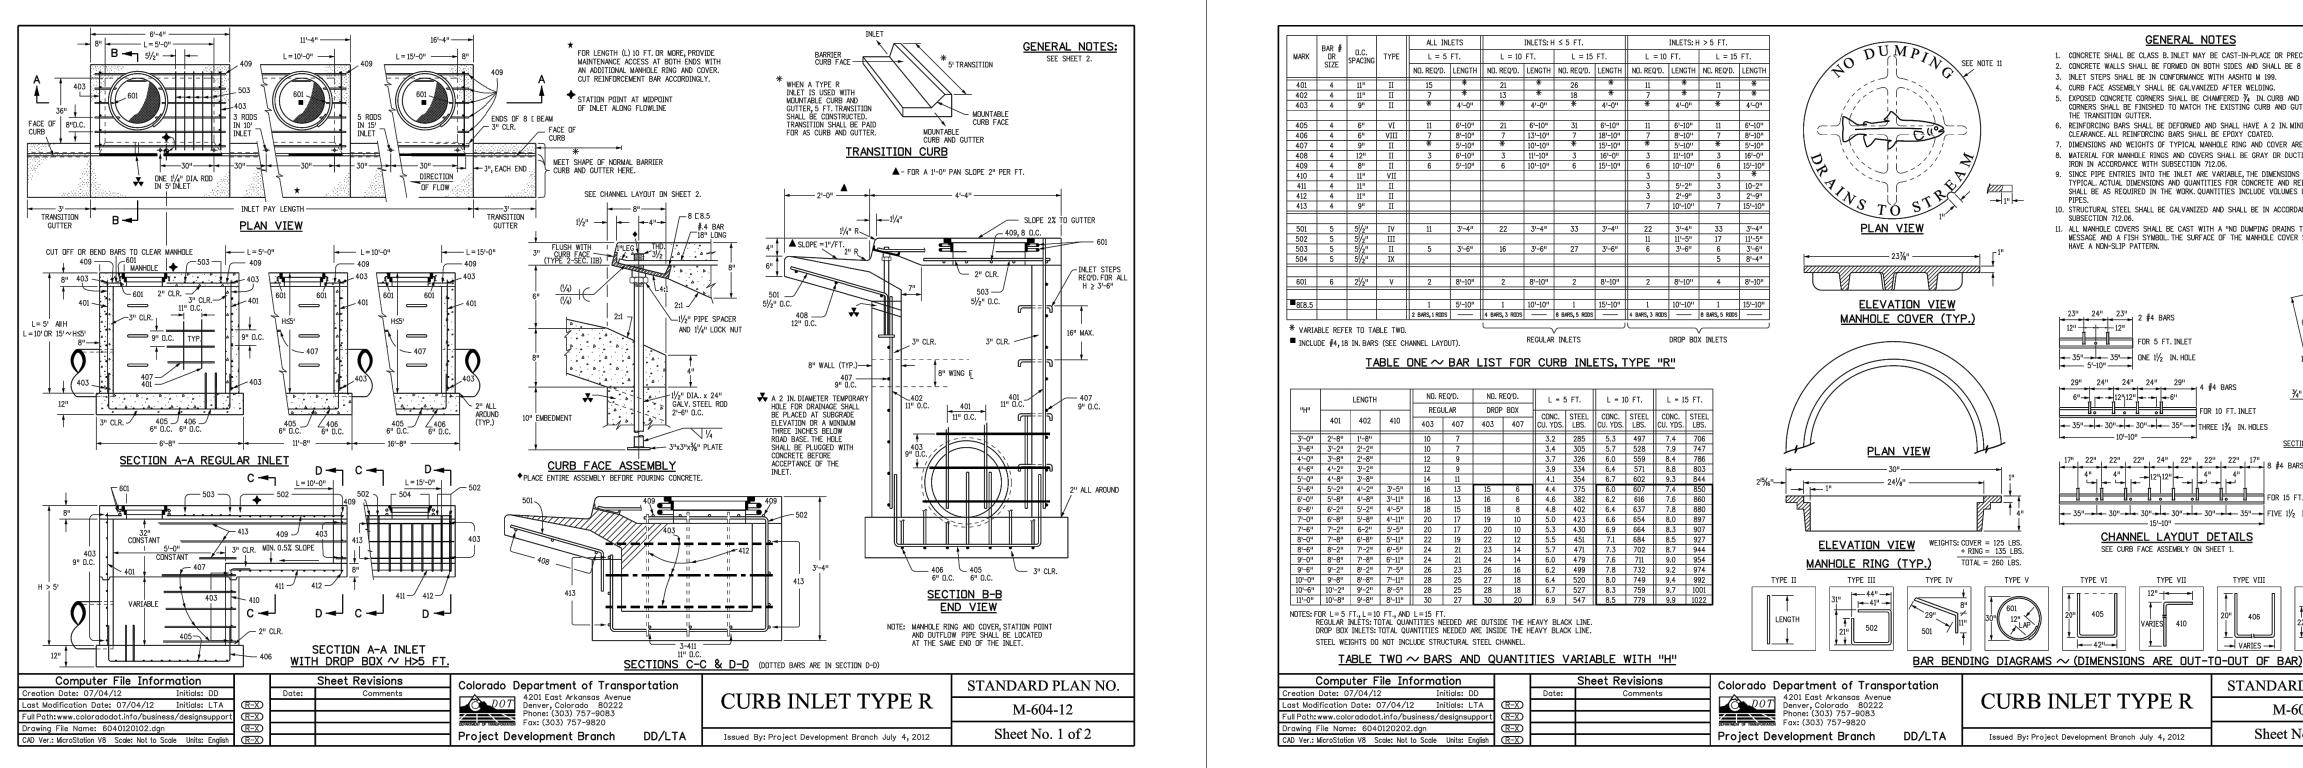

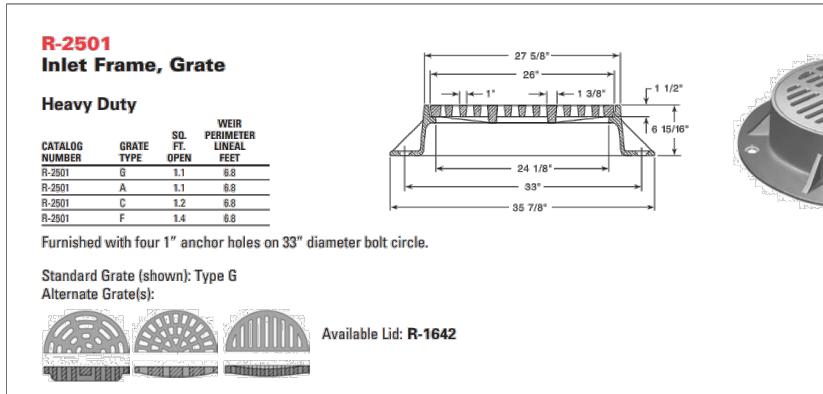

PRECAST. BE 8 IN. THICK. AND GUTTER D GUTTER BEYOND A. MINIMUM R ARE NOMINAL. DUCTILE CAST SIONS SHOWN ARE ID REINFORCEMENT MES DOCUPIED BY SORDANCE WITH INS TO STREAM" JVER SHALL 1/4	FOR LOCATING GAS, ELEPHONE LINES FOR BURIED UTILITY INFORMATION 48 HRS BEFORE YOU DIG CALL 1-800-922-1987	CROSSROADS MIXED USE FILING NO.2	STORM SEWER DETAILS	NO. 18-004	DESIGNED BY: TAU N/A DRAWN BY: TAU VERTICAL: SHEET 8 OF 9 ST04 CHECKED BY: VAS N/A
TYPE X TYPE X TYPE X TYPE X TYPE X ARD PLAN NO. 1-604-12 t No. 2 of 2		0 P.E. NO. 37160		60 CONSULTANTS, CONSULTANTS, INC.	
		REVISIONS:     VIRGIL A. SANCHEZ, COLORAD       NO.     DATE:     BY:     DESCRIPTION:       NO.     DATE:     PRV'D: BY:     DATE:		37160	THE ENGINEER PREPARING THESE PLANS WILL NOT BE RESPONSIBLE, OR LIABLE FOR, UNAUTHORIZED CHANGES TO OR USES OF THESE PLANS. ALL CHANGES TO THE PLANS MUST BE IN WRITING AND MUST BE APPROVED BY THE PREPARER OF THESE PLANS.

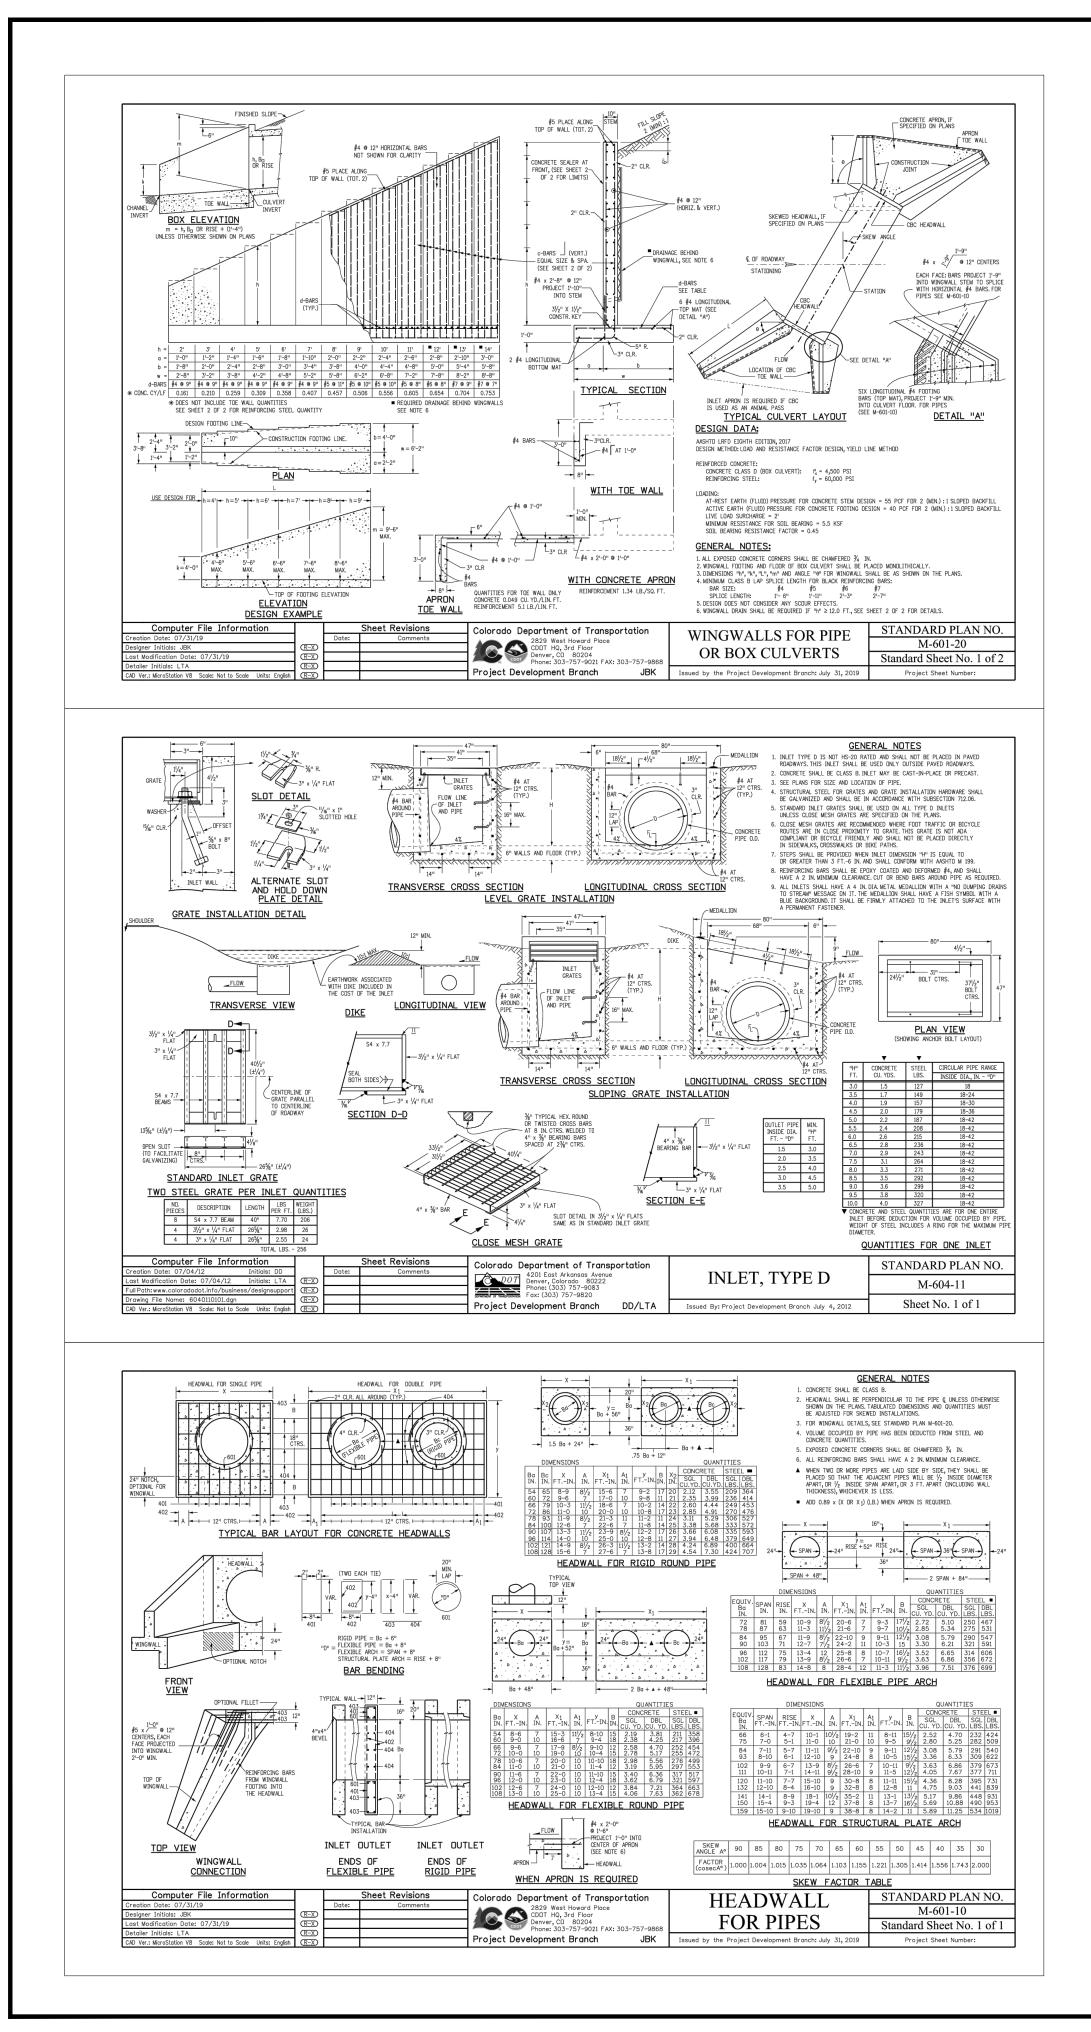



## SOIL RIPRAP NOTES:

- 1. THE SOIL MATERIAL SHALL BE NATIVE OR TOPSOIL AND MIXED WITH SIXTY FIVE PERCENT (65%) RIPRAP AND THIRTY FIVE PERCENT (35%) SOIL BY VOLUME.
- 2. SOIL RIPRAP SHALL CONSIST OF A UNIFORM MIXTURE OF SOIL AND RIPRAP WITHOUT VOIDS.
- 3. CONTRACTOR SHALL COOPERATE WITH ENGINEER IN OBTAINING AND PROVIDED SAMPLES OF ALL SPECIFIED MATERIALS.
- 4. CONTRACTOR SHALL SUBMIT CERTIFIED LABORATORY TEST CERTIFICATES FOR ALL ITEMS REQUIRED FOR SOIL RIPRAP.
- 5. RIPRAP USED SHALL BE THE TYPE DESIGNATED ON THE DRAWINGS AND SHALL CONFORM TO TABLE SHOWN TO THE RIGHT.
- 6. THE RIPRAP DESIGNATION AND TOTAL THICKNESS OF RIPRAP SHALL BE AS SHOWN ON THE DRAWINGS. THE MAXIMUM STONE SIZE SHALL NOT LARGER THAN THE THICKNESS OF THE RIPRAP.
- 7. NEITHER WIDTH NOR THICKNESS OF A SINGLE STONE OF RIPRAP SHALL BE LESS THAN ONE-THIRD (3) OF ITS LENGTH.
- 8. THE SPECIFIC GRAVITY OF THE RIPRAP SHALL BE TWO AND ONE-HALF (2.5) OR GREATER.
- 9. MINIMUM DENSITY FOR ACCEPTABLE RIPRAP SHALL BE ONE HUNDRED AND SIXTY FIVE (165) POUNDS PER CUBIC FOOT.
- 10. RIPRAP SPECIFIC GRAVITY SHALL BE ACCORDING TO THE BULK-SATURATED, SURFACE-DRY BASIS, IN ACCORDANCE WITH AASHTO T85.
- 11. BROKEN CONCRETE OR ASPHALT PAVEMENT SHALL NOT BE ACCEPTABLE FOR USE IN THE WORK.
- 12. ROUNDED RIPRAP (RIVER ROCK) IS NOT ACCEPTABLE, UNLESS SPECIFICALLY DESIGNATED ON THE DRAWINGS.

	CROSSROADS MIXED USE FILING NO.2	BMP DETAILS	PROJECT NO. 18-004SCALE: DESIGNED BY: TAU DRAWN BY: TAU CHECKED BY: VASSCALE: DATE: 07/26/2023DESIGNED BY: TAU DRAWN BY: TAU CHECKED BY: VASHORIZONTAL: N/ADATE: 07/26/2023DESIGNED BY: TAU DRAWN BY: TAU CHECKED BY: VASN/ABATE: 07/26/2023
	212 N WAHSATCH AVE STE 305	COLORADO SPRINGS, CO 80903 PHONE: 719.955.5485	
			CIVIL CONSULTANTS, INC.
	NO. 37160	FOR AND ON Behalf of	M&S CIVIL CONSULTANTS, INC.
	VIRGIL A. SANCHEZ, COLORADO P.E.	UNITERE CONTENTS CONT	37160 - 07-31-2023
	APRV'D. BY: DATE:		ESE PLANS WILL NOT BE RESPONSIBLE, OR LIABLE FOR, OR USES OF THESE PLANS. ALL CHANGES TO THE PLANS ST BE APPROVED BY THE PREPARER OF THESE PLANS.
FOR LOCATING & MARKING GAS, ELECTRIC, WATER & TELEPHONE LINES FOR BURIED UTILITY INFORMATION 48 HRS BEFORE YOU DIG CALL 1-800-922-1987	REVISIONS: NO. DATE: BY: DESCRIPTION:		THE ENGINEER PREPARING THESE PLA UNAUTHORIZED CHANGES TO OR USE MUST BE IN WRITING AND MUST BE A

# V4\_CDs Comments.pdf Markup Summary

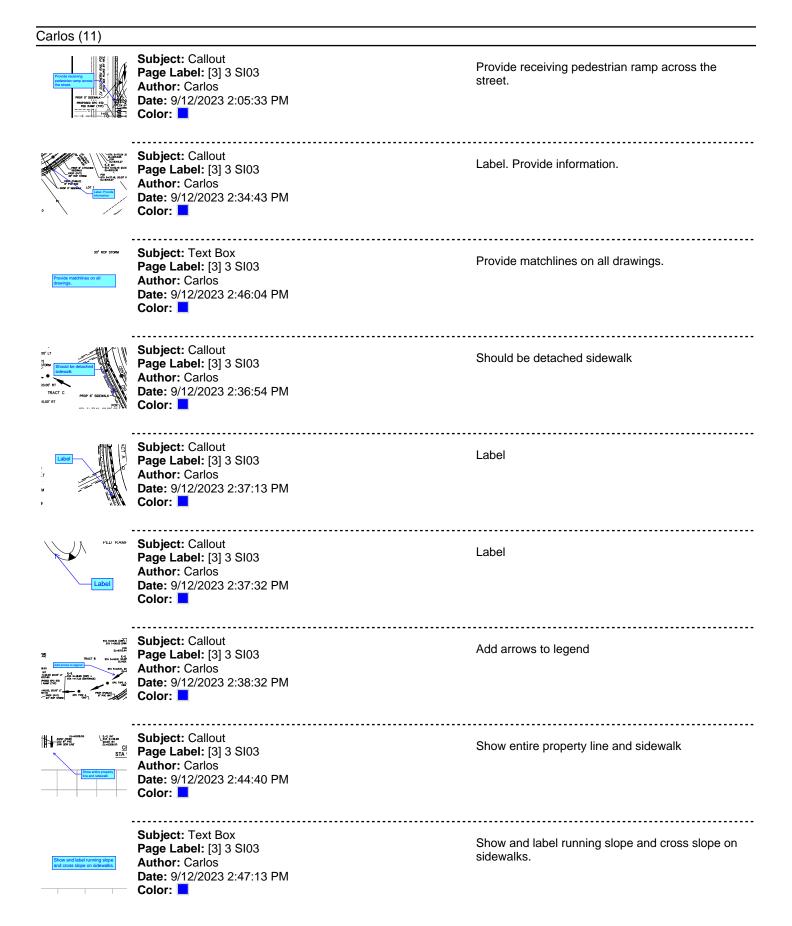

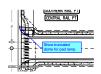

Subject: Callout Page Label: [4] 4 Sl04 Author: Carlos Date: 9/12/2023 2:40:33 PM Color:

Show truncated dome for ped ramp.



Subject: Callout Page Label: [5] 5 SI05 Author: Carlos Date: 9/12/2023 2:45:09 PM Color:

Identify on the plan where this is located.

## Daniel Torres (10)



Subject: Callout Page Label: [2] 2 SI02 Author: Daniel Torres Date: 9/12/2023 5:51:44 PM Color:



Subject: Callout Page Label: [2] 2 SI02 Author: Daniel Torres Date: 9/12/2023 5:15:29 PM Color:



Subject: Callout Page Label: [2] 2 Sl02 Author: Daniel Torres Date: 9/12/2023 5:51:57 PM Color:

Subject: Cloud+ Page Label: [3] 3 Sl03 Author: Daniel Torres Date: 9/12/2023 5:45:23 PM Color:



Subject: Callout Page Label: [3] 3 Sl03 Author: Daniel Torres Date: 9/12/2023 5:36:35 PM Color:



Subject: Callout Page Label: [3] 3 SI03 Author: Daniel Torres Date: 9/12/2023 5:40:47 PM Color:



Subject: Text Box Page Label: [3] 3 SI03 Author: Daniel Torres Date: 9/12/2023 5:42:44 PM Color: It was indicated in the preliminary plan deviation and the submitted TIS that these would have a design and posted speed of 25 mph similar to a urban local classification. Please revise. Also please add note on the cross sections: per deviation request from Preliminary Plan SP2011

revise to Tract D as there is no longer a lot 2

cross section shows detached. revise

Please revise the drawings and texts so that there is no conflict. Will there be curbs cuts and a driveway for or will the sidewalk continue through?

.....

Please extend to show the entire sidewalk along Southern Rail Pt and how it ties to the sidewalk along Meadowbrook.

The cross sections show a detached sidewalk. Revise to match. Is there a reason for having an attached sidewalk at this location? Please give us a call to discuss.

cross section show a detached sidewalk. revise to match.

PROP 5' SIDEWALK PROPOSED EPC STD	Subject: Arrow Page Label: [3] 3 SI03 Author: Daniel Torres Date: 9/12/2023 5:44:02 PM Color:	
Refer to ECM 2.5.2.C.3 PROP 5' : PROPOSE PED F	Subject: Text Box Page Label: [3] 3 SI03 Author: Daniel Torres Date: 9/12/2023 5:46:31 PM Color:	Refer to ECM 2.5.2.C.3
Length Annual Lingth	Subject: Callout Page Label: [5] 5 SI05 Author: Daniel Torres Date: 9/12/2023 5:49:13 PM Color:	provide truncated dome