STANDARD CONSTRUCTION NOTES:

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- b. CITY OF COLORADO SPRINGS/EL PASO COUNTY DRAINAGE CRITERIA MANUAL, VOLUMES 1 AND 2 COLORADO DEPARTMENT OF TRANSPORTATION (CDOT) STANDARD SPECIFICATIONS FOR ROAD AND BRIDGE CONSTRUCTION
- CDOT M & S STANDARDS
- 4. NOTWITHSTANDING ANYTHING DEPICTED IN THESE PLANS IN WORDS OR GRAPHIC REPRESENTATION, ALL DESIGN AND CONSTRUCTION RELATED TO ROADS, STORM DRAINAGE AND EROSION CONTROL SHALL CONFORM TO THE STANDARDS AND REQUIREMENTS OF THE MOST RECENT VERSION OF THE RELEVANT ADOPTED EL PASO COUNTY STANDARDS, INCLUDING THE LAND DEVELOPMENT CODE, THE ENGINEERING CRITERIA MANUAL, THE DRAINAGE CRITERIA MANUAL. AND THE DRAINAGE CRITERIA MANUAL VOLUME 2. ANY DEVIATIONS FROM REGULATIONS AND STANDARDS MUST BE REQUESTED, AND APPROVED, IN WRITING. ANY MODIFICATIONS NECESSARY TO MEET CRITERIA AFTER-THE-FACT WILL BE ENTIRELY THE DEVELOPER'S RESPONSIBILITY TO RECTIFY.
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SIGNAGE & STRIPING NOTES:

- 1. ALL SIGNS AND PAVEMENT MARKINGS SHALL BE IN COMPLIANCE WITH THE CURRENT MANUAL ON UNIFORM TRAFFIC CONTROL DEVICES (MUTCD).
- REMOVAL OF EXISTING PAVEMENT MARKINGS SHALL BE ACCOMPLISHED BY A METHOD THAT DOES NOT MATERIALLY DAMAGE THE PAVEMENT. THE PAVEMENT MARKINGS SHALL BE REMOVED TO THE EXTENT THAT THEY WILL NOT BE VISIBLE UNDER DAY OR NIGHT CONDITIONS. AT NO TIME WILL IT BE ACCEPTABLE TO PAINT OVER EXISTING PAVEMENT MARKINGS.
- 3. ANY DEVIATION FROM THE STRIPING AND SIGNING PLAN SHALL BE APPROVED BY EL PASO COUNTY DEVELOPMENT SERVICES.
- 4. ALL SIGNS SHOWN ON THE SIGNING AND STRIPING PLAN SHALL BE NEW SIGNS. EXISTING SIGNS MAY REMAIN OR BE REUSED IF THEY MEET CURRENT EL PASO COUNTY AND MUTCD STANDARDS.
- 5. STREET NAME AND REGULATORY STOP SIGNS SHALL BE ON THE SAME POST AT INTERSECTIONS.
- 6. ALL REMOVED SIGNS SHALL BE DISPOSED OF IN A PROPER MANNER BY THE CONTRACTOR.
- ALL STREET NAME SIGNS SHALL HAVE "D" SERIES LETTERS. WITH LOCAL ROADWAY SIGNS BEING 4" UPPER-LOWER CASE LETTERING ON 8" BLANK AND NON-LOCAL ROADWAY SIGNS BEING 6" LETTERING, UPPER-LOWER CASE ON 12" BLANK, WITH A WHITE BORDER THAT IS NOT RECESSED. MULTI-LANE ROADWAYS WITH SPEED LIMITS OF 40 MPH OR HIGHER SHALL HAVE 8" UPPER-LOWER CASE LETTERING ON 18" BLANK WITH A WHITE BORDER THAT IS NOT RECESSED. THE WIDTH OF THE NON-RECESSED WHITE BORDERS SHALL MATCH PAGE 255 OF THE 2012 MUTCD "STANDARD HIGHWAY SIGNS"
- 8. ALL TRAFFIC SIGNS SHALL HAVE A MINIMUM HIGH INTENSITY PRISMATIC GRADE SHEETING.
- 9. ALL LOCAL RESIDENTIAL STREET SIGNS SHALL BE MOUNTED ON A 1.75" x 1.75" SQUARE TUBE SIGN POST AND STUB POST BASE. FOR OTHER APPLICATIONS, REFER TO THE CDOT STANDARD S-614-8 REGARDING USE OF THE P2 TUBULAR STEEL POST SLIPBASE DESIGN.
- 10. ALL SIGNS SHALL BE SINGLE SHEET ALUMINUM WITH 0.100" MINIMUM THICKNESS.
- 11. ALL LIMIT LINES/STOP LINES, CROSSWALK LINES, PAVEMENT LEGENDS, AND ARROWS SHALL BE A MINIMUM 125 MIL THICKNESS PREFORMED THERMOPLASTIC PAVEMENT MARKINGS WITH TAPERED LEADING EDGES PER CDOT STANDARD S-627-1. WORD AND SYMBOL MARKINGS SHALL BE THE NARROW TYPE. STOP BARS SHALL BE 24" IN WIDTH. CROSSWALKS LINES SHALL BE 12" WIDE AND 8' LONG PFR CDOT S-627-1.
- 12. ALL LONGITUDINAL LINES SHALL BE A MINIMUM 15MIL THICKNESS EPOXY PAINT. ALL NON-LOCAL RESIDENTIAL ROADWAYS SHALL INCLUDE BOTH RIGHT AND LEFT EDGE LINE STRIPING AND ANY ADDITIONAL STRIPING AS REQUIRED BY CDOT S-627-1.
- 13. THE CONTRACTOR SHALL NOTIFY EL PASO COUNTY DEVELOPMENT SERVICES (719) 520-6819 PRIOR TO AND UPON COMPLETION OF SIGNING AND STRIPING.
- 14. THE CONTRACTOR SHALL OBTAIN A WORK IN THE RIGHT OF WAY PERMIT FROM THE EL PASO COUNTY PUBLIC SERVICE DEPARTMENT (PSD) PRIOR TO ANY SIGNAGE OR STRIPING WORK WITHIN AN EXISTING EL PASO COUNTY ROADWAY.

GENERAL NOTES

- 1. ALL PAVING AND CURB & GUTTER SHALL BE CONSTRUCTED SO AS NOT TO OBSTRUCT THE DRAINAGE PATHS. GRADES SHALL BE MAINTAINED AS SHOWN IN THESE PLANS FOR THE DRAINAGE PATHS. IF THIS CANNOT BE ACCOMPLISHED, THEN THE ENGINEER SHALL BE NOTIFIED IMMEDIATELY FOR CORRECTION.
- . POSITIVE DRAINAGE AWAY FROM THE BUILDING SHALL BE MAINTAINED DURING AND AFTER SITE CONSTRUCTION. SWALES SHALL BE CONSTRUCTED AROUND BUILDINGS TO DIRECT DRAINAGE AWAY FROM STRUCTURES.
- 3. SITE CONSTRUCTION INCLUDING PAVING AND CURB & GUTTER INSTALLATION SHALL MAINTAIN POSITIVE DRAINAGE AS SHOWN ON THIS PLAN. STANDING WATER OR PONDING ANYWHERE ON THE SITE IS UNACCEPTABLE.
- 4. IT SHALL BE THE RESPONSIBILITY OF THE CONTRACTOR TO VERIFY THE EXISTENCE AND LOCATION OF ALL UNDERGROUND UTILITIES ALONG THE ROUTE OF THE WORK. THE OMISSION FROM OR THE INCLUSION OF UTILITY LOCATIONS ON THE PLANS IS NOT TO BE CONSIDERED AS THE NONEXISTENCE OF OR A DEFINITE LOCATION OF EXISTING UNDERGROUND UTILITIES.

BENCHMARKS:

- THE MOST NORTHERLY CORNER OF THE SITE MONUMENTED BY A 1" YELLOW PLASTIC CAP STAMPED "23890." EL = 5865.58
- THE MOST SOUTHERLY CORNER ALONG US HIGHWAY 85-87 BEING MONUMENTED BY A 1-1/2" ALUMINUM SURVEYORS CAP STAMPED "CCES LLC PLS 30118" LOCATED AT THE WESTERLY CORNER OF THE INTERSECTION OF WESTMARK AVENUE AND US HIGHWAY 85-87. EL = 5854.18

BASIS OF BEARING:

THE WEST LINE OF THE SOUTHWEST QUARTER OF THE SOUTHWEST QUARTER OF SECTION 33, TOWNSHIP 14 SOUTH, RANGE 66 WEST OF THE 6TH P.M. BEING MONUMENTED AT THE NORTH END BY A 2-1/2" ALUMINUM SURVEYORS CAP WITH APPROPRIATE MARKINGS AND AT THE SOUTH END BY A 3-1/4" ALUMINUM SURVEYORS CAP WITH APPROPRIATE MARKINGS IS ASSUMED TO BEAR NO0'44'35"W, A DISTANCE OF 1320.61 FEET.

| IV. | DESCRIPTION | DATE |
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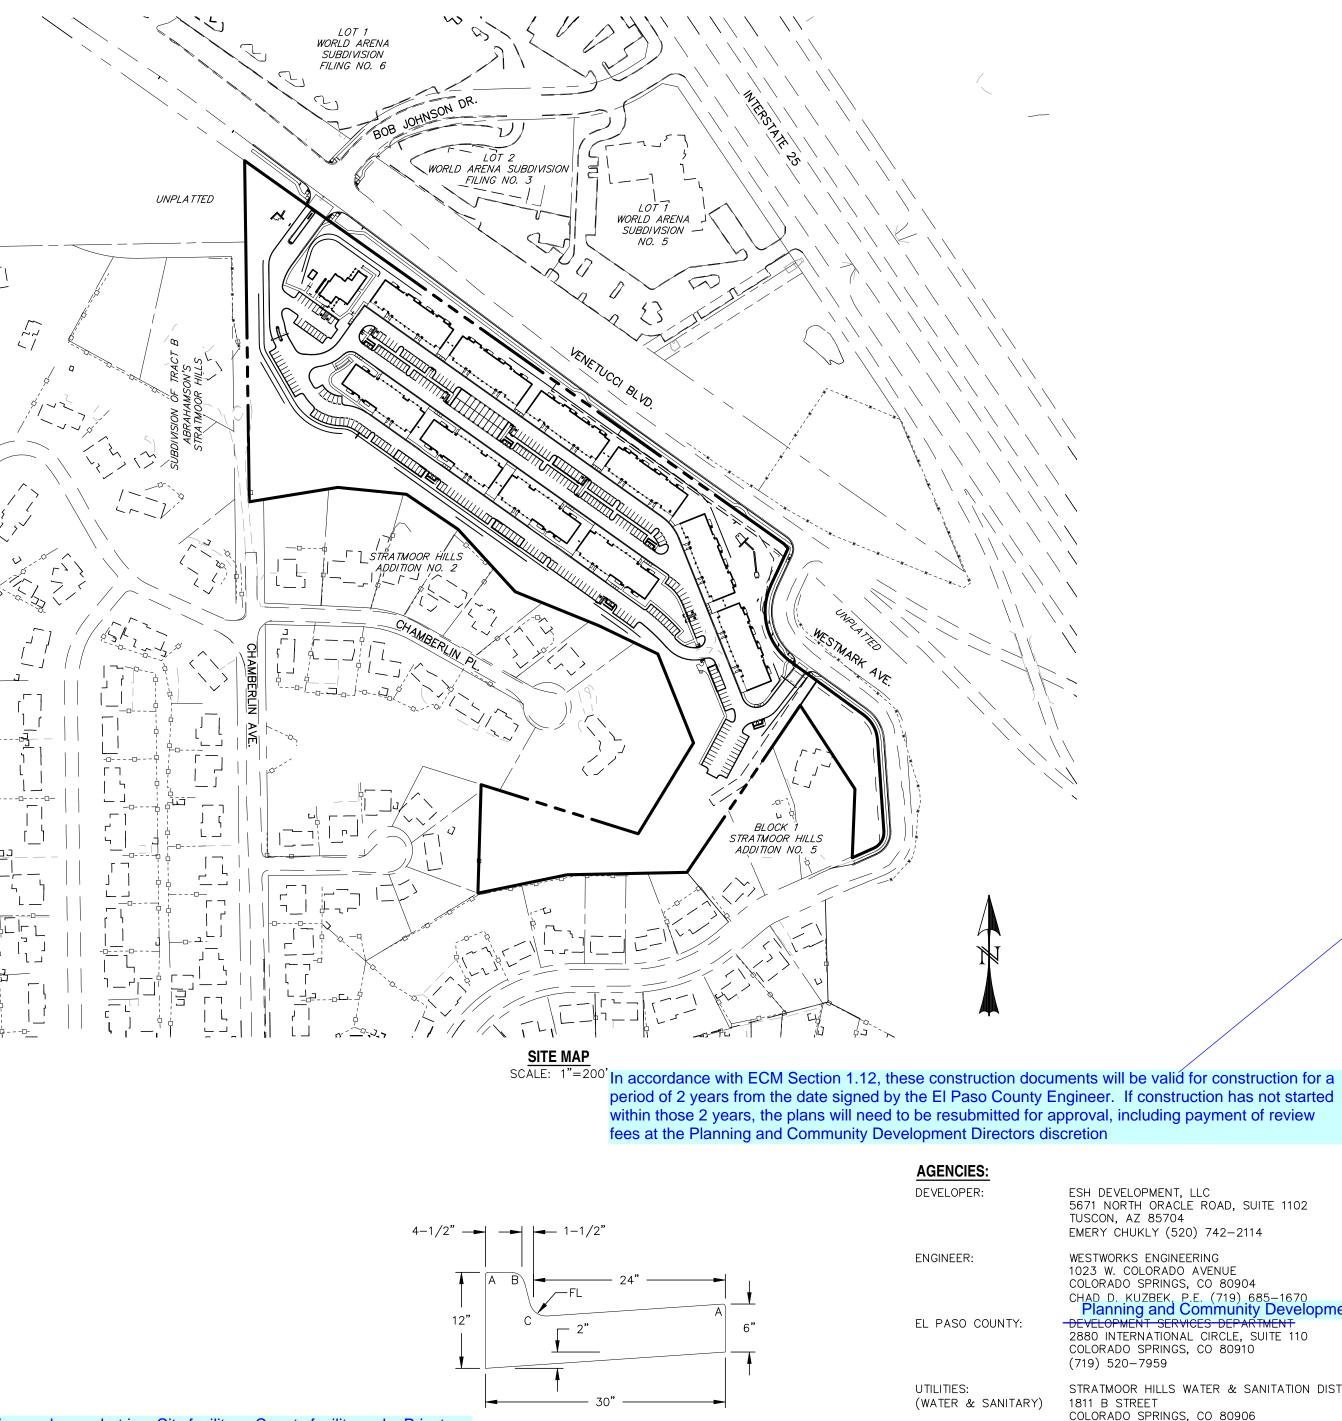


Know what's DelOW Call / 2 hours before you dig. For more details visit: www.call811.com

| Siamy in this construction |
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| acility. Include all items in |
| The City and County will n |
| |

ELDORADO SPRINGS PUBLIC STREET IMPROVEMENT PLANS

EL PASO COUNTY, COLORADO



Clarify in this construction package what is a City facility, a County facility and a Private n this CD set. eed to agree on who owns and mai\ntains facilities.

TYPE A VERTICAL CURB & GUTTER SCALE: N.T.S.

> RADII LEGEND: A = 1/8" TO 1/4" B = 1 - 1/2" C = 1 - 1/2" TO 2" D = 1/2"

UTILITIES: (GAS)


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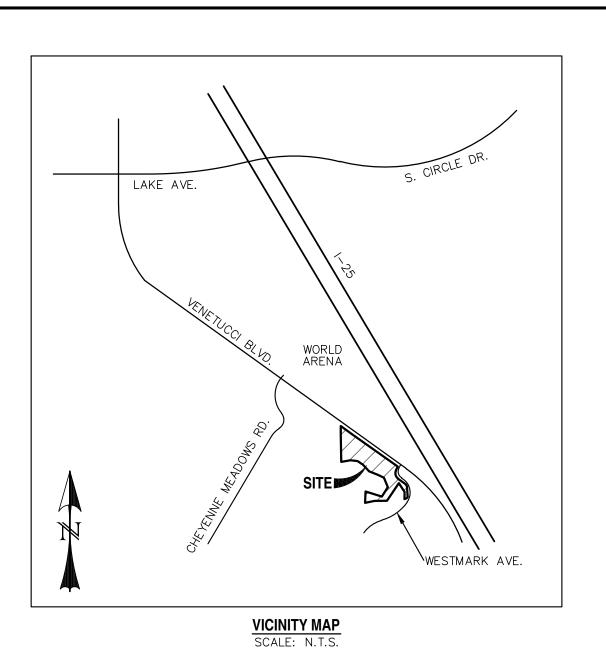
5671 NORTH ORACLE ROAD, SUITE 1102 EMERY CHUKLY (520) 742-2114 WESTWORKS ENGINEERING 1023 W. COLORADO AVENUE COLORADO SPRINGS, CO 80904 CHAD D. KUZBEK, P.E. (719) 685-1670 Planning and Community Development **DEVELOPMENT SERVICES DEPARTMENT** 2880 INTERNATIONAL CIRCLE, SUITE 110 COLORADO SPRINGS, CO 80910 STRATMOOR HILLS WATER & SANITATION DISTRICT

COLORADO SPRINGS, CO 80906 KIRK MEDINA (719) 576–0311 COLORADO SPRINGS UTILITIES 111 S. CASCADE AVENUE

COLORADO SPRINGS, CO 80903 (719) 448-4800 STRATMOOR HILLS FIRE PROTECTION DISTRICT 2160 B STREET

COLORADO SPRINGS, CO 80906 DOTTIE BARRETT (719) 576-1200



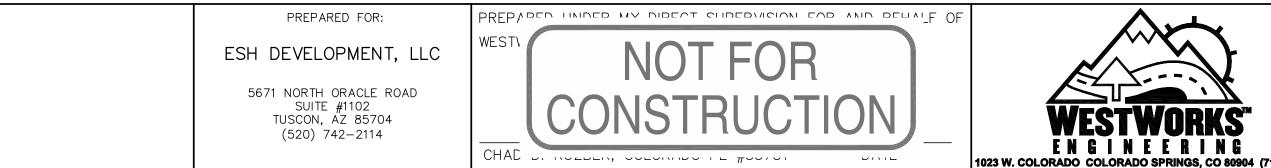

CONSTRUCTION PLANS AND SPECIFICATIONS ENGINEERS STATEMENT:

THESE DETAILED PLANS AND SPECIFICATIONS WERE PREPARED UNDER MY DIRECTION AND SUPERVISION. SAID DETAILED PLANS AND SPECIFICATIONS HAVE BEEN PREPARED ACCORDING TO THE CRITERIA ESTABLISHED BY THE CITY/COUNTY FOR DETAILED DRAINAGE PLANS AND SPECIFICATIONS, AND SAID DETAILED PLANS AND SPECIFICATIONS ARE IN CONFORMITY WITH THE MASTER PLAN OF THE DRAINAGE BASIN. SAID DETAILED PLANS AND SPECIFICATIONS MEET THE PURPOSES WHICH THE PARTICULAR DRAINAGE FACILITY(S) IS DESIGNED. I ACCEPT RESPONSIBILITY FOR ANY LIABILITY CAUSED BY ANY NEGLIGENT ACTS, ERROR OR OMMISSIONS ON MY PART IN PREPARATION OF THE DETAILED PLANS AND SPECIFICATIONS.

CHAD D. KUZBEK, COLORADO PE #35751

EL PASO COUNTY (WESTMARK AVENUE ONLY):

COUNTY PLAN REVIEW IS PROVIDED ONLY FOR GENERAL CONFORMANCE WITH COUNTY DESIGN CRITERIA. THE COUNTY IS NOT RESPONSIBLE FOR THE ACCURACY AND ADEQUACY OF THE DESIGN, DIMENSIONS, AND/OR ELEVATIONS WHICH SHALL BE CONFIRMED AT THE JOB SITE. THE COUNTY THROUGH THE APPROVAL OF THIS DOCUMENT ASSUMES NO RESPONSIBILITY FOR COMPLETENESS AND/OR ACCURACY OF THIS DOCUMENT.

FILED IN ACCORDANCE WITH THE REQUIREMENTS OF THE EL PASO COUNTY LAND DEVELOPMENT CODE, DRAINAGE CRITERIA, AND ENGINEERING CRITERIA MANUAL AS AMENDED.

JENNIFER IRVINE, P.E. COUNTY ENGINEER/ECM ADMINISTRATOR

OWNER STATEMENT:

THE OWNER WILL COMPLY WITH THE REQUIREMENTS OF THE STREET IMPROVEMENT PLANS.

OWNER NAME: DATE LEGEND EXISTING PROPOSED (P) FUTURE (F) BEGIN TRANSITION END TRANSITION FΤ CURB RETURN CR POC POINT ON CURVE POINT ON CURB RETURN POCR POINT OF REVERSE CURVATURE PRC EDGE OF ASPHALT EOA POINT OF CURVATURE PC PТ POINT OF TANGENCY BOUNDARY _____ RIGHT-OF-WAY ____ _ _ _ ___ LOT LINE _____ EASEMENT _____ (E) STORM SEWER

SHEET INDEX:

(P) STORM SEWER, INLET, MH

TITLE SHEET STREET IMPROVEMENT PLAN - WESTMARK AVENUE STREET IMPROVEMENT PLAN - VENETUCCI BOULEVARD SIGNAGE & STRIPING PLAN - VENETUCCI BOULEVARD SIGNAGE & STRIPING PLAN - WESTMARK AVENUE




| | ELDORADO SPRINGS | 00.11.5 | DRAWN BY: CDK |
|----------------|--------------------------|----------------|------------------|
| | | SCALE: 1"=200' | 06/27/19 |
| | STREET IMPROVEMENT PLANS | JOB NUMBER | SHEET |
| (719) 685-1670 | TITLE SHEET | 91807 | SI1 OF 5 |




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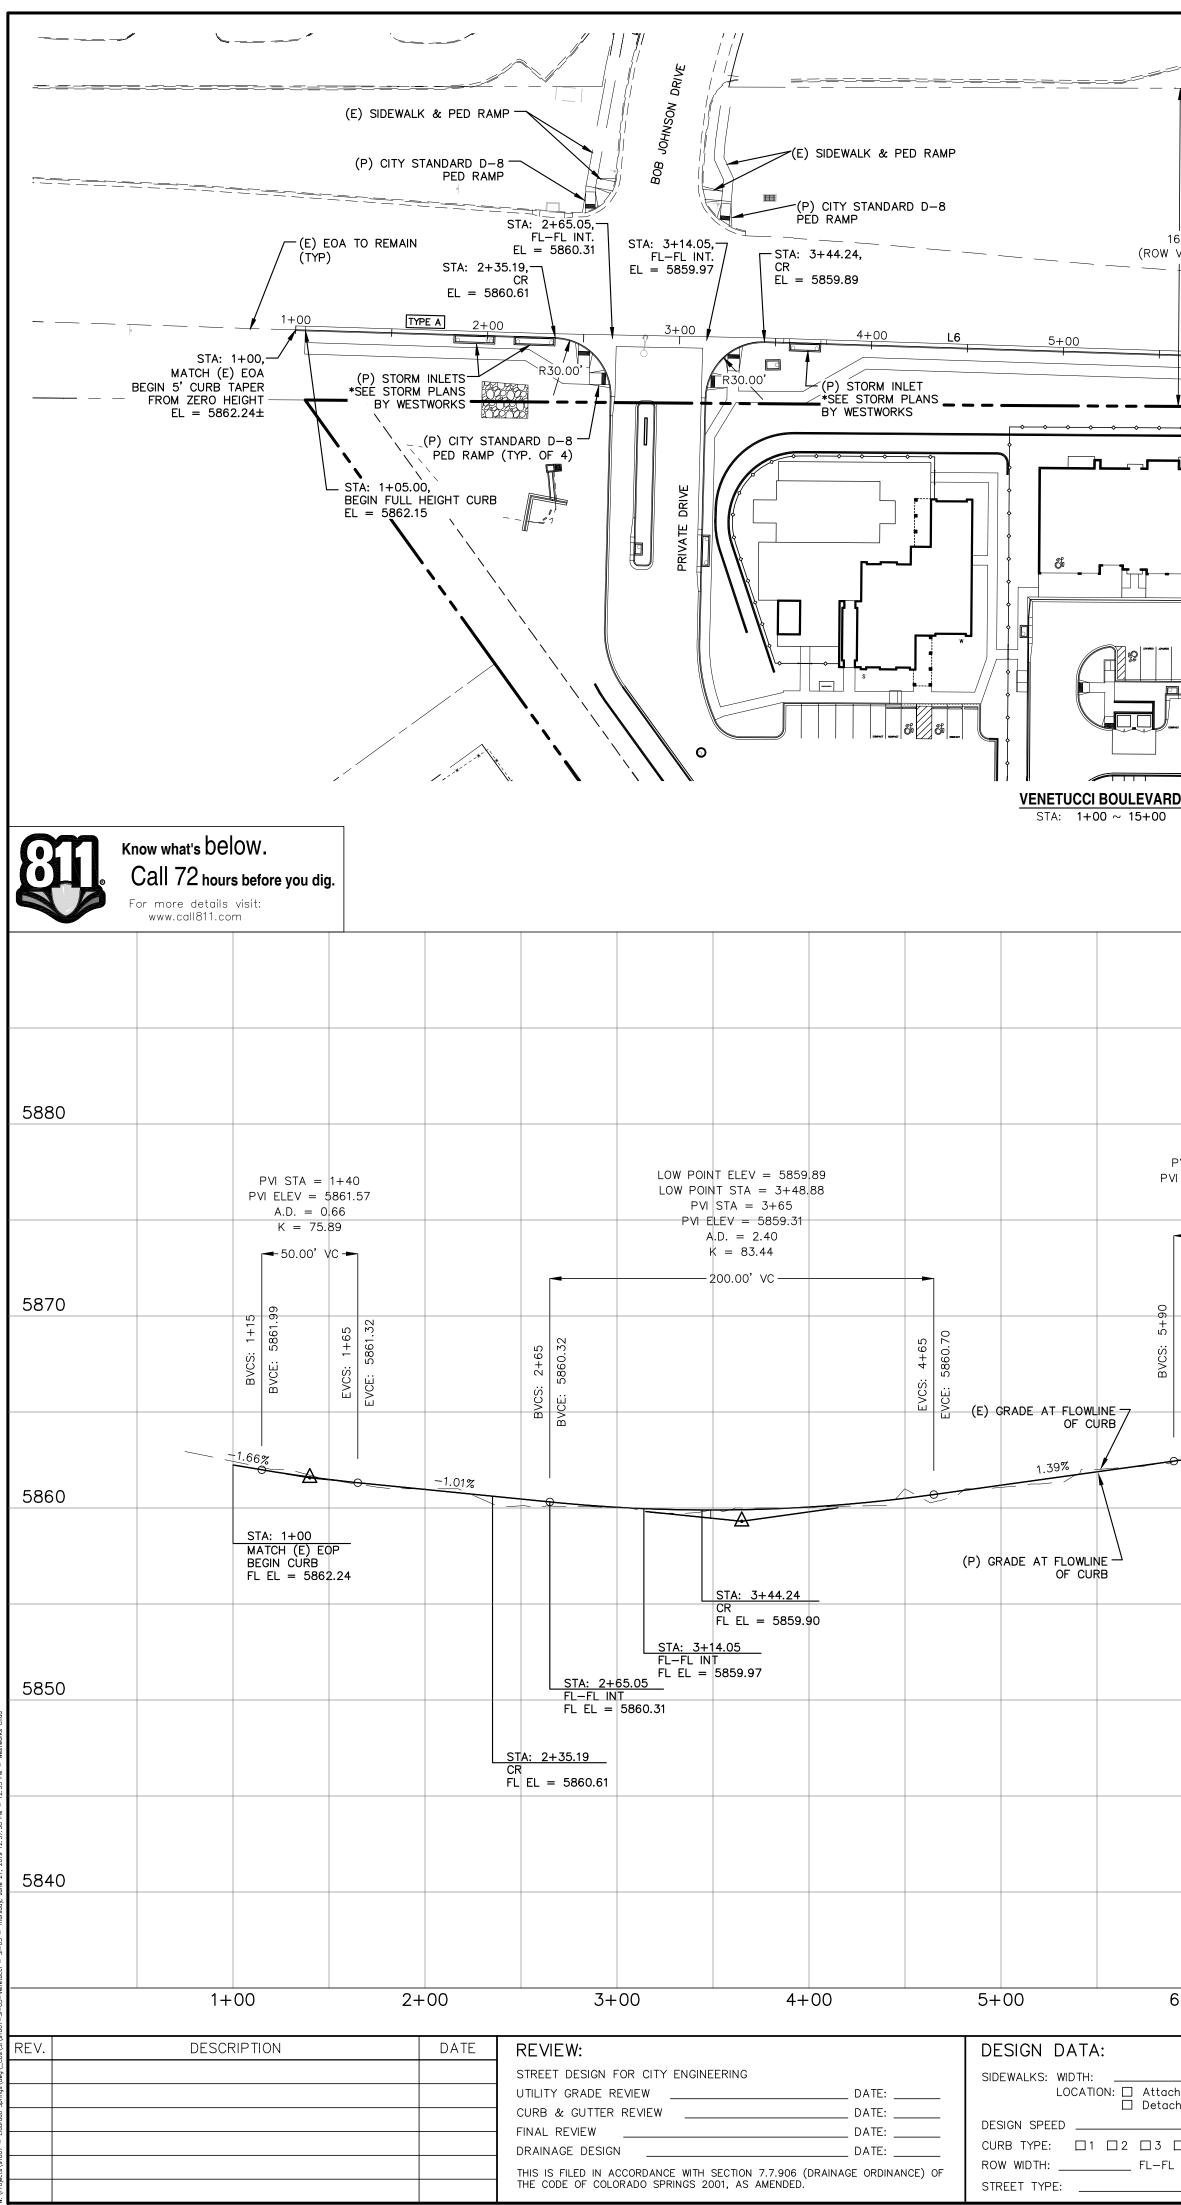


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| | | | EVCS: 9+17 EVCE: 5898.62 | | | | | | | | |
| | | | | STA: 9+70.04 MATCH (E) EOA FL EL = 5904.75± | | | | | | | 5900 |
| | | | STA: 9- END C& FL EL = | - <u>20.95</u> G • 5899.05 | | | | | | | |
| | | | | | | | | | | | 5890 |
| BVCS: 5+97 BVCE: 5874.92 | | | | | | | | | | | 5880 |
| | | | | | | | | | | | |
| | | | | | | | | | | | 5870 |
| 6+00 | 7+00 | 8+00 | 9+00 | 10+00 | 11+00 | 12+00 | 13+00 | 14+00 | 15+00 | 16+00 | |
| Attached THICK Detached COMPO | : HMA D BASE D (NESS: ESH | PREPARED FOR: DEVELOPMENT, LLC | WESTI | NOT FOR | | | Ž | ELDORADO SPF | RINGS | 1 = 50 | DRAWN BY: CDK DATE: 06/27/19 |
| □ 3 □ 4 □ 5 FL−FL SUBGR, CHEM | BASE 56° ADE STABILIZATION: | 71 NORTH ORACLE ROAD SUITE #1102 TUSCON, AZ 85704 (520) 742–2114 | | | | WESTWOR ENGINEER W. COLORADO COLORADO SPRINGS, | KS™ NG CO 80904 (719) 685-1670 | STREET IMPROVEME WESTMARK AV | | JOB NUMBER 91807 | SHEET SI2 OF 5 |

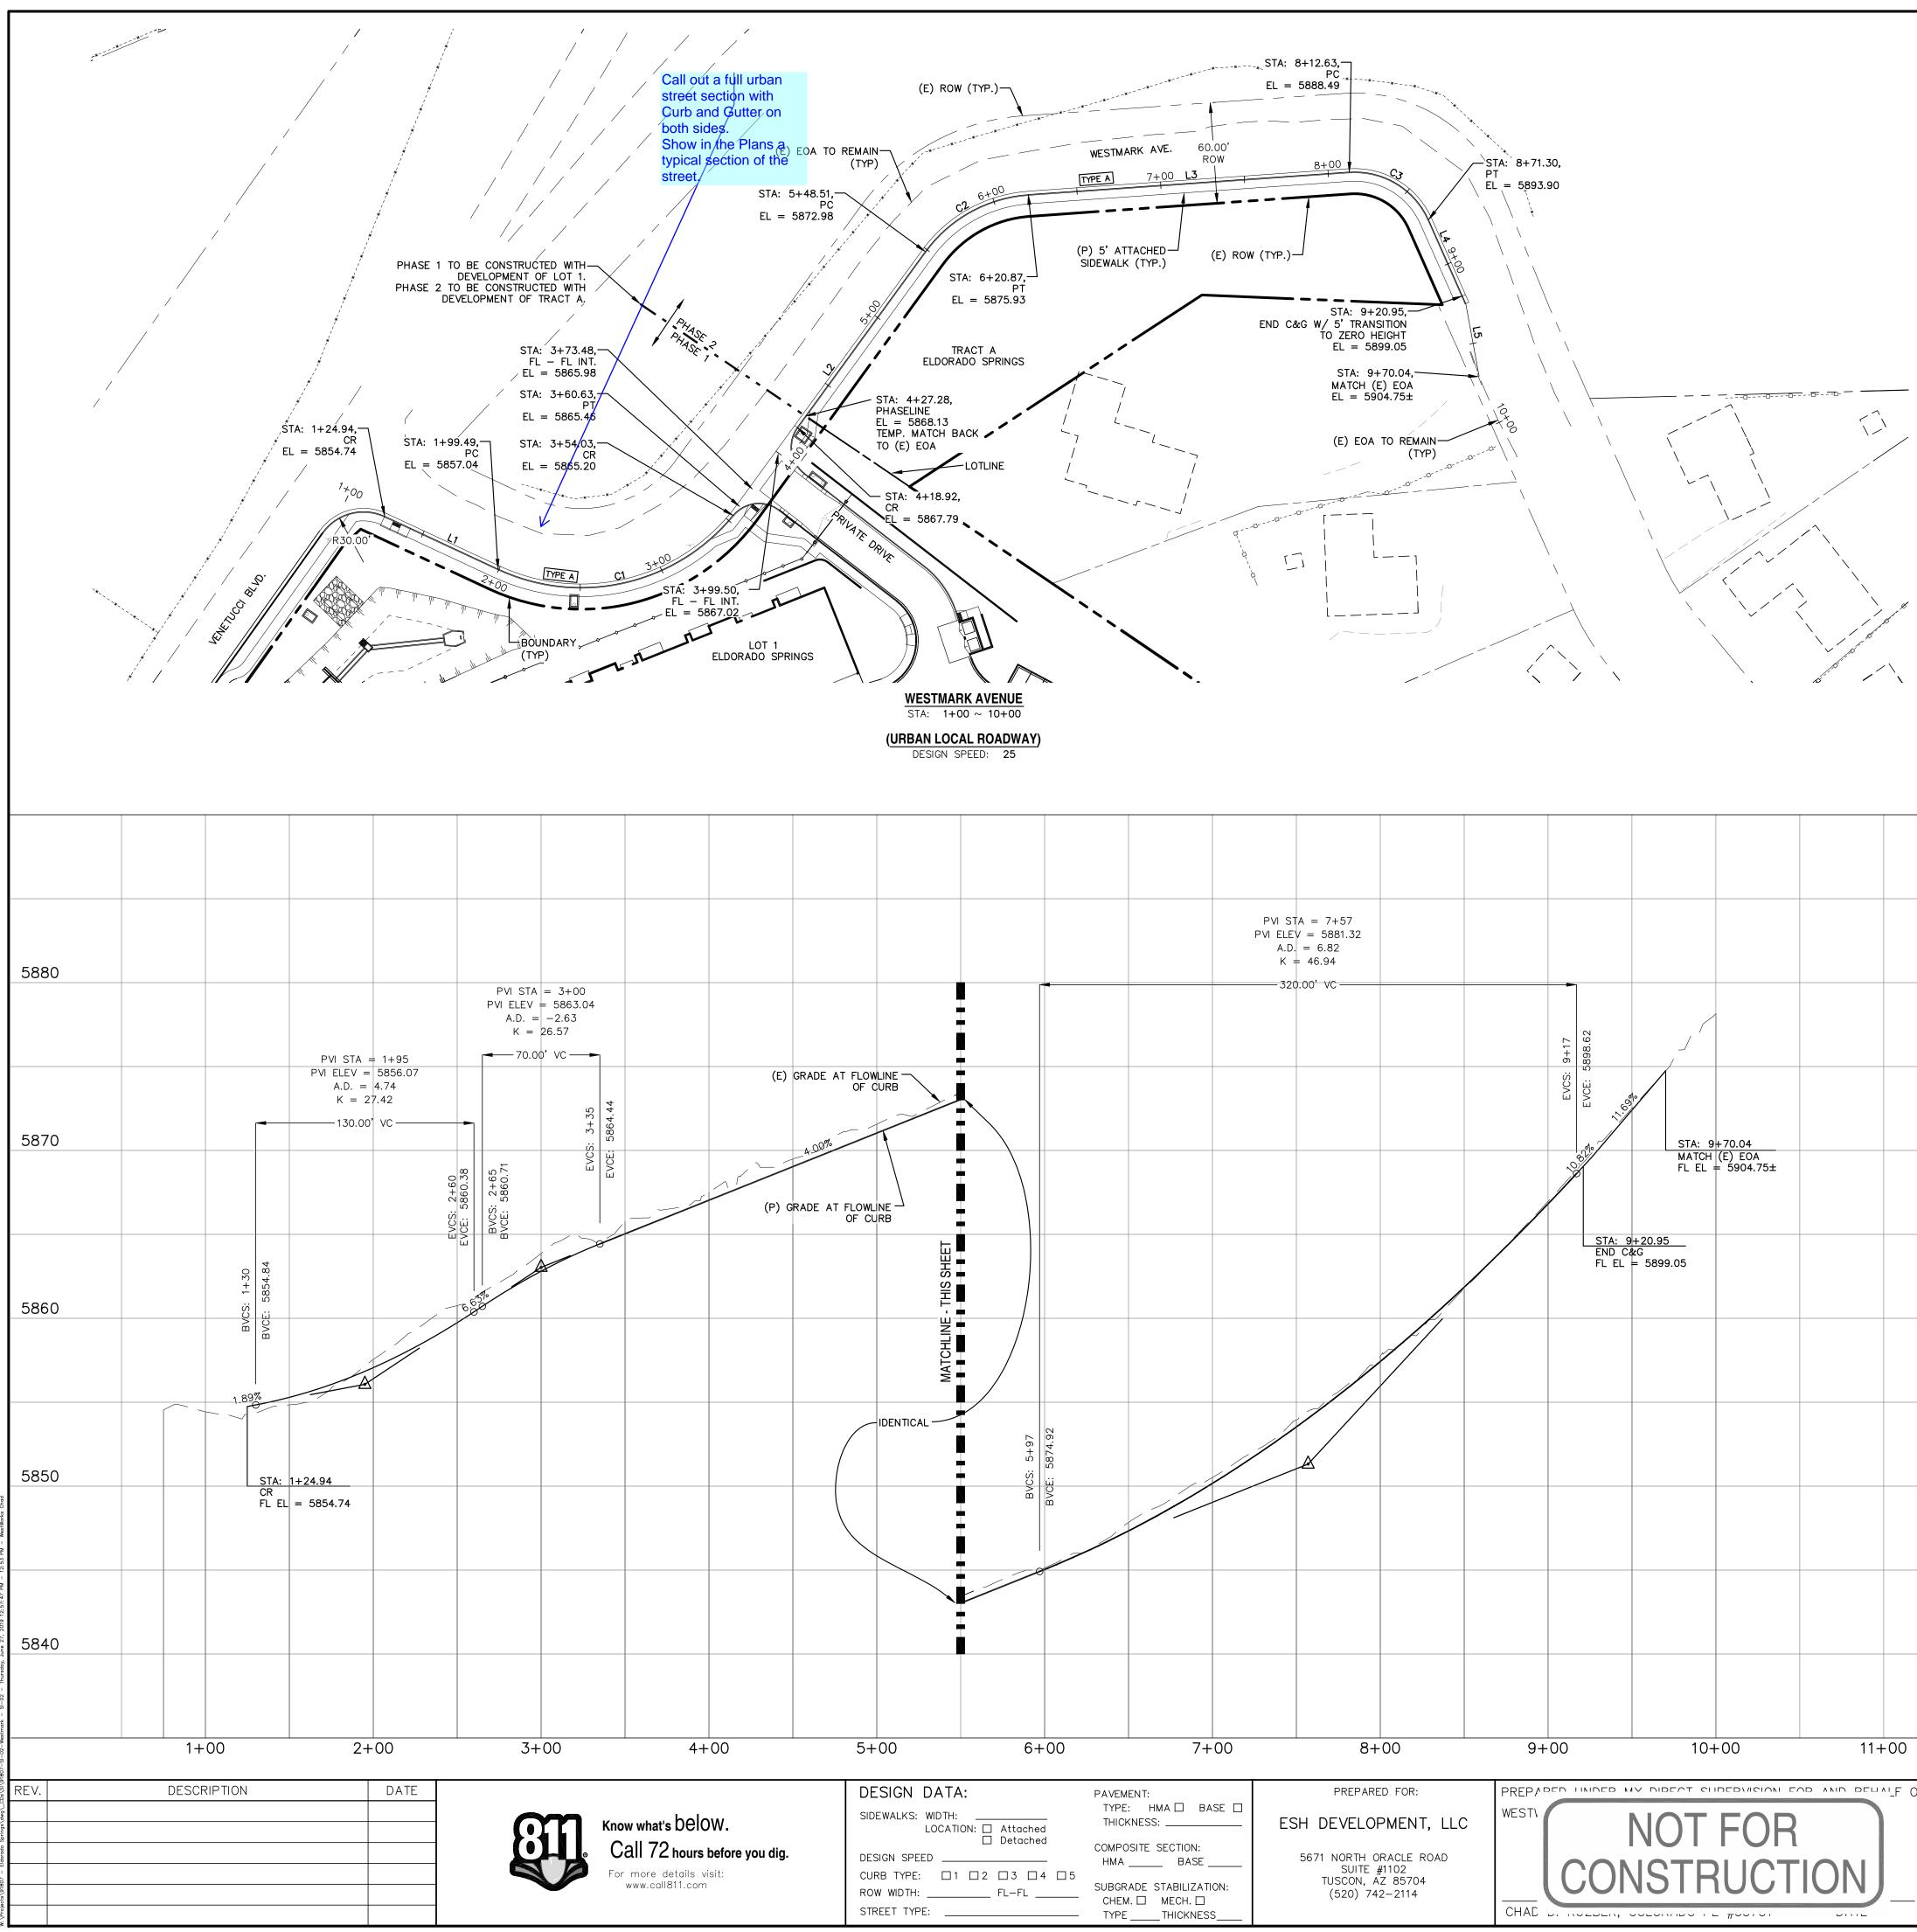



| LIN | E TABLE – FL | - |
|------|----------------------|----------|
| LINE | BEARING | DISTANCE |
| L1 | S24 ° 57'21"W | 74.55 |
| L2 | S53*57'15"E | 187.88 |
| L3 | S04°00'16"E | 191.76 |
| L4 | S66'02'05"W | 54.65 |
| L5 | S79 · 32'48"W | 44.09 |
| L5 | S79'32'48"W | 44.09 |

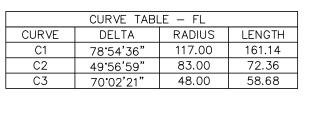





| | NESTIMARK AVE. |
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| LINE TABLE – FL CURVE TABLE – FL LINE BEARING DISTANCE L6 S53'18'36"E 680.61 C4 1'05'26" 24069.82 458.14 | 50 100 CONTAL SCALE: $1'' = 50'$ RTICAL SCALE: $1'' = 5'$ |
| PVI STA = 6+15 PVI STA = 7+60. PVI STA = 6+15 PVI STA = 7+60. PVI ELEV = 5863.73 A.D. = -1.63 | 5880 |
| A.D. = -0.83 K = 61.21 K = 59.97 K = 61.21 V = 50.00' VC VC V = 000' VC VC V = 100.00' VC VC VC VC V = 100.00' VC VC VC VC VC V = 100.00' VC VC VC | 5870 |
| (E) GRADE AT FLOWLINE OF CURB 0.56% | 5860 |
| STA: 14+81.06 FL EL = 5855.02 | |
| | 5840 |
| 5+00 6+00 7+00 8+00 9+00 10+00 11+00 12+00 13+00 14+00 15+00 DESIGN DATA: SIDEWALKS: WIDTH: LOCATION: PAVEMENT: Intickness: PREPARED FOR: THICKNESS: PREPARED FOR: ESH DEVELOPMENT, LLC PREPARED FOR: ESH DEVELOPMENT, LLC PREPARED FOR: THICKNESS: PREPARED FOR: ESH DEVELOPMENT, LLC PREPARED FOR: ESH DEVELOPMENT, LLC PREPARED FOR: ESH DEVELOPMENT, LLC FOR FOR ELDORADO SPRINGS | 16+00 DESIGNED BY: MGP DRAWN BY: CDK SCALE: 1"=50' DATE: 06/27/19 |
| DESIGN SPEED | JOB NUMBERSHEET91807SI3 OF 5 |

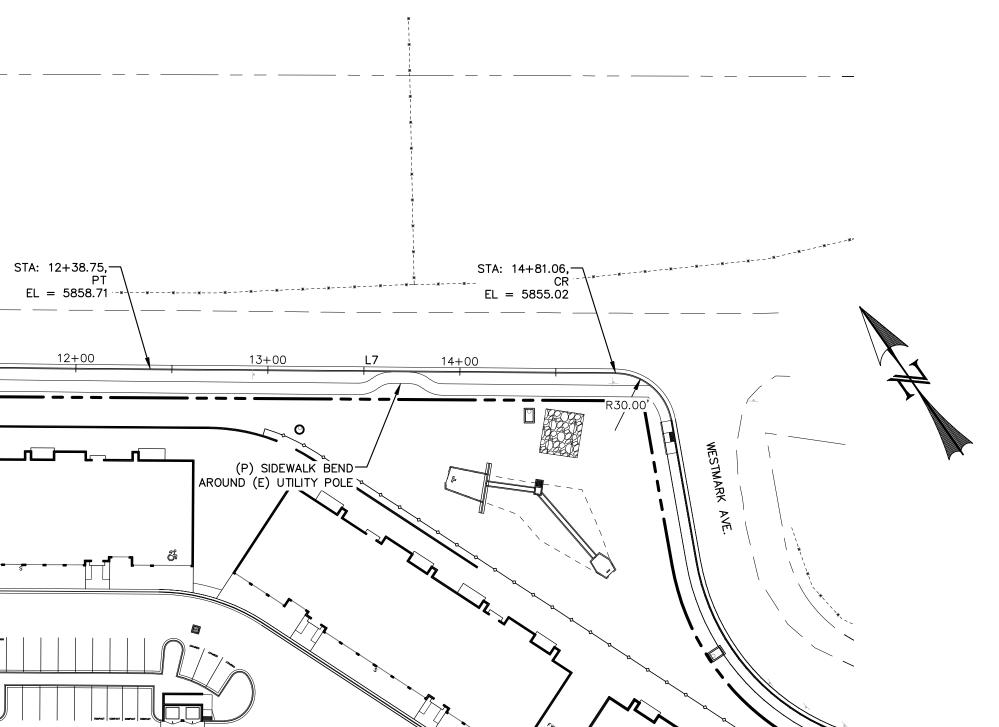

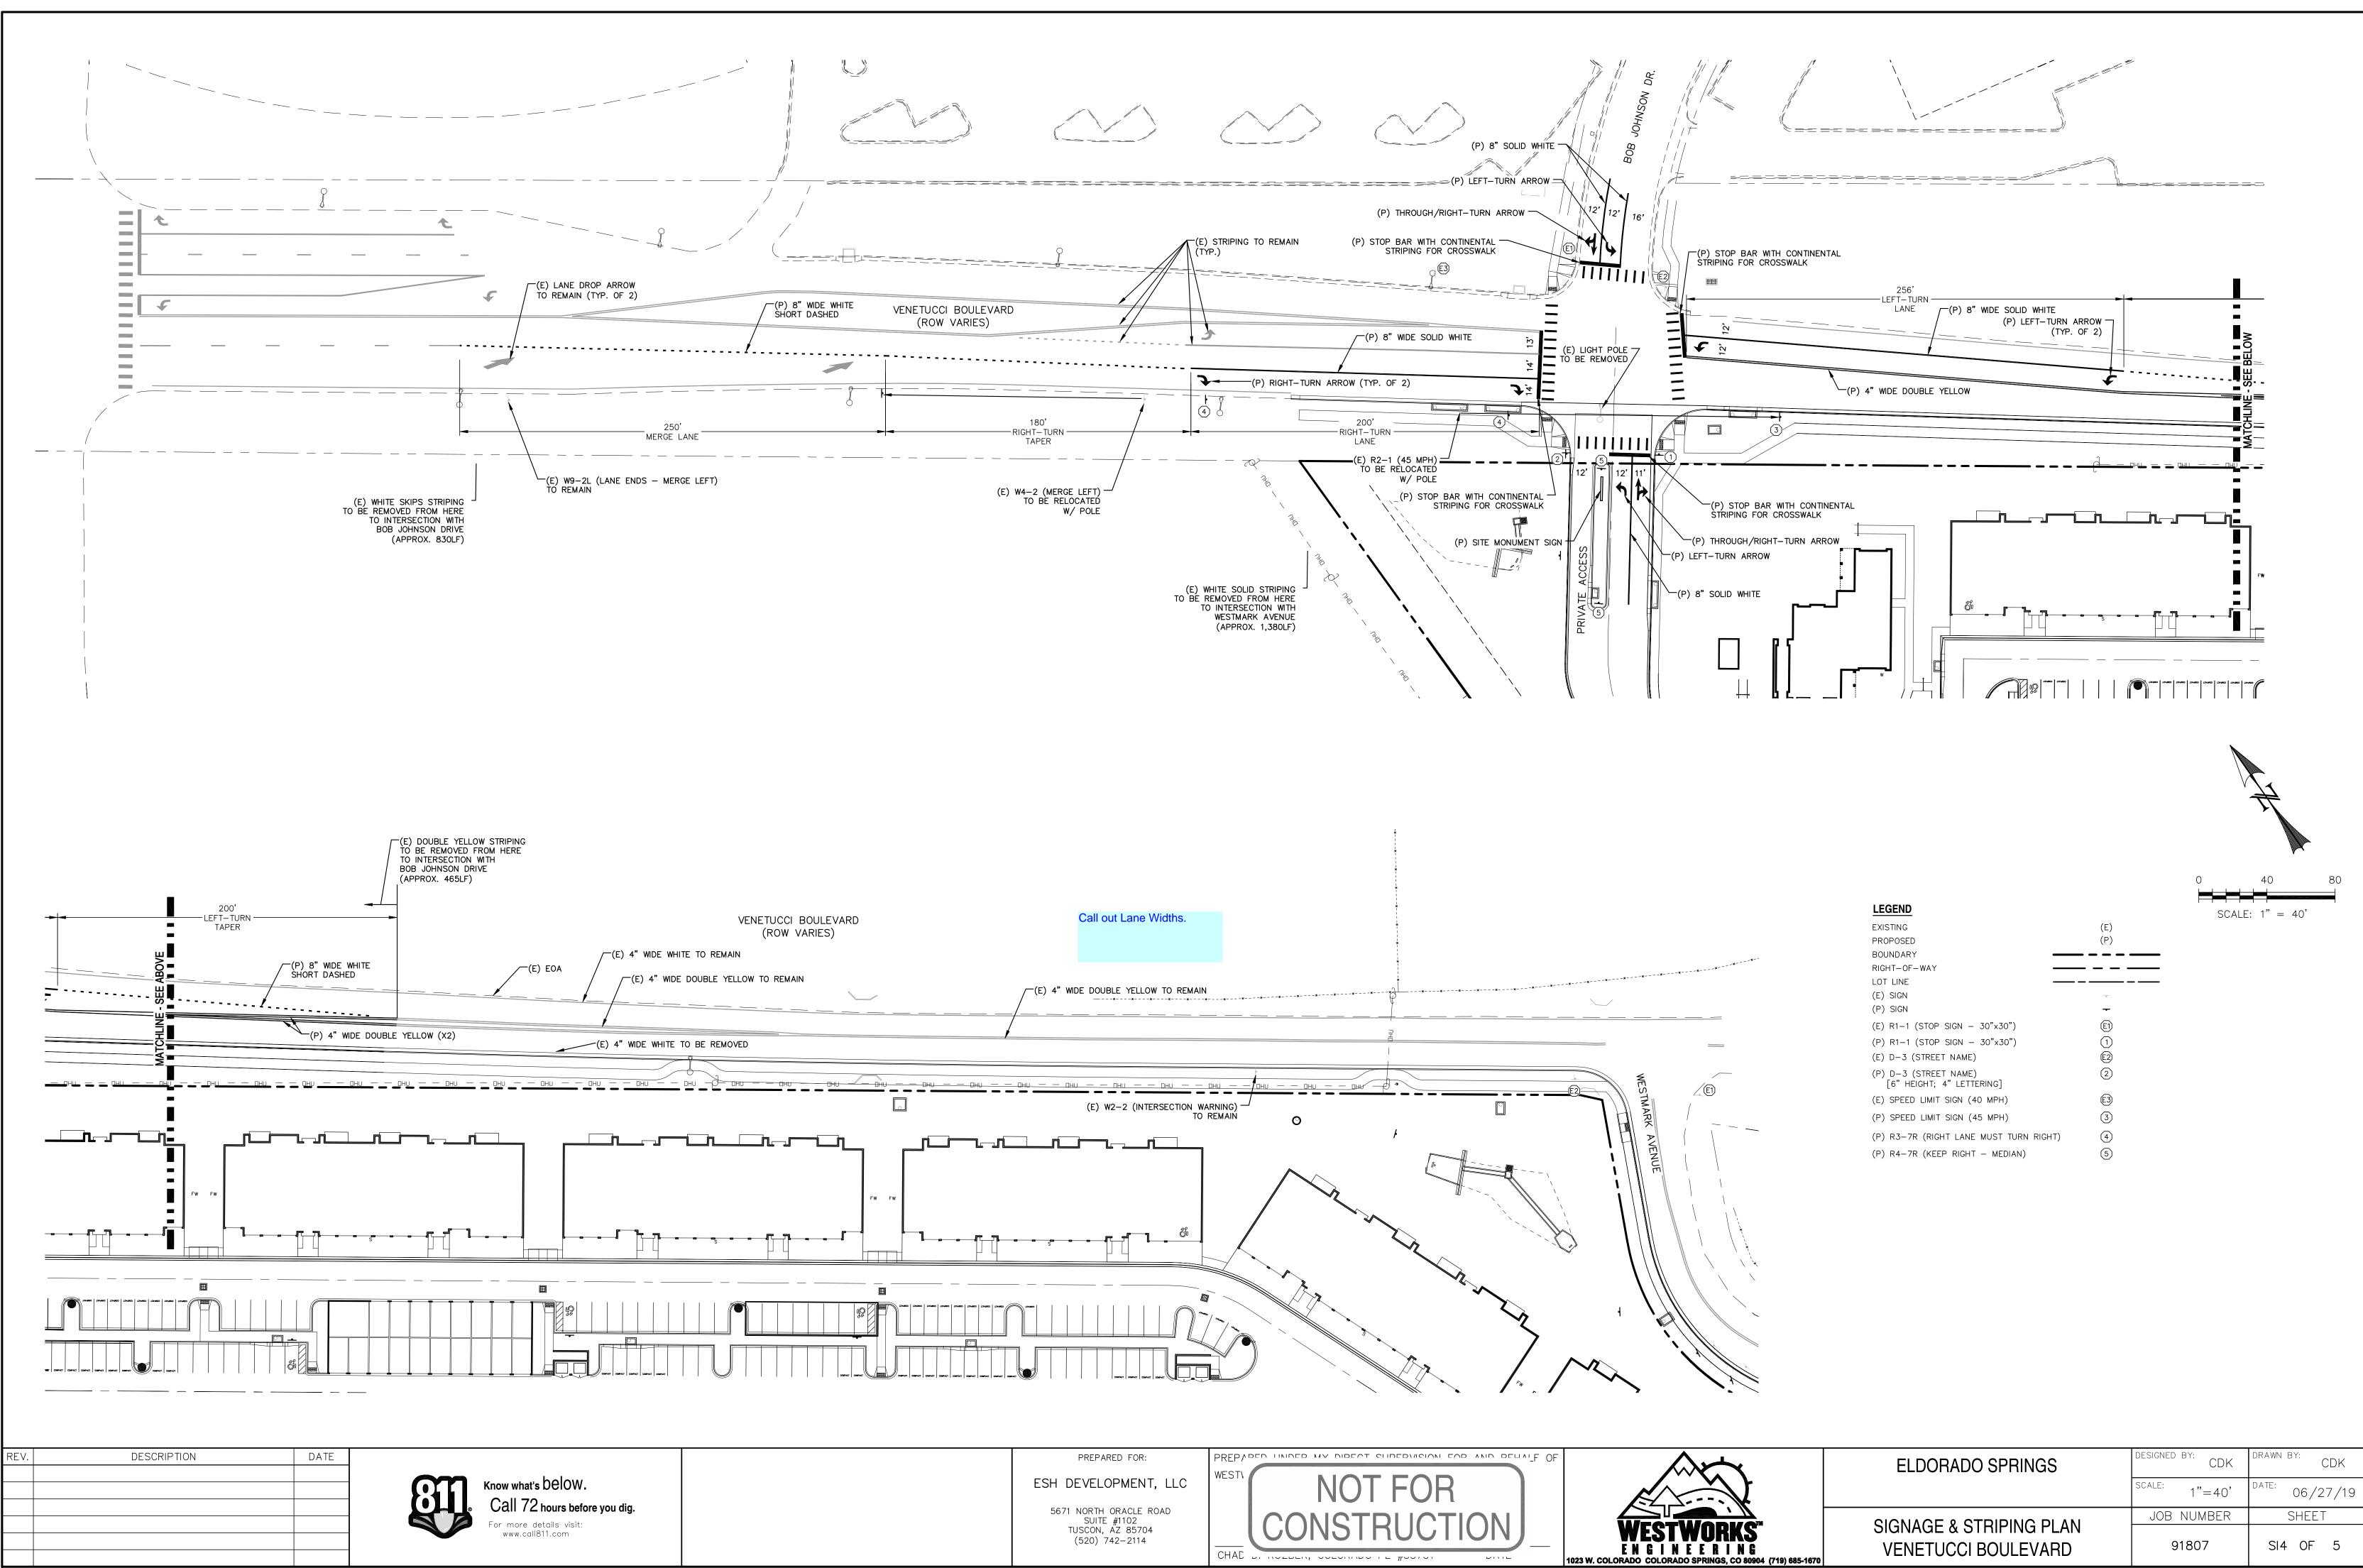


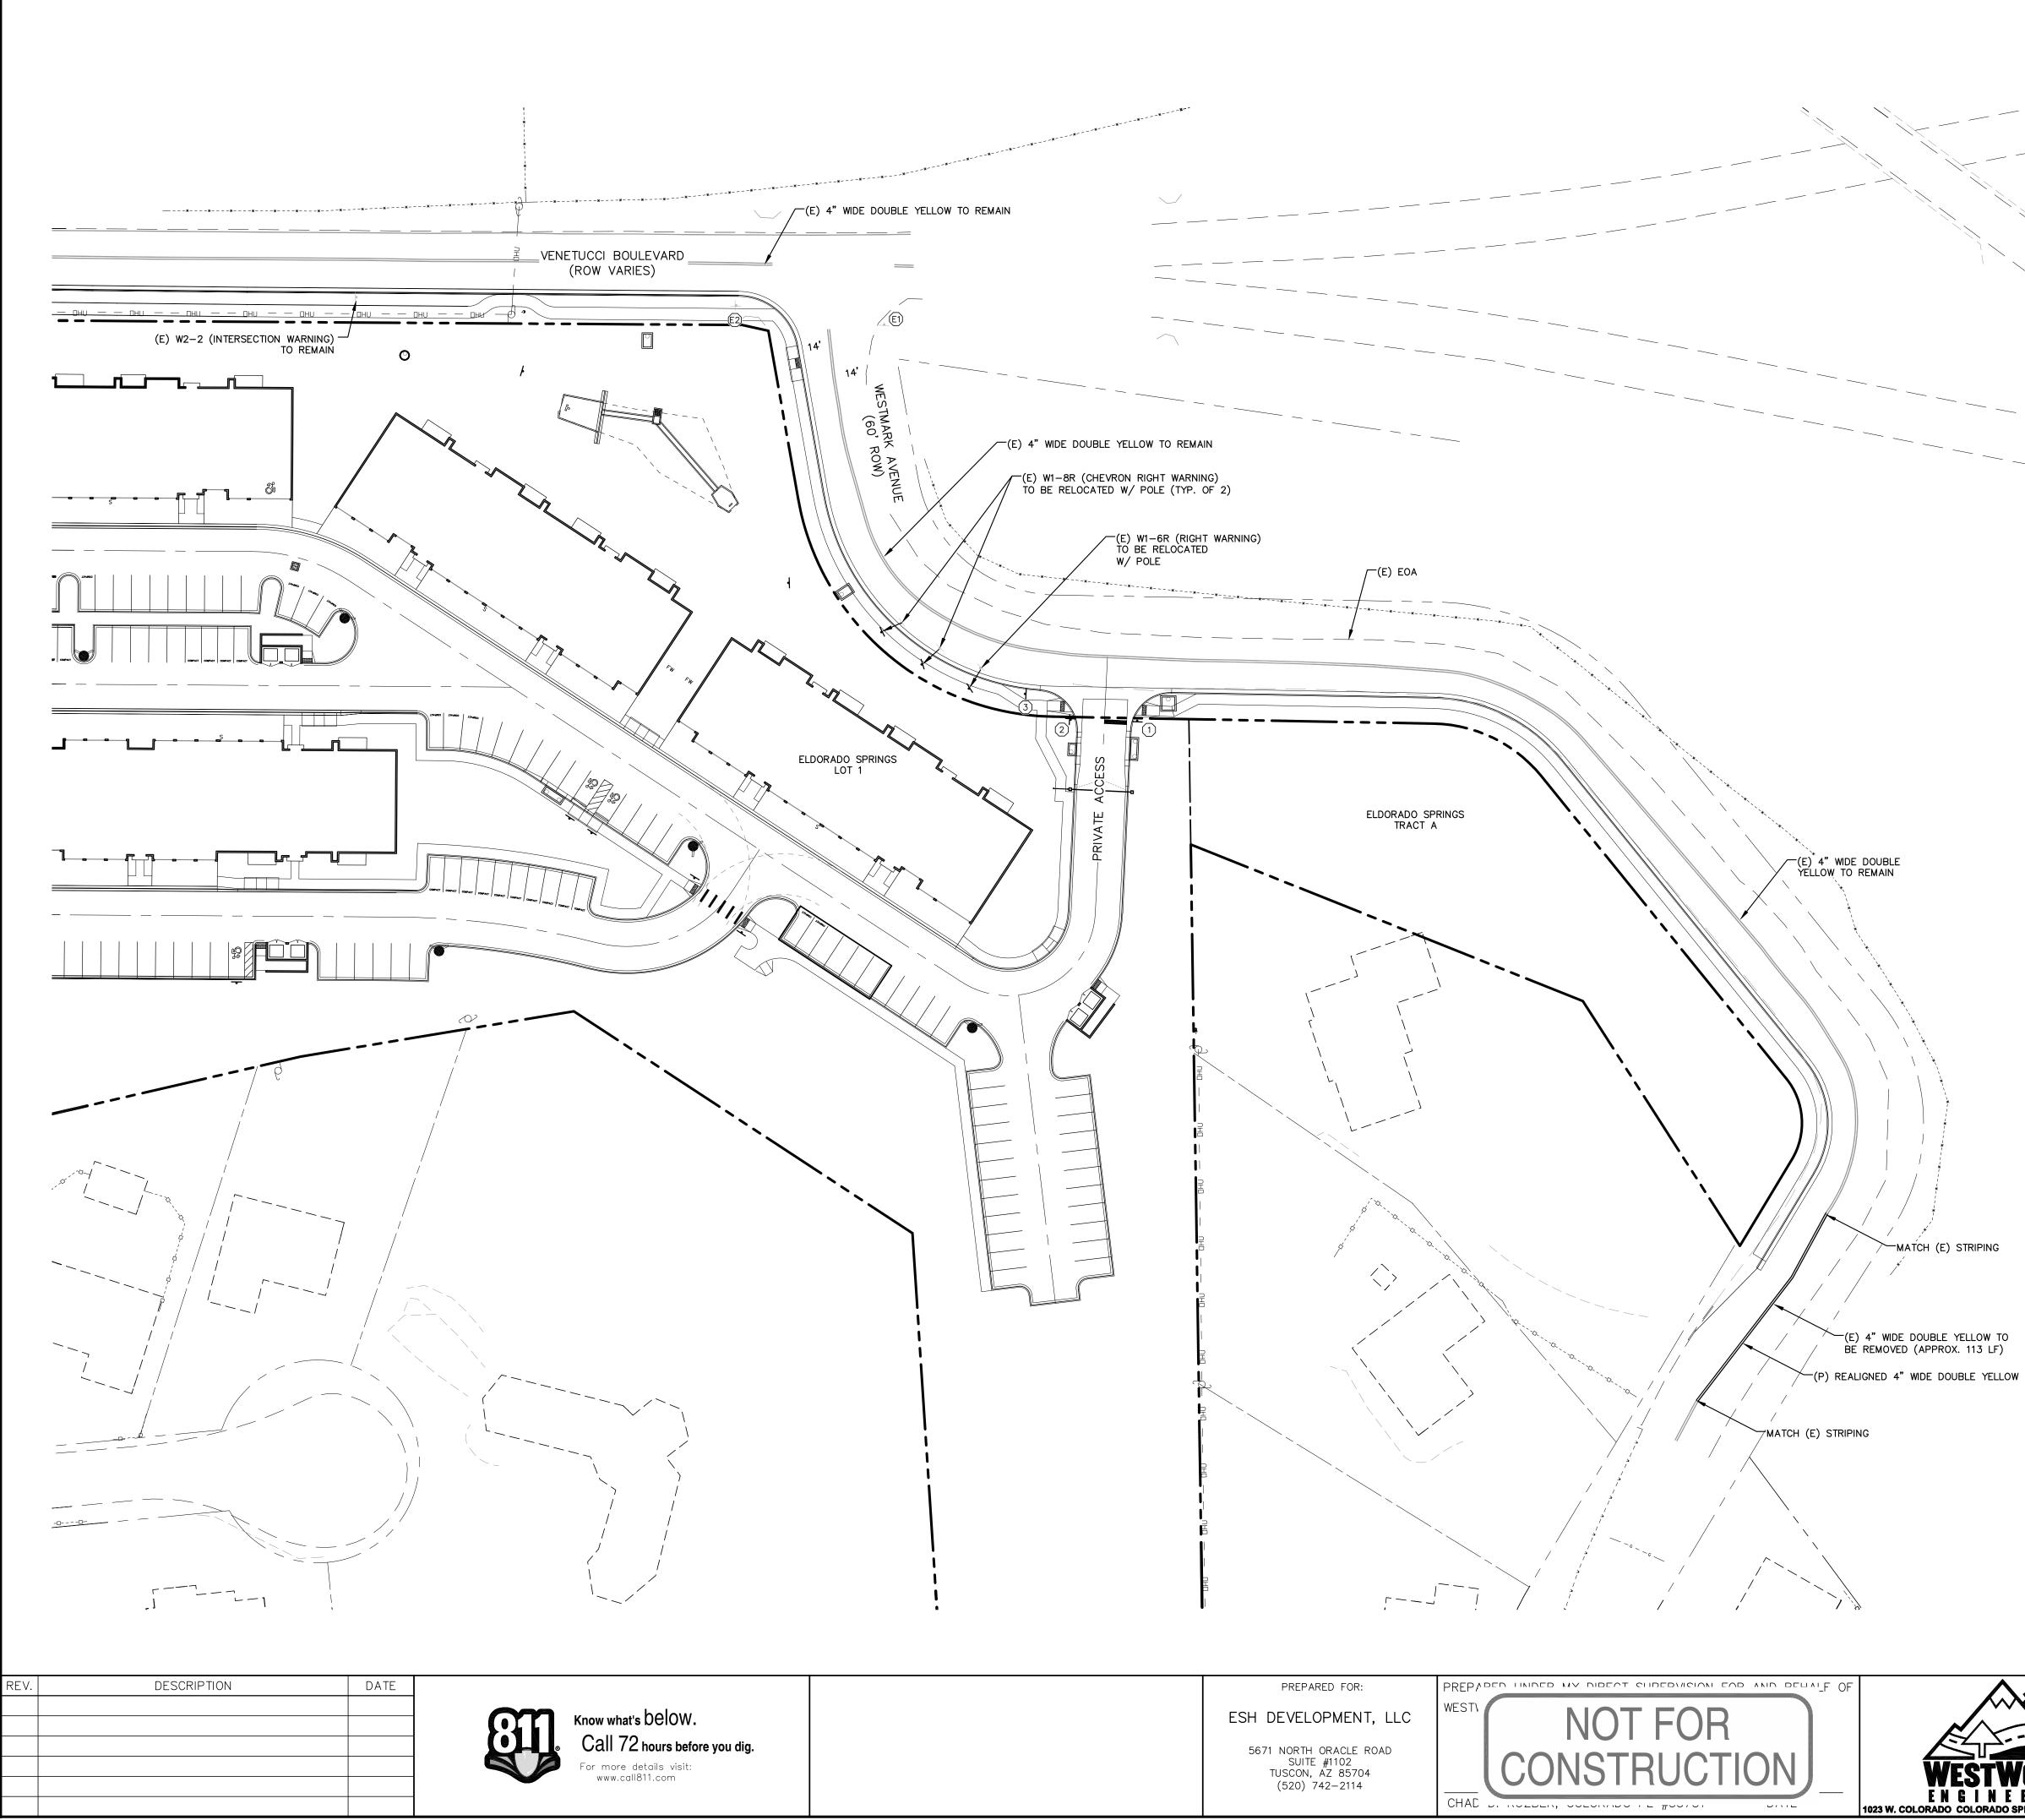

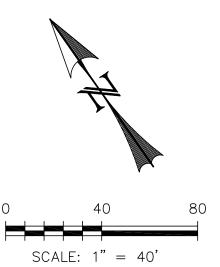

LEGEND EXISTING PROPOSED BOUNDARY RIGHT-OF-WAY LOT LINE

(E) SIGN (P) SIGN (E) R1-1 (STOP SIGN - 30"x30") (P) R1-1 (STOP SIGN - 30"x30") (E) D-3 (STREET NAME) (P) D-3 (STREET NAME) [6" HEIGHT; 4" LETTERING] (P) SPEED LIMIT SIGN (25 MPH)

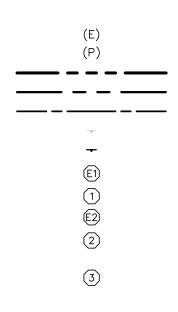

| | ELDORADO SPRINGS | DESIGNED BY: CDK | drawn by: CDK |
|---|--|------------------|------------------|
| | | SCALE: 1"=40' | DATE: 06/27/19 |
| | | JOB NUMBER | SHEET |
| STWORKS [™] I N E E R I N G olorado springs, co 80904 (719) 685-1670 | SIGNAGE & STRIPING PLAN WESTMARK AVENUE | 91807 | SI5 OF 5 |

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Jpdate notes to the latest version (updated 7/2019 see PDC Engineering

GRADING NOTES:

- 1. CONSTRUCTION MAY NOT COMMENCE UNTIL A CONSTRUCTION PERMIT IS OBTAINED FROM DEVELOPMENT SERVICES AND A PRECONSTRUCTION CONFERENCE IS HELD WITH DEVELOPMENT SERVICES INSPECTIONS.
- 2. STORMWATER DISCHARGES FROM CONSTRUCTION SITES SHALL NOT CAUSE OR THREATEN TO CAUSE POLLUTION, CONTAMINATION, OR DEGRADATION OF STATE WATERS. ALL WORK AND EARTH DISTURBANCE SHALL BE DONE IN A MANNER THAT MINIMIZES POLLUTION OF ANY ON-SITE OR OFF SITE WATERS, INCLUDING WETLANDS
- NOTWITHSTANDING ANYTHING DEPICTED IN THESE PLANS IN WORDS OR GRAPHIC REPRESENTATION, ALL DESIGN AND CONSTRUCTION RELATED TO ROADS, STORM DRAINAGE AND EROSION CONTROL SHALL CONFORM TO THE STANDARDS AND REQUIREMENTS OF THE MOST RECENT VERSION OF THE RELEVANT ADOPTED EL PASO COUNTY STANDARDS, INCLUDING THE LAND DEVELOPMENT CODE, THE ENGINEERING CRITERIA MANUAL, THE DRAINAGE CRITERIA MANUAL, AND THE DRAINAGE CRITERIA MANUAL VOLUME 2. ANY DEVIATIONS FROM REGULATIONS AND STANDARDS MUST BE REQUESTED, AND APPROVED, IN WRITING.
- 4. A SEPARATE STORMWATER MANAGEMENT PLAN (SMWP) FOR THIS PROJECT SHALL BE COMPLETED AND AN EROSION AND STORMWATER QUALITY CONTROL PERMIT (ESQCP) ISSUED PRIOR TO COMMENCING CONSTRUCTION. DURING CONSTRUCTION THE SWMP IS THE RESPONSIBILITY OF THE DESIGNATED STORMWATER MANAGER SHALL BE LOCATED ON SITE AT ALL TIMES AND SHALL BE KEPT UP TO DATE WITH WORK PROGRESS AND CHANGES IN THE FIELD.
- 5. ONCE THE ESQCP HAS BEEN ISSUED, THE CONTRACTOR MAY INSTALL THE INITIAL STAGE EROSION AND SEDIMENT CONTROL BMPS AS INDICATED ON THE GEC. A PRECONSTRUCTION MEETING BETWEEN THE CONTRACTOR, ENGINEER, AND EL PASO COUNTY WILL BE HELD PRIOR TO ANY CONSTRUCTION. IT IS THE RESPONSIBILITY OF THE APPLICANT TO COORDINATE THE MEETING TIME AND PLACE WITH COUNTY DSD INSPECTIONS STAFE
- SOIL EROSION CONTROL MEASURES FOR ALL SLOPES, CHANNELS, DITCHES, OR ANY DISTURBED LAND AREA SHALL BE COMPLETED WITHIN 21 CALENDAR DAYS AFTER FINAL GRADING, OR FINAL EARTH DISTURBANCE, HAS BEEN COMPLETED. DISTURBED AREAS AND STOCKPILES WHICH ARE NOT AT FINAL GRADE BUT WILL REMAIN DORMANT FOR LONGER THAN 30 DAYS SHALL ALSO BE MULCHED WITHIN 21 DAYS AFTER INTERIM GRADING. AN AREA THAT IS GOING TO REMAIN IN AN INTERIM STATE FOR MORE THAN 60 DAYS SHALL ALSO BE SEEDED. ALL TEMPORARY SOIL FROSION CONTROL MEASURES AND BMPS SHALL BE MAINTAINED UNTIL PERMANENT SOIL FROSION CONTROL MEASURES ARE IMPLEMENTED AND ESTABLISHE
- 7. TEMPORARY SOIL EROSION CONTROL FACILITIES SHALL BE REMOVED AND EARTH DISTURBANCE AREAS GRADED AND STABILIZED WITH PERMANENT SOIL EROSION CONTROL MEASURES PURSUANT TO STANDARDS AND SPECIFICATION PRESCRIBED IN THE DCM VOLUME II AND THE ENGINEERING CRITERIA MANUAL (ECM) APPENDIX I.
- 8. ALL PERSONS ENGAGED IN EARTH DISTURBANCE SHALL IMPLEMENT AND MAINTAIN ACCEPTABLE SOIL EROSION AND SEDIMENT CONTROL MEASURES INCLUDING BMPS IN CONFORMANCE WITH THE EROSION CONTROL TECHNICAL STANDARDS OF THE DRAINAGE CRITERIA MANUAL (DCM) VOLUME II AND IN ACCORDANCE WITH THE STORMWATER MANAGEMENT PLAN (SWMP).
- 9. ALL TEMPORARY EROSION CONTROL FACILITIES INCLUDING BMPS AND ALL PERMANENT FACILITIES INTENDED TO CONTROL EROSION OF ANY EARTH DISTURBANCE OPERATIONS. SHALL BE INSTALLED AS DEFINED IN THE APPROVED PLANS, THE SWMP AND THE DCM VOLUME II AND MAINTAINED THROUGHOUT THE DURATION OF THE EARTH DISTURBANCE OPERATION.
- 10. ANY EARTH DISTURBANCE SHALL BE CONDUCTED IN SUCH A MANNER SO AS TO EFFECTIVELY REDUCE ACCELERATED SOIL EROSION AND RESULTING SEDIMENTATION. ALL DISTURBANCES SHALL BE DESIGNED, CONSTRUCTED, AND COMPLETED SO THAT THE EXPOSED AREA OF ANY DISTURBED LAND SHALL BE LIMITED TO THE SHORTEST PRACTICAL PERIOD OF TIME
- 11. ANY TEMPORARY OR PERMANENT FACILITY DESIGNED AND CONSTRUCTED FOR THE CONVEYANCE OF STORMWATER AROUND, THROUGH, OR FROM THE EARTH DISTURBANCE AREA SHALL BE DESIGNED TO LIMIT THE DISCHARGE TO A NON-EROSIVE VELOCITY. 12. CONCRETE WASH WATER SHALL BE CONTAINED AND DISPOSED OF IN ACCORDANCE WITH THE SWMP. NO WASH WATER SHALL BE DISCHARGED TO OR ALLOWED TO RUNOFF TO STATE WATERS,
- INCLUDING ANY SURFACE OR SUBSURFACE STORM DRAINAGE SYSTEM OR FACILITIES. 13. EROSION CONTROL BLANKETING SHALL BE USED ON SLOPES STEEPER THAN 3:1.
- 14. BUILDING, CONSTRUCTION, EXCAVATION, OR OTHER WASTE MATERIALS SHALL NOT BE TEMPORARILY PLACED OR STORED IN THE STREET, ALLEY, OR OTHER PUBLIC WAY, UNLESS IN ACCORDANCE WITH AN APPROVED TRAFFIC CONTROL PLAN. BMP'S MAY BE REQUIRED BY EL PASO COUNTY ENGINEERING IF DEEMED NECESSARY, BASED ON SPECIFIC CONDITIONS AND CIRCUMSTANCES.
- 15. VEHICLE TRACKING OF SOILS AND CONSTRUCTION DEBRIS OFF-SITE SHALL BE MINIMIZED. MATERIALS TRACKED OFFSITE SHALL BE CLEANED UP AND PROPERLY DISPOSED OF IMMEDIATELY.
- 16. CONTRACTOR SHALL BE RESPONSIBLE FOR THE REMOVAL OF ALL WASTES FROM THE CONSTRUCTION SITE FOR DISPOSAL IN ACCORDANCE WITH LOCAL AND STATE REGULATORY REQUIREMENTS. NO CONSTRUCTION DEBRIS, TREE SLASH, BUILDING MATERIAL WASTES OR UNUSED BUILDING MATERIALS SHALL BE BURIED, DUMPED, OR DISCHARGED AT THE SITE. 17. THE OWNER. SITE DEVELOPER. CONTRACTOR. AND/OR THEIR AUTHORIZED AGENTS SHALL BE RESPONSIBLE FOR THE REMOVAL OF ALL CONSTRUCTION DEBRIS, DIRT, TRASH, ROCK, SEDIMENT, AND
- SAND THAT MAY ACCUMULATE IN THE STORM SEWER OR OTHER DRAINAGE CONVEYANCE SYSTEM AND STORMWATER APPURTENANCES AS A RESULT OF SITE DEVELOPMENT.
- 18. THE QUANTITY OF MATERIALS STORED ON THE PROJECT SITE SHALL BE LIMITED, AS MUCH AS PRACTICAL, TO THAT QUANTITY REQUIRED TO PERFORM THE WORK IN AN ORDERLY SEQUENCE. ALL MATERIALS STORED ON-SITE SHALL BE STORED IN A NEAT, ORDERLY MANNER, IN THEIR ORIGINAL CONTAINERS, WITH ORIGINAL MANUFACTURER'S LABELS.
- 19. NO CHEMICALS ARE TO BE USED BY THE CONTRACTOR, WHICH HAVE THE POTENTIAL TO BE RELEASED IN STORMWATER UNLESS PERMISSION FOR THE USE OF A SPECIFIC CHEMICAL IS GRANTED IN WRITING BY THE ECM ADMINISTRATOR. IN GRANTING THE USE OF SUCH CHEMICALS, SPECIAL CONDITIONS AND MONITORING MAY BE REQUIRED. 20. BULK STORAGE STRUCTURES FOR PETROLEUM PRODUCTS AND OTHER CHEMICALS SHALL HAVE ADEQUATE PROTECTION SO AS TO CONTAIN ALL SPILLS AND PREVENT ANY SPILLED MATERIAL FROM
- ENTERING STATE WATERS, INCLUDING ANY SURFACE OR SUBSURFACE STORM DRAINAGE SYSTEM OR FACILITIES.
- 21. NO PERSON SHALL CAUSE THE IMPEDIMENT OF STORMWATER FLOW IN THE FLOW LINE OF THE CURB AND GUTTER OR IN THE DITCHLINE.
- 22. INDIVIDUALS SHALL COMPLY WITH THE "COLORADO WATER QUALITY CONTROL ACT" (TITLE 25, ARTICLE 8, CRS), AND THE "CLEAN WATER ACT" (33 USC 1344), IN ADDITION TO THE REQUIREMENTS INCLUDED IN THE DCM VOLUME II AND THE ECM APPENDIX I. ALL APPROPRIATE PERMITS MUST BE OBTAINED BY THE CONTRACTOR PRIOR TO CONSTRUCTION (NPDES, FLOODPLAIN, 404, FUGITIVE DUST, ETC.). IN THE EVENT OF CONFLICTS BETWEEN THESE REQUIREMENTS AND LAWS, RULES, OR REGULATIONS OF OTHER FEDERAL, STATE, OR COUNTY AGENCIES, THE MORE RESTRICTIVE LAWS, RULES, OR REGULATIONS SHALL APPLY. 23. ALL CONSTRUCTION TRAFFIC MUST ENTER/EXIT THE SITE AT APPROVED CONSTRUCTION ACCESS POINTS.
- 24. PRIOR TO ACTUAL CONSTRUCTION THE PERMITTEE SHALL VERIFY THE LOCATION OF EXISTING UTILITIES.
- 25. A WATER SOURCE SHALL BE AVAILABLE ON SITE DURING EARTHWORK OPERATIONS AND UTILIZED AS REQUIRED TO MINIMIZE DUST FROM EARTHWORK EQUIPMENT AND WIND.
- 26. THE SOILS REPORT FOR THIS SITE HAS BEEN PREPARED BY ENTECH ENGINEERING AND SHALL BE CONSIDERED A PART OF THESE PLANS.
- 27. AT LEAST TEN DAYS PRIOR TO THE ANTICIPATED START OF CONSTRUCTION, FOR PROJECTS THAT WILL DISTURB 1 ACRE OR MORE, THE OWNER OR OPERATOR OF CONSTRUCTION ACTIVITY SHALL SUBMIT A PERMIT APPLICATION FOR STORMWATER DISCHARGE TO THE COLORADO DEPARTMENT OF PUBLIC HEALTH AND ENVIRONMENT, WATER QUALITY DIVISION. THE APPLICATION CONTAINS CERTIFICATION OF COMPLETION OF A STORMWATER MANAGEMENT PLAN (SWMP), OF WHICH THIS GRADING AND EROSION CONTROL PLAN MAY BE A PART. FOR INFORMATION OR APPLICATION MATERIALS CONTACT:

COLORADO DEPARTMENT OF PUBLIC HEALTH AND ENVIRONMENT WATER QUALITY CONTROL DIVISION WQCD - PERMITS


| 4300 CHERRY CREEK DRIVE SOUTH | |
|-------------------------------|--|
| DENVER, CO 80246-1530 | |
| ATTN: PERMITS UNIT | |
| | |

| DATE | DESCRIPTION | ٧. |
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Know what's below. $Call \ 72 \ \text{hours before you dig}$ For more details visit: www.call811.com

ELDORADO SPRINGS **STORM SEWER PLAN & PROFILES** [PUBLIC & PRIVATE]

EL PAS COUNTY, COLORADO

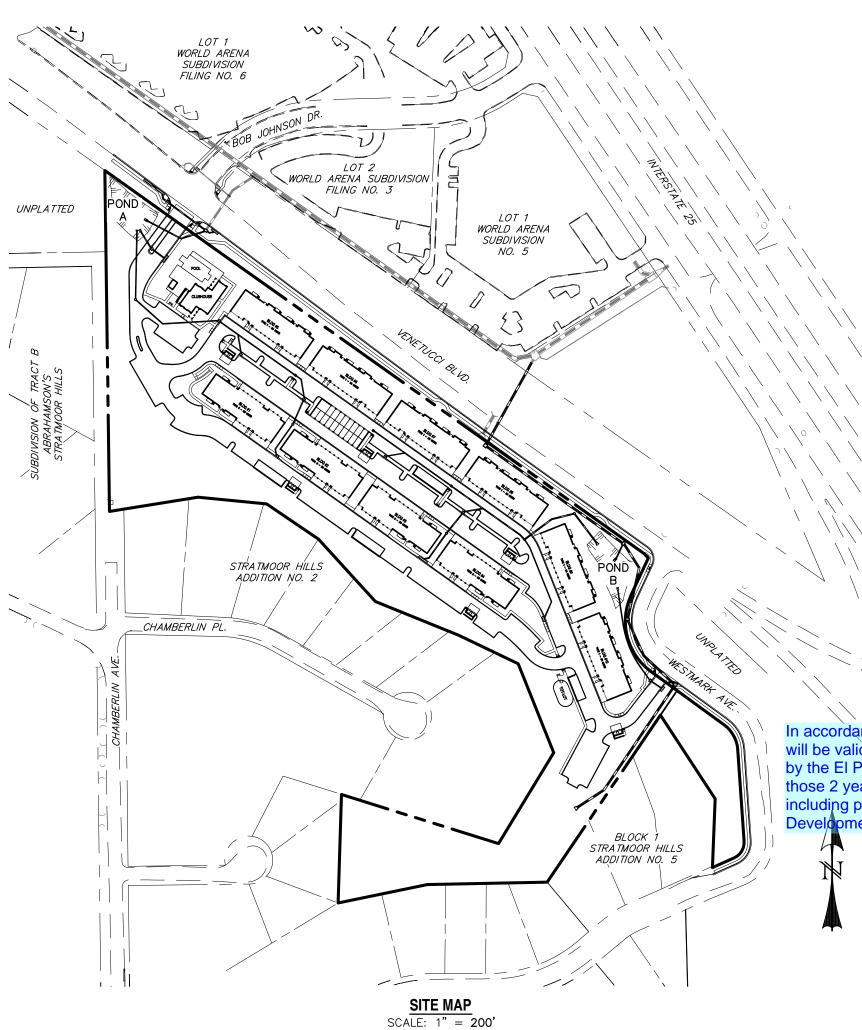

In accordance with ECM Section 1.12, these construction documents will be valid for construction for a period of 2 years from the date signed by the El Paso County Engineer. If construction has not started within lose 2 years, the plans will need to be resubmitted for a ncluding payment of review fees at the Planning and Community Development Directors discretion

GENERAL NOTES:

- 1. ALL PAVING AND CURB & GUTTER SHALL BE CONSTRUCTED SO AS NOT TO OBSTRUCT THE DRAINAGE PATHS. GRADES SHALL BE MAINTAINED AS SHOWN IN THESE PLANS FOR THE DRAINAGE PATHS. IF THIS CANNOT BE ACCOMPLISHED, THEN THE ENGINEER SHALL BE NOTIFIED IMMEDIATELY FOR CORRECTION.
- 2. POSITIVE DRAINAGE AWAY FROM THE BUILDING SHALL BE MAINTAINED DURING AND AFTER SITE CONSTRUCTION. SWALES SHALL BE CONSTRUCTED AROUND BUILDINGS TO DIRECT DRAINAGE AWAY FROM STRUCTURES.
- 3. SITE CONSTRUCTION INCLUDING PAVING AND CURB & GUTTER INSTALLATION SHALL MAINTAIN POSITIVE DRAINAGE AS SHOWN ON THIS PLAN. STANDING WATER OR PONDING ANYWHERE ON THE SITE IS UNACCEPTABLE.
- 4. IT SHALL BE THE RESPONSIBILITY OF THE CONTRACTOR TO VERIFY THE EXISTENCE AND LOCATION OF ALL UNDERGROUND UTILITIES ALONG THE ROUTE OF THE WORK. THE OMISSION FROM OR THE INCLUSION OF UTILITY LOCATIONS ON THE PLANS IS NOT TO BE CONSIDERED AS THE NONEXISTENCE OF OR A DEFINITE LOCATION OF EXISTING UNDERGROUND UTILITIES.

BENCHMARKS:

- 1. THE MOST NORTHERLY CORNER OF THE SITE MONUMENTED BY A 1" YELLOW PLASTIC CAP STAMPED "23890." EL = 5865.58
- 2. THE MOST SOUTHERLY CORNER ALONG US HIGHWAY 85-87 BEING MONUMENTED BY A 1-1/2" ALUMINUM SURVEYORS CAP STAMPED "CCES LLC PLS 30118" LOCATED AT THE WESTERLY CORNER OF THE INTERSECTION OF WESTMARK AVENUE AND US HIGHWAY 85-87. FI = 5854.18

BASIS OF BEARING:

THE WEST LINE OF THE SOUTHWEST QUARTER OF THE SOUTHWEST QUARTER OF SECTION 33, TOWNSHIP 14 SOUTH, RANGE 66 WEST OF THE 6TH P.M. BEING MONUMENTED AT THE NORTH END BY A 2-1/2" ALUMINUM SURVEYORS CAP WITH APPROPRIATE MARKINGS AND AT THE SOUTH END BY A 3-1/4" ALUMINUM SURVEYORS CAP WITH APPROPRIATE MARKINGS IS ASSUMED TO BEAR NO0'44'35"W, A DISTANCE OF 1320.61 FEET.

CURB AND GUTTER EASEMENT BUILDING

LEGEND

EXISTING

PROPOSED

- DRAINAGE PUBLIC PRIVATE UNDERGROUND UTILITY SANITARY SEWER WATER BOUNDARY RIGHT-OF-WA LOT LINE EASEMENT SETBACK (E) SANITARY MAIN, MH (E) WATER MAIN, VALVE, FH (E) UG ELECTRIC (E) FIBER OPTIC (E) GAS MAIN (E) OVERHEAD UTILITY (E) UG TELEPHONE (E) STORM SEWER (P) SANITARY MAIN, MH
- (P) FIRE SERVICE. VALVE (P) STORM SEWER, MH

PRFPARED FOR

5671 NORTH ORACLE ROAD SUITE #1102 TUSCON, AZ 85704


(520) 742–2114

DRED הואורבם איז הופבטד פווטבסוזופוטאו בטם אאור פרחאו ד U



CHAD D. TOLDER, ODEORADO I E π^{00701}

ESH DEVELOPMENT, LLC

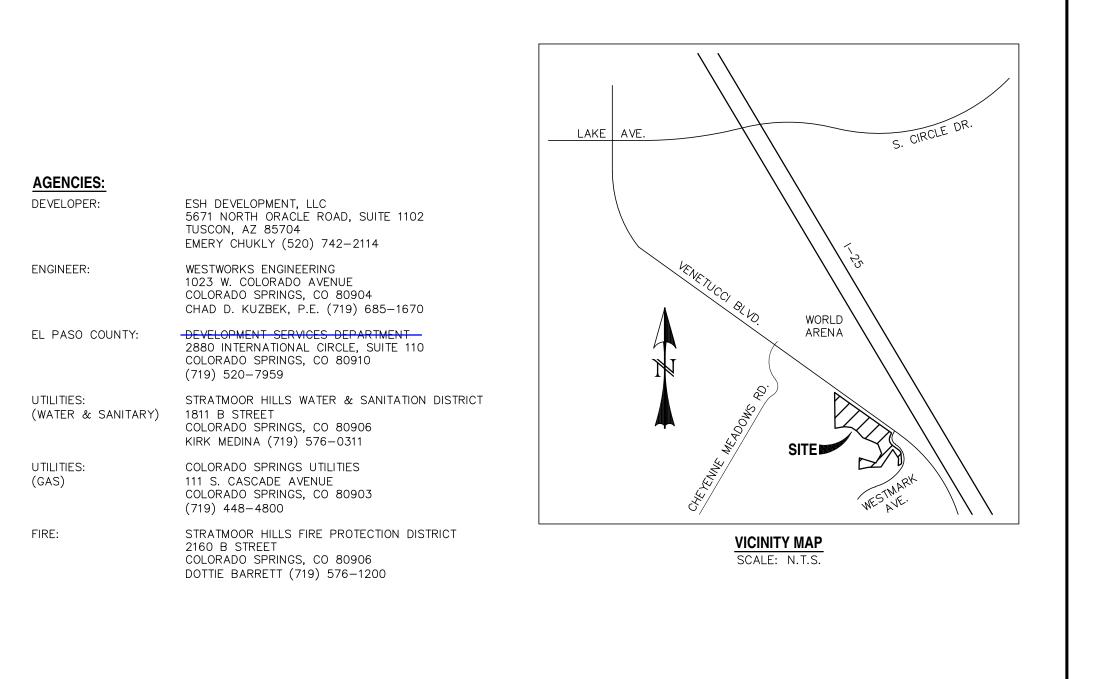

CONSTRUCTION PLANS AND SPECIFICATIONS ENGINEERS STATEMENT:

THESE DETAILED PLANS AND SPECIFICATIONS WERE PREPARED UNDER MY DIRECTION AND SUPERVISION. SAID DETAILED PLANS AND SPECIFICATIONS HAVE BEEN PREPARED ACCORDING TO THE CRITERIA ESTABLISHED BY THE CITY/COUNTY FOR DETAILED DRAINAGE PLANS AND SPECIFICATIONS, AND SAID DETAILED PLANS AND SPECIFICATIONS ARE IN CONFORMITY WITH THE MASTER PLAN OF THE DRAINAGE BASIN. SAID DETAILED PLANS AND SPECIFICATIONS MEET THE PURPOSES WHICH THE PARTICULAR DRAINAGE FACILITY(S) IS DESIGNED. I ACCEPT RESPONSIBILITY FOR ANY LIABILITY CAUSED BY ANY NEGLIGENT ACTS, ERROR OR OMMISSIONS ON MY PART IN PREPARATION OF THE DETAILED PLANS AND SPECIFICATIONS.

CHAD D. KUZBEK, COLORADO PE #35751

EL PASO COUNTY (WESTMARK AVENUE ONLY):

COUNTY PLAN REVIEW IS PROVIDED ONLY FOR GENERAL CONFORMANCE WITH COUNTY DESIGN CRITERIA. THE COUNTY IS NOT RESPONSIBLE FOR THE ACCURACY AND ADEQUACY OF THE DESIGN, DIMENSIONS, AND/OR ELEVATIONS WHICH SHALL BE CONFIRMED AT THE JOB SITE. THE COUNTY THROUGH THE APPROVAL OF THIS DOCUMENT ASSUMES NO RESPONSIBILITY FOR COMPLETENESS AND/OR ACCURACY OF THIS DOCUMENT.


FILED IN ACCORDANCE WITH THE REQUIREMENTS OF THE EL PASO COUNTY LAND DEVELOPMENT CODE, DRAINAGE CRITERIA, AND ENGINEERING CRITERIA MANUAL AS AMENDED.

JENNIFER IRVINE, P.E. COUNTY ENGINEER/ECM ADMINISTRATOR

OWNER STATEMENT:

THE OWNER WILL COMPLY WITH THE REQUIREMENTS OF THE STORM SEWER PLANS.


OWNER NAME:

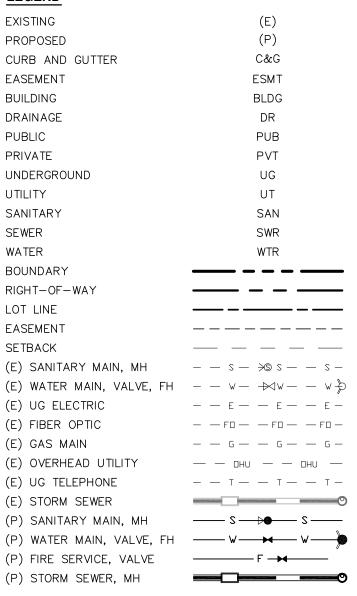



| SHEET INDEX: | |
|--|----------------------------------|
| TITLE SHEET STORM SEWER PLAN & PROFILES [PRIVATE] | ST1 OF 9 |
| STM-01, STM-02, STM-03, & ŠTM-03A STM-04, STM-05, & STM-07 | ST2 OF 9 ST3 OF 9 ST4 OF 9 |
| STM-06, STM-06A, & STM-06B STORM SEWER PLAN & PROFILES [PUBLIC] STM-01 | ST4 OF 9 |
| STM-02 PERMANENT BMP POND A PLAN DEBMANENT BMP DOND B DLAN | ST6 OF 9 ST7 OF 9 ST8 OF 9 |
| PERMANENT BMP POND B PLAN DETAIL SHEET | ST8 OF 9 ST9 OF 9 |
| | |

| | ELDORADO SPRINGS | designed by: MGP | drawn by: MGP |
|---|--|------------------|----------------|
| | | SCALE: 1"=200' | DATE: 06/27/19 |
| | | JOB NUMBER | SHEET |
| IWORKS N E E R I N G RADO SPRINGS, CO 80904 (719) 685-1670 | STORM SEWER PLAN & PROFILES TITLE SHEET | 91807 | ST1 OF 9 |


| | | [PRIVATE] | | | | | | | |
|------------|---|--|--|--|---|---|---|---|----------|
| | | | | | | | CL (P) 15 | 32.00 LF | = 586 |
| 5870 | | | | | | | CL (P) 5' TYPE R A | 24" RCP [CL @ 0.9 | 3 |
| | STA: 0+98.0 (P) TYPE 1 MH- RIM = 5860.5 INV (24") S = 5853.7 INV (24") E = 5853.7 INV (30") W = 5853.2 INV (48") N = 5851.7 | 01 10.86 LF 57 24" RCP 79 0 19.89% 79 (E) | [CL III] | | | | 39.98 L 24" RCP [0 |) GRADE | |
| 5860 | | (P) GRA | DE 120.78 LF OI 24" RCP [CL III © 0.509 | | | | (P) CONC FOREBAY W/ ENEGERY DISSIPATER | | |
| | | | | | | | | | |
| 5850 | | | | | 0.71.01 | | STA: 1+0 BEGIN 24" INV = 585 | FES 9.25 STA: 1+46.08 NV OUT = 5859.48 | |
| | STA: 0+96.0 (E) 48" RCP OU INV (48") = 5851.7 STA: 1+00. | 9 | STA: 1+6 (P) 8" P BOP (STA | (P) STRI INV (SEE | 2+31.64 POND A OUTF UCTURE - INLI OUT = 5856.5 POND A DET | ET-01 50 | 24 | STA: 1+49.08 INV IN = 5859.98 | <u>}</u> |
| 5840 (P | STA: 1+00. BEGIN (P) 24" R INV (24") = 5853. STA: 1+) 11.25' PRE-FAB VERTICAL INV = 58 | 79 -10.86 BEND | TOP (SAN CLR = 1. STA: 1+52.57 | N) = 5854.31 6' 7 RE-FAB HORIZO | NTAL BEND | | | | |
| | (E) GAS CR BOP (STM) = 5 TOP (GAS) = 5 | 855.72 | | | | | | | |
| 5830 | | | <u>stm-01</u> [private] | | | | | <u>stm-02</u> [private | |
| | | 1+00 | | ·00 | | | | 1+00 | |
| REV. | DESCRIPTION | | DATE | | | ow what's belov Call 72 hours be r more details visi www.call811.com | efore you dig. | | |

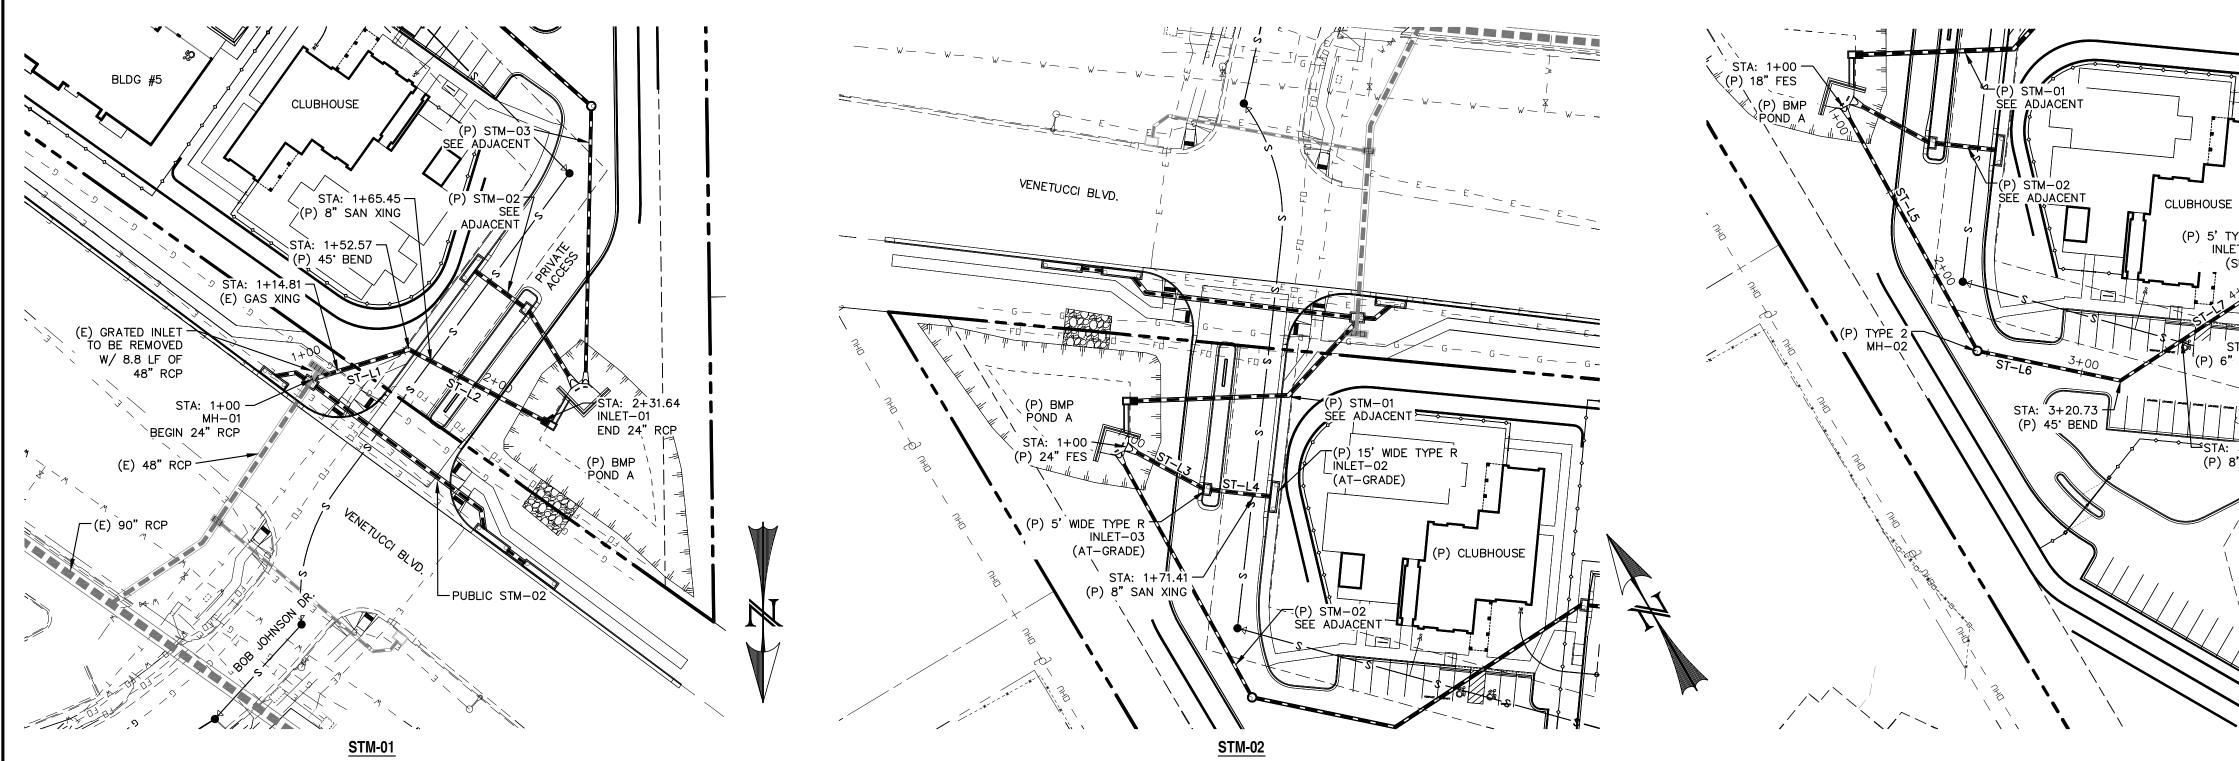


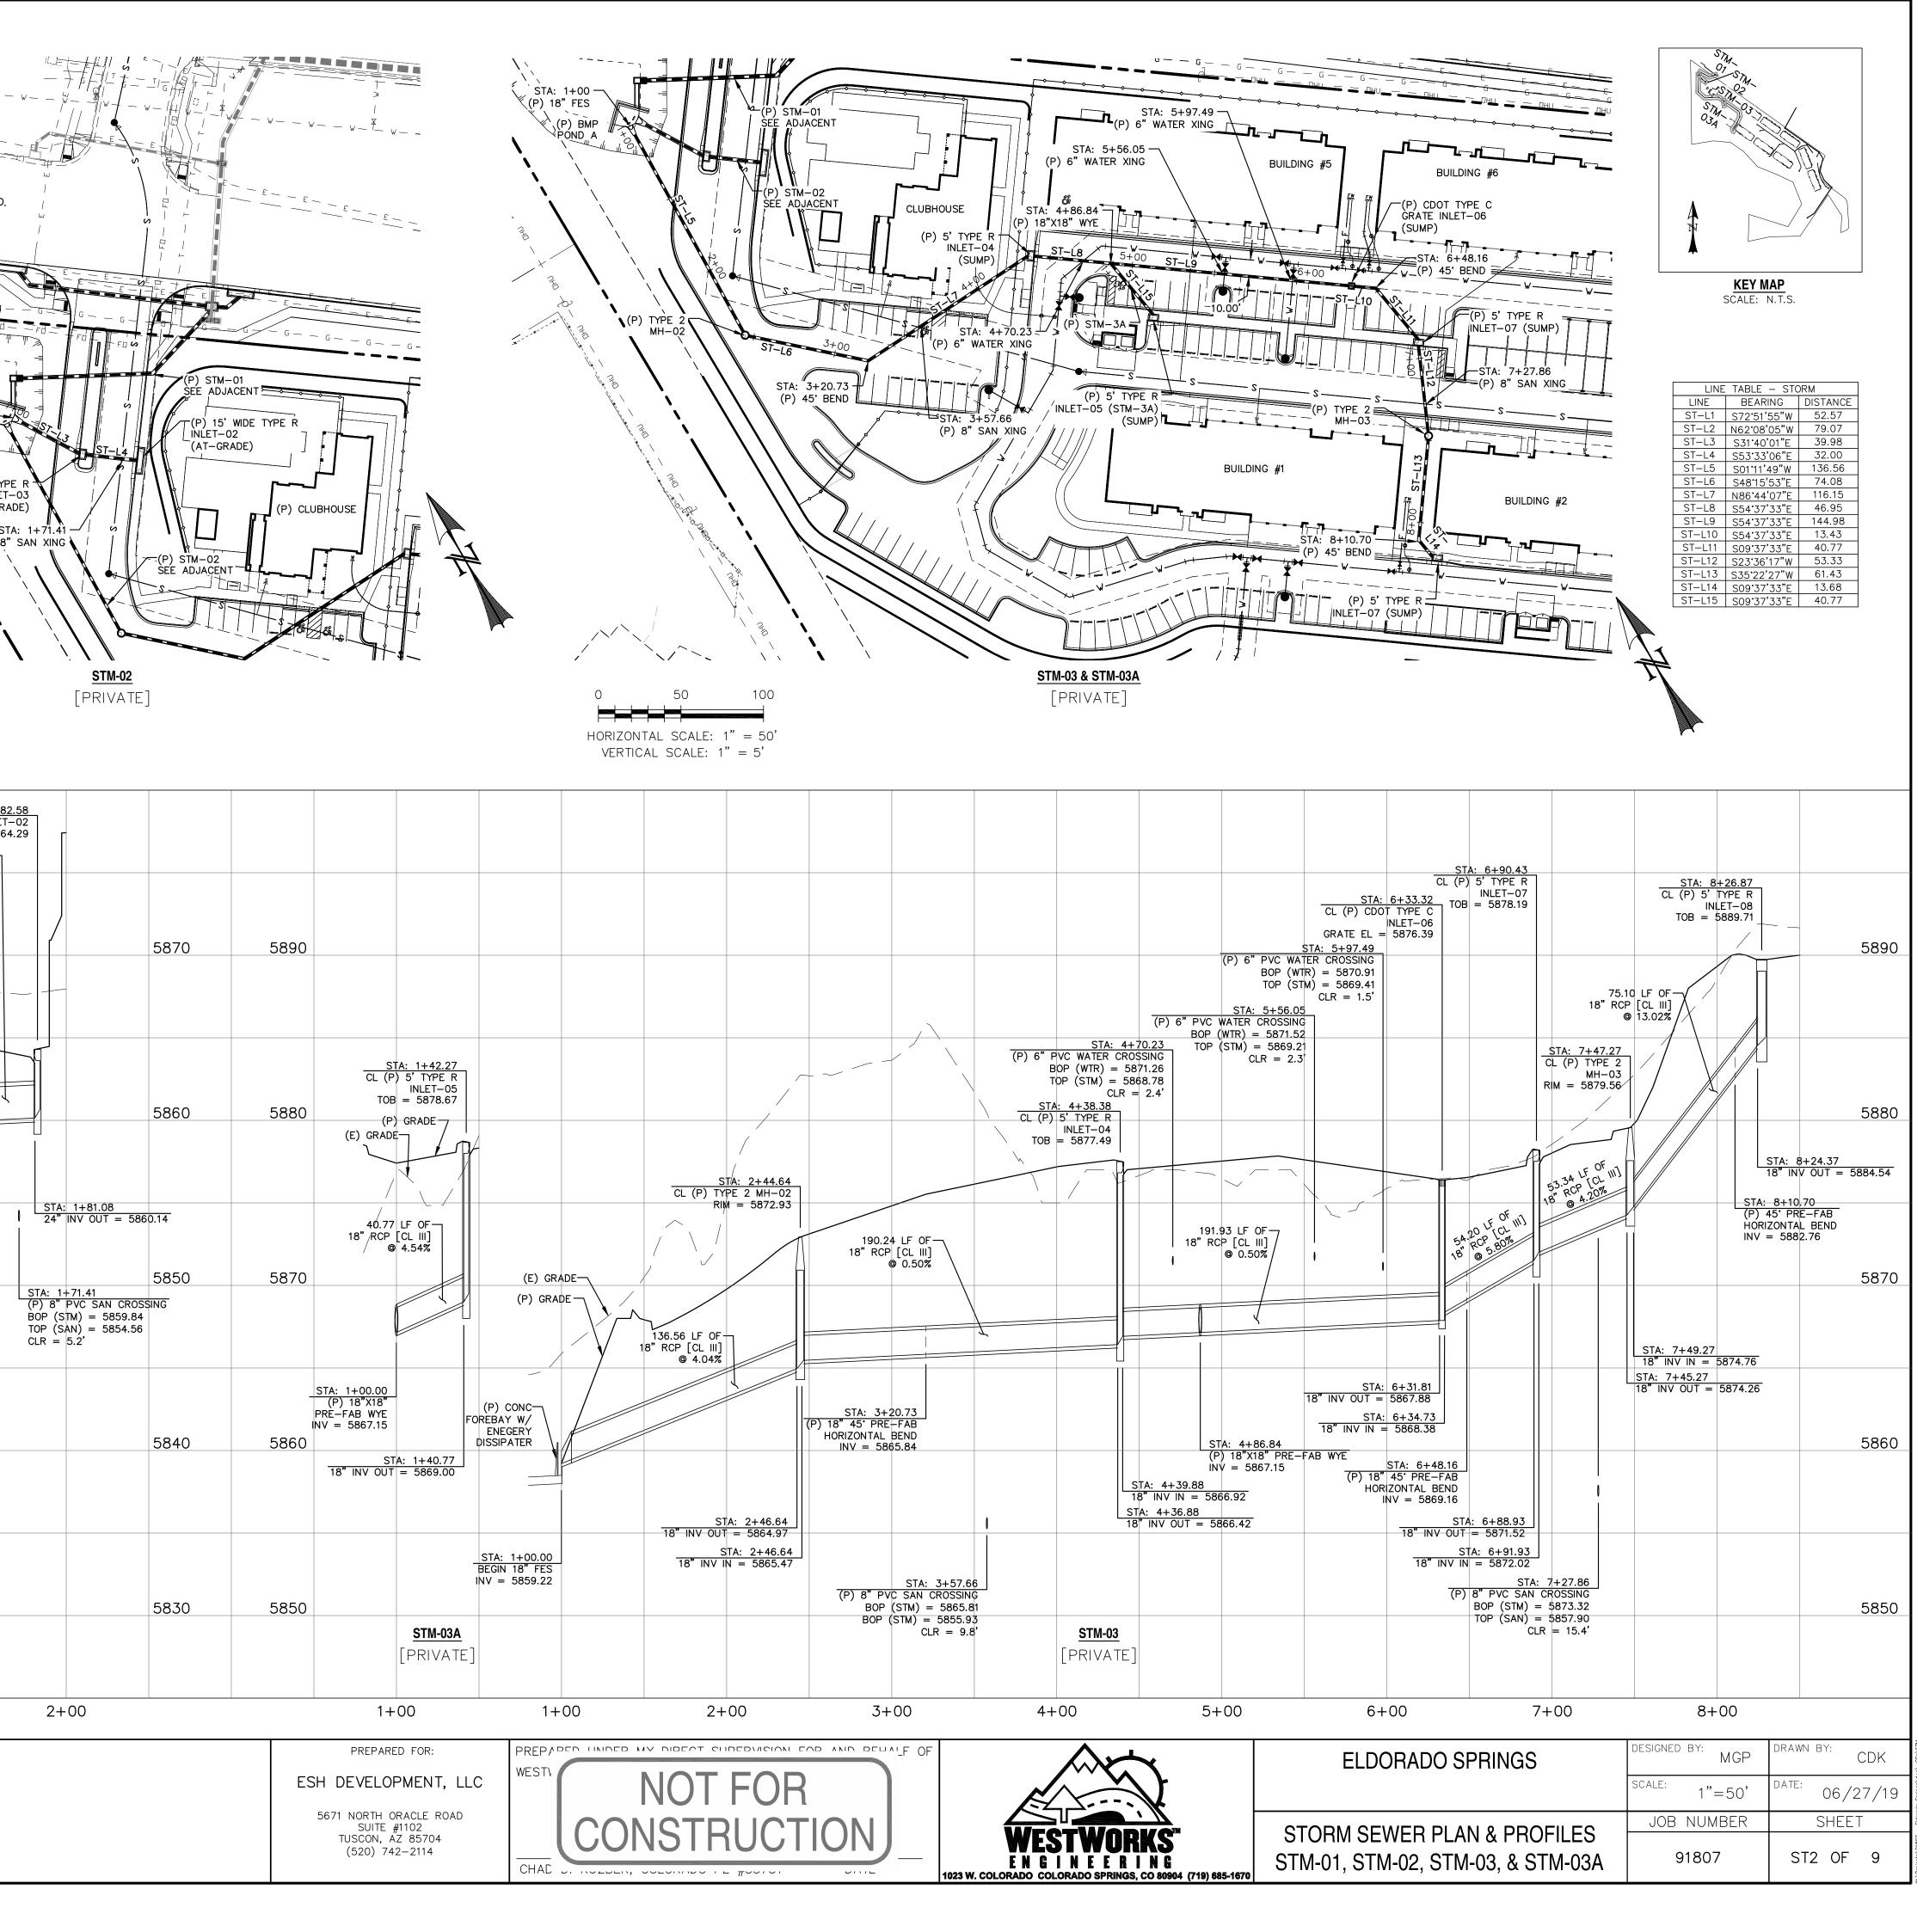


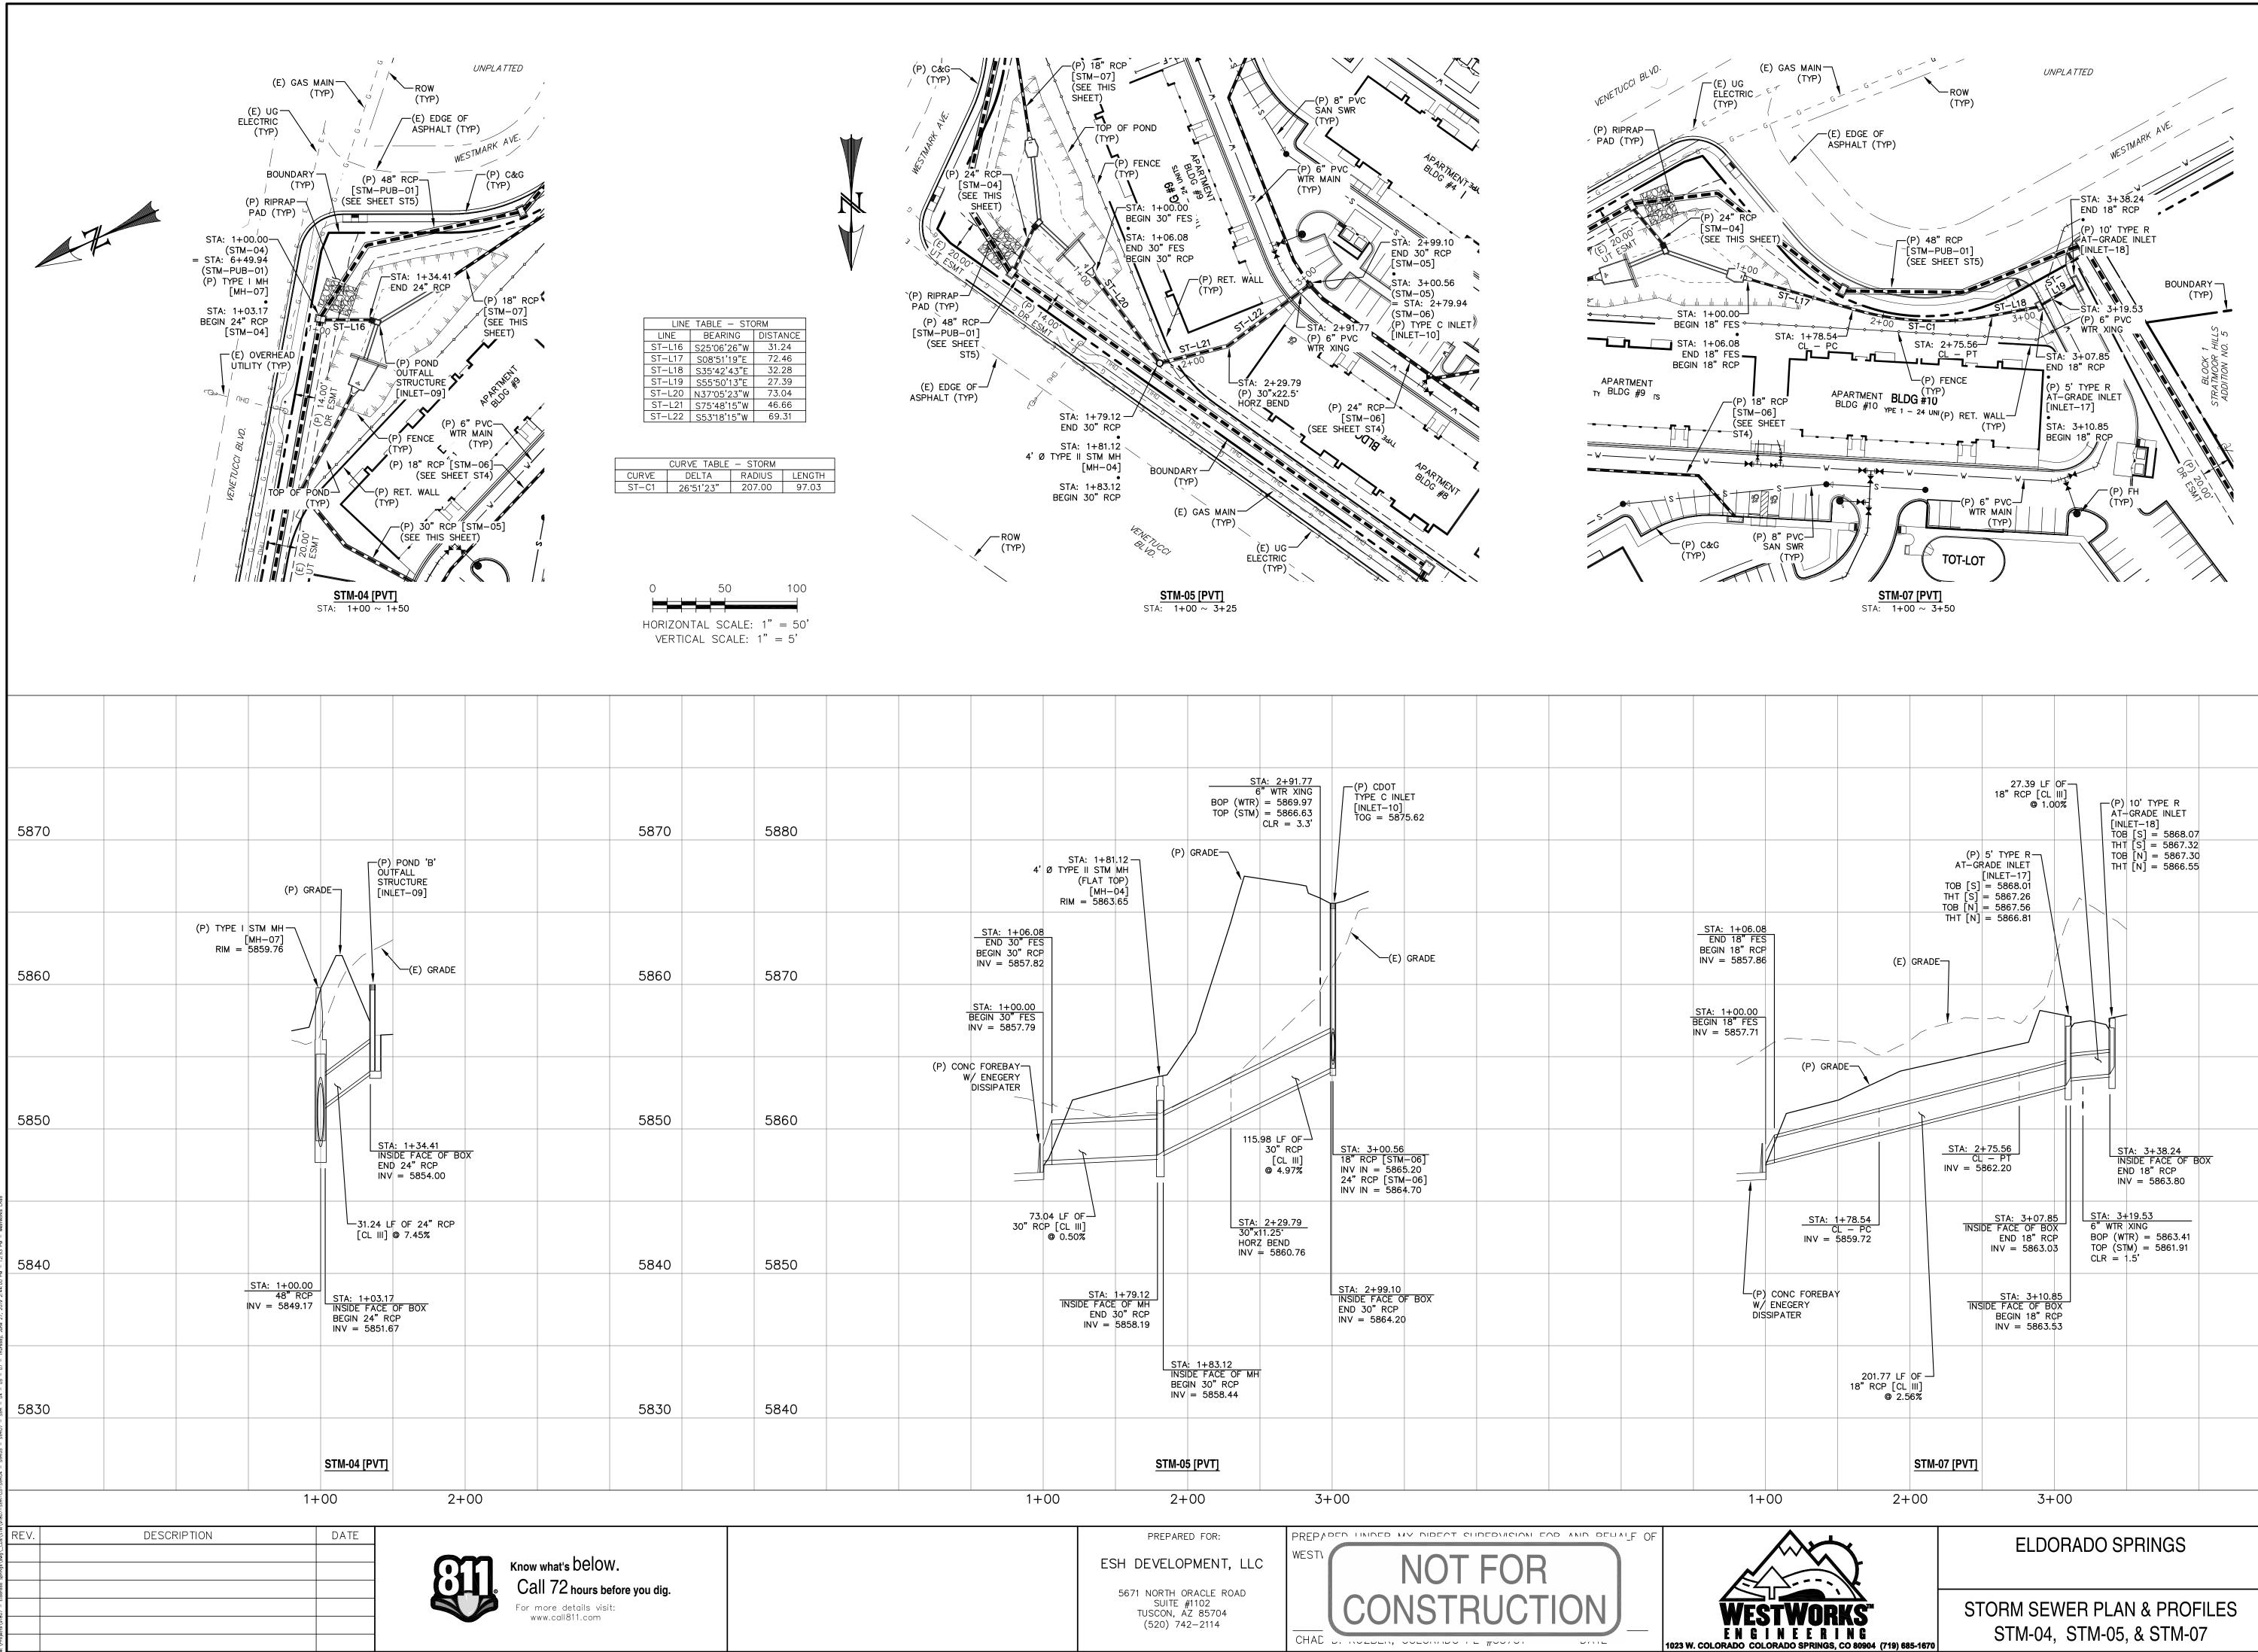

| | $\begin{array}{c ccccccccccccccccccccccccccccccccccc$ | | 5880 |
|--|--|-----------------------------------|-------------------|
| 06.08 FES RCP 57.86 (E) GRADE | THT [N] = 5866.81 | | 5870 |
| .00 TES 7.71 (P) GRADE | | | |
| | STA: 2+75.56 STA: 3+38.24 CL - PT INSIDE FACE OF BOX INV = 5862.20 END 18" RCP INV = 5863.80 INV = 5863.80 | | 5860 |
| $\frac{STA: 1+78.54}{CL - PC}$ INV = 5859.72 | $\begin{array}{c c} STA: 3+07.85\\\hline INSIDE FACE OF BOX\\END 18" RCP\\INV = 5863.03\\\end{array} \begin{array}{c c} STA: 3+19.53\\6" WTR XING\\BOP (WTR) = 5863.41\\TOP (STM) = 5863.41\\CLR = 1.5\\\end{array}$ | | 5850 |
| -(P) CONC FOREBAY W/ ENEGERY DISSIPATER | STA: 3+10.85 INSIDE FACE OF BOX BEGIN 18" RCP INV = 5863.53 | | |
| 201.77 LF OF 18" RCP [CL III] @ 2.56% | | | 5840 |
| | <u>-07 [PVT]</u> | | |
| 1+00 2+00 | 3+00 | | |
| | ELDORADO SPRINGS | DESIGNED BY: MGP SCALE: 1"=50' | |
| ESTWORKS G I N E E R I N G COLORADO SPRINGS, CO 80904 (719) 685-1670 | STORM SEWER PLAN & PROFILES STM-04, STM-05, & STM-07 | JOB NUMBER 91807 | SHEET ST3 OF 9 |

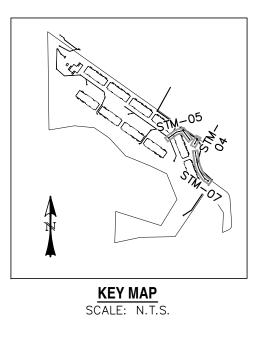

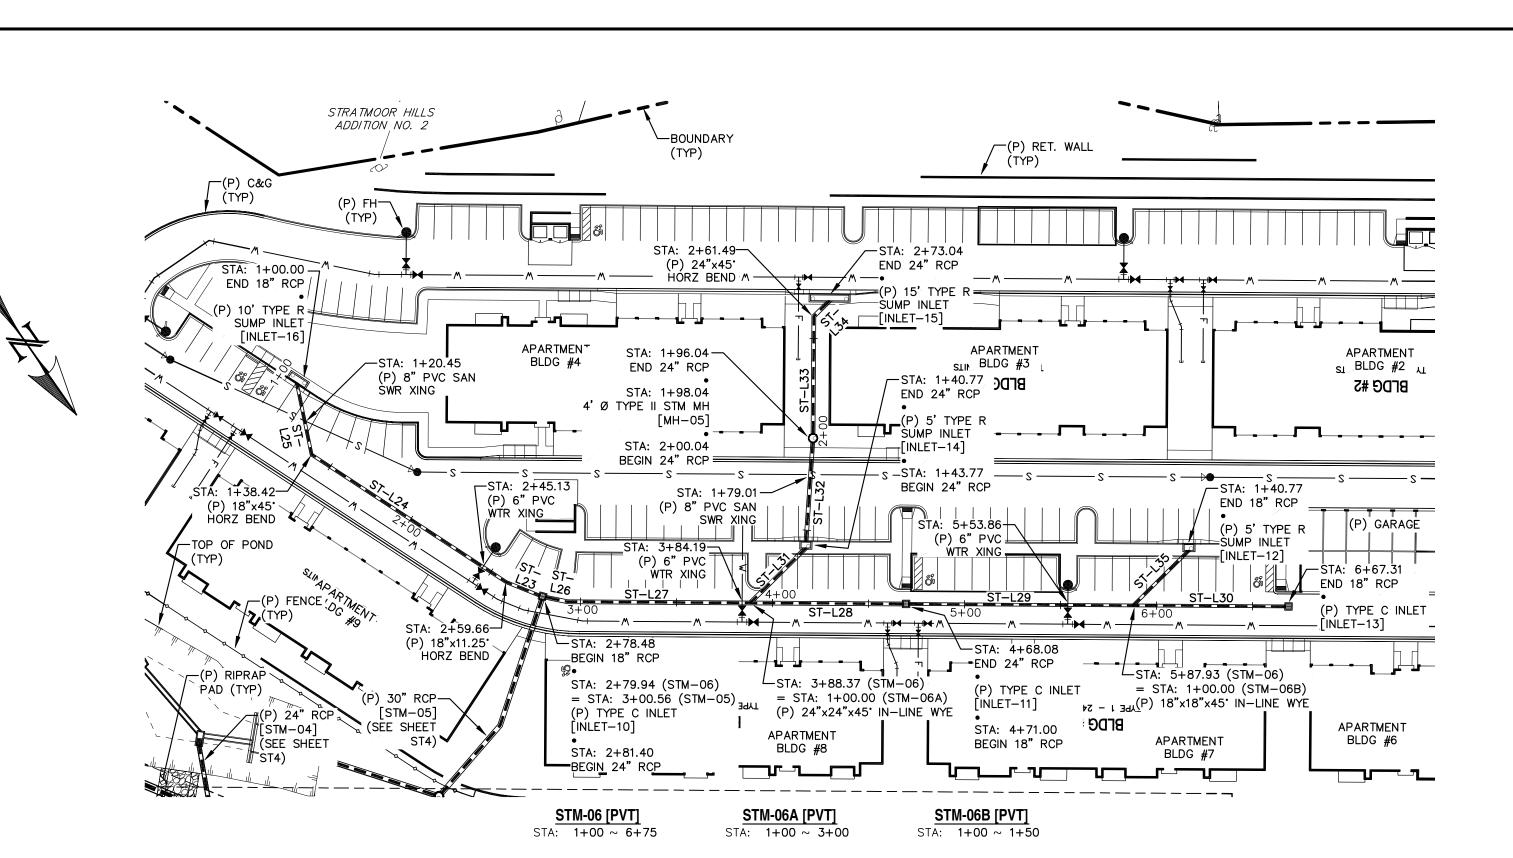

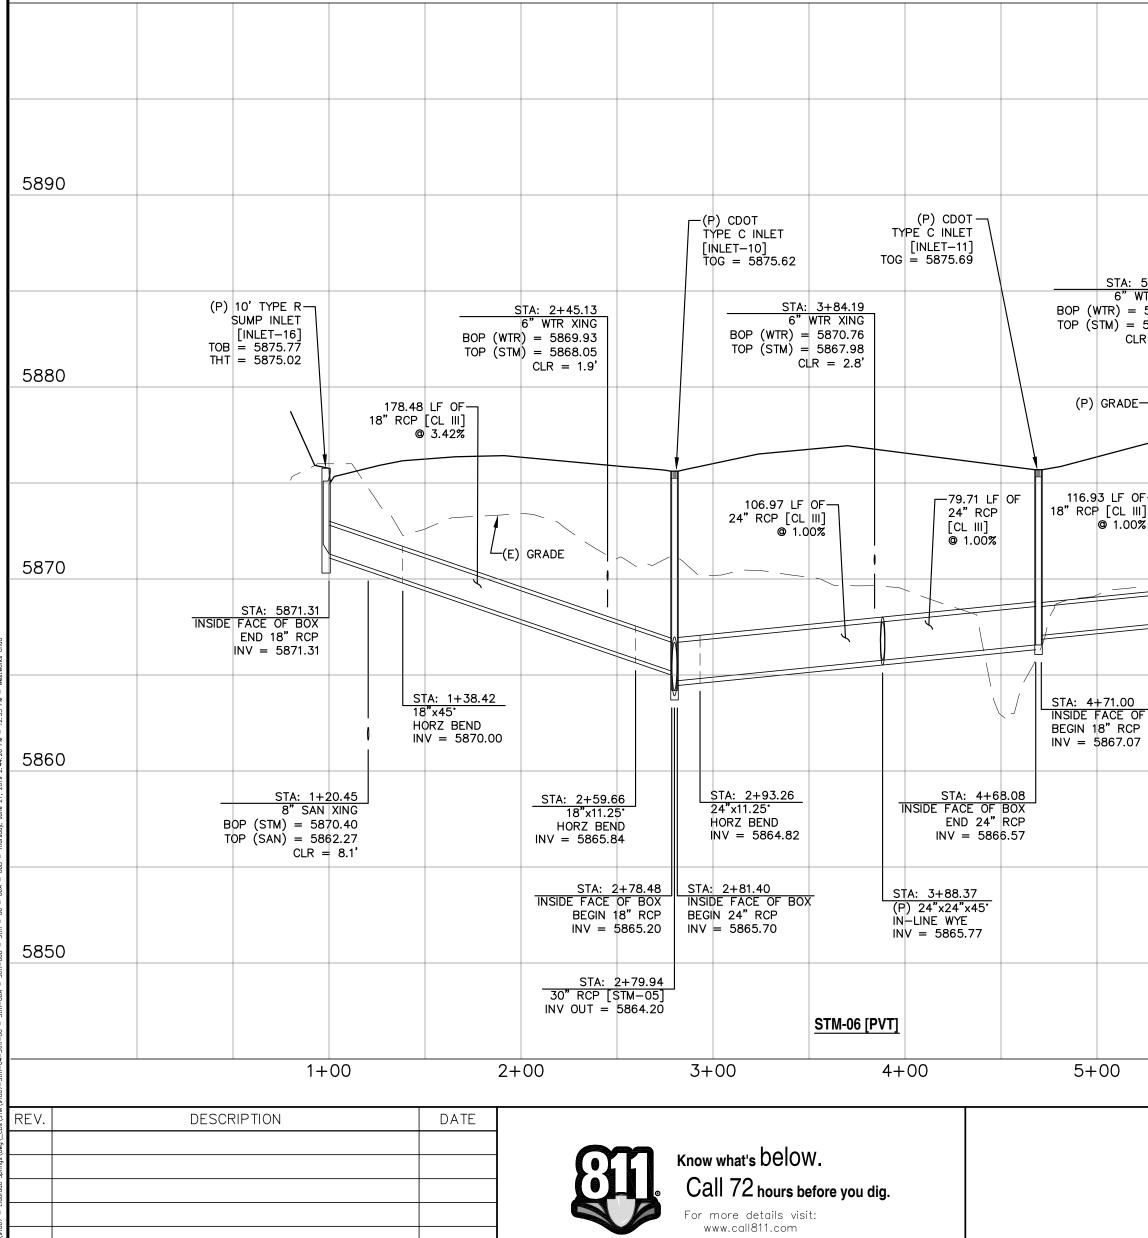


| | | | | | 4'Ø TYPE II (FL | 1+98.04 STM MH AT TOP) [MH-05] 5876.88 | | (P) 15' TYPE R SUMP INLET [INLET-15] TOB = 5888.08 THT = 5887.33 |
|--|---|--|----------------------------------|-----------|---|--|--|--|
| 5+53.86 | | | | | (P) 5' TYPE R SUMP INLET [INLET-14] TOB = 5875.74 THT = 5874.99 | | (P) GRADE | THT = 5887.33 |
| WTR XING 5871.35 5869.60 R = 1.8' | (P) CDOT TYPE C INLET [INLET-13] TOG = 5876.64 | | | 4 24" | 0.77 LF OF RCP [CL III] @ 5.65% | | | |
| | 79.38 LF OF | | | | | | | STA: 2+73.04 INSIDE FACE OF BOX END 24" RCP INV = 5882.91 |
| 1] % | 18" RCP [CL III] © 1.00% | | | | (E) GRADE | | -73.00 LF (24" RCP [@ 14.99% | STA: 2+61.49 24"x45" HORZ BEND INV = 5881.18 |
| F BOX | STA: 5+87.93 (P) 18"x18"x45" IN-LINE WYE INV = 5868.23 | | | (P) 24"x2 | NE WYE | | STA: 2+00.04 INSIDE FACE OF BEGIN 24" RCP INV = 5871.97 | МН |
| | STA: 6+67.3 INSIDE FACE OF BO END 24" RC INV = 5869.0 | | | Т | STA: 1+40.77 NSIDE FACE OF BOX END 24" RCP INV = 5868.07 | | STA: 1+96.04 INSIDE FACE OF END 24" RCP INV = 5871.72 | MH |
| | | | | | STA: 1+43.77 INSIDE FACE OF BOX BEGIN 24" RCP INV = 5868.57 | 8"S BOP TOP | 1+79.01 SAN XING (STM) = 5870.44 (SAN) = 5859.99 = 10.5' | - |
| | | | | | 52.27 LF 24" RCP [CL @ 6.0 |])1% | 6A [PVT] | |
| | 6+00 | 7+00 | | | 1+00 | | -00 | 3+00 |
| | | PREPAR ESH DEVELO 5671 NORTH SUITE TUSCON, (520) 74 | ORACLE ROAD #1102 AZ 85704 | WESTI | NOT ONSTR | FOR RUCT | ION | |
| | | | | CHAL J | | - π | UNIL | 1023 W. COLORADO C |


| LINEBEARINGDISTANCEST-L23S33'01'15"E18.82ST-L24S21'46'15"E121.24ST-L25S23'13'45"W38.42ST-L26N43'22'33"W11.86ST-L27N54'37'33"W95.11ST-L28N54'37'33"W79.71ST-L29N54'37'33"W79.71ST-L30N54'37'33"W79.38ST-L31S80'22'27"W40.77ST-L32S38'53'49"W52.27ST-L33S35'22'27"W61.44ST-L34S80'22'27"W40.77ST-L35S80'22'27"W40.77 | | | | KEY MA SCALE: N. | Ρ T.S. |
|--|------------------------------|---|--------------------------------------|---------------------|---------------------------------|
| | | | 50 PRIZONTAL SCA VERTICAL SCAL | LE: 1" = | |
| | | | | | |
| | | | | | 5890 |
| | | | | | |
| (P) GR | RADE | (P) 5' TYPE R SUMP INLET [INLET-12] TOB = 5877.69 THT = 5876.94 | | | 5880 |
| (E) GR | ADE | | | | 5870 |
| | | | | | |
| <u>STA: 1</u> (P) 18"x IN-LII INV = 5 | NE WYE EN | FA: 1+40.77 SIDE FACE OF BOX ND 18" RCP V = 5871.02 | | | |
| | -40.77 I 18" RC @ 6.84 | _F OF P [CL III] % | | | 5860 |
| | STM-06B [PVT] | | | | 5850 |
| | 1+00 | 2+00 | | | |
| | ELDC | RADO SPRINGS | DESIGNED BY: SCALE: 1"= | MGP | DRAWN BY: MGP DATE: 06/27/19 |
| STWORKS [™] INEERING DLORADO SPRINGS, CO 80904 (719) 685-1670 | | VER PLAN & PROF STM-06A, & STM-0 | JOB NUM 91807 | BER | SHEET ST4 OF 9 |


KEY MAP SCALE: N.T.S.


LINE TABLE – STORM LINE BEARING DISTANCE ST-L23 S33'01'15''E 18.82

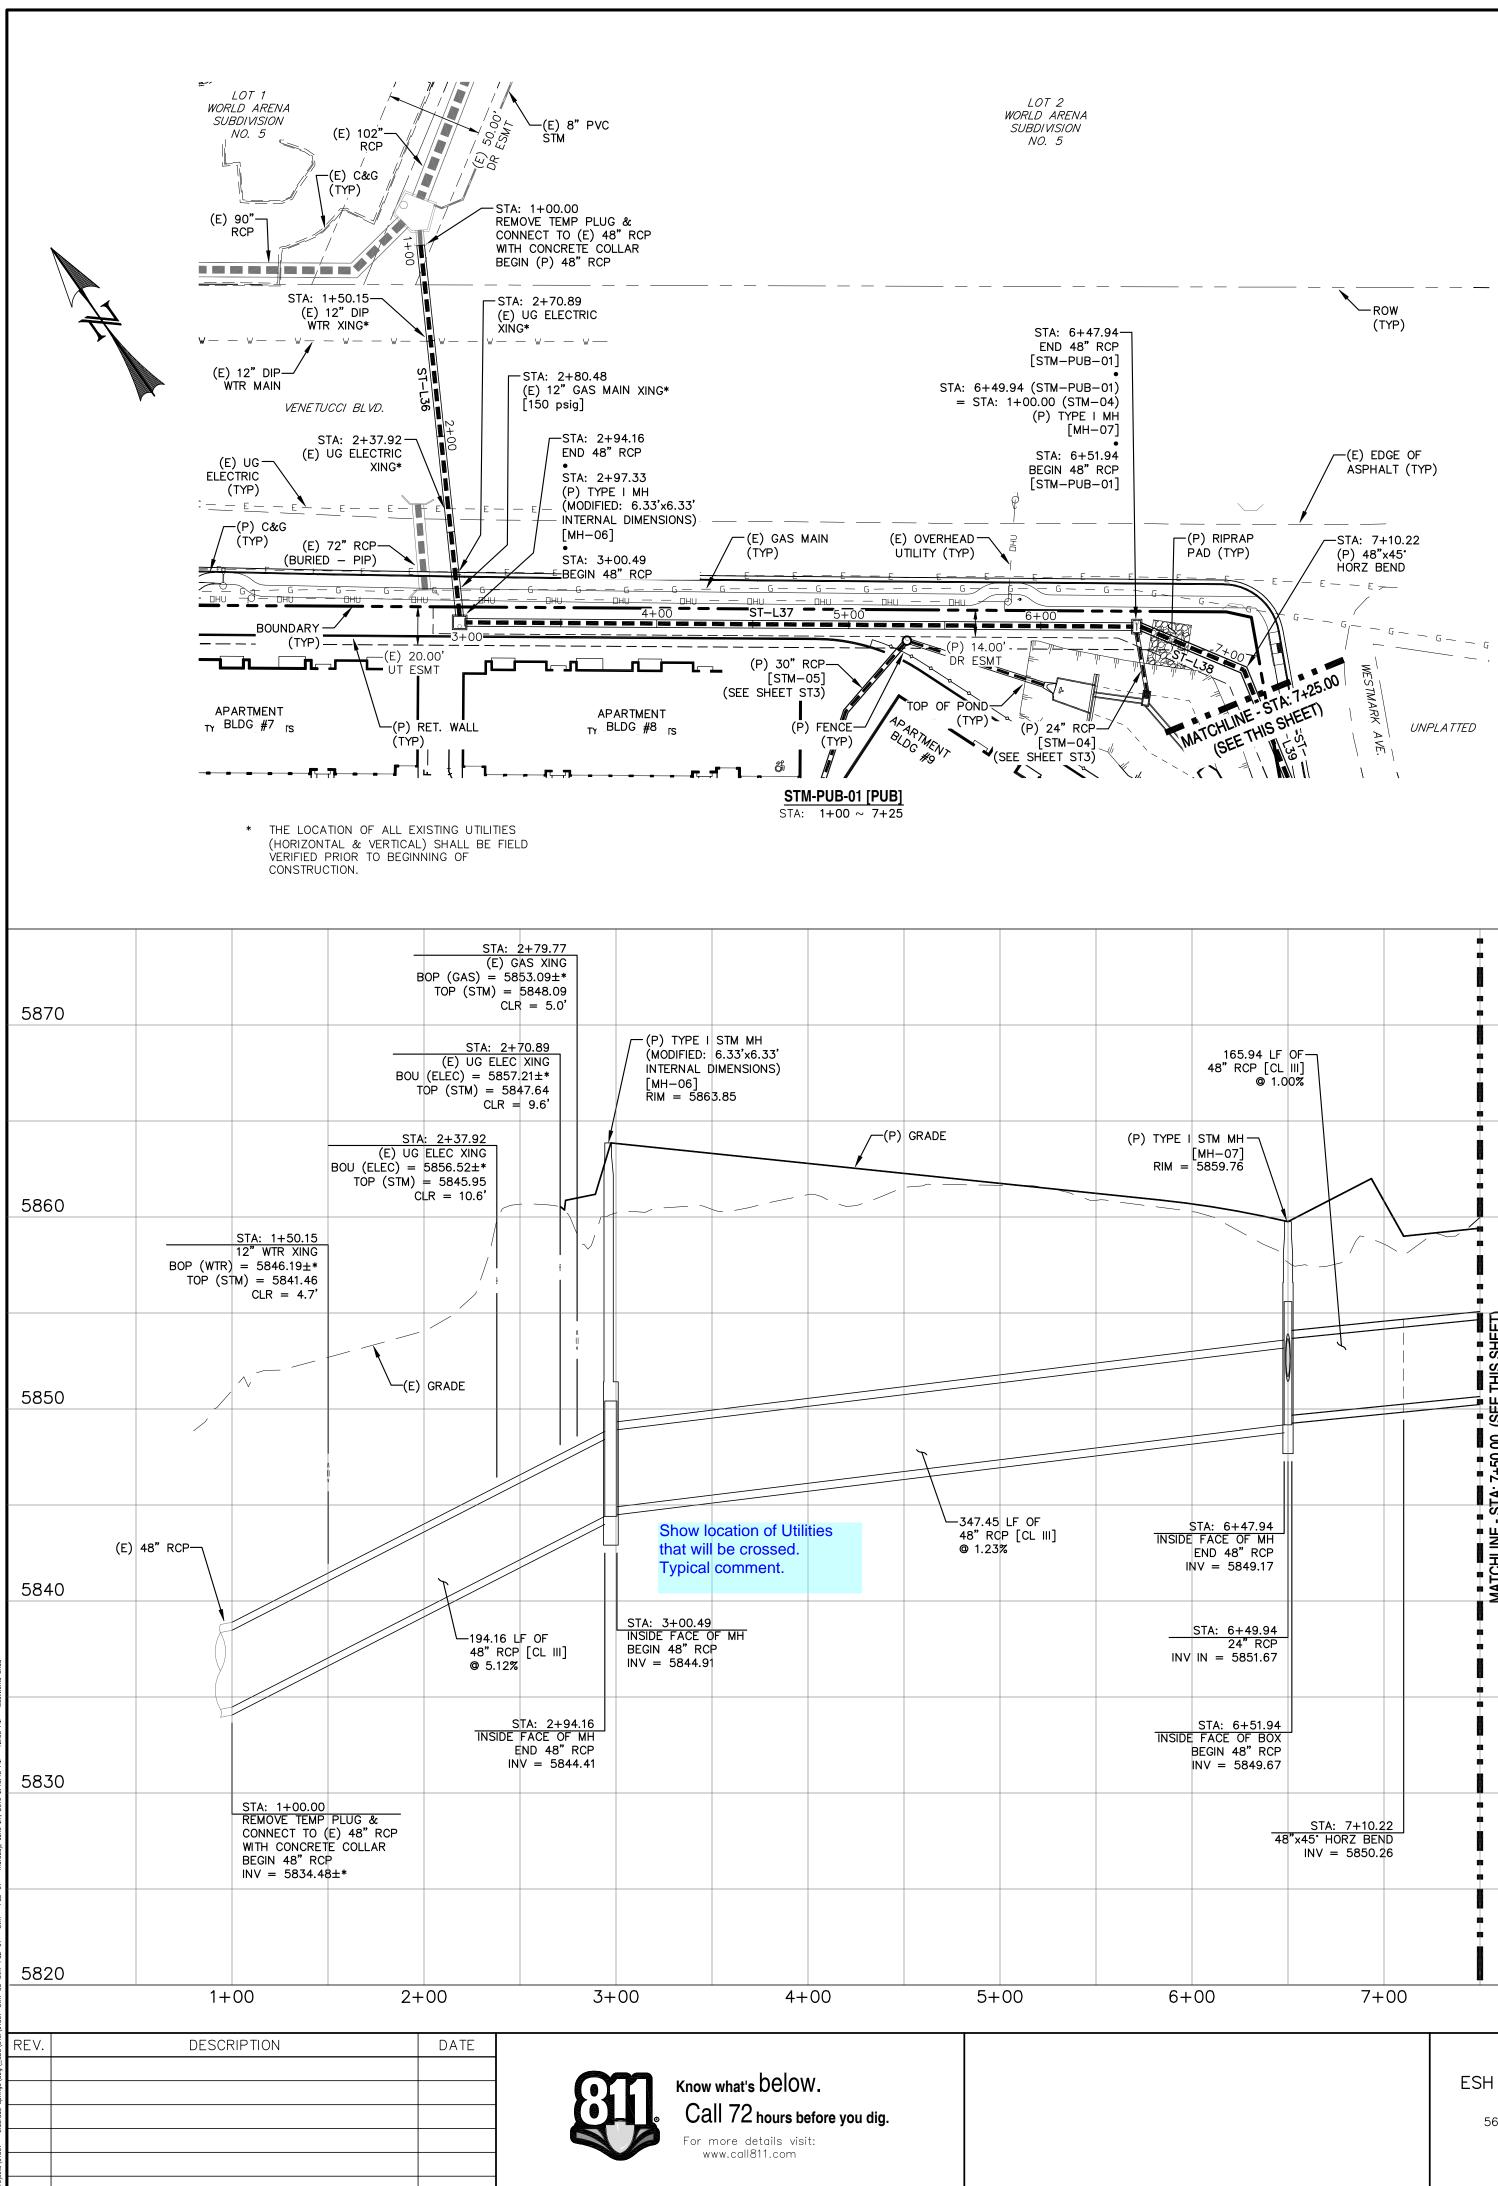


| ROW (TYP) (E) EDCE OF ASPHALT (TYP) (P) RIPRAP PAD (TYP) (P) 48"x45 HORZ BEND E - E - E - E - E - E - E - E - E - E - | $ \begin{bmatrix} LINE TABLE - STORM \\ LINE BEARING DISTA ST-L36 S2859'35''W 194 ST-L37 S54'38'03''E 347 ST-L39 S12'45'14'W 107 ST-L40 S24'24'28''E 86. ST-L41 S46'54'28''E 86. ST-L42 S34'08'59''W 261. ST-L43 S56'38'59''W 263. ST-L43 S56'38'59''W 63. ST-L43 S56'38'59''W 63. LATTED 0 50 $ | NCE 16 16 16 16 16 16 16 16 16 16 | (P) 18" RCP [STM-07] (SEE SHEET ST3) (P) FENCE (P) 18" RCP [STM-06] EE SHEET ST4) (P) 18" RCP (P) 18" RCP (P) 18" RCP (P) 18" RCP (P) 18" RCP (P) 18" RCP (STM-06] (SEE SHEET ST4) (P) 8" PVC SAN SWR (P) 8" PVC SAN SWR | STA: 9+89.19 BOUNDARY END 48" RCP (TYP) STA: 9+92.35 (TYP) (MODIFIED: 6.33'x6.33' INTERNAL DIMENSIONS) IMH-09] STA: 9+95.52 BEGIN 48" RCP (MODIFIED: 6.33'x6.33') (P) 6" PVC (P) 78 F (P) 6" PVC (P) RET. WALL (P) 6" PVC (P) RET. WALL (P) 6" PVC (P) RET. WALL (P) 6" PVC (P) C&G (P) 707-00T (P) C&G (P) C&G (TYP) (TYP) (TYP) (TYP) (TYP) (P) C&G (TYP) (TYP) (TYP) (TYP) (TYP) (TYP) (TYP) (TYP) </th <th>(E) BLDG (TYP)</th> <th><image/></th> | (E) BLDG (TYP) | <image/> |
|---|---|---|--|--|---|---|
| 165.94 LF OF 48" RCP [CL III] @ 1.00% | 5870 | 5900 | | | (E) GRADE | STA: 13+28.83 END 48" FES INV = 5884.36 5900 |
| (P) TYPE I STM MH [MH-07] RIM = 5859.76 | 5860 | 5890 | HIG5.94 LF OF (MODIFIED: 48" RCP [CL III] INTERNAL [| (P) GRADE (P) GRADE (P) GRADE (P) GRADE (MH-09] = 5868.12 | | 5890 <u>STA: 13+21.16</u> END 48" RCP BEGIN 48" FES INV = 5883.71 |
| | SITA: 74-50.00 SEE THIS SHEET S12: 74-50.00 SEE THIS SHEET | 5880 | $\begin{array}{c c} STA: 9\\ 6'' WT\\ BOP (WTR) = 5\\ TOP (STM) = 5\\ CLR \end{array}$ | +71.90 X XING 861.30 359.30 = 2.0' | STA: 12+57.4 48"x22.5" HOI INV = 5878.2 | 8 RZ BEND 4 5880 |
| $\frac{\text{STA: } 6+47.94}{\text{INSIDE FACE OF MH}}$ $\frac{\text{STA: } 6+49.94}{\text{INV} = 5849.17}$ $\frac{\text{STA: } 6+49.94}{24^{"} \text{ RCP}}$ $\frac{\text{STA: } 6+49.94}{1 \text{ INV} \text{ IN} = 5851.67}$ | 5840 | | S | | -325.64 LF OF 48" RCP [CL III] @ 8.59% | 5870 |
| $\frac{\text{STA: } 6+51.94}{\text{INSIDE FACE OF BOX}}$ $\frac{\text{BEGIN } 48" \text{ RCP}}{\text{INV} = 5849.67}$ $\frac{\text{STA: } 7+10.22}{48"\times 45" \text{ HORZ BEND}}$ $\frac{\text{STA: } 7+10.22}{100000000000000000000000000000000000$ | 5830 | 5860 | STA: 8+21.88 INSIDE FACE OF BOX BEGIN 48" RCP INV = 5851.83 STA: 9+03. 48"x22.5' HORZ BEND INV = 5853 | 0 STA: 9+95.52 INSIDE FACE OF BEGIN 48" RCP INV = 5855.73 | | 5860 |
| 6+00 7+00 | PREPARED FOR: | PREPADED LINDED MY DIDECT | SUDEDVISION FOR AND DELLALE OF | $\begin{array}{c c} \hline A: 9+89.19 \\ \hline ACE OF MH \\ ND 48" RCP \\ = 5855.23 \\ \hline 10+00 \\ \hline 11+00 \\ \hline \end{array}$ | | SIGNED DV. DRAWN DV. |
| | 5671 NORTH ORACLE ROAD SUITE #1102 TUSCON, AZ 85704 (520) 742-2114 | WEDT | FOR RUCTION | | LDORADO SPRINGS | MGP DRAWN BT. MGP CALE: 1"=50' DATE: 06/27/19 JOB NUMBER SHEET 91807 ST5 OF 9 |

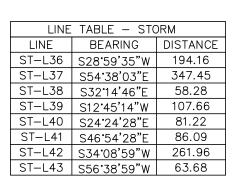


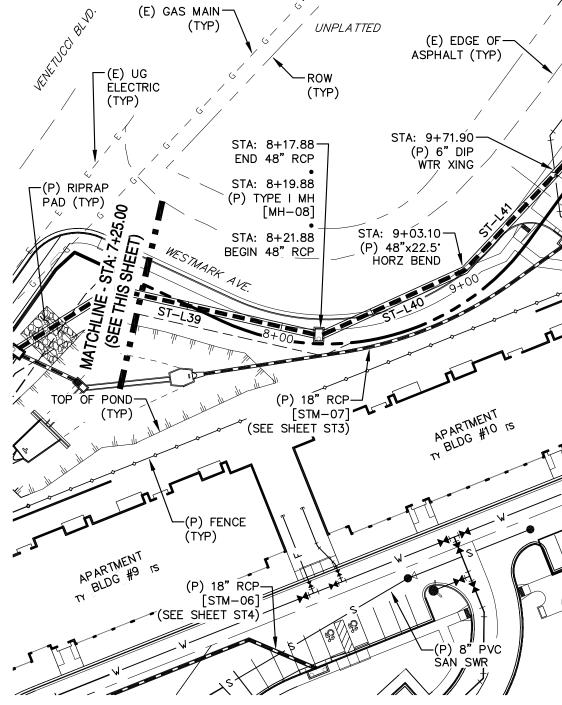


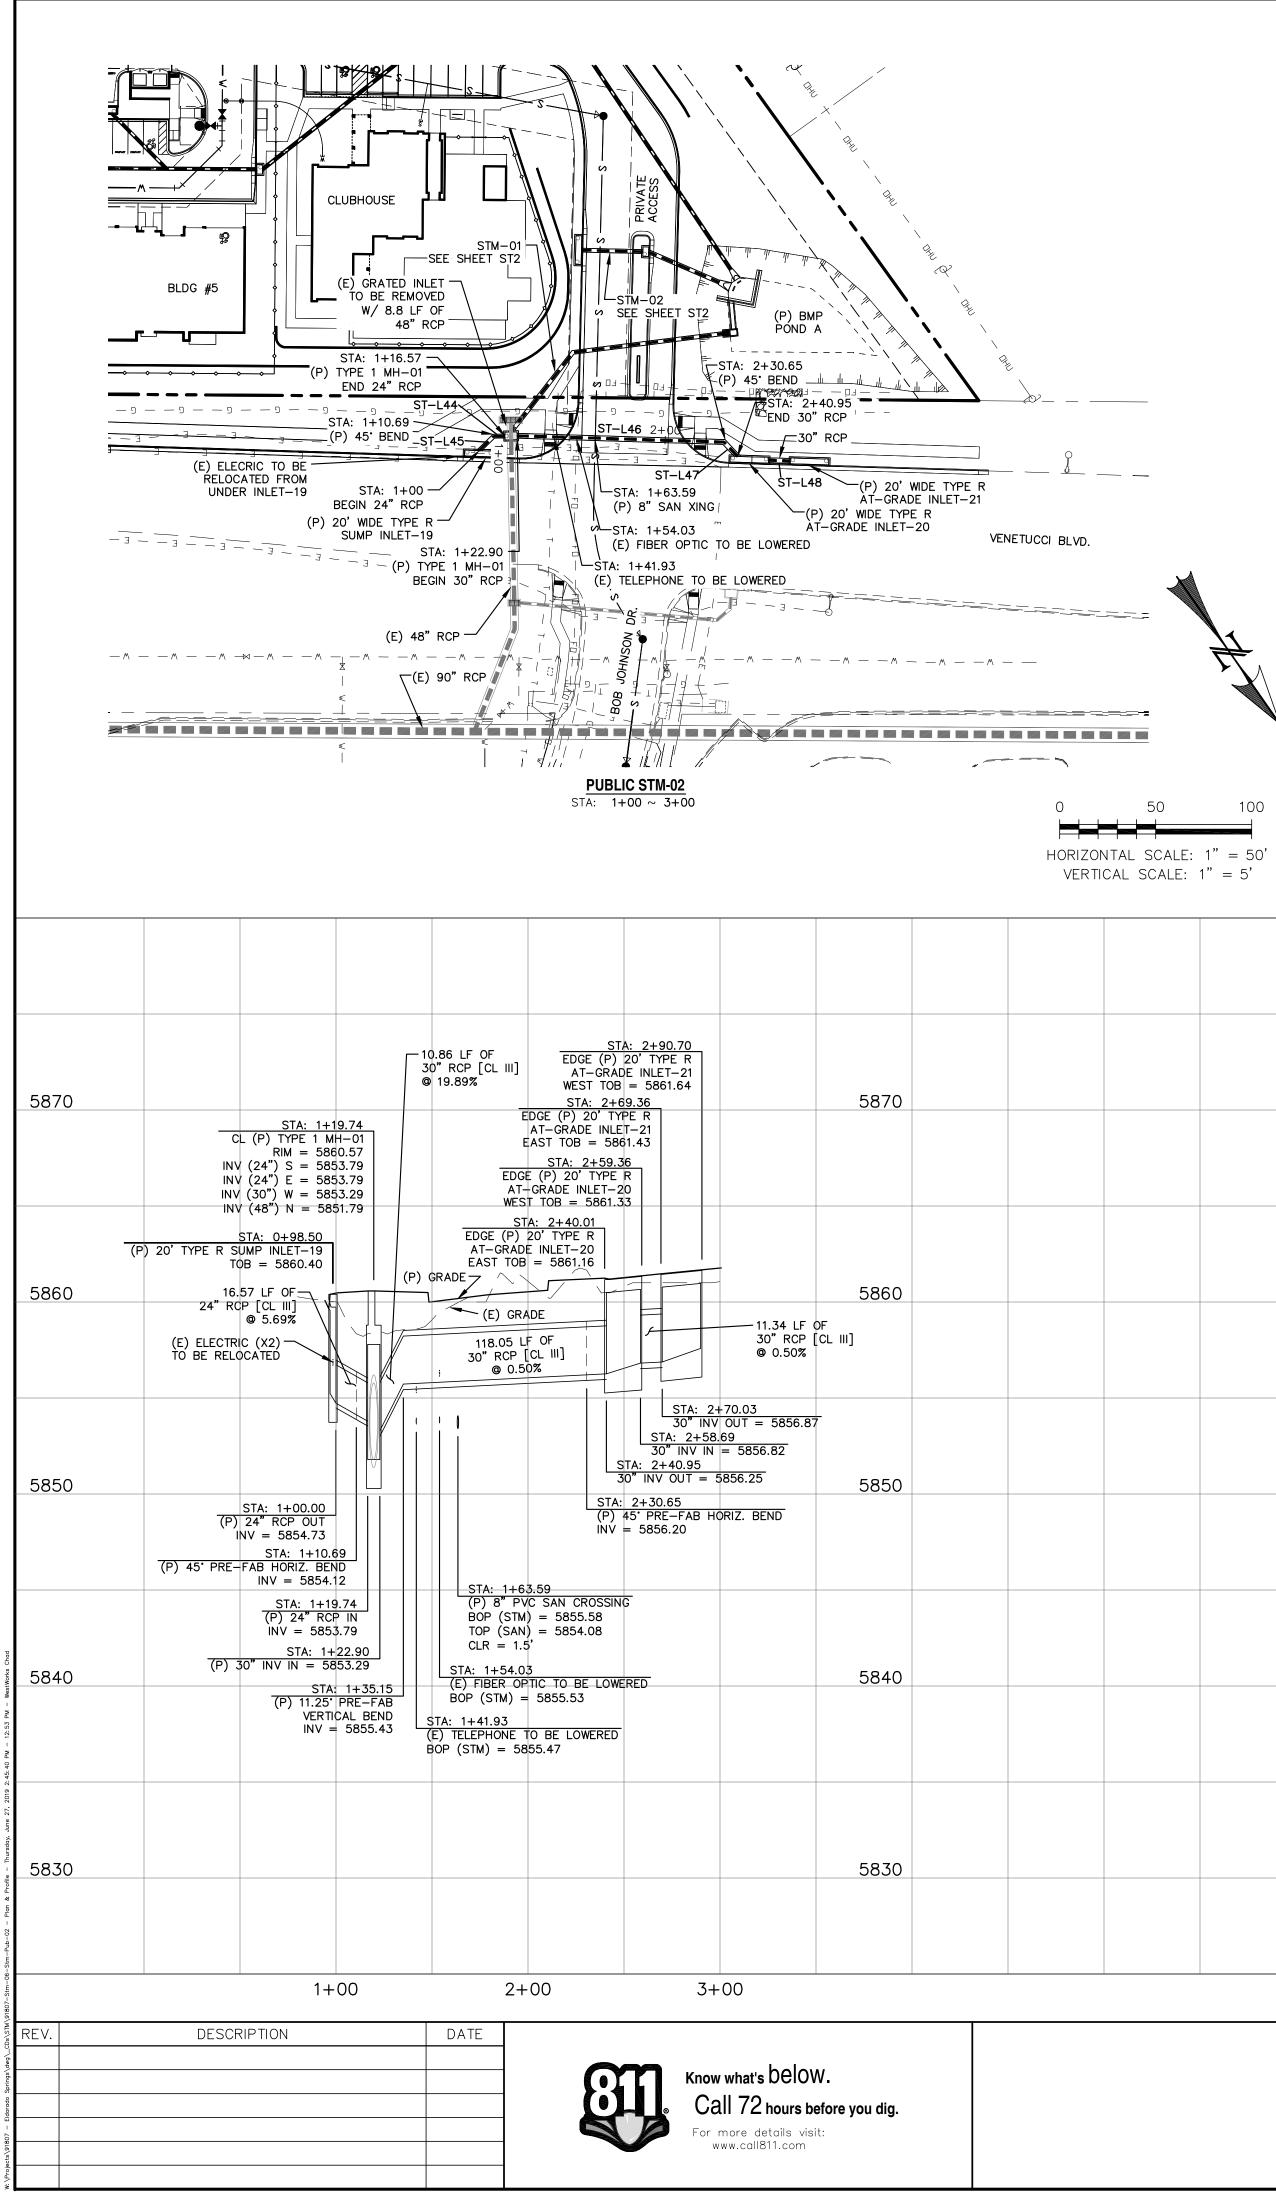

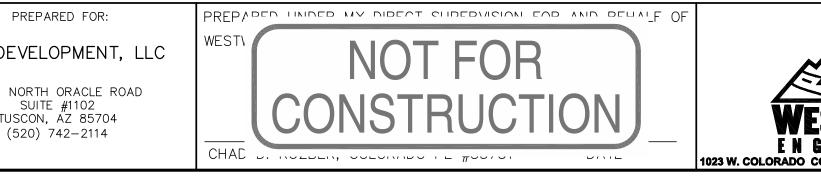


| ESH | D | EVEL | DPI | MEN | ١T, | LLC |
|-----|---|----------------|-----|-----|-----|-----|
| 567 | | NORTH SUITE | #1 | 102 | | AD |

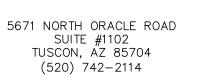

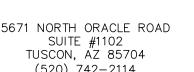


| LINE | TABLE – STO | DRM |
|--------|----------------------|----------|
| LINE | BEARING | DISTANCE |
| ST-L44 | S56°06'50"E | 5.87 |
| ST-L45 | N80'32'59"E | 10.69 |
| ST-L46 | N53 ° 16'45"W | 107.76 |
| ST-L47 | N08'16'45"W | 10.30 |
| ST-L48 | N53°16'45"W | 11.34 |


| | ELDORADO SPRINGS | DESIGNED BY: MGP | drawn by: CDK | |
|--|-----------------------------|------------------|------------------|--|
| | | SCALE: 1"=50' | DATE: 06/27/19 | |
| | STORM SEWER PLAN & PROFILES | JOB NUMBER | SHEET | |
| ESIWURKS GINEERING COLORADO SPRINGS, CO 80904 (719) 685-1670 | PUBLIC STM-02 | 91807 | ST6 OF 9 | |

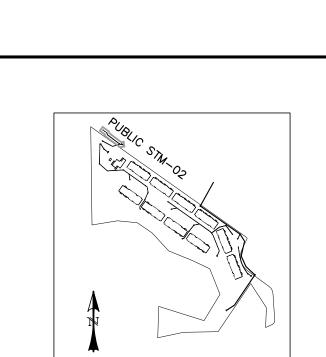


KEY MAP SCALE: N.T.S.

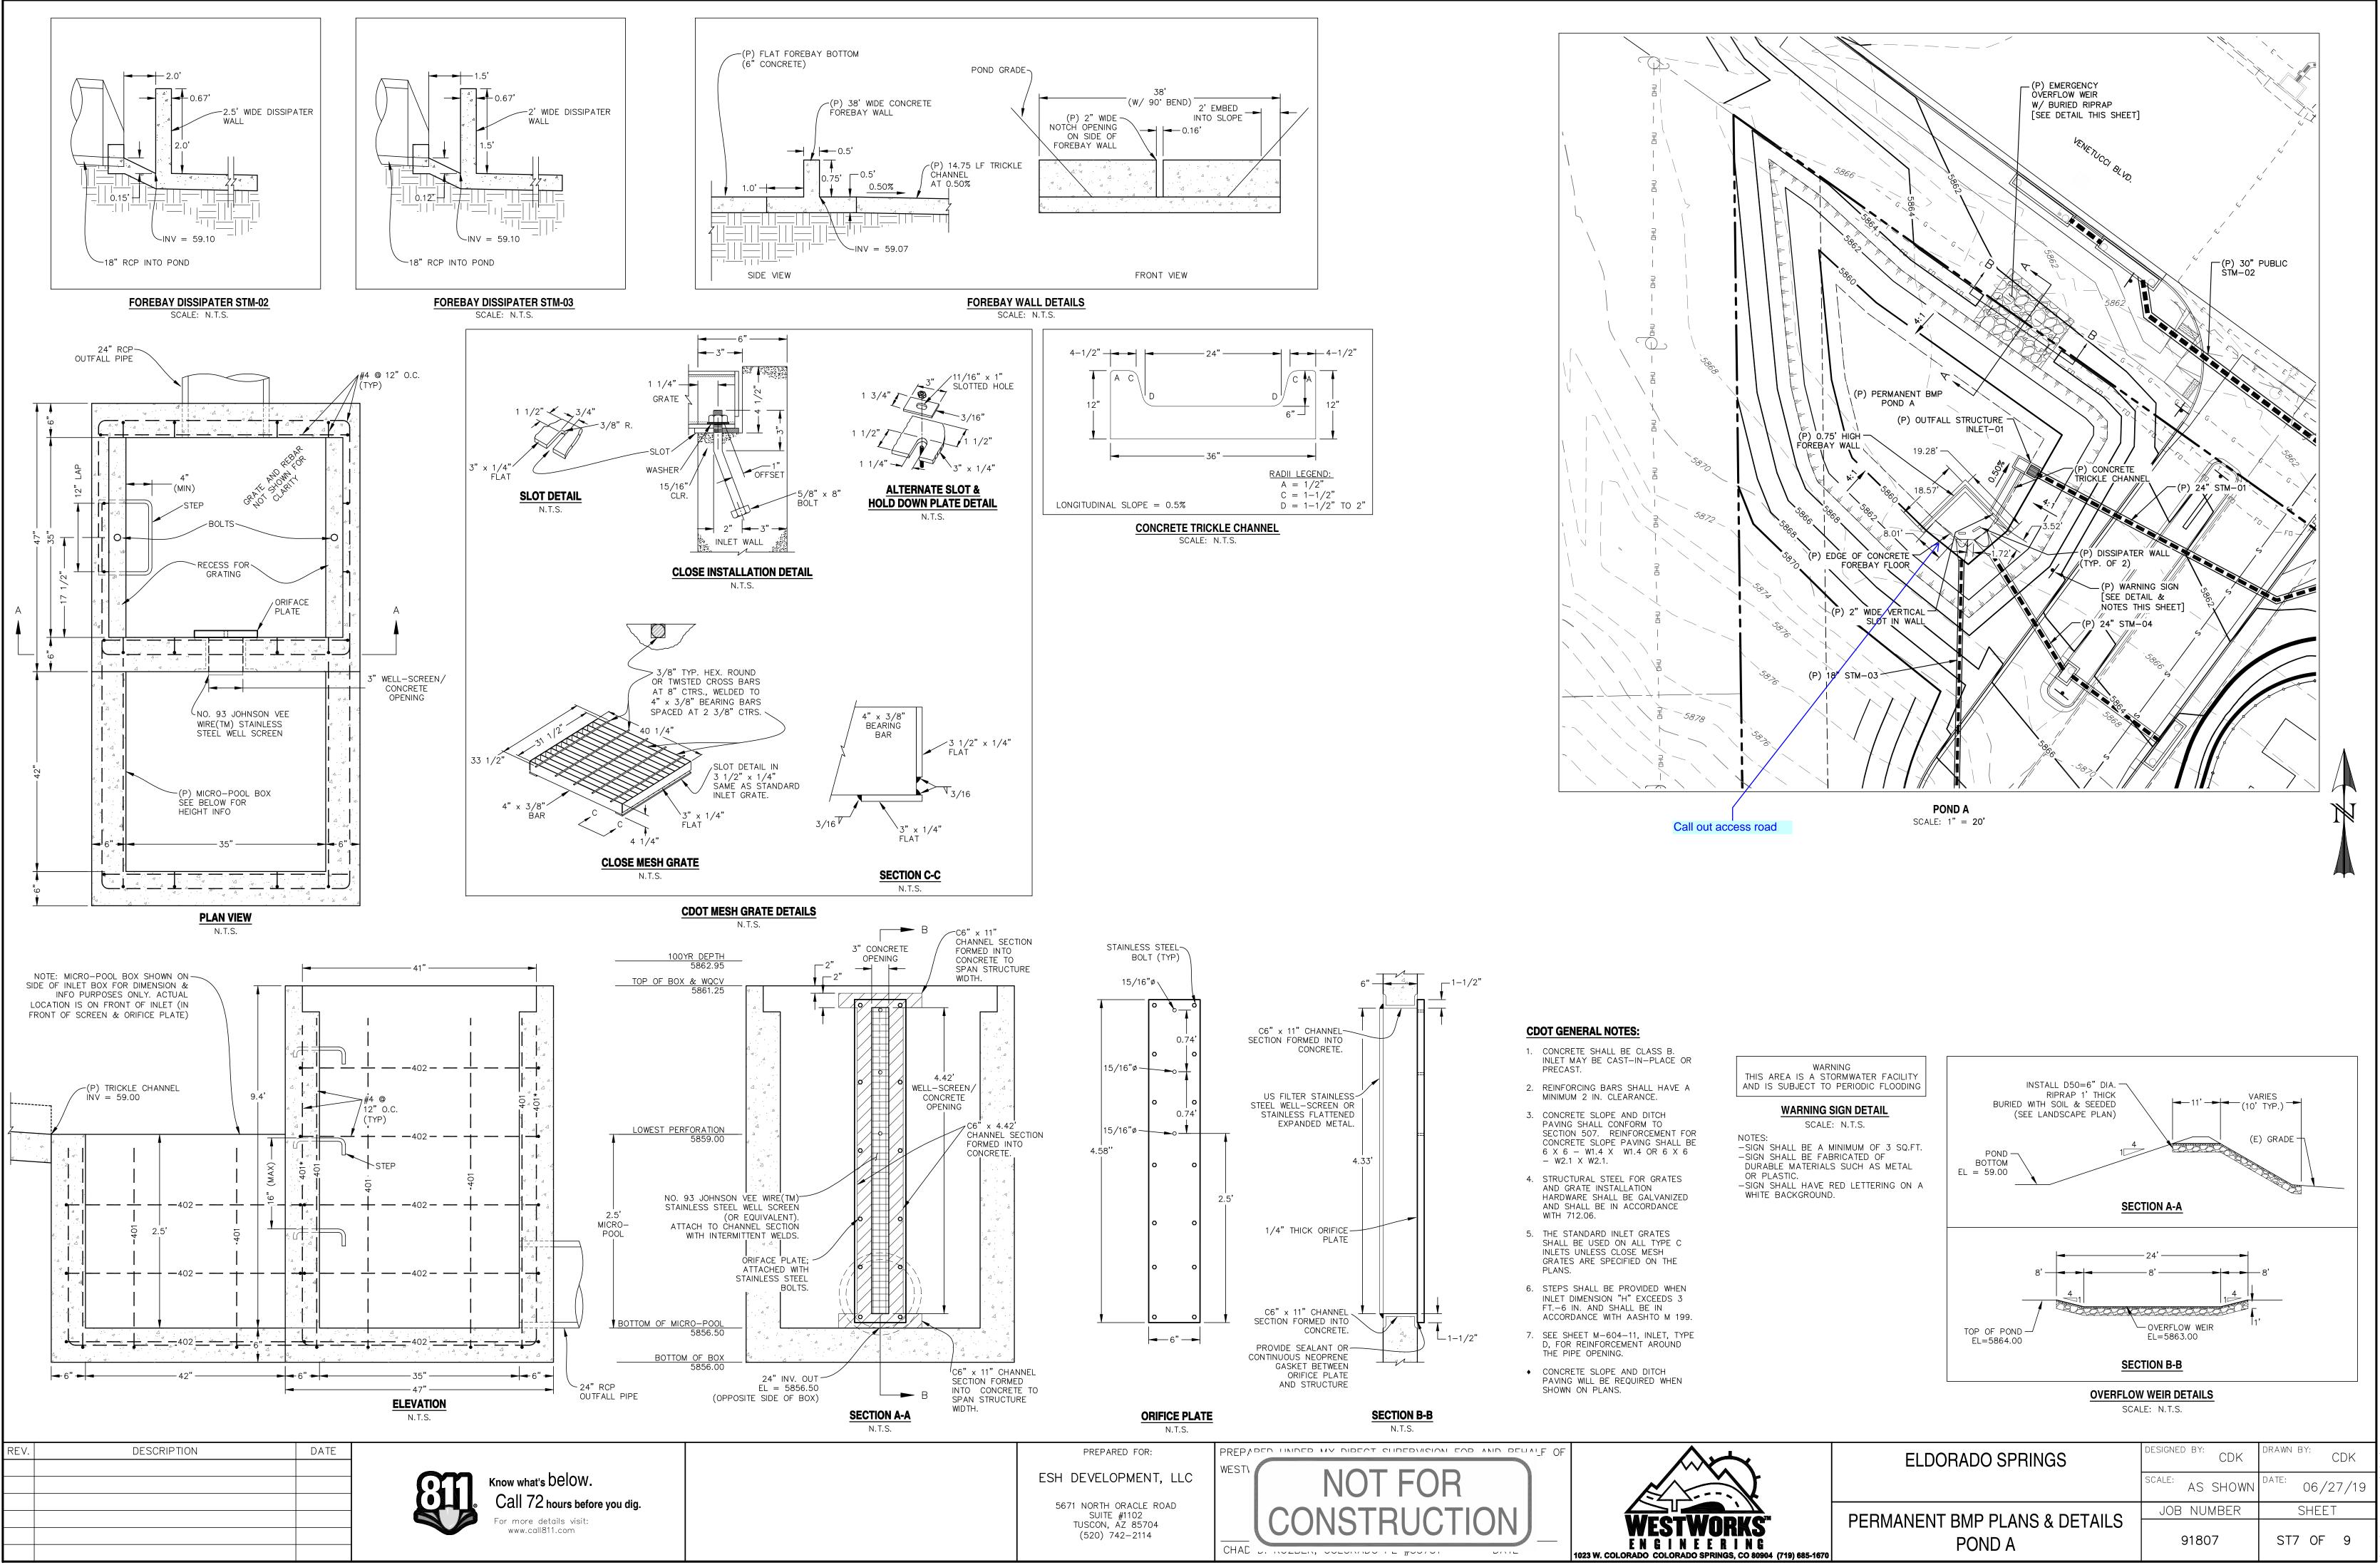

sets/91807 – Eldarada Springs/dwg/_CDs/STM/91807-Stm-07-Pond A - POND A - Thursday, June 27, 2019 2:45:56 PM - 12:53 PW

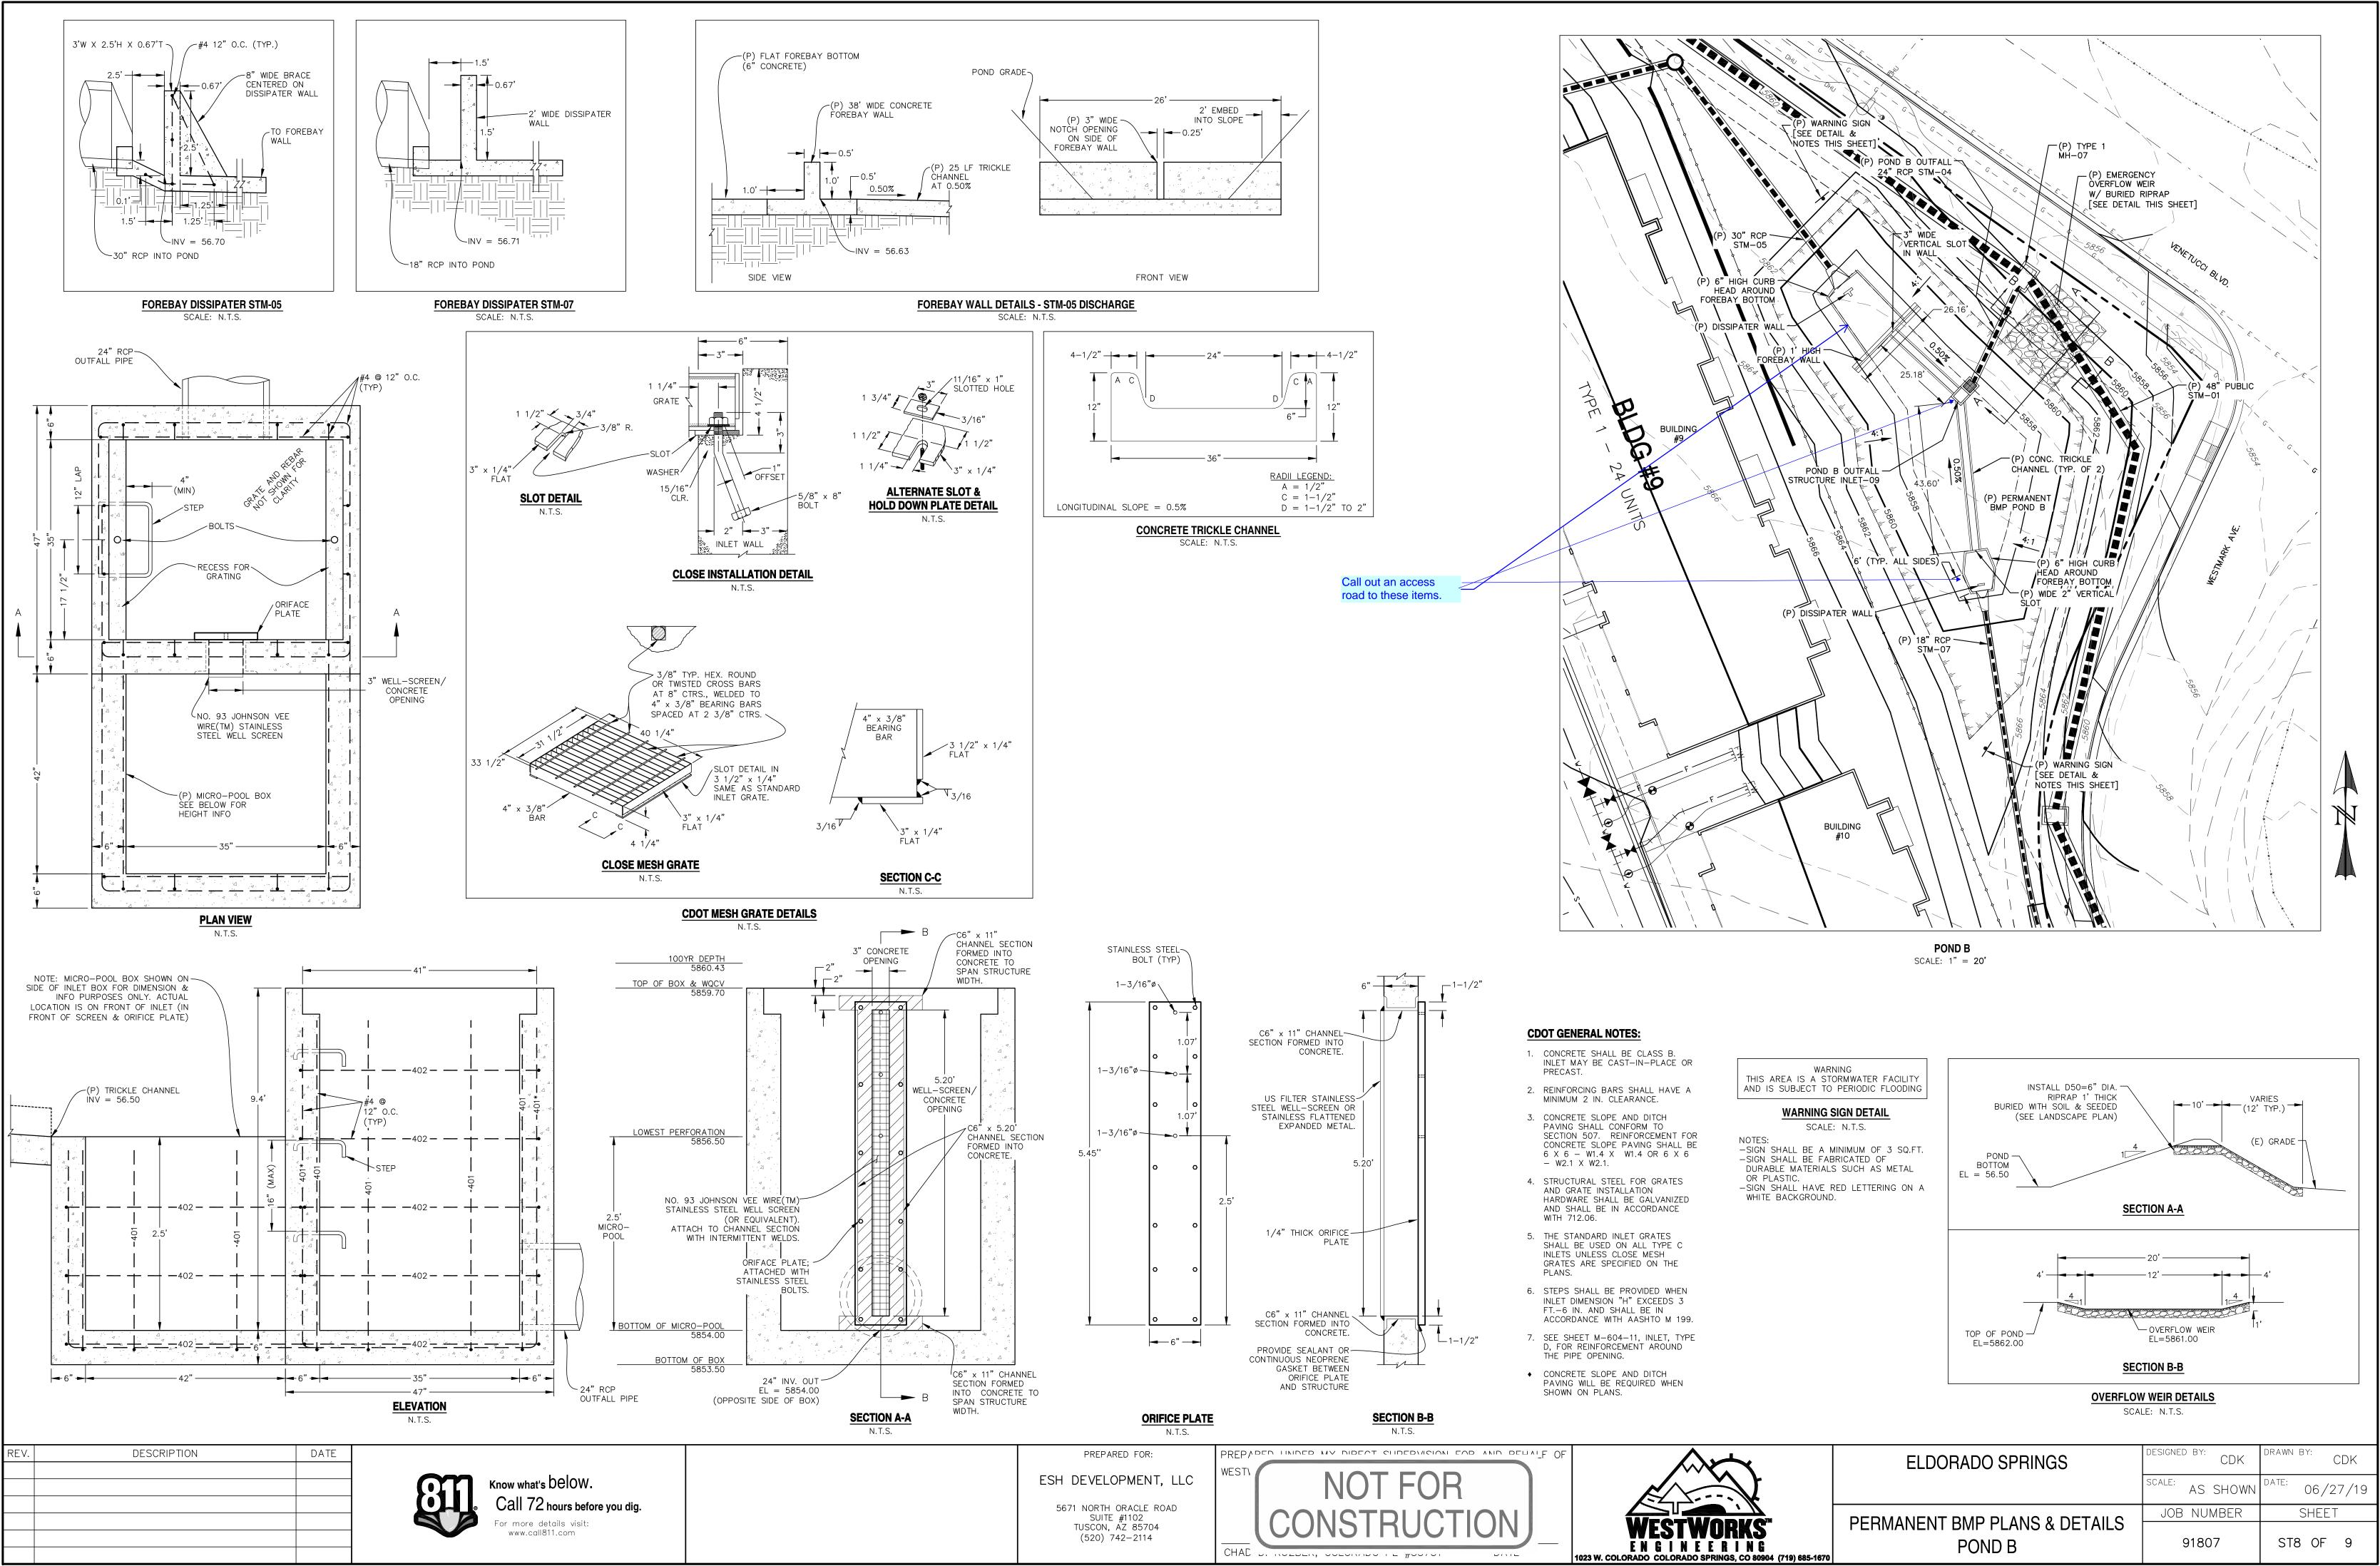


Projects/91807 – Eldorado Springs/dwg_C0s/STM/91807-Stm-08-Pond B – POND B – Thursdoy, June 27, 2019 2:46:11 PM – 12:53 PM – WestWorks Chao

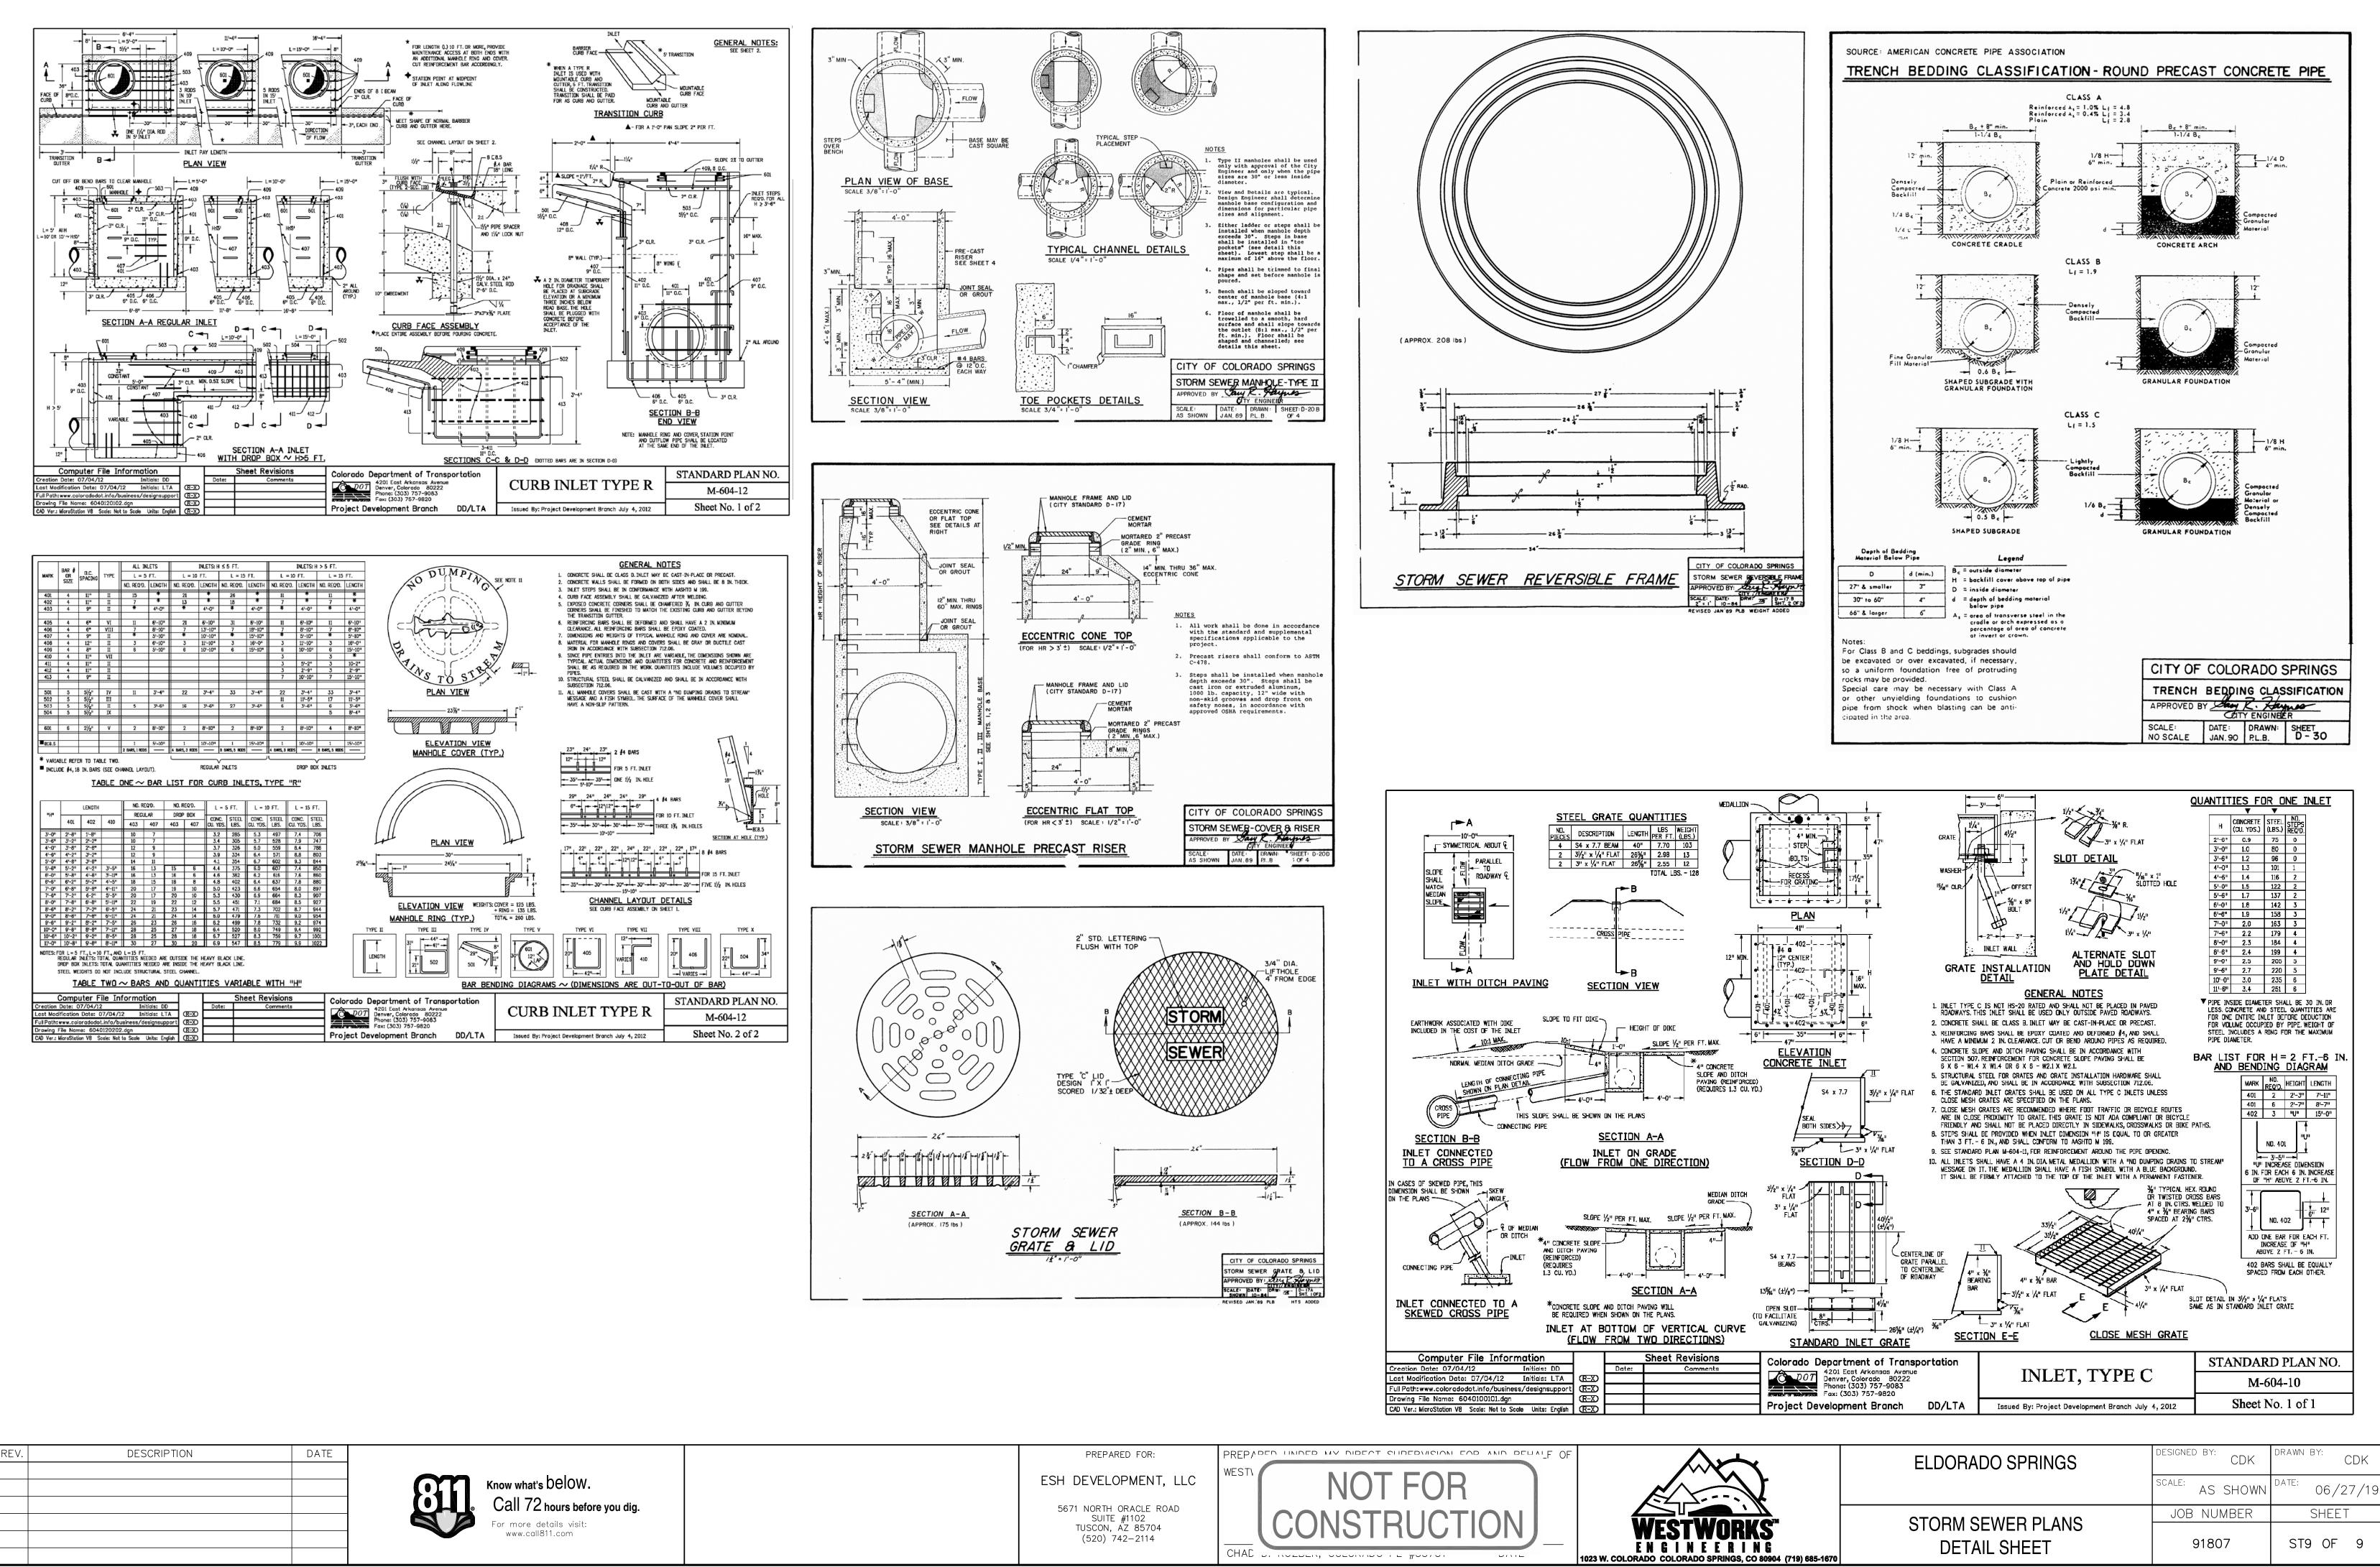


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Markup Summary



| | Subject: Arrow Page Label: 3 Lock: Locked Author: Steve Kuehster Date: 8/13/2019 2:38:21 PM Color: | |
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| Call out Lane Widths. | Subject: text box Page Label: 4 Lock: Locked Author: Steve Kuehster Date: 8/13/2019 2:38:22 PM Color: | Call out Lane Widths. |
| MIT NOTITI GRACI FINO, SUIT 1102 DIATY CHART (SQ) 74-2116 BETTO CHART (SQ) 74-2116 BETTO CHART (SQ) 74-2116 BETTO CHART (SQ) 74-2116 COLLARS OF STRONG OF DRAMA-1170 COLLARS OF STRONG OF DRAMA-1170 COLLARS OF STRONG OF DRAMA-1170 COLLARS OF STRONG OF DRAMA-1170 BETTO CHART OF STRONG OF DRAMA (TH) 53-789 BETALOOK OF LIE MERE & SURFACE OF STRONG CTU 53-789 BETALOOK ULLI MERE & SURFACE OF STRONG CTU 53-789 BETALOOK ULLI MERE & SURFACE OF STRONG CTU 53-789 | Subject: Pen Page Label: 6 Lock: Locked Author: Steve Kuehster Date: 8/13/2019 2:38:23 PM Color: | |
| And | Subject: text box Page Label: 6 Lock: Locked Author: Steve Kuehster Date: 8/13/2019 2:38:23 PM Color: | In accordance with ECM Section 1.12, these construction documents will be valid for construction for a period of 2 years from the date signed by the EI Paso County Engineer. If construction has not started within those 2 years, the plans will need to be resubmitted for approval, including payment of review fees at the Planning and Community Development Directors discretion |
| UCTON SHALL REMAIN WITHIN THE PROPERTY MENTS, WHERE REQUERED, FROM ADJOINNG PH Update notes to the latest version (updated 7/2019 see PDC Engineering website. Xouthock unit, a construction repair is ortal Proce constructions rets shall and to call or proce of the state of the shall and the shall and the proce constructions rets shall update of p | Subject: text box Page Label: 6 Lock: Locked Author: Steve Kuehster Date: 8/13/2019 2:38:24 PM Color: | Update notes to the latest version (updated 7/2019 see PDC Engineering website. |
| Show location of Utiliais that will be crossed. Typical comment. | Subject: text box Page Label: 10 Lock: Locked Author: Steve Kuehster Date: 8/13/2019 2:38:25 PM Color: | Show location of Utilities that will be crossed. Typical comment. |
| | Subject: arrow & box Page Label: 12 Lock: Locked Author: Steve Kuehster Date: 8/13/2019 2:38:26 PM Color: | Call out access road |
| | Subject: Arrow Page Label: 13 Lock: Locked Author: Steve Kuehster Date: 8/13/2019 2:38:27 PM Color: | |

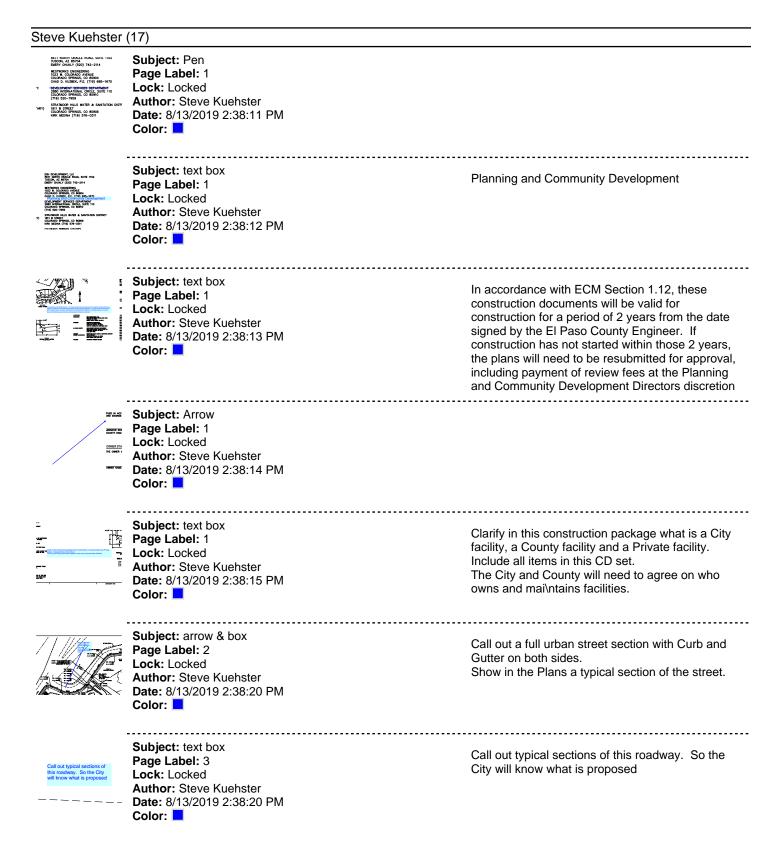

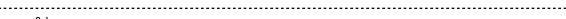

Subject: arrow & box Page Label: 13 Lock: Locked Author: Steve Kuehster Date: 8/13/2019 2:38:27 PM Color:

Call out an access road to these items.



Subject: Arrow Page Label: 13 Lock: Locked Author: Steve Kuehster Date: 8/13/2019 2:38:27 PM Color: