
DWG No.	SHEET		
TS01 GN01 SS01-SS10 SS11-SS13	WASTE	SHEET1CAL NOTES, LEGEND & ABBREVIATIONS2EWATER PLAN & PROFILE3-12ARY SERVICE PLAN13-15	
OWNER/DEVEL	OPER.	COLA, LLC 555 MIDDLE CREEK PARKWAY, SUITE 380 COLORADO SPRINGS, CO 80921	
CIVIL ENGINEE	R	MATRIX DESIGN GROUP 2435 RESEARCH PARKWAY, SUITE 300 COLORADO SPRINGS, CO 80920	
WATER & SANI	TARY SEWER	WIDEFIELD WATER AND SANITATION DISTRICT 8495 FONTAINE BOULEVARD COLORADO SPRINGS, CO 80925 ROBERT BANNISTER, (719) 390-7111	
ELECTRIC		MOUNTAIN VIEW ELECTRIC ASSOCIATION (719) 495-2283	
GAS		COLORADO SPRINGS UTILITIES 1521 HANCOCK EXPRESSWAY COLORADO SPRINGS, CO MARY HOAGLUND (719) 668-4083	
STREET		EL PASO COUNTY PUBLIC SERVICES DEPARTMENT (719) 520-6460	
DRAINAGE		EL PASO COUNTY PUBLIC SERVICES DEPARTMENT (719) 520-6460	
FIRE DEPARTM	ENT	SECURITY FIRE DEPARTMENT 400 SECURITY BOULEVARD SECURITY, CO 80911	
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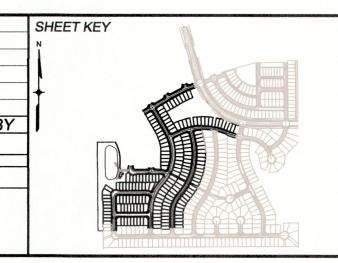
PLOT DATE: March 1, 2022 12:53:21 PM

THIS DRAWING IS CURRENT AS OF PLOT DATE AND MAY BE SUBJECT TO CHANGE.

S AT ASPEN RIDGE - FILING NO. 3 EL PASO COUNTY, COLORADO **8" PUBLIC SANITARY MAIN PLANS MARCH 2022**

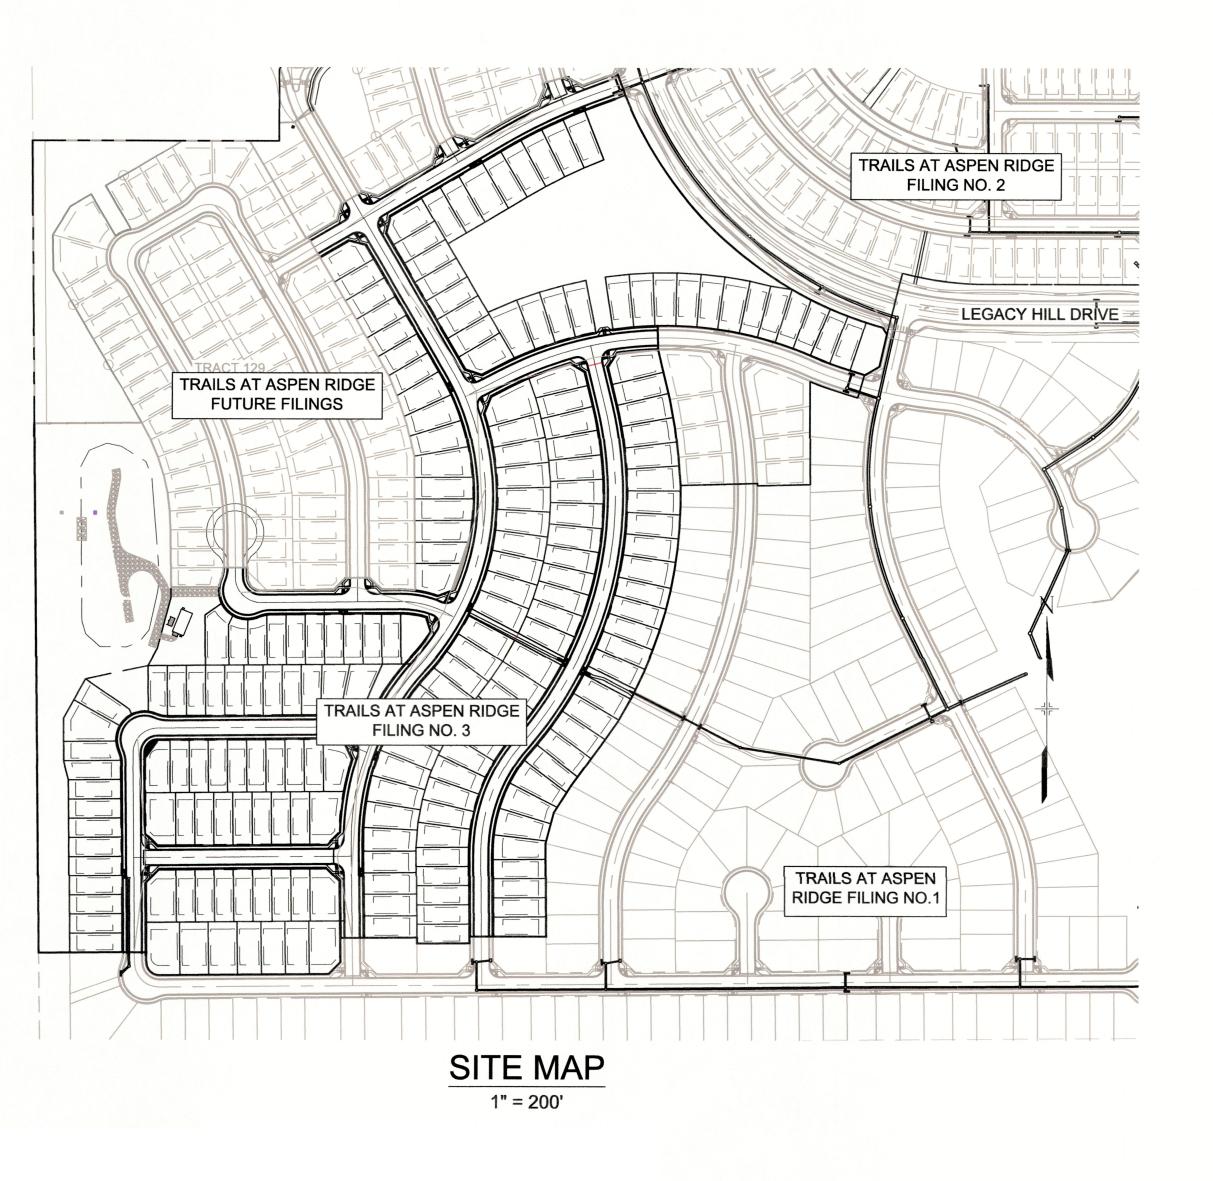

THE LOCATIONS OF EXISTING ABOVE GROUND AND UNDERGROUND UTILITIES ARE SHOWN IN AN APPROXIMATE WAY ONLY. THE CONTRACTOR SHALL DETERMINE THE EXACT LOCATION OF ALL EXISTING UTILITIES BEFORE COMMENCING WORK. THE CONTRACTOR SHALL BE FULLY RESPONSIBLE FOR ANY AND ALL DAMAGES WHICH MIGHT BE CAUSED BY HIS FAILURE TO EXACTLY LOCATE AND PRESERVE ANY AND ALL ABOVE GROUND AND UNDERGROUND UTILITIES.



BENCHMARK COLORADO SPRINGS UTILITIES (FIMS) MONUMENT F206


A BERNTSEN TOP SECURITY MONUMENT SYSTEM WITH A 3.5-INCH DIAMETER ALUMINUM CAP IN A ROAD BOX, LOCATED ON THE NORTHWEST CORNER OF FONTAINE BOULEVARD AND POWERS BOULEVARD,

ELEVATION - 5897.89' U.S. SURVEY FT

BASIS OF BEARING

BEARINGS ARE BASED ON THE NURTH LINE OF THE 6TH P.M. SAID LINE BEARS S89°51'23"E FROM THE TOWNSHIP 15 SOUTH, RANGE 65 WEST OF THE 6TH P.M. SAID LINE BEARS S89°51'23"E FROM THE NORTHWEST CORNER OF SAID SECTION 9 (2 ½" AULM. CAP PLS 17664) TO THE N ½ CORNER OF SAID SECTION 9 (2 ½" AULM. CAP PLS 17664) TO THE N ½ CORNER OF SAID SECTION 9 (2 ½" AULM. CAP PLS 17664) TO THE N ½ CORNER OF SAID SECTION 9 (2 ½" AULM. CAP PLS 17664) TO THE N ½ CORNER OF SAID SECTION 9 (2 ½" AULM. CAP PLS 17664) TO THE N ½ CORNER OF SAID SECTION 9 (2 ½" AULM. CAP PLS 17664) TO THE N ½ CORNER OF SAID SECTION 9 (2 ½" AULM. CAP PLS 17664) TO THE N ½ CORNER OF SAID SECTION 9 (2 ½" AULM. CAP PLS 17664) TO THE N ½ CORNER OF SAID BEARINGS ARE BASED ON THE NORTH LINE OF THE NORTHWEST QUARTER OF SECTION 9,

PREPARED BY:

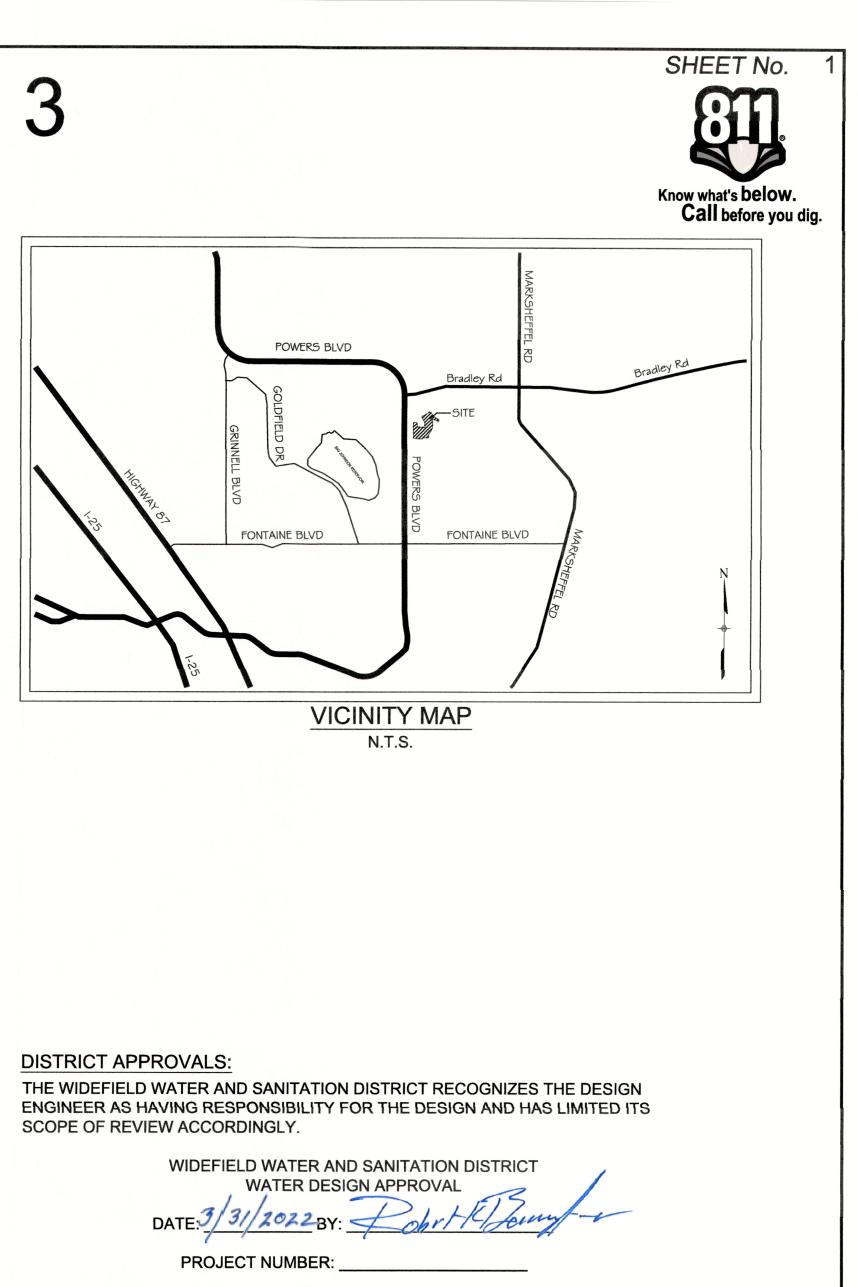

IN CASE OF ERRORS OR OMISSIONS WITH THE WATER DESIGN AS SHOWN ON THIS DOCUMENT THE STANDARDS AS DEFINED IN THE "RULES AND REGULATIONS FOR INSTALLATION OF WATER MAINS AND SERVICES" SHALL RULE.

APPROVAL EXPIRES 180 DAYS FROM DESIGN APPROVAL

WATER AND SANITARY SEWER APPROVAL

ANY CHANGES OR ALTERATIONS AFFECTING THE GRADE, ALIGNMENT, ELEVATION, AND/OR DEPTH OF COVER OF ANY WATER OR SEWER MAINS OR OTHER APPURTENANCE SHOWN ON THIS DRAWING SHALL BE THE RESPONSIBILITY OF THE OWNER/DEVELOPER. THE OWNER/DEVELOPER SHALL BE RESPONSIBLE FOR ALL OPERATION DAMAGES AND DEFECTS IN INSTALLATION AND MATERIAL FOR MAINS AND SERVICES FROM THE DATE OF APPROVAL UNTIL FINAL ACCEPTANCE IS ISSUED.

SIGNED DATE 3/1/22 DATE 3/1/22	
PRINT NAME TIM BUSCHAR	
DBA COLA, LLC	
ADDRESS 555 MIDDLE CREEK PARKWAY, SUME SOO	
ADDRESS 555 MIDDLE CREEK PARKWAY, SUME SOO COLORADO SPRINGS, CO 80921	
SEAL TRAILS AT ASPEN RIDGE	
FILING NO. 3 57/27/2022 52434 FILING NO. 3 8" SANITARY SEWER PLANS	
TITLE SHEET	
FOR AND ON BEHALF OF MATRIX DESIGN GROUP, INC. DESIGNED BY: BAS SCALE DATE ISSUED: MARCH 2022 DRA PROJECT No. 20.886.028 CHECKED BY: NMS VERT. N/A SHEET 1 OF 15 Drawn by: 1 OF 15	WING NO. TS01

WIDEFIELD WATER AND SANITATION DISTRICT GENERAL NOTES

- 1. ALL UTILITY CONSTRUCTION TO BE CONDUCTED IN CONFORMANCE WITH THE CURRENT WIDEFIELD WATER AND SANITATION DISTRICT SPECIFICATIONS. COMPACTION REQUIREMENTS SHALL BE 95% STANDARD PROCTOR AS DETERMINED BY ASTM D698, UNLESS OTHERWISE APPROVED BY THE WIDEFIELD WATER AND SANITATION DISTRICT OR A HIGHER STANDARD IS IMPOSED BY ANOTHER AGENCY HAVING RIGHT-OF-WAY JURISDICTION.
- 2. ALL MATERIALS AND WORKMANSHIP SHALL BE SUBJECT TO INSPECTION BY THE WIDEFIELD WATER AND SANITATION DISTRICT. THE WIDEFIELD WATER AND SANITATION DISTRICT RESERVES THE RIGHT TO ACCEPT OR REJECT ANY SUCH MATERIALS AND WORKMANSHIP THAT DOES NOT CONFORM TO ITS STANDARDS AND SPECIFICATIONS
- 3. THE DEVELOPER OR HIS ENGINEER HAS LOCATED ALL FIRE HYDRANTS AND FUTURE SERVICE STUBS. ANY REQUIRED REALIGNMENT, EITHER HORIZONTAL OR VERTICAL, SHALL BE AT THE EXPENSE OF THE DEVELOPER.
- 4. ALL DUCTILE IRON PIPE, TO INCLUDE FITTINGS, VALVES AND FIRE HYDRANTS WILL BE WRAPPED WITH POLYETHYLENE TUBING, AND ELECTRICALLY ISOLATED.
- 5. ALL DUCTILE IRON PIPE AND FITTINGS SHALL BE DOUBLE BONDED. SPECIFICATIONS FOR CATHODIC PROTECTION ON BOTH DIP MAINS AND PVC MAINS IS SPECIFIED IN THE STANDARDS AND SPECIFICATIONS.
- 6. PVC MAIN LINES SHALL BE INSTALLED WITH COATED NO. 12 TRACER WIRE
- 7. THE CONTRACTOR IS REQUIRED TO NOTIFY THE WIDEFIELD WATER AND SANITATION DISTRICT (390-7111) A MINIMUM OF 48 HOURS AND A MAXIMUM OF 96 HOURS PRIOR TO THE START OF CONSTRUCTION. THE CONTRACTOR SHALL ALSO NOTIFY AFFECTED UTILITY COMPANIES 48 HOURS PRIOR TO CONSTRUCTION ADJACENT TO THE KNOWN UTILITY LINES.
- 8. THE LOCATION OF ALL UTILITIES AS SHOWN ON THESE DRAWINGS ARE APPROXIMATE ONLY. THE LOCATION OF ALL UTILITIES SHALL BE VERIFIED PRIOR TO CONSTRUCTION BY THE CONTRACTOR.
- 9. THE CONTRACTOR SHALL FIELD EXCAVATE AND VERIFY THE VERTICAL AND HORIZONTAL LOCATION OF ALL TIE-INS. CONTRACTOR SHALL NOTIFY THE WIDEFIELD WATER AND SANITATION DISTRICT AND THE ENGINEER OF THE FIELD VERIFIED INFORMATION PRIOR TO CONSTRUCTION.
- 10. ALL BENDS SHALL BE FIELD STAKED PRIOR TO CONSTRUCTION.
- 11. ANY WATER UTILITY MATERIAL REMOVED AND NOT REUSED SHALL BE RETURNED TO THE WIDEFIELD WATER AND SANITATION DISTRICT IF THE DISTRICT SO REQUESTS.
- 12. THE CONTRACTOR SHALL AT HIS EXPENSE SUPPORT AND PROTECT ALL UTILITY MAINS SO THAT THEY WILL FUNCTION CONTINUOUSLY DURING CONSTRUCTION. SHOULD A UTILITY MAIN FAIL AS A RESULT OF THE CONTRACTOR'S OPERATION, IT WILL BE REPLACED IMMEDIATELY BY EITHER THE CONTRACTOR OR THE WIDEFIELD WATER AND SANITATION DISTRICT AT FULL COST OF LABOR AND MATERIALS TO THE CONTRACTOR.
- 13. ANY PUMPING OR BYPASS OPERATIONS MUST BE REVIEWED AND APPROVED PRIOR TO EXECUTION BY BOTH THE WIDEFIELD WATER AND SANITATION DISTRICT AND THE ENGINEER.
- 14. CONTRACTOR MUST REPLACE OR REPAIR ANY DAMAGE TO ALL SURFACE IMPROVEMENTS, INCLUDING BUT NOT LIMITED TO FENCES, CURB AND GUTTER AND/OR ASPHALT THAT MAY BE CAUSED DURING CONSTRUCTION.
- 15. ALL WATER LINES 6" AND LARGER, AND ALL SEWER LINES 8" AND LARGER, SHALL HAVE AS "AS-BUILT" PLANS PREPARED AND APPROVED PRIOR TO FINAL ACCEPTANCE BY THE WIDEFIELD WATER AND SANITATION DISTRICT.
- 16. PRIOR TO CONSTRUCTION, A PRE-CONSTRUCTION CONFERENCE IS REQUIRED A MINIMUM OF 72 HOURS IN ADVANCE OF COMMENCEMENT OF WORK. TO SET THE PRE-CONSTRUCTION CONFERENCE, CONTACT BRANDON BERNARD-WATER DIVISION MANAGER AND/OR JASON DREESSEN, WASTEWATER DIVISION MANAGER AT (719)955-0548 OF THE WIDEFIELD WATER AND SANITATION DISTRICT FOR A TIME. NO PRE-CONSTRUCTION CONFERENCE TIMES WILL BE SET UNTIL 4 SETS OF SIGNED DRAWINGS ARE RECEIVED BY THE WIDEFIELD W & S DISTRICT. PRE-CONSTRUCTION DATE/INITIALS

EL PASO COUNTY STANDARD CONSTRUCTION NOTES:

- 1. ALL DRAINAGE AND ROADWAY CONSTRUCTION SHALL MEET THE STANDARDS AND SPECIFICATIONS OF THE CITY OF COLORADO SPRINGS/EL PASO COUNTY DRAINAGE MANUAL.
- CONTRACTOR SHALL BE RESPONSIBLE FOR THE NOTIFICATION AND FIELD NOTIFICATION OF ALL EXISTING UTILITIES, WHETHER SHOWN ON THE PLANS OR NOT, BEFORE BEGINNING CONSTRUCTION. LOCATION OF EXISTING UTILITIES SHALL BE VERIFIED BY THE CONTRACTOR PRIOR TO CONSTRUCTION. CALL 811 TO CONTACT THE UTILITY NOTIFICATION CENTER OF COLORADO (UNCC).
- CONTRACTOR SHALL KEEP A COPY OF THESE APPROVED PLANS, THE GRADING AND 3 EROSION CONTROL PLAN, THE STORMWATER MANAGEMENT PLAN (SWMP), THE SOILS AND GEOTECHNICAL REPORT. AND THE APPROPRIATE DESIGN AND CONSTRUCTION STANDARDS AND SPECIFICATIONS AT THE JOB SITE AT ALL TIMES, INCLUDING THE FOLLOWING:
- a. EL PASO COUNTY ENGINEERING CRITERIA MANUAL (ECM) b. CITY OF COLORADO SPRINGS/EL PASO COUNTY DRAINAGE CRITERIA MANUAL, VOLUMES 1 AND 2
- FOR ROAD AND BRIDGE CONSTRUCTION
- d. CDOT M & S STANDARDS
- 4. NOTWITHSTANDING ANYTHING DEPICTED IN THESE PLANS IN WORDS OR GRAPHIC REPRESENTATION, ALL DESIGN AND CONSTRUCTION RELATED TO ROADS, STORM DRAINAGE AND EROSION CONTROL SHALL CONFORM TO THE STANDARDS AND COUNTY STANDARDS, INCLUDING THE LAND DEVELOPMENT CODE, THE ENGINEERING CRITERIA MANUAL, THE DRAINAGE CRITERIA MANUAL, AND THE DRAINAGE CRITERIA MANUAL VOLUME 2. ANY DEVIATIONS FROM REGULATIONS AND STANDARDS MUST BE REQUESTED, AND APPROVED, IN WRITING. ANY MODIFICATIONS NECESSARY TO MEET CRITERIA AFTER-THE-FACT WILL BE ENTIRELY THE DEVELOPER'S RESPONSIBILITY TO RECTIFY.
- IT IS THE DESIGN ENGINEER'S RESPONSIBILITY TO ACCURATELY SHOW EXISTING CONDITIONS, BOTH ONSITE AND OFFSITE, ON THE CONSTRUCTION PLANS. ANY WILL BE ENTIRELY THE DEVELOPER'S RESPONSIBILITY TO RECTIFY.
- PLANNING AND COMMUNITY DEVELOPMENT (PCD) INSPECTIONS, PRIOR TO STARTING CONSTRUCTION.
- 7. IT IS THE CONTRACTOR'S RESPONSIBILITY TO UNDERSTAND THE REQUIREMENTS OF ALL LIMITED TO EL PASO COUNTY EROSION AND STORMWATER QUALITY CONTROL PERMIT PERMITS.
- CONTRACTOR SHALL NOT DEVIATE FROM THE PLANS WITHOUT FIRST OBTAINING WRITTEN APPROVAL FROM THE DESIGN ENGINEER AND PCD. CONTRACTOR SHALL NOTIFY THE DESIGN ENGINEER IMMEDIATELY UPON DISCOVERY OF ANY ERRORS OR INCONSISTENCIES.
- 9. ALL STORM DRAIN PIPE SHALL BE CLASS III RCP UNLESS OTHERWISE NOTED AND APPROVED BY PCD.
- 10. CONTRACTOR SHALL COORDINATE GEOTECHNICAL TESTING PER ECM STANDARDS. PAVEMENT DESIGN SHALL BE APPROVED BY EL PASO COUNTY PCD PRIOR TO PLACEMENT OF CURB AND GUTTER AND PAVEMENT.
- 11. ALL CONSTRUCTION TRAFFIC MUST ENTER/EXIT THE SITE AT APPROVED CONSTRUCTION ACCESS POINTS.
- 12. SIGHT VISIBILITY TRIANGLES AS IDENTIFIED IN THE PLANS SHALL BE PROVIDED AT ALL ALLOWED WITHIN SIGHT TRIANGLES.
- 13. SIGNING AND STRIPING SHALL COMPLY WITH EL PASO COUNTY DOT AND MUTCD CRITERIA. IIF APPLICABLE. ADDITIONAL SIGNING AND STRIPING NOTES WILL BE PROVIDED.]
- 14. CONTRACTOR SHALL OBTAIN ANY PERMITS REQUIRED BY EL PASO COUNTY DOT, INCLUDING WORK WITHIN THE RIGHT-OF-WAY AND SPECIAL TRANSPORT PERMITS.
- 15. THE LIMITS OF CONSTRUCTION SHALL REMAIN WITHIN THE PROPERTY LINE UNLESS OFF-SITE DISTURBANCE, GRADING, OR CONSTRUCTION.

REFERENCE				
DRAWINGS				
	No.	DATE	DESCRIPTION	BY
			REVISIONS	
	COM	IPUTER FIL	E MANAGEMENT	
	CTB FI PLOT I	LE: Matrix(bl DATE: July 27,	6.028 (Trails F3)\100 Dwg\104 Plan Sets\Construction Plans\Utility Plans\Sanitary Plan\GN01.DWG ack).ctb 2022 11:55:17 AM IS OF PLOT DATE AND MAY BE SUBJECT TO CHANGE.	

CRITERIA MANUAL, VOLUMES 1 AND 2, AND THE EL PASO COUNTY ENGINEERING CRITERIA

c. COLORADO DEPARTMENT OF TRANSPORTATION (CDOT) STANDARD SPECIFICATIONS

REQUIREMENTS OF THE MOST RECENT VERSION OF THE RELEVANT ADOPTED EL PASO


MODIFICATIONS NECESSARY DUE TO CONFLICTS, OMISSIONS, OR CHANGED CONDITIONS

CONTRACTOR SHALL SCHEDULE A PRE-CONSTRUCTION MEETING WITH EL PASO COUNTY


JURISDICTIONAL AGENCIES AND TO OBTAIN ALL REQUIRED PERMITS, INCLUDING BUT NOT (ESQCP), REGIONAL BUILDING FLOODPLAIN DEVELOPMENT PERMIT, U.S. ARMY CORPS OF ENGINEERS-ISSUED 401 AND/OR 404 PERMITS, AND COUNTY AND STATE FUGITIVE DUST

INTERSECTIONS. OBSTRUCTIONS GREATER THAN 18 INCHES ABOVE FLOWLINE ARE NOT


OTHERWISE NOTED. THE OWNER/DEVELOPER SHALL OBTAIN WRITTEN PERMISSION AND EASEMENTS, WHERE REQUIRED, FROM ADJOINING PROPERTY OWNER(S) PRIOR TO ANY

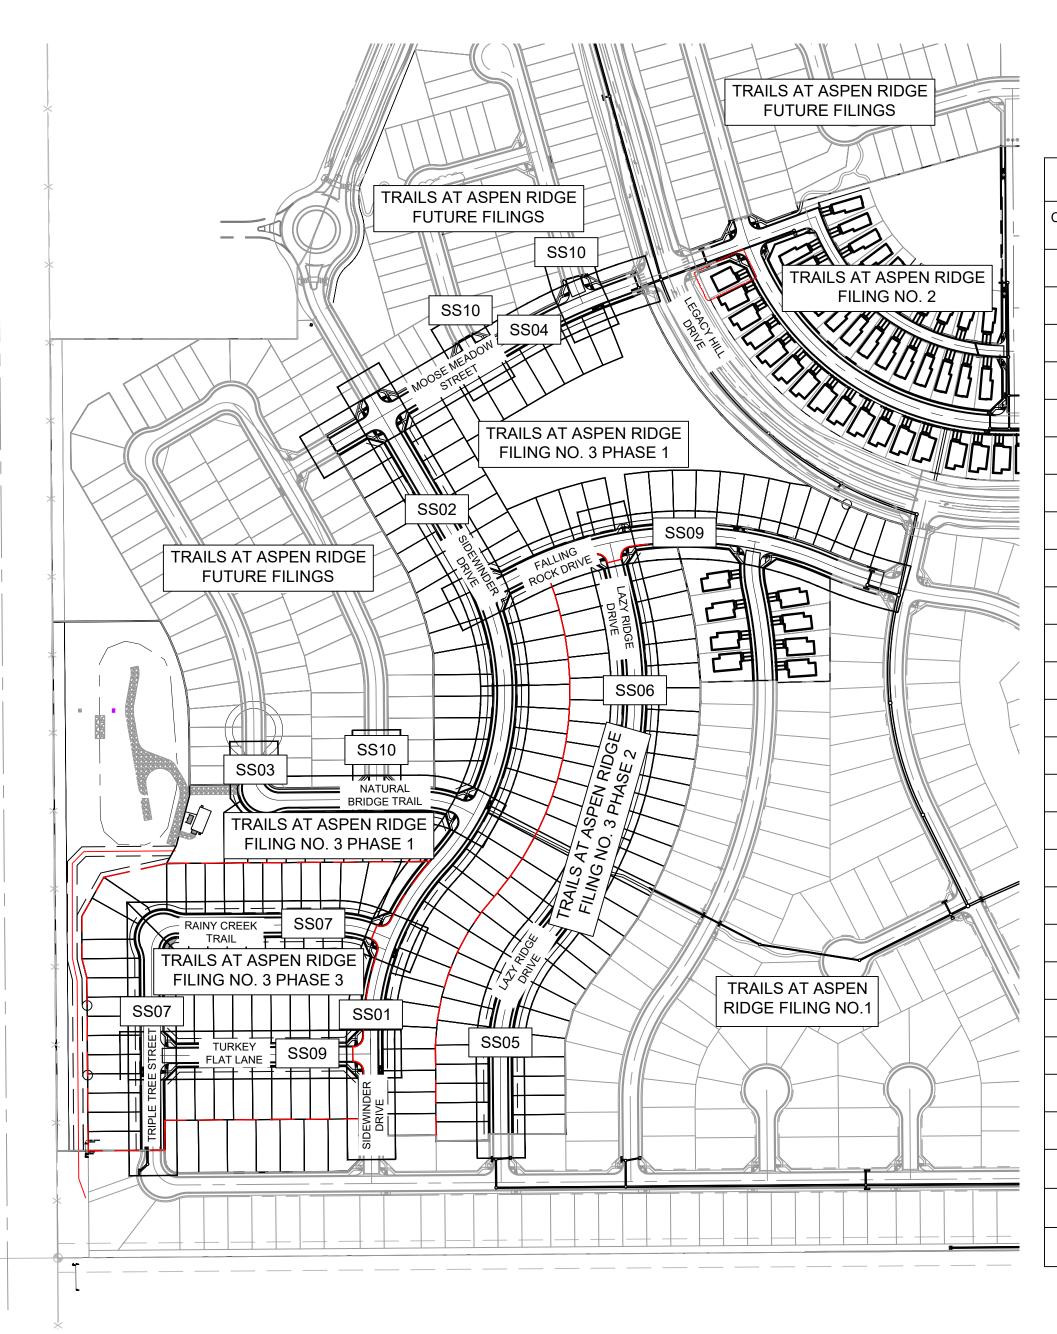



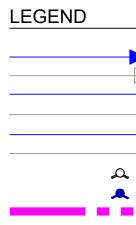

— E-G —

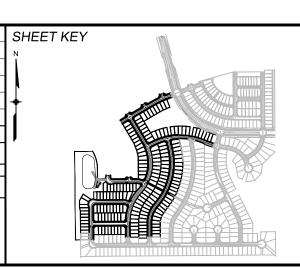

BENCHMARK

COLORADO SPRINGS UTILITIES (FIMS) MONUMENT F206 A BERNTSEN TOP SECURITY MONUMENT SYSTEM WITH A 3.5-INCH DIAMETER ALUMINUM CAP IN A ROAD BOX, LOCATED ON THE NORTHWEST CORNER OF FONTAINE BOULEVARD AND POWERS BOULEVARD, ELEVATION - 5897.89' U.S. SURVEY FT

BASIS OF BEARING


BEARINGS ARE BASED ON THE NORTH LINE OF THE NORTHWEST QUARTER OF SECTION 9, TOWNSHIP 15 SOUTH, RANGE 65 WEST OF THE 6TH P.M. SAID LINE BEARS S89°51'23"E FROM THE NORTHWEST CORNER OF SAID SECTION 9 (2 1/2" AULM. CAP PLS 17664) TO THE N 1/4 CORNER OF SAI SECTION 9 (3 ¼" AULM. CAP PLS 10377)

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ID	PREPARED BY:	
	Matrix	MA I



	UTI	LITY CROSSING	DETAILS	
CROSSING #	N & E	TOP OF PIPE	BTM OF PIPE	VERT. SEP.
1	N 5688.22 E 12330.98	8" PVC SEWER 5859.82	18" RCP STORM 5875.14	15.32'
2	N 5716.39 E 12330.76	8" PVC SEWER 5860.51	8" PVC WATER 5873.05	12.54'
3	N 5955.33 E 12375.11	8" PVC SEWER 5866.51	8" PVC WATER 5879.02	12.51'
4	N 6196.45 E 12540.16	8" PVC SEWER 5867.98	12" PVC WATER 5881.63	13.65'
5	N 7043.98 E 12349.93	8" PVC SEWER 5893.78	8" PVC WATER 5904.09	10.31'
6	N 6249.55 E 12088.53	8" PVC SEWER 5871.33	36" RCP STORM 5874.14	2.81'
7	N 6235.29 E 12098.97	8" PVC SEWER 5870.90	8" PVC WATER 5877.52	6.62'
8	N 6235.29 E 12193.58	8" PVC SEWER 5870.42	24" RCP STORM 5877.15	6.73'
9	N 6236.58 E 12353.72	8" PVC SEWER 5869.32	8" PVC WATER 5880.15	10.83'
10	N 7265.76 E 12762.69	8" PVC SEWER 5878.46	24" RCP STORM 5880.38	1.92'
11	N 6115.04 E 12801.82	8" PVC SEWER 5859.90	18" RCP STORM 5867.58	7.68'
12	N 6425.98 E 12880.82	8" PVC SEWER 5863.22	18" RCP STORM 5872.19	8.97'
13	N 5692.89 E 11875.92	8" PVC SEWER 5862.82	18" RCP STORM 5870.52	7.70'
14	N 5744.86 E 11875.52	8" PVC SEWER 5863.64	18" RCP STORM 5870.36	6.72'
15	N 5898.88 E 11874.33	8" PVC SEWER 5865.18	18" RCP STORM 5870.29	5.11'
16	N 5930.88 E 11874.08	8" PVC SEWER 5865.49	38"x24" STORM 5868.60	3.11'
17	N 5973.00 E 11888.59	8" PVC SEWER 5866.37	38"x24" STORM 5868.47	2.10'
18	N 5973.23 E 11918.32	8" PVC SEWER 5866.67	8" PVC WATER 5875.26	8.59'
19	N 5702.97 E 11885.84	8" PVC SEWER 5863.32	8" PVC WATER 5867.73	4.41'
20	N 6773.07 E 12838.85	8" PVC SEWER 5867.43	8" PVC WATER 5873.76	6.33'
21	N 6694.47 E 13369.12	8" PVC SEWER 5844.10	24" RCP STORM 5849.51	5.41'
22	N 6667.39 E 13414.87	8" PVC SEWER 5843.40	30" RCP STORM 5848.10	4.70'
23	N 6654.15 E 13428.61	8" PVC SEWER 5843.25	48" RCP STORM 5846.27	3.02'
24	N 7279.35 E 12768.92	8" PVC SEWER 5878.05	8" PVC WATER 5884.88	6.83'
25	N 7306.17 E 12757.74	8" PVC SEWER 5878.34	18" RCP STORM 5881.75	3.41'
26	N 6276.57 E 12343.41	8" PVC SEWER 5870.07	24" RCP STORM 5879.34	9.27'
27	N 7160.33 E 12547.35	8" PVC SEWER 5889.91	8" PVC WATER 5895.84	5.93'

VALVE (PROPOSED) VALVE (EXISTING) BLOWOFF (PROPOSED) BLOWOFF (EXISTING) PLUG (PROPOSED) PLUG (EXISTING) **EXISTING FIRE HYDRANT** PROPOSED FIRE HYDRANT PROPERTY LINE CURB LINE EXISTING GAS MAIN

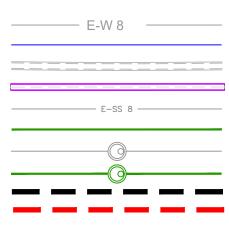

EXISTING WATER PROPOSED WATER EXISTING STORM DRAIN PROPOSED STORM DRAIN EXISTING SAN. SEWER PROPOSED SAN. SEWER EXISTING MANHOLE PROPOSED MANHOLE MATCHLINE PHASE LINE


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FOR AND ON BEHALF OF	

TRAILS AT ASPEN RIDGE


FILING NO. 3 **8" SANITARY SEWER PLANS**

GENERAL NOTES, LEGEND & ABBREVIATIONS


FOR AND ON BEHALF OF	DESIGNED BY:	BAS	SCALE		DATE ISSUED:	MARCH 2022	DRAWING No.
MATRIX DESIGN GROUP, INC.	DRAWN BY:	BAS	HORIZ.	N/A			
*			HORIZ.		0.UEET	2 05 15	GN01
PROJECT No. 20.886.028	CHECKED BY:	NMS	VERT.	N/A	SHEET	2 OF 15	UNUT

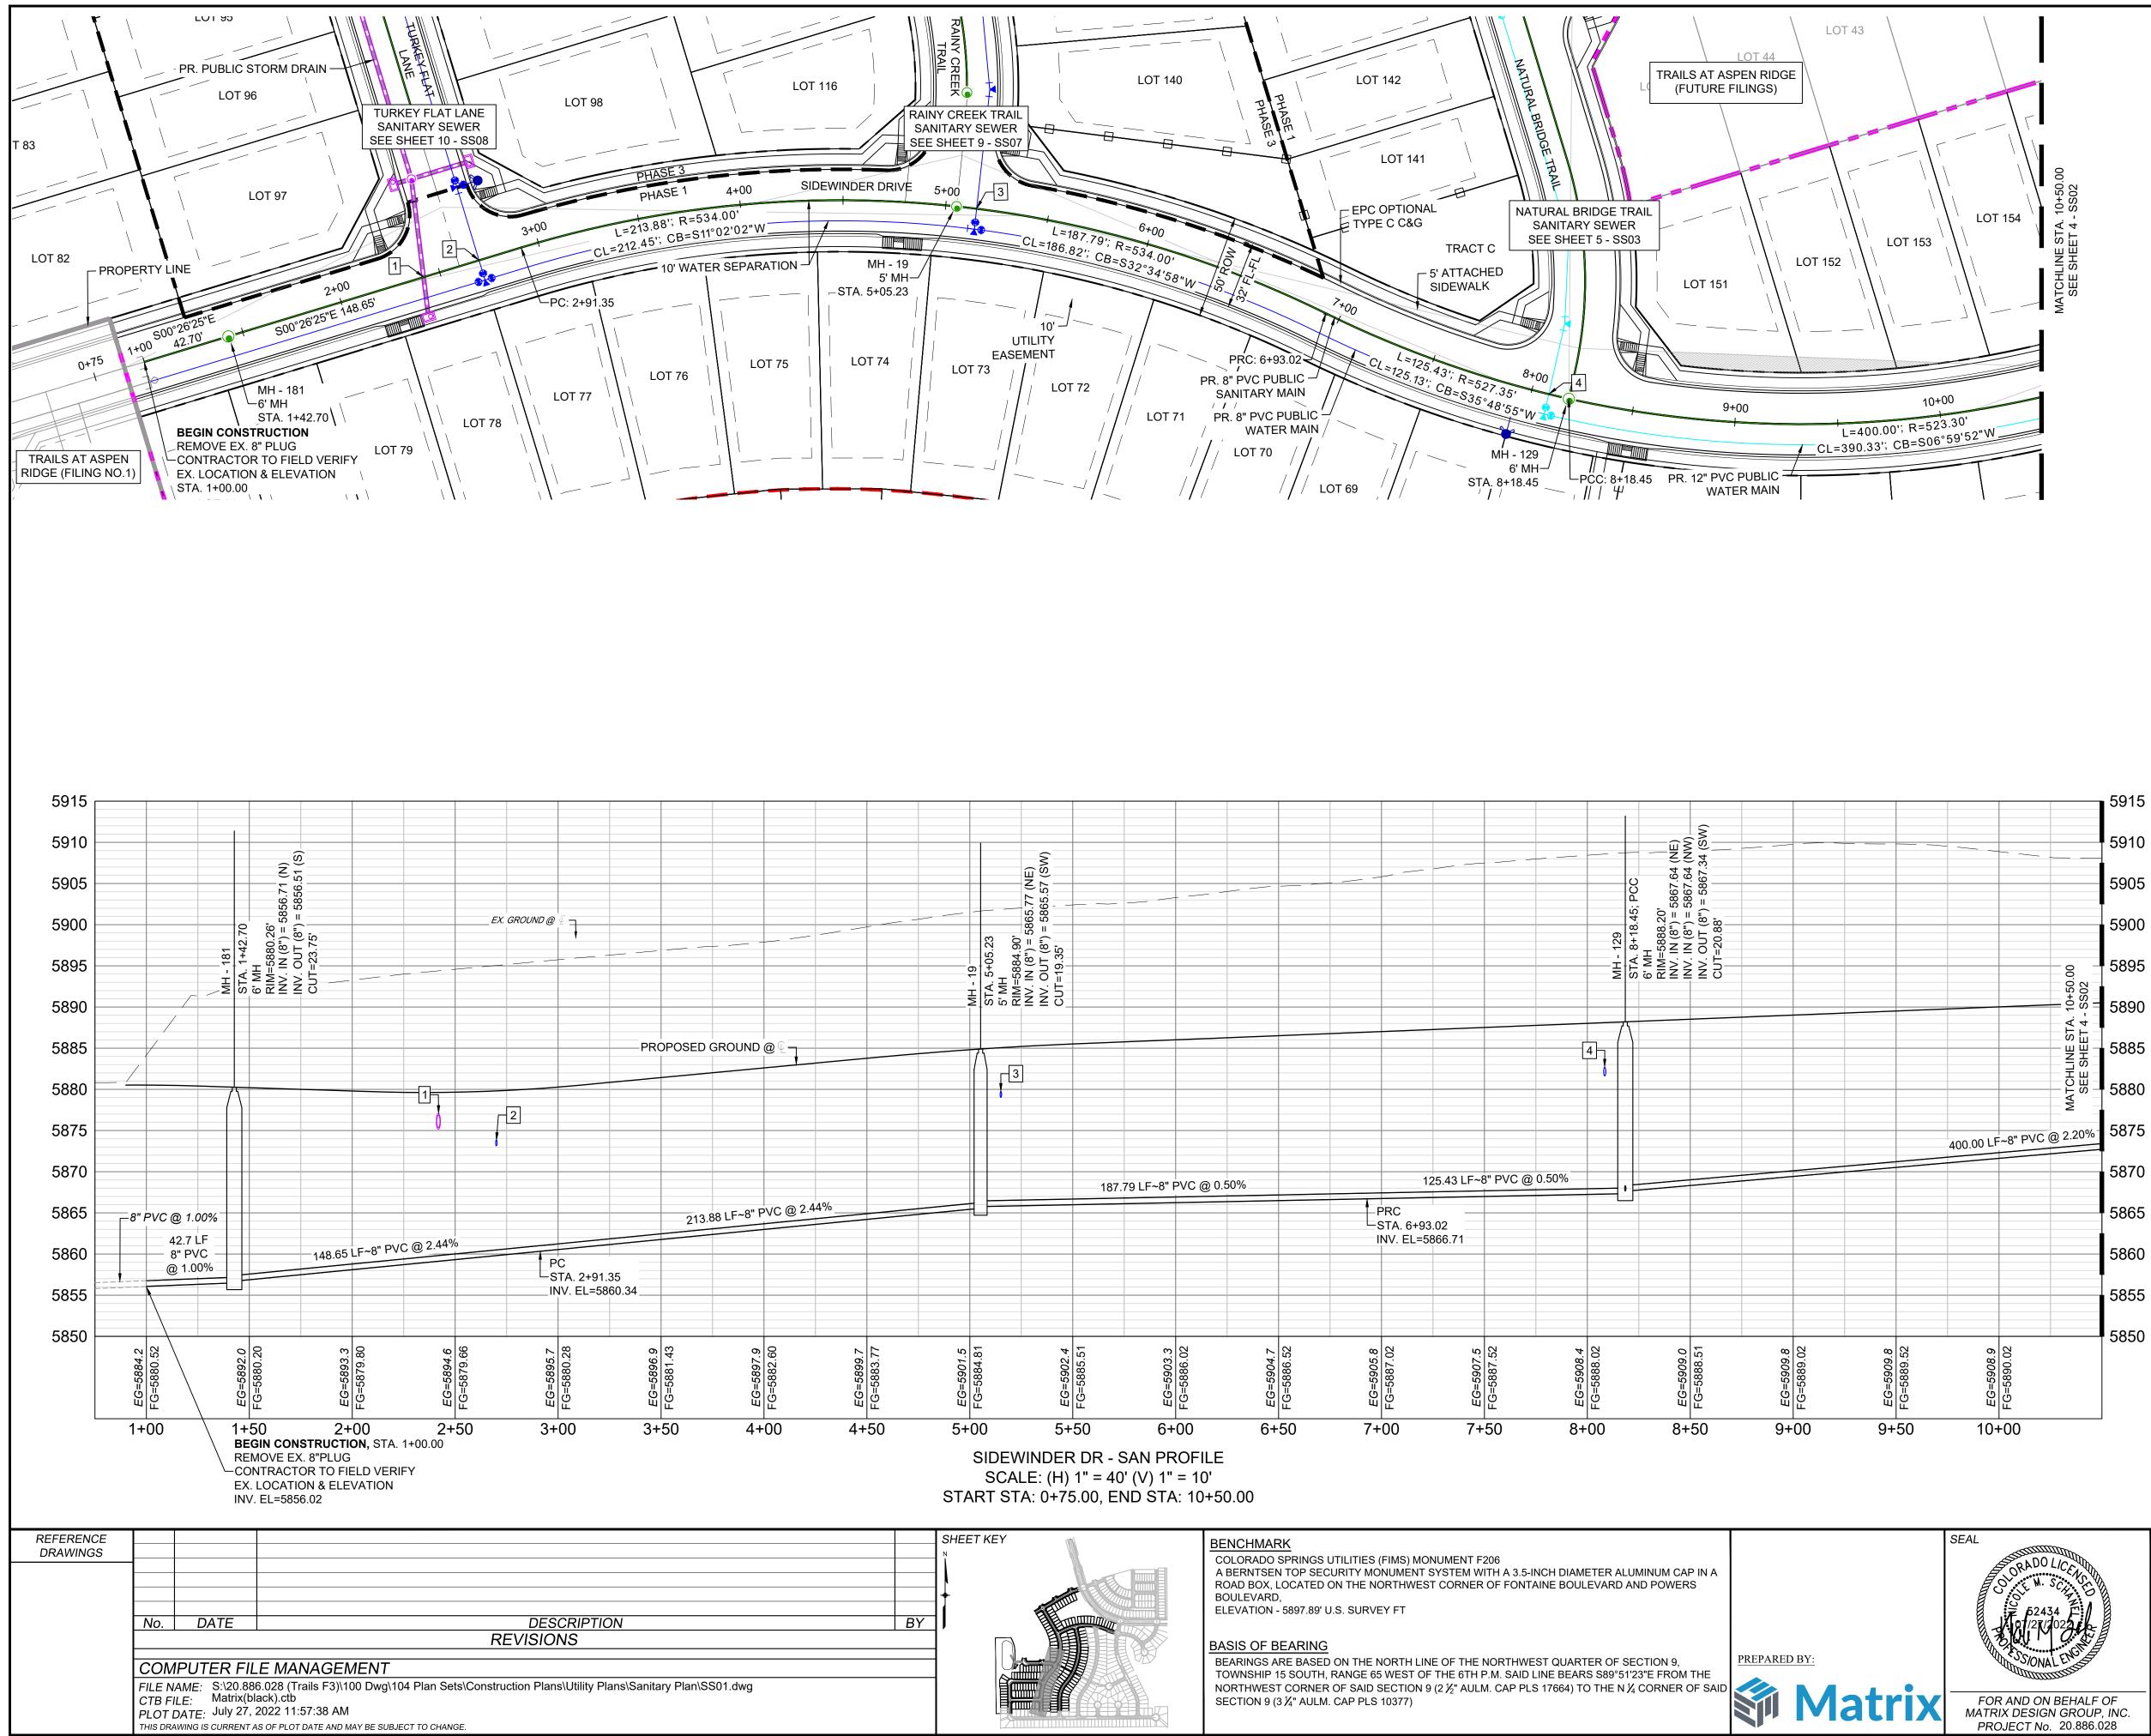

PREPARE	<u>D BY:</u>			
	Μ	a	tri	X

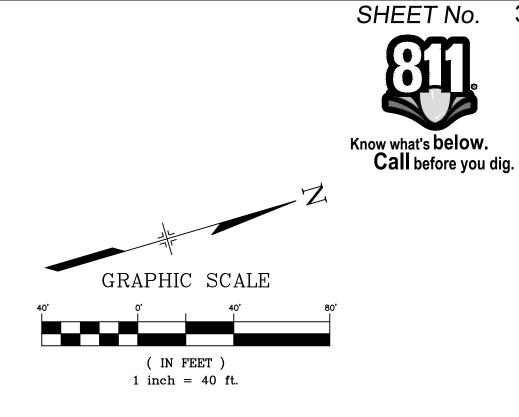

NOTE: CURVILINEAR PIPE OF RADII 523' - 534' TO UTILIZE 3° BENDS AT EVERY OTHER JOINT

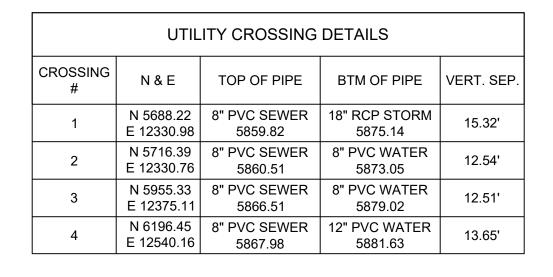


THE LOCATIONS OF EXISTING ABOVE GROUND AND UNDERGROUND UTILITIES ARE SHOWN IN AN APPROXIMATE WAY ONLY. THE CONTRACTOR SHALL DETERMINE THE EXACT LOCATION OF ALL EXISTING UTILITIES BEFORE COMMENCING WORK. THE CONTRACTOR SHALL BE FULLY RESPONSIBLE FOR ANY AND ALL DAMAGES WHICH MIGHT BE CAUSED BY HIS FAILURE TO EXACTLY LOCATE AND PRESERVE ANY AND ALL ABOVE GROUND AND UNDERGROUND UTILITIES.

TRAILS AT ASPEN RIDGE

FILING NO. 3 **8" SANITARY SEWER PLANS**

_F OF	DESIGNED BY:	BAS	SC/	4LE	DATE ISSUED:	MARCH 2022	DRAWING No.	
JP, INC. 6.028	DRAWN BY: CHECKED BY:	BAS NMS	HORIZ. VERT.	1" = 40' 1" = 10'	SHEET	3 OF 15	SS01	

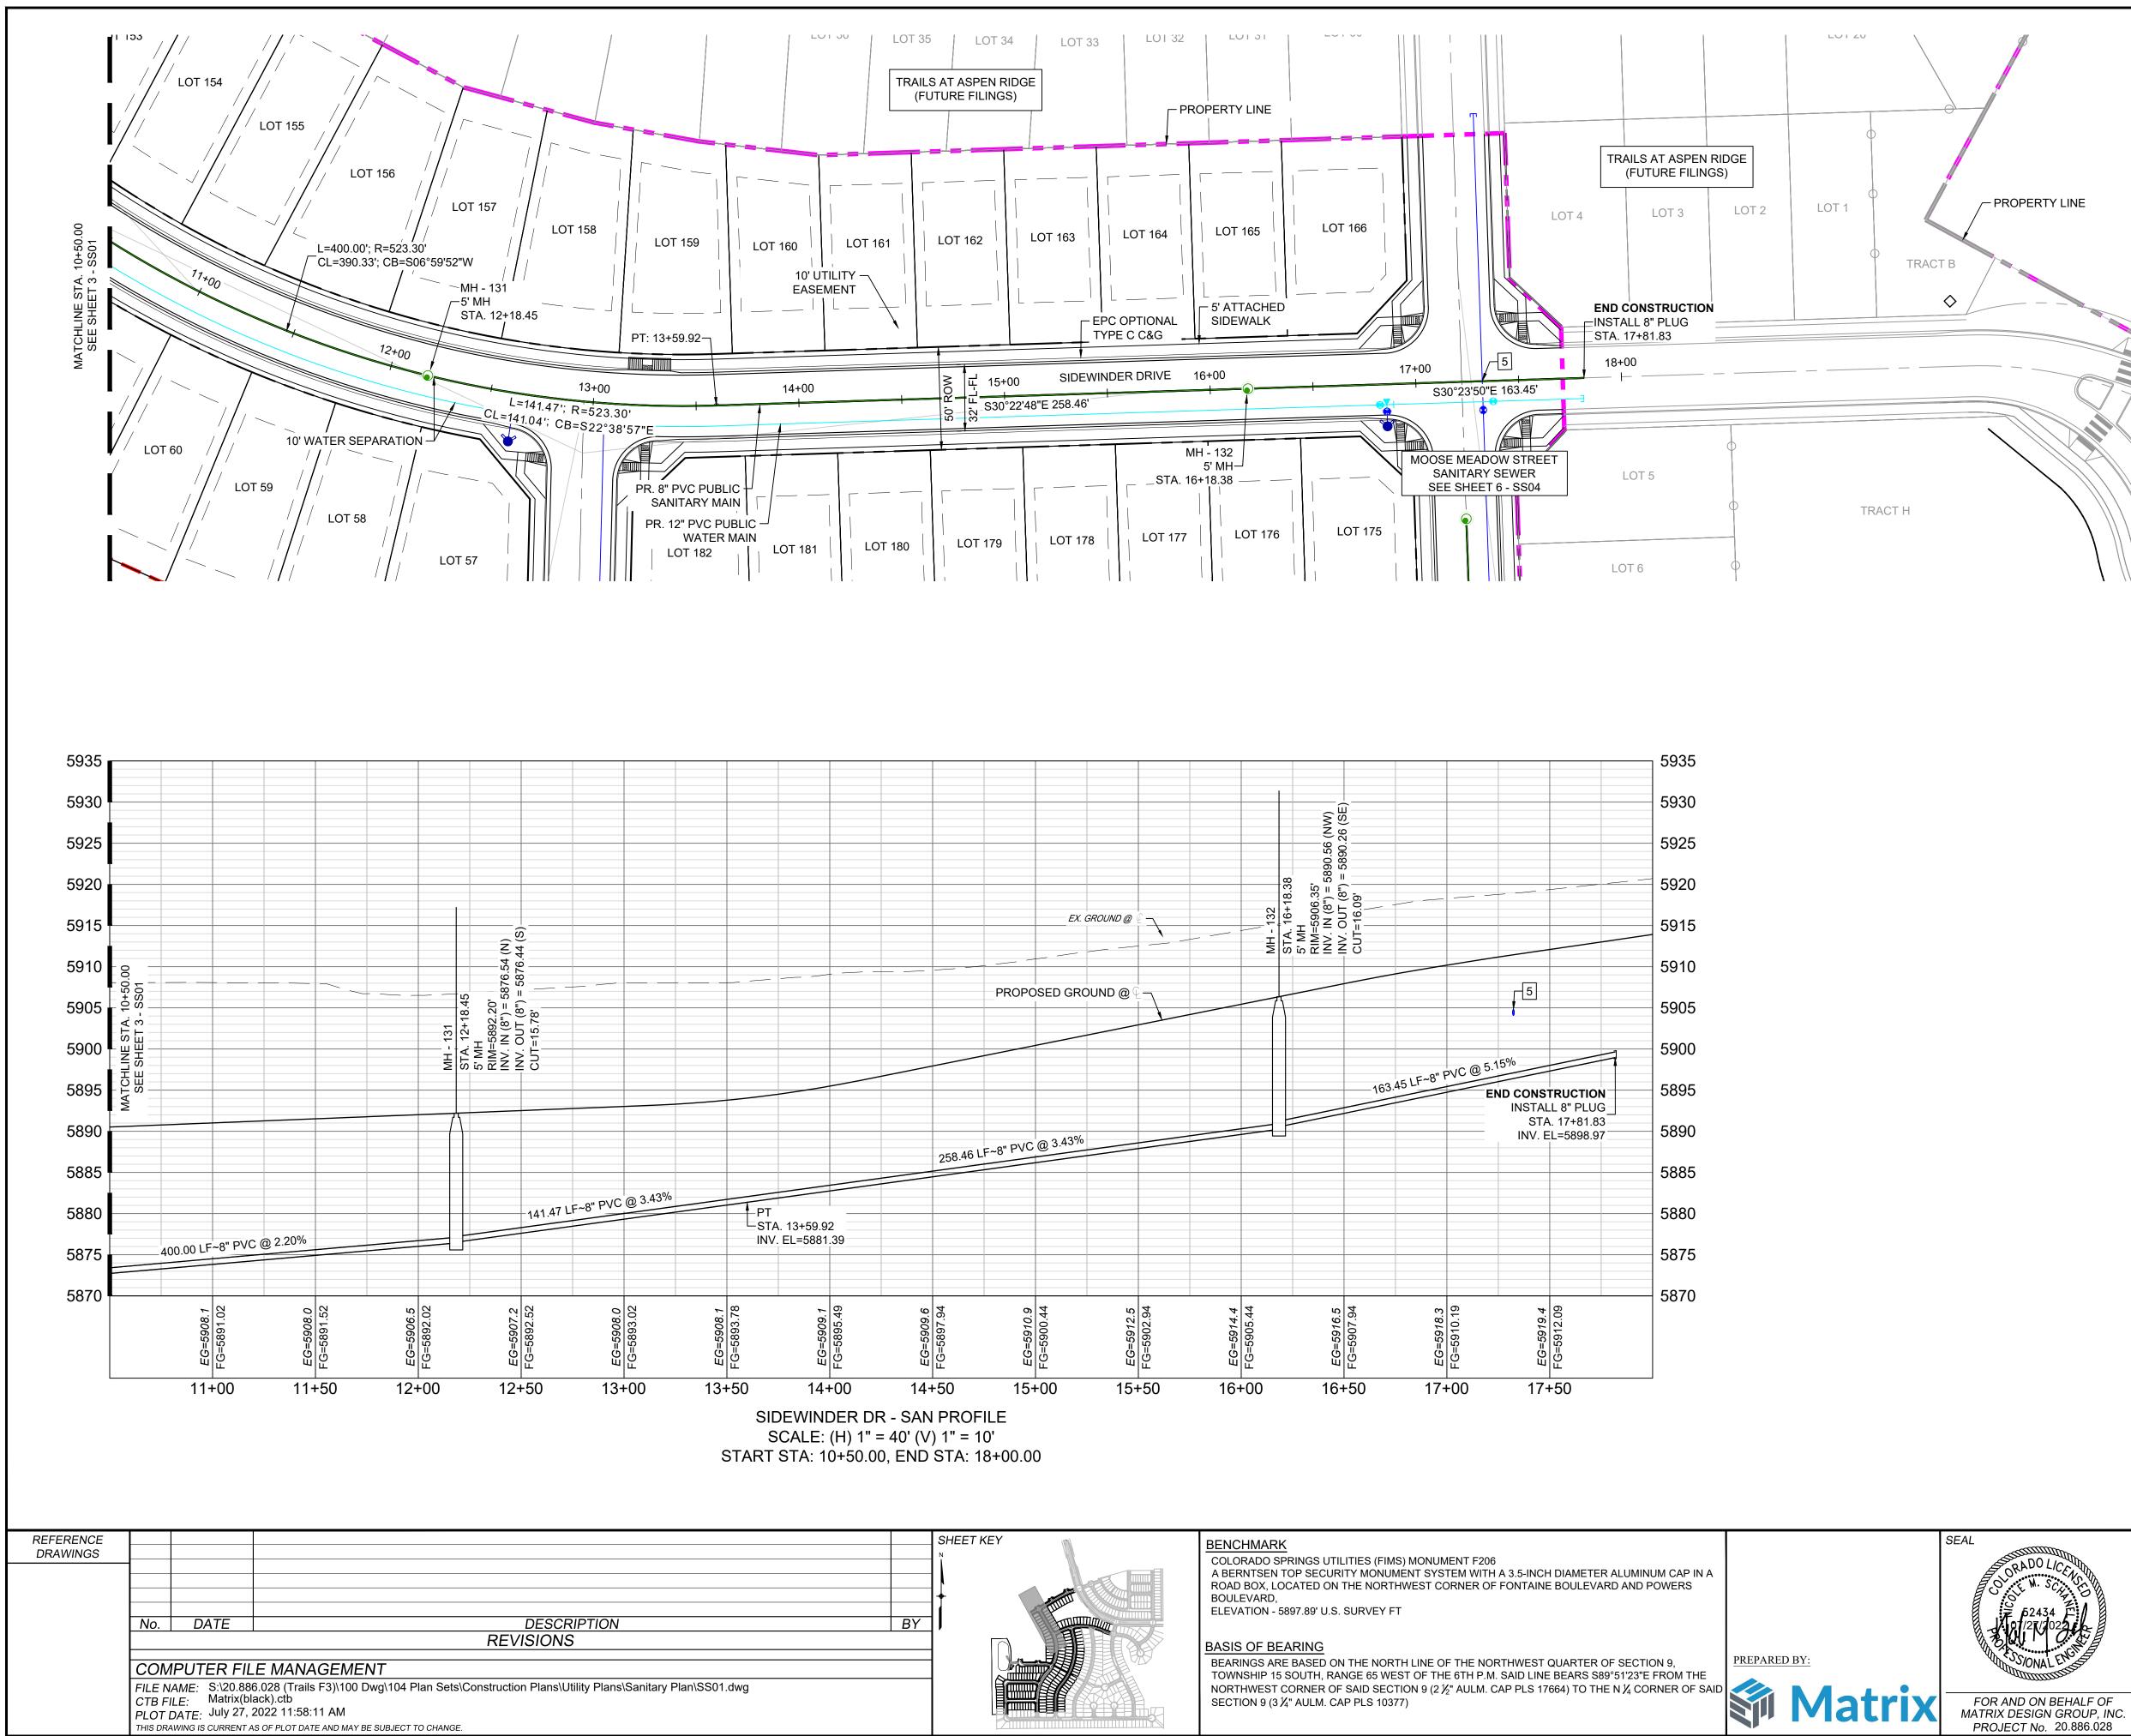

SHEET No. Know what's **below**. Call before you dig. GRAPHIC SCALE (IN FEET) 1 inch = 40 ft.

NOTE: CURVILINEAR PIPE OF RADII 523.30' TO UTILIZE 3° BENDS AT	
EVERY OTHER JOINT	


UTILITY CROSSING DETAILS						
CROSSING #	CROSSING # N & E TOP OF PIPE BTM OF PIPE VERT. SEP.					
5	N 7043.98 E 12349.93	8" PVC SEWER 5893.78	8" PVC WATER 5904.09	10.31'		


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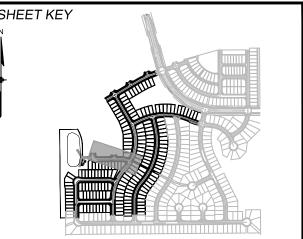
TRAILS AT ASPEN RIDGE

FILING NO. 3 **8" SANITARY SEWER PLANS**


	G No.
JP, INC. DRAWN BY: BAS HORIZ. 1" = 40' 6.028 CHECKED BY: NMS VERT. 1" = 10' SHEET 4 OF 15 SS02	302



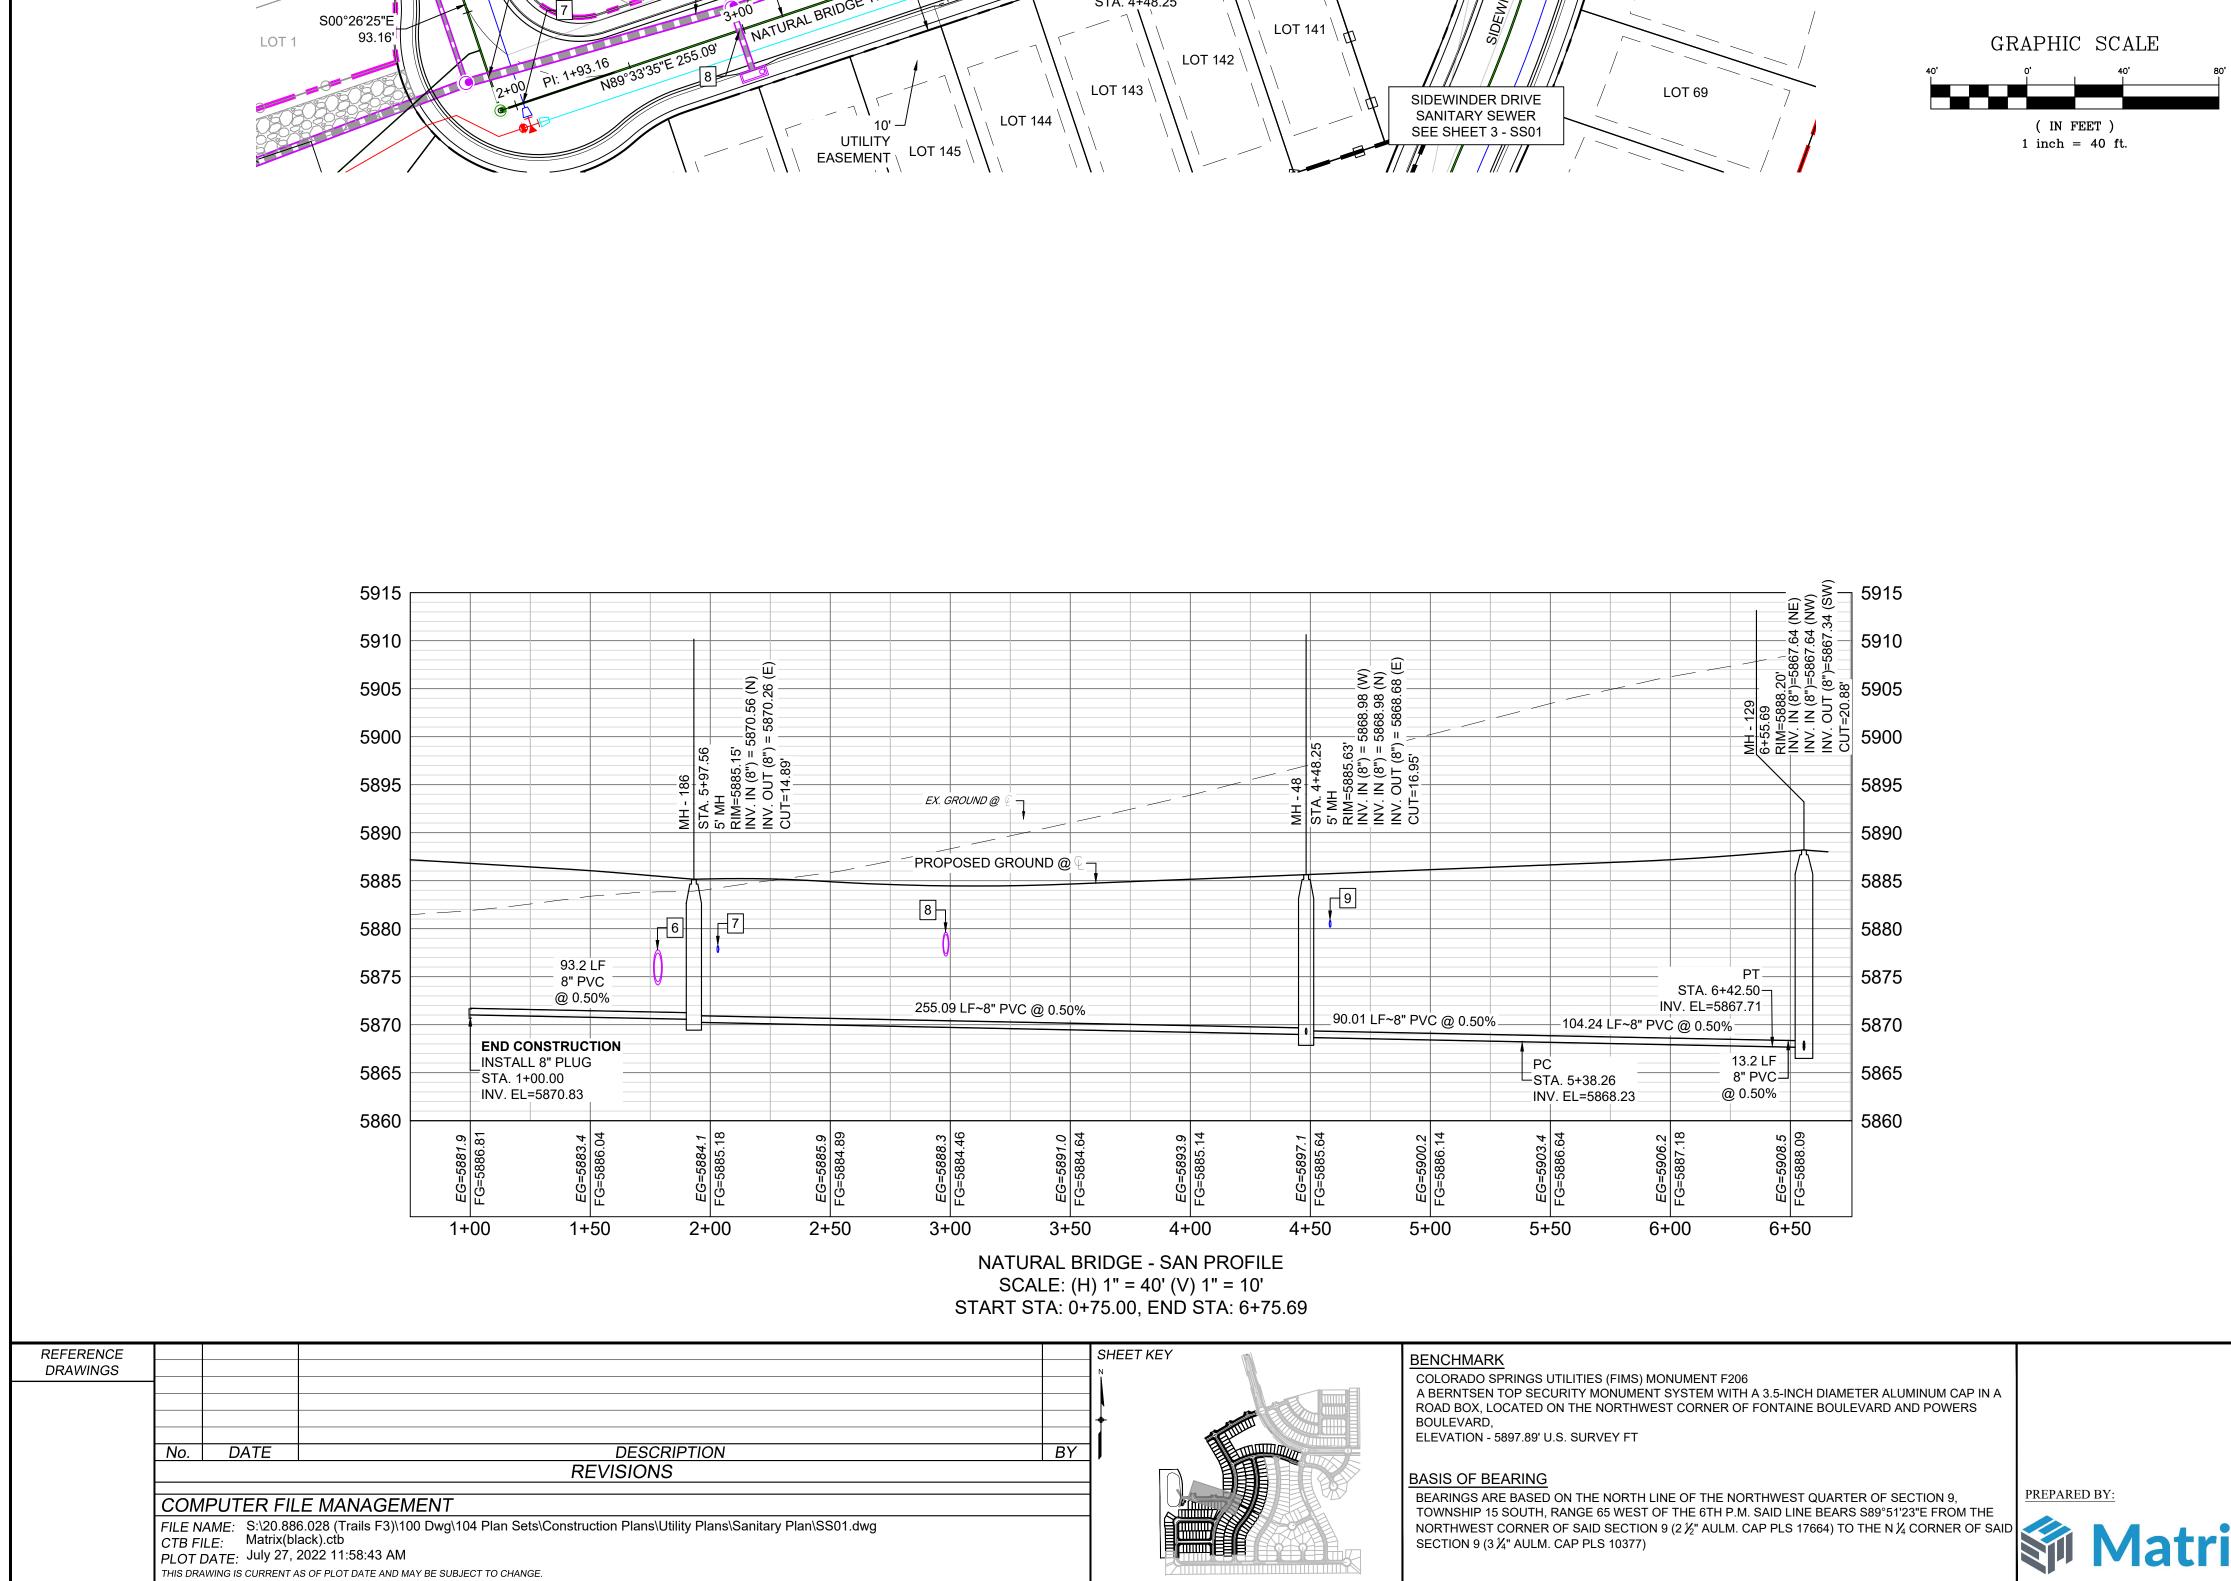

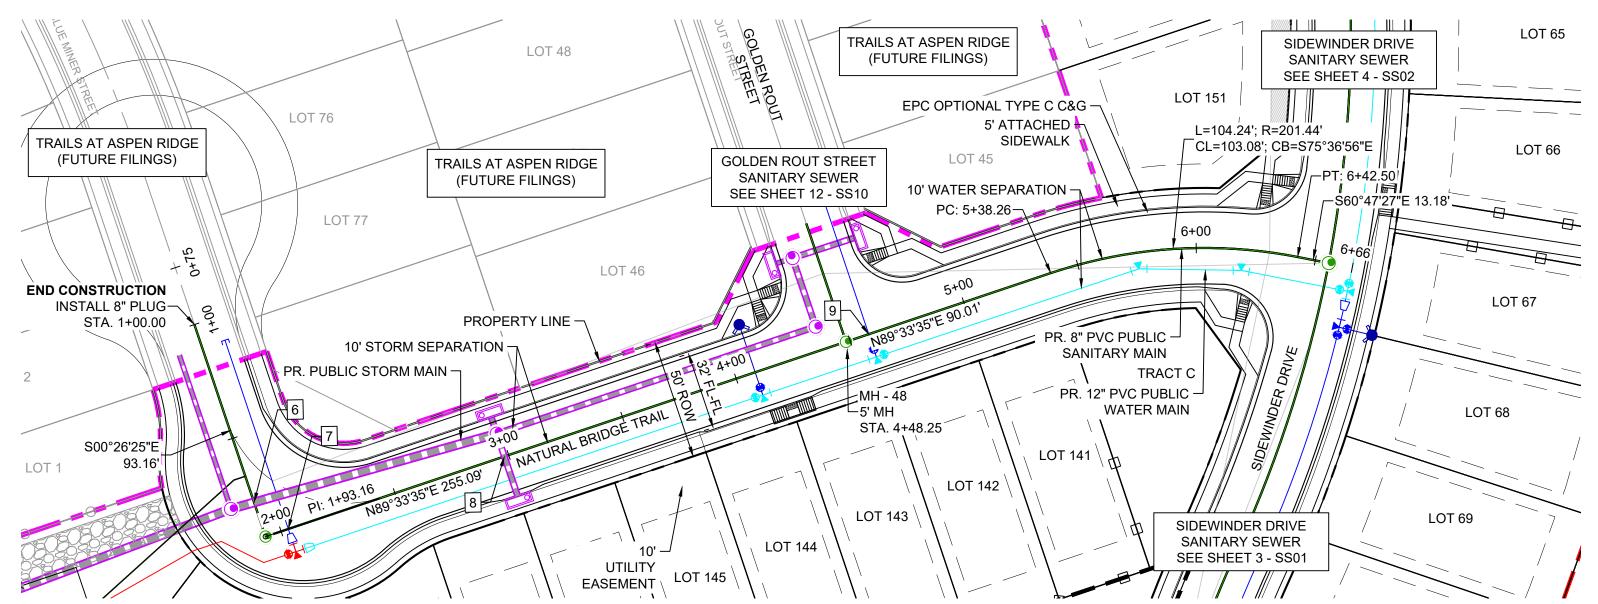

	PREPARED BY:	
D		
	Matrix	

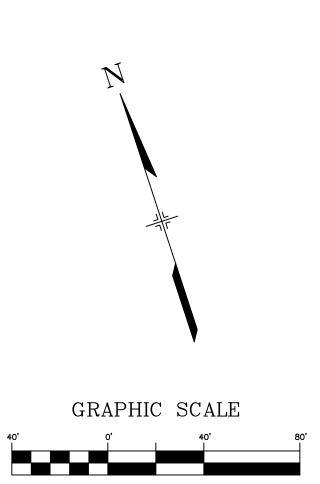




NOTE: CURVILINEAR PIPE OF RADII 201.44' TO UTILIZE 3° BENDS AT EVERY JOINT. MAX PIPE LENGTH OF 10'.

UTILITY CROSSING DETAILS											
CROSSING #	N & E	TOP OF PIPE	BTM OF PIPE	VERT. SEP.							
6	N 6249.55 E 12088.53	8" PVC SEWER 5871.33	36" RCP STORM 5874.14	2.81'							
7	N 6235.29 E 12098.97	8" PVC SEWER 5870.90	8" PVC WATER 5877.52	6.62'							
8	N 6235.29 E 12193.58	8" PVC SEWER 5870.42	24" RCP STORM 5877.15	6.73'							
9	N 6236.58 E 12353.72	8" PVC SEWER 5869.32	8" PVC WATER 5880.15	10.83'							


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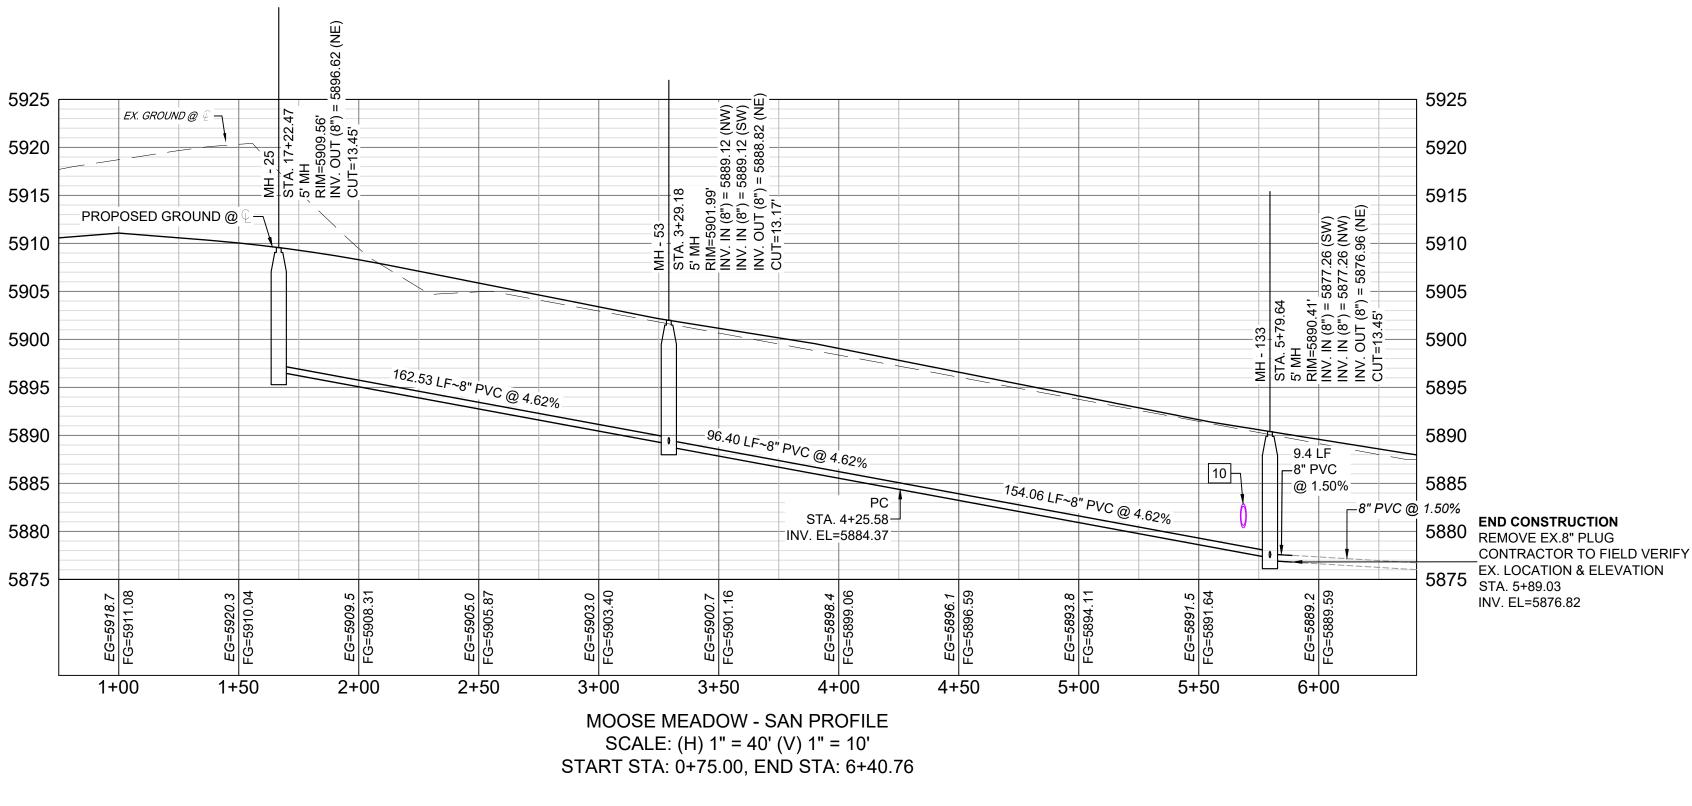


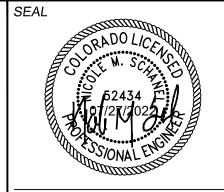TRAILS AT ASPEN RIDGE


FILING NO. 3 **8" SANITARY SEWER PLANS**

FOR AND ON BEHALF OF	DESIGNED BY:	BAS	SC,	ALE	DATE ISSUED:	MARCH 2022	DRAWING No.	
MATRIX DESIGN GROUP, INC. PROJECT No. 20.886.028	DRAWN BY: CHECKED BY:	BAS NMS	HORIZ. VERT.	1" = 40' 1" = 10'	SHEET	5 OF 15	SS03	



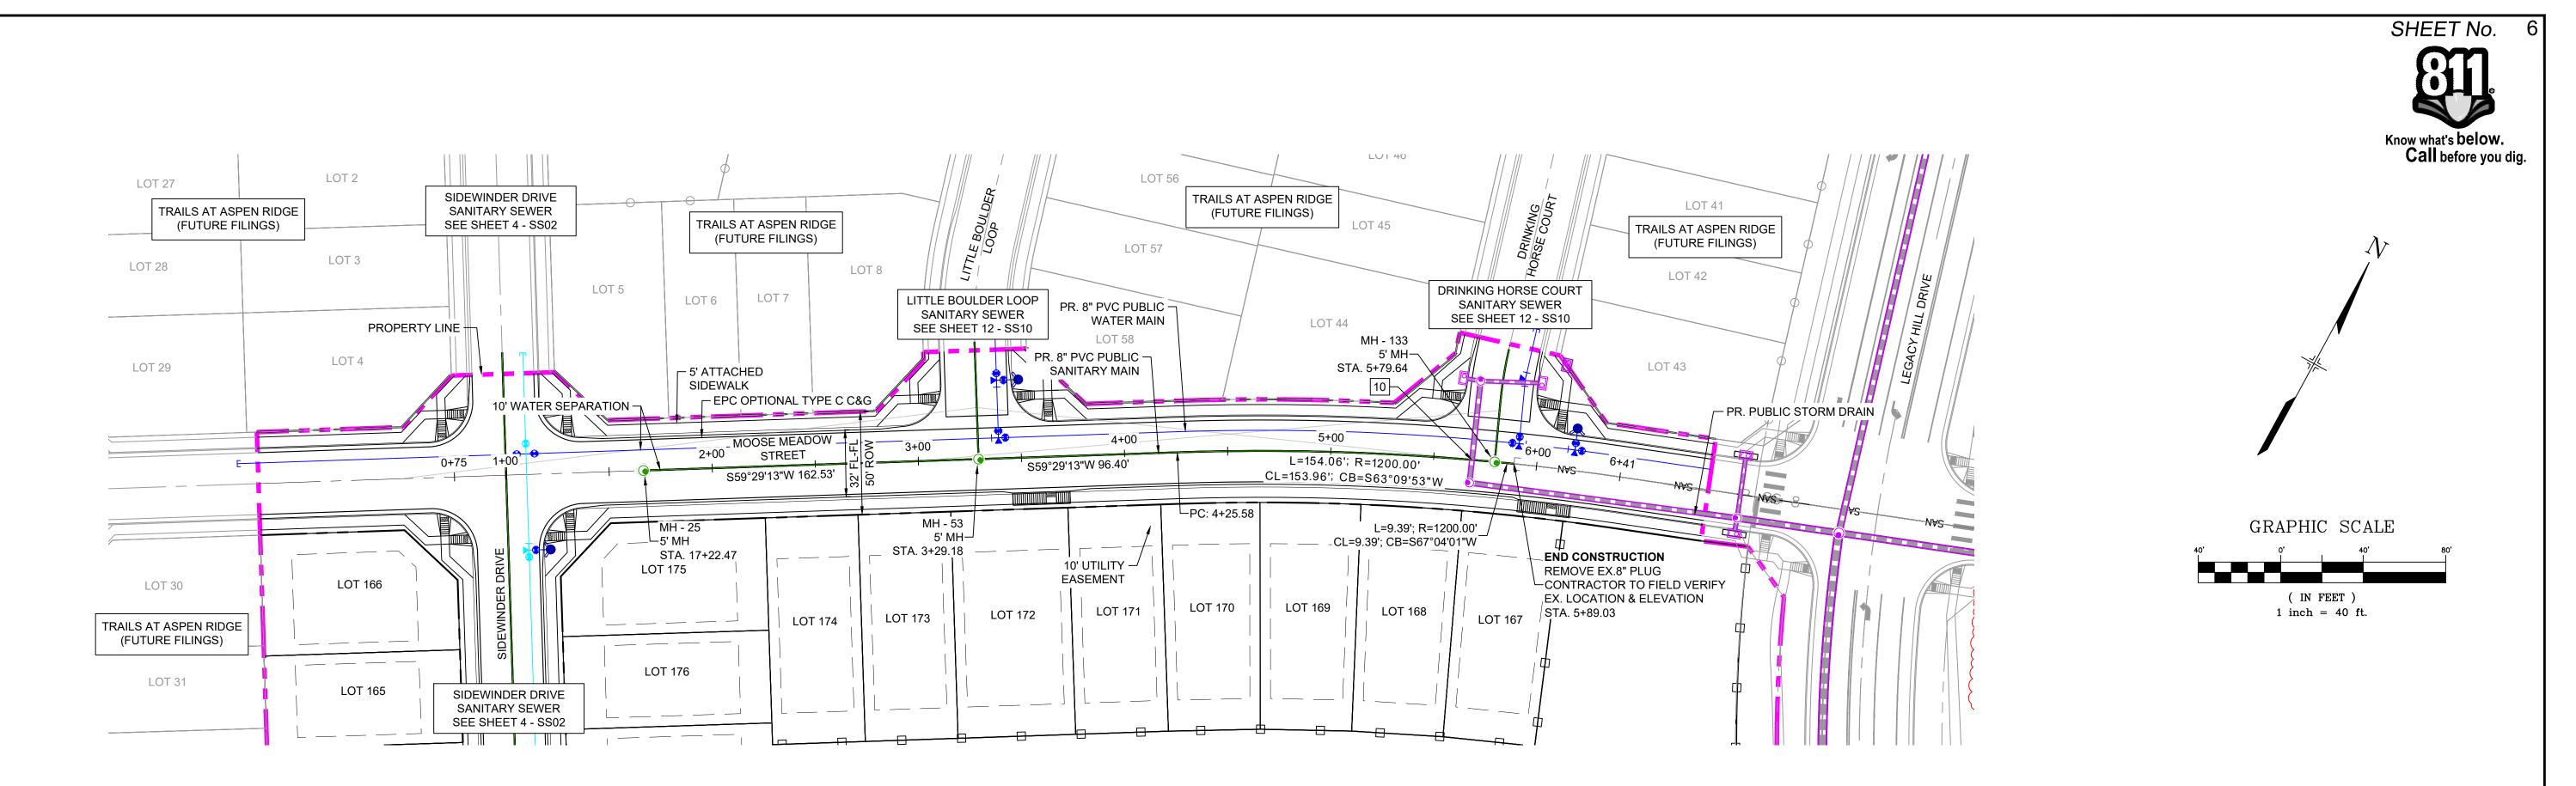

REFERENCE									
DRAWINGS									
	No.	DATE	DESCRIPTION	BY					
	REVISIONS								
	COMPUTER FILE MANAGEMENT								
	FILE NAME: S:\20.886.028 (Trails F3)\100 Dwg\104 Plan Sets\Construction Plans\Utility Plans\Sanitary Plan\SS01.dwg CTB FILE: Matrix(black).ctb PLOT DATE: July 27, 2022 11:59:14 AM								
	THIS DRA	AWING IS CURRENT A	S OF PLOT DATE AND MAY BE SUBJECT TO CHANGE.						

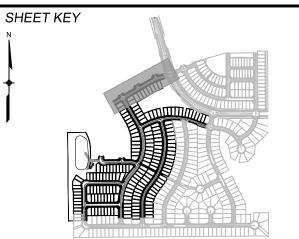

BENCHMARK COLORADO SPRINGS UTILITIES (FIMS) MONUMENT F206

A BERNTSEN TOP SECURITY MONUMENT SYSTEM WITH A 3.5-INCH DIAMETER ALUMINUM CAP IN A ROAD BOX, LOCATED ON THE NORTHWEST CORNER OF FONTAINE BOULEVARD AND POWERS BOULEVARD, ELEVATION - 5897.89' U.S. SURVEY FT

BASIS OF BEARING

BEARINGS ARE BASED ON THE NORTH LINE OF THE NORTHWEST QUARTER OF SECTION 9, TOWNSHIP 15 SOUTH, RANGE 65 WEST OF THE 6TH P.M. SAID LINE BEAKS 309 51 23 ET NOW THE NORTHWEST CORNER OF SAID SECTION 9 (2 ½" AULM. CAP PLS 17664) TO THE N ½ CORNER OF SAID SECTION 9 (3 ¼" AULM. CAP PLS 10377)

UTILITY CROSSING DETAILS											
CROSSING #	N & E	TOP OF PIPE	BTM OF PIPE	VERT. SEP.							
10 N 7265.76 E 12762.69		8" PVC SEWER 5878.46	24" RCP STORM 5880.38	1.92'							

THE LOCATIONS OF EXISTING ABOVE GROUND AND UNDERGROUND UTILITIES ARE SHOWN IN AN APPROXIMATE WAY ONLY. THE CONTRACTOR SHALL DETERMINE THE EXACT LOCATION OF ALL EXISTING UTILITIES BEFORE COMMENCING WORK. THE CONTRACTOR SHALL BE FULLY RESPONSIBLE FOR ANY AND ALL DAMAGES WHICH MIGHT BE CAUSED BY HIS FAILURE TO EXACTLY LOCATE AND PRESERVE ANY AND ALL ABOVE GROUND AND UNDERGROUND UTILITIES.





PREPARED BY:

TRAILS AT ASPEN RIDGE

FILING NO. 3 **8" SANITARY SEWER PLANS**

DUP, INC. DRAWN BY: BAS HORIZ. 1" = 40' SHEET 6 OF 15 SS04 86.028 CHECKED BY: NMS VERT. 1" = 10' SHEET 6 OF 15 SS04	LF OF	DESIGNED BY:	BAS	SCA	ALE	DATE ISSUED:	MARCH 2022	DRAWING No.	
	,			-	-		6 OF 15		

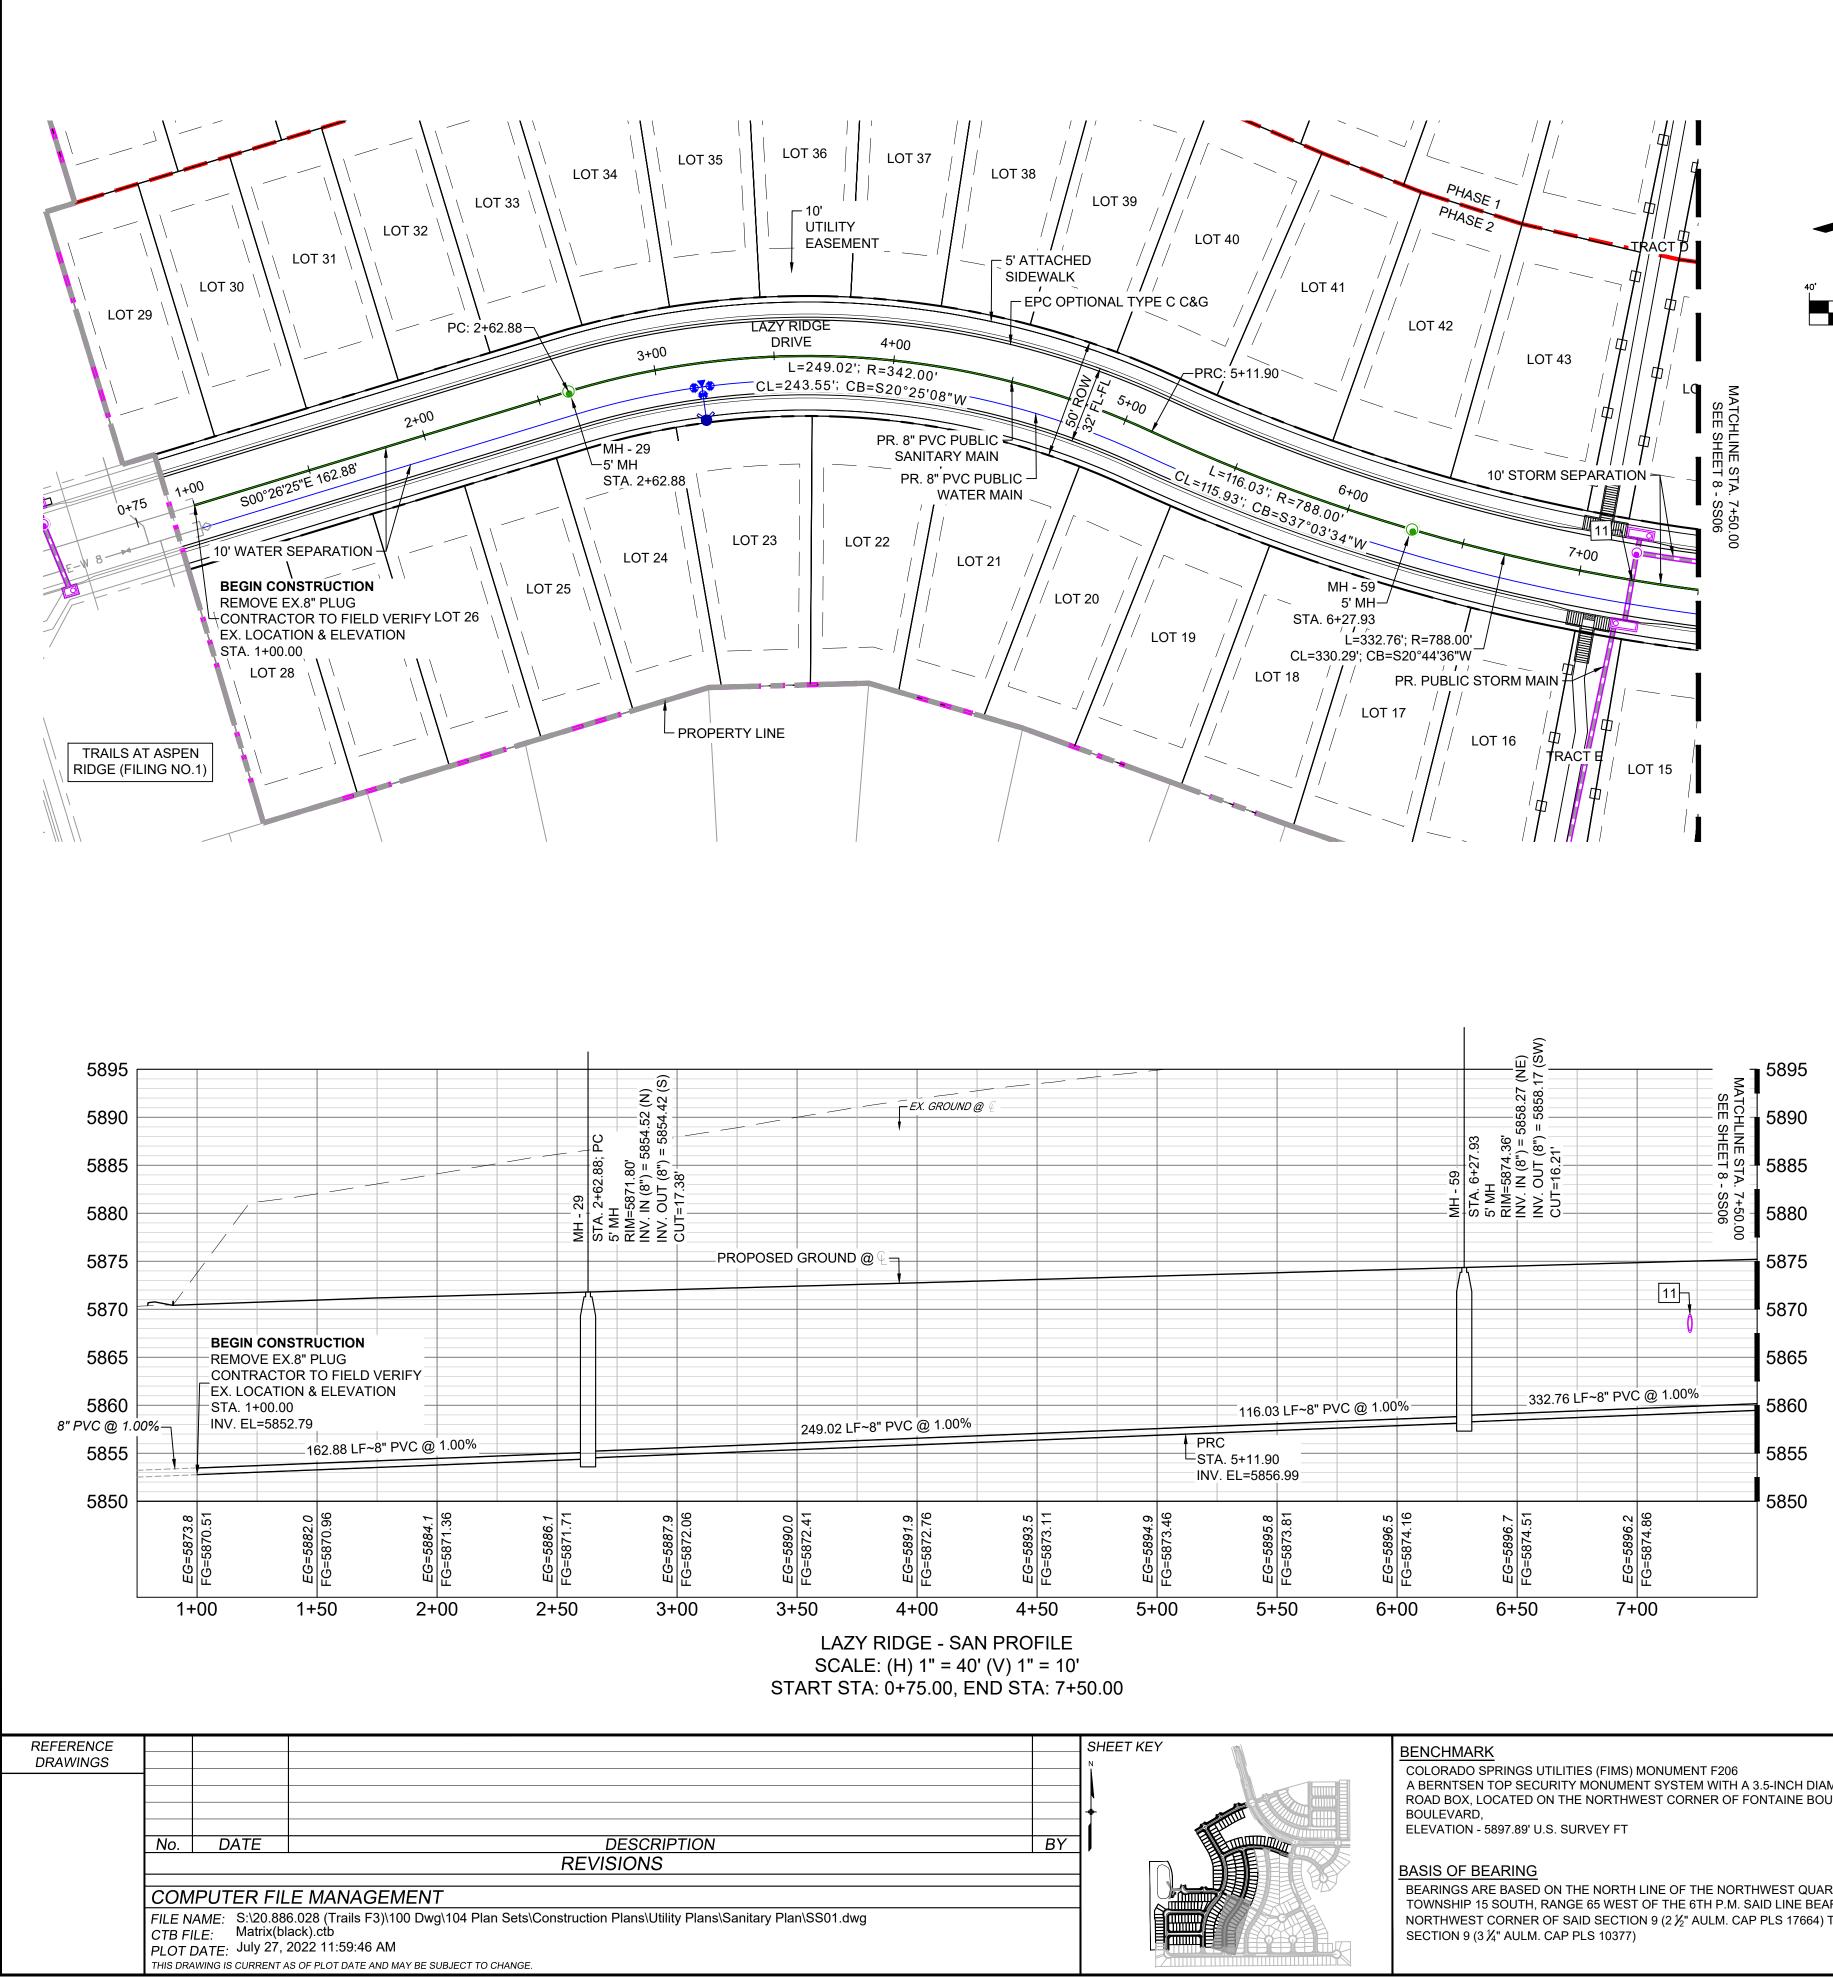

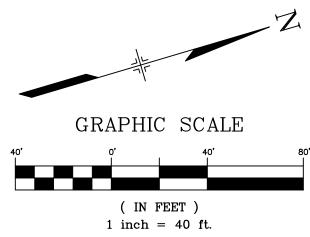

A BERNTSEN TOP SECURITY MONUMENT SYSTEM WITH A 3.5-INCH DIAMETER ALUMINUM CAP IN A ROAD BOX, LOCATED ON THE NORTHWEST CORNER OF FONTAINE BOULEVARD AND POWERS

BEARINGS ARE BASED ON THE NORTH LINE OF THE NORTHWEST QUARTER OF SECTION 9, TOWNSHIP 15 SOUTH, RANGE 65 WEST OF THE 6TH P.M. SAID LINE BEARS S89°51'23"E FROM THE NORTHWEST CORNER OF SAID SECTION 9 (2 1/2" AULM. CAP PLS 17664) TO THE N 1/4 CORNER OF SAI

PREPARED BY:	SEAL ORADO L/CCA OF THE M. SCH. IS DOI: IN. SCH. IS DOI: IN SCH. IS DOI: IN SCH. IS DOI: IN
Matrix	FOR AND ON BEHALF OF MATRIX DESIGN GROUP, INC. PROJECT No. 20.886.028

WASTEWATER PLAN & PROFILE

MARCH 2022 DRAWING No.

7 OF 15

SS05

DESIGNED BY:BASSCALEDATE ISSUED:DRAWN BY:BASHORIZ.1" = 40'CHECKED BY:NMSVERT.1" = 10'

FILING NO. 3 **8" SANITARY SEWER PLANS**

TRAILS AT ASPEN RIDGE

THE LOCATIONS OF EXISTING ABOVE GROUND AND UNDERGROUND UTILITIES ARE SHOWN IN AN APPROXIMATE WAY ONLY. THE CONTRACTOR SHALL DETERMINE THE EXACT LOCATION OF ALL EXISTING UTILITIES BEFORE COMMENCING WORK. THE CONTRACTOR SHALL BE FULLY RESPONSIBLE FOR ANY AND ALL DAMAGES WHICH MIGHT BE CAUSED BY HIS FAILURE TO EXACTLY LOCATE AND PRESERVE ANY AND ALL ABOVE GROUND AND UNDERGROUND UTILITIES.


UTILITY CROSSING DETAILS											
CROSSING #	N & E	TOP OF PIPE	BTM OF PIPE	VERT. SEP.							
11	N 6115.04 E 12801.82	8" PVC SEWER 5859.90	18" RCP STORM 5867.58	7.68'							


NOTE: CURVILINEAR PIPE OF RADII 788' TO UTILIZE 3° BENDS AT EVERY 3RD JOINT

NOTE: CURVILINEAR PIPE OF RADII 342' TO UTILIZE 3° BENDS AT EVERY JOINT




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BENCHMARK COLORADO SPRINGS UTILITIES (FIMS) MONUMENT F206

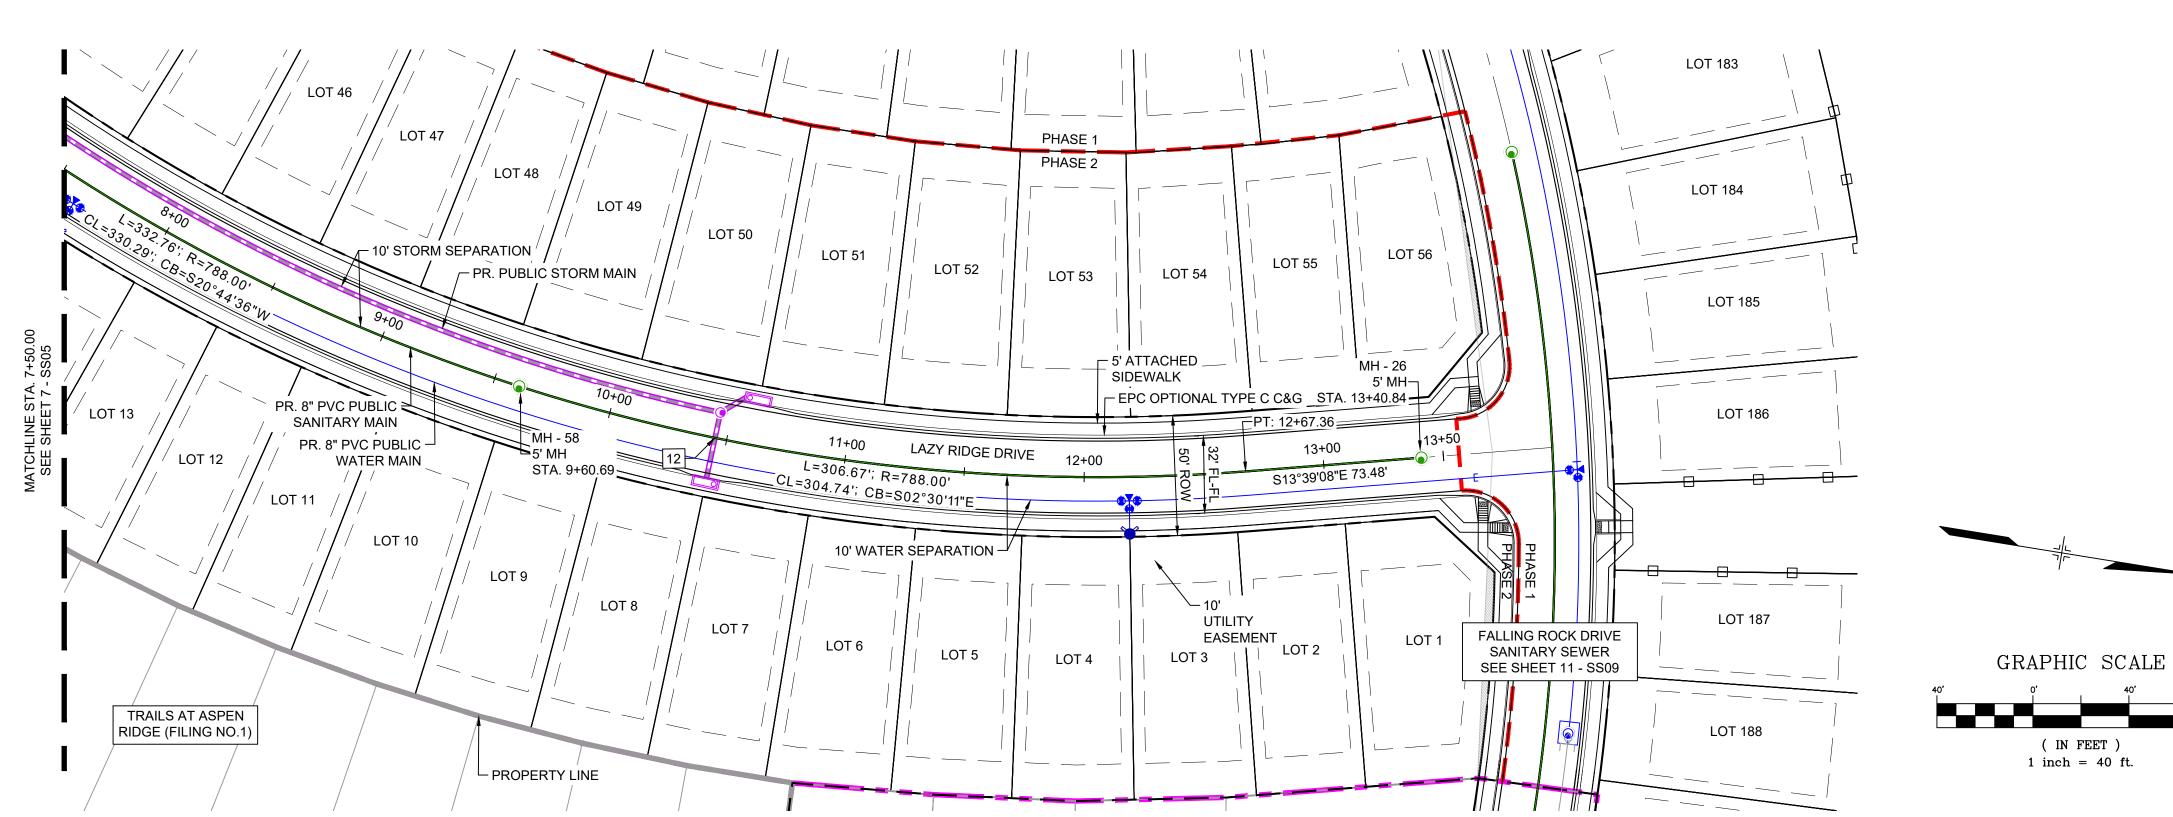
A BERNTSEN TOP SECURITY MONUMENT SYSTEM WITH A 3.5-INCH DIAMETER ALUMINUM CAP IN A ROAD BOX, LOCATED ON THE NORTHWEST CORNER OF FONTAINE BOULEVARD AND POWERS BOULEVARD, ELEVATION - 5897.89' U.S. SURVEY FT

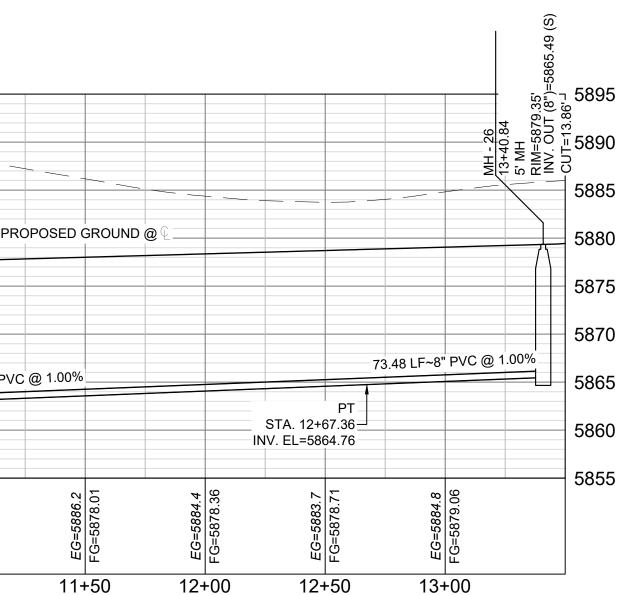BASIS OF BEARING

BEARINGS ARE BASED ON THE NORTH LINE OF THE NORTHWEST QUARTER OF SECTION 9, TOWNSHIP 15 SOUTH, RANGE 65 WEST OF THE 6TH P.M. SAID LINE BEARS S89°51'23"E FROM THE NORTHWEST CORNER OF SAID SECTION 9 (2 1/2" AULM. CAP PLS 17664) TO THE N 1/4 CORNER OF SAID SECTION 9 (3 ¼" AULM. CAP PLS 10377)

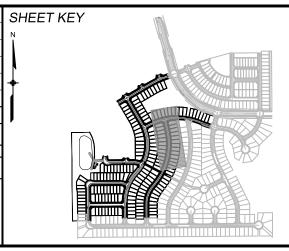PREPARED BY:	
🇊 Matrix	



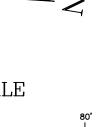

NOTE: CURVILINEAR PIPE OF RADII 788' TO UTILIZE 3° BENDS AT EVERY 3RD JOINT

UTILITY CROSSING DETAILS										
CROSSING #	N & E	TOP OF PIPE	BTM OF PIPE	VERT. SEP.						
12 N 6425.98 E 12880.82		8" PVC SEWER 5863.22	18" RCP STORM 5872.19	8.97'						

THE LOCATIONS OF EXISTING ABOVE GROUND AND UNDERGROUND UTILITIES ARE SHOWN IN AN APPROXIMATE WAY ONLY. THE CONTRACTOR SHALL DETERMINE THE EXACT LOCATION OF ALL EXISTING UTILITIES BEFORE COMMENCING WORK. THE CONTRACTOR SHALL BE FULLY RESPONSIBLE FOR ANY AND ALL DAMAGES WHICH MIGHT BE CAUSED BY HIS FAILURE TO EXACTLY LOCATE AND PRESERVE ANY AND ALL ABOVE GROUND AND UNDERGROUND UTILITIES.




TRAILS AT ASPEN RIDGE

FILING NO. 3

WASTEWATER PLAN & PROFILE


8" SANITARY SEWER PLANS


DESIGNED BY:BASSCALEDATE ISSUED:DRAWN BY:BASHORIZ.1" = 40'CHECKED BY:NMSVERT.1" = 10' MARCH 2022 DRAWING No. SS06 8 OF 15

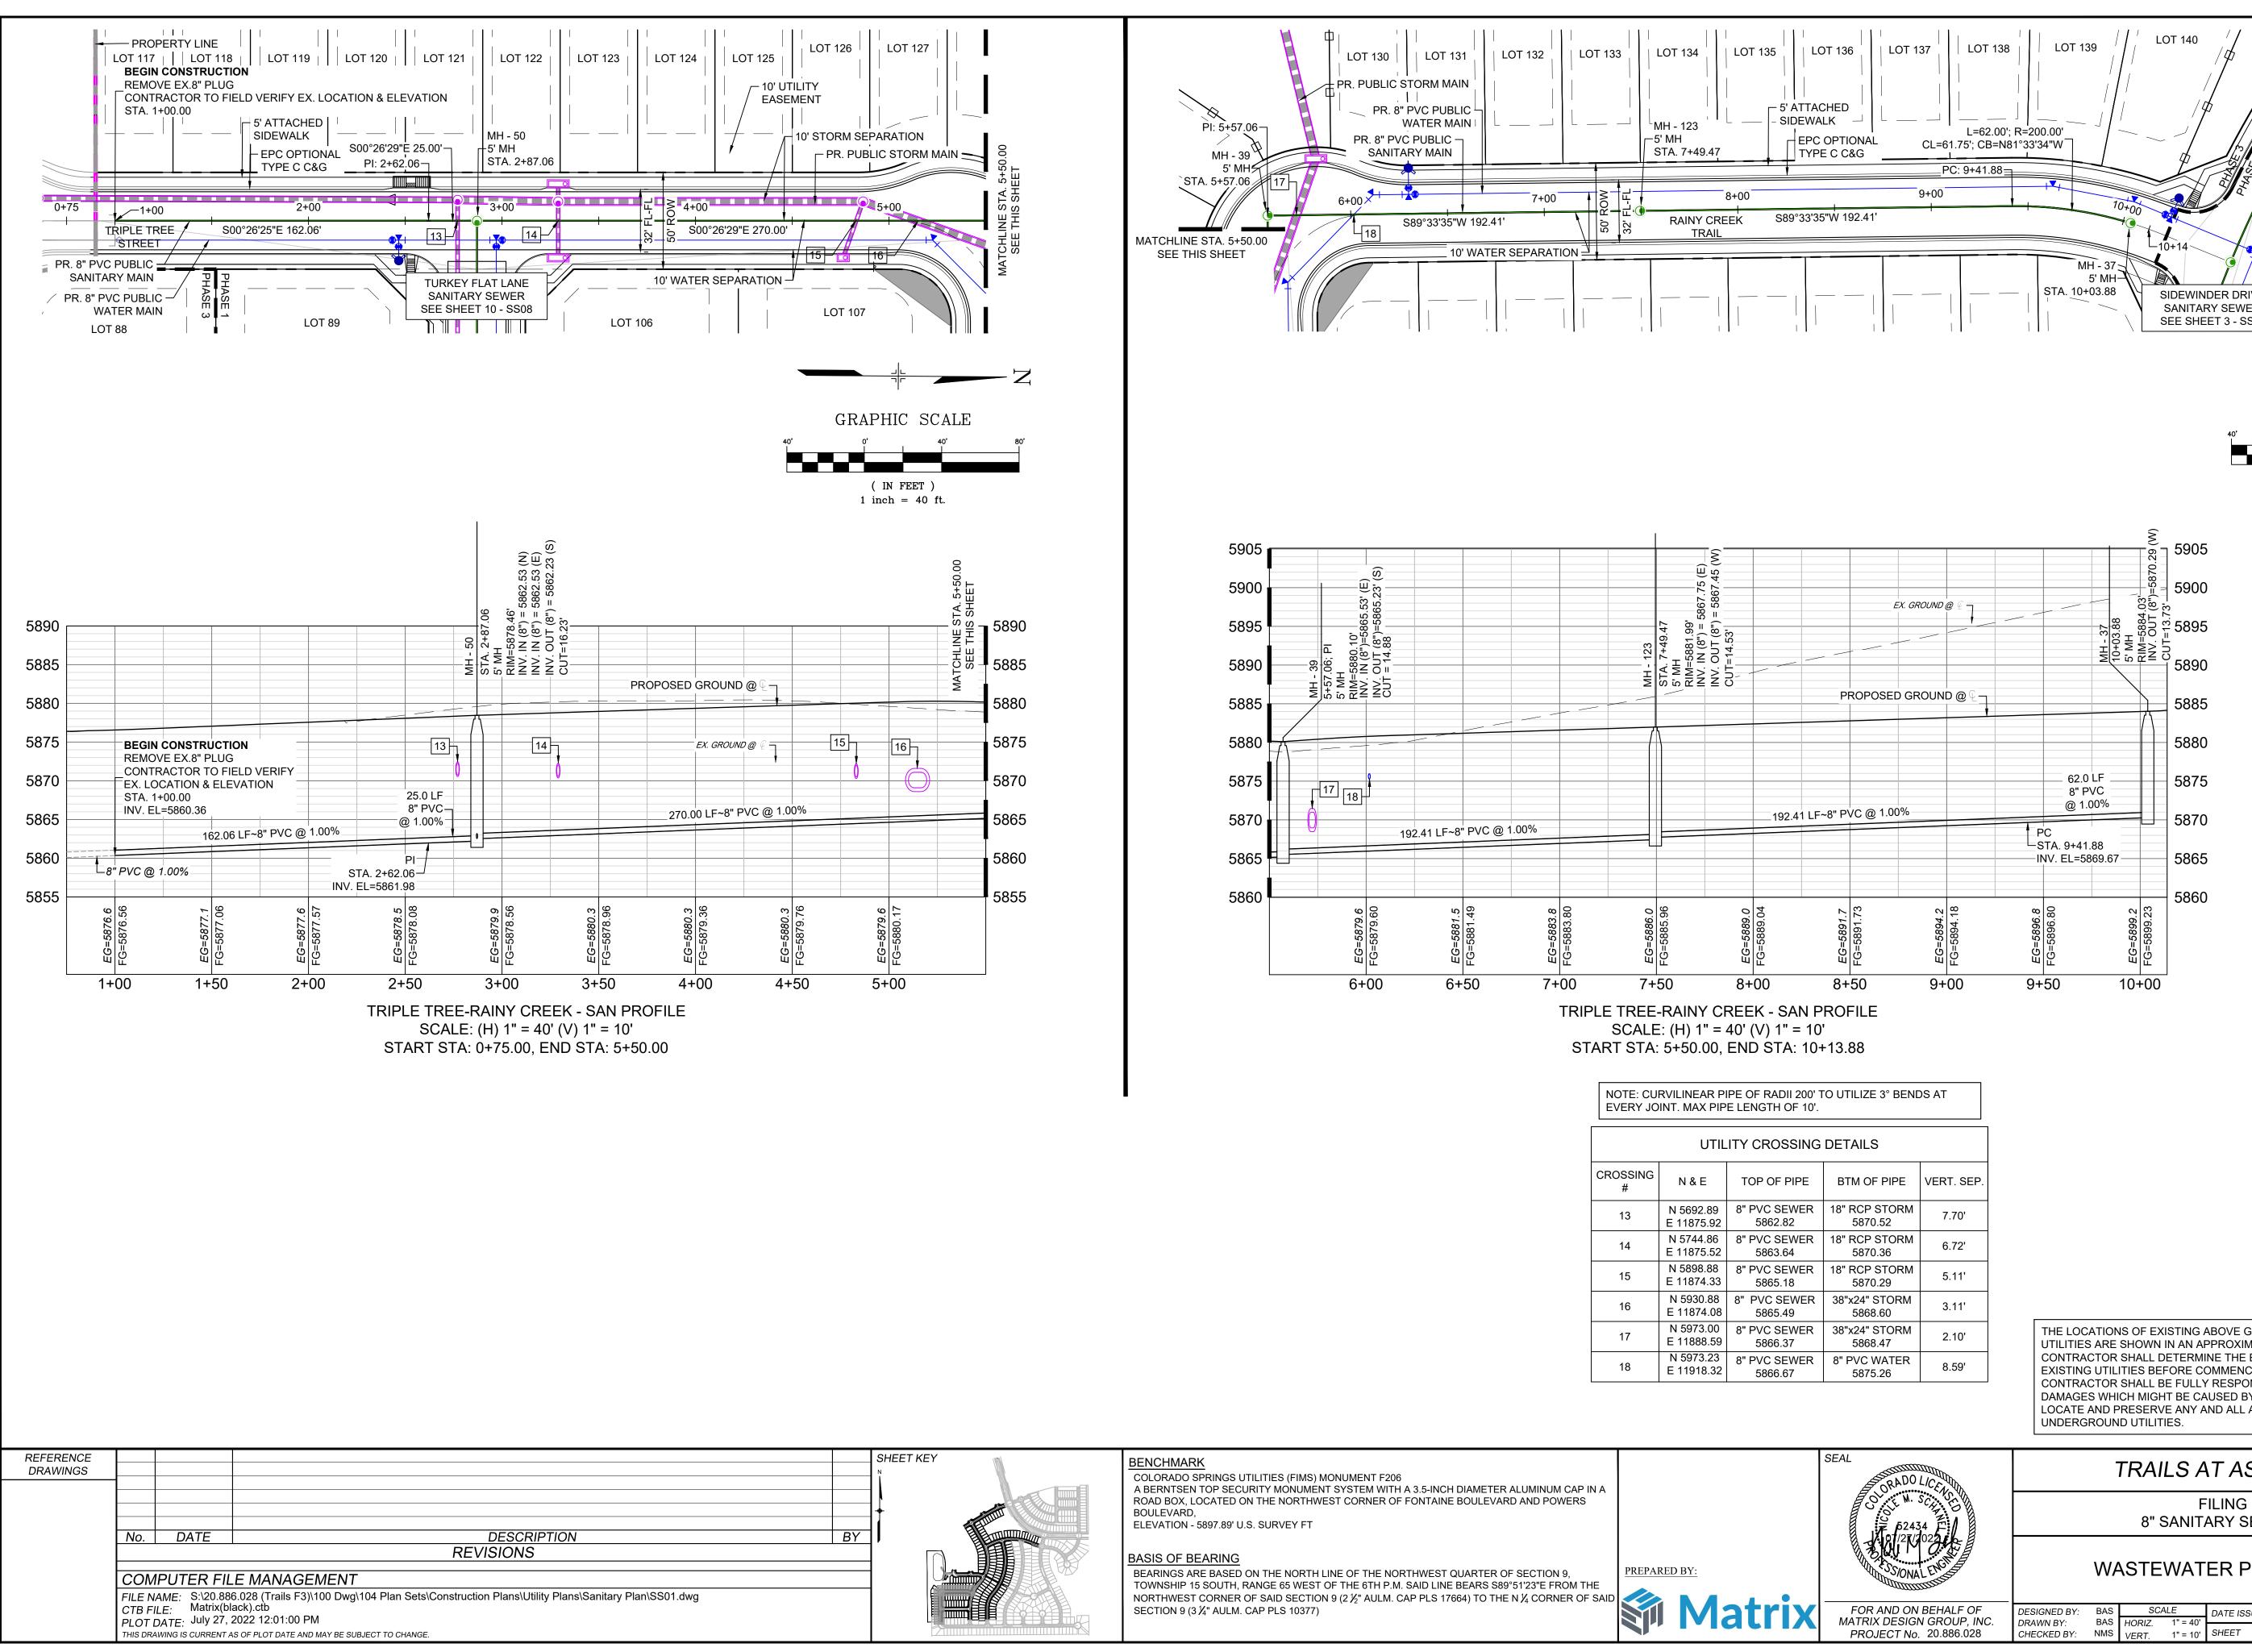

							/	SHEET No.	9
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	<u> </u>					5' MH RIM=5884.03 INV. OUT (8")=5870.29 (W) CUT=13.73'			
	5 (E) .45 (W)					2.000			
	STA. 7+49.47 5' MH RIM=5881.99' INV. IN (8'') = 5867.75 (E) INV. OUT (8'') = 5867.45 (V		E	X. GROUND @ 2		0.065 ± (8")=5 73' ± (8")=5 73' ± (8")=5			
	-49.47 81.99' (8") = { JT (8")				H - 37 +03.88	5' MH FRIM=5884.03 INV. OUT (8'' - CUT=13.73'- - CUT=13.73'-			
MH - 123	8TA. 74 MH 81M=58 NV. IN VV. OU	CUT=14.53			<u>₹</u> P	_ਯ ਛੋਟ ਹੋ 5890			
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						5880			
					62.0 LF				
				0/.	8" PVC @ 1.00%	5875			
		192.41	LF~8" PVC @ 1.00		PC	5870			
					STA. 9+41.88	5865			
	(0	- 4		- m		5860			
EG=5886.0	FG=5885.96	<u>EG=5889.0</u> FG=5889.04	EG=5891.7 FG=5891.73	EG=5894.2 FG=5894.18	EG=5896.80 FG=5896.80	EG=5899.2 FG=5899.23			
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7+: 		8+00	8+50	9+00	9+50	10+00			
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RT STA:	5+50.00,	END STA: 1	0+13.88						
			0' TO UTILIZE 3° B	ENDS AT					
EVERY JU	INT. MAX PIP	E LENGTH OF 1	U ^r .						
	UTIL	ITY CROSSIN	IG DETAILS						
ROSSING #	N & E	TOP OF PIPE							
13	N 5692.89 E 11875.92	8" PVC SEWER 5862.82	5870.52	7.70'					
14	N 5744.86 E 11875.52	8" PVC SEWER 5863.64	5870.36	6.72					
15	N 5898.88 E 11874.33	8" PVC SEWER 5865.18	5870.29	5.11					
16	N 5930.88 E 11874.08 N 5973.00	8" PVC SEWE 5865.49 8" PVC SEWE	5868.60	3.11		S OF EXISTING ABOVE			
17	E 11888.59 N 5973.23	8 PVC SEWER 5866.37 8" PVC SEWER	5868.47	2.10	UTILITIES ARE S CONTRACTOR S	SHOWN IN AN APPROX SHALL DETERMINE TH	(IMATE WAY ONLY E EXACT LOCATIO	7. THE DN OF ALL	
18	E 11918.32	5866.67	5875.26	8.59'	CONTRACTOR	TIES BEFORE COMME SHALL BE FULLY RESP	PONSIBLE FOR AN	Y AND ALL	
						CH MIGHT BE CAUSED RESERVE ANY AND AL D UTILITIES.			
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			O'O'	M. SCHERE		FILIN 8" SANITARY	G NO. 3 SEWER PLAN		
				52434 F		U SANTARY			
PREPA	RED BY:			ONAL ENGINE	WA	STEWATER	PLAN & PF	ROFILE	
		atrix	FOR AND	ON BEHALF OF	DESIGNED BY: BAS	SCALE DATE	ISSUED: Mi	ARCH 2022 DRAWING No	D.
		au 1/	MATRIX DE PROJECT	SIGN GROUP, INC. No. 20.886.028	DRAWN BY: BAS	HORIZ. 1" = 40' VERT. 1" = 10' SHEET		9 OF 15 SS0	

	UTIL	ITY CROSSING	DE
CROSSING #	N & E	TOP OF PIPE	
13	N 5692.89 E 11875.92	8" PVC SEWER 5862.82	18
14	N 5744.86 E 11875.52	8" PVC SEWER 5863.64	18
15	N 5898.88 E 11874.33	8" PVC SEWER 5865.18	18
16	N 5930.88 E 11874.08	8" PVC SEWER 5865.49	3
17	N 5973.00 E 11888.59	8" PVC SEWER 5866.37	3
18	N 5973.23 E 11918.32	8" PVC SEWER 5866.67	8

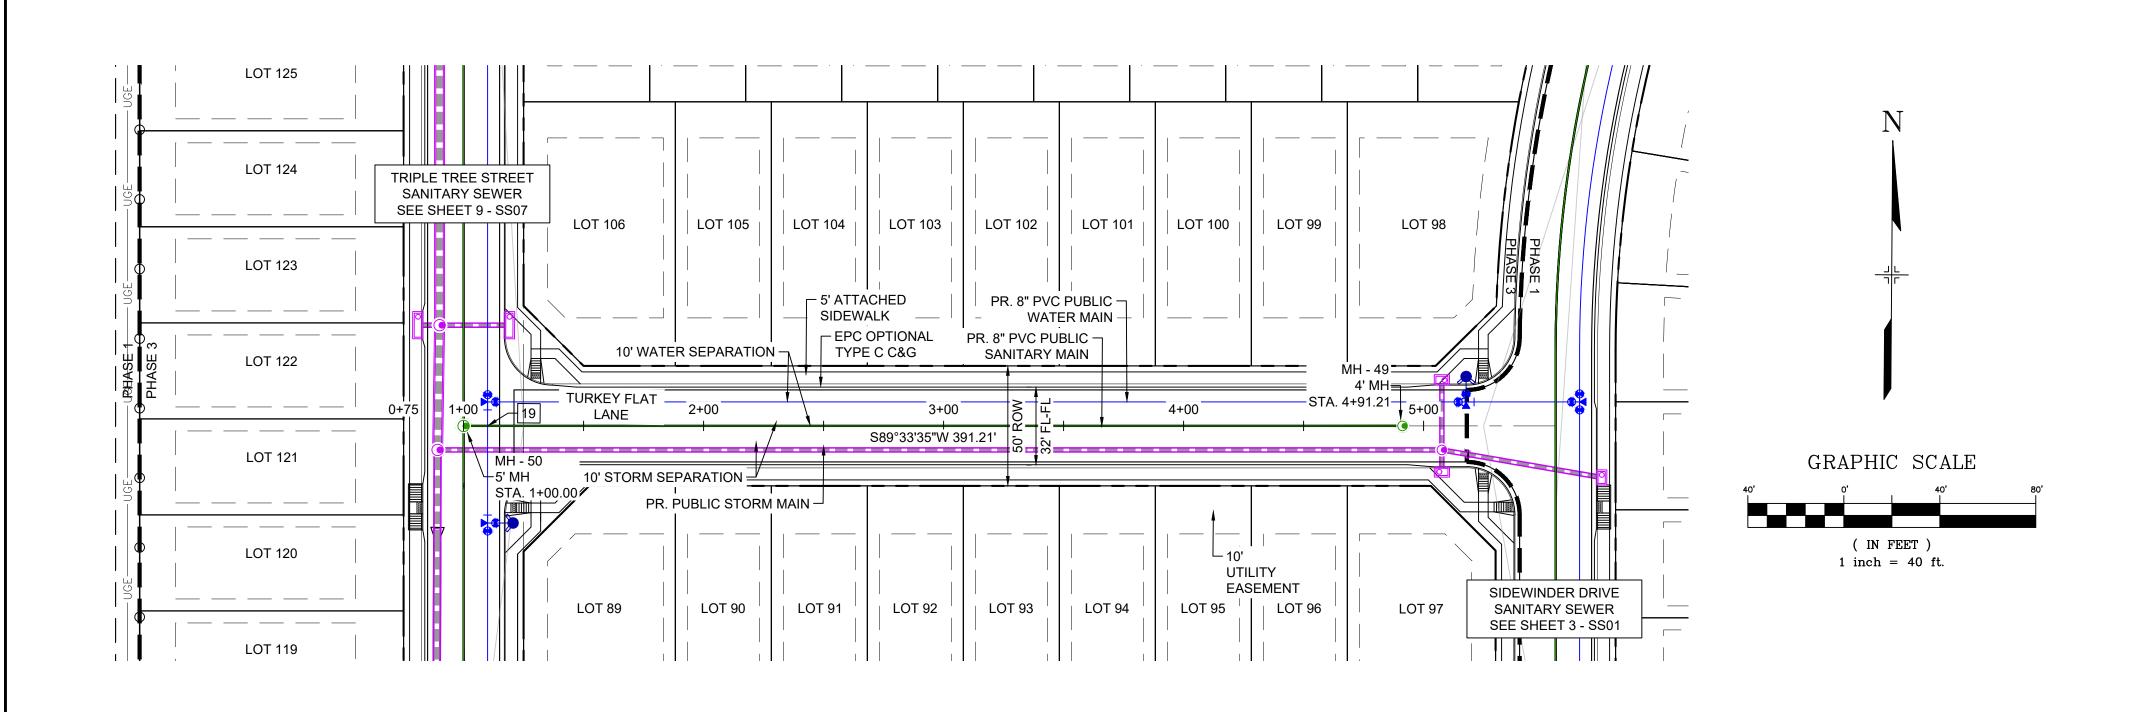

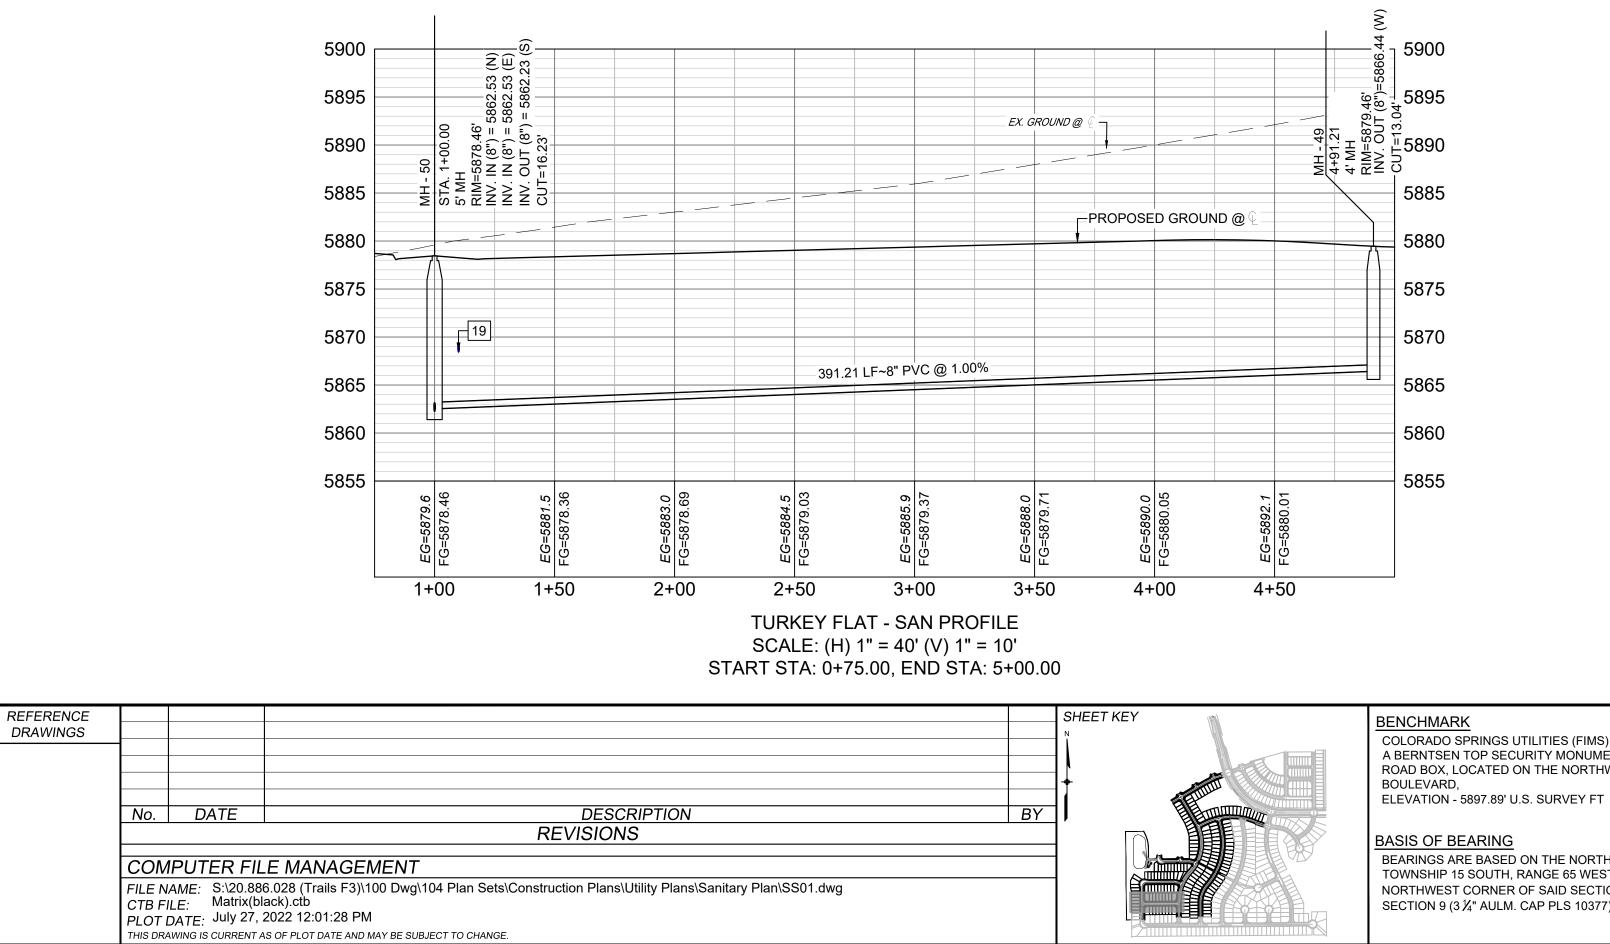

COLORADO SPRINGS UTILITIES (FIMS) MONUMENT F206

A BERNTSEN TOP SECURITY MONUMENT SYSTEM WITH A 3.5-INCH DIAMETER ALUMINUM CAP IN A ROAD BOX, LOCATED ON THE NORTHWEST CORNER OF FONTAINE BOULEVARD AND POWERS BOULEVARD,

BASIS OF BEARING

BEARINGS ARE BASED ON THE NORTH LINE OF THE NORTHWEST QUARTER OF SECTION 9, TOWNSHIP 15 SOUTH, RANGE 65 WEST OF THE 6TH P.M. SAID LINE BEARS S89°51'23"E FROM THE NORTHWEST CORNER OF SAID SECTION 9 (2 1/2" AULM. CAP PLS 17664) TO THE N 1/4 CORNER OF SAID SECTION 9 (3 ¼" AULM. CAP PLS 10377)

PREPAREI	<u>) BY:</u>	
	Matrix	_



	UTILITY CROSSING DETAILS											
CROSSING #	N & E TOP OF PIPE BTM OF PIPE VERT. SEP.											
19	N 5702.97 E 11885.84	8" PVC SEWER 5863.32	8" PVC WATER 5867.73	4.41'								


THE LOCATIONS OF EXISTING ABOVE GROUND AND UNDERGROUND UTILITIES ARE SHOWN IN AN APPROXIMATE WAY ONLY. THE CONTRACTOR SHALL DETERMINE THE EXACT LOCATION OF ALL EXISTING UTILITIES BEFORE COMMENCING WORK. THE CONTRACTOR SHALL BE FULLY RESPONSIBLE FOR ANY AND ALL DAMAGES WHICH MIGHT BE CAUSED BY HIS FAILURE TO EXACTLY LOCATE AND PRESERVE ANY AND ALL ABOVE GROUND AND UNDERGROUND UTILITIES.



TRAILS AT ASPEN RIDGE

FILING NO. 3 **8" SANITARY SEWER PLANS**

= OF	DESIGNED BY:	BAS	SCA	ALE	DATE ISSUED:	MARCH 2022	DRAWING No.	
P, INC. .028	DRAWN BY: CHECKED BY:	BAS NMS	HORIZ. VERT.	1" = 40' 1" = 10'	SHEET	10 OF 15	SS08	
	SHEGHEB BH		VLINI.	1 10				_

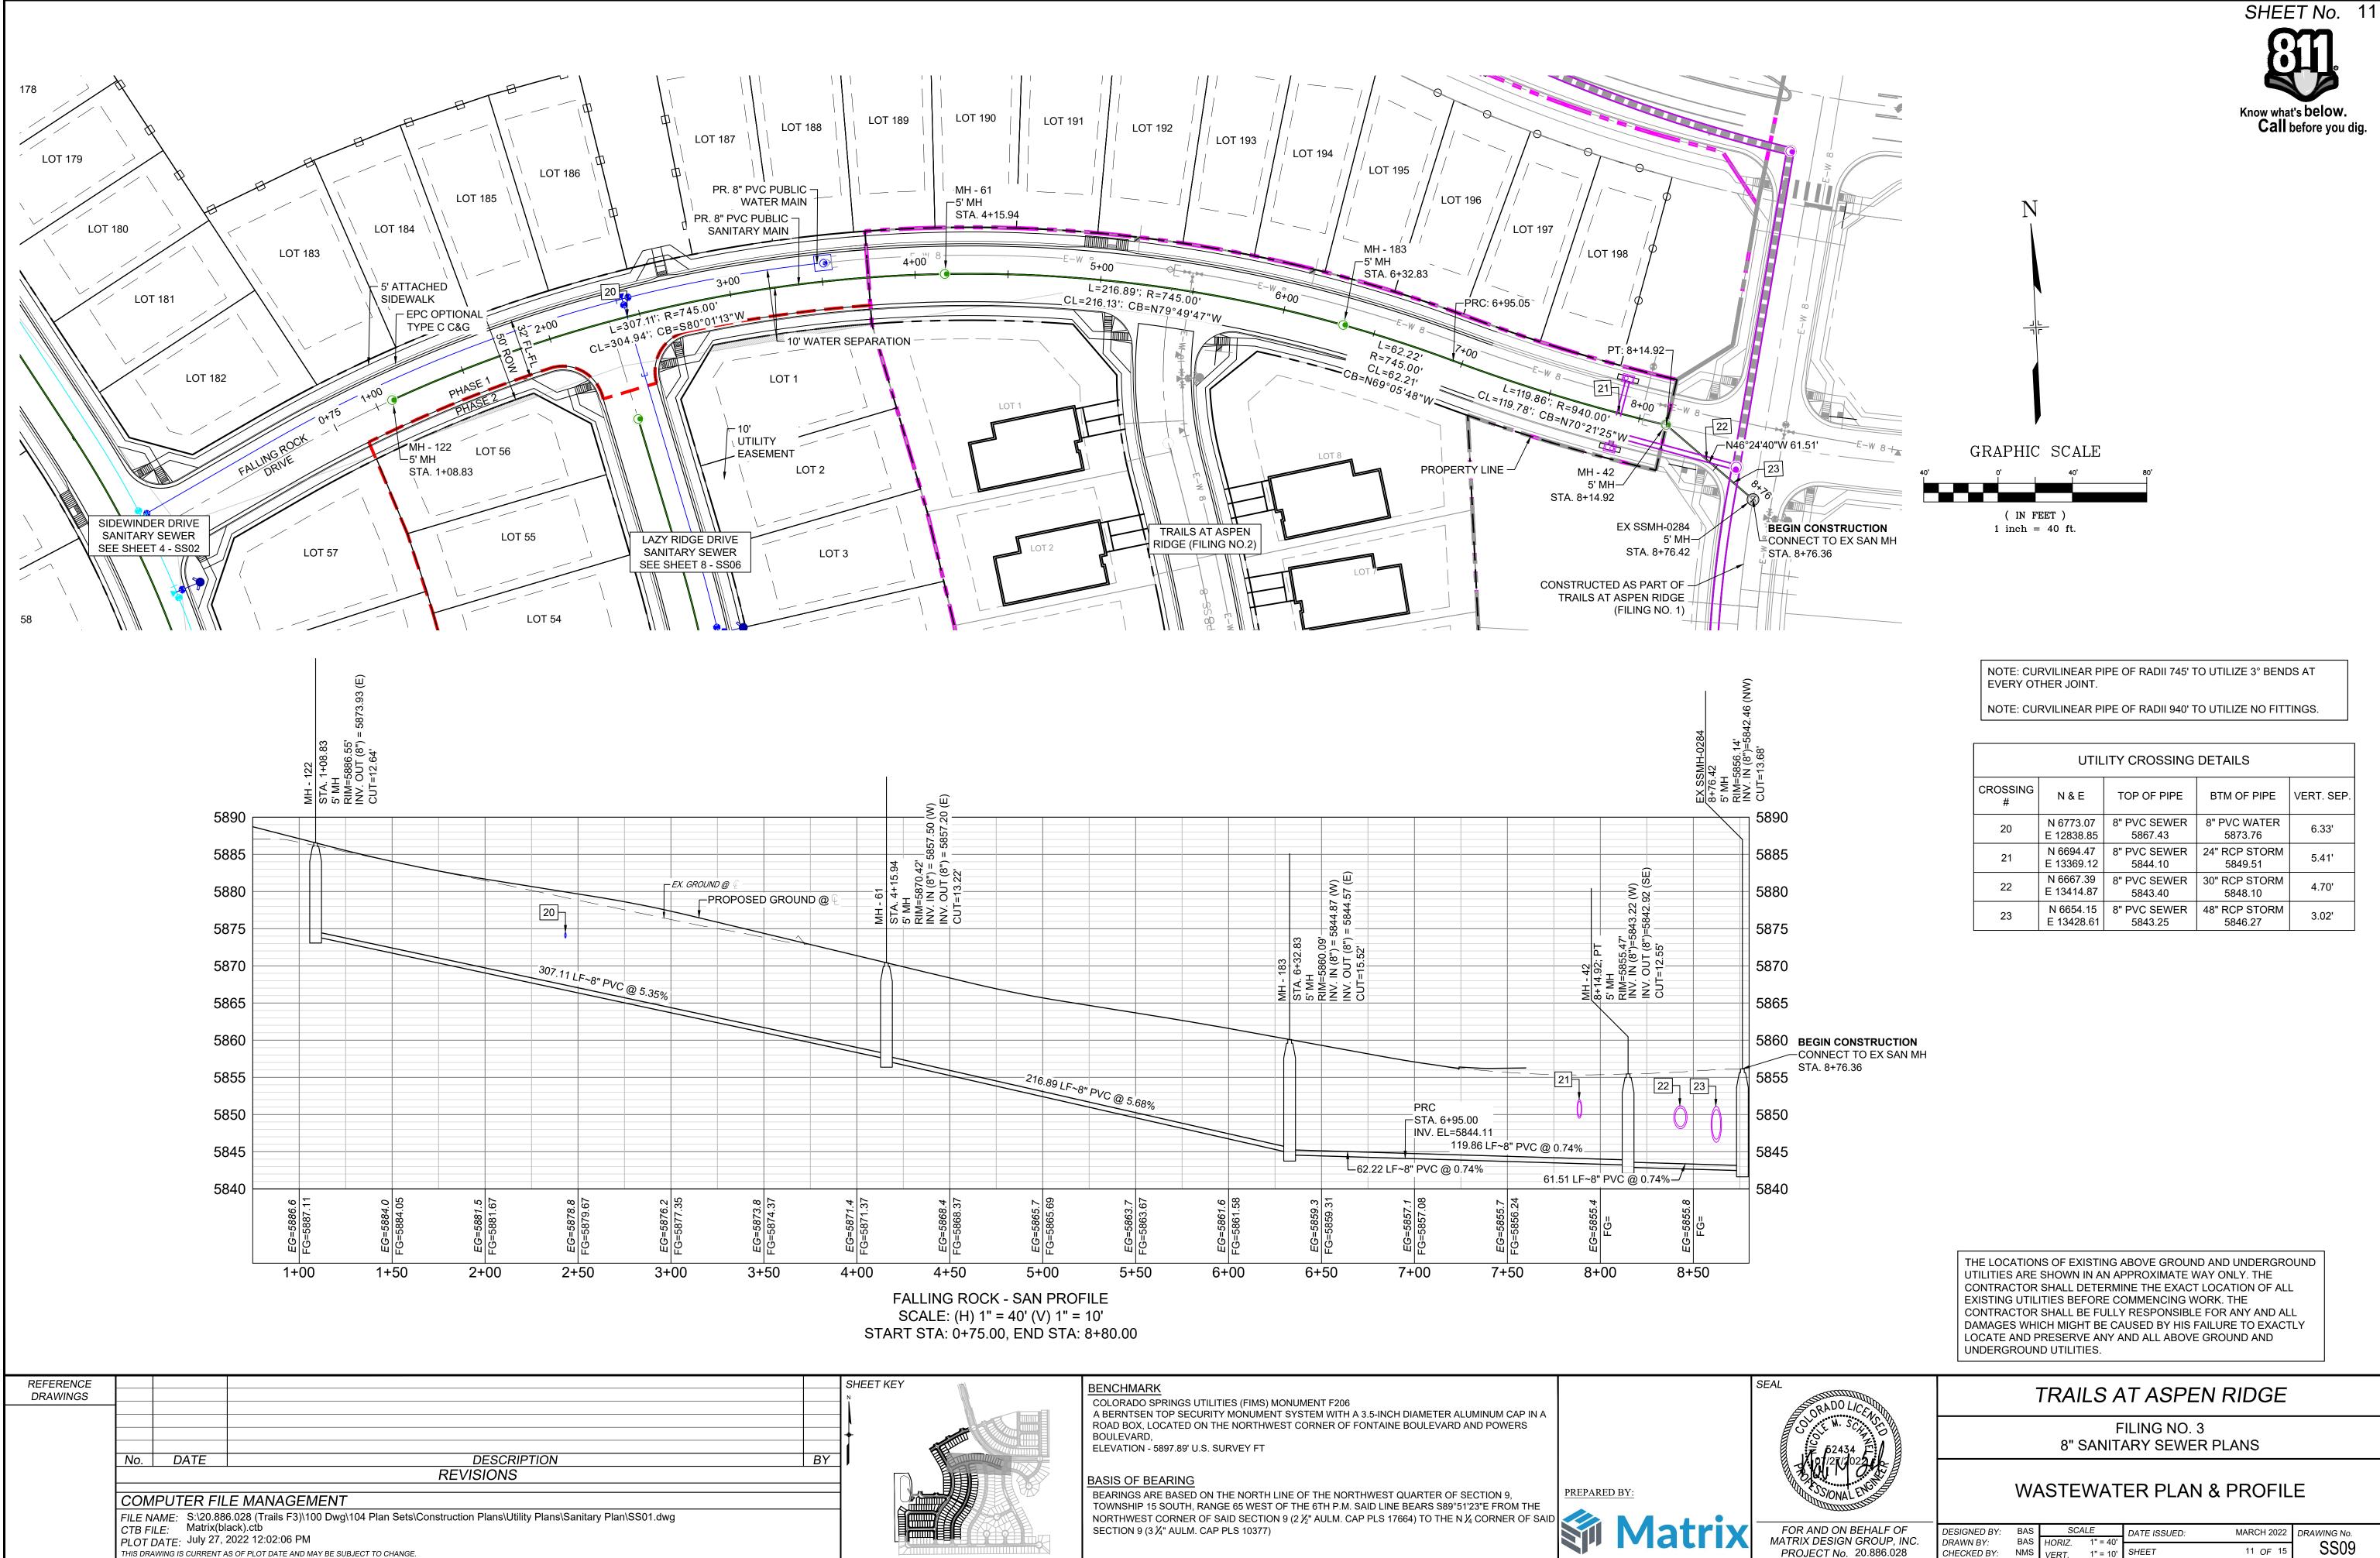


<u>PREPAREI</u>	DBY:	
	Matrix	


NOTE: CURVILINEAR PIPE OF RADII 940' TO UTILIZE NO FITTINGS.

CROSSING #	N & E	TOP OF PIPE	BTM OF PIPE	VERT. SEP.
20	N 6773.07 E 12838.85	8" PVC SEWER 5867.43	8" PVC WATER 5873.76	6.33'
21	N 6694.47 E 13369.12	8" PVC SEWER 5844.10	24" RCP STORM 5849.51	5.41'
22	N 6667.39 E 13414.87	8" PVC SEWER 5843.40	30" RCP STORM 5848.10	4.70'
23	N 6654.15 E 13428.61	8" PVC SEWER 5843.25	48" RCP STORM 5846.27	3.02'

D ON BEHALF OF	DESIGNED BY:	BAS	SCA	ALE	DATE ISSUED:	MARCH 2022	DRAWING No.	
ESIGN GROUP, INC.	DRAWN BY:	BAS	HORIZ.	1" = 40'			0000	
,					SHEET	11 OF 15	SS09	
T No. 20.886.028	CHECKED BY:	NMS	VERT.	1" = 10'	SHEET	11 OF 15	0000	

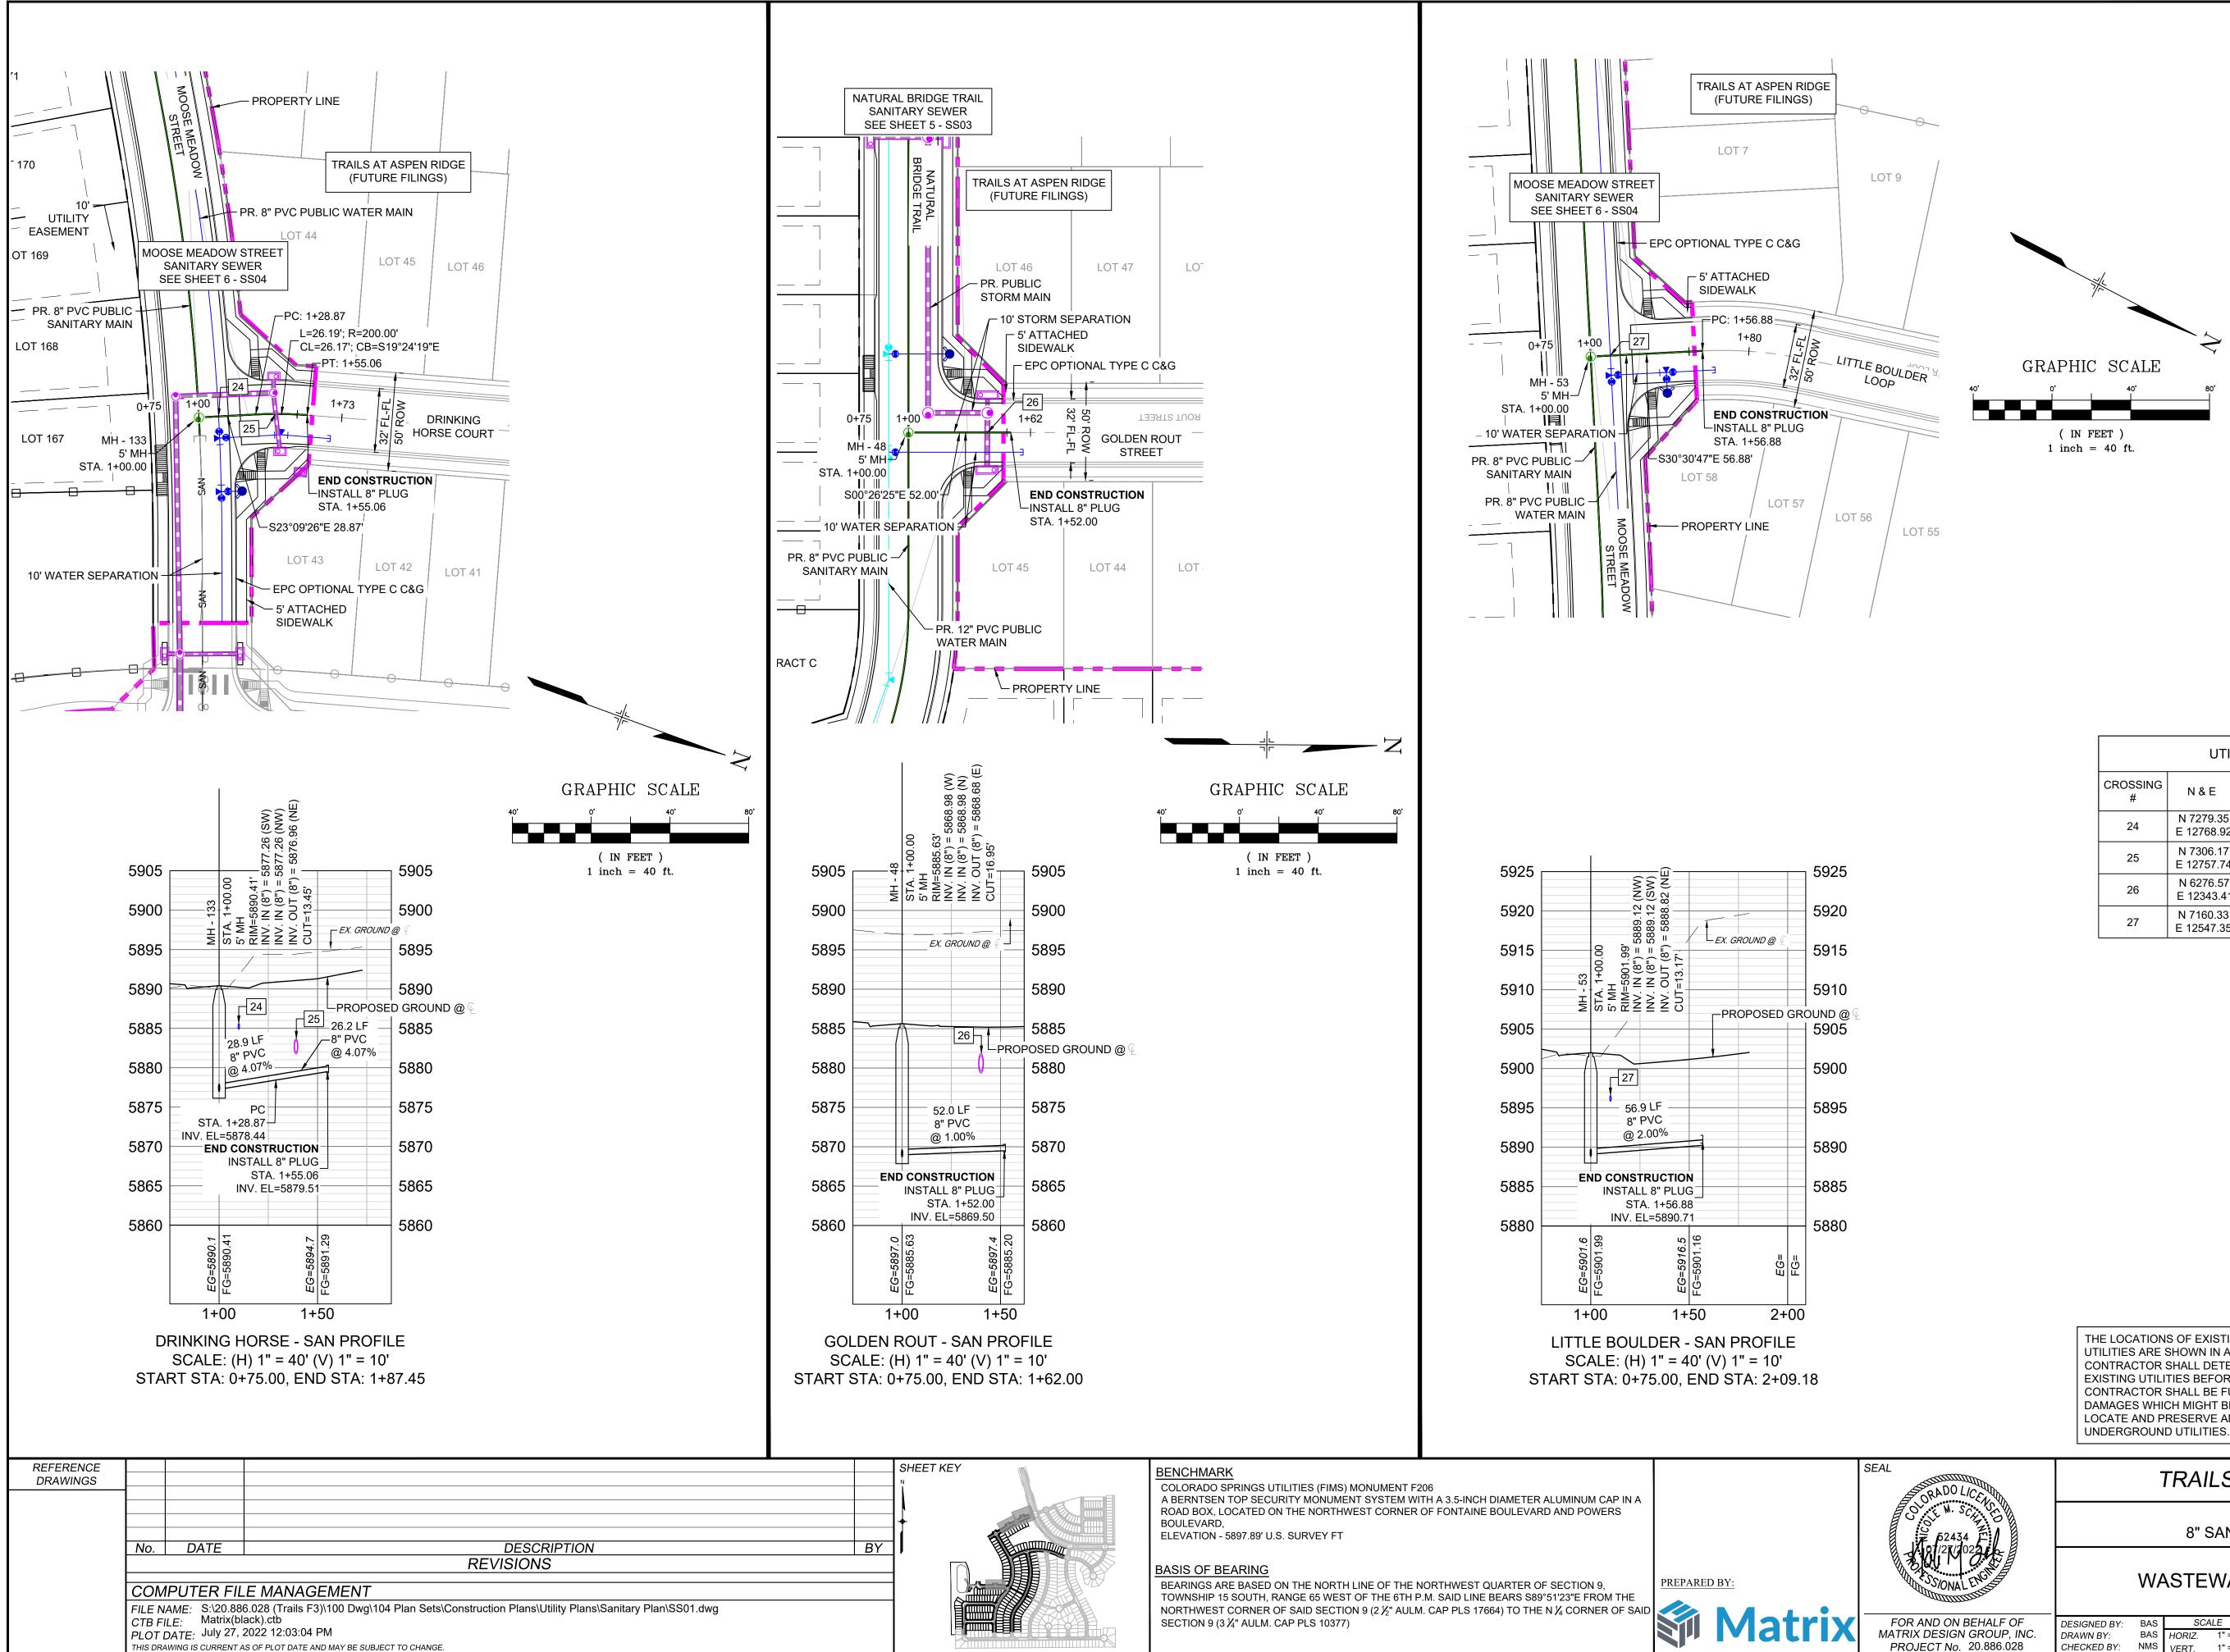

THIS DRAWING IS CURRENT AS OF PLOT DATE AND MAY BE SUBJECT TO CHANGE

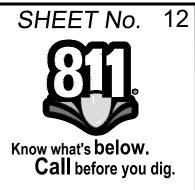


UTILITY CROSSING DETAILS N & E TOP OF PIPE BTM OF PIPE VERT. SEP. N 7279.35 | 8" PVC SEWER | 8" PVC WATER 6.83' E 12768.92 5878.05 5884.88 N 7306.17 | 8" PVC SEWER | 18" RCP STORM 2.21' E 12757.74 5879.54 5881.75 N 6276.57 8" PVC SEWER 24" RCP STORM 9.27' E 12343.41 5870.07 5879.34 N 7160.33 8" PVC SEWER 8" PVC WATER 5.75' E 12547.35 5890.09 5895.84

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TRAILS AT ASPEN RIDGE

FILING NO. 3 **8" SANITARY SEWER PLANS**

OF	DESIGNED BY:	BAS	SCALE		DATE ISSUED:	MARCH 2022	DRAWING No.
P, INC. 028	DRAWN BY: CHECKED BY:	BAS NMS	HORIZ. VERT.	1" = 40' 1" = 10'	SHEET	12 OF 15	SS10

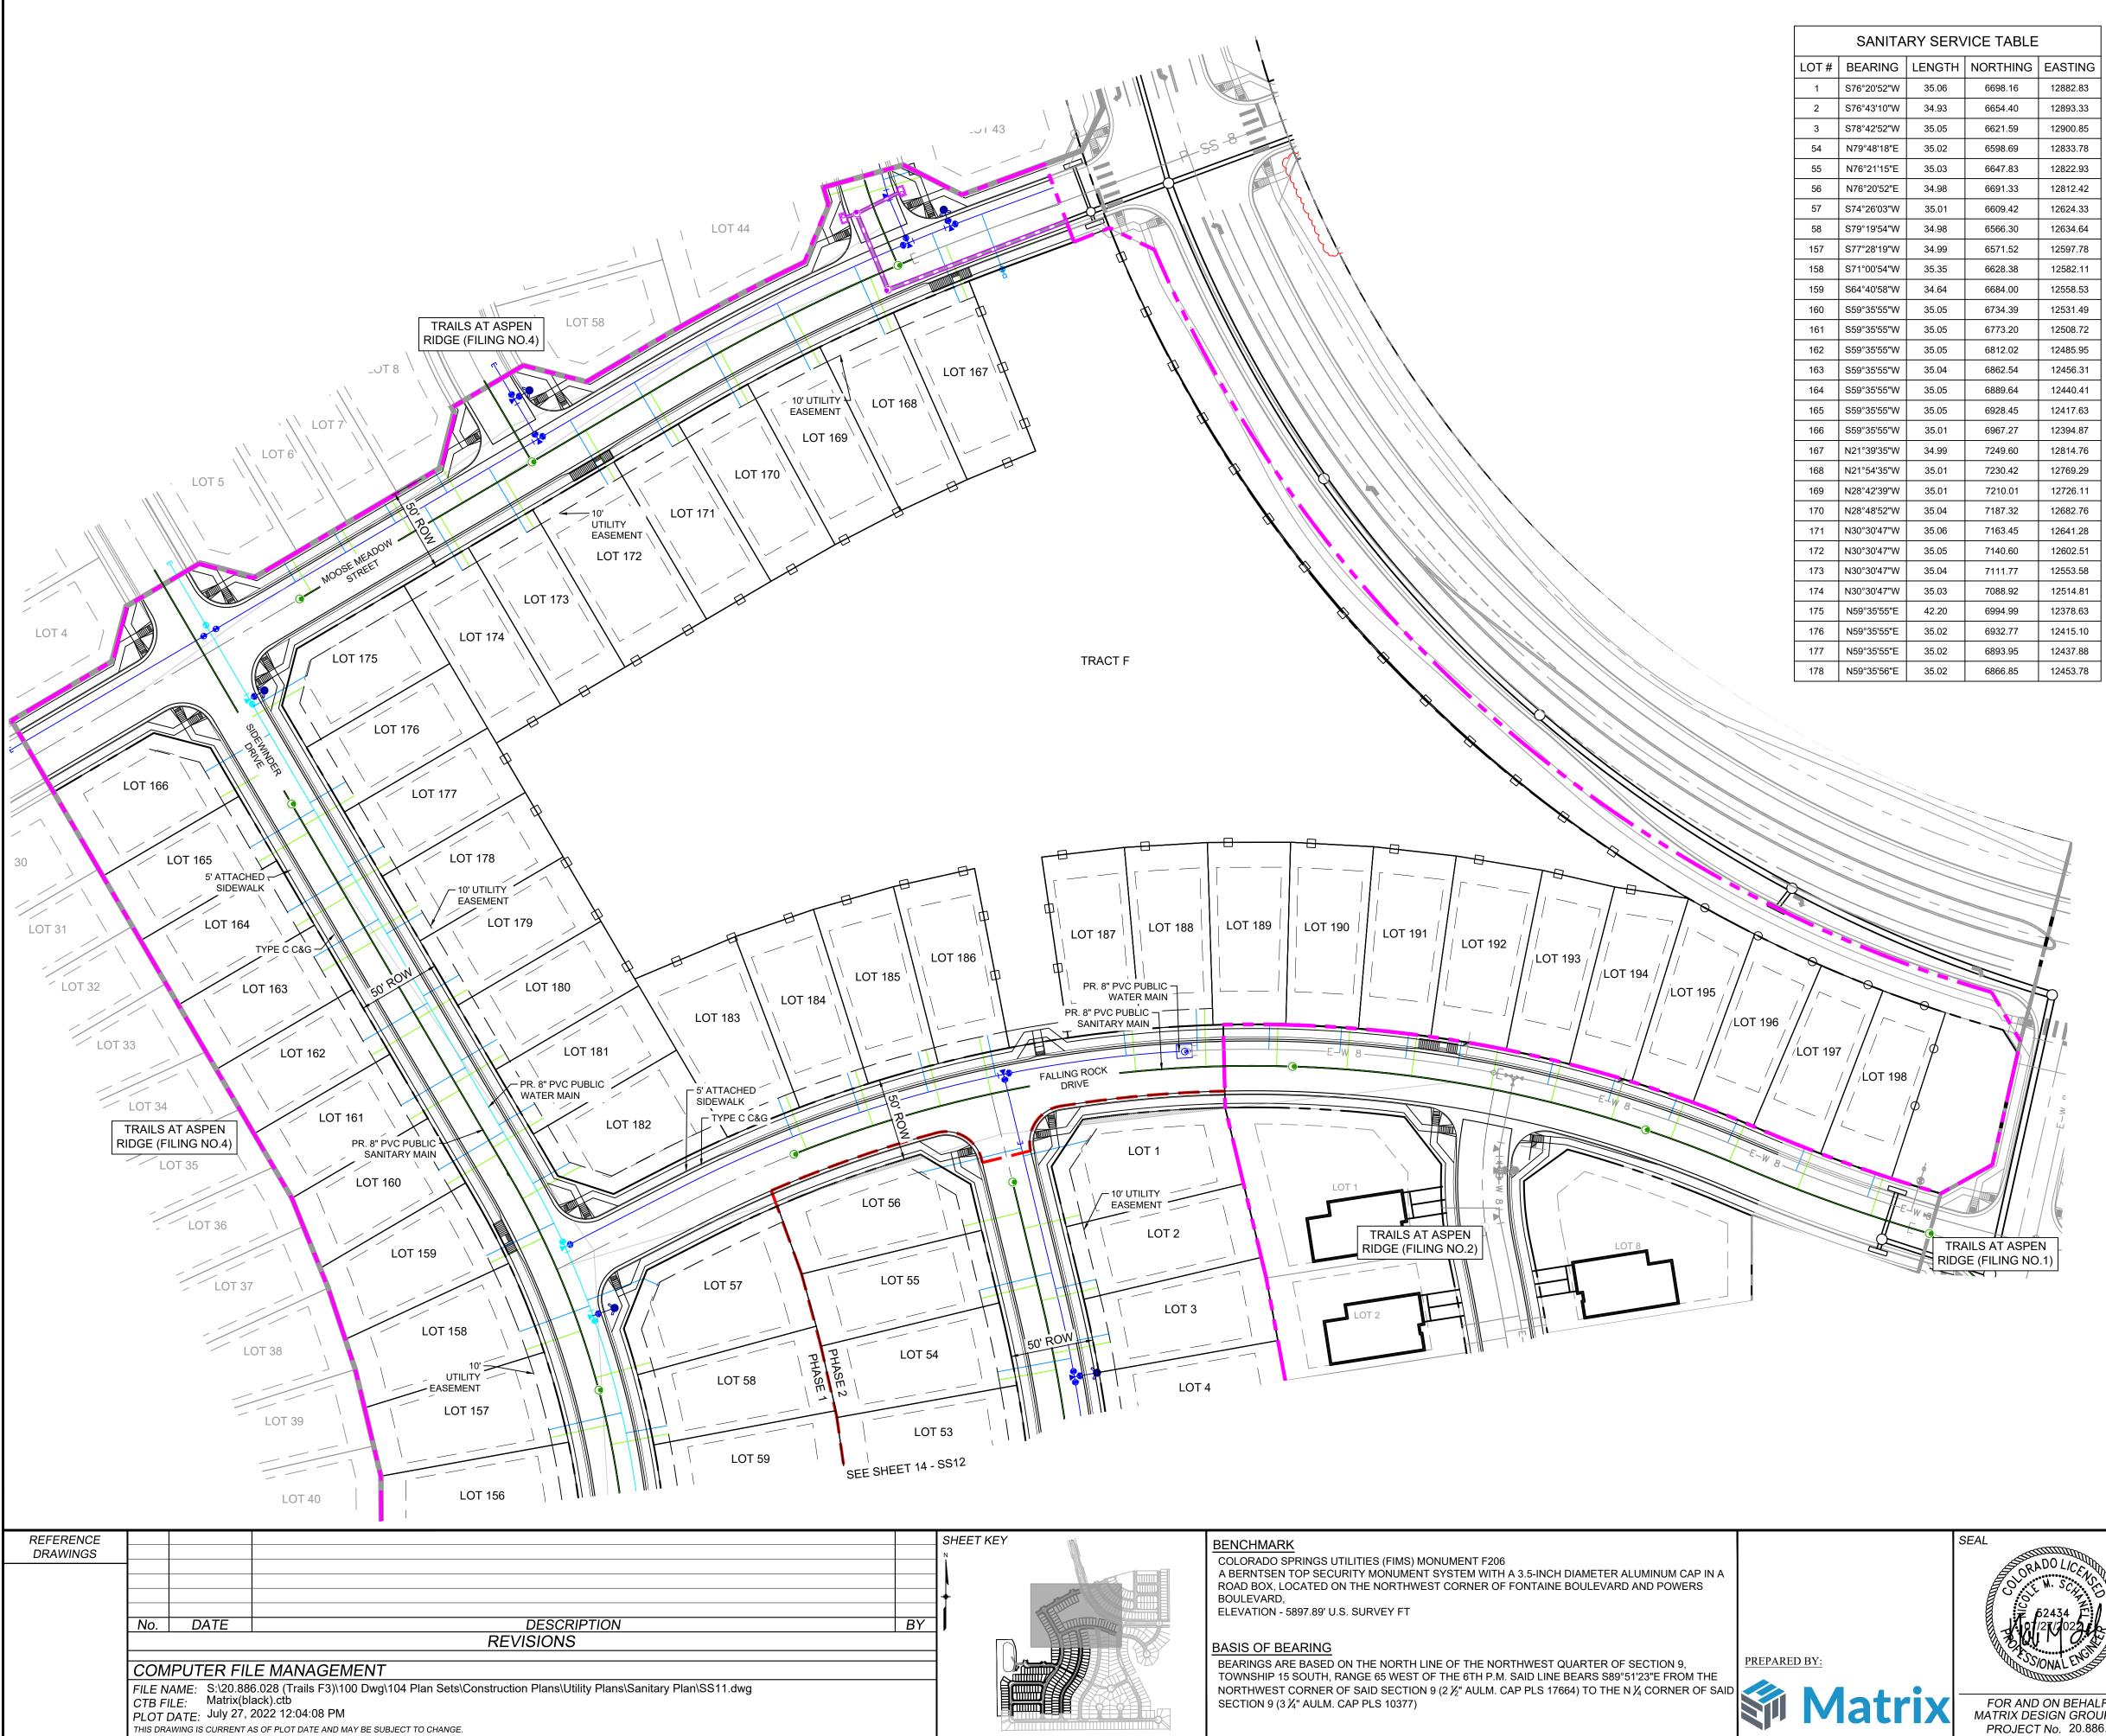


SHEET KEY	

	165	S59°35'55"W	35.05	6928.45	12417.63		195	N20°10'25"E	24.84	6744.08	13238.50	
	166	S59°35'55"W	35.01	6967.27	12394.87		196	N23°05'22"E	24.59	6730.44	13273.67	
_	167	N21°39'35"W	34.99	7249.60	12814.76	-	197	N21°41'47"E	25.02	6713.56	13314.75	
_	168	N21°54'35"W	35.01	7230.42	12769.29		198	N17°46'48"E	25.02	6697.76	13358.95	-
-	169	N28°42'39"W	35.01	7210.01	12726.11		201	N74°19'28"E	25.00	7311.96	12729.50	
-	170	N28°48'52"W	35.04	7187.32	12682.76	-	202	S73°22'46"W	35.60	7324.08	12789.03	
-	171	N30°30'47"W	35.06	7163.45	12641.28	-	203	N30°30'47"W	25.00	7073.34	12419.44	
-	172	N30°30'47"W	35.05	7140.60	12602.51	F	204	N30°30'47"W	25.00	7091.11	12449.60	-
-	173	N30°30'47"W	35.04	7111.77	12553.58	ľ	205	N30°30'47"W	25.00	7108.88	12479.75	-
-	174	N30°30'47"W	35.03	7088.92	12514.81	Ĺ	206	S30°30'47"E	25.18	7148.86	12497.98	
-	175 176	N59°35'55"E N59°35'55"E	42.20	6994.99	12378.63	1						
-	170	N59°35'55"E	35.02 35.02	6932.77 6893.95	12415.10 12437.88			: LOTS 201-20 TO BE BUILT				Ν
-	178	N59°35'56"E	35.02	6866.85	12453.78			N RIDGE F3				
OT 196	LOT 197			AILS AT ASPE BE (FILING NO								APHIC SCALE $\int _{1}^{50'} \int _{10'}^{10'}$ (IN FEET) 1 inch = 50 ft.
								UTILITIES AR CONTRACTO EXISTING UT CONTRACTO DAMAGES W	E SHOWN R SHALL E ILITIES BE R SHALL E HICH MIGH PRESERV	IN AN APPRO DETERMINE T FORE COMM BE FULLY RES IT BE CAUSE /E ANY AND /	DXIMATE W THE EXACT IENCING WO SPONSIBLE D BY HIS F.	D AND UNDERGROUND AY ONLY. THE LOCATION OF ALL ORK. THE E FOR ANY AND ALL AILURE TO EXACTLY GROUND AND
			S	SEAL	DO LICEN				TRA	ILS AT	ASPE	EN RIDGE
					M. SCH				• "		ING NO.	
									δ	SANITAR	T SEVVE	RPLANS
<u>PREPAREI</u>	<u> </u>			ALL SS	IM O. A				SAN	NITARY	SERV	ICE PLAN
			•		AMARINA ST							
	M	latr	XI	MATRIX DE	ON BEHALI SIGN GROU No. 20.886	P, INC.	DRA	WN BY: B	AS SO AS HORIZ. MS VERT.	1" = 50'	TE ISSUED: IEET	MARCH 2022 DRAWING No. 13 OF 15 SS11
							-			•		

NORTHING	EASTING
6698.16	12882.83
6654.40	12893.33
6621.59	12900.85
6598.69	12833.78
6647.83	12822.93
6691.33	12812.42
6609.42	12624.33
6566.30	12634.64
6571.52	12597.78
6628.38	12582.11
6684.00	12558.53
6734.39	12531.49
6773.20	12508.72
6812.02	12485.95
6862.54	12456.31
6889.64	12440.41
6928.45	12417.63
6967.27	12394.87
7249.60	12814.76
7230.42	12769.29
7210.01	12726.11
7187.32	12682.76
7163.45	12641.28
7140.60	12602.51
7111.77	12553.58
7088.92	12514.81
6994.99	12378.63
6932.77	12415.10
6893.95	12437.88

SANITARY SERVICE TABLE						
LOT #	BEARING	LENGTH	NORTHING	EASTING		
179	N59°35'55"E	34.41	6816.50	12483.71		
180	N59°35'55"E	35.01	6777.52	12506.19		
181	N59°35'55"E	35.00	6738.70	12528.96		
182	S60°55'11"W	40.47	6727.54	12582.10		
183	N21°09'39"W	34.94	6737.68	12717.82		
184	N17°53'53"W	34.95	6751.86	12757.80		
185	N14°38'07"W	34.95	6763.74	12798.52		
186	N11°50'40"W	34.95	6771.01	12828.95		
187	N05°26'15"W	34.95	6784.56	12916.17		
188	N01°33'15"W	34.95	6787.38	12958.49		
189	N02°09'46"E	25.22	6787.55	13000.91		
190	N04°21'03"E	25.15	6785.60	13043.27		
191	N07°36'49"E	25.10	6781.66	13082.19		
192	N10°26'56"E	25.00	6774.02	13129.92		
193	N14°23'20"E	25.03	6765.93	13166.31		
194	N17°17'50"E	25.00	6755.93	13202.67		
195	N20°10'25"E	24.84	6744.08	13238.50		
196	N23°05'22"E	24.59	6730.44	13273.67		
197	N21°41'47"E	25.02	6713.56	13314.75		
198	N17°46'48"E	25.02	6697.76	13358.95		
201	N74°19'28"E	25.00	7311.96	12729.50		
202	S73°22'46"W	35.60	7324.08	12789.03		
203	N30°30'47"W	25.00	7073.34	12419.44		
204	N30°30'47"W	25.00	7091.11	12449.60		
205	N30°30'47"W	25.00	7108.88	12479.75		
206	S30°30'47"E	25.18	7148.86	12497.98		

SHEET No. 13 Know what's **below. Call** before you dig.

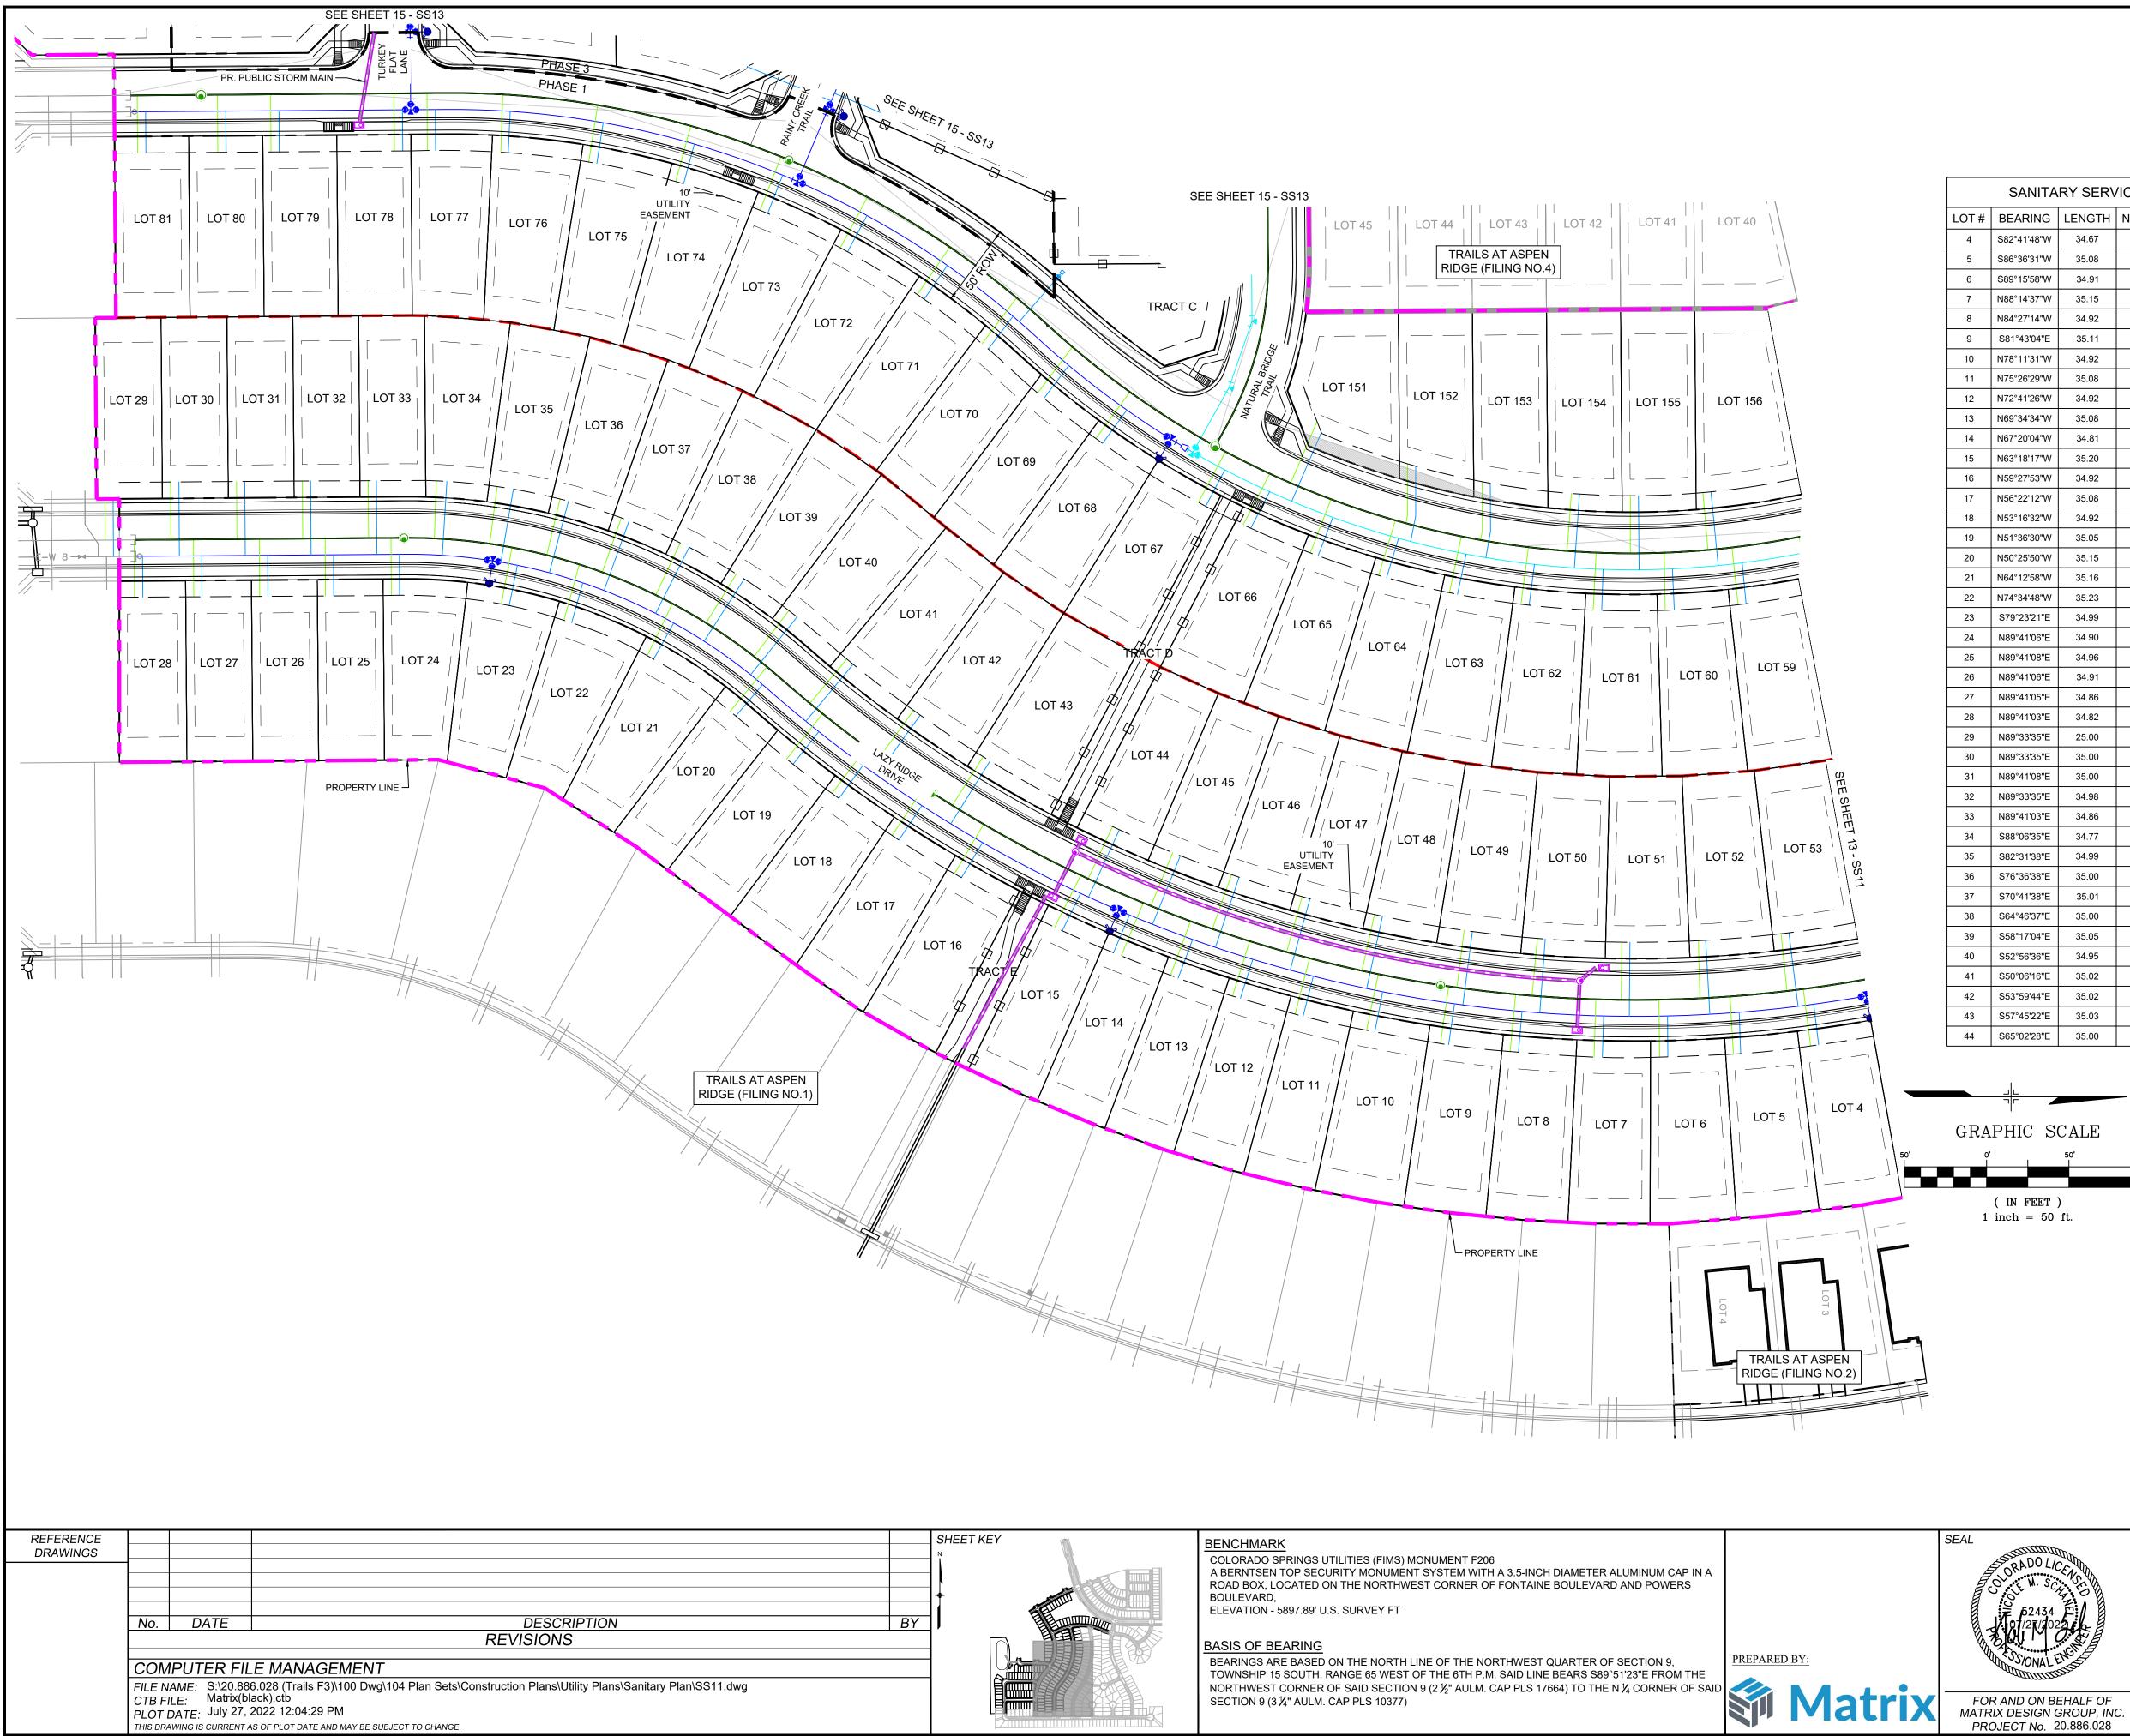

THIS DRAWING IS CURRENT AS OF PLOT DATE AND MAY BE SUBJECT TO CHANGE.



SANITARY SERVICE TABLE						
OT #	BEARING	LENGTH	NORTHING	EASTING		
4	S82°41'48"W	34.67	6566.75	12909.58		
5	S86°36'31"W	35.08	6519.87	12914.51		
6	S89°15'58"W	34.91	6475.03	12916.36		
7	N88°14'37"W	35.15	6435.26	12916.34		
8	N84°27'14"W	34.92	6384.23	12912.95		
9	S81°43'04"E	35.11	6346.97	12873.37		
10	N78°11'31"W	34.92	6297.00	12900.02		
11	N75°26'29"W	35.08	6253.59	12890.23		
12	N72°41'26"W	34.92	6215.64	12879.22		
13	N69°34'34"W	35.08	6177.95	12866.64		
14	N67°20'04"W	34.81	6148.02	12854.78		
15	N63°18'17"W	35.20	6107.59	12837.38		
16	N59°27'53"W	34.92	6046.70	12804.89		
17	N56°22'12"W	35.08	6008.81	12781.65		
18	N53°16'32"W	34.92	5972.43	12756.14		
19	N51°36'30"W	35.05	5944.81	12735.22		
20	N50°25'50"W	35.15	5910.48	12706.25		
21	N64°12'58"W	35.16	5860.13	12672.40		
22	N74°34'48"W	35.23	5809.48	12650.89		
23	S79°23'21"E	34.99	5777.99	12606.64		
24	N89°41'06"E	34.90	5704.50	12600.86		
25	N89°41'08"E	34.96	5664.50	12601.17		
26	N89°41'06"E	34.91	5624.50	12601.47		
27	N89°41'05"E	34.86	5584.50	12601.78		
28	N89°41'03"E	34.82	5548.51	12602.06		
29	N89°33'35"E	25.00	5530.69	12577.19		
30	N89°33'35"E	35.00	5570.61	12566.89		
31	N89°41'08"E	35.00	5610.68	12566.58		
32	N89°33'35"E	34.98	5650.61	12566.29		
33	N89°41'03"E	34.86	5690.68	12566.10		
34	S88°06'35"E	34.77	5732.01	12566.17		
35	S82°31'38"E	34.99	5769.00	12569.65		
36	S76°36'38"E	35.00	5807.18	12577.19		
37	S70°41'38"E	35.01	5844.38	12588.64		
38	S64°46'37"E	35.00	5880.19	12603.86		
39	S58°17'04"E	35.05	5914.29	12622.74		
40	S52°56'36"E	34.95	5946.15	12644.98		
41	S50°06'16"E	35.02	5981.37	12674.48		
42	S53°59'44"E	35.02	6021.89	12705.65		
43	S57°45'22"E	35.03	6064.11	12733.80		
44	S65°02'28"E	35.00	6142.74	12776.25		

SANITARY SERVICE TABLE						
LOT #	BEARING LENGTH NORTHING EAST					
45	S67°44'34"E	35.10	6179.34	12792.12		
46	S70°35'43"E	35.02	6215.03	12805.44		
47	S74°23'24"E	35.02	6257.87	12818.80		
48	S77°27'28"E	35.02	6301.85	12829.67		
49	N82°45'42"W	35.11	6351.91	12874.16		
50	S84°45'02"E	35.08	6400.77	12844.20		
51	S89°21'45"E	35.00	6452.11	12846.53		
52	N88°32'03"E	35.03	6498.59	12845.61		
53	N84°08'49"E	35.02	6548.82	12841.37		
59	S83°51'37"W	34.98	6522.71	12641.48		
60	S88°50'53"W	34.99	6478.47	12644.87		
61	N87°05'16"W	34.98	6434.71	12644.75		
62	N82°34'01"W	34.97	6390.84	12641.18		
63	N78°02'44"W	34.96	6347.39	12634.15		
64	N73°05'36"W	34.96	6304.38	12623.66		
65	N69°00'34"W	34.94	6262.87	12609.98		
66	N62°37'41"W	34.98	6222.11	12592.89		
67	N61°47'19"W	34.96	6194.87	12579.26		
68	N53°48'23"W	35.00	6132.63	12540.50		
69	N53°01'52"W	35.07	6097.27	12512.89		
70	N53°02'20"W	34.94	6063.49	12482.94		
71	N55°41'21"W	34.92	6024.19	12453.06		
72	N61°49'49"W	34.97	5977.43	12424.66		
73	N68°35'04"W	34.99	5928.66	12401.86		
74	N74°48'14"W	35.00	5877.41	12384.35		
75	N81°01'25"W	35.00	5824.56	12372.49		
76	N88°02'23"W	35.13	5771.22	12366.56		
77	S89°41'03"W	34.84	5726.58	12365.52		
78	S89°41'09"W	35.00	5706.57	12365.84		
79	S89°41'09"W	35.00	5631.58	12366.41		
80	N89°41'08"E	35.00	5599.09	12331.66		
81	S89°41'08"W	35.00	5550.59	12367.04		
151	S66°41'08"E	40.58	6266.97	12530.24		
152A	S78°45'00"E	4.84	6321.88	12587.16		
152B	N90°00'00"E	31.31	6321.88	12555.85		
153A	S79°54'29"E	5.88	6367.35	12596.35		
153B	N89°42'39"E	29.65	6367.20	12566.71		
154	N85°41'44"W	34.97	6418.82	12608.74		
155	N89°56'19"W	34.64	6457.23	12609.88		
156	S84°54'50"W	34.66	6504.38	12607.85		


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TRAILS AT ASPEN RIDGE

FILING NO. 3 **8" SANITARY SEWER PLANS**

SANITARY SERVICE PLAN

OF DESIGNED BY:BASSCALE HORIZ.DATE ISSUED:MARCH 2022DRAWING No.P, INC. .028DRAWN BY:BASHORIZ.1" = 50' VERT.SHEET14 OF 15SS12									
	· ·			DATE ISSUED:	MARCH 2022				
				-		SHEET	14 OF 15	SS12	

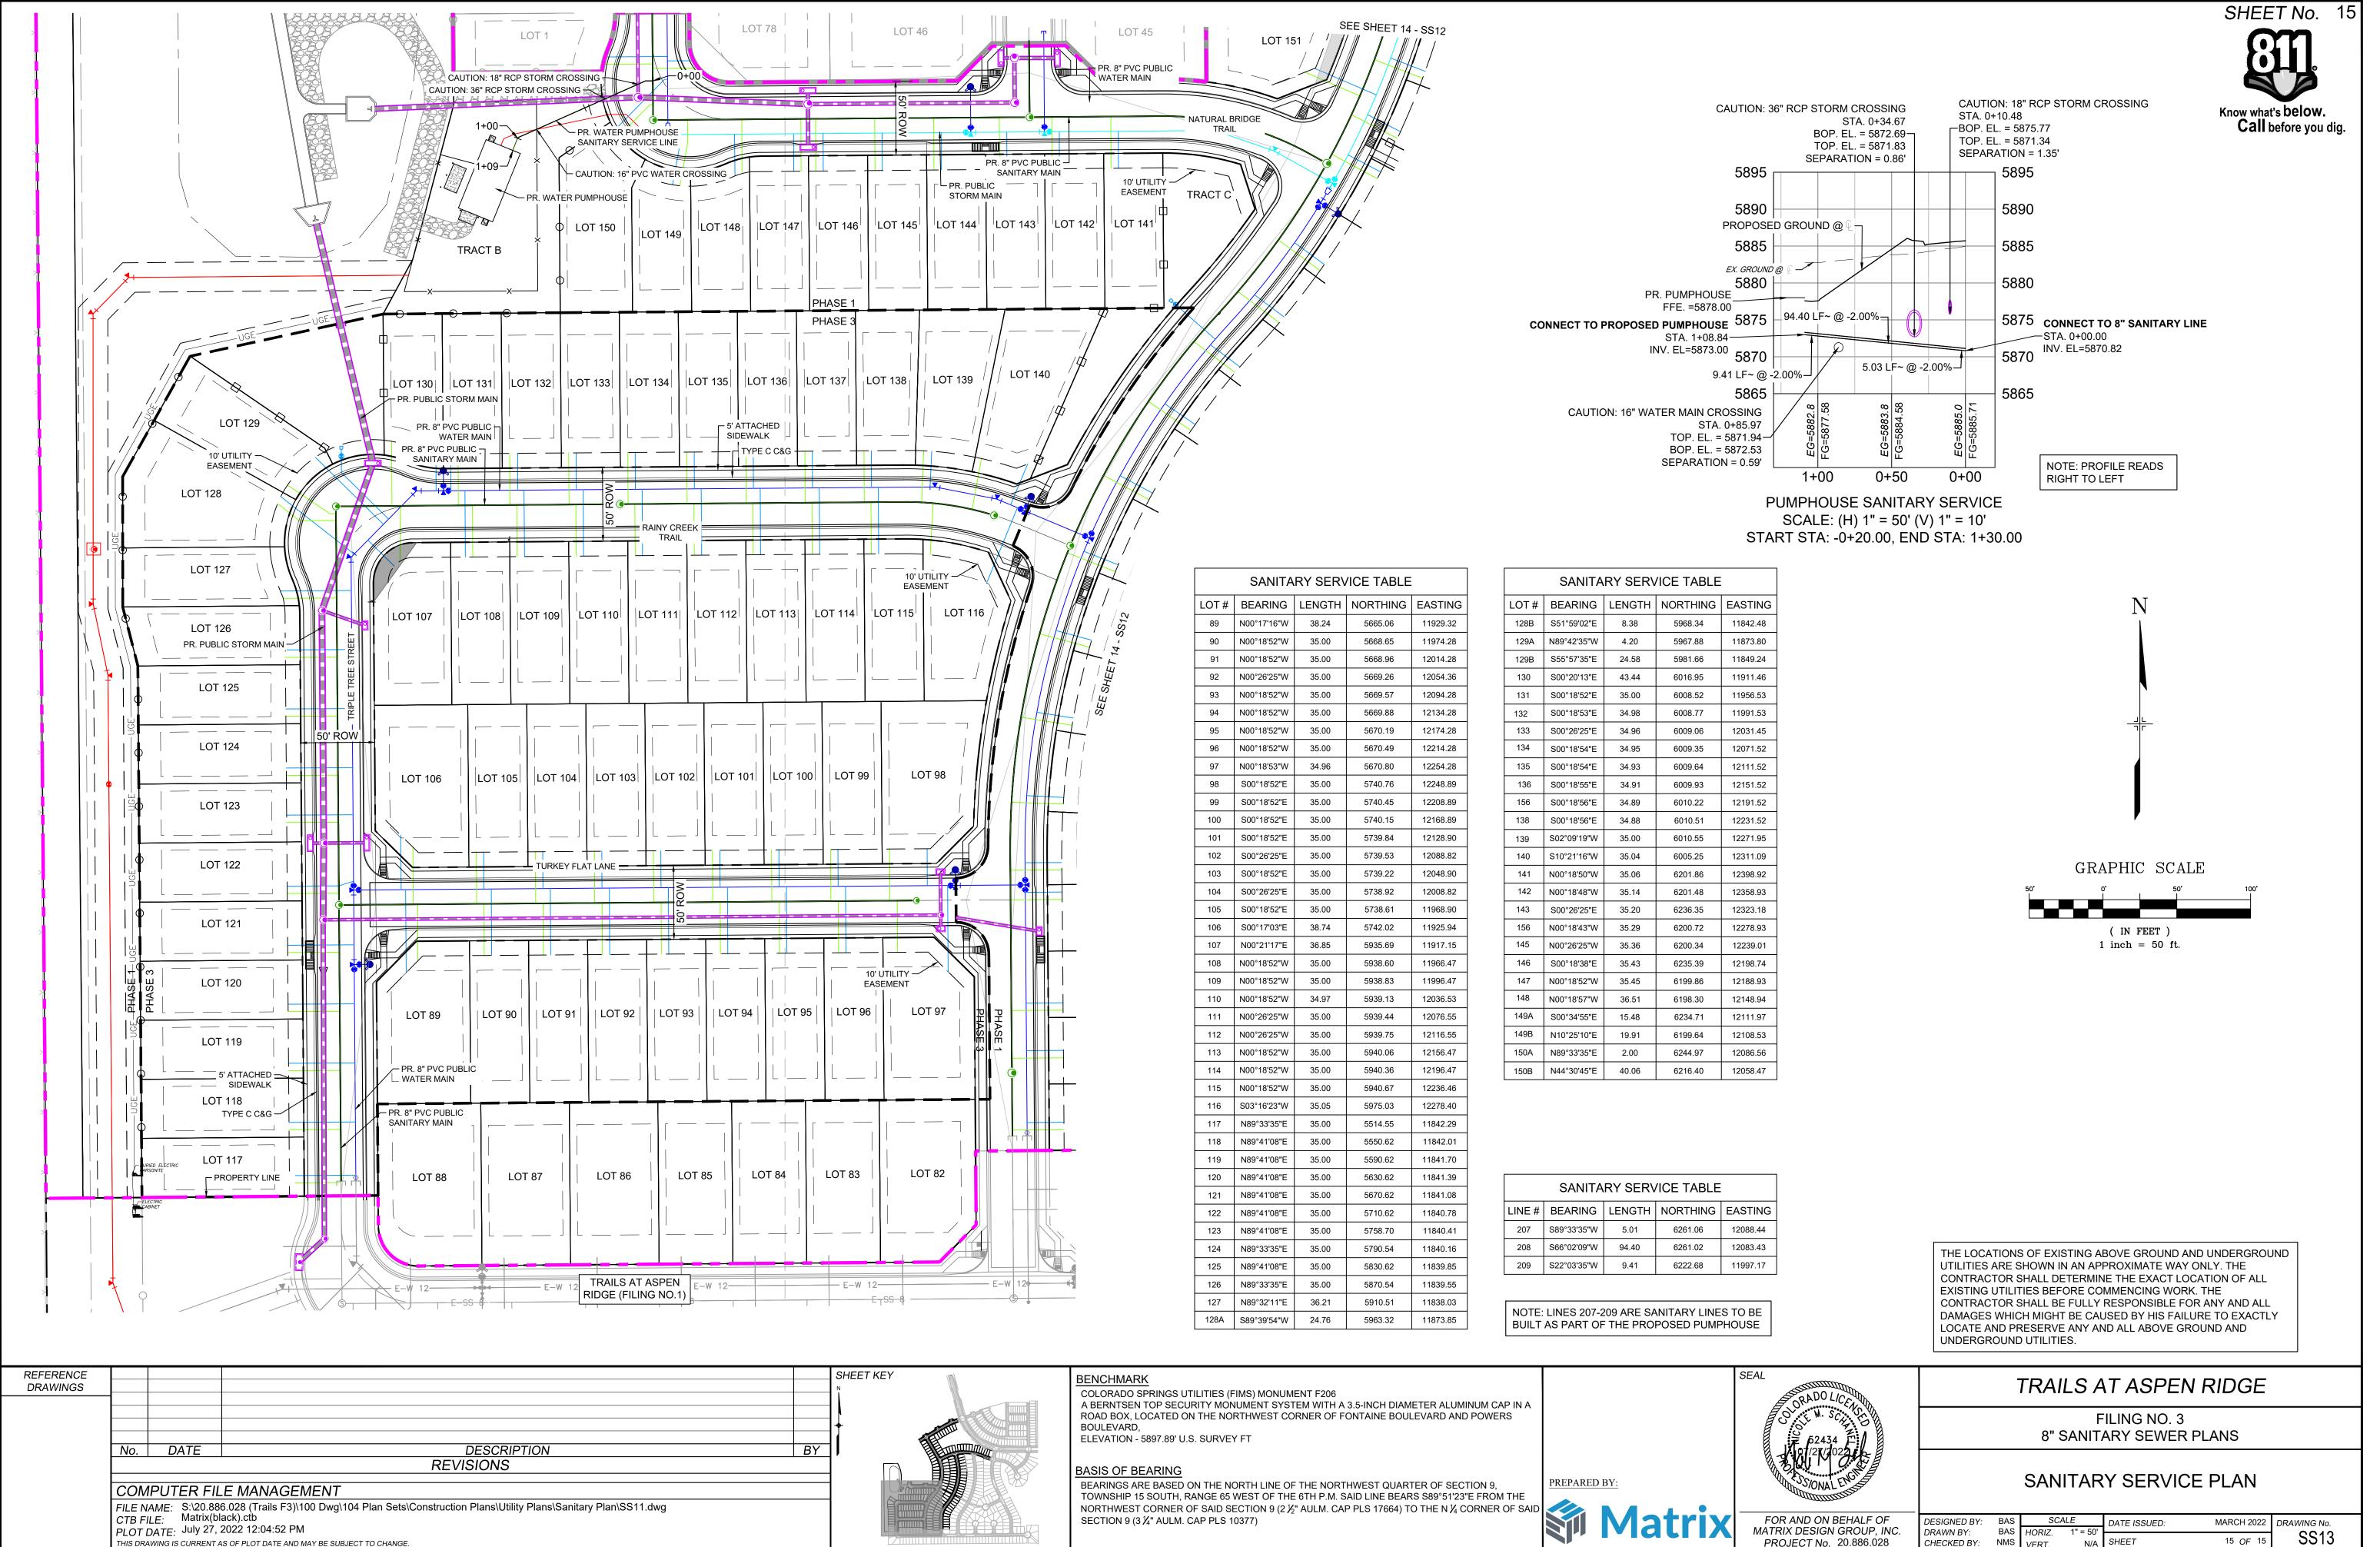

	SE
PREPARED BY:	
Matrix	