



AMERICAN TOWER®

Security-Widefi SITE NAME: REBUILD TURKEY CREEK CO

SITE NUMBER: 211173

SITE ADDRESS: 2945 LITTLE TURKEY

CREEK RD.

COLORADO SPRINGS, CO

80926



LOCATION MAP

DROP AND SWAP CONSTRUCTION DRAWINGS

COMPLIANCE CODE	PROJECT SUMMARY	PROJECT DESCRIPTION	SHEET INDEX				
ALL WORK SHALL BE PERFORMED AND MATERIALS INSTALLED IN ACCORDANCE WITH THE CURRENT EDITIONS OF THE	SITE ADDRESS:	THIS PROJECT ENTAILS THE CONSTRUCTION OF A NEW 69'	SHEET NO:	DESCRIPTION:	REV:	DATE:	BY:
FOLLOWING CODES AS ADOPTED BY THE LOCAL GOVERNMENT AUTHORITIES. NOTHING IN THESE PLANS IS	2945 LITTLE TURKEY CREEK RD COLORADO SPRINGS. CO 80926	TOWER AND THE REMOVAL OF THE EXISTING TOWER ONCE THE NEW TOWER IS FULLY FUNCTIONAL.	G-001	TITLE SHEET	0	04/26/23	AB
TO BE CONSTRUED TO PERMIT WORK NOT CONFORMING TO THESE CODES.	COUNTY: EL PASO		G-002	GENERAL NOTES	0	04/26/23	AB
INTERNATIONAL BUILDING CODE (IBC)	GEOGRAPHIC COORDINATES:	PROJECT NOTES	V-101	AS-BUILT/TITLE & BOUNDARY PLAN			
NATIONAL ELECTRIC CODE (NEC) LOCAL BUILDING CODE	LATITUDE: 38.653606°	4. THE EASH ITY IS INNAANNED	V-102	PARENT PARCEL BOUNDARY PLAN & TITLE			
4. CITY/COUNTY ORDINANCES	LONGITUDE: -104.870844° GROUND ELEVATION: 6707' AMSL	THE FACILITY IS UNMANNED.	V-103	EXISTING CONDITIONS AND TOPOGRAPHIC PLAN			
	PARCEL SIZE: 37.38 ACRES	A TECHNICIAN WILL VISIT THE SITE APPROXIMATELY ONCE A MONTH FOR ROUTINE INSPECTION AND MAINTENANCE.	C-101	OVERALL SITE PLAN	0	04/26/23	AB
		3. FACILITY WILL MEET OR EXCEEDS ALL FAA AND FCC	C-401	COMPOUND PLAN	0	04/26/23	AB
		REGULATORY REQUIREMENTS.	C-402	TOWER ELEVATION	0	04/26/23	AB
		NO SANITARY SEWER, POTABLE WATER OR TRASH DISPOSAL IS REQUIRED.	C-501	CONSTRUCTION DETAILS	0	04/26/23	AB
		5. HANDICAP ACCESS IS NOT REQUIRED.	C-502	SIGNAGE	0	04/26/23	AB
SURVEY INFORMATION	PROJECT TEAM	6. THE FACILITY WILL NOT GENERATE NOISE IN EXCESS OF 50db AT THE PROPERTY LINES.	E-401	GROUNDING LAYOUT	0	04/26/23	AB
TOPOGRAPHY OBTAINED FROM SURVEY BOUNDARY INFORMATION WAS OBTAINED FROM SURVEY	TOWER OWNER:	SOUDAT THE PROPERTY LINES.	E-501	ELECTRICAL DETAILS	0	04/26/23	AB
PLAN DATED 09/19/22 BY ARROW SURVEY GROUP	AMERICAN TOWER CORPORATION 10 PRESIDENTIAL WAY WOBURN, MA 01801						
UTILITY COMPANIES	PROPERTY OWNER:						+
POWER COMPANY: UNKNOWN	RONALD D. BLAIR 8630 PONDEROSA SPRINGS PT. COLORADO SPRINGS. CO 80908						
PHONE: (UNKNOWN)	CULURADU SPRINGS, CU 80908	PROJECT LOCATION DIRECTIONS					
TELEPHONE COMPANY: UNKNOWN PHONE: (UNKNOWN)	ENGINEER:	FROM COLORADO SPRINGS:					
Know what's below. Call before you dig.	ATC TOWER SERVICES 3500 REGENCY PARKWAY SUITE 100 CARY, NC 27518	HEAD SOUTH TOWARD PIKES PEAK AVE. TURN RIGHT AT THE 1ST CROSS STREET ONTO PIKES PEAK AVE. TURN LEFT AT THE 1ST CROSS STREET ONTO S NEVADA AVE. CONTINUE STRAIGHT ONTO CO-115 S/S NEVADA AVE. CONTINUE TO FOLLOW CO-115 S. CONTINUE STRAIGHT TO STAY ON CO-115 S. TURN RIGHT ONTO PSO CORTO. TURN LEFT AT THE 1ST CROSS STREET ONTO CLL CORVO				PCD FILE: NO	

AMERICAN TOWER® ATC TOWER SERVICES, LLC

3500 REGENCY PARKWAY SUITE 100 CARY, NC 27518 PHONE: (919) 468-0112

THESE DRAWINGS AND/OR THE ACCOMPANYING SPECIFICATION AS INSTRUMENTS OR SERVICE ARE THE EXCLUSIVE PROPERTY OF AMERICAN TOWER. THEIR USE AND PUBLICATION SHALL BE RESTRICTED TO THE ORIGINAL SITE FOR WHICH THEY ARE PREPARED. ANY USE OR DISCLOSURE OTHER THAN THAT WHICH RELATES TO AMERICAN TOWER OR THE SPECIFIED CARRIER IS STRICTLY PROHIBITED. ITILE TO THESE DOCUMENTS SHALL REMAIN THE PROPERTY OF AMERICAN TOWER WHETHER OR NOT THE PROPICED IS EXECUTED. NEITHER THE ARCHITECT NOR THE ENGINEER WILL BE PROVIDING ON-SITE CONSTRUCTION REVIEW OF THIS PROJECT. CONTRACTOR'S) MUST VERIEY ALL DIMENSIONS AND ADVISE AMERICAN TOWER OF ANY DISCREPANCIES. ANY PRIOR ISSUANCE OF THIS DRAWING IS SUPERSEDED BY THE LATEST VERSION ON FILE WITH AMERICAN TOWER.

REV.	DESCRIPTION	BY	DATE
\triangle _	FOR CONSTRUCTION	<u>AB</u> _	04/26/23
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ATC SITE NUMBER:

211173

ATC SITE NAME:

REBUILD TURKEY CREEK CO

SITE ADDRESS: 2945 LITTLE TURKEY CREEK RD COLORADO SPRINGS. CO 80926

SEAL



Approved
By: Justin Kityese
Planning Manager
Date:05/16/2023
El Paso County Planning & Community Develop

	DATE DRAWN:	04/26/23
	ATC JOB NO:	14141546_D4
	OPS JOB NO:	13734361
l	ATC LEGACY #:	419522

TITLE SHEET

SHEET NUMBER:

G-001

GENERAL CONSTRUCTION NOTES:

- ALL WORK SHALL CONFORM TO ALL CURRENT APPLICABLE FEDERAL, STATE, AND LOCAL CODES, INCLUDING ANSI/EIA/TIA-222, AND COMPLY WITH ATC CONSTRUCTION SPECIFICATIONS FOR WIRELESS TOWER SITES.
- CONTRACTOR SHALL CONTACT LOCAL 811 FOR IDENTIFICATION OF UNDERGROUND UTILITIES PRIOR TO START OF CONSTRUCTION
- CONTRACTOR IS RESPONSIBLE FOR COORDINATING ALL REQUIRED INSPECTIONS.
- ALL DIMENSIONS TO OF AND ON EXISTING BUILDINGS, DRAINAGE STRUCTURES, AND SITE IMPROVEMENTS SHALL BE VERIFIED IN FIELD BY CONTRACTOR WITH ALL DISCREPANCIES REPORTED TO THE ENGINEER.
- DO NOT CHANGE SIZE OR SPACING OF STRUCTURAL ELEMENTS.
- DETAILS SHOWN ARE TYPICAL; SIMILAR DETAILS APPLY TO SIMILAR CONDITIONS UNLESS
- THESE DRAWINGS DO NOT INCLUDE NECESSARY COMPONENTS FOR CONSTRUCTION SAFETY WHICH IS THE SOLE RESPONSIBILITY OF THE CONTRACTOR.
- CONTRACTOR SHALL BRACE STRUCTURES UNTIL ALL STRUCTURAL ELEMENTS NEEDED FOR STABILITY ARE INSTALLED. THESE ELEMENTS ARE AS FOLLOWS: LATERAL BRACING, ANCHOR
- CONTRACTOR SHALL DETERMINE EXACT LOCATION OF EXISTING UTILITIES, GROUNDS DRAINS DRAIN PIPES, VENTS, ETC. BEFORE COMMENCING WORK.
- INCORRECTLY FARRICATED, DAMAGED, OR OTHERWISE MISEITTING OR NONCONFORMING MATERIALS OR CONDITIONS SHALL BE REPORTED TO THE ATC CM PRIOR TO REMEDIAL OR CORRECTIVE ACTION, ANY SUCH REMEDIAL ACTION SHALL REQUIRE WRITTEN APPROVAL BY THE ATC CM PRIOR TO PROCEEDING.
- EACH CONTRACTOR SHALL COOPERATE WITH THE ATC CM, AND COORDINATE HIS WORK WITH THE WORK OF OTHERS
- CONTRACTOR SHALL REPAIR ANY DAMAGE CAUSED BY CONSTRUCTION OF THIS PROJECT TO MATCH EXISTING PRE-CONSTRUCTION CONDITIONS TO THE SATISFACTION OF THE ATC CONSTRUCTION MANAGER
- ALL CABLE/CONDUIT ENTRY/EXIT PORTS SHALL BE WEATHERPROOFED DURING INSTALLATION USING A SILICONE SEALANT.
- WHERE EXISTING CONDITIONS DO NOT MATCH THOSE SHOWN IN THIS PLAN SET, CONTRACTOR WILL NOTIFY THE ATC CONSTRUCTION MANAGER IMMEDIATELY.
- CONTRACTOR SHALL ENSURE ALL SUBCONTRACTORS ARE PROVIDED WITH A COMPLETE AND CURRENT SET OF DRAWINGS AND SPECIFICATIONS FOR THIS PROJECT.
- ALL ROOF WORK SHALL BE DONE BY A QUALIFIED AND EXPERIENCED ROOFING CONTRACTOR IN COORDINATION WITH ANY CONTRACTOR WARRANTING THE ROOF TO ENSURE THAT THE WARRANTY IS MAINTAINED.
- CONTRACTOR SHALL REMOVE ALL RUBBISH AND DEBRIS FROM THE SITE AT THE END OF EACH
- CONTRACTOR SHALL COORDINATE WORK SCHEDULE WITH LANDLORD AND TAKE PRECAUTIONS TO MINIMIZE IMPACT AND DISRUPTION OF OTHER OCCUPANTS OF THE FACILITY
- CONTRACTOR SHALL FURNISH ATC WITH THREE AS-BUILT SETS OF DRAWINGS UPON COMPLETION OF WORK
- PRIOR TO SUBMISSION OF BID, CONTRACTOR SHALL COORDINATE WITH ATC CM TO DETERMINE WHAT, IF ANY, ITEMS WILL BE PROVIDED. ALL ITEMS NOT PROVIDED SHALL BE PROVIDED AND INSTALLED BY THE CONTRACTOR. CONTRACTOR WILL INSTALL ALL ITEMS PROVIDED.
- PRIOR TO SUBMISSION OF BID, CONTRACTOR WILL COORDINATE WITH ATC CONSTRUCTION MANAGER TO DETERMINE IF ANY PERMITS WILL BE OBTAINED BY ATC. ALL REQUIRED PERMITS NOT OBTAINED BY ATC MUST BE OBTAINED, AND PAID FOR, BY THE CONTRACTOR.
- CONTRACTOR SHALL SUBMIT ALL SHOP DRAWINGS TO ATC FOR REVIEW AND APPROVAL PRIOR
- ALL EQUIPMENT SHALL BE INSTALLED ACCORDING TO MANUFACTURER'S SPECIFICATIONS AND LOCATED ACCORDING TO ATC SPECIFICATIONS, AND AS SHOWN IN THESE PLANS.
- THE CONTRACTOR SHALL SUPERVISE AND DIRECT THE PROJECT DESCRIBED HEREIN. THE CONTRACTOR SHALL BE SOLELY RESPONSIBLE FOR ALL THE CONSTRUCTION MEANS, METHODS, TECHNIQUES, SEQUENCES AND PROCEDURES AND FOR COORDINATING ALL PORTIONS OF THE WORK UNDER THE CONTRACT
- CONTRACTOR SHALL NOTIFY ATC CM A MINIMUM OF 48 HOURS IN ADVANCE OF POURING CONCRETE OR BACKFILLING ANY UNDERGROUND UTILITIES, FOUNDATIONS OR SEALING ANY WALL, FLOOR OR ROOF PENETRATIONS FOR ENGINEERING REVIEW AND APPROVAL

EROSION AND SEDIMENTATION CONTROL PLAN NOTES:

THIS PLAN HAS BEEN DEVELOPED TO PROVIDE A STRATEGY FOR CONTROLLING SOIL EROSION AND SEDIMENTATION DURING AND AFTER CONSTRUCTION OF THE PROPOSED FACILITY. THE EQUIPMENT ANTICIPATED TO BE USED FOR THE CONSTRUCTION INCLUDES THE FOLLOWING: BACKHOES, BUILDOZERS LOADERS TRUCKS CRANES COMPACTORS AND GRADERS THE FOLLOWING MEASURES WILL BE UNDERTAKEN TO PROVIDE MAXIMUM PROTECTION TO THE SOIL, WATER, AND ABUTTING LANDS:

- ALL EARTH DISTURBANCE ACTIVITIES SHALL PROCEED IN ACCORDANCE WITH THE SEQUENCE PROVIDED ON THE PLAN DRAWINGS. DEVIATION FROM THAT SEQUENCE MUST BE APPROVED IN WRITING FROM AMERICAN TOWER PRIOR TO IMPLEMENTATION.
- THE LIMITS OF DISTURBANCE (LOD) SHOULD BE MARKED PRIOR TO DISTURBANCE ACTIVITIES (I.E. SURVEY STAKES, POSTS & ROPE, CONSTRUCTION FENCE, ETC.).
- A COPY OF THE SEDIMENT AND EROSION CONTROL PLAN MUST BE AVAILABLE AT THE PROJECT SITE DURING CONSTRUCTION UNTIL THE SITE IS STABILIZED. (AS APPLICABLE)
- PRIOR TO GRUBBING OR ANY FARTHMOVING OPERATION SILTATION FENCE WILL BE INSTALLED ACROSS THE SLOPE ON THE CONTOUR AT THE DOWNHILL LIMIT OF THE WORK AS PROTECTION AGAINST CONSTRUCTION RELATED EROSION. (CONSULT ATC CM AS REQUIRED)
- STONE CHECK DAMS WILL BE INSTALLED IN THE DRAINAGE DITCHES TO PREVENT EROSION PRIOR TO THE STABILIZATION OF THE CHANNELS, EROSION CONTROL BLANKETS WILL ALSO BE INSTALLED IN ALL DITCHES TO BE REVEGETATED.
- PERMANENT SOIL EROSION CONTROL MEASURES FOR ALL SLOPES, CHANNELS, DITCHES, OR ANY UNDISTURBED LAND AREA WILL BE COMPLETED WITHIN FIFTEEN CALENDAR DAYS AFTER FINAL GRADING HAS BEEN COMPLETED. WHEN IT IS NOT POSSIBLE OR PRACTICAL TO PERMANENTLY STABILIZE DISTURBED LAND, TEMPORARY EROSION CONTROL MEASURES WILL BE IMPLEMENTED WITHIN THIRTY CALENDAR DAYS OF EXPOSURE OF SOIL. ALL DISTURBED AREAS WILL BE MULCHED FOR EROSION CONTROL UPON COMPLETION OF ROUGH GRADING. CUT SLOPES IN COMPETENT BEDROCK AND ROCK FILLS NEED NOT BE VEGETATED.
- ANY EXPOSED SLOPES GREATER THAN 2:1 AND NEWLY CONSTRUCTED DRAINAGE DITCHES WILL

- BE STABILIZED WITH EROSION CONTROL BLANKET TO PREVENT EROSION DURING CONSTRUCTION AND TO FACILITATE REVEGETATION AFTER LOAMING AND SEEDING.
- TO PROVIDE PROTECTION AGAINST EROSION, RIPRAP WILL BE PLACED AT ALL CULVERT INLETS AND OUTLETS AS SHOWN ON THE ATTACHED DRAWINGS.
- IN AREAS OF CONSTRUCTION DEWATERING, ISOLATED SETTLEMENT TRAPS WILL BE CONSTRUCTED ADJACENT TO THE ACTIVITY, WATER WILL BE PUMPED FROM THE EXCAVATIONS TO THESE DEPRESSION AREAS FOR SEDIMENT REMOVAL. ADDITIONAL SEDIMENTATION PROTECTION WILL BE PROVIDED BY THE INSTALLATION OF HAYBALE BARRIERS BETWEEN THE BASINS AND THE RECEIVING DRAINAGE COARSE.
- NATIVE TOPSOIL SHALL BE SAVED, STOCKPILED, MULCHED, AND REUSED AS MUCH AS POSSIBLE ON THE SITE. SILTATION FENCE SHALL BE INSTALLED AT THE BASE OF STOCKPILES AT THE DOWNHILL LIMIT TO PROTECT AGAINST EROSION. STOCKPILES WILL BE STABILIZED BY SEEDING AND MULCHING UPON FORMATION OF THE PILES, UPHILL OF THE STOCKPILES, STABILIZED DITCHES AND/OR BERMS WILL BE CONSTRUCTED TO DIVERT STORMWATER RUNOFF AWAY FROM THE PILES
- FINAL SEEDING WILL BE APPLIED IN ACCORDANCE WITH THE AMERICAN TOWER CORPORATION CONSTRUCTION SPECIFICATION.
- SHOULD CONSTRUCTION OCCUR AFTER NOVEMBER 15, ADDITIONAL EROSION CONTROL METHODS WILL BE IMPLEMENTED. ALL DISTURBED AREAS WILL BE MINIMIZED AS MUCH AS POSSIBLE PRIOR TO FREEZING ADDITIONAL FROSION CONTROL DEVICES WILL BE INSTALLED AS APPROPRIATE INSPECTION OF THESE EROSION CONTROL ITEMS WILL BE CONSTANT, WITH PARTICULAR ATTENTION PAID TO WEATHER PREDICTIONS TO ENSURE THAT THESE MEASURES ARE PROPERLY IN PLACE TO HANDLE LARGE AMOUNTS OF RUNOFF FROM HEAVY RAINS OR
- FOR AN EARTH DISTURBANCE ACTIVITY OR ANY STAGE OR PHASE OF AN ACTIVITY TO BE CONSIDERED PERMANENTLY STABILIZED. THE DISTURBED AREAS SHALL BE COVERED BY A MINIMUM UNIFORM 70% PERENNIAL VEGETATIVE COVER OR OTHER PERMANENT NON-VEGETATIVE COVER WITH A DENSITY SUFFICIENT TO RESIST ACCELERATED EROSION AND SUBSURFACE CHARACTERISTICS SUFFICIENT TO RESIST SLIDING AND OTHER MOVEMENTS
- THE CONTRACTOR WILL REGULARLY INSPECT THE PROJECT'S EROSION AND SEDIMENTATION CONTROLS DURING THE ENTIRE ACTIVE CONSTRUCTION STAGES. THE INSPECTIONS WILL BE PERFORMED WEEKLY AND AFTER ALL RUNOFF EVENTS. THE CONTRACTOR WILL BE RESPONSIBLE FOR THE INSTALLATION, OPERATION, MAINTENANCE, AND REMOVAL OF ALL EROSION AND SEDIMENTATION CONTROLS. ALL PREVENTATIVE AND REMEDIAL MAINTENANCE WORK, INCLUDING CLEAN OUT REPAIR, REPLACEMENT, REGRADING, RESEEDING, REMULCHING AND RENETTING MUST BE PERFORMED IMMEDIATELY. SEDIMENT THAT HAS BEEN TRAPPED BY THE SILT BARRIER WILL BE REMOVED AS REQUIRED, AND IN ALL CASES, BEFORE THE ACCUMULATION HAS REACHED HALF THE HEIGHT OF THE FENCE. THE SILT BARRIER WILL BE RE-ANCHORED, REPAIRED, OR REPLACED AS NECESSARY. ALL OTHER CONTROLS WILL BE INSPECTED ON THE SAME SCHEDULE. IF EROSION AND SEDIMENT CONTROL BMP'S FAIL TO PERFORM AS EXPECTED, REPLACEMENT BMP'S, OR MODIFICATION OF THOSE INSTALLED WILL
- ALL FILLS SHALL BE COMPACTED AS REQUIRED TO REDUCE EROSION, SLIPPAGE, SETTLEMENT, SUBSIDENCE OR OTHER RELATED PROBLEMS. FILL INTENDED TO SUPPORT BUILDINGS, STRUCTURES AND CONDUITS, ETC. SHALL BE COMPACTED IN ACCORDANCE WITH LOCAL REQUIREMENTS OR CODES.
- ALL EARTHEN FILLS SHALL BE PLACED IN COMPACTED LAYERS NOT TO EXCEED 9 INCHES IN THICKNESS.
- FILL MATERIALS SHALL BE FREE OF FROZEN PARTICLES, BRUSH, ROOTS, SOD, OR OTHER FOREIGN OR OBJECTIONABLE MATERIALS THAT WOULD INTERFERE WITH OR PREVENT CONSTRUCTION OF SATISFACTORY FILLS. FILL SHALL NOT BE PLACED ON SATURATED OR
- SEEPS OR SPRINGS ENCOUNTERED DURING CONSTRUCTION SHALL BE HANDLED IN ACCORDANCE WITH THE AMERICAN TOWER CORPORATION CONSTRUCTION SPECIFICATION AND/OR THE CONTRACTOR SHALL NOTIFY THE ATC CONSTRUCTION MANAGER.
- SEDIMENT TRACKED ONTO ANY PUBLIC ROADWAY OR SIDEWALK SHALL BE RETURNED TO THE CONSTRUCTION SITE BY THE END OF EACH WORK DAY AND DISPOSED IN THE MANNER DESCRIBED IN THIS PLAN. IN NO CASE SHALL THE SEDIMENT BE WASHED, SHOVELED, OR SWEPT INTO ANY ROADSIDE DITCH, STORM SEWER, OR SURFACE WATER.

CONSTRUCTION SEQUENCE:

- CONSTRUCT PROPOSED TOWER PER TOWER MANUFACTURER'S SPECIFICATIONS.
- INSTALL ANY REQUIRED ICE BRIDGES PER ATC SPECIFICATIONS.
- DECONSTRUCT EXISTING TOWER ONLY ONCE THE PROPOSED TOWER IS ERECTED AND IN FULL WORKING CONDITION.
- IF CONSTRUCTION IS TERMINATED OR SUSPENDED PRIOR TO CONSTRUCTION COMPLETION, ALL EXPOSED SOIL AREAS SHALL BE SEEDED WITH TEMPORARY SEEDING AND MULCHED IMMEDIATELY

CONCRETE AND REINFORCING STEEL NOTES:

- DESIGN AND CONSTRUCTION OF ALL CONCRETE FLEMENTS SHALL CONFORM TO THE LATEST EDITIONS OF ALL APPLICABLE CODES INCLUDING: ACI 301 "SPECIFICATIONS FOR STRUCTURAL CONCRETE FOR BUILDINGS", AND ACI 318 "BUILDING CODE REQUIREMENTS FOR REINFORCED
- MIX DESIGN SHALL BE APPROVED BY OWNER'S REPRESENTATIVE AND SUBMITTED TO ENGINEER PRIOR TO PLACING CONCRETE.
- CONCRETE SHALL BE NORMAL WEIGHT. 6 % AIR ENTRAINED (+/- 1.5%) WITH A MAXIMUM 4" SLUMP AND HAVE A MINIMUM 28-DAY COMPRESSIVE STRENGTH OF 4500 PSI UNLESS OTHERWISE
- THE FOLLOWING MATERIALS SHALL BE USED:

PORTLAND CEMENT: ASTM C-150, TYPE 1 OR 2

REINFORCEMENT: ASTM A-185, PLAIN STEEL WELDED WIRE FABRIC

REINFORCEMENT BARS ASTM A615, GRADE 60, DEFORMED

NORMAL WEIGHT AGGREGATE: ASTM C-33 WATER DRINKABI F

NON-CHLORIDE CONTAINING ADMIXTURES

MINIMUM CONCRETE COVER FOR REINFORCING STEEL SHALL BE AS FOLLOWS (UNLESS OTHERWISE NOTED):

- A. CONCRETE CAST AGAINST EARTH: 3"
- B. ALL OTHER CONCRETE: 2"
- A 3/4" CHAMFER SHALL BE PROVIDED AT ALL EXPOSED EDGES OF CONCRETE IN ACCORDANCE WITH ACI 301 SECTION 4.2.4. UNLESS NOTED OTHERWISE.
- INSTALLATION OF CONCRETE EXPANSION/WEDGE ANCHOR SHALL BE PER MANUFACTURER'S WRITTEN RECOMMENDED PROCEDURE. THE ANCHOR BOLT, DOWEL, OR ROD SHALL CONFORM TO MANUFACTURER'S RECOMMENDATION FOR EMBEDMENT DEPTH OR AS SHOWN ON THE DRAWINGS. NO REBAR SHALL BE CUT WITHOUT PRIOR ATC CM APPROVAL WHEN DRILLING HOLES IN CONCRETE.
- ADMIXTURES SHALL CONFORM TO THE APPROPRIATE ASTM STANDARD AS REFERENCED IN ACI
- DO NOT WELD OR TACK WELD REINFORCING STEEL
- ALL DOWELS, ANCHOR BOLTS, EMBEDDED STEEL, ELECTRICAL CONDUITS, PIPE SLEEVES GROUNDS AND ALL OTHER EMBEDDED ITEMS AND FORMED DETAILS SHALL BE IN PLACE BEFORE START OF CONCRETE PLACEMENT.
- REINFORCEMENT SHALL BE COLD BENT WHENEVER BENDING IS REQUIRED
- DO NOT PLACE CONCRETE IN WATER, ICE, OR ON FROZEN GROUND.
- DO NOT ALLOW REINFORCEMENT, CONCRETE OR SUBBASE TO FREEZE DURING CONCRETE CURING AND SETTING PERIOD, OR FOR A MINIMUM OF 3 DAYS AFTER PLACEMENT.
- FOR COLD-WEATHER AND HOT-WEATHER CONCRETE PLACEMENT, CONFORM TO APPLICABLE ACI CODES AND RECOMMENDATIONS. IN EITHER CASE, MATERIAL'S CONTAINING CHLORIDE, CALCIUM, SALTS, ETC. SHALL NOT BE USED. PROTECT FRESH CONCRETE FROM WEATHER FOR 7 DAYS, MINIMUM.
- CONCRETE SHALL BE RUBBED TO A ROUGH GROUT FINISH. PADS SHALL BE SEALED BY STEEL TROWEL
- UNLESS OTHERWISE NOTED:
 - A. ALL REINFORCING STEEL SHALL BE DEFORMED BARS CONFORMING TO ASTM A615, GRADE 60.
 - B. WELDED WIRE FABRIC SHALL CONFORM TO ASTM A185.
- SPLICING OF REINFORCEMENT IS PERMITTED ONLY AT LOCATIONS SHOWN IN THE CONTRACT DRAWINGS OR AS ACCEPTED BY THE ENGINEER. UNLESS OTHERWISE SHOWN OR NOTED REINFORCING STEEL SHALL BE SPLICED TO DEVELOP ITS FULL TENSILE CAPACITY (CLASS A) IN ACCORDANCE WITH ACI 318.
- REINFORCING BAR DEVELOPMENT LENGTHS. AS COMPUTED IN ACCORDANCE WITH ACI 318. FORM THE BASIS FOR BAR EMBEDMENT LENGTHS AND BAR SPLICED LENGTHS SHOWN IN THE DRAWINGS. APPLY APPROPRIATE MODIFICATION FACTORS FOR TOP STEEL. BAR SPACING. COVER AND THE LIKE.
- DETAILING OF REINFORCING STEEL SHALL CONFORM TO "ACI MANUAL OF STANDARD PRACTICE FOR DETAILING REINFORCED CONCRETE STRUCTURES" (ACI 315).
- ALL SLAB CONSTRUCTION SHALL BE CAST MONOLITHICALLY WITHOUT HORIZONTAL CONSTRUCTION JOINTS, UNLESS SHOWN IN THE CONTRACT DRAWINGS.
- LOCATION OF ALL CONSTRUCTION JOINTS ARE SUBJECT TO THE REQUIREMENTS OF THE CONTRACT DOCUMENTS, CONFORMANCE WITH ACI 318, AND ACCEPTANCE OF THE ENGINEER. DRAWINGS SHOWING LOCATION OF DETAILS OF THE PROPOSED CONSTRUCTION JOINTS SHALL BE SUBMITTED WITH REINFORCING STEEL PLACEMENT DRAWINGS
- SPLICES OF WWF, AT ALL SPLICED EDGES, SHALL BE SUCH THAT THE OVERLAP MEASURED BETWEEN OUTERMOST CROSS WIRES OF EACH FABRIC SHEET IS NOT LESS THAN THE SPACING OF THE CROSS WIRE PLUS 2 INCHES, NOR LESS THAN 8".
- BAR SUPPORTS SHALL BE ALL-GALVINIZED METAL WITH PLASTIC TIPS.
- ALL REINFORCEMENT SHALL BE SECURELY TIED IN PLACE TO PREVENT DISPLACEMENT BY CONSTRUCTION TRAFFIC OR CONCRETE. TIE WIRE SHALL BE 16 GAUGE CONFORMING TO ASTM
- SLAB ON GROUND
 - A. COMPACT STRUCTURAL FILL TO 95% DENSITY AND THEN PLACE 6" GRAVEL BENEATH
 - B. PROVIDE VAPOR BARRIER BENEATH SLAB ON GROUND

GENERAL FOUNDATION NOTES:

(APPLICABLE FOR EQUIPMENT SHELTER ONLY)

- THOROUGHLY COMPACT BOTTOM OF EXCAVATIONS PRIOR TO PLACING RIGID INSULATION BARRIER. BACKFILL AND COMPACTION PROCEDURES SHALL BE DONE PER INDUSTRY
- ALL REINFORCING STEEL SHALL BE ASTM A615 GRADE 60. SECURE REINFORCING IN PLACE TO PREVENT MOVEMENT DURING CONCRETE PLACEMENT.
- VERIFY DETAILS AND DIMENSIONS WITH SHELTER DRAWINGS. NOTIFY ATC CM OF ANY DISCREPANCIES
- INSULATION BARRIER PROVIDED IS FOR FROST PROTECTION IN LIEU OF STANDARD FOUNDATIONS WITH BEARING AT CODE REQUIRED FROST DEPTH.
- SHELTER MUST BE ANCHORED TO ITS FOUNDATION. ANCHOR IN ACCORDANCE WITH SHELTER MANUFACTURER SPECIFICATIONS.



3500 REGENCY PARKWAY

SUITE 100

CARY, NC 27518

PHONE: (919) 468-0112

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SPECIFICATION AS INSTRUMENTS OR SERVICE ARE THE
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OTHER THAN THAT WHICH RELATES TO AMERICAN TOWER OR
THE STRETCHE CAMPILED IS STRICT A DROBUISTED. THE TO THE SPECIFIED CARRIER IS STRICTLY PROHIBITED. TITLE TO THESE DOCUMENTS SHALL REMAIN THE PROPERTY OF AMERICAN TOWER WHETHER OR NOT THE PROJECT IS EXECUTED. NEITHER THE ARCHITECT NOR THE ENGINEER WIL BE PROVIDING ON-SITE CONSTRUCTION REVIEW OF THIS PROJECT. CONTRACTOR(S) MUST VERIFY ALL DIMENSIONS AND
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ATC SITE NUMBER:

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ATC SITE NAME:

REBUILD TURKEY CREEK CO

SITE ADDRESS: 2945 LITTLE TURKEY CREEK RD COLORADO SPRINGS, CO 80926



DATE DRAWN: | 04/26/23 14141546 D4 ATC JOB NO: OPS JOB NO: 13734361 ATC LEGACY #: 419522

GENERAL NOTES

SHEET NUMBER

G-002

PROJECT SUMMARY SURVEYOR'S NOTES FIELD SURVEY DATE: 09/08/2022 SITE ADDRESS: 2945 LITTLE TURKEY CREEK ROAD COLORADO SPRINGS, COLORADO 80926-96 THERE IS ACCESS TO THE ATC LEASE AREA VIA THE ACCESS & UTILITY EASEMENT FROM LITTLE TURKEY CREEK ROAD, A PUBLIC RIGHT OF WAY (SEE NOTE FOLLOWING ACCESS & UTILITY EASEMENT AS SURVEYED LEC-2 Certific PARENT PARCEL INFORMATION OWNER: RONALD D. BLAIR 2. THE LOCATIONS OF ALL UTILITIES SHOWN ON THE SURVEY ARE FROM VISIBLE SURFACE EVIDENCE ONLY. OWNER ADDRESS: 8630 PONDEROSA SPRINGS PT COLORADO SPRINGS, COLORADO 80908 VIOLED SURFACE EVIDENCE ONLY. AT THE TIME OF THIS SURVEY THERE WAS NO OBSERVABLE SURFACE EVIDENCE OF EARTH MOVING WORK, BUILDING CONSTRUCTION OR BUILDING ADDITIONS WITHIN RECENT MONTHS. APN: 7615000004 (SCHEDULE NO.) RECORDED AS RECEPTION NO. 215070998 TOTAL AREAS: PARENT PARCEL: 37.351± ACRES (CALCULATED IN CAD) AT THE TIME OF THIS SURVEY, THERE WAS NO OBSERVABLE EVIDENCE OF THE SUBJECT PROPERTY BEING USED AS A SOLID WASTE DUMP, SUMP OR FANSAI FARVEL: 37.3913 ACRES (CALCULATED IN CAU) ATC LEASE AREA AS PROVIDED: 3,600.00 SQ FT OR 0.083± ACRES ATC LEASE AREA AS SURVEYED: 3,597.62 SQ FT OR 0.083± ACRES ACCESS & UTILITY EASEMENT AS PROVIDED: (UNDETERMINED DUE TO SANITARY LANDFILL SITE LOCATION > SANITARY LANDRILL. AT THE TIME OF THIS SURVEY, THERE WAS NO OBSERVABLE EVIDENCE OF ANY RECENT CHANGES IN STREET RIGHT-OF-WAY LINES EITHER COMPLETED OR PROPOSED, AND AVAILABLE FROM THE CONTROLLING SEL NEL SWL ILLEGIBLE DESCRIPTION) ACCESS & UTILITY EASEMENT AS SURVEYED: 9,015.34 SQ FT OR 0.207± ACRES UTILITY EASEMENT AS PROVIDED: (UNDETERMINED DUE TO ILLEGIBLE ACCESS ROAD JUNISDICTION. A T'HE TIME OF THIS SURVEY, THERE WAS NO OBSERVABLE EVIDENCE OF ANY RECENT STREET OR SIDEWALK CONSTRUCTION OR REPAIRS. THIS AS-BUILT SURVEY OF AN EXISTING LEASE AREA WITHIN AN EXISTING PARCEL OF LAND WAS PREPARED TO SHOW THE INTERESTS OF AMERICAN TOWER CORPORATION AND IMPROVEMENTS PROXIMAL TO SAD INTERESTS. IT DOES NOT CONSTITUTE AN AS-BUILT SURVEY OF THE ENTIRE PARENT PARCEL. DESCRIPTION) UTILITY EASEMENT AS SURVEYED: 1,195.37 SQ FT OR 0.027± ACRES UTILITY EASEMENT AS SUIVELLESS TO TOWER: GEOGRAPHIC COORDINATES OF EXISTING TOWER: LATITUDE: 38°39'13.2" N LONGITUDE: 104°52'14.9" W HORIZONTAL DATUM: NADB3 DEAN, SCHED VERTICAL DATUM: NAVD 1988 GROUND ELEVATION: 6717.3' GEOGRAPHIC COORDINATES OF PROPOSED TOWER: LATITUDE: 38°39'13.0" N LONGITUDE: 104°52'15.0" W ALL CALLS ARE MEASURED UNLESS OTHERWISE NOTED . UNLESS OTHERWISE SPECIFIED, UTILITY POLES DID NOT IDENTIFY RMBC GROUP LLC SCHED #7615000006 OWINENSHIP. OUTLIN'S ASSEMENT (AND ACCESS & UTILITY EASEMENT) AS SURVEYED DESCRIPTIONS ARE BASED ONLY ON SURFACE EVIDENCE OF EXISTING UTILITIES SERVICING THE TOWER SITE. DESCRIBED EASEMENTS MAY NOT INCLIDE ALL UNDERGOUND UTILITIES NOT VISIBLE ATTIME OF SURVEY AND UTILITIES SHOULD BE LOCATED IF NECESSARY. BEARINGS AND COORDINATES ARE BASED ON COLORADO STATE PLANE AT BEARINGS AND COORDINATES ARE BASED ON COLDRADO STATE PLANE AT GROUND, CENTRAL ZONE, FROM GPS OBSERVATION. PROVIDED BEARINGS HAVE BEEN ROTATED CLOCKWISE 00°00'17" TO MATCH OBSERVED BEARINGS ALONG THE EAST LINE OF SECTION 15. FLOODPLAIN: PER THE FEMA FLOODPLAIN MAPS, THE SITE IS LOCATED IN AN AREA I. THE ATC LEASE AREA, ACCESS & UTILITY EASEMENT AND UTILITYEND LEAGE AREA, ACCESS & UTILITY EASEMENT AND UTILITY EASEMENT LIE WHOLLY WITHIN THE PARENT PARCEL. NONE OF THE MONOPINE BRANCHES WERE OBSERVED TO REACH OUTSIDE THE ATC LEASE AREA/FENCED AREA. DESIGNATED AS ZONE X, AND IS NOT IN A SPECIAL FLOOD HAZARD AREA. COMMUNITY PANEL NUMBER: 08041C0950G ATED: 12/07/2018 BOUNDARY NOTE THIS SURVEY DOES NOT CONSTITUTE A BOUNDARY SURVEY OF THE PARENT VICINITY MAP TRACT. ANY PARENT TRACT PROPERTY LINES SHOWN HEREON ARE FROM SUPPLIED INFORMATION AND MAY NOT BE FIELD VERIFIED. ENCROACHMENT STATEMENT AT THE TIME OF THE SURVEY, THERE WAS VISIBLE EVIDENCE OF THE ZONING INFORMATION A THE ATC LEASE AREA AS PROVIDED DOES NOT PLOT IN THE LOCATION OF THE TOWER COMPOUND, WHICH WOULD BE REMEDIED BY THE ATC LEASE ZONED "A-5", AGRICULTURAL, PER EL PASO COUNTY ONLINE INFORMATION. FOR ADDITIONAL ZONING INFORMATION CONTACT: THE TOWER COMPOUND, WHICH WOULD BE REMEDIED BY THE ATC LEASE AREA AS SURVEYED LEGAL DESCRIPTION SHOWN HEREON. A PORTION OF WIRE FENCE (UNKNOWN OWNERSHIP) AND WIRE FENCE (LANDOWNER) LIES WITHIN THE ACCESSES & UTILITY EASEMENT AS SURVEYED AND UTILITY EASEMENT AS SURVEYED. EL PASO COUNTY PLANNING & COMMUNITY DEVELOPMEN 2880 INTERNATIONAL CIRCLE, SUITE 110 COLORADO SPRINGS, COLORADO 80910 **LEGAL DESCRIPTIONS** TITLE COMMITMENT LEGAL DESCRIPTION - PARENT PARCEL: THE REAL PROPERTY, TOGETHER WITH THE FIXTURES AND IMPROVEMENTS LOCATED THEREON, IF ANY, SITUATE, LYING AND BEING IN THE COUNTY OF EL PASO AND STATE OF COLORADO, DESCRIBED AS FOLLOWS: THE SOUTH HALF OF THE NORTHHEAST OLARTER AND THAT PORTION OF THE NORTHHEAST QUARTER OF THE SOUTHHEAST QUARTER OF SAID SECTION 15 THENCEN THE NORTHHEAST COURSE OF THE NORTHHEAST QUARTER OF THE SOUTHHEAST QUARTER OF SAID SECTION 15 THENCE SOUTH 11 DEGREES 25 MINUTES 40 SECONDS EAST ON AN ASSUMED BEARING ON THE NORTHH-SOUTH CENTERLINE OF SAID SECTION 474.00 FEET THENCE NORTHH 86 DEGREES 34 MINUTES 50 SECONDS WEST 153.05 ECONDS WEST 153.05 TO THE SOUTHHEAST QUARTER OF THE SOUTHEAST QUARTER OF THE SOUTHEAST QUARTER OF THE SOUTHEAST QUARTER OF THE SOUTHEAST QUARTER OF THE SOUTH SOUTHEAST QUARTER OF THE SOUTHEAST QUARTER OF THE SOUTHEAST QUARTER OF THE SOUTHEAST QUARTER OF THE SOUTH SOUT CENTER OF EXISTING MONOPINE LAT: 38'39'13.2"N LONG: 104'52'14.9"W GROUND ELEV: 6717.3' (AMSL) 5'X5' CONCRETE TOWER BASE 0.6'H —TOP OF STEEL TOWER HEIGHT AGL: 50.6' 20' UTILITY EASEMENT CENTER OF PROPOSED MONOPINE LAT: 38'39'13.0'N LONG: 104'52'15.0'N GROUND ELEY: 671.78' (AMS.) 5'X5' CONCRETE TOWER BASE 0.6'H TOP OF STEEL TOWER HEIGHT AGL: 50.6' TOP OF HIGHEST BRANCH AGL: 55.1' — <u>P.O.B.</u> UTILITY EASEMENT AS SURVEYED ATC LEASE AREA - AS PROVIDED (PER MEMORANDUM OF LEASE RECORDED 01/19/2016 AS INSTRUMENT NO 216004903); BEING A LEASE AREA WITHIN A PORTION OF THE SOUTHEAST QUARTER OF SECTION 15, TOWNSHIP 16 SOUTH, RANGE 67 WEST OF THE 6TH P.M., COUNTY OF -SEE COMPOUND DETAIL BEING A LEASE AREA WITHIN A PORTION OF THE SOUTHEAST QUARTER OF SECTION 15, TOWNSHIP 16 SOUTH, RANGE 67 WEST OF THE 6TH P.M., COUNTY LEASO, STATE OF COLORADO, BEING MORE PARTICULARILY DESCRIBED AS FOLLOWS: COMMENCING ATTHE SOUTHEAST CORNER OF SAID SECTION 15; THENCE ALONG THE EAST LINE OF SAID SECTION NO4*3808*W, 1706.72 FEET, THENCE SOUTHEAST CORNER OF SAID SECTION NO4*3808*W, 1706.72 FEET, THENCE SOUTHEAST CORNER OF SAID SECTION NO4*3808*W, 1706.72 FEET, THENCE CONTINUING SOUTH FOR THE POINT OF BEGINNING, THENCE SOUTH AS POINT THE TO A POINT HEREINAFTER REFERRED TO AS POINT "B", THENCE NOUTGOOD'S, 80.00 FEET, THENCE NOUTGOOD'S, 80.00 FEET, THENCE NOUTGOOD'S, 80.00 FEET, THENCE SOUTH OF SOUTH OF SOUTH SOUTH AS POINT "B", THENCE NOUTGOOD'S, 80.00 FEET, THENCE NOUTG 89*24'56"W 78.77 NVERT ELEV: 6717.3 ATC LEASE AREA - AS SURVEYED: A PARCEL OF LAND LOCATED WITHIN THE SOUTHEAST QUARTER (NE1/4 SE1/4) OF SECTION 15, TOWNSHIP 16 SOUTH, RANGE 67 WEST OF THE 6TH P.M., BEING

A PARCEL OF LAND LOCATED WITHIN THE SOUTHEAST QUARTER (NETHEOCENHOUS) CONTROLLING, TOTHESHIF TO GOOD, THE SOUTHEAST CORNER OF SAID SECTION 15, THENCE MAY 33'10'W, 2052 AE FEET TO THE SOUTHEAST CORNER OF THE PROPERTY DESCRIBED IN QUIT CLAM DEED DATED MAY 28, 2003 AND RECORDED JUNE 05, 2003 IN INSTRUMENT NO. 203123705, DEPICITED ON EL PASO COUNTY ASSESSOR'S MAP 76150 AS PARCEL 00-004; THENCE NOM'39557W ALONG THE EAST LINE OF SAID PROPERTY, 40.1.58 FEET; THENCE S87'32'15'W ALONG A LINE PERPENDICULAR TO SAID EAST LINE, 52.28 FEET TO THE POINT OF BEGINNING; THENCE S88'24'56'W, 59.76 FEET; THENCE NO0'08'11"E, 60.51 FEET; THENCE S88'592ZE, 59.76 FEET; THENCE S00'080'TW, 59.89 FEET TO THE POINT OF BEGINNING.
CONTAINING A TOTAL CALCULATED AREA OF 3,597.62 SQUARE FEET OR 0.083 ACRES, MORE OR LESS.

BEING A STRIP OF LAND 20.00 FEET IN WIDTH WITHIN A PORTION OF THE SOUTHEAST QUARTER OF SECTION 15, TOWNSHIP 16 SOUTH, RANGE 67 WEST OF THE 6TH P.M., COUNTY OF EL PASO, STATE OF COLORADO, LYING 10.00 FEET ON EACH SIDE OF THE FOLLOWING DESCRIBED CENTRELINE: COMMENCING AT POINT "B" AS DESCRIBED ABOVE; THENCE SOO"0000"W, 10.00 FEET TO THE POINT OF BEGINNING; THENCE SOO"0000"E, 78.43 FEET; THENCE SOO"0000"W, 10.00 FEET TO THE POINT OF BEGINNING; THENCE SOO"0000"E, 78.43 FEET; THENCE SOO"0000"W, 38.42 FEET TO THE NORTH RIGHT OF WAY LINE OF LITTLE TURKEY CREEK ROAD AND END DO JOS TRIPP OF LAND. SIDELINES OF SAID STRIPPS AND FIR POWER OF LAND ARE TO BE LENGTHENED AND/OR SHORTENED TO PREVENT GAPS AND/OR OVERLAPS. (THIS EASEMENT IS PROVIDED FOR INFORMATIONAL PURPOSES ONLY, BECAUSE IT COMMENCES AT A POINT IN THE PROVIDED, ERRONEOUS ATC LEASE AREA DESCRIPTION.)

ACCESS & UTILITY EASEMENT - AS SURVEYED:
A 20 FOOT WIDE STRIP OF LAND LOCATED WITHIN THE SOUTHEAST QUARTER (NE1/4 SE1/4) OF SECTION 15, TOWNSHIP 16 SOUTH, RANGE 67 WEST OF THE

AZD FOOT WILD STATE OF LINEAD SIZE OF THE FOLLOWING DESCRIBED CERTIFICATION OF THE STATE OF THE SOUTHEAST CORNER OF THE FOLLOWING DESCRIBED CENTER OF THE SOUTHEAST CORNER OF SAID SECRIBED OF THE SOUTHEAST CORNER OF SAID SECRIBED OF THE SOUTHEAST CORNER OF SAID SECRIBED OF THE SOUTHEAST CORNER OF THE POPERTY DESCRIBED OF THE SOUTHEAST CORNER OF THE POPERTY DESCRIBED OF THE SOUTHEAST CORNER OF THE POPERTY OF THE SOUTHEAST CORNER OF THE SOUTHEAST CORNER OF THE POPERTY OF THE SOUTHEAST CORNER OF THE SOUTHEAST

POINT OF TERMINUS.
CONTAINING A TOTAL CALCULATED AREA OF 9,015.34 SQUARE FEET OR 0.207 ACRES, MORE OR LESS.
(NOTE: DOCUMENTATION WAS NOT PROVIDED TO DETERMINE RIGHT-OF-WAY WIDTH FOR LITTLE TURKEY CREEK ROAD; THEREFORE, THE EASEMENT IS
WRITTEN TO BEGIN AT THE EDGE OF THE EXISTING ROAD. LITTLE TURKEY CREEK ROAD IS DEPORTED AS PUBLIC RIGHT-OF-WAY ON AN UNRECORDED SC PERFORMED BY JESUS A. LUGO, DATED 2012.)

UTILITY EASEMENT - AS PROVIDED (PER AN UNRECORDED FIRST AMENDMENT TO LAND LEASE AGREEMENT DATED FEBRUARY 12, 2012);
BEING TWO STRIPS OF LAND 10.00 FEET IN WIDTH WITHIN A PORTION OF THE SOUTHEAST QUARTER OF SECTION 15, TOWNSHIP 16 SOUTH, RANGE 67 WEST

(STRIP ONE)
BEGINNING AT POINT "A" AS DESCRIBED ABOVE; THENCE (ILLEGIBLE), 23.43 FEET; THENCE 800"00"00"W, 416.92 FEET TO A POINT HEREINAFTER REFERRED TO AS POINT "C"; THENCE CONTINUING 800"00"00"W, 14.23 FEET TO THE END OF SAID STRIP OF LAND.

BEGINNING AT POINT "C" AS DESCRIBED ABOVE; THENCE S89°35'35"E, 50.84 FEET TO THE END OF SAID STRIP OF LAND. (NOTE: THIS LEGAL DESCRIPTION IS PROVIDED ON A SURVEY ATTACHED TO THE REFERENCED AGREEMENT, AND IS A POOR COPY. THIS RENDITION MAY CONTAIN ERRORS, AND IS DEPENDENT ON THE PREVIOUS PROVIDED ATC LEASE AREA AND ACCESS EASEMENT DESCRIPTIONS.)


UTILITY EASEMENT - AS SURVEYED:
A 20 FOOT WIDE STRIP OF LAND LOCATED WITHIN THE SOUTHEAST QUARTER (NE1/4 SE1/4) OF SECTION 15, TOWNSHIP 16 SOUTH, RANGE 67 WEST OF THE

AZD FOOT WILE STOR FOR HACH SIDE OF THE FOLLOWING DESCRIBED CENTERLINE:

COMMENCING TO FEET ON EACH SIDE OF THE FOLLOWING DESCRIBED CENTERLINE:

COMMENCING AT THE SOUTHEAST CORNER OF SAID SECTION 15, THENCE MS'35, 2003 AND SECTION 15, ALONG THE SOUTH LINE OF A SECTION 15, ALONG THE SOUT

00°08'01"E, 59.77 FEET TO THE POINT OF TERMINUS. ONTAINING A TOTAL CALCULATED AREA OF 1,195.37 SQUARE FEET OR 0.027 ACRES, MORE OR LESS.

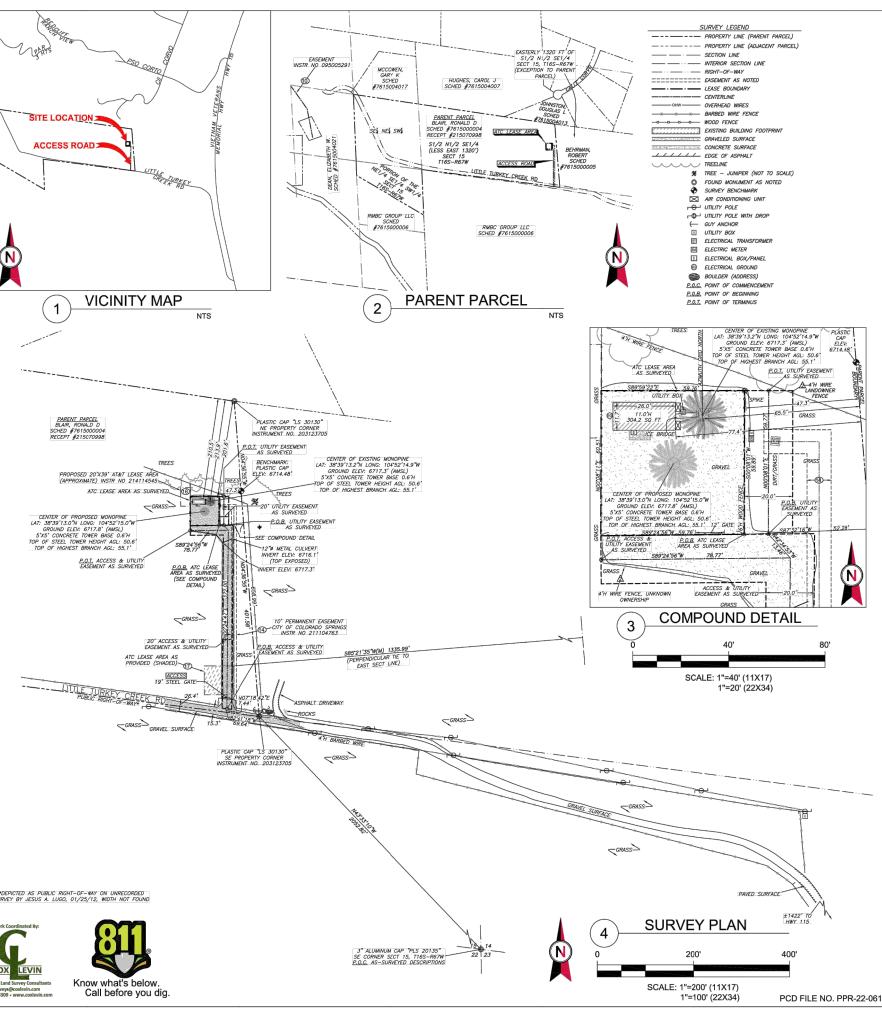



ATC TOWER SERVICES, INC.

3500 REGENCY PARKWAY SUITE 100 CARY, NC 27518 PHONE: (919) 468-0112 FAX: (919) 466-5415

THESE DRAWINGS AND/OR THE ACCOMPANYING SPECIFICATION AS INSTRUMENTS OR SERVICE ARE THE EXCLUSIVE PROPERTY OF AMERICAN TOWER. THEIR USE AND EXCLUSIVE PROPERTY OF AMERICAN TOWER. THEIR USE AND PUBLICATION SHALL BE RESTRICTED TO THE ORIGINAL SITE FOR WHICH THEY ARE PREPARED, ANY USE OR DISCLOSURE OTHER THAN THAT WHICH RELATES TO AMERICAN TOWER OR THE SPECIFIED CARRIER IS STRICTLY PROHIBITED. TITLE TO THESE DOCUMENTS SHALL REMAIN THE PROPERTY OF AMERICAN TOWER WHETHER OR NOT THE PROJECT IS EXECUTED. NEITHER THE ARCHITECT NOR THE ENGINEER WILL BE PROVIDING ON-SITE CONSTRUCTION REVIEW OF THIS PROJECT, CONTRACTOR(S) MUST VERIFY ALL DIMENSIONS AND ADVISE AMERICAN TOWER OF ANY DISCREPANCIES. ANY PRIOR ISSUANCE OF THIS DRAWING IS SUPERSEDED BY THE LATEST VERSION ON FILE WITH AMERICAN TOWER.

	<i>∕</i> 6\	PRELIM	нн	09/19/2022
	1	TITLE	НН	03/06/2023
	2			

ATC SITE NUMBER:

211173

(LEGACY 419522)

ATC SITE NAME:

REBUILD TURKEY CREEK CO

SITE ADDRESS:

2945 LITTLE TURKEY CREEK RD COLORADO SPRINGS, COLORADO 80926-9615

THIS IS TO CERTIFY THAT ARROW SURVEY GROUP, INC., AT THE REQUEST AND FOR THE EXCLUSIVE USE OF AMERICAN TOWER CORP., HAS PERFORMED THIS AS-BUILT SURVEY OF THE ATC LEASE AREA, FROM THE RECORD SOURCES AND ACTUAL FIELD SURVEY ON 09/08/2022 IN ACCORDANCE WITH THE MINIMUM STANDARDS OF PROPERTY BOUNDARY SURVEYS. ALL LINEAR AND ANGULAR VALUES SHOWN ARE BASED UPON DEED OR RECORD INFORMATION UNLESS OTHERWISE NOTED.

DATE OF PLAT: 03/06/2023

JASON D. LEVANEN CO LICENSE NO. 38159




SURVEY PREPARED BY:



DRAWN BY:	нн
APPROVED BY:	JL
DATE DRAWN:	03/06/2023
ATC JOB NO:	419522

AS-BUILT/TITLE & **BOUNDARY PLAN**

SHEET NUMBER V-101

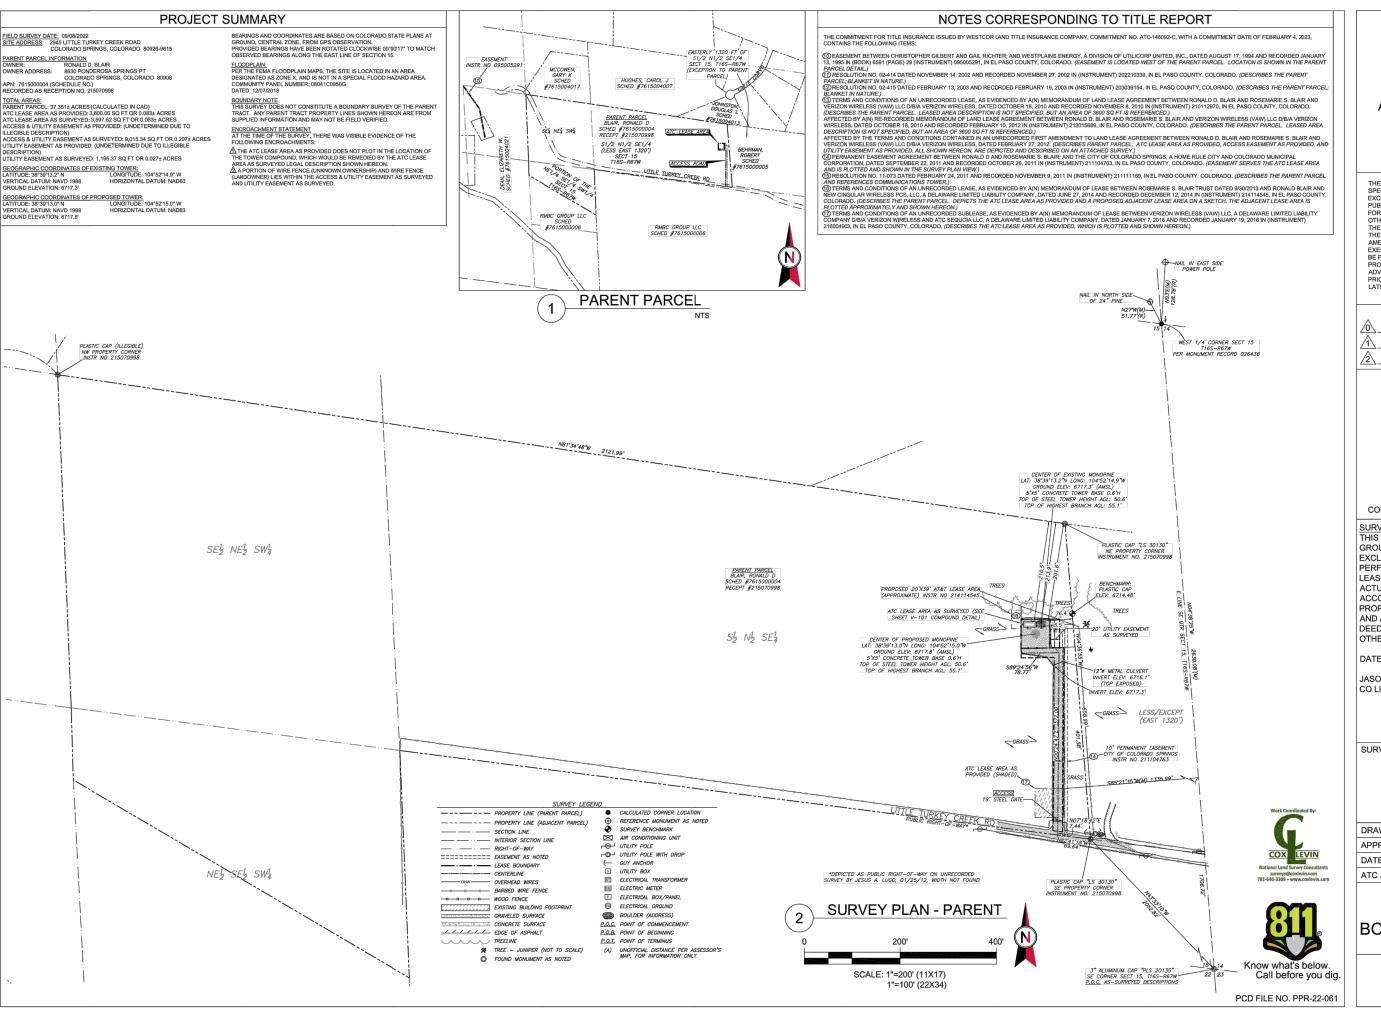



AMERICAN TOWERATC TOWER SERVICES, INC.

3500 REGENCY PARKWAY SUITE 100 CARY, NC 27518 PHONE: (919) 468-0112 FAX: (919) 466-5415

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	$\overline{\wedge}$	TITLE	нн	03/06/2023
	2			

ATC SITE NUMBER:

211173

(LEGACY 419522)

ATC SITE NAME:

REBUILD TURKEY CREEK CO

SITE ADDRESS:

2945 LITTLE TURKEY CREEK RD COLORADO SPRINGS, COLORADO 80926-9615

SURVEY CERTIFICATE:

THIS IS TO CERTIFY THAT ARROW SURVEY GROUP, INC., AT THE REQUEST AND FOR THE EXCLUSIVE USE OF AMERICAN TOWER CORP., HAS PERFORMED THIS AS-BUILT SURVEY OF THE ATC LEASE AREA, FROM THE RECORD SOURCES AND ACTUAL FIELD SURVEY ON 09/08/2022 IN ACCORDANCE WITH THE MINIMUM STANDARDS OF PROPERTY BOUNDARY SURVEYS. ALL LINEAR AND ANGULAR VALUES SHOWN ARE BASED UPON DEED OR RECORD INFORMATION UNLESS OTHERWISE NOTED.

DATE OF PLAT: 03/06/2023

JASON D. LEVANEN CO LICENSE NO. 38159



SURVEY PREPARED BY:




	DRAWN BY:	нн
	APPROVED BY:	JL
	DATE DRAWN:	03/06/2023
	ATC JOB NO:	419522

PARENT PARCEL BOUNDARY PLAN & TITLE

SHEET NUMBER:

V-101

1

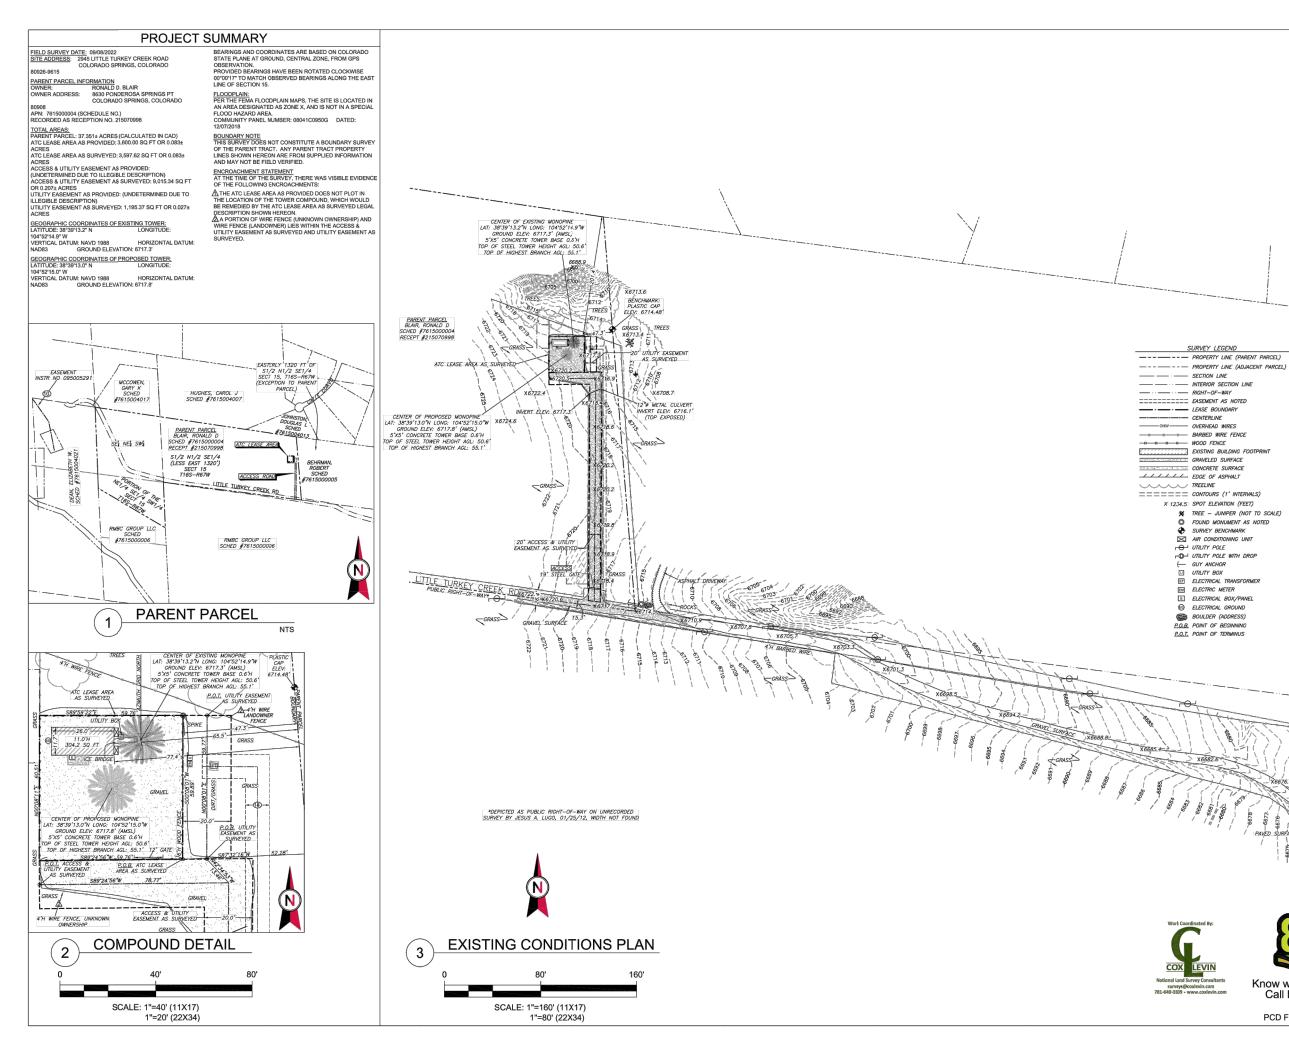



AMERICAN TOWER ATC TOWER SERVICES, INC.

3500 REGENCY PARKWAY SUITE 100 CARY, NC 27518 PHONE: (919) 468-0112 FAX: (919) 466-5415

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<u> </u>	PRELIM		09/19/2022
1	TITLE	НН	03/06/2023
2			

ATC SITE NUMBER:

211173

(LEGACY 419522)

ATC SITE NAME:

REBUILD TURKEY CREEK CO

SITE ADDRESS:

2945 LITTLE TURKEY CREEK RD COLORADO SPRINGS, COLORADO 80926-9615

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DATE OF PLAT: 03/06/2023

JASON D. LEVANEN CO LICENSE NO. 38159



SURVEY PREPARED BY:



DRAWN BY:	нн
APPROVED BY:	JL
DATE DRAWN:	03/06/2023
ATC JOB NO:	419522

EXISTING CONDITIONS AND TOPOGRAPHIC PLAN

SHEET NUMBER:

Know what's below.
Call before you dig.

PCD FILE NO. PPR-22-061

V-103





3500 REGENCY PARKWAY SUITE 100 CARY, NC 27518 PHONE: (919) 468-0112

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REV.	. DESCRIPTION	BY	DATE
<u></u>	FOR CONSTRUCTION	AB	04/26/23
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ATC SITE NUMBER:

211173

ATC SITE NAME:

REBUILD TURKEY CREEK CO

SITE ADDRESS: 2945 LITTLE TURKEY CREEK RD COLORADO SPRINGS, CO 80926

SEAL



DATE DRAWN:	04/26/23
ATC JOB NO:	14141546_D4
OPS JOB NO:	13734361
ATC LEGACY #:	419522

OVERALL SITE PLAN


SHEET NUMBER:

REVISION:

C-101

LEGEND

	EXISTING PROPERTY
	EXISTING ADJ. PROPERTY
	EXISTING EASEMENT
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	EXISTING CONTOUR (MINOR,
~~~~~~	EXISTING TREELINE
x x	EXISTING CHAINLINK FENCE
	EXISTING BUILDING
SDSD	EXISTING STORM DRAIN
	EXISTING ROAD (DIRT)
	EXISTING ROAD (STONE)
	EXISTING ROAD (PAVED)
	EXISTING CONCRETE
	EXISTING LEASE AREA
OHW OHW	EXISTING OVERHEAD WIRE
	EXISTING UTILITY POLE

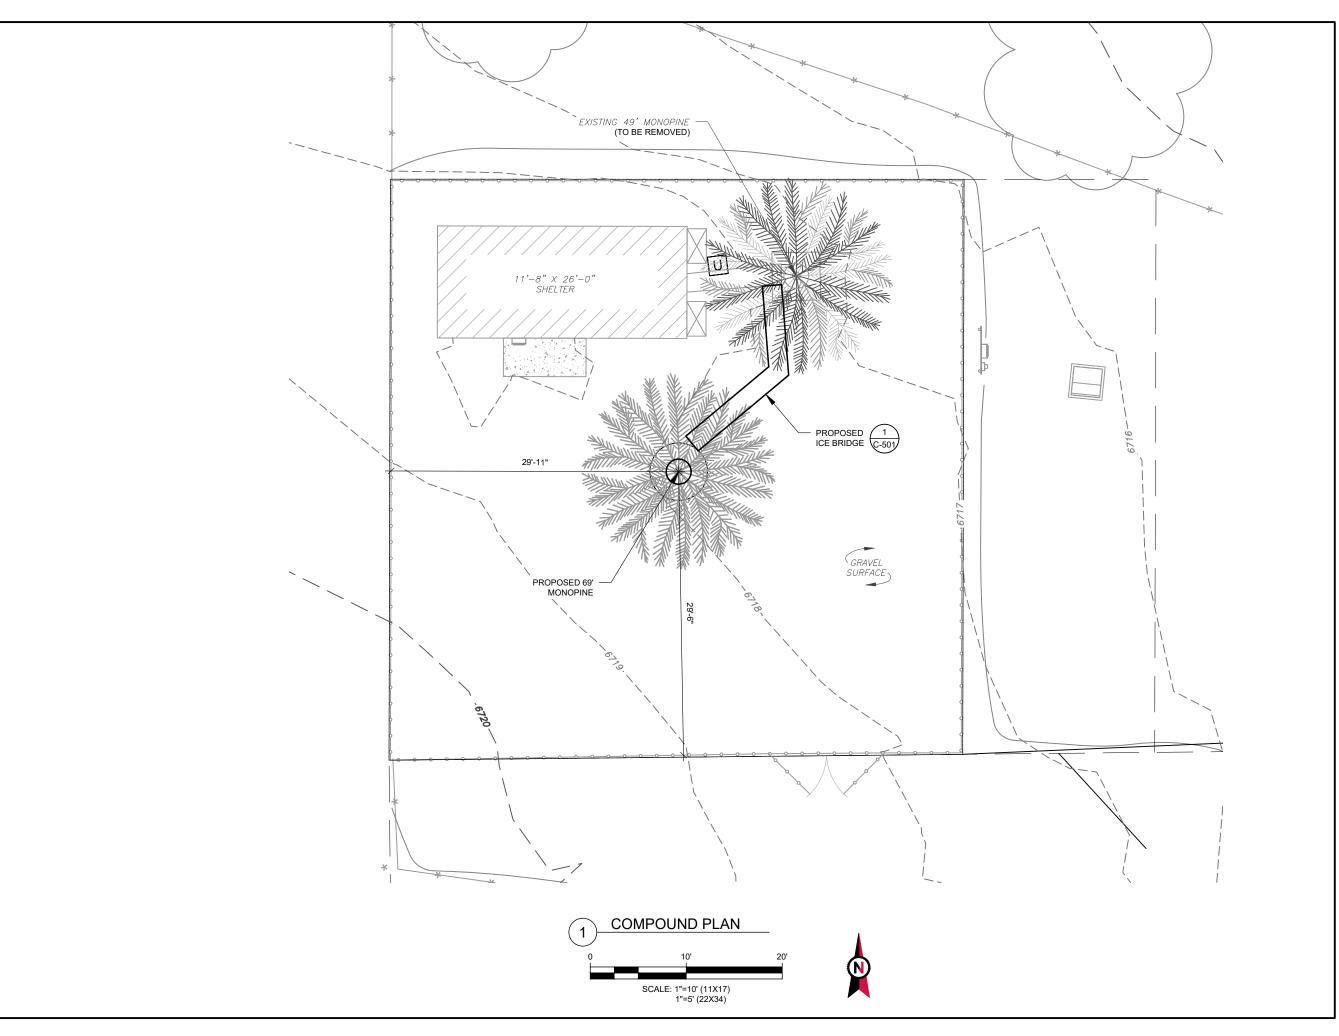



3500 REGENCY PARKWAY SUITE 100 CARY, NC 27518 PHONE: (919) 468-0112

THESE DRAWINGS AND/OR THE ACCOMPANYING SPECIFICATION AS INSTRUMENTS OR SERVICE ARE THE EXCLUSIVE PROPERTY OF AMERICAN TOWER. THEIR USE AND PUBLICATION SHALL BE RESTRICTED TO THE ORIGINAL SITE FOR WHICH THEY ARE PREPARED. ANY USE OR DISCLOSURE OTHER THAN THAT WHICH RELATES TO AMERICAN TOWER OR THE SPECIFIED CARRIER IS STRICTLY PROHIBITED. TITLE TO THESE DOCUMENTS SHALL REMAIN THE PROPERTY OF AMERICAN TOWER WHETHER OR NOT THE PROJECT IS EXECUTED. RETHER THE ARCHITECT NOR THE ENGINEER WILL BE PROVIDING ON-SITE CONSTRUCTION REVIEW OF THIS PROJECT. CONTRACTOR(S) MUST VERIFY ALL DIMENSIONS AND ADVISE AMERICAN TOWER OF ANY DISCREPANCIES. ANY PRIOR ISSUANCE OF THIS DRAWING IS SUPERSEDED BY THE LATEST VERSION ON FILE WITH AMERICAN TOWER.

REV.	DESCRIPTION	BY	DATE
△_	FOR CONSTRUCTION	_AB_	04/26/23
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ATC SITE NUMBER:

211173

ATC SITE NAME:

# REBUILD TURKEY CREEK CO

SITE ADDRESS: 2945 LITTLE TURKEY CREEK RD COLORADO SPRINGS, CO 80926



	DATE DRAWN:	04/26/23
	ATC JOB NO:	14141546_D4
	OPS JOB NO:	13734361
	ATC LEGACY #:	419522

# **COMPOUND PLAN**

SHEET NUMBER:


REVISION: C-401

#### TOWER NOTE:

EXISTING GRADE ELEV 6717.9' AMSL

ELEV O' A.G.L.

- NO TOWER LIGHTING IS PROPOSED.
   TO BE CONFIRMED BY FAA/FCC. SEE
   SHEET E-502 FOR DETAIL.
- CARRIER LOADING SHOWN IS FOR ILLUSTRATIVE PURPOSES ONLY AND MAY NOT REPRESENT ACTUAL FINAL LOADING. PLEASE REFER TO THE LATEST RFDS OR APPLICATION FOR CONFIRMATION.
- PROPOSED TREE SHOWN
   CONCEPTUALLY. REFER TO THE
   TOWER MANUFACTURER DRAWINGS
   FOR ACTUAL BRANCH
   COUNT/LOCATION AND FOLIAGE
   DENSITY.

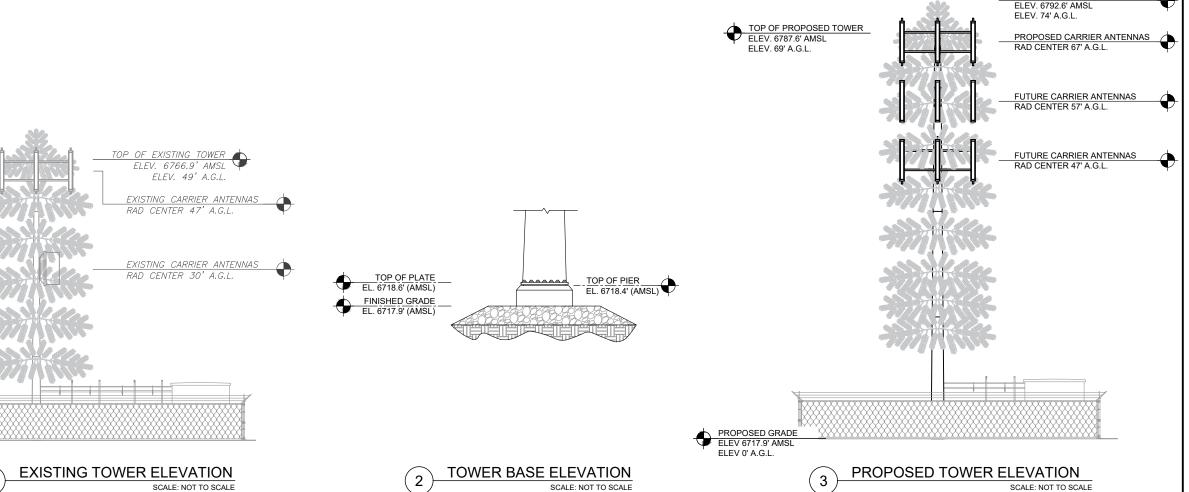



3500 REGENCY PARKWAY SUITE 100 CARY, NC 27518 PHONE: (919) 468-0112

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REV.	DESCRIPTION	BY	DATE
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ATC SITE NUMBER:

211173

ATC SITE NAME:

# REBUILD TURKEY CREEK CO

SITE ADDRESS: 2945 LITTLE TURKEY CREEK RD COLORADO SPRINGS. CO 80926

SEAL

PROPOSED TOP OF BRANCHES



DATE DRAWN:	04/26/23
ATC JOB NO:	14141546_D4
OPS JOB NO:	13734361
ATC LEGACY #:	419522


## **TOWER ELEVATION**

SHEET NUMBER:

C-402

#### **CONSTRUCTION NOTE:**

- WHERE POSSIBLE AND AS APPLICABLE, THE CONTRACTOR SHALL UTILIZE EXISTING ICE BRIDGE, CABLE LADDER, COAX SUPPORTS, AND COAX PORTS. BEFORE UTILIZING, CONTRACTOR SHALL VERIFY THAT ALL ASPECTS OF THE COMPONENTS MEET THE ATC SPECIFICATIONS. CONTRACTOR SHALL COORDINATE THE INSTALLATION OF NEW ICE BRIDGE, CABLE LADDER, COAX SUPPORT, AND COAX PORT, AS REQUIRED, WITH THE ATC CONSTRUCTION MANAGER.
- INSTALL ICE BRIDGE TO ALLOW 7 FEET CLEARANCE ABOVE GRADE TO LOWEST

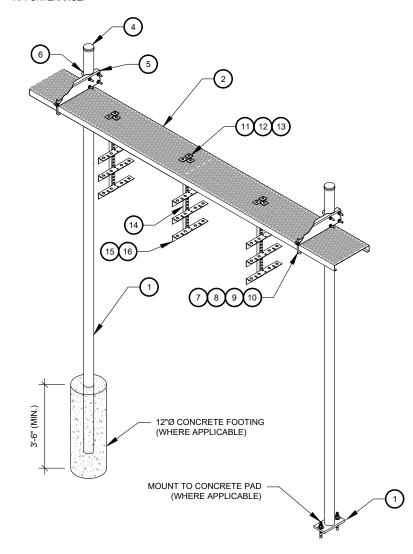

WB-	WB-K210-B WAVEGUIDE BRIDGE KIT - BILL OF MATERIALS (INCLUDED WITH KIT UNLESS NOTED OTHERWISE)				
ITEM PART DESCRIPTION		DESCRIPTION	ITEM	PART NUMBER	DESCRIPTION
1	MF126.01 MF-130	10'-4" COLUMN & BASE SHOE* 13'-4" PIPE COLUMN	9	GWL-04	1/2" GALV LOCK WASHER
2	WB-CY210	SAFETY GRATING 24" X 10'	10	GN-04	1/2" GALV HEX NUT
3	WBK110BHK	HARDWARE KIT (ITEMS 4-16)	11	GB-03205	3/8" X 2" GALV BOLT KIT
4	PC-034	PIPE CAP 3-1/2"	12	MT-387	SQUARE WASHER, 1-1/2" X 1-1/2" W/ 7/16" HOLE
5	WBLB243.08	24" WAVEGUIDE BRIDGE SUPPORT BRACKET	13	GWF-03	3/8" GALV FLAT WASHER
6	GUB-4356	1/2" X 3-5/8" X 6" GALV U-BOLT	14	WBT243.01	VERTICAL TRAPEZE SECTION
7	WB-JB-6	1/2" J-BOLT	15	GB-03105	3/8" X 1" GALV BOLT KIT
8	GWF-04	1/2" GALV FLAT WASHER	16	WBT243.02	HORIZONTAL TRAPEZE SECTION

CONTRACTOR SHALL USE PARTS MANUFACTURED BY COMMSCOPE OR APPROVED EQUIVALENT. *BASE SHOE NOT INCLUDED IN WB-K210-B KIT, ORDER COLUMN SEPARATELY OR KIT WB-K210-S.



24" WAVEGUIDE BRIDGE KIT

SCALE: NOT TO SCALE



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FOR CONSTRUCTION	_AB_	04/26/23

ATC SITE NUMBER:

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# REBUILD TURKEY CREEK CO

SITE ADDRESS: 2945 LITTLE TURKEY CREEK RD COLORADO SPRINGS, CO 80926



DATE DRAWN:	04/26/23
ATC JOB NO:	14141546_D4
OPS JOB NO:	13734361
ATC LEGACY #:	419522

CONSTRUCTION **DETAILS** 

SHEET NUMBER:

C-501





Beyond this point: Radio frequency fields at this site may exceed FCC rules for human exposure.

For your safety, obey all posted signs and site guidelines for working in radio frequency environments.

In accordance with Federal Communications on rules on radio frequency emissions 47 CFR 1.1307(b)

# **NO TRESPASSING**

ATC CAUTION AND NO TRESPASSING SIGN






Beyond this point: Radio frequency fields at this site may exceed FCC rules for human exposure.

For your safety, obey all posted signs and site guidelines for working in radio frequency environments.

In accordance with Federal Communications sion rules on radio frequency emissions 47 CFR 1.1307(b)

ATC RF WARNING AND FCC NUMBER SIGN

A "NO TRESPASSING" SIGN MUST BE POSTED A MINIMUM OF EVERY 50'

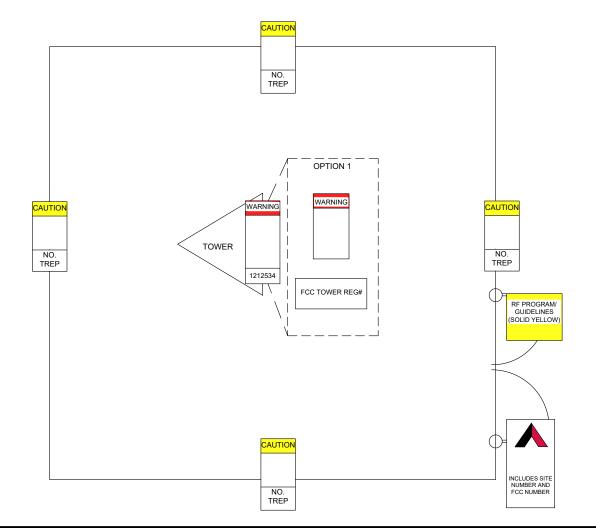

#### FCC TOWER REGISTRATION #

Posting of sign required by law

THERE MUST BE AN ATC SIGN WITH SITE INFORMATION AND FCC REGISTRATION

NUMBER AT BOTH THE ACCESS ROAD GATE (GATE OFF OF MAIN ROAD, IF APPLICABLE)

AND COMPOUND FENCE (IF NO COMPOUND

UPON DRIVE UP). IN ADDITION, PLEASE LOOK

FENCE, THEN IN A CONSPICUOUS PLACE

AT DIAGRAM FOR ALL ADDITIONAL SIGNS

OPTION 1 MAY BE USED TO POST TOWER

REGISTRATION NUMBERS AT THE BASE OF THE TOWER IF A WARNING SIGN DOES NOT

HAVE SPACE FOR THE TOWER REGISTRATION

IMPORTANT: FOR ANY ATC SIGN THAT DOES

NOT MEET THE ATC SPECIFICATION FOR

(RE-WRITE IF WORN) AND FLAG FOR

THROUGH THE WAREHOUSE)

PRINTER WILL BE ACCEPTED.

SIGNAGE (I.E., SHARPIE/PAINT PEN, WORN LABELS, ETC.), BRING IT INTO COMPLIANCE

REPLACEMENT ASAP WITH THE APPROPRIATE

PERMANENT SIGN (YOU CAN ORDER THESE

ONLY LABELS PRINTED BY A ZEBRA LABEL

ATC STAND-ALONE FCC TOWER

# **⚠ NOTICE ⚠**

#### **GUIDELINES FOR WORKING IN** RADIOFREQUENCY ENVIRONMENTS

- All personnel should have electromagnetic energy (EME) awareness training.
- All personnel entering this site must be authorized.
- A Obey all posted signs.
- Assume all antennas are active.
- A Before working on antennas, notify owners and disable appropriate
- A Maintain minimum 3 feet clearance from all antennas.
- A Do not stop in front of antennas.
- A Never operate transmitters without shields during normal operation.
- Do not operate base station antennas in equipment room.

ATC RF PROGRAM NOTICE SIGN



SITE NAME:

REBUILD TURKEY CREEK CO

SITE NUMBER: FCC REGISTRATION #:

211173

FOR LEASING INFORMATION:

877-282-7483 877-ATC-SITE FOR EMERGENCIES CALL:

877-518-6937 877-51-TOWER

# NO TRESPASSING

### www.americantower.com

POSTING OF THIS SIGNAGE REQUIRED BY LAW

ATC SITE SIGN

#### REPLACEMENT OF SIGNAGE:

AS SIGNAGE BECOMES STOLEN, DAMAGED, BRITTLE OR FADED, IT SHOULD BE REPLACED WITH SIGNAGE PER THIS SPECIFICATION, ANY ACQUIRED SITE SHOULD HAVE NEW SIGNS POSTED WITHIN 60 DAYS UNLESS OTHERWISE SPECIFIED. ANY SITE SOLD SHOULD HAVE THE ATC SIGNS REMOVED WITHIN 30 DAYS UNLESS OTHERWISE SPECIFIED. ALL FCC OR REGULATORY SIGNAGE MUST BE INSTALLED OR REPLACED AS REQUIRED TO MEET OUR STANDARD. SIGNS SHOULD BE REPLACED ON NORMAL, QUARTERLY MAINTENANCE VISITS BY CONTRACTORS OR SITE MANAGERS, UNLESS OTHERWISE REQUIRED ON A CASE-BY-CASE BASIS

## NOTE:

EXTERIOR SIGNS ARE NOT PROPOSED EXCEPT AS REQUIRED BY THE FCC. ALL EXISTING SIGNAGE AND ANY FUTURE SIGNAGE WILL BE COMPLIANT WITH STATUTE 164-43 4 NO HIGH-VOLTAGE SIGNAGE IS NECESSARY NO HIGH-VOLTAGE FOUIPMENT PRESENT



ATC TOWER SERVICES, LLC 3500 REGENCY PARKWAY SUITE 100 **CARY, NC 27518** PHONE: (919) 468-0112

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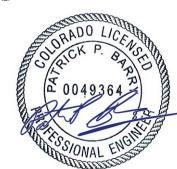
ATC SITE NUMBER:

211173

ATC SITE NAME:

# REBUILD TURKEY CREEK CO

SITE ADDRESS: 2945 LITTLE TURKEY CREEK RD COLORADO SPRINGS, CO 80926




ATE DRAWN:	04/26/23
TC JOB NO:	14141546_D4
PS JOB NO:	13734361
TC LEGACY #:	419522

**SIGNAGE** 

SHEET NUMBER:

C-502

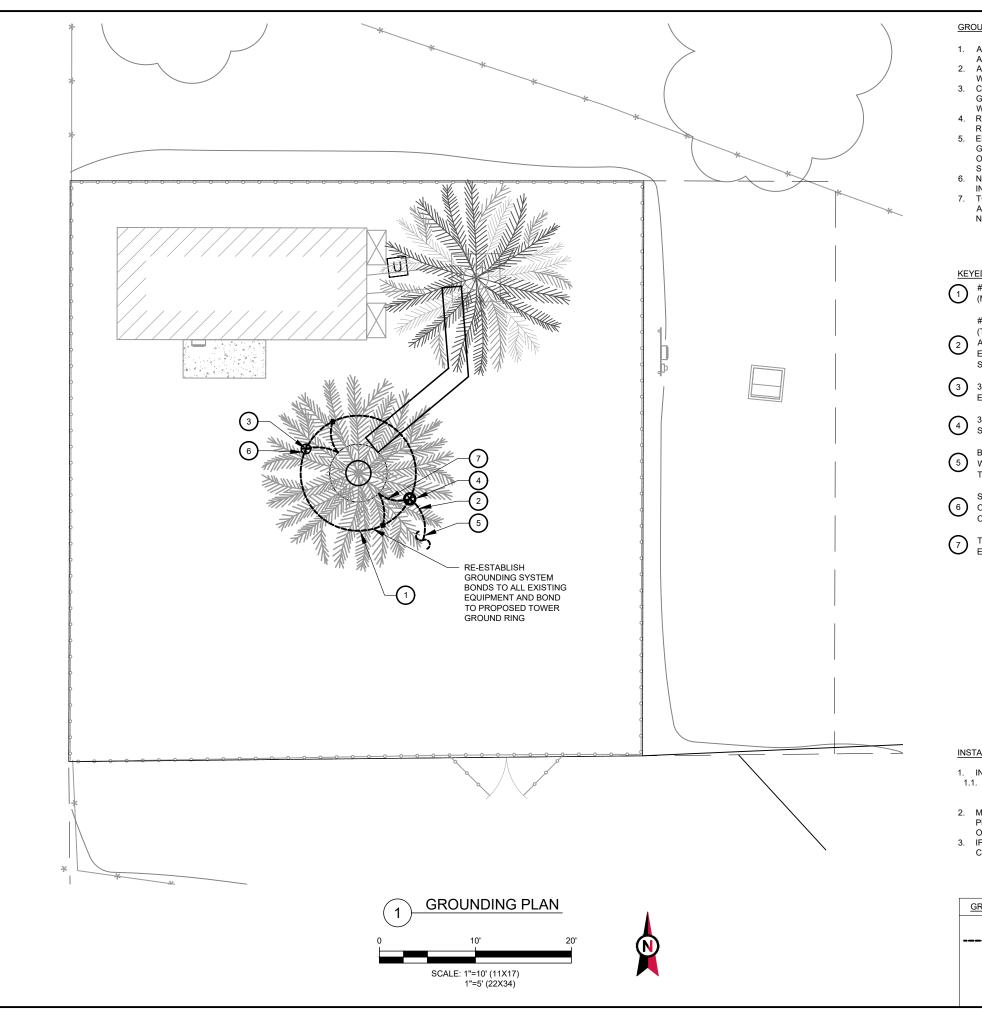

#### **GROUNDING PLAN NOTES:**

- ALL DETAILS ARE SHOWN IN GENERAL TERMS. ACTUAL INSTALLATION AND CONSTRUCTION MAY VARY DUE TO SITE SPECIFIC CONDITIONS.
- ALL GROUND CONNECTIONS SHALL BE EXOTHERMIC WELDED. ALL
- WIRES SHALL BE COPPER.
  CONTRACTOR TO VERIFY AND TEST GROUND TO SOURCE.
  GROUNDING AND OTHER OPERATIONAL TESTING WILL BE WITNESSED BY OWNER REPRESENTATIVE.
  - REFER TO ATC CONSTRUCTION SPEC AND COMPLY WITH ALL REQUIREMENTS OF GROUNDING STANDARDS.
- ELECTRICAL CONTRACTOR TO PROVIDE DETAILED DESIGN OF GROUNDING SYSTEM, AND RECEIVE APPROVAL OF DESIGN BY OWNER REPRESENTATIVE, PRIOR TO INSTALLATION OF GROUNDING SYSTEM. PHOTO DOCUMENT ALL CONNECTIONS AND GROUND RING
- NOTIFY CONSTRUCTION MANAGER IF THERE ARE ANY DIFFICULTIES INSTALLING GROUNDING SYSTEM DUE TO SITE SOIL CONDITIONS.
- TO AVOID TOWER FOUNDATION, GROUND RODS MAY BE INSTALLED AT AN ANGLE OR TOWER GROUND RING MAY BE EXTENDED AS

#### KEYED NOTES:

- #2 AWG SBTC TOWER GROUND RING. (MIN 2 FT FROM FOUNDATION)
- #2 AWG SBTC TOWER RING RADIALS. GROUNDING RADIAL (TYP.) SEE TRENCH DETAIL 4 ON SHEET E-501. MAINTAIN DEPTH AND MINIMUM 15 FT. SEPARATION FROM OTHER RADIALS AT ENDS AND MINIMUM 5 FT. SEPARATION AT GROUNDING SYSTEMS AND BUILDING FOUNDATIONS.
- 3/4Ø" X 10 FT GROUND ROD (TYP). SEE DETAIL 2 ON SHEET
- 3/4Ø" X 10 FT GROUND ROD WITH TEST WELL (MIN. ONE PER SITE ON TOWER GROUND RING). SEE DETAIL 5 ON SHEET E-501.
- BOND TO ELECTRICAL SERVICE AT MAIN BONDING JUMPER WITH #2 AWG SBTC. PARALLEL CONNECTION AWAY FROM TOWER. SEE DETAIL 1 ON SHEET E-501.
- SERVICE GROUND ROD SIZE MINIMUM PER NEC OR AS OTHERWISE INDICATED. PLACE MINIMUM OF 10' FROM ALL OTHER GROUND RODS.
- TOWER TO GROUND RING BONDS. SEE DETAIL 3 ON SHEET

#### INSTALLATION NOTES:

- 1. INSTALL STANDARD LEVEL I DESIGN (BASE BID) WHICH INCLUDES: TOWER RING, 1 GROUND ROD PÈR LEG, SÉRVICE GROUND ROD AT H-FRAME, RADIALS TO H-FRAME. ADDITIONAL WORK NECESSARY BELOW SHALL BE CONSIDERED AN ALLOWANCE.
- MEASURE GROUNDING SYSTEM RESISTANCE WITH A 3-PROBE TEST PRIOR TO BACKFILL/DEMOBILIZATION AND PRIOR TO CONNECTION OF UTILITY POWER NEUTRAL TO THE SYSTEM.
- IF GROUNDING SYSTEM RESISTANCE IS GREATER THAN 10 OHMS COORDINATE WITH ATC ENGINEER OF RECORD.

#### **GROUNDING PLAN LEGEND:**

---- GROUND WIRE

COPPER GROUND

EXOTHERMIC WELD

MECHANICAL WELD





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ATC SITE NUMBER:

211173

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# REBUILD TURKEY CREEK CO

SITE ADDRESS: 2945 LITTLE TURKEY CREEK RD COLORADO SPRINGS, CO 80926




DATE DRAWN:	04/26/23
ATC JOB NO:	14141546_D4
OPS JOB NO:	13734361
ATC LEGACY #:	419522

# **GROUNDING LAYOUT**

SHEET NUMBER:

E-401

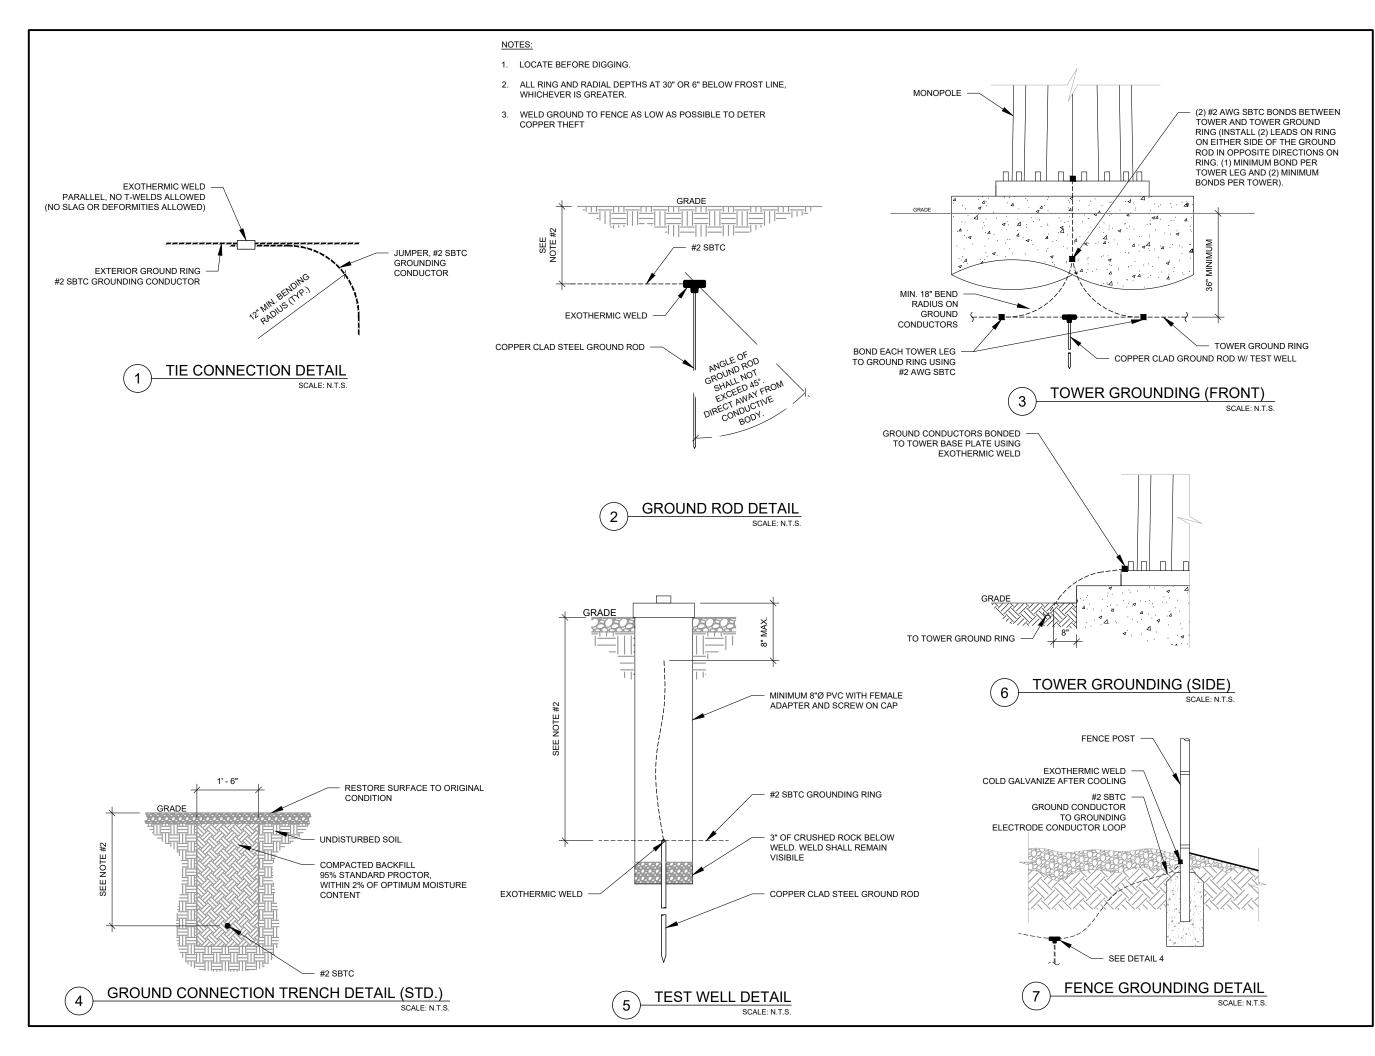



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# REBUILD TURKEY CREEK CO

SITE ADDRESS: 2945 LITTLE TURKEY CREEK RD COLORADO SPRINGS, CO 80926



DATE DRAWN:	04/26/23
ATC JOB NO:	14141546_D4
OPS JOB NO:	13734361
ATC LEGACY #:	419522

**ELECTRICAL DETAILS** 

SHEET NUMBER:

REVISION

E-501





# **AMERICAN TOWER®**

Security-Widefi SITE NAME: REBUILD TURKEY CREEK CO

SITE NUMBER: 211173

SITE ADDRESS: 2945 LITTLE TURKEY

CREEK RD.

COLORADO SPRINGS, CO

80926



**LOCATION MAP** 

# DROP AND SWAP CONSTRUCTION DRAWINGS

COMPLIANCE CODE	PROJECT SUMMARY PROJECT DESCRIPTION SHEET		SHEET INDEX				
ALL WORK SHALL BE PERFORMED AND MATERIALS INSTALLED IN ACCORDANCE WITH THE CURRENT EDITIONS OF THE	SITE ADDRESS:	THIS PROJECT ENTAILS THE CONSTRUCTION OF A NEW 69'	SHEET NO:	DESCRIPTION:	REV:	DATE:	BY:
FOLLOWING CODES AS ADOPTED BY THE LOCAL GOVERNMENT AUTHORITIES. NOTHING IN THESE PLANS IS	2945 LITTLE TURKEY CREEK RD COLORADO SPRINGS. CO 80926	TOWER AND THE REMOVAL OF THE EXISTING TOWER ONCE THE NEW TOWER IS FULLY FUNCTIONAL.	G-001	TITLE SHEET	0	04/26/23	AB
TO BE CONSTRUED TO PERMIT WORK NOT CONFORMING TO THESE CODES.	COLORADO SPRINGS, CO 80926 COUNTY: EL PASO	1.2.1 1.0.1.2.1.0.1.0.1.0.1.0.1.2.1	G-002	GENERAL NOTES	0	04/26/23	AB
INTERNATIONAL BUILDING CODE (IBC)	GEOGRAPHIC COORDINATES:	PROJECT NOTES	V-101	AS-BUILT/TITLE & BOUNDARY PLAN			
NATIONAL ELECTRIC CODE (NEC)     LOCAL BUILDING CODE	LATITUDE: 38.653606°		V-102	PARENT PARCEL BOUNDARY PLAN & TITLE			
CITY/COUNTY ORDINANCES	LONGITUDE: -104.870844°  GROUND ELEVATION: 6707' AMSL	1. THE FACILITY IS UNMANNED.	V-103	EXISTING CONDITIONS AND TOPOGRAPHIC PLAN			
	PARCEL SIZE: 37.38 ACRES	A TECHNICIAN WILL VISIT THE SITE APPROXIMATELY ONCE A     MONTH FOR ROUTINE INSPECTION AND MAINTENANCE.	C-101	OVERALL SITE PLAN	0	04/26/23	AB
		3. FACILITY WILL MEET OR EXCEEDS ALL FAA AND FCC	C-401	COMPOUND PLAN	0	04/26/23	AB
		REGULATORY REQUIREMENTS.	C-402	TOWER ELEVATION	0	04/26/23	AB
		NO SANITARY SEWER, POTABLE WATER OR TRASH DISPOSAL IS REQUIRED.	C-501	CONSTRUCTION DETAILS	0	04/26/23	AB
		5. HANDICAP ACCESS IS NOT REQUIRED.	C-502	SIGNAGE	0	04/26/23	AB
SURVEY INFORMATION	PROJECT TEAM	6. THE FACILITY WILL NOT GENERATE NOISE IN EXCESS OF	E-401	GROUNDING LAYOUT	0	04/26/23	AB
TOPOGRAPHY OBTAINED FROM SURVEY     BOUNDARY INFORMATION WAS OBTAINED FROM SURVEY	TOWER OWNER:  AMERICAN TOWER CORPORATION 10 PRESIDENTIAL WAY WOBURN, MA 01801		E-501	ELECTRICAL DETAILS	0	04/26/23	AB
PLAN DATED 09/19/22 BY ARROW SURVEY GROUP							
UTILITY COMPANIES	PROPERTY OWNER:						
POWER COMPANY: UNKNOWN	RONALD D. BLAIR 8630 PONDEROSA SPRINGS PT.						
PHONE: (UNKNOWN)	COLORADO SPRINGS, CO 80908	PROJECT LOCATION DIRECTIONS					
TELEPHONE COMPANY: UNKNOWN PHONE: (UNKNOWN)	ENGINEER:	FROM COLORADO SPRINGS:					
Know what's below. Call before you dig.	ATC TOWER SERVICES 3500 REGENCY PARKWAY SUITE 100 CARY, NC 27518	HEAD SOUTH TOWARD PIKES PEAK AVE. TURN RIGHT AT THE 1ST CROSS STREET ONTO PIKES PEAK AVE. TURN LEFT AT THE 1ST CROSS STREET ONTO S NEVADA AVE. CONTINUE STRAIGHT ONTO CO-115 S/S NEVADA AVE. CONTINUE TO FOLLOW CO-115 S. CONTINUE STRAIGHT TO STAY ON CO-115 S. TURN RIGHT ONTO PSO CORTO. TURN LEFT AT THE 1ST CROSS STREET ONTO CLL CORVO				PCD FILE: NO	D. PPR-22-061

# AMERICAN TOWER® ATC TOWER SERVICES, LLC

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ATC SITE NUMBER:

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# REBUILD TURKEY CREEK CO

SITE ADDRESS: 2945 LITTLE TURKEY CREEK RD COLORADO SPRINGS. CO 80926

SEAL:



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OPS JOB NO:	13734361
ATC LEGACY #:	419522

TITLE SHEET

SHEET NUMBER:

G-001

#### **GENERAL CONSTRUCTION NOTES:**

- ALL WORK SHALL CONFORM TO ALL CURRENT APPLICABLE FEDERAL, STATE, AND LOCAL CODES, INCLUDING ANSI/EIA/TIA-222, AND COMPLY WITH ATC CONSTRUCTION SPECIFICATIONS FOR WIRELESS TOWER SITES.
- CONTRACTOR SHALL CONTACT LOCAL 811 FOR IDENTIFICATION OF UNDERGROUND UTILITIES PRIOR TO START OF CONSTRUCTION
- CONTRACTOR IS RESPONSIBLE FOR COORDINATING ALL REQUIRED INSPECTIONS.
- ALL DIMENSIONS TO OF AND ON EXISTING BUILDINGS, DRAINAGE STRUCTURES, AND SITE IMPROVEMENTS SHALL BE VERIFIED IN FIELD BY CONTRACTOR WITH ALL DISCREPANCIES REPORTED TO THE ENGINEER.
- DO NOT CHANGE SIZE OR SPACING OF STRUCTURAL ELEMENTS.
- DETAILS SHOWN ARE TYPICAL; SIMILAR DETAILS APPLY TO SIMILAR CONDITIONS UNLESS
- THESE DRAWINGS DO NOT INCLUDE NECESSARY COMPONENTS FOR CONSTRUCTION SAFETY WHICH IS THE SOLE RESPONSIBILITY OF THE CONTRACTOR.
- CONTRACTOR SHALL BRACE STRUCTURES UNTIL ALL STRUCTURAL ELEMENTS NEEDED FOR STABILITY ARE INSTALLED. THESE ELEMENTS ARE AS FOLLOWS: LATERAL BRACING, ANCHOR
- CONTRACTOR SHALL DETERMINE EXACT LOCATION OF EXISTING UTILITIES, GROUNDS DRAINS DRAIN PIPES, VENTS, ETC. BEFORE COMMENCING WORK.
- INCORRECTLY FARRICATED, DAMAGED, OR OTHERWISE MISEITTING OR NONCONFORMING MATERIALS OR CONDITIONS SHALL BE REPORTED TO THE ATC CM PRIOR TO REMEDIAL OR CORRECTIVE ACTION, ANY SUCH REMEDIAL ACTION SHALL REQUIRE WRITTEN APPROVAL BY THE ATC CM PRIOR TO PROCEEDING.
- EACH CONTRACTOR SHALL COOPERATE WITH THE ATC CM, AND COORDINATE HIS WORK WITH THE WORK OF OTHERS
- CONTRACTOR SHALL REPAIR ANY DAMAGE CAUSED BY CONSTRUCTION OF THIS PROJECT TO MATCH EXISTING PRE-CONSTRUCTION CONDITIONS TO THE SATISFACTION OF THE ATC CONSTRUCTION MANAGER
- ALL CABLE/CONDUIT ENTRY/EXIT PORTS SHALL BE WEATHERPROOFED DURING INSTALLATION USING A SILICONE SEALANT.
- WHERE EXISTING CONDITIONS DO NOT MATCH THOSE SHOWN IN THIS PLAN SET, CONTRACTOR WILL NOTIFY THE ATC CONSTRUCTION MANAGER IMMEDIATELY.
- CONTRACTOR SHALL ENSURE ALL SUBCONTRACTORS ARE PROVIDED WITH A COMPLETE AND CURRENT SET OF DRAWINGS AND SPECIFICATIONS FOR THIS PROJECT.
- ALL ROOF WORK SHALL BE DONE BY A QUALIFIED AND EXPERIENCED ROOFING CONTRACTOR IN COORDINATION WITH ANY CONTRACTOR WARRANTING THE ROOF TO ENSURE THAT THE WARRANTY IS MAINTAINED.
- CONTRACTOR SHALL REMOVE ALL RUBBISH AND DEBRIS FROM THE SITE AT THE END OF EACH
- CONTRACTOR SHALL COORDINATE WORK SCHEDULE WITH LANDLORD AND TAKE PRECAUTIONS TO MINIMIZE IMPACT AND DISRUPTION OF OTHER OCCUPANTS OF THE FACILITY
- CONTRACTOR SHALL FURNISH ATC WITH THREE AS-BUILT SETS OF DRAWINGS UPON COMPLETION OF WORK
- PRIOR TO SUBMISSION OF BID, CONTRACTOR SHALL COORDINATE WITH ATC CM TO DETERMINE WHAT, IF ANY, ITEMS WILL BE PROVIDED. ALL ITEMS NOT PROVIDED SHALL BE PROVIDED AND INSTALLED BY THE CONTRACTOR. CONTRACTOR WILL INSTALL ALL ITEMS PROVIDED.
- PRIOR TO SUBMISSION OF BID, CONTRACTOR WILL COORDINATE WITH ATC CONSTRUCTION MANAGER TO DETERMINE IF ANY PERMITS WILL BE OBTAINED BY ATC. ALL REQUIRED PERMITS NOT OBTAINED BY ATC MUST BE OBTAINED, AND PAID FOR, BY THE CONTRACTOR.
- CONTRACTOR SHALL SUBMIT ALL SHOP DRAWINGS TO ATC FOR REVIEW AND APPROVAL PRIOR
- ALL EQUIPMENT SHALL BE INSTALLED ACCORDING TO MANUFACTURER'S SPECIFICATIONS AND LOCATED ACCORDING TO ATC SPECIFICATIONS, AND AS SHOWN IN THESE PLANS.
- THE CONTRACTOR SHALL SUPERVISE AND DIRECT THE PROJECT DESCRIBED HEREIN. THE CONTRACTOR SHALL BE SOLELY RESPONSIBLE FOR ALL THE CONSTRUCTION MEANS, METHODS, TECHNIQUES, SEQUENCES AND PROCEDURES AND FOR COORDINATING ALL PORTIONS OF THE WORK UNDER THE CONTRACT
- CONTRACTOR SHALL NOTIFY ATC CM A MINIMUM OF 48 HOURS IN ADVANCE OF POURING CONCRETE OR BACKFILLING ANY UNDERGROUND UTILITIES, FOUNDATIONS OR SEALING ANY WALL, FLOOR OR ROOF PENETRATIONS FOR ENGINEERING REVIEW AND APPROVAL

#### **EROSION AND SEDIMENTATION CONTROL PLAN NOTES:**

THIS PLAN HAS BEEN DEVELOPED TO PROVIDE A STRATEGY FOR CONTROLLING SOIL EROSION AND SEDIMENTATION DURING AND AFTER CONSTRUCTION OF THE PROPOSED FACILITY. THE EQUIPMENT ANTICIPATED TO BE USED FOR THE CONSTRUCTION INCLUDES THE FOLLOWING: BACKHOES, BUILDOZERS LOADERS TRUCKS CRANES COMPACTORS AND GRADERS THE FOLLOWING MEASURES WILL BE UNDERTAKEN TO PROVIDE MAXIMUM PROTECTION TO THE SOIL, WATER, AND ABUTTING LANDS:

- ALL EARTH DISTURBANCE ACTIVITIES SHALL PROCEED IN ACCORDANCE WITH THE SEQUENCE PROVIDED ON THE PLAN DRAWINGS. DEVIATION FROM THAT SEQUENCE MUST BE APPROVED IN WRITING FROM AMERICAN TOWER PRIOR TO IMPLEMENTATION.
- THE LIMITS OF DISTURBANCE (LOD) SHOULD BE MARKED PRIOR TO DISTURBANCE ACTIVITIES (I.E. SURVEY STAKES, POSTS & ROPE, CONSTRUCTION FENCE, ETC.).
- A COPY OF THE SEDIMENT AND EROSION CONTROL PLAN MUST BE AVAILABLE AT THE PROJECT SITE DURING CONSTRUCTION UNTIL THE SITE IS STABILIZED. (AS APPLICABLE)
- PRIOR TO GRUBBING OR ANY FARTHMOVING OPERATION SILTATION FENCE WILL BE INSTALLED ACROSS THE SLOPE ON THE CONTOUR AT THE DOWNHILL LIMIT OF THE WORK AS PROTECTION AGAINST CONSTRUCTION RELATED EROSION. (CONSULT ATC CM AS REQUIRED)
- STONE CHECK DAMS WILL BE INSTALLED IN THE DRAINAGE DITCHES TO PREVENT EROSION PRIOR TO THE STABILIZATION OF THE CHANNELS, EROSION CONTROL BLANKETS WILL ALSO BE INSTALLED IN ALL DITCHES TO BE REVEGETATED.
- PERMANENT SOIL EROSION CONTROL MEASURES FOR ALL SLOPES, CHANNELS, DITCHES, OR ANY UNDISTURBED LAND AREA WILL BE COMPLETED WITHIN FIFTEEN CALENDAR DAYS AFTER FINAL GRADING HAS BEEN COMPLETED. WHEN IT IS NOT POSSIBLE OR PRACTICAL TO PERMANENTLY STABILIZE DISTURBED LAND, TEMPORARY EROSION CONTROL MEASURES WILL BE IMPLEMENTED WITHIN THIRTY CALENDAR DAYS OF EXPOSURE OF SOIL. ALL DISTURBED AREAS WILL BE MULCHED FOR EROSION CONTROL UPON COMPLETION OF ROUGH GRADING. CUT SLOPES IN COMPETENT BEDROCK AND ROCK FILLS NEED NOT BE VEGETATED.
- ANY EXPOSED SLOPES GREATER THAN 2:1 AND NEWLY CONSTRUCTED DRAINAGE DITCHES WILL

- BE STABILIZED WITH EROSION CONTROL BLANKET TO PREVENT EROSION DURING CONSTRUCTION AND TO FACILITATE REVEGETATION AFTER LOAMING AND SEEDING.
- TO PROVIDE PROTECTION AGAINST EROSION, RIPRAP WILL BE PLACED AT ALL CULVERT INLETS AND OUTLETS AS SHOWN ON THE ATTACHED DRAWINGS.
- IN AREAS OF CONSTRUCTION DEWATERING, ISOLATED SETTLEMENT TRAPS WILL BE CONSTRUCTED ADJACENT TO THE ACTIVITY, WATER WILL BE PUMPED FROM THE EXCAVATIONS TO THESE DEPRESSION AREAS FOR SEDIMENT REMOVAL. ADDITIONAL SEDIMENTATION PROTECTION WILL BE PROVIDED BY THE INSTALLATION OF HAYBALE BARRIERS BETWEEN THE BASINS AND THE RECEIVING DRAINAGE COARSE.
- NATIVE TOPSOIL SHALL BE SAVED, STOCKPILED, MULCHED, AND REUSED AS MUCH AS POSSIBLE ON THE SITE. SILTATION FENCE SHALL BE INSTALLED AT THE BASE OF STOCKPILES AT THE DOWNHILL LIMIT TO PROTECT AGAINST EROSION. STOCKPILES WILL BE STABILIZED BY SEEDING AND MULCHING UPON FORMATION OF THE PILES, UPHILL OF THE STOCKPILES, STABILIZED DITCHES AND/OR BERMS WILL BE CONSTRUCTED TO DIVERT STORMWATER RUNOFF AWAY FROM THE PILES
- FINAL SEEDING WILL BE APPLIED IN ACCORDANCE WITH THE AMERICAN TOWER CORPORATION CONSTRUCTION SPECIFICATION.
- SHOULD CONSTRUCTION OCCUR AFTER NOVEMBER 15, ADDITIONAL EROSION CONTROL METHODS WILL BE IMPLEMENTED. ALL DISTURBED AREAS WILL BE MINIMIZED AS MUCH AS POSSIBLE PRIOR TO FREEZING ADDITIONAL FROSION CONTROL DEVICES WILL BE INSTALLED AS APPROPRIATE INSPECTION OF THESE EROSION CONTROL ITEMS WILL BE CONSTANT, WITH PARTICULAR ATTENTION PAID TO WEATHER PREDICTIONS TO ENSURE THAT THESE MEASURES ARE PROPERLY IN PLACE TO HANDLE LARGE AMOUNTS OF RUNOFF FROM HEAVY RAINS OR
- FOR AN EARTH DISTURBANCE ACTIVITY OR ANY STAGE OR PHASE OF AN ACTIVITY TO BE CONSIDERED PERMANENTLY STABILIZED. THE DISTURBED AREAS SHALL BE COVERED BY A MINIMUM UNIFORM 70% PERENNIAL VEGETATIVE COVER OR OTHER PERMANENT NON-VEGETATIVE COVER WITH A DENSITY SUFFICIENT TO RESIST ACCELERATED EROSION AND SUBSURFACE CHARACTERISTICS SUFFICIENT TO RESIST SLIDING AND OTHER MOVEMENTS
- THE CONTRACTOR WILL REGULARLY INSPECT THE PROJECT'S EROSION AND SEDIMENTATION CONTROLS DURING THE ENTIRE ACTIVE CONSTRUCTION STAGES. THE INSPECTIONS WILL BE PERFORMED WEEKLY AND AFTER ALL RUNOFF EVENTS. THE CONTRACTOR WILL BE RESPONSIBLE FOR THE INSTALLATION, OPERATION, MAINTENANCE, AND REMOVAL OF ALL EROSION AND SEDIMENTATION CONTROLS. ALL PREVENTATIVE AND REMEDIAL MAINTENANCE WORK, INCLUDING CLEAN OUT REPAIR, REPLACEMENT, REGRADING, RESEEDING, REMULCHING AND RENETTING MUST BE PERFORMED IMMEDIATELY. SEDIMENT THAT HAS BEEN TRAPPED BY THE SILT BARRIER WILL BE REMOVED AS REQUIRED, AND IN ALL CASES, BEFORE THE ACCUMULATION HAS REACHED HALF THE HEIGHT OF THE FENCE. THE SILT BARRIER WILL BE RE-ANCHORED, REPAIRED, OR REPLACED AS NECESSARY. ALL OTHER CONTROLS WILL BE INSPECTED ON THE SAME SCHEDULE. IF EROSION AND SEDIMENT CONTROL BMP'S FAIL TO PERFORM AS EXPECTED, REPLACEMENT BMP'S, OR MODIFICATION OF THOSE INSTALLED WILL
- ALL FILLS SHALL BE COMPACTED AS REQUIRED TO REDUCE EROSION, SLIPPAGE, SETTLEMENT, SUBSIDENCE OR OTHER RELATED PROBLEMS. FILL INTENDED TO SUPPORT BUILDINGS, STRUCTURES AND CONDUITS, ETC. SHALL BE COMPACTED IN ACCORDANCE WITH LOCAL REQUIREMENTS OR CODES.
- ALL EARTHEN FILLS SHALL BE PLACED IN COMPACTED LAYERS NOT TO EXCEED 9 INCHES IN THICKNESS.
- FILL MATERIALS SHALL BE FREE OF FROZEN PARTICLES, BRUSH, ROOTS, SOD, OR OTHER FOREIGN OR OBJECTIONABLE MATERIALS THAT WOULD INTERFERE WITH OR PREVENT CONSTRUCTION OF SATISFACTORY FILLS. FILL SHALL NOT BE PLACED ON SATURATED OR
- SEEPS OR SPRINGS ENCOUNTERED DURING CONSTRUCTION SHALL BE HANDLED IN ACCORDANCE WITH THE AMERICAN TOWER CORPORATION CONSTRUCTION SPECIFICATION AND/OR THE CONTRACTOR SHALL NOTIFY THE ATC CONSTRUCTION MANAGER.
- SEDIMENT TRACKED ONTO ANY PUBLIC ROADWAY OR SIDEWALK SHALL BE RETURNED TO THE CONSTRUCTION SITE BY THE END OF EACH WORK DAY AND DISPOSED IN THE MANNER DESCRIBED IN THIS PLAN. IN NO CASE SHALL THE SEDIMENT BE WASHED, SHOVELED, OR SWEPT INTO ANY ROADSIDE DITCH, STORM SEWER, OR SURFACE WATER.

#### CONSTRUCTION SEQUENCE:

- CONSTRUCT PROPOSED TOWER PER TOWER MANUFACTURER'S SPECIFICATIONS.
- INSTALL ANY REQUIRED ICE BRIDGES PER ATC SPECIFICATIONS.
- DECONSTRUCT EXISTING TOWER ONLY ONCE THE PROPOSED TOWER IS ERECTED AND IN FULL WORKING CONDITION.
- IF CONSTRUCTION IS TERMINATED OR SUSPENDED PRIOR TO CONSTRUCTION COMPLETION, ALL EXPOSED SOIL AREAS SHALL BE SEEDED WITH TEMPORARY SEEDING AND MULCHED IMMEDIATELY

#### CONCRETE AND REINFORCING STEEL NOTES:

- DESIGN AND CONSTRUCTION OF ALL CONCRETE FLEMENTS SHALL CONFORM TO THE LATEST EDITIONS OF ALL APPLICABLE CODES INCLUDING: ACI 301 "SPECIFICATIONS FOR STRUCTURAL CONCRETE FOR BUILDINGS", AND ACI 318 "BUILDING CODE REQUIREMENTS FOR REINFORCED
- MIX DESIGN SHALL BE APPROVED BY OWNER'S REPRESENTATIVE AND SUBMITTED TO ENGINEER PRIOR TO PLACING CONCRETE.
- CONCRETE SHALL BE NORMAL WEIGHT. 6 % AIR ENTRAINED (+/- 1.5%) WITH A MAXIMUM 4" SLUMP AND HAVE A MINIMUM 28-DAY COMPRESSIVE STRENGTH OF 4500 PSI UNLESS OTHERWISE
- THE FOLLOWING MATERIALS SHALL BE USED:

PORTLAND CEMENT: ASTM C-150, TYPE 1 OR 2

REINFORCEMENT: ASTM A-185, PLAIN STEEL WELDED WIRE FABRIC

REINFORCEMENT BARS ASTM A615, GRADE 60, DEFORMED

NORMAL WEIGHT AGGREGATE: ASTM C-33 WATER DRINKABI F

NON-CHLORIDE CONTAINING ADMIXTURES

MINIMUM CONCRETE COVER FOR REINFORCING STEEL SHALL BE AS FOLLOWS (UNLESS OTHERWISE NOTED):

- A. CONCRETE CAST AGAINST EARTH: 3"
- B. ALL OTHER CONCRETE: 2"
- A 3/4" CHAMFER SHALL BE PROVIDED AT ALL EXPOSED EDGES OF CONCRETE IN ACCORDANCE WITH ACI 301 SECTION 4.2.4. UNLESS NOTED OTHERWISE.
- INSTALLATION OF CONCRETE EXPANSION/WEDGE ANCHOR SHALL BE PER MANUFACTURER'S WRITTEN RECOMMENDED PROCEDURE. THE ANCHOR BOLT, DOWEL, OR ROD SHALL CONFORM TO MANUFACTURER'S RECOMMENDATION FOR EMBEDMENT DEPTH OR AS SHOWN ON THE DRAWINGS. NO REBAR SHALL BE CUT WITHOUT PRIOR ATC CM APPROVAL WHEN DRILLING HOLES IN CONCRETE.
- ADMIXTURES SHALL CONFORM TO THE APPROPRIATE ASTM STANDARD AS REFERENCED IN ACI
- DO NOT WELD OR TACK WELD REINFORCING STEEL
- ALL DOWELS, ANCHOR BOLTS, EMBEDDED STEEL, ELECTRICAL CONDUITS, PIPE SLEEVES GROUNDS AND ALL OTHER EMBEDDED ITEMS AND FORMED DETAILS SHALL BE IN PLACE BEFORE START OF CONCRETE PLACEMENT.
- REINFORCEMENT SHALL BE COLD BENT WHENEVER BENDING IS REQUIRED
- DO NOT PLACE CONCRETE IN WATER ICE OR ON FROZEN GROUND
- DO NOT ALLOW REINFORCEMENT, CONCRETE OR SUBBASE TO FREEZE DURING CONCRETE CURING AND SETTING PERIOD, OR FOR A MINIMUM OF 3 DAYS AFTER PLACEMENT.
- FOR COLD-WEATHER AND HOT-WEATHER CONCRETE PLACEMENT, CONFORM TO APPLICABLE ACI CODES AND RECOMMENDATIONS. IN EITHER CASE, MATERIAL'S CONTAINING CHLORIDE, CALCIUM, SALTS, ETC. SHALL NOT BE USED. PROTECT FRESH CONCRETE FROM WEATHER FOR 7 DAYS, MINIMUM.
- CONCRETE SHALL BE RUBBED TO A ROUGH GROUT FINISH. PADS SHALL BE SEALED BY STEEL TROWEL
- UNLESS OTHERWISE NOTED:
  - A. ALL REINFORCING STEEL SHALL BE DEFORMED BARS CONFORMING TO ASTM A615, GRADE 60.
  - B. WELDED WIRE FABRIC SHALL CONFORM TO ASTM A185.
- SPLICING OF REINFORCEMENT IS PERMITTED ONLY AT LOCATIONS SHOWN IN THE CONTRACT DRAWINGS OR AS ACCEPTED BY THE ENGINEER. UNLESS OTHERWISE SHOWN OR NOTED REINFORCING STEEL SHALL BE SPLICED TO DEVELOP ITS FULL TENSILE CAPACITY (CLASS A) IN ACCORDANCE WITH ACI 318.
- REINFORCING BAR DEVELOPMENT LENGTHS. AS COMPUTED IN ACCORDANCE WITH ACI 318. FORM THE BASIS FOR BAR EMBEDMENT LENGTHS AND BAR SPLICED LENGTHS SHOWN IN THE DRAWINGS. APPLY APPROPRIATE MODIFICATION FACTORS FOR TOP STEEL. BAR SPACING. COVER AND THE LIKE.
- DETAILING OF REINFORCING STEEL SHALL CONFORM TO "ACI MANUAL OF STANDARD PRACTICE FOR DETAILING REINFORCED CONCRETE STRUCTURES" (ACI 315).
- ALL SLAB CONSTRUCTION SHALL BE CAST MONOLITHICALLY WITHOUT HORIZONTAL CONSTRUCTION JOINTS, UNLESS SHOWN IN THE CONTRACT DRAWINGS.
- LOCATION OF ALL CONSTRUCTION JOINTS ARE SUBJECT TO THE REQUIREMENTS OF THE CONTRACT DOCUMENTS, CONFORMANCE WITH ACI 318, AND ACCEPTANCE OF THE ENGINEER. DRAWINGS SHOWING LOCATION OF DETAILS OF THE PROPOSED CONSTRUCTION JOINTS SHALL BE SUBMITTED WITH REINFORCING STEEL PLACEMENT DRAWINGS
- SPLICES OF WWF, AT ALL SPLICED EDGES, SHALL BE SUCH THAT THE OVERLAP MEASURED BETWEEN OUTERMOST CROSS WIRES OF EACH FABRIC SHEET IS NOT LESS THAN THE SPACING OF THE CROSS WIRE PLUS 2 INCHES, NOR LESS THAN 8".
- BAR SUPPORTS SHALL BE ALL-GALVINIZED METAL WITH PLASTIC TIPS.
- ALL REINFORCEMENT SHALL BE SECURELY TIED IN PLACE TO PREVENT DISPLACEMENT BY CONSTRUCTION TRAFFIC OR CONCRETE. TIE WIRE SHALL BE 16 GAUGE CONFORMING TO ASTM
- SLAB ON GROUND
  - A. COMPACT STRUCTURAL FILL TO 95% DENSITY AND THEN PLACE 6" GRAVEL BENEATH
  - B. PROVIDE VAPOR BARRIER BENEATH SLAB ON GROUND

#### **GENERAL FOUNDATION NOTES:**

(APPLICABLE FOR EQUIPMENT SHELTER ONLY)

- THOROUGHLY COMPACT BOTTOM OF EXCAVATIONS PRIOR TO PLACING RIGID INSULATION BARRIER. BACKFILL AND COMPACTION PROCEDURES SHALL BE DONE PER INDUSTRY
- ALL REINFORCING STEEL SHALL BE ASTM A615 GRADE 60. SECURE REINFORCING IN PLACE TO PREVENT MOVEMENT DURING CONCRETE PLACEMENT.
- VERIFY DETAILS AND DIMENSIONS WITH SHELTER DRAWINGS. NOTIFY ATC CM OF ANY DISCREPANCIES
- INSULATION BARRIER PROVIDED IS FOR FROST PROTECTION IN LIEU OF STANDARD FOUNDATIONS WITH BEARING AT CODE REQUIRED FROST DEPTH.
- SHELTER MUST BE ANCHORED TO ITS FOUNDATION. ANCHOR IN ACCORDANCE WITH SHELTER MANUFACTURER SPECIFICATIONS.



3500 REGENCY PARKWAY

SUITE 100

**CARY, NC 27518** 

PHONE: (919) 468-0112

THESE DRAWINGS AND/OR THE ACCOMPANYING THESE DRAWINGS AND/OR THE ACCOMPANYING 
SPECIFICATION AS INSTRUMENTS OR SERVICE ARE THE 
EXCLUSIVE PROPERTY OF AMERICAN TOWER. THEIR USE AND 
PUBLICATION SHALL BE RESTRICTED TO THE ORIGINAL SITE 
FOR WHICH THEY ARE PREPARED. ANY USE OR DISCLOSURE 
OTHER THAN THAT WHICH RELATES TO AMERICAN TOWER OR 
THE STRETCHE CAMPILED IS STRICT A DROBUISTED. THE TO THE SPECIFIED CARRIER IS STRICTLY PROHIBITED. TITLE TO THESE DOCUMENTS SHALL REMAIN THE PROPERTY OF AMERICAN TOWER WHETHER OR NOT THE PROJECT IS EXECUTED. NEITHER THE ARCHITECT NOR THE ENGINEER WIL BE PROVIDING ON-SITE CONSTRUCTION REVIEW OF THIS PROJECT. CONTRACTOR(S) MUST VERIFY ALL DIMENSIONS AND
ADVISE AMERICAN TOWER OF ANY DISCREPANCIES. ANY PRIO SSUANCE OF THIS DRAWING IS SUPERSEDED BY THE LATEST

l	REV.	DESCRIPTION	BY	DATE
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ATC SITE NUMBER:

211173

ATC SITE NAME:

# REBUILD TURKEY CREEK CO

SITE ADDRESS: 2945 LITTLE TURKEY CREEK RD COLORADO SPRINGS, CO 80926



DATE DRAWN: | 04/26/23 14141546 D4 ATC JOB NO: OPS JOB NO: 13734361 ATC LEGACY #: 419522

**GENERAL NOTES** 

SHEET NUMBER

G-002

#### **PROJECT SUMMARY** SURVEYOR'S NOTES FIELD SURVEY DATE: 09/08/2022 SITE ADDRESS: 2945 LITTLE TURKEY CREEK ROAD COLORADO SPRINGS, COLORADO 80926-96 THERE IS ACCESS TO THE ATC LEASE AREA VIA THE ACCESS & UTILITY EASEMENT FROM LITTLE TURKEY CREEK ROAD, A PUBLIC RIGHT OF WAY (SEE NOTE FOLLOWING ACCESS & UTILITY EASEMENT AS SURVEYED LEC-2 Certific PARENT PARCEL INFORMATION OWNER: RONALD D. BLAIR 2. THE LOCATIONS OF ALL UTILITIES SHOWN ON THE SURVEY ARE FROM VISIBLE SURFACE EVIDENCE ONLY. OWNER ADDRESS: 8630 PONDEROSA SPRINGS PT COLORADO SPRINGS, COLORADO 80908 VIOLED SURFACE EVIDENCE ONLY. AT THE TIME OF THIS SURVEY THERE WAS NO OBSERVABLE SURFACE EVIDENCE OF EARTH MOVING WORK, BUILDING CONSTRUCTION OR BUILDING ADDITIONS WITHIN RECENT MONTHS. APN: 7615000004 (SCHEDULE NO.) RECORDED AS RECEPTION NO. 215070998 TOTAL AREAS: PARENT PARCEL: 37.351± ACRES (CALCULATED IN CAD) AT THE TIME OF THIS SURVEY, THERE WAS NO OBSERVABLE EVIDENCE OF THE SUBJECT PROPERTY BEING USED AS A SOLID WASTE DUMP, SUMP OR FANSAI FARVEL: 37.3913 ACRES (CALCULATED IN CAU) ATC LEASE AREA AS PROVIDED: 3,600.00 SQ FT OR 0.083± ACRES ATC LEASE AREA AS SURVEYED: 3,597.62 SQ FT OR 0.083± ACRES ACCESS & UTILITY EASEMENT AS PROVIDED: (UNDETERMINED DUE TO SANITARY LANDFILL SITE LOCATION > SANITARY LANDRILL. AT THE TIME OF THIS SURVEY, THERE WAS NO OBSERVABLE EVIDENCE OF ANY RECENT CHANGES IN STREET RIGHT-OF-WAY LINES EITHER COMPLETED OR PROPOSED, AND AVAILABLE FROM THE CONTROLLING SEL NEL SWL ILLEGIBLE DESCRIPTION) ACCESS & UTILITY EASEMENT AS SURVEYED: 9,015.34 SQ FT OR 0.207± ACRES UTILITY EASEMENT AS PROVIDED: (UNDETERMINED DUE TO ILLEGIBLE ACCESS ROAD JUNISDICTION. A T'HE TIME OF THIS SURVEY, THERE WAS NO OBSERVABLE EVIDENCE OF ANY RECENT STREET OR SIDEWALK CONSTRUCTION OR REPAIRS. THIS AS-BUILT SURVEY OF AN EXISTING LEASE AREA WITHIN AN EXISTING PARCEL OF LAND WAS PREPARED TO SHOW THE INTERESTS OF AMERICAN TOWER CORPORATION AND IMPROVEMENTS PROXIMAL TO SAD INTERESTS. IT DOES NOT CONSTITUTE AN AS-BUILT SURVEY OF THE ENTIRE PARENT PARCEL. DESCRIPTION) UTILITY EASEMENT AS SURVEYED: 1,195.37 SQ FT OR 0.027± ACRES UTILITY EASEMENT AS SUIVELLESS TO TOWER: GEOGRAPHIC COORDINATES OF EXISTING TOWER: LATITUDE: 38°39'13.2" N LONGITUDE: 104°52'14.9" W HORIZONTAL DATUM: NADB3 DEAN, SCHED VERTICAL DATUM: NAVD 1988 GROUND ELEVATION: 6717.3' GEOGRAPHIC COORDINATES OF PROPOSED TOWER: LATITUDE: 38°39'13.0" N LONGITUDE: 104°52'15.0" W ALL CALLS ARE MEASURED UNLESS OTHERWISE NOTED . UNLESS OTHERWISE SPECIFIED, UTILITY POLES DID NOT IDENTIFY RMBC GROUP LLC SCHED #7615000006 OWINENSHIP. OUTLIN'S ASSEMENT (AND ACCESS & UTILITY EASEMENT) AS SURVEYED DESCRIPTIONS ARE BASED ONLY ON SURFACE EVIDENCE OF EXISTING UTILITIES SERVICING THE TOWER SITE. DESCRIBED EASEMENTS MAY NOT INCLIDE ALL UNDERGOUND UTILITIES NOT VISIBLE ATTIME OF SURVEY AND UTILITIES SHOULD BE LOCATED IF NECESSARY. BEARINGS AND COORDINATES ARE BASED ON COLORADO STATE PLANE AT BEARINGS AND COORDINATES ARE BASED ON COLDRADO STATE PLANE AT GROUND, CENTRAL ZONE, FROM GPS OBSERVATION. PROVIDED BEARINGS HAVE BEEN ROTATED CLOCKWISE 00°00'17" TO MATCH OBSERVED BEARINGS ALONG THE EAST LINE OF SECTION 15. FLOODPLAIN: PER THE FEMA FLOODPLAIN MAPS, THE SITE IS LOCATED IN AN AREA I. THE ATC LEASE AREA, ACCESS & UTILITY EASEMENT AND UTILITY ....END LEAGE AREA, ACCESS & UTILITY EASEMENT AND UTILITY EASEMENT LIE WHOLLY WITHIN THE PARENT PARCEL. NONE OF THE MONOPINE BRANCHES WERE OBSERVED TO REACH OUTSIDE THE ATC LEASE AREA/FENCED AREA. DESIGNATED AS ZONE X, AND IS NOT IN A SPECIAL FLOOD HAZARD AREA. COMMUNITY PANEL NUMBER: 08041C0950G ATED: 12/07/2018 BOUNDARY NOTE THIS SURVEY DOES NOT CONSTITUTE A BOUNDARY SURVEY OF THE PARENT VICINITY MAP TRACT. ANY PARENT TRACT PROPERTY LINES SHOWN HEREON ARE FROM SUPPLIED INFORMATION AND MAY NOT BE FIELD VERIFIED. ENCROACHMENT STATEMENT AT THE TIME OF THE SURVEY, THERE WAS VISIBLE EVIDENCE OF THE ZONING INFORMATION A THE ATC LEASE AREA AS PROVIDED DOES NOT PLOT IN THE LOCATION OF THE TOWER COMPOUND, WHICH WOULD BE REMEDIED BY THE ATC LEASE ZONED "A-5", AGRICULTURAL, PER EL PASO COUNTY ONLINE INFORMATION. FOR ADDITIONAL ZONING INFORMATION CONTACT: THE TOWER COMPOUND, WHICH WOULD BE REMEDIED BY THE ATC LEASE AREA AS SURVEYED LEGAL DESCRIPTION SHOWN HEREON. A PORTION OF WIRE FENCE (UNKNOWN OWNERSHIP) AND WIRE FENCE (LANDOWNER) LIES WITHIN THE ACCESSES & UTILITY EASEMENT AS SURVEYED AND UTILITY EASEMENT AS SURVEYED. EL PASO COUNTY PLANNING & COMMUNITY DEVELOPMEN 2880 INTERNATIONAL CIRCLE, SUITE 110 COLORADO SPRINGS, COLORADO 80910 **LEGAL DESCRIPTIONS** TITLE COMMITMENT LEGAL DESCRIPTION - PARENT PARCEL: THE REAL PROPERTY, TOGETHER WITH THE FIXTURES AND IMPROVEMENTS LOCATED THEREON, IF ANY, SITUATE, LYING AND BEING IN THE COUNTY OF EL PASO AND STATE OF COLORADO, DESCRIBED AS FOLLOWS: THE SOUTH HALF OF THE NORTHHEAST OLARTER AND THAT PORTION OF THE NORTHHEAST QUARTER OF THE SOUTHHEAST QUARTER OF SAID SECTION 15 THENCEN THE NORTHHEAST COURSE OF THE NORTHHEAST QUARTER OF THE SOUTHHEAST QUARTER OF SAID SECTION 15 THENCE SOUTH 11 DEGREES 25 MINUTES 40 SECONDS EAST ON AN ASSUMED BEARING ON THE NORTHH-SOUTH CENTERLINE OF SAID SECTION 474.00 FEET THENCE NORTHH 86 DEGREES 34 MINUTES 50 SECONDS WEST 153.05 ECONDS WEST 153.05 TO THE SOUTHHEAST QUARTER OF THE SOUTHEAST QUARTER OF THE SOUTHEAST QUARTER OF THE SOUTHEAST QUARTER OF THE SOUTHEAST QUARTER OF THE SOUTH SOUTHEAST QUARTER OF THE SOUTHEAST QUARTER OF THE SOUTHEAST QUARTER OF THE SOUTHEAST QUARTER OF THE SOUTH SOUT CENTER OF EXISTING MONOPINE LAT: 38'39'13.2"N LONG: 104'52'14.9"W GROUND ELEV: 6717.3' (AMSL) 5'X5' CONCRETE TOWER BASE 0.6'H —TOP OF STEEL TOWER HEIGHT AGL: 50.6' 20' UTILITY EASEMENT CENTER OF PROPOSED MONOPINE LAT: 38'39'13.0'N LONG: 104'52'15.0'N GROUND ELEY: 671.78' (AMS.) 5'X5' CONCRETE TOWER BASE 0.6'H TOP OF STEEL TOWER HEIGHT AGL: 50.6' TOP OF HIGHEST BRANCH AGL: 55.1' — <u>P.O.B.</u> UTILITY EASEMENT AS SURVEYED ATC LEASE AREA - AS PROVIDED (PER MEMORANDUM OF LEASE RECORDED 01/19/2016 AS INSTRUMENT NO 216004903); BEING A LEASE AREA WITHIN A PORTION OF THE SOUTHEAST QUARTER OF SECTION 15, TOWNSHIP 16 SOUTH, RANGE 67 WEST OF THE 6TH P.M., COUNTY OF -SEE COMPOUND DETAIL BEING A LEASE AREA WITHIN A PORTION OF THE SOUTHEAST QUARTER OF SECTION 15, TOWNSHIP 16 SOUTH, RANGE 67 WEST OF THE 6TH P.M., COUNTY LEASO, STATE OF COLORADO, BEING MORE PARTICULARILY DESCRIBED AS FOLLOWS: COMMENCING ATTHE SOUTHEAST CORNER OF SAID SECTION 15; THENCE ALONG THE EAST LINE OF SAID SECTION NO4*3808*W, 1706.72 FEET, THENCE SOUTHEAST CORNER OF SAID SECTION NO4*3808*W, 1706.72 FEET, THENCE SOUTHEAST CORNER OF SAID SECTION NO4*3808*W, 1706.72 FEET, THENCE CONTINUING SOUTH FOR THE POINT OF BEGINNING, THENCE SOUTH AS POINT THE TO A POINT HEREINAFTER REFERRED TO AS POINT "B", THENCE NOUTGOOD'S, 80.00 FEET, THENCE NOUTGOOD'S, 80.00 FEET, THENCE NOUTGOOD'S, 80.00 FEET, THENCE SOUTH OF SOUTH OF SOUTH SOUTH AS POINT "B", THENCE NOUTGOOD'S, 80.00 FEET, THENCE NOUTG 89*24'56"W 78.77 NVERT ELEV: 6717.3 ATC LEASE AREA - AS SURVEYED: A PARCEL OF LAND LOCATED WITHIN THE SOUTHEAST QUARTER (NE1/4 SE1/4) OF SECTION 15, TOWNSHIP 16 SOUTH, RANGE 67 WEST OF THE 6TH P.M., BEING

A PARCEL OF LAND LOCATED WITHIN THE SOUTHEAST QUARTER (NETHEOCENHOUS) CONTROLLING, TOTHESHIF TO GOOD, THE SOUTHEAST CORNER OF SAID SECTION 15, THENCE MAY 33'10'W, 2052 AE FEET TO THE SOUTHEAST CORNER OF THE PROPERTY DESCRIBED IN QUIT CLAM DEED DATED MAY 28, 2003 AND RECORDED JUNE 05, 2003 IN INSTRUMENT NO. 203123705, DEPICITED ON EL PASO COUNTY ASSESSOR'S MAP 76150 AS PARCEL 00-004; THENCE NOM'39557W ALONG THE EAST LINE OF SAID PROPERTY, 40.1.58 FEET; THENCE S87'32'15'W ALONG A LINE PERPENDICULAR TO SAID EAST LINE, 52.28 FEET TO THE POINT OF BEGINNING; THENCE S88'24'56'W, 59.76 FEET; THENCE NO0'08'11"E, 60.51 FEET; THENCE S88'592ZE, 59.76 FEET; THENCE S00'080'TW, 59.89 FEET TO THE POINT OF BEGINNING.
CONTAINING A TOTAL CALCULATED AREA OF 3,597.62 SQUARE FEET OR 0.083 ACRES, MORE OR LESS.

BEING A STRIP OF LAND 20.00 FEET IN WIDTH WITHIN A PORTION OF THE SOUTHEAST QUARTER OF SECTION 15, TOWNSHIP 16 SOUTH, RANGE 67 WEST OF THE 6TH P.M., COUNTY OF EL PASO, STATE OF COLORADO, LYING 10.00 FEET ON EACH SIDE OF THE FOLLOWING DESCRIBED CENTRELINE: COMMENCING AT POINT "B" AS DESCRIBED ABOVE; THENCE SOO"0000"W, 10.00 FEET TO THE POINT OF BEGINNING; THENCE SOO"0000"E, 78.43 FEET; THENCE SOO"0000"W, 10.00 FEET TO THE POINT OF BEGINNING; THENCE SOO"0000"E, 78.43 FEET; THENCE SOO"0000"W, 38.42 FEET TO THE NORTH RIGHT OF WAY LINE OF LITTLE TURKEY CREEK ROAD AND END DO JOS TRIPP OF LAND. SIDELINES OF SAID STRIPPS AND FIR POWER OF LAND ARE TO BE LENGTHENED AND/OR SHORTENED TO PREVENT GAPS AND/OR OVERLAPS. (THIS EASEMENT IS PROVIDED FOR INFORMATIONAL PURPOSES ONLY, BECAUSE IT COMMENCES AT A POINT IN THE PROVIDED, ERRONEOUS ATC LEASE AREA DESCRIPTION.)

ACCESS & UTILITY EASEMENT - AS SURVEYED:
A 20 FOOT WIDE STRIP OF LAND LOCATED WITHIN THE SOUTHEAST QUARTER (NE1/4 SE1/4) OF SECTION 15, TOWNSHIP 16 SOUTH, RANGE 67 WEST OF THE

AZD FOOT WILD STATE OF LINEAD SIZE OF THE FOLLOWING DESCRIBED CERTIFICATION OF THE STATE OF THE SOUTHEAST CORNER OF THE FOLLOWING DESCRIBED CENTER OF THE SOUTHEAST CORNER OF SAID SECRIBED OF THE SOUTHEAST CORNER OF SAID SECRIBED OF THE SOUTHEAST CORNER OF SAID SECRIBED OF THE SOUTHEAST CORNER OF THE POPERTY DESCRIBED OF THE SOUTHEAST CORNER OF THE POPERTY DESCRIBED OF THE SOUTHEAST CORNER OF THE POPERTY OF THE SOUTHEAST CORNER OF THE SOUTHEAST CORNER OF THE POPERTY OF THE SOUTHEAST CORNER OF THE SOUTHEAST

POINT OF TERMINUS.
CONTAINING A TOTAL CALCULATED AREA OF 9,015.34 SQUARE FEET OR 0.207 ACRES, MORE OR LESS.
(NOTE: DOCUMENTATION WAS NOT PROVIDED TO DETERMINE RIGHT-OF-WAY WIDTH FOR LITTLE TURKEY CREEK ROAD; THEREFORE, THE EASEMENT IS
WRITTEN TO BEGIN AT THE EDGE OF THE EXISTING ROAD. LITTLE TURKEY CREEK ROAD IS DEPORTED AS PUBLIC RIGHT-OF-WAY ON AN UNRECORDED SC PERFORMED BY JESUS A. LUGO, DATED 2012.)

UTILITY EASEMENT - AS PROVIDED (PER AN UNRECORDED FIRST AMENDMENT TO LAND LEASE AGREEMENT DATED FEBRUARY 12, 2012);
BEING TWO STRIPS OF LAND 10.00 FEET IN WIDTH WITHIN A PORTION OF THE SOUTHEAST QUARTER OF SECTION 15, TOWNSHIP 16 SOUTH, RANGE 67 WEST

(STRIP ONE)
BEGINNING AT POINT "A" AS DESCRIBED ABOVE; THENCE (ILLEGIBLE), 23.43 FEET; THENCE 800"00"00"W, 416.92 FEET TO A POINT HEREINAFTER REFERRED TO AS POINT "C"; THENCE CONTINUING 800"00"00"W, 14.23 FEET TO THE END OF SAID STRIP OF LAND.

BEGINNING AT POINT "C" AS DESCRIBED ABOVE; THENCE S89°35'35"E, 50.84 FEET TO THE END OF SAID STRIP OF LAND. (NOTE: THIS LEGAL DESCRIPTION IS PROVIDED ON A SURVEY ATTACHED TO THE REFERENCED AGREEMENT, AND IS A POOR COPY. THIS RENDITION MAY CONTAIN ERRORS, AND IS DEPENDENT ON THE PREVIOUS PROVIDED ATC LEASE AREA AND ACCESS EASEMENT DESCRIPTIONS.)


UTILITY EASEMENT - AS SURVEYED:
A 20 FOOT WIDE STRIP OF LAND LOCATED WITHIN THE SOUTHEAST QUARTER (NE1/4 SE1/4) OF SECTION 15, TOWNSHIP 16 SOUTH, RANGE 67 WEST OF THE

AZD FOOT WILE STOR FOR HACH SIDE OF THE FOLLOWING DESCRIBED CENTERLINE:

COMMENCING TO FEET ON EACH SIDE OF THE FOLLOWING DESCRIBED CENTERLINE:

COMMENCING AT THE SOUTHEAST CORNER OF SAID SECTION 15, THENCE MS'35, 2003 AND SECTION 15, ALONG THE SOUTH LINE OF A SECTION 15, ALONG THE SOUT

00°08'01"E, 59.77 FEET TO THE POINT OF TERMINUS. ONTAINING A TOTAL CALCULATED AREA OF 1,195.37 SQUARE FEET OR 0.027 ACRES, MORE OR LESS.

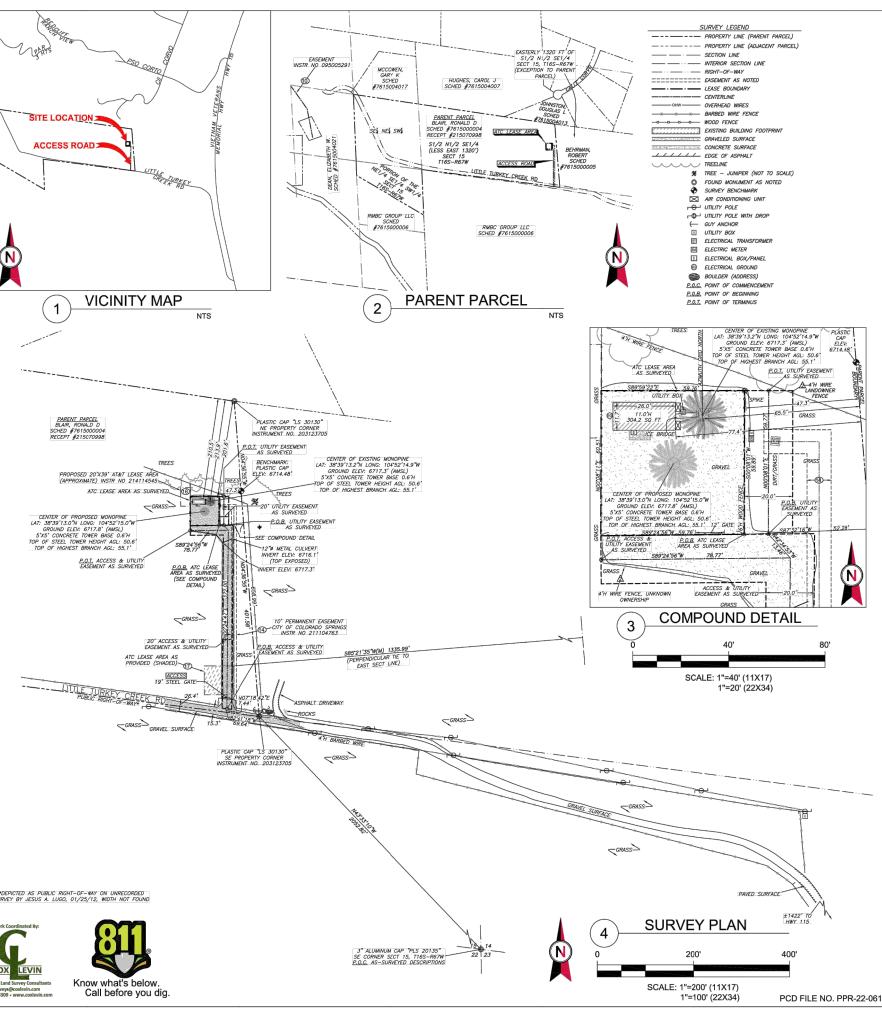



ATC TOWER SERVICES, INC.

3500 REGENCY PARKWAY SUITE 100 CARY, NC 27518 PHONE: (919) 468-0112 FAX: (919) 466-5415

THESE DRAWINGS AND/OR THE ACCOMPANYING SPECIFICATION AS INSTRUMENTS OR SERVICE ARE THE EXCLUSIVE PROPERTY OF AMERICAN TOWER. THEIR USE AND EXCLUSIVE PROPERTY OF AMERICAN TOWER. THEIR USE AND PUBLICATION SHALL BE RESTRICTED TO THE ORIGINAL SITE FOR WHICH THEY ARE PREPARED, ANY USE OR DISCLOSURE OTHER THAN THAT WHICH RELATES TO AMERICAN TOWER OR THE SPECIFIED CARRIER IS STRICTLY PROHIBITED. TITLE TO THESE DOCUMENTS SHALL REMAIN THE PROPERTY OF AMERICAN TOWER WHETHER OR NOT THE PROJECT IS EXECUTED. NEITHER THE ARCHITECT NOR THE ENGINEER WILL BE PROVIDING ON-SITE CONSTRUCTION REVIEW OF THIS PROJECT, CONTRACTOR(S) MUST VERIFY ALL DIMENSIONS AND ADVISE AMERICAN TOWER OF ANY DISCREPANCIES. ANY PRIOR ISSUANCE OF THIS DRAWING IS SUPERSEDED BY THE LATEST VERSION ON FILE WITH AMERICAN TOWER.

	<i>∕</i> 6\	PRELIM	нн	09/19/2022
	1	TITLE	НН	03/06/2023
	2			

ATC SITE NUMBER:

211173

(LEGACY 419522)

ATC SITE NAME:

## **REBUILD TURKEY CREEK CO**

SITE ADDRESS:

2945 LITTLE TURKEY CREEK RD COLORADO SPRINGS, COLORADO 80926-9615

THIS IS TO CERTIFY THAT ARROW SURVEY GROUP, INC., AT THE REQUEST AND FOR THE EXCLUSIVE USE OF AMERICAN TOWER CORP., HAS PERFORMED THIS AS-BUILT SURVEY OF THE ATC LEASE AREA, FROM THE RECORD SOURCES AND ACTUAL FIELD SURVEY ON 09/08/2022 IN ACCORDANCE WITH THE MINIMUM STANDARDS OF PROPERTY BOUNDARY SURVEYS. ALL LINEAR AND ANGULAR VALUES SHOWN ARE BASED UPON DEED OR RECORD INFORMATION UNLESS OTHERWISE NOTED.

DATE OF PLAT: 03/06/2023

JASON D. LEVANEN CO LICENSE NO. 38159




SURVEY PREPARED BY:



DRAWN BY:	нн
APPROVED BY:	JL
DATE DRAWN:	03/06/2023
ATC JOB NO:	419522

# AS-BUILT/TITLE & **BOUNDARY PLAN**

SHEET NUMBER V-101

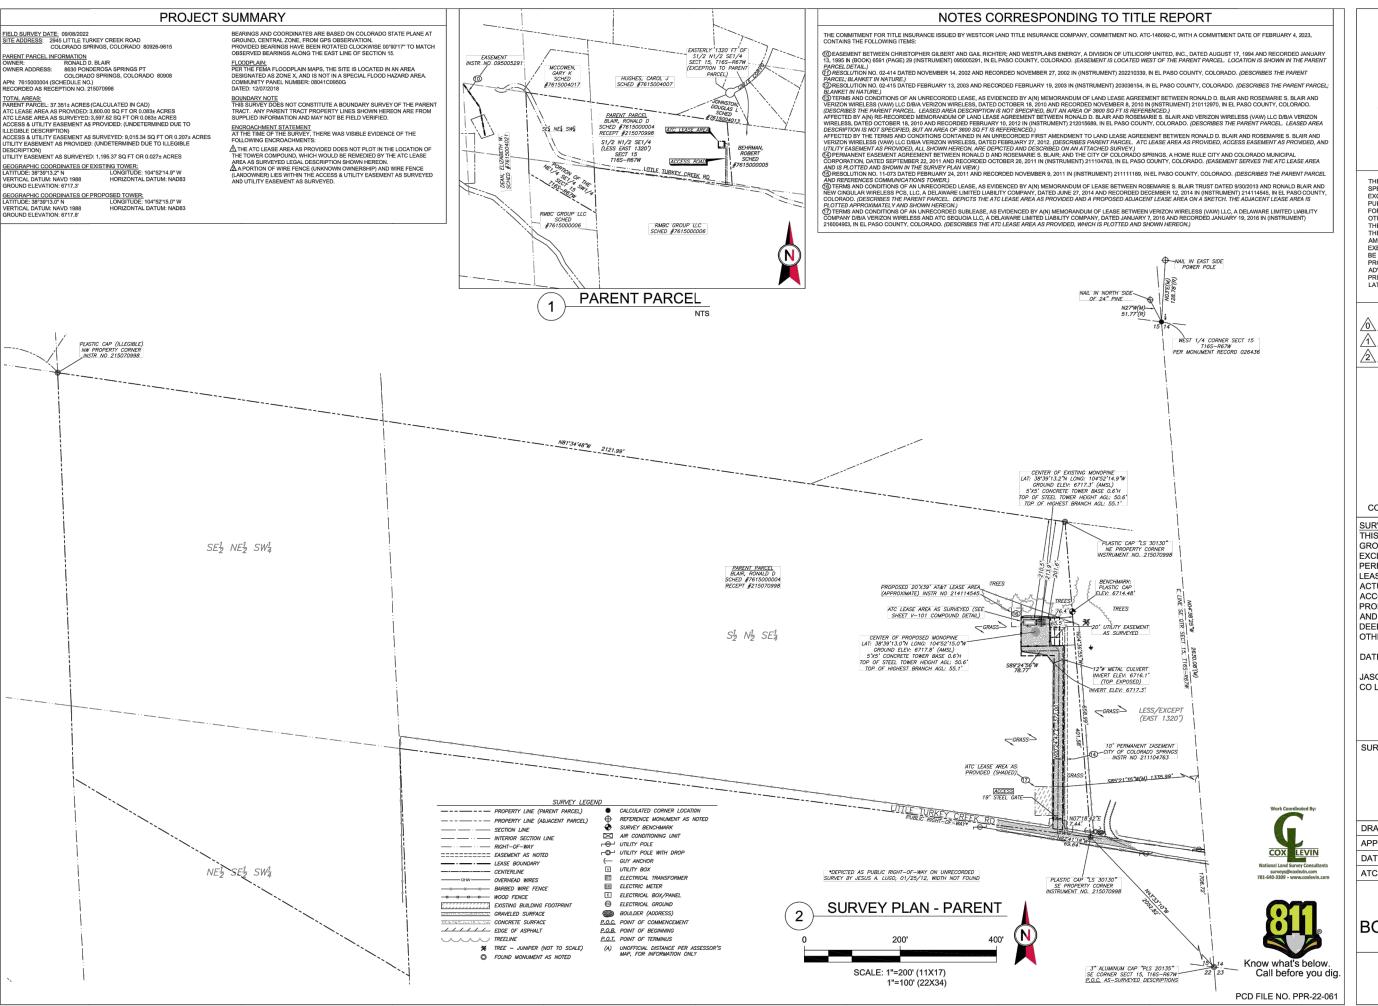



AMERICAN TOWER
ATC TOWER SERVICES, INC.

3500 REGENCY PARKWAY SUITE 100 CARY, NC 27518 PHONE: (919) 468-0112 FAX: (919) 466-5415

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	$\wedge$	PRELIM	нн	09/19/2022
	1	TITLE	НН	03/06/2023
	2			

ATC SITE NUMBER:

211173

(LEGACY 419522)

ATC SITE NAME:

## REBUILD TURKEY CREEK CO

SITE ADDRESS:

2945 LITTLE TURKEY CREEK RD COLORADO SPRINGS, COLORADO 80926-9615

#### SURVEY CERTIFICATE:

THIS IS TO CERTIFY THAT ARROW SURVEY GROUP, INC., AT THE REQUEST AND FOR THE EXCLUSIVE USE OF AMERICAN TOWER CORP., HAS PERFORMED THIS AS-BUILT SURVEY OF THE ATC LEASE AREA, FROM THE RECORD SOURCES AND ACTUAL FIELD SURVEY ON 09/08/2022 IN ACCORDANCE WITH THE MINIMUM STANDARDS OF PROPERTY BOUNDARY SURVEYS. ALL LINEAR AND ANGULAR VALUES SHOWN ARE BASED UPON DEED OR RECORD INFORMATION UNLESS OTHERWISE NOTED.

DATE OF PLAT: 03/06/2023

JASON D. LEVANEN CO LICENSE NO. 38159



SURVEY PREPARED BY:




	DRAWN BY:	нн
	APPROVED BY:	JL
	DATE DRAWN:	03/06/2023
	ATC JOB NO:	419522

# PARENT PARCEL BOUNDARY PLAN & TITLE

SHEET NUMBER:

V-101

1

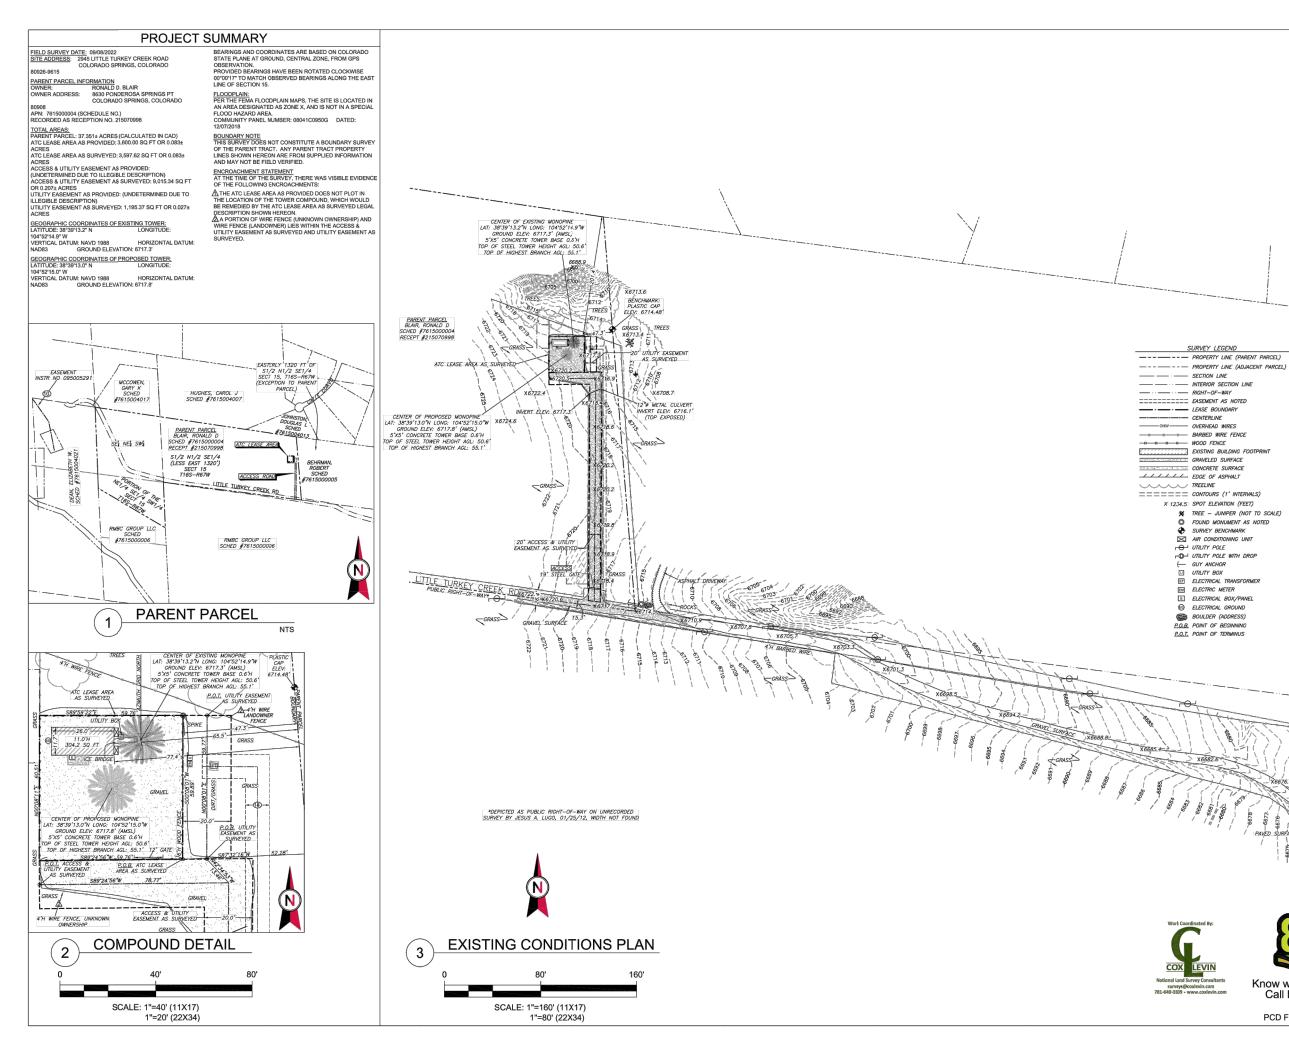



# AMERICAN TOWER ATC TOWER SERVICES, INC.

3500 REGENCY PARKWAY SUITE 100 CARY, NC 27518 PHONE: (919) 468-0112 FAX: (919) 466-5415

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<u> </u>	PRELIM		09/19/2022
1	TITLE	НН	03/06/2023
2			

ATC SITE NUMBER:

211173

(LEGACY 419522)

ATC SITE NAME:

## REBUILD TURKEY CREEK CO

SITE ADDRESS:

2945 LITTLE TURKEY CREEK RD COLORADO SPRINGS, COLORADO 80926-9615

#### RVEY CERTIFICATE

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DATE OF PLAT: 03/06/2023

JASON D. LEVANEN CO LICENSE NO. 38159



SURVEY PREPARED BY:



DRAWN BY:	нн
APPROVED BY:	JL
DATE DRAWN:	03/06/2023
ATC JOB NO:	419522

# EXISTING CONDITIONS AND TOPOGRAPHIC PLAN

SHEET NUMBER:

Know what's below.
Call before you dig.

PCD FILE NO. PPR-22-061

V-103





3500 REGENCY PARKWAY SUITE 100 CARY, NC 27518 PHONE: (919) 468-0112

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REV.	. DESCRIPTION	BY	DATE
<u></u>	FOR CONSTRUCTION	AB	04/26/23
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ATC SITE NUMBER:

211173

ATC SITE NAME:

# REBUILD TURKEY CREEK CO

SITE ADDRESS: 2945 LITTLE TURKEY CREEK RD COLORADO SPRINGS, CO 80926

SEAL



DATE DRAWN:	04/26/23
ATC JOB NO:	14141546_D4
OPS JOB NO:	13734361
ATC LEGACY #:	419522

**OVERALL SITE PLAN** 


SHEET NUMBER:

REVISION:

C-101

# LEGEND

	EXISTING PROPERTY
	EXISTING ADJ. PROPERTY
	EXISTING EASEMENT
— — XXX— —	EXISTING CONTOUR (MAJOR
	EXISTING CONTOUR (MINOR,
~~~~~~	EXISTING TREELINE
x x	EXISTING CHAINLINK FENCE
	EXISTING BUILDING
SDSD	EXISTING STORM DRAIN
	EXISTING ROAD (DIRT)
	EXISTING ROAD (STONE)
	EXISTING ROAD (PAVED)
	EXISTING CONCRETE
	EXISTING LEASE AREA
OHW OHW	EXISTING OVERHEAD WIRE
	EXISTING UTILITY POLE

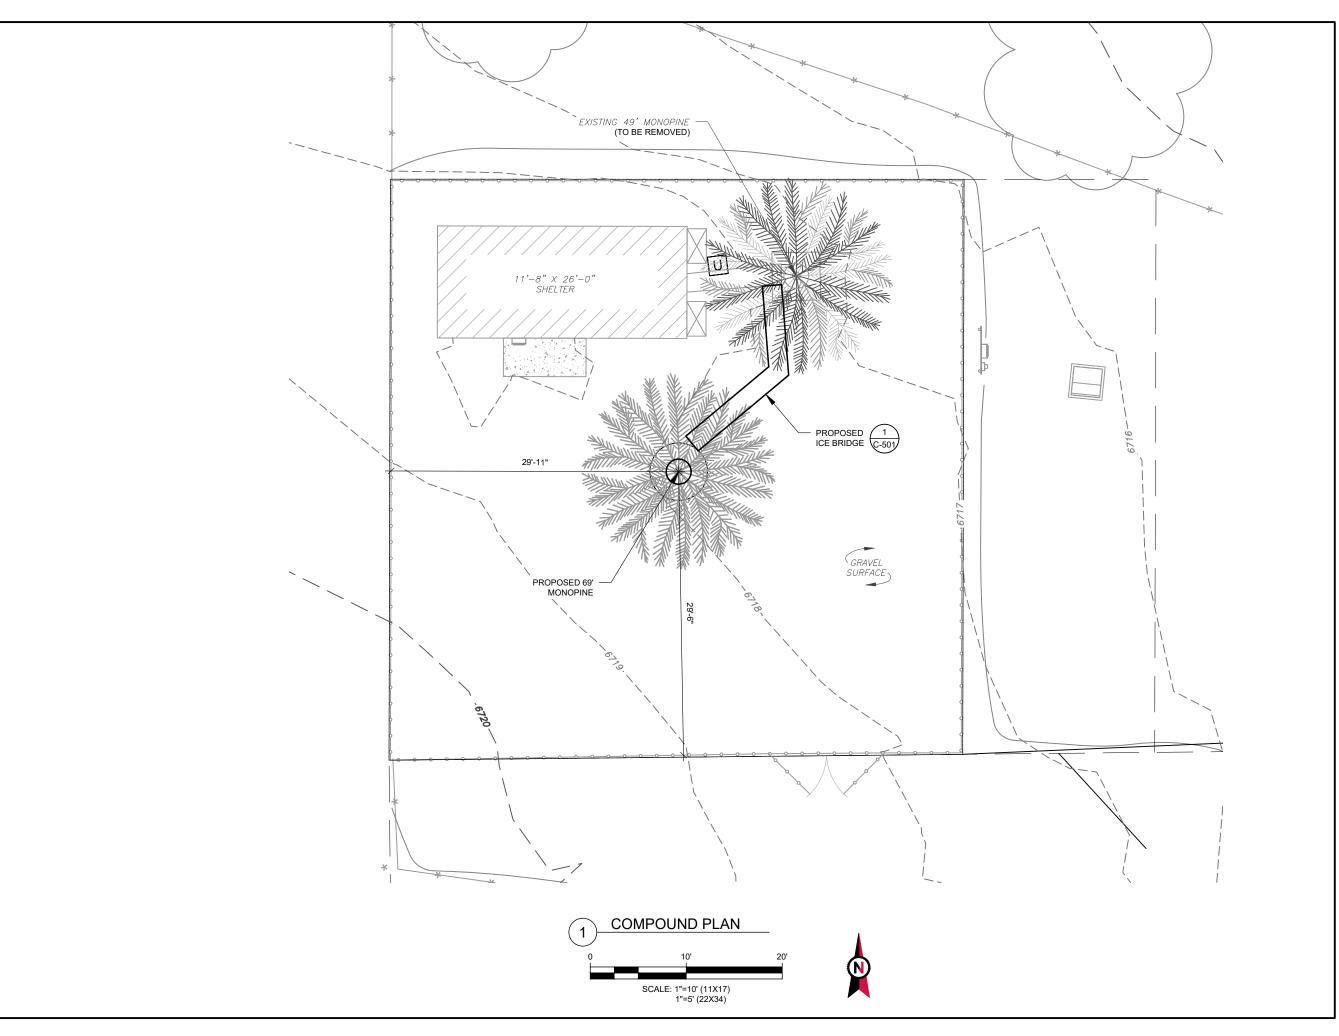



3500 REGENCY PARKWAY SUITE 100 CARY, NC 27518 PHONE: (919) 468-0112

THESE DRAWINGS AND/OR THE ACCOMPANYING SPECIFICATION AS INSTRUMENTS OR SERVICE ARE THE EXCLUSIVE PROPERTY OF AMERICAN TOWER. THEIR USE AND PUBLICATION SHALL BE RESTRICTED TO THE ORIGINAL SITE FOR WHICH THEY ARE PREPARED. ANY USE OR DISCLOSURE OTHER THAN THAT WHICH RELATES TO AMERICAN TOWER OR THE SPECIFIED CARRIER IS STRICTLY PROHIBITED. TITLE TO THESE DOCUMENTS SHALL REMAIN THE PROPERTY OF AMERICAN TOWER WHETHER OR NOT THE PROJECT IS EXECUTED. RETHER THE ARCHITECT NOR THE ENGINEER WILL BE PROVIDING ON-SITE CONSTRUCTION REVIEW OF THIS PROJECT. CONTRACTOR(S) MUST VERIFY ALL DIMENSIONS AND ADVISE AMERICAN TOWER OF ANY DISCREPANCIES. ANY PRIOR ISSUANCE OF THIS DRAWING IS SUPERSEDED BY THE LATEST VERSION ON FILE WITH AMERICAN TOWER.

REV.	DESCRIPTION	BY	DATE
△_	FOR CONSTRUCTION	_AB_	04/26/23
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ATC SITE NUMBER:

211173

ATC SITE NAME:

REBUILD TURKEY CREEK CO

SITE ADDRESS: 2945 LITTLE TURKEY CREEK RD COLORADO SPRINGS, CO 80926



	DATE DRAWN:	04/26/23
	ATC JOB NO:	14141546_D4
	OPS JOB NO:	13734361
	ATC LEGACY #:	419522

COMPOUND PLAN

SHEET NUMBER:


REVISION: C-401

TOWER NOTE:

EXISTING GRADE ELEV 6717.9' AMSL

ELEV O' A.G.L.

- NO TOWER LIGHTING IS PROPOSED.
 TO BE CONFIRMED BY FAA/FCC. SEE
 SHEET E-502 FOR DETAIL.
- CARRIER LOADING SHOWN IS FOR ILLUSTRATIVE PURPOSES ONLY AND MAY NOT REPRESENT ACTUAL FINAL LOADING. PLEASE REFER TO THE LATEST RFDS OR APPLICATION FOR CONFIRMATION.
- PROPOSED TREE SHOWN
 CONCEPTUALLY. REFER TO THE
 TOWER MANUFACTURER DRAWINGS
 FOR ACTUAL BRANCH
 COUNT/LOCATION AND FOLIAGE
 DENSITY.

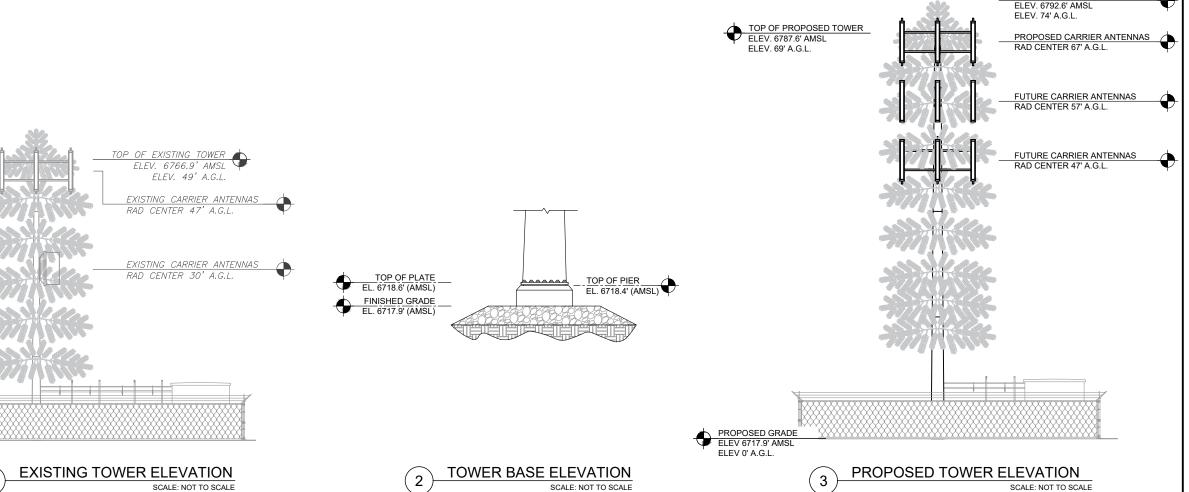



3500 REGENCY PARKWAY SUITE 100 CARY, NC 27518 PHONE: (919) 468-0112

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REV.	DESCRIPTION	BY	DATE
\triangle_{-}	FOR CONSTRUCTION	AB	04/26/23
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ATC SITE NUMBER:

211173

ATC SITE NAME:

REBUILD TURKEY CREEK CO

SITE ADDRESS: 2945 LITTLE TURKEY CREEK RD COLORADO SPRINGS. CO 80926

SEAL

PROPOSED TOP OF BRANCHES



DATE DRAWN:	04/26/23
ATC JOB NO:	14141546_D4
OPS JOB NO:	13734361
ATC LEGACY #:	419522


TOWER ELEVATION

SHEET NUMBER:

C-402

CONSTRUCTION NOTE:

- WHERE POSSIBLE AND AS APPLICABLE, THE CONTRACTOR SHALL UTILIZE EXISTING ICE BRIDGE, CABLE LADDER, COAX SUPPORTS, AND COAX PORTS. BEFORE UTILIZING, CONTRACTOR SHALL VERIFY THAT ALL ASPECTS OF THE COMPONENTS MEET THE ATC SPECIFICATIONS. CONTRACTOR SHALL COORDINATE THE INSTALLATION OF NEW ICE BRIDGE, CABLE LADDER, COAX SUPPORT, AND COAX PORT, AS REQUIRED, WITH THE ATC CONSTRUCTION MANAGER.
- INSTALL ICE BRIDGE TO ALLOW 7 FEET CLEARANCE ABOVE GRADE TO LOWEST

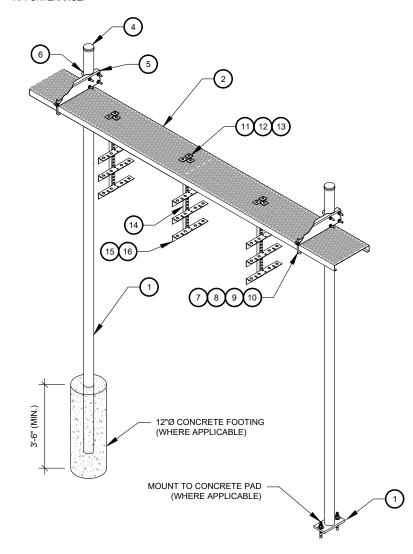

WB-	WB-K210-B WAVEGUIDE BRIDGE KIT - BILL OF MATERIALS (INCLUDED WITH KIT UNLESS NOTED OTHERWISE)				
ITEM	PART NUMBER	DESCRIPTION	ITEM	PART NUMBER	DESCRIPTION
1	MF126.01 MF-130	10'-4" COLUMN & BASE SHOE* 13'-4" PIPE COLUMN	9	GWL-04	1/2" GALV LOCK WASHER
2	WB-CY210	SAFETY GRATING 24" X 10'	10	GN-04	1/2" GALV HEX NUT
3	WBK110BHK	HARDWARE KIT (ITEMS 4-16)	11	GB-03205	3/8" X 2" GALV BOLT KIT
4	PC-034	PIPE CAP 3-1/2"	12	MT-387	SQUARE WASHER, 1-1/2" X 1-1/2" W/ 7/16" HOLE
5	WBLB243.08	24" WAVEGUIDE BRIDGE SUPPORT BRACKET	13	GWF-03	3/8" GALV FLAT WASHER
6	GUB-4356	1/2" X 3-5/8" X 6" GALV U-BOLT	14	WBT243.01	VERTICAL TRAPEZE SECTION
7	WB-JB-6	1/2" J-BOLT	15	GB-03105	3/8" X 1" GALV BOLT KIT
8	GWF-04	1/2" GALV FLAT WASHER	16	WBT243.02	HORIZONTAL TRAPEZE SECTION

CONTRACTOR SHALL USE PARTS MANUFACTURED BY COMMSCOPE OR APPROVED EQUIVALENT. *BASE SHOE NOT INCLUDED IN WB-K210-B KIT, ORDER COLUMN SEPARATELY OR KIT WB-K210-S.



24" WAVEGUIDE BRIDGE KIT

SCALE: NOT TO SCALE



3500 REGENCY PARKWAY SUITE 100 **CARY, NC 27518** PHONE: (919) 468-0112

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DESCRIPTION	BY	DATE
FOR CONSTRUCTION	_AB_	04/26/23

ATC SITE NUMBER:

211173

ATC SITE NAME:

REBUILD TURKEY CREEK CO

SITE ADDRESS: 2945 LITTLE TURKEY CREEK RD COLORADO SPRINGS, CO 80926



DATE DRAWN:	04/26/23
ATC JOB NO:	14141546_D4
OPS JOB NO:	13734361
ATC LEGACY #:	419522

CONSTRUCTION **DETAILS**

SHEET NUMBER:

C-501





Beyond this point: Radio frequency fields at this site may exceed FCC rules for human exposure.

For your safety, obey all posted signs and site guidelines for working in radio frequency environments.

In accordance with Federal Communications on rules on radio frequency emissions 47 CFR 1.1307(b)

NO TRESPASSING

ATC CAUTION AND NO TRESPASSING SIGN






Beyond this point: Radio frequency fields at this site may exceed FCC rules for human exposure.

For your safety, obey all posted signs and site guidelines for working in radio frequency environments.

In accordance with Federal Communications sion rules on radio frequency emissions 47 CFR 1.1307(b)

ATC RF WARNING AND FCC NUMBER SIGN

A "NO TRESPASSING" SIGN MUST BE POSTED A MINIMUM OF EVERY 50'

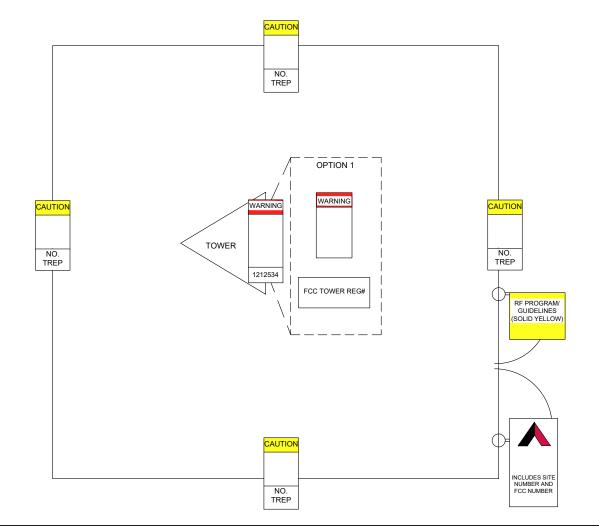

FCC TOWER REGISTRATION

Posting of sign required by law

THERE MUST BE AN ATC SIGN WITH SITE INFORMATION AND FCC REGISTRATION

NUMBER AT BOTH THE ACCESS ROAD GATE (GATE OFF OF MAIN ROAD, IF APPLICABLE)

AND COMPOUND FENCE (IF NO COMPOUND

UPON DRIVE UP). IN ADDITION, PLEASE LOOK

FENCE, THEN IN A CONSPICUOUS PLACE

AT DIAGRAM FOR ALL ADDITIONAL SIGNS

OPTION 1 MAY BE USED TO POST TOWER

REGISTRATION NUMBERS AT THE BASE OF THE TOWER IF A WARNING SIGN DOES NOT

HAVE SPACE FOR THE TOWER REGISTRATION

IMPORTANT: FOR ANY ATC SIGN THAT DOES

NOT MEET THE ATC SPECIFICATION FOR

(RE-WRITE IF WORN) AND FLAG FOR

THROUGH THE WAREHOUSE)

PRINTER WILL BE ACCEPTED.

SIGNAGE (I.E., SHARPIE/PAINT PEN, WORN LABELS, ETC.), BRING IT INTO COMPLIANCE

REPLACEMENT ASAP WITH THE APPROPRIATE

PERMANENT SIGN (YOU CAN ORDER THESE

ONLY LABELS PRINTED BY A ZEBRA LABEL

ATC STAND-ALONE FCC TOWER

⚠ NOTICE ⚠

GUIDELINES FOR WORKING IN RADIOFREQUENCY ENVIRONMENTS

- All personnel should have electromagnetic energy (EME) awareness training.
- All personnel entering this site must be authorized.
- A Obey all posted signs.
- Assume all antennas are active.
- A Before working on antennas, notify owners and disable appropriate
- A Maintain minimum 3 feet clearance from all antennas.
- A Do not stop in front of antennas.
- A Never operate transmitters without shields during normal operation.
- A Do not operate base station antennas in equipment room.

ATC RF PROGRAM NOTICE SIGN



SITE NAME:

REBUILD TURKEY CREEK CO

SITE NUMBER: FCC REGISTRATION #:

FOR LEASING INFORMATION:

FOR EMERGENCIES CALL:

877-282-7483 877-ATC-SITE

877-518-6937 877-51-TOWER

NO TRESPASSING

www.americantower.com

211173

POSTING OF THIS SIGNAGE REQUIRED BY LAW

ATC SITE SIGN

REPLACEMENT OF SIGNAGE:

AS SIGNAGE BECOMES STOLEN, DAMAGED, BRITTLE OR FADED, IT SHOULD BE REPLACED WITH SIGNAGE PER THIS SPECIFICATION, ANY ACQUIRED SITE SHOULD HAVE NEW SIGNS POSTED WITHIN 60 DAYS UNLESS OTHERWISE SPECIFIED. ANY SITE SOLD SHOULD HAVE THE ATC SIGNS REMOVED WITHIN 30 DAYS UNLESS OTHERWISE SPECIFIED. ALL FCC OR REGULATORY SIGNAGE MUST BE INSTALLED OR REPLACED AS REQUIRED TO MEET OUR STANDARD. SIGNS SHOULD BE REPLACED ON NORMAL, QUARTERLY MAINTENANCE VISITS BY CONTRACTORS OR SITE MANAGERS, UNLESS OTHERWISE REQUIRED ON A CASE-BY-CASE BASIS

NOTE:

EXTERIOR SIGNS ARE NOT PROPOSED EXCEPT AS REQUIRED BY THE FCC. ALL EXISTING SIGNAGE AND ANY FUTURE SIGNAGE WILL BE COMPLIANT WITH STATUTE 164-43 4 NO HIGH-VOLTAGE SIGNAGE IS NECESSARY NO HIGH-VOLTAGE FOUIPMENT PRESENT



ATC TOWER SERVICES, LLC 3500 REGENCY PARKWAY SUITE 100 **CARY, NC 27518** PHONE: (919) 468-0112

THESE DRAWINGS AND/OR THE ACCOMPANYING THESE DRAWINGS AND/OR THE ACCOMPANYING SPECIFICATION AS INSTRUMENTS OR SERVICE ARE THE EXCLUSIVE PROPERTY OF AMERICAN TOWER. THEIR USE AND PUBLICATION SHALL BE RESTRICTED TO THE ORIGINAL SITE FOR WHICH THEY ARE PREPARED. ANY USE OR DISCLOSURE OTHER THAN THAT WHICH RELATES TO AMERICAN TOWER OR THE SPECIFIED CARRIER IS STRICTLY PROHIBITED. TITLE TO THESE DOCUMENTS SHALL REMAIN THE PROPERTY OF AMERICAN TOWER WHETHER DRAW OF NOT THE PROJECT IS STRICTLY PROHIBITED. THE SECOND THE PROJECT IS MALERICAN TOWER WHETHER OR NOT THE PROJECT IS STRICTLY PROHIBITED. AMERICAN TOWER WHE HER OR NOT THE PROJECT IS EXECUTED. NEITHER THE ARCHITECT NOR THE ENGINEER WILL BE PROVIDING ON-SITE CONSTRUCTION REVIEW OF THIS PROJECT. CONTRACTORS) MUST VERIEY ALL DIMENSIONS AND ADVISE AMERICAN TOWER OF ANY DISCREPANCIES. ANY PRIOR ISSUANCE OF THIS DRAWING IS SUPERSEDED BY THE LATEST VERSION ON FILE WITH AMERICAN TOWER.

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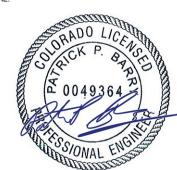
ATC SITE NUMBER:

211173

ATC SITE NAME:

REBUILD TURKEY CREEK CO

SITE ADDRESS: 2945 LITTLE TURKEY CREEK RD COLORADO SPRINGS, CO 80926




ATE DRAWN:	04/26/23
TC JOB NO:	14141546_D4
PS JOB NO:	13734361
TC LEGACY #:	419522

SIGNAGE

SHEET NUMBER:

C-502

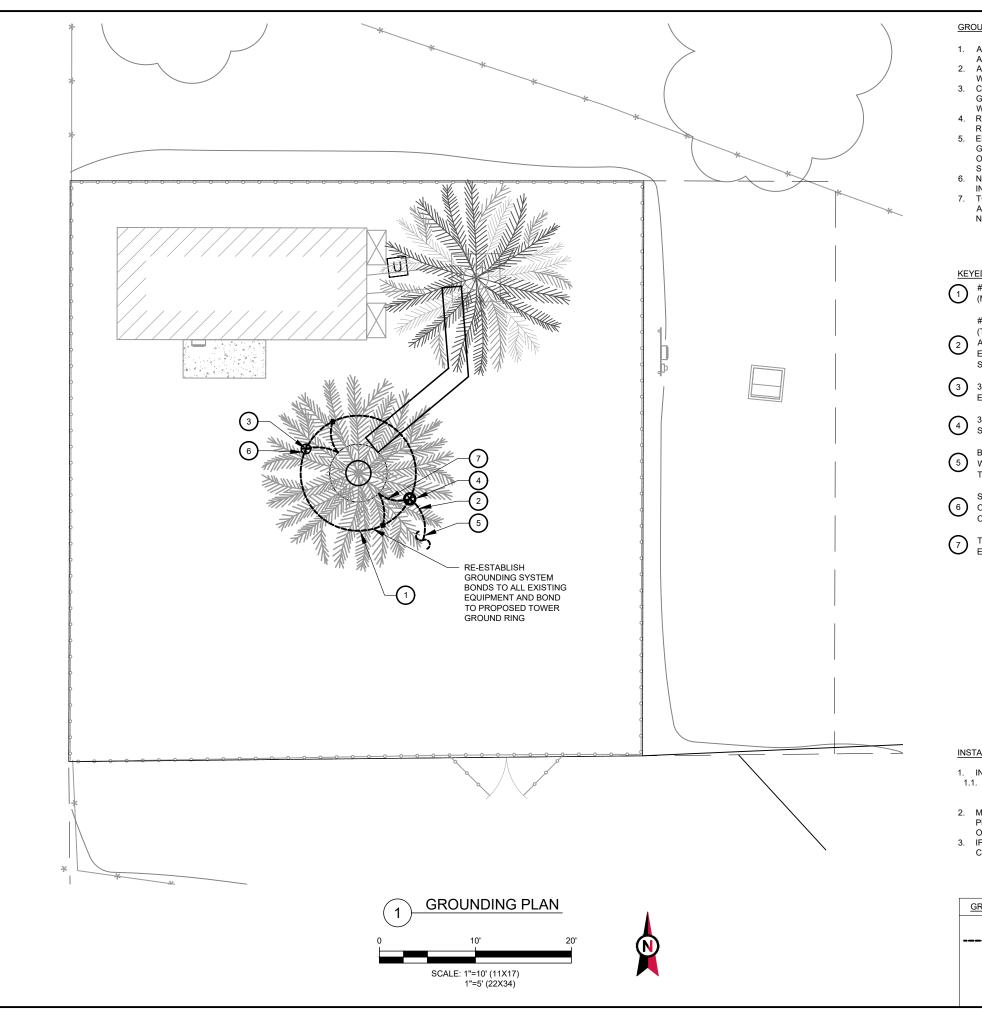

GROUNDING PLAN NOTES:

- ALL DETAILS ARE SHOWN IN GENERAL TERMS. ACTUAL INSTALLATION AND CONSTRUCTION MAY VARY DUE TO SITE SPECIFIC CONDITIONS.
- 2. ALL GROUND CONNECTIONS SHALL BE EXOTHERMIC WELDED. ALL
- WIRES SHALL BE COPPER.

 3. CONTRACTOR TO VERIFY AND TEST GROUND TO SOURCE.
 GROUNDING AND OTHER OPERATIONAL TESTING WILL BE
 WITNESSED BY OWNER REPRESENTATIVE.
 - REFER TO ATC CONSTRUCTION SPEC AND COMPLY WITH ALL REQUIREMENTS OF GROUNDING STANDARDS.
- ELECTRICAL CONTRACTOR TO PROVIDE DETAILED DESIGN OF GROUNDING SYSTEM, AND RECEIVE APPROVAL OF DESIGN BY OWNER REPRESENTATIVE, PRIOR TO INSTALLATION OF GROUNDING SYSTEM. PHOTO DOCUMENT ALL CONNECTIONS AND GROUND RING
- 5. NOTIFY CONSTRUCTION MANAGER IF THERE ARE ANY DIFFICULTIES INSTALLING GROUNDING SYSTEM DUE TO SITE SOIL CONDITIONS.
- . TO AVOID TOWER FOUNDATION, GROUND RODS MAY BE INSTALLED AT AN ANGLE OR TOWER GROUND RING MAY BE EXTENDED AS NEEDED.

KEYED NOTES:

- #2 AWG SBTC TOWER GROUND RING.
 (MIN 2 FT FROM FOUNDATION)
- #2 AWG SBTC TOWER RING RADIALS. GROUNDING RADIAL
 (TYP.) SEE TRENCH DETAIL 4 ON SHEET E-501. MAINTAIN DEPTH
 AND MINIMUM 15 FT. SEPARATION FROM OTHER RADIALS AT
 ENDS AND MINIMUM 5 FT. SEPARATION AT GROUNDING
 SYSTEMS AND BUILDING FOUNDATIONS.
- 3 3/40" X 10 FT GROUND ROD (TYP). SEE DETAIL 2 ON SHEET E-501
- 3/4Ø" X 10 FT GROUND ROD WITH TEST WELL (MIN. ONE PER SITE ON TOWER GROUND RING). SEE DETAIL 5 ON SHEET E-501.
- 5 BOND TO ELECTRICAL SERVICE AT MAIN BONDING JUMPER WITH #2 AWG SBTC. PARALLEL CONNECTION AWAY FROM TOWER. SEE DETAIL 1 ON SHEET E-501.
- SERVICE GROUND ROD SIZE MINIMUM PER NEC OR AS OTHERWISE INDICATED. PLACE MINIMUM OF 10' FROM ALL OTHER GROUND RODS.
- 7 TOWER TO GROUND RING BONDS. SEE DETAIL 3 ON SHEET E-501.

INSTALLATION NOTES:

- INSTALL STANDARD LEVEL I DESIGN (BASE BID) WHICH INCLUDES:
 TOWER RING, 1 GROUND ROD PER LEG, SERVICE GROUND ROD AT H-FRAME, RADIALS TO H-FRAME. ADDITIONAL WORK NECESSARY BELOW SHALL BE CONSIDERED AN ALLOWANCE.
- MEASURE GROUNDING SYSTEM RESISTANCE WITH A 3-PROBE TEST PRIOR TO BACKFILL/DEMOBILIZATION AND PRIOR TO CONNECTION OF UTILITY POWER NEUTRAL TO THE SYSTEM.
- 3. IF GROUNDING SYSTEM RESISTANCE IS GREATER THAN 10 OHMS COORDINATE WITH ATC ENGINEER OF RECORD.

GROUNDING PLAN LEGEND:

MECHANICAL WELD

---- GROUND WIRE

 \otimes

COPPER GROUND ROD

EXOTHERMIC WELD

(X) TEST WELL

AMERICAN TOWER®

ATC TOWER SERVICES, LLC

3500 REGENCY PARKWAY

SUITE 100

CARY, NC 27518

PHONE: (919) 468-0112

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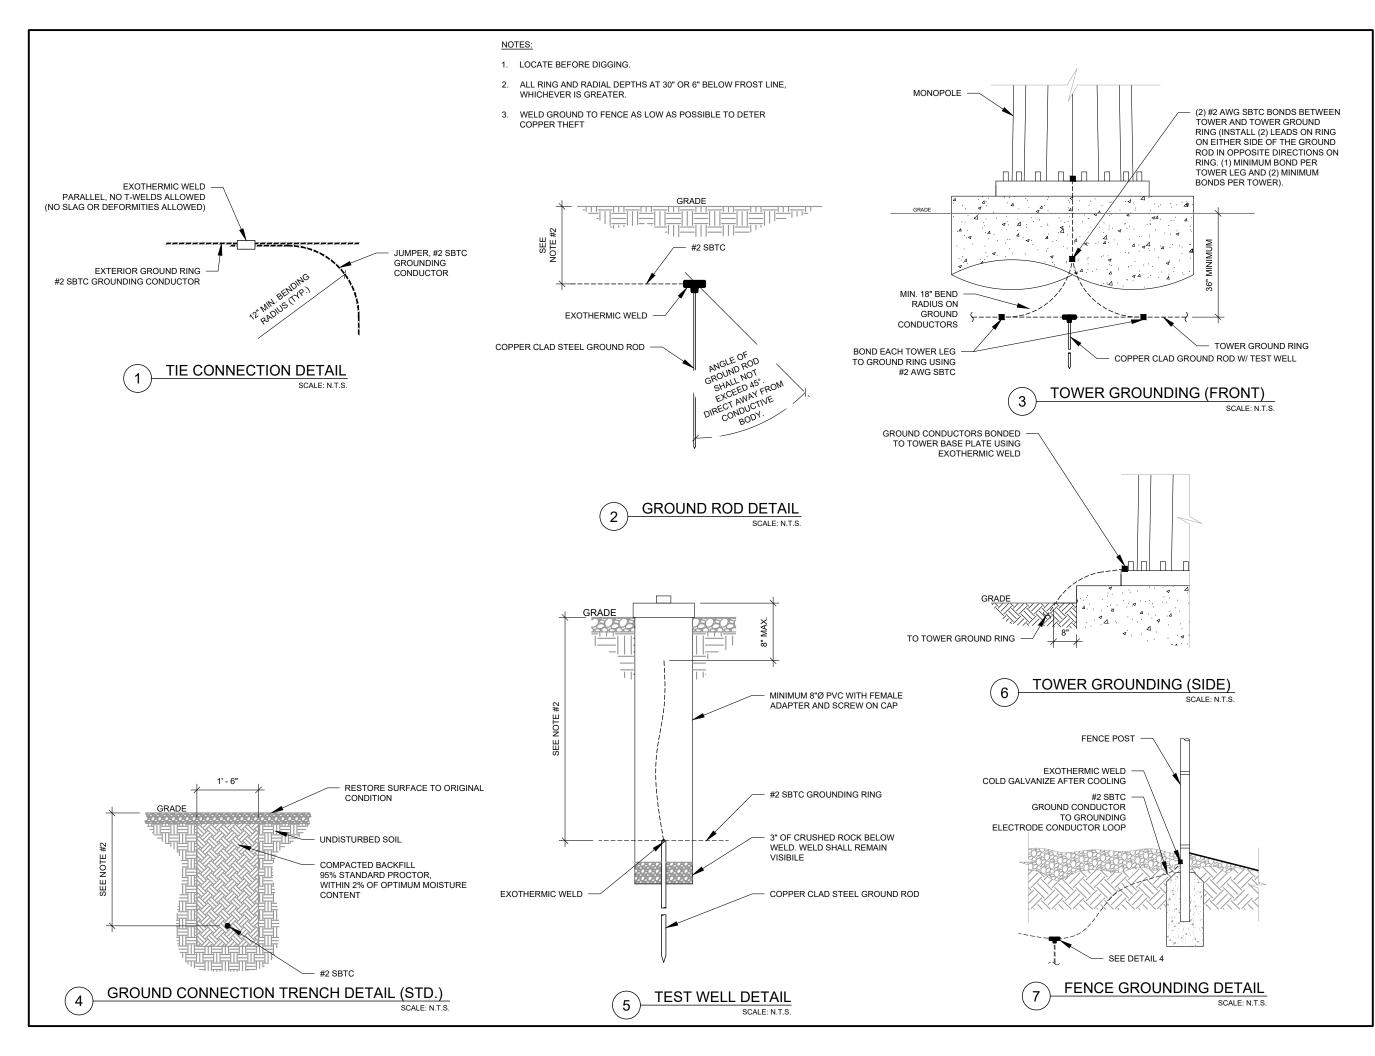
DATE DRAWN:	04/26/23
ATC JOB NO:	14141546_D4
OPS JOB NO:	13734361
ATC LEGACY #:	419522

GROUNDING LAYOUT

SHEET NUMBER:

E-401

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3500 REGENCY PARKWAY SUITE 100 CARY, NC 27518 PHONE: (919) 468-0112

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DATE DRAWN:	04/26/23
ATC JOB NO:	14141546_D4
OPS JOB NO:	13734361
ATC LEGACY #:	419522

ELECTRICAL DETAILS

SHEET NUMBER:

E-501



April 6, 2023

El Paso County Planning and Community Development Department 2880 International Circle, Suite 110 Colorado Springs, CO 80910

Re: American Tower Corporation, Replacement of telecommunications structure, 2945 Little Turkey Creek Rd, Colorado Springs, CO

Applicant: Tilson Technology Management on behalf of American Tower Corporation

Contact: Heather Carlisle

Property Address: 2945 Little Turkey Creek Rd, Colorado Springs, CO

Property Tax Schedule Number: 7615000004

Current Zoning of the Property: A-5

To Whom It May Concern,

Tilson Technology Management, Inc., ("Tilson") on behalf of American Tower Corporation ("ATC") respectfully submits the following information to supplement its application for a Site Development Plan Application for the proposed replacement tower located at 2945 Little Turkey Creek Rd, Colorado Springs, CO. Pursuant to Section 5.2.19 (B) of the El Paso County Land Development Code, Tilson presents the following information:

5.2.19. Commercial Mobile Radio Service Facility (CMRS) Facilities

(B) General Standards

An applicant for a new freestanding CMRS facility shall demonstrate that a good faith effort has been made to co-locate on existing CMRS facilities. The applicant shall demonstrate that due to



physical constraints, or economic or technological infeasibility, no such location or co-location is available. The applicant shall also demonstrate that contact has been made with the owners of all suitable structures within the search area of the proposed site and was denied permission to locate its CMRS facility on those structure:

All facilities shall be designed and constructed to allow for colocation of a minimum of 2 users unless specifically exempted by the BOCC.

American Tower is proposing to replace the existing tower located at 2945 Little

Turkey Creek Rd, Colorado Springs with a new tower and add an additional height of 20'

(increasing the height of the previous stealth monopine from 49' to 69') to accommodate an additional carrier. This will therefore fall under the site development plan process (PPR) since this proposal is for the construction of a new tower. There are currently utilities on-site servicing the existing tower, and the same utilities will provide service to the new tower.

(2) Compliance with FCC Standards

At the request of the PCD Director, which request shall occur no more than once per year, CMRS facility owners and operators shall certify that:

The CMRS facility complies with the current FCC regulations prohibiting localized interference with reception of television and radio broadcasts; and

The CMRS facility complies with the current FCC standards for cumulative field measurements of radio frequency power densities and electromagnetic fields.



In adopting this requirement, the County is not attempting to regulate radio frequency power densities or electromagnetic fields, which regulation is controlled by the FCC.

ATC will provide certification at the request of the PCD Director on an annual basis.

(3) Abandonment and Expiration

If the CMRS facility ceases operation for any reason for a period of one year:

El Paso County, Colorado Land Development Code

Use and Dimensional Standards – Chapter 5-Page 21 Effective 01/09/2018

- The owner or operator shall remove the CMRS facility within 6 months of the expiration;
 and
- Any permit or approval authorizing the CMRS facility shall be considered expired.

ATC shall comply with this provision.

(4) Application Approval or Denial

In considering an application for a CMRS facility, the County shall base its decision as to the approval or denial of the application on whether the proposed CMRS facility meets the design



standards set forth in this Section and any approval criteria associated with the applicable application or review process.

The current plans adhere to the design standards set forth in this Section.

(5) Accessory Equipment for CMRS Facility

All accessory equipment for a CMRS Facility shall be 100% screened from view. All equipment shelters shall be located within the lease area for the CMRS facility. No equipment storage shelter shall exceed 15 feet in height. Equipment storage shelters shall be grouped as closely together as practical, so as to minimize impact on adjoining properties. The total area of all accessory equipment, including equipment storage shelters, shall not exceed 400 square feet per CMRS facility, except for a small cell facility where 17 square feet shall be the maximum allowed.

ATC will continue to comply with this requirement, as shown on the construction drawings included with this submission.

(6) Standards for Freestanding CMRS Facilities

(a) Tower/Structure Removal Agreement

Prior to commencing construction of a new freestanding CMRS facility or any alteration of an existing freestanding CMRS facility, a Tower/Structure Removal Agreement shall be signed by the owner of the property and filed for recording with the Clerk and Recorder.

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ATC shall comply with this provision prior to commencing construction of the replacement tower.

(b) Financial Assurance

Prior to commencing construction of a CMRS facility, the owner of a freestanding CMRS facility shall be required to provide the County with adequate financial assurance to cover removal of the facility if abandoned. The form of financial assurance shall be approved by the PCD Director.

ATC shall comply with this provision prior to commencing construction of the replacement tower.

- (c) Minimum Setbacks for Freestanding CMRS Facilities
 - (i) Located Within 250 Feet of Residential Zoning District

A freestanding CMRS facility located within 250 feet of any property zoned for residential use shall be set back from any residential property line one foot of distance for every foot of facility height (as measured from grade elevation), plus an additional 10 feet.

N/A, tower is not located within 250' of a Residential Zoning District

(ii) Located Over 250 Feet from Residential Zoning District



A freestanding CMRS facility located greater than 250 feet from property zoned for residential use shall meet the minimum setback requirements for structures and structures of the underlying zoning district and located in a manner to contain any freefall or icefall on the same property.

As demonstrated in the construction drawings that are included with this submission, the aforementioned setbacks have been met.

(d) Maximum Height for Freestanding CMRS Facilities

A freestanding CMRS facility, including antennae, shall not exceed the maximum structure height limit in the zoning district unless otherwise specifically authorized as a part of the special use or variance of use approval. Any tower that exceeds 200 feet shall require FAA approval prior to approval of a special use or variance of use.

The height of the replacement tower will be 69', thus meeting the maximum height requirements.

(e) Administrative Special Use of Variance of Use Amendment.

The PCD Director may administratively amend the special use or variance of use approval for a minor modification to the CMRS facility provided the modifications do not constitute a Substantial Change.

N/A, the tower replacement with height increase constitutes a substantial change.

(f) Design Standards for Freestanding CMRS Facilities

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A freestanding CMRS facility shall adhere to the following design standards to minimize impacts:

(i) Compatible with Surrounding Area

A freestanding CMRS facility shall be designed to be compatible with surrounding buildings and structures and existing or planned uses in the area, subject to any applicable FAA regulations.

The current/proposed structure is a monopine which blends into the surrounding area, which is primarily agricultural/forest.

(ii) Existing Vegetation Existing landforms, vegetation and structures shall be used to screen the facility from view and blend in with the surrounding environment, to the extent practicable. Existing vegetation shall be preserved or enhanced, where feasible.

Existing vegetation and structures shall continue to be used to screen the facility, and shall be preserved and enhanced, where feasible.

(iii) No Lighting

The facility antennae shall not be lighted unless required by the FAA and authorized by the permit or approval.

The structure is unlit.

(iv) Dangerous Equipment and Attractive Nuisance Any equipment that could be dangerous to persons or wildlife shall be adequately

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fenced. The attractive nuisance potential shall be minimized through fencing and methods to discourage unauthorized climbing.

Leased area and compound are fenced.

(vii) Dish Diameter Limited

The diameter of a microwave dish antenna shall not exceed 4 feet.

N/A

(7) Stealth CMRS Facility Design Standards

A stealth CMRS facility shall meet the same design standards and maximum height allowance as a freestanding CMRS facility.

As demonstrated above, the proposed stealth CMRS facility meets the applicable design standards and maximum height allowances for a freestanding CMRS facility.

The proposed tower replacement at 2945 Little Turkey Creek Rd, Colorado Springs, CO meets all of the applicable requirements of Section 5.2.19 (B) of the El Paso County Land Development Code. The replacement of the existing facility will allow for additional collocators while not exceeding the Code's maximum height requirements, and the tower will continue to blend within the surrounding area and will not adversely impact adjacent properties. Existing stormwater runoff patterns will also not be affected, since the footprint of the existing tower compound will not be expanded.



Respectfully submitted,

Heather Carlisle

Heather Carlisle

Sr. Counsel, Siting & Real Estate

hcarlisle@tilsontech.com

(774) 285-1082