

BENCHMARK

1" = 20' 1:240

DESIGNED BY DRAWN BY

CHECKED BY

AS-BUILTS BY CHECKED BY

SECURITY FIRE

STATION NO. 4

PLAN SITE PLAN

MVE DRAWING DEV-SP

SHEET 2 OF 2

TOW POPI	/
para para para para para para para para	
	0.00 (0.00
	0.00 (0.00 (0.00)
	a.ao (a.ao (a.ao (a.ao (a.ao (a.ao
10.01, 20.01, 20.01, 20.01, 20.01, 10	
20.01, 0.01, 0.01, 0.01, 0.01, 0.01, 0.01, 0.01, 0.01, 0.01, 0.01, 0.01, 0.01, 0.01, 0.01, 0.01, 0.02, 0.02, 0.03, 0.04, 0.04, 0.03, 0.04, 0.04, 0.02, 0.02, 0.03, 0.04, 0.04, 0.01,	
20.01, 20	
1.8 H=6, 0.07, 0.03, 0.01, 0.0	
0.02, 0.04, 0.01,	
D H=6 4.1.1.2.20 .0.1.	
0.02 .0.01 .0.01 .0.02 .0.02 .0.03 .0.02 .0.03 .	0.10 (0.10 (0.10 (0.10 (0.10
10.01, 10.02, 10.03, 10.04, 10.02, 10.03, 10.04, 10.02, 10.03, 10.04, 10.04, 10.04, 10.04, 10.04, 10.04, 10.04, 10.04, 10.04, 10.04, 10.04, 10.04, 10.04, 10.04, 10.04, 10.04, 10.04, 10.04, 10.04, 10	a. ao (a. ao (a. ao (a. ao (a. ao
1,4,0,0,0,0,0,0,0,0,0,0,0,0,0,0,0,0,0,0,	a. oo (a. oo (a. oo (a. oo
	a.ab (a.ab (a.ab (a.ab
	0.00 (0.00 (0.00
	0.00 (0.00 (0.00
	0.00 (0.00)
EDD ADD ADD ADD ADD ADD ADD ADD ADD ADD	0.00 (0.00 (0.00
	0.00 (0.00
	0.00 (0.00
	(I. II)
шаль два	
шашашашашашашашашашашашашашашашашашаша	
сторьно разона по дато дато дато дато дато дато дато дат	
10.07 4.0.04 4.0.04 4.0.04 4.0.05 4.0.04 4.0.05 4.0	D. 1
	Note: N
20.01, 20.01, 10	lighting
	with this
######################################	ab.;a;!44
	submitta
	Lighting
	Lighting
هــــــــ هــــــ هـــــ هــــ هـــ هــ	
هیم	approve
	previou
$oldsymbol{U} = oldsymbol{U} = oldsymbol{U = oldsymbol{U} = oldsymbol{U} = oldsymbol{U} = oldsymbol{U = oldsymbol{U} = oldsymbol{U} = oldsymbol{$	

Luminaire list (Site 1)

1x LED 3,8W

3x 3 LED 13W

Item number

620-2017

Luminous flux

293 lm

1496 lm

0.80

0.80

Article name

LED 3,8W

QLS410 [M] IP66: LED-3/13W/3K

Index

2

Manufacturer

> hting are requested ith this COM ubmittal. This ighting Plan was oproved with the previous Development Plan on 5/17/2021

Quantity

Connected load

ote: No changes to

Upward directed light is ideal for highlighting various architectural features. Project: Modified: Luminaire housing constructed of die-cast marine grade, copper free (≤0.3% copper content) A360.0 aluminum alloy Reflectors made of pure anodized aluminum Silicone applied robotically to casting, plasma treated for increased High temperature silicone gasket Mechanically captive stainless steel fasteners NRTL listed to North American Standards, suitable for wet locations Protection class IP64 Weight: 1.5 lbs Electrical 120-277VAC Operating voltage -30° C 40° C 3.8 W 7.3 W Minimum start temperature Maximum ambient temperature LED module wattage System wattage 0-10V dimmable Controllability Color rendering index Luminaire lumens 309 lumens (4000K) LED service life (L70) LED color temperature □ 4000K - Product number + **K4 (EXPRESS)** □ 3500K - Product number + **K35** □ 3000K - Product number + **K3 (EXPRESS)** □ 2700K - Product number + **K27** ☐ Amber - Product number + **AMB** Wildlife friendly amber LED - Optional Luminaire is optionally available with a narrow bandwidth, amber LED source (585-600nm) approved by the FWC. This light output is suggested **Available Options** for use within close proximity to sea turtle nesting and hatching habitats. ☐ FSC Fusing☐ FRO Frosted lens Electrical and control information may vary from standard luminaire. LED module wattage 4.2W (Amber) ☐ **FFRO** Factory fixed reduced output System wattage 7.6W (Amber) ☐ **UPO** Uplight only Luminaire lumens 89 lumens (Amber) See individual accessory spec sheet for details. BEGA can supply you with suitable LED replacement modules for up to 20 years after the purchase of LED luminaires - see website for details All BEGA standard finishes are matte, textured polyester powder coat with minimum 3 mil thickness. Available colors ☐ Black (BLK) ☐ White (WHT) ☐ RAL: \square Bronze (BRZ) \square Silver (SLV) \square CUS: Wall luminaire - two-sided light distribution A B C **33590** ADA 3.8W 22° BEGA 1000 BEGA Way, Carpinteria, CA 93013 (805) 684-0533 info@bega-us.com Due to the dynamic nature of lighting products and the associated technologies, luminaire data on this sheet is subject to change at the discretion of BEGA North America. For the most current technical data, please refer to bega-us.com © copyright BEGA 2019 Updated 08/07/19

BEGA Product:

Wall luminaire - two-sided light distribution

QLS410 LED

Wall luminaire with light emission on two sides. Downward directed light

distribution is ideal for general illumination of pathways and corridors.

BEGA



Description	Beam Type	symmetric, medium beam [M]
IP66, Class I. IK07. Surface mounted LED wall luminaire. Marine-grade, die-cast aluminum alloy. 5CE superior corrosion protection including	Light Source	LED-3/13W / 1400 mA - 3000 K
PCS hardware. Silicone rubber gasket. Safety glass lens. Integral EC electronic converter. CAD-optimised optics for superior illumination	CRI	80
and glare control. OLC® One LED Concept. Factory installed LED circuit board. 0-10V on request. Suitable for installation over 4" recessed	Gear Type	electronic gear
junction box. ADA (American Disabilities Act) Compliant.	Nominal Luminous F	Flux (Im)

LEDs

Total Lumens

Rated Input Power

498.7 Im

1496 lm


85 °C

336.1 lm

1008.4 lm

25 °C

3

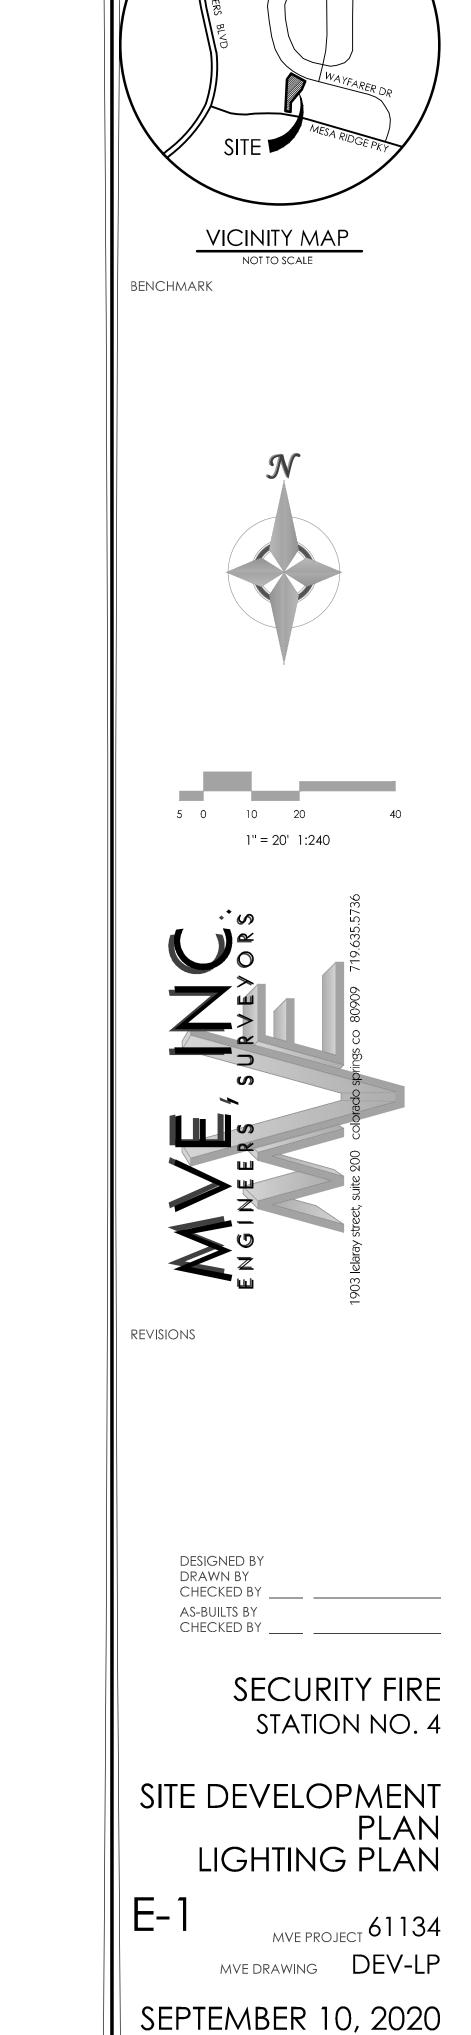

SHEET 1 OF 1

