

161 INVERNESS DR W, 2ND FLOOR ENGLEWOOD, CO 80112


AT&T SITE NAME: BLACK FOREST CO AT&T SITE ID: COL02237 **AT&T PACE NUMBER: MRUTH042457 AT&T FA CODE: 15312482 NSB - (SELF-SUPPORT TOWER) LTE 1C/2C/3C/4C/5G NR 1SR** USID: 295098



ATC SITE NAME: BLACK FOREST **ATC SITE NUMBER: 302460** SITE ADDRESS: 4590 HODGEN RD

COLORADO SPRINGS, CO 80908

(EL PASO COUNTY)

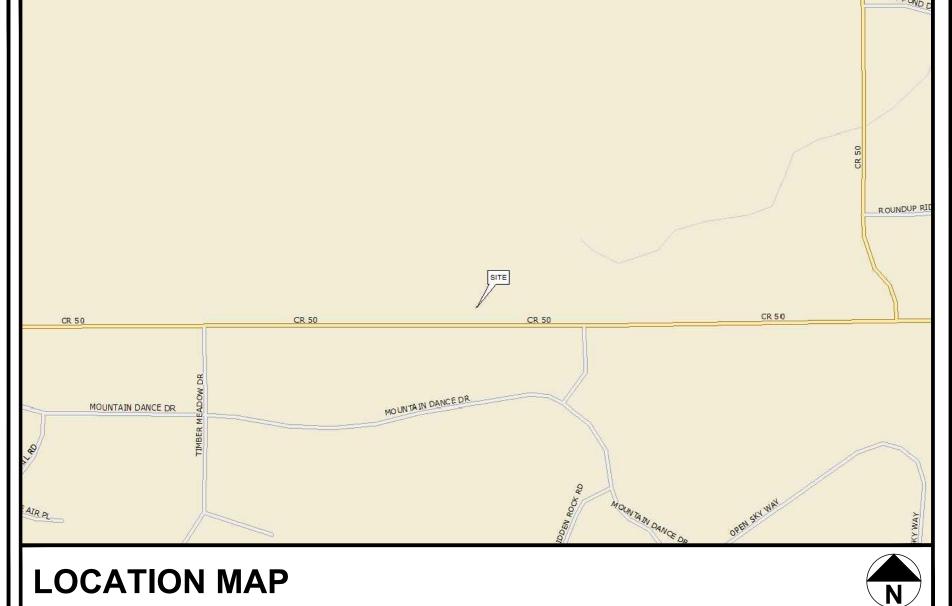

LOCATION MAP

DRIVING DIRECTIONS

I-25 EXIT 161, GO EAST ON HWY 105, SOUTH ON HWY 83, EAST ON HODGEN ROAD TO SITE.

*LATITUDE N 39° 4' 16.18" (39.07116°) *LONGITUDE W 104° 44' 35.53" (-104.7432°)

*GROUND ELEV. (AMSL) = 7,625'±

*INFORMATION PROVIDED BY ATC

ALL WORK AND MATERIALS SHALL BE PERFORMED AND INSTALLED IN ACCORDANCE WITH THE CURRENT EDITIONS OF THE FOLLOWING CODES AS ADOPTED BY THE LOCAL

1. INTERNATIONAL BUILDING CODE (2015 EDITION)

(2017 EDITION) 5. LOCAL BUILDING CODE 6. CITY/COUNTY ORDINANCES

ROUNDING PLANS

CODE COMPLIANCE

AT&T SITE NAME: **BLACK FOREST CO**

AT&T SITE ID: COL02237 15312482

TOWER COORDINATES

PACE NUMBER: MRUTH042457 ATC SITE NAME: **BLACK FOREST**

ATC SITE NUMBER: 302460

PROJECT TEAM

PROJECT DESCRIPTION: COLLOCATION

170' SELF-SUPPORT TOWER W/ 20' TOWER EXTENSION

JURISDICTION: **EL PASO COUNTY**

300 SQ FT LEASE AREA: CURRENT ZONING:

TOWER TYPE:

PROJECT INFORMATION

OITE CONOTRUCTION MANAGER.	SHEET:	DESCRIPTION:
SITE CONSTRUCTION MANAGER: NAME: AT&T	T-1	TITLE SHEET
ADDRESS: 161 INVERNESS DR W, 2ND FLOOR CITY, STATE, ZIP: ENGLEWOOD, CO 80112	T-2	GENERAL NOTES
CONTACT: REID POST PHONE: (720) 838-4228	S-1	SITE SURVEY I
	S-2	SITE SURVEY II
SITE APPLICANT: NAME: AT&T	C-1	COMPOUND DETAIL
ADDRESS: 4393 S RIVERBOAT RD, 4TH FLOOR CITY, STATE, ZIP: SALT LAKE CITY, UT 84123 CONTACT: JAN ROBINETTE	C-2	EQUIPMENT & ANTENNA LAYOUTS
CONTACT: JAN ROBINETTE PHONE: (801) 201-4173	C-3	EXISTING AND FINAL ELEVATIONS
	C-4	EQUIPMENT DETAILS
CIVIL ENGINEER: NAME: TOWER ENGINEERING	C-5	EQUIPMENT DETAILS
PROFESSIONALS ADDRESS: 326 TRYON ROAD	C-6	WIC SHELTER DETAILS
CITY, STATE, ZIP: RALEIGH, NC 27603 CONTACT: GRAHAM M. ANDRES, P.E. PHONE: (919) 661-6351	C-7	GENERATOR DETAILS
PHONE: (919) 661-6351	C-8	FOUNDATION DETAILS
ELECTRICAL ENGINEER:	E-1	ELECTRICAL PANEL & GROUNDING
NAME: TOWER ENGINEERING PROFESSIONALS	E-2	ONE-LINE DIAGRAM
ADDRESS: 326 TRYON ROAD CITY, STATE, ZIP: RALEIGH, NC 27603	E-3	DC SYSTEM DETAILS
CONTACT: GRAHAM M. ANDRES, P.E. PHONE: (919) 661-6351	E-4	FIBER ROUTING PLAN
	G-1	GROUNDING DETAILS
PROPERTY OWNER: NAME: AMERICAN TOWER ASSET SUB LLC	G-2	GROUNDING DETAILS
AMERICAN TOWER ASSET SOBILES ADDRESS: 4590 HODGEN RD CITY, STATE, ZIP: COLORADO SPRINGS, CO 80908		
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SHEET INDEX

4. NATIONAL ELECTRIC CODE 2. INTERNATIONAL CODE COUNCIL

3. ANSI/TIA/EIA-222-H

MOUNTAIN VIEW ELECTRIC POWER COMPANY: **CUSTOMER SERVICE** CONTACT: (800) 388-9881

METER # NEAR SITE:

TELEPHONE COMPANY: CENTURY LINK CONTACT: CUSTOMER SERVICE PHONE: (800) 784-3414

69 712 849

PHONE # NEAR SITE: (719) 337-8124 PEDESTAL # NEAR SITE: UNKNOWN

UTILITY INFORMATION

DESIGN PACKAGE BASED ON RF DATA SHEET RFDS NAME: COL02237

REVISION: V1.00 ISSUED: 9/21/20 5:35:48 P.M. DATE UPDATED: 10/14/2020 3:55:55 P.M.

NUMBER OF SECTORS: 3 NUMBER OF ANTENNAS: 6 NUMBER OF TMAs: 0 NUMBER OF RRHs: 9 NUMBER OF DC SQUIDS: 3

NUMBER OF FIBER TRUNK CABLES: 3 NUMBER OF DC TRUNK CABLES: 6 NUMBER OF RF CABLES: 0

RFDS DATA

THE PURPOSE OF THIS PROJECT IS AS FOLLOWS:

TOWER SCOPE OF WORK:

- **INSTALL (6) ANTENNAS** INSTALL (9) RRHs
- **INSTALL (3) SQUIDS**
- **INSTALL (3) FIBER TRUNKS** INSTALL (6) DC TRUNKS
- INSTALL (1) CABLE LADDER **INSTALL (1) TOWER EXTENSION**

GROUND SCOPE OF WORK:

- INSTALL (1) W.I.C. SHELTER PAD **INSTALL (1) GENERATOR PAD**
- INSTALL (1) W.I.C SHELTER
- INSTALL (1) GENERATOR INSTALL (1) H-FRAME
- **INSTALL METER**
- **INSTALL DISCONNECT INSTALL FIBER BOX**

NSB - 170' SELF-SUPPORT TOWER LTE - 1C/2C/3C/4C/5G NR 1SR

SCOPE OF WORK


JURISDICTIONAL APPROVAL

DO NOT SCALE DRAWINGS.

GENERAL NOTES

CONTRACTOR SHALL VERIFY ALL PLANS AND EXISTING DIMENSIONS AND CONDITIONS ON THE JOB SITE AND SHALL IMMEDIATELY NOTIFY THE ARCHITECT/ENGINEER IN WRITING OF ANY DISCREPANCIES BEFORE PROCEEDING WITH THE WORK OR BE RESPONSIBLE FOR SAME.

THE FACILITY IS UNMANNED AND NOT FOR HUMAN HABITATION. A TECHNICIAN WILL VISIT THE SITE AS REQUIRED FOR ROUTINE MAINTENANCE. THE PROJECT WILL NOT RESULT IN ANY SIGNIFICANT DISTURBANCE OR EFFECT ON DRAINAGE; NO SANITARY SEWER SERVICE, POTABLE WATER, OR TRASH DISPOSAL IS REQUIRED AND NO COMMERCIAL SIGNAGE IS PROPOSED.

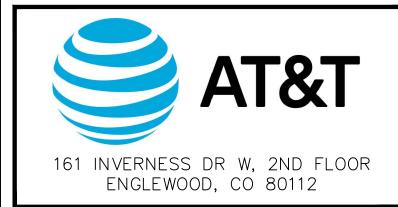



19100 VON KARMAN AVE SUITE 200 IRVINE, CA 92612



AT&T SITE ID: COL02237 AT&T FA CODE: 15312482 **AT&T PACE #: MRUTH042457** ATC #: 302460 **BLACK FOREST**

4590 HODGEN RD COLORADO SPRINGS, CO 80908 (EL PASO COUNTY)

EXISTING 170'-0" W/ 20' EXTENSION SELF-SUPPORT TOWER NSB - LTE - 1C/2C/3C/4C/5G NR 1SR

	ISSUED FOR:						
REV	DATE	DRWN	DESCRIPTION	QA			
Α	11-23-20	RRG	PRELIMINARY	EGG			
В	12-10-20	СВМ	90% CONSTRUCTION	EGG			
С	02-17-21	BCL	90% CONSTRUCTION	EGG			

SEAL:



IT IS A VIOLATION OF LAW FOR ANY PERSON, UNLESS THEY ARE ACTING UNDER THE DIRECTION OF A LICENSED PROFESSIONAL ENGINEER, TO ALTER THIS DOCUMENT.

SHEET TITLE:

TITLE SHEET

SHEET NUMBER:

REVISION:

TEP #:

GENERAL CONSTRUCTION NOTES:

- 1. OWNER FURNISHED MATERIALS, AT&T "THE COMPANY" WILL PROVIDE AND THE **CONTRACTOR WILL INSTALL**
 - A. BTS EQUIPMENT FRAME (PLATFORM) AND ICEBRIDGE SHELTER (GROUND
 - **BUILD/CO-LOCATE ONLY)** B. AC/TELCO INTERFACE BOX (PPC)
 - C. ICE BRIDGE (CABLE TRAY WITH COVER) (GROUND BUILD/CO-LOCATE ONLY, GC TO FURNISH AND INSTALL FOR ROOFTOP INSTALLATION)
 - D. TOWERS, MONOPOLES
 - E. TOWER LIGHTING
 - F. GENERATORS & LIQUID PROPANE TANK G. ANTENNA STANDARD BRACKETS, FRAMES AND PIPES FOR MOUNTING
 - H. ANTENNAS (INSTALLED BY OTHERS)
 - I. TRANSMISSION LINE
 - J. TRANSMISSION LINE JUMPERS
 - K. TRANSMISSION LINE CONNECTORS WITH WEATHERPROOFING KITS
 - L. TRANSMISSION LINE GROUND KITS
 - M. HANGERS
 - N. HOISTING GRIPS O. BTS EQUIPMENT
- THE CONTRACTOR IS RESPONSIBLE TO PROVIDE ALL OTHER MATERIALS FOR THE COMPLETE INSTALLATION OF THE SITE INCLUDING, BUT NOT LIMITED TO, SUCH MATERIALS AS FENCING, STRUCTURAL STEEL SUPPORTING SUB-FRAME FOR PLATFORM, ROOFING LABOR AND MATERIALS, GROUNDING RINGS, GROUNDING WIRES, COPPER-CLAD OR XIT CHEMICAL GROUND ROD(S), BUSS BARS, TRANSFORMERS AND DISCONNECT SWITCHES WHERE APPLICABLE, TEMPORARY ELECTRICAL POWER, CONDUIT, LANDSCAPING COMPOUND STONE, CRANES, CORE DRILLING, SLEEPERS AND RUBBER MATTING, REBAR, CONCRETE CAISSONS, PADS AND/OR AUGER MOUNTS, MISCELLANEOUS FASTENERS, CABLE TRAYS, NON-STANDARD ANTENNA FRAMES AND ALL OTHER MATERIAL AND LABOR REQUIRED TO COMPLETE THE JOB ACCORDING TO THE DRAWINGS AND SPECIFICATIONS. IT IS THE POSITION OF AT&T TO APPLY FOR PERMITTING AND CONTRACTOR RESPONSIBLE FOR PICKUP AND PAYMENT OF REQUIRED PERMITS.
- ALL WORK SHALL CONFORM TO ALL CURRENT APPLICABLE FEDERAL, STATE, AND LOCAL CODES, INCLUDING ANSI/EIA/TIA-222, AND COMPLY WITH ATC CONSTRUCTION
- CONTRACTOR SHALL CONTACT LOCAL 811 FOR IDENTIFICATION OF UNDERGROUND UTILITIES PRIOR TO START OF CONSTRUCTION.
- 5. CONTRACTOR SHALL BE RESPONSIBLE FOR COORDINATING ALL REQUIRED
- ALL DIMENSIONS TO, OF, AND ON EXISTING BUILDINGS, DRAINAGE STRUCTURES, AND SITE IMPROVEMENTS SHALL BE VERIFIED IN FIELD BY CONTRACTOR WITH ALL DISCREPANCIES REPORTED TO THE ENGINEER.
- 7. DO NOT CHANGE SIZE OR SPACING OF STRUCTURAL ELEMENTS.
- 8. DETAILS SHOWN ARE TYPICAL; SIMILAR DETAILS APPLY TO SIMILAR CONDITIONS **UNLESS OTHERWISE NOTED.**
- THESE DRAWINGS DO NOT INCLUDE NECESSARY COMPONENTS FOR CONSTRUCTION SAFETY WHICH SHALL BE THE SOLE RESPONSIBILITY OF THE CONTRACTOR.
- 10. CONTRACTOR SHALL BRACE STRUCTURES UNTIL ALL STRUCTURAL ELEMENTS NEEDED FOR STABILITY ARE INSTALLED. THESE ELEMENTS ARE AS FOLLOWS: LATERAL BRACING, ANCHOR BOLTS, ETC.
- CONTRACTOR SHALL DETERMINE EXACT LOCATION OF EXISTING UTILITIES, GROUNDS DRAINS, DRAIN PIPES, VENTS, ETC. BEFORE COMMENCING WORK.
- 12. INCORRECTLY FABRICATED, DAMAGED, OR OTHERWISE MISFITTING OR NONCONFORMING MATERIALS OR CONDITIONS SHALL BE REPORTED TO THE AT&T REP PRIOR TO REMEDIAL OR CORRECTIVE ACTION. ANY SUCH REMEDIAL ACTION SHALL REQUIRE WRITTEN APPROVAL BY THE AT&T REP PRIOR TO PROCEEDING.
- 13. EACH CONTRACTOR SHALL COOPERATE WITH THE AT&T REP, AND COORDINATE HIS WORK WITH THE WORK OF OTHERS.
- 14. CONTRACTOR SHALL REPAIR ANY DAMAGE CAUSED BY CONSTRUCTION OF THIS PROJECT TO MATCH EXISTING PRE-CONSTRUCTION CONDITIONS TO THE SATISFACTION OF THE AT&T CONSTRUCTION MANAGER.
- INSTALLATION USING A SILICONE SEALANT.

15. ALL CABLE/CONDUIT ENTRY/EXIT PORTS SHALL BE WEATHERPROOFED DURING

- 16. WHERE EXISTING CONDITIONS DO NOT MATCH THOSE SHOWN IN THIS PLAN SET, CONTRACTOR SHALL NOTIFY THE AT&T REP AND ENGINEER OF RECORD
- 17. CONTRACTOR SHALL ENSURE ALL SUBCONTRACTORS ARE PROVIDED WITH A COMPLETE AND CURRENT SET OF DRAWINGS AND SPECIFICATIONS FOR THIS
- 18. CONTRACTOR SHALL REMOVE ALL RUBBISH AND DEBRIS FROM THE SITE AT THE END OF EACH DAY.
- 19. CONTRACTOR SHALL COORDINATE WORK SCHEDULE WITH AMERICAN TOWER CORPORATION (ATC) AND TAKE PRECAUTIONS TO MINIMIZE IMPACT AND DISRUPTION OF OTHER OCCUPANTS OF THE FACILITY.
- 20. CONTRACTOR SHALL FURNISH ######### AND AMERICAN TOWER CORPORATION (ATC) WITH A PDF MARKED UP AS-BUILT SET OF DRAWINGS UPON COMPLETION OF
- 21. PRIOR TO SUBMISSION OF BID, CONTRACTOR SHALL COORDINATE WITH AT&T REP TO DETERMINE WHAT, IF ANY, ITEMS WILL BE PROVIDED. ALL ITEMS NOT PROVIDED SHALL BE PROVIDED AND INSTALLED BY THE CONTRACTOR. CONTRACTOR WILL INSTALL ALL ITEMS PROVIDED.
- PRIOR TO SUBMISSION OF BID, CONTRACTOR SHALL COORDINATE WITH AT&T REP TO DETERMINE IF ANY PERMITS WILL BE OBTAINED BY CONTRACTOR. ALL REQUIRED PERMITS NOT OBTAINED BY AT&T MUST BE OBTAINED, AND PAID FOR, BY THE CONTRACTOR.
- CONTRACTOR SHALL INSTALL ALL SITE SIGNAGE IN ACCORDANCE WITH AT&T SPECIFICATIONS AND REQUIREMENTS.

- 24. CONTRACTOR SHALL SUBMIT ALL SHOP DRAWINGS TO AT&T FOR REVIEW AND APPROVAL PRIOR TO FABRICATION.
- 25. ALL EQUIPMENT SHALL BE INSTALLED ACCORDING TO MANUFACTURER'S SPECIFICATIONS AND LOCATED ACCORDING TO AT&T SPECIFICATIONS, AND AS SHOWN IN THESE PLANS.
- 26. THE CONTRACTOR SHALL SUPERVISE AND DIRECT THE PROJECT DESCRIBED HEREIN. THE CONTRACTOR SHALL BE SOLELY RESPONSIBLE FOR ALL THE CONSTRUCTION MEANS, METHODS, TECHNIQUES, SEQUENCES AND PROCEDURES AND FOR COORDINATING ALL PORTIONS OF THE WORK UNDER THE CONTRACT.
- 27. CONTRACTOR SHALL NOTIFY AT&T REP A MINIMUM OF 48 HOURS IN ADVANCE OF POURING CONCRETE OR BACKFILLING ANY UNDERGROUND UTILITIES, FOUNDATIONS OR SEALING ANY WALL, FLOOR OR ROOF PENETRATIONS FOR ENGINEERING REVIEW AND
- 28. CONTRACTOR SHALL BE RESPONSIBLE FOR SITE SAFETY INCLUDING COMPLIANCE WITH ALL APPLICABLE OSHA STANDARDS AND RECOMMENDATIONS AND SHALL PROVIDE ALL NECESSARY SAFETY DEVICES INCLUDING PPE AND PPM AND CONSTRUCTION DEVICES SUCH AS WELDING AND FIRE PREVENTION, TEMPORARY SHORING, SCAFFOLDING, TRENCH BOXES/SLOPING, BARRIERS, ETC.
- 29. THE CONTRACTOR SHALL PROTECT AT HIS OWN EXPENSE, ALL EXISTING FACILITIES AND SUCH OF HIS NEW WORK LIABLE TO INJURY DURING THE CONSTRUCTION PERIOD. ANY DAMAGE CAUSED BY NEGLECT ON THE PART OF THIS CONTRACTOR OR HIS REPRESENTATIVES, OR BY THE ELEMENTS DUE TO NEGLECT ON THE PART OF THIS CONTRACTOR OR HIS REPRESENTATIVES, EITHER TO THE EXISTING WORK, OR TO HIS WORK OR THE WORK OF ANY OTHER CONTRACTOR, SHALL BE REPAIRED AT HIS EXPENSE TO THE OWNER'S SATISFACTION.
- 30. ALL WORK SHALL BE INSTALLED IN A FIRST CLASS, NEAT AND WORKMANLIKE MANNER BY MECHANICS SKILLED IN THE TRADE INVOLVED. THE QUALITY OF WORKMANSHIP SHALL BE SUBJECT TO THE APPROVAL OF THE AT&T REP. ANY WORK FOUND BY THE AT&T REP TO BE OF INFERIOR QUALITY AND/OR WORKMANSHIP SHALL BE REPLACED AND/OR REWORKED AT CONTRACTOR EXPENSE UNTIL APPROVAL IS OBTAINED.
- 31. IN ORDER TO ESTABLISH STANDARDS OF QUALITY AND PERFORMANCE, ALL TYPES OF MATERIALS LISTED HEREINAFTER BY MANUFACTURER'S NAMES AND/OR MANUFACTURER'S CATALOG NUMBER SHALL BE PROVIDED BY THESE MANUFACTURERS AS SPECIFIED.
- 32. AT&T FURNISHED EQUIPMENT SHALL BE PICKED-UP AT THE AT&T WAREHOUSE, NO LATER THAN 48HR AFTER BEING NOTIFIED INSURED, STORED, UNCRATE, PROTECTED AND INSTALLED BY THE CONTRACTOR WITH ALL APPURTENANCES REQUIRED TO PLACE THE EQUIPMENT IN OPERATION, READY FOR USE. THE CONTRACTOR SHALL BE RESPONSIBLE FOR THE EQUIPMENT AFTER PICKING IT UP.
- 33. AT&T OR HIS ARCHITECT/ENGINEER RESERVES THE RIGHT TO REJECT ANY EQUIPMENT OR MATERIALS WHICH, IN HIS OWN OPINION ARE NOT IN COMPLIANCE WITH THE CONTRACT DOCUMENTS, EITHER BEFORE OR AFTER INSTALLATION AND THE EQUIPMENT SHALL BE REPLACED WITH EQUIPMENT CONFORMING TO THE REQUIREMENTS OF THE CONTRACT DOCUMENTS BY THE CONTRACTOR AT NO COST TO AT&T OR THEIR ARCHITECT/ENGINEER.

STRUCTURAL STEEL NOTES:

- 1. STRUCTURAL STEEL SHALL CONFORM TO THE LATEST EDITION OF THE AISC SPECIFICATION FOR THE DESIGN, FABRICATION AND ERECTION OF STRUCTURAL STEE FOR BUILDINGS."
- 2. STRUCTURAL STEEL ROLLED SHAPES, PLATES AND BARS SHALL CONFORM TO THE **FOLLOWING ASTM DESIGNATIONS:**
- A. ASTM A-572, GRADE 50 ALL W SHAPES, UNLESS NOTED OR A992 OTHERWISE
- B. ASTM A-36 ALL OTHER ROLLED SHAPES, PLATES AND BARS UNLESS NOTED OTHERWISE.
- C. ASTM A-500. GRADE B HSS SECTION (SQUARE, RECTANGULAR, AND ROUND)
- D. ASTM A-325, TYPE SC OR N ALL BOLTS FOR CONNECTING STRUCTURAL MEMBERS

- ALL ANCHOR BOLTS, UNLESS NOTED OTHERWISE E. ASTM F-1554 07

- 3. ALL EXPOSED STRUCTURAL STEEL MEMBERS SHALL BE HOT-DIPPED GALVANIZED AFTER FABRICATION PER ASTM A123. EXPOSED STEEL HARDWARE AND ANCHOR BOLTS SHALL BE GALVANIZED PER ASTM A153 OR B695.
- 4. ALL FIELD CUT SURFACES, FIELD DRILLED HOLES AND GROUND SURFACES WHERE EXISTING PAINT OR GALVANIZATION REMOVAL WAS REQUIRED SHALL BE REPAIRED WITH (2) BRUSHED COATS OF ZRC GALVILITE COLD GALVANIZING COMPOUND PER ASTM A780 AND MANUFACTURER'S RECOMMENDATIONS.
- 5. DO NOT DRILL HOLES THROUGH STRUCTURAL STEEL MEMBERS EXCEPT AS SHOWN AND DETAILED ON STRUCTURAL DRAWINGS.
- 6. CONNECTIONS:
- A. ALL WELDING TO BE PERFORMED BY AWS CERTIFIED WELDERS AND CONDUCTED IN ACCORDANCE WITH THE LATEST EDITION OF THE AWS WELDING CODE D1.1.
- B. ALL WELDS SHALL BE INSPECTED VISUALLY. 25% OF WELDS SHALL BE INSPECTED WITH DYE PENETRANT OR MAGNETIC PARTICLE TO MEET THE ACCEPTANCE CRITERIA OF AWS D1.1. REPAIR ALL WELDS AS NECESSARY.
- C. INSPECTION SHALL BE PERFORMED BY AN AWS CERTIFIED WELD INSPECTOR.
- D. IT IS THE CONTRACTORS RESPONSIBILITY TO PROVIDE BURNING/WELDING PERMITS AS REQUIRED BY LOCAL GOVERNING AUTHORITY AND IF REQUIRED SHALL HAVE FIRE DEPARTMENT DETAIL FOR ANY WELDING ACTIVITY.
- E. ALL ELECTRODES TO BE LOW HYDROGEN, MATCHING FILLER METAL, PER AWS D1.1, **UNLESS NOTED OTHERWISE.**

- F. MINIMUM WELD SIZE TO BE 0.1875 INCH FILLET WELDS, UNLESS NOTED OTHERWISE
- G. PRIOR TO FIELD WELDING GALVANIZING MATERIAL, CONTRACTOR SHALL GRIND OFF GALVANIZING 1/2" BEYOND ALL FIELD WELD SURFACES. AFTER WELD AND WELD INSPECTION IS COMPLETE, REPAIR ALL GROUND AND WELDED SURFACES WITH ZRC GALVILITE COLD GALVANIZING COMPOUND PER ASTM A780 AND MANUFACTURERS RECOMMENDATIONS.
- H. THE CONTRACTOR SHALL PROVIDE ADEQUATE SHORING AND/OR BRACING WHERE REQUIRED DURING CONSTRUCTION UNTIL ALL CONNECTIONS ARE COMPLETE.
- I. ANY FIELD CHANGES OR SUBSTITUTIONS SHALL HAVE PRIOR APPROVAL FROM THE **ENGINEER, AND AT&T PROJECT MANAGER IN WRITING**

SPECIAL CONSTRUCTION ANTENNA INSTALLATION NOTES:

- WORK INCLUDED:
- A. ANTENNA AND COAXIAL CABLES ARE FURNISHED BY AT&T UNDER A SEPARATE CONTRACT. THE CONTRACTOR SHALL ASSIST ANTENNA INSTALLATION CONTRACTOR IN TERMS OD COORDINATION AND SITE ACCESS. ERECTION SUBCONTRACTOR SHALL BE RESPONSIBLE FOR THE PROTECTION OF PERSONNEL AND
- B. INSTALL ANTENNA AS INDICATE ON DRAWINGS AND AT&T SPECIFICATIONS.
- C. INSTALL GALVANIZED STEEL ANTENNA MOUNTS AS INDICATED ON DRAWINGS
- D. INSTALL FURNISHED GALVANIZED STEEL OR ALUMINUM WAVEGUIDE AND PROVIDE PRINTOUT OF THAT TEST.
- E. CONTRACTOR SHALL PROVIDE FOUR (4) SETS OF SWEEP TESTS USING ANRITZU-PACKARD 8713B RF SCALAR NETWORK ANALYZER. SUBMIT FREQUENCY DOMAIN REFLECTOMETER(FDR) TESTS RESULTS TO THE PROJECT MANAGER. SWEEP TESTS SHALL BE AS PER ATTACHED RFS "MINIMUM FIELD TESTING RECOMMENDED FOR ANTENNA AND HELIAX COAXIAL CABLE SYSTEMS" DATED 10/5/93. TESTING SHALL BE PERFORMED BY AN INDEPENDENT TESTING SERVICE AND BE BOUND AND SUBMITTED WITHIN ONE WEEK OF WORK COMPLETION.
- F. INSTALL COAXIAL CABLES AND TERMINATING BETWEEN ANTENNAS AND EQUIPMENT PER MANUFACTURER'S RECOMMENDATIONS. WEATHERPROOF ALL CONNECTIONS BETWEEN THE ANTENNA AND EQUIPMENT PER MANUFACTURER'S REQUIREMENTS. TERMINATE ALL COAXIAL CABLE THREE (3) FEET IN EXCESS OF ENTRY PORT LOCATION **UNLESS OTHERWISE STATED.**
- G. ANTENNA AND COAXIAL CABLE GROUNDING:
- 2. ALL EXTERIOR #6 GREED GROUND WIRE "DAISY CHAIN" CONNECTIONS ARE TO BE WEATHER SEALED WITH RFS CONNECTORS/SPLICE WEATHERPROOFING KIT #221213 OR
- ALL COAXIAL CABLE GROUNDING KITS ARE TO BE INSTALLED ON STRAIGHT RUNS OF **COAXIAL CABLE (NOT WITHIN BENDS)**

CONCRETE AND REINFORCING STEEL NOTES:

- DESIGN AND CONSTRUCTION OF ALL CONCRETE ELEMENTS SHALL CONFORM TO THE LATEST EDITIONS OF ALL APPLICABLE CODES INCLUDING: ACI 301 "SPECIFICATIONS FOR STRUCTURAL CONCRETE FOR BUILDINGS", ACI 117 "SPECIFICATIONS FOR TOLERANCES FOR CONCRETE CONSTRUCTION AND MATERIALS", AND ACI 318 "BUILDING CODE REQUIREMENTS FOR REINFORCED CONCRETE."
- 2. MIX DESIGN SHALL BE APPROVED BY AT&T REP PRIOR TO PLACING CONCRETE.
- 3. CONCRETE SHALL BE NORMAL WEIGHT, 6 % AIR ENTRAINED (+/- 1.5%) WITH A SLUMP RANGE OF 3-6" AND HAVE A MINIMUM 28-DAY COMPRESSIVE STRENGTH OF 4000 PSI **UNLESS OTHERWISE NOTED.**

ASTM A185

- 4. THE FOLLOWING MATERIALS SHALL BE USED: PORTLAND CEMENT: ASTM C150, TYPE 2 REINFORCEMENT: ASTM A185, PLAIN STEEL WELDED WIRE FABRIC REINFORCEMENT BARS: ASTM A615, GRADE 60, DEFORMED NORMAL WEIGHT AGGREGATE: ASTM C33 WATER: **ASTM C 94/C 94M**
 - **ADMIXTURES:** -WATER-REDUCING AGENT: ASTM C 494/C 494M, TYPE A -AIR-ENTERING AGENT: ASTM C 260/C 260M -SUPERPLASTICIZER: ASTM C494, TYPE F OR TYPE G -RETARDING: **ASTM C 494/C 494M, TYPE B**

WELDED WIRE FABRIC:


- 5. MINIMUM CONCRETE COVER FOR REINFORCING STEEL SHALL BE NO LESS THAN 3".
- 6. A 3/4" CHAMFER SHALL BE PROVIDED AT ALL EXPOSED EDGES OF CONCRETE IN ACCORDANCE WITH ACI 301 SECTION 4.2.4, UNLESS NOTED OTHERWISE.
- INSTALLATION OF CONCRETE EXPANSION/WEDGE ANCHOR SHALL BE PER MANUFACTURER'S WRITTEN RECOMMENDED PROCEDURE. THE ANCHOR BOLT, DOWEL. OR ROD SHALL CONFORM TO MANUFACTURER'S RECOMMENDATION FOR EMBEDMENT DEPTH OR AS SHOWN ON THE DRAWINGS. NO REBAR SHALL BE CUT WITHOUT PRIOR APPROVAL FROM AN ATC ENGINEER WHEN DRILLING HOLES IN CONCRETE.
- 8. ADMIXTURES SHALL CONFORM TO THE APPROPRIATE ASTM STANDARD AS REFERENCED IN "METHOD 1" OF ACI 301.
- 9. DO NOT WELD OR TACK WELD REINFORCING STEEL.
- 10. ALL DOWELS, ANCHOR BOLTS, EMBEDDED STEEL, ELECTRICAL CONDUITS, PIPE SLEEVES, GROUNDS AND ALL OTHER EMBEDDED ITEMS AND FORMED DETAILS SHALL BE IN PLACE BEFORE START OF CONCRETE PLACEMENT.

- 11. REINFORCEMENT SHALL BE COLD BENT WHENEVER BENDING IS REQUIRED.
- 12. DO NOT PLACE CONCRETE IN WATER, ICE, OR ON FROZEN GROUND.
- 13. FOR COLD-WEATHER (ACI 306) AND HOT-WEATHER (ACI 301M) CONCRETE PLACEMENT, CONFORM TO APPLICABLE ACI CODES AND RECOMMENDATIONS. IN EITHER CASE, MATERIALS CONTAINING CHLORIDE, CALCIUM, SALTS, ETC. SHALL NOT BE USED. PROTECT FRESH CONCRETE FROM WEATHER FOR 7 DAYS, MINIMUM.
- 14. ALL CONCRETE SHALL HAVE A "SMOOTH FORM FINISH."
- 15. SPLICING OF REINFORCEMENT IS PERMITTED ONLY AT LOCATIONS SHOWN IN THE CONTRACT DRAWINGS OR AS ACCEPTED BY THE ENGINEER. UNLESS OTHERWISE SHOWN OR NOTED REINFORCING STEEL SHALL BE SPLICED TO DEVELOP ITS FULL TENSILE CAPACITY (CLASS A) IN ACCORDANCE WITH ACI 318.
- 16. DETAILING OF REINFORCING STEEL SHALL CONFORM TO "ACI MANUAL OF STANDARD PRACTICE FOR DETAILING REINFORCED CONCRETE STRUCTURES" (ACI
- 17. ALL SLAB CONSTRUCTION SHALL BE CAST MONOLITHICALLY WITHOUT HORIZONTAL CONSTRUCTION JOINTS, UNLESS SHOWN IN THE CONTRACT DRAWINGS.
- 18. LOCATION OF ALL CONSTRUCTION JOINTS ARE SUBJECT TO THE REQUIREMENTS OF THE CONTRACT DOCUMENTS, CONFORMANCE WITH ACI 318, AND ACCEPTANCE OF THE ENGINEER. DRAWINGS SHOWING LOCATION OF DETAILS OF THE PROPOSED CONSTRUCTION JOINTS SHALL BE SUBMITTED WITH REINFORCING STEEL PLACEMENT DRAWINGS.
- 19. SPLICES OF WWF, AT ALL SPLICED EDGES, SHALL BE SUCH THAT THE OVERLAP MEASURED BETWEEN OUTERMOST CROSS WIRES OF EACH FABRIC SHEET IS NOT LESS THAN THE SPACING OF THE CROSS WIRE PLUS 2 INCHES, NOR LESS THAN 6".
- 20. BAR SUPPORTS SHALL BE ALL-GALVANIZED METAL WITH PLASTIC TIPS.
- ALL REINFORCEMENT SHALL BE SECURELY TIED IN PLACE TO PREVENT DISPLACEMENT BY CONSTRUCTION TRAFFIC OR CONCRETE. TIE WIRE SHALL BE OF SUFFICIENT STRENGTH FOR INTENDED PURPOSE, BUT NOT LESS THAN NO. 18
- 22. SLAB ON GROUND: COMPACT STRUCTURAL FILL TO 95% DENSITY AND THEN PLACE **6" GRAVEL BENEATH SLAB.**

ELECTRICAL NOTES:

- 1. ELECTRICAL DESIGN SHALL BE PERFORMED BY ELECTRICAL CONTRACTOR. STRUCTURAL DESIGN SHALL BE PERFORMED BY GENERAL CONTRACTOR. ELECTRICAL CONTRACTOR SHALL ENSURE THAT ALL WORK COMPLIES WITH ALL APPLICABLE LOCAL AND STATE CODES AND NATIONAL ELECTRICAL CODE.
- ALL SUGGESTED ELECTRICAL ELEMENTS (SUCH AS BREAKER SIZES, WIRE SIZES, CONDUITS SIZES ARE FOR ZONING PURPOSES ONLY. IT IS THE RESPONSIBILITY TO OF THE ELECTRICAL CONTRACTOR TO CONFIRM COMPLIANCE WITH LOCAL ELECTRICAL CODES AND PASS ALL APPLICABLE AND NECESSARY INSPECTIONS. IN SOME EVENTS. IT MAY BE NECESSARY TO PERFORM AN ELECTRICAL LOAD STUDY TO VERIFY THE CAPACITY OF THE EXISTING SERVICE. THIS IS NOT THE RESPONSIBILITY OF CONCORDIA. IT IS THE RESPONSIBILITY OF THE ELECTRICAL CONTRACTOR.
- CONTRACTOR SHALL FIELD LOCATE ALL BELOW GRADE GROUND LINES AND UTILITY LINES PRIOR TO CONSTRUCTION. CONTRACTOR IS RESPONSIBLE FOR RELOCATION OF ALL UTILITIES AND GROUND LINES THAT MAY BECOME DISTURBED OR CONFLICTING IN THE COURSE OF CONSTRUCTION.

ALL DISCREPANCIES FROM WHAT IS SHOWN ON THESE CONSTRUCTION DRAWINGS SHALL BE COMMUNICATED TO ATC ENGINEERING IMMEDIATELY FOR CORRECTION OR RE-DESIGN. FAILURE TO COMMUNICATE DIRECTLY WITH ATC ENGINEERING OR ANY CHANGES FROM THE DESIGN CONDUCTED WITHOUT PRIOR APPROVAL FROM ATC ENGINEERING SHALL BE THE SOLE RESPONSIBILITY OF THE GENERAL CONTRACTOR.

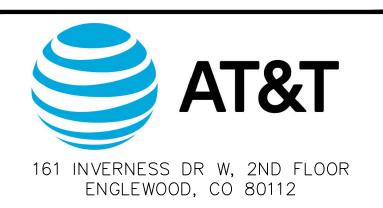

19100 VON KARMAN AVE

SUITE 200

IRVINE, CA 92612





AT&T SITE ID: COL02237 AT&T FA CODE: 15312482 **AT&T PACE #: MRUTH042457** ATC #: 302460 **BLACK FOREST**

4590 HODGEN RD COLORADO SPRINGS, CO 80908 (EL PASO COUNTY)

EXISTING 170'-0" W/ 20' EXTENSION SELF-SUPPORT TOWER NSB - LTE - 1C/2C/3C/4C/5G NR 1SR

	ISSUED FOR:						
REV	DATE	DRWN	DESCRIPTION	QA			
Α	11-23-20	RRG	PRELIMINARY	EGG			
В	12-10-20	СВМ	90% CONSTRUCTION	EGG			
С	02-17-21	BCL	90% CONSTRUCTION	EGG			

SEAL:



IT IS A VIOLATION OF LAW FOR ANY PERSON. UNLESS THEY ARE ACTING UNDER THE DIRECTION OF A LICENSED PROFESSIONAL ENGINEER,

TO ALTER THIS DOCUMENT.

SHEET TITLE:


GENERAL NOTES

SHEET NUMBER:

REVISION:

TEP #:

SHOWN BELOW WAS PROVIDED BY AMERICAN TOWER CORPORATION AND IS FOR REFERENCE ONLY.

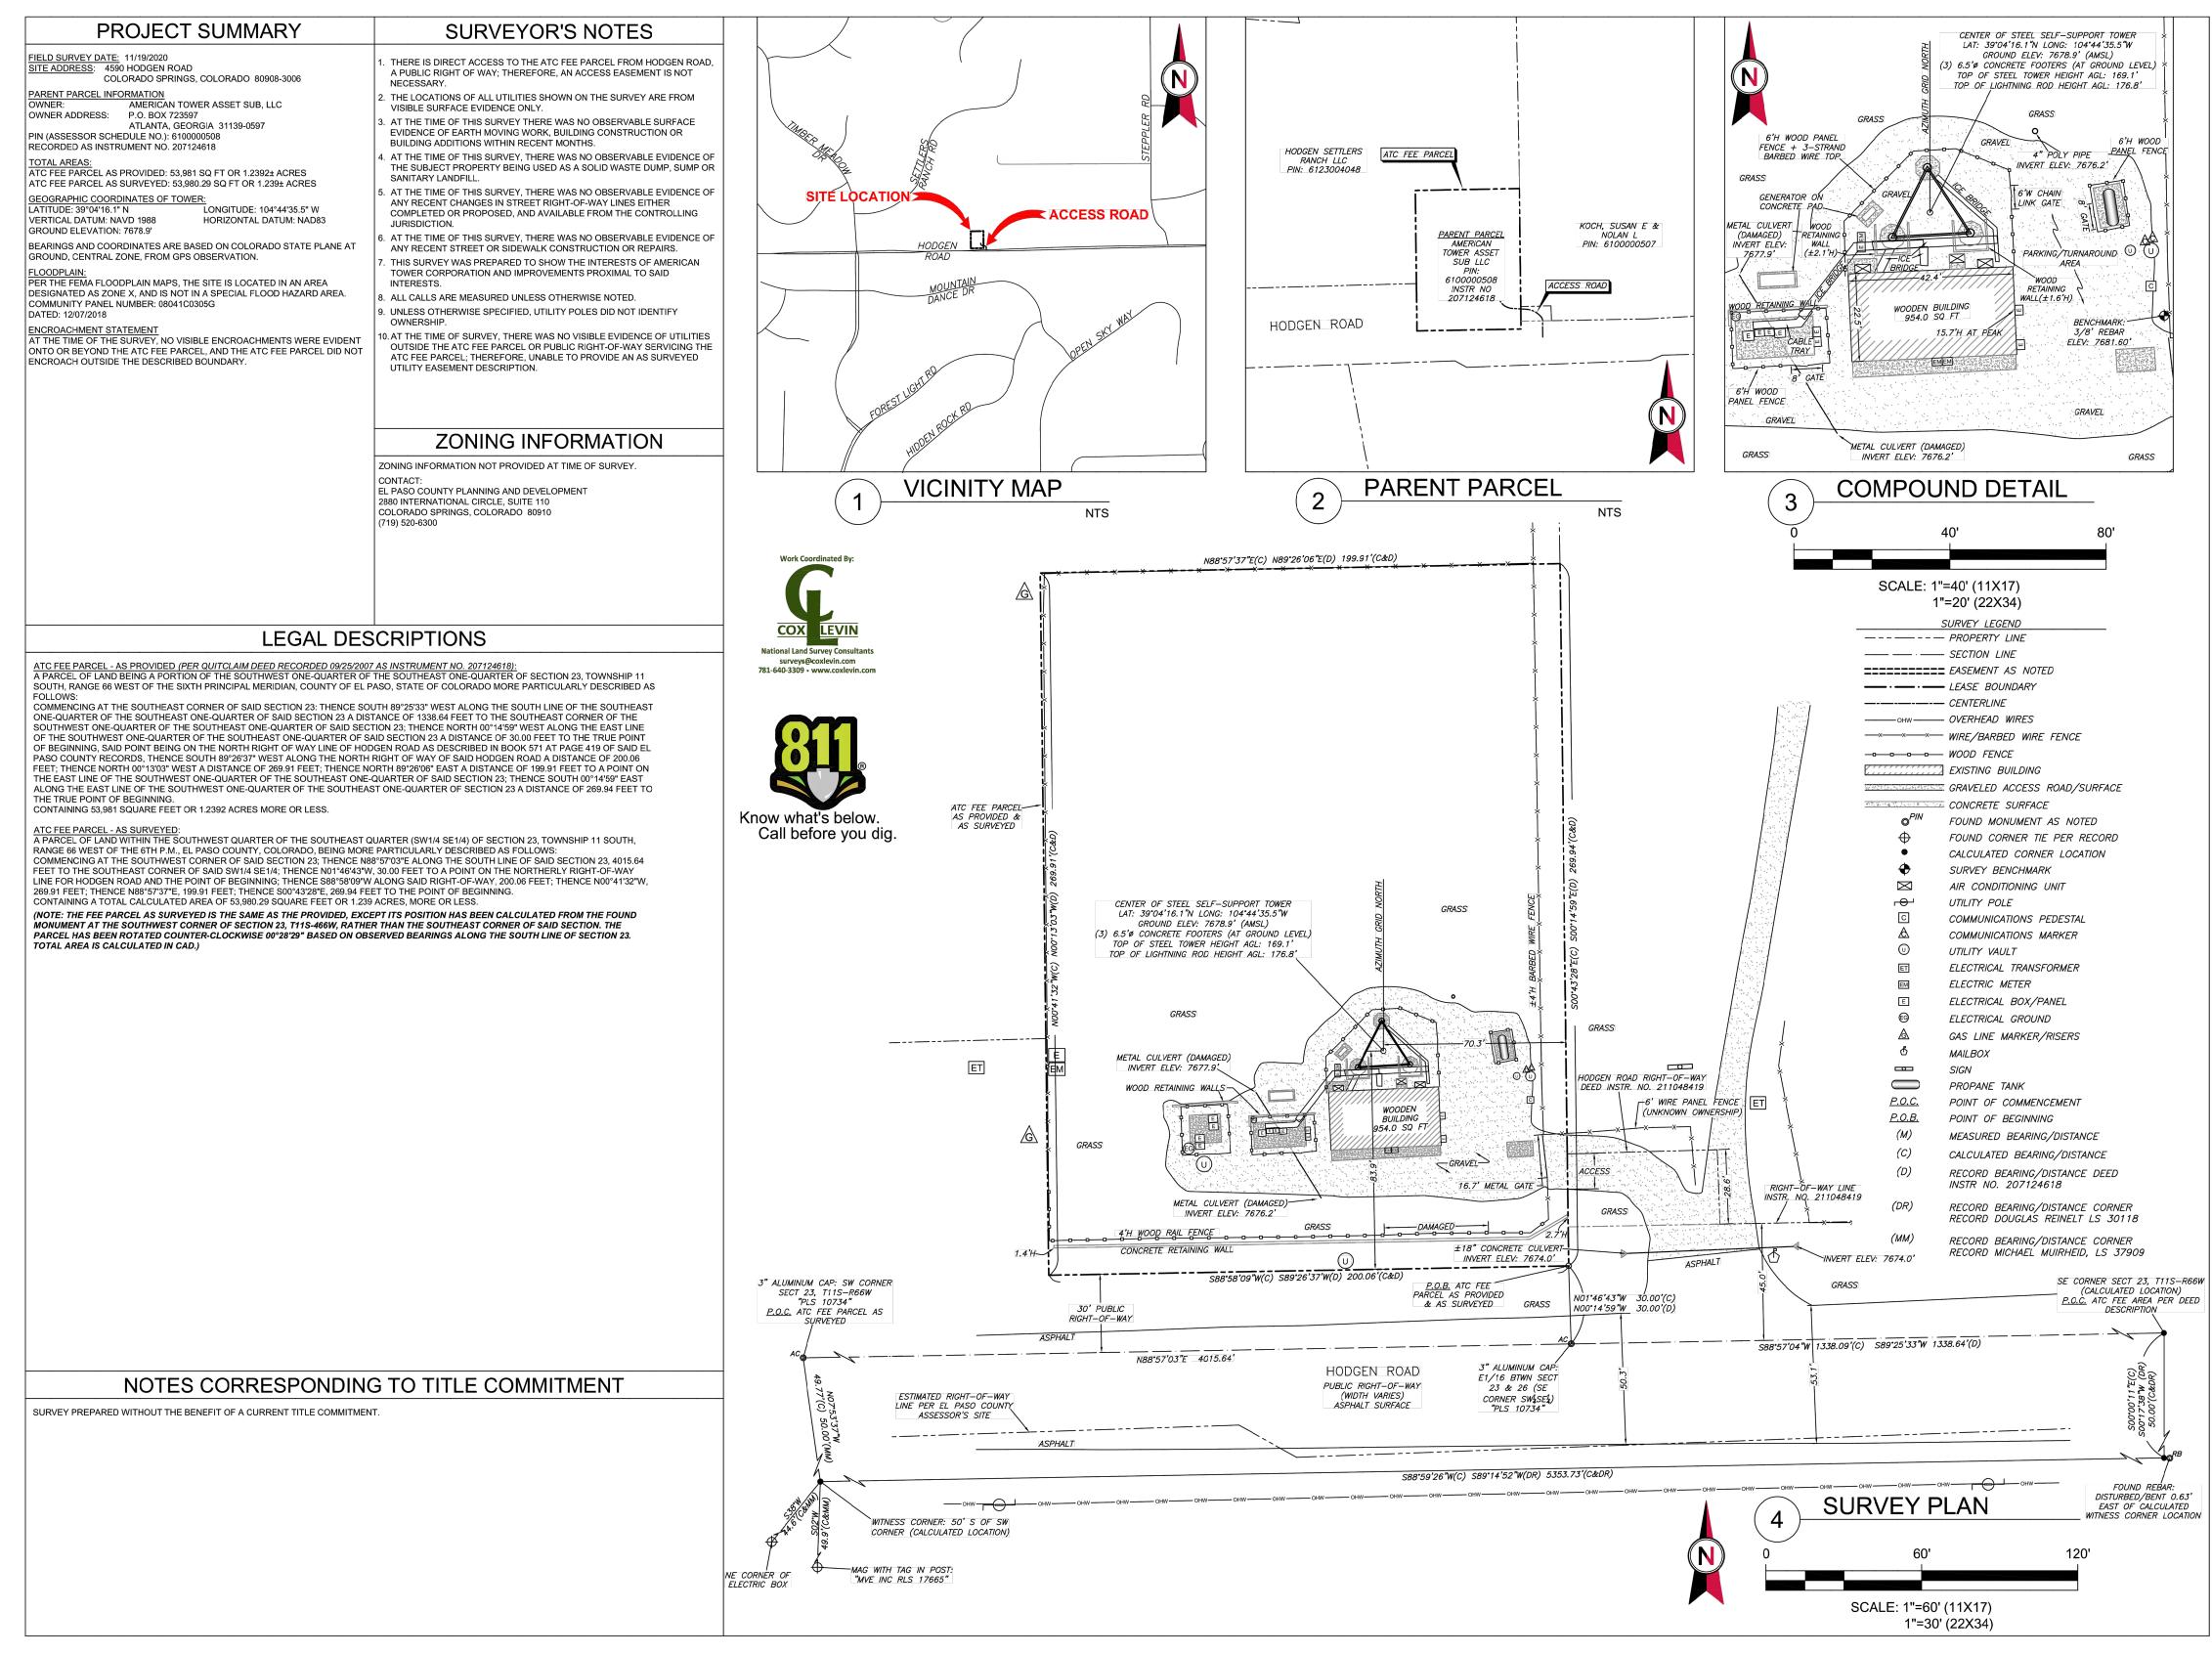



AMERICAN TOWER

ATC TOWER SERVICES, INC.

3500 REGENCY PARKWAY

SUITE 100

CARY, NC 27518

PHONE: (919) 468-0112

FAX: (919) 466-5415

THESE DRAWINGS AND/OR THE ACCOMPANYING SPECIFICATION AS INSTRUMENTS OR SERVICE ARE THE EXCLUSIVE PROPERTY OF AMERICAN TOWER. THEIR USE AND PUBLICATION SHALL BE RESTRICTED TO THE ORIGINAL SITE FOR WHICH THEY ARE PREPARED. ANY USE OR DISCLOSURE OTHER THAN THAT WHICH RELATES TO AMERICAN TOWER OR THE SPECIFIED CARRIER IS STRICTLY PROHIBITED. TITLE TO THESE DOCUMENTS SHALL REMAIN THE PROPERTY OF AMERICAN TOWER WHETHER OR NOT THE PROJECT IS EXECUTED. NEITHER THE ARCHITECT NOR THE ENGINEER WILL BE PROVIDING ON-SITE CONSTRUCTION REVIEW OF THIS PROJECT. CONTRACTOR(S) MUST VERIFY ALL DIMENSIONS AND ADVISE AMERICAN TOWER OF ANY DISCREPANCIES. ANY PRIOR ISSUANCE OF THIS DRAWING IS SUPERSEDED BY THE LATEST VERSION ON FILE WITH AMERICAN TOWER.

PRELIM HH 11/30/2020

CLIENT COMMENTS HH 12/07/2020

ATC SITE NUMBER:

302460 ATC SITE NAME:

BLACK FOREST

SITE ADDRESS:

4590 HODGEN ROAD COLORADO SPRINGS, COLORADO 80908-3006

SURVEY CERTIFICATE:
THIS IS TO CERTIFY THAT ARROW SURVEY
GROUP, INC., AT THE REQUEST AND FOR THE
EXCLUSIVE USE OF AMERICAN TOWER CORP. AND
NAME OF TITLE COMPANY, HAS PERFORMED THIS
AS-BUILT SURVEY OF THE ATC LEASE AREA, FROM
THE RECORD SOURCES AND ACTUAL FIELD
SURVEY ON 11/19/2020 IN ACCORDANCE WITH THE
MINIMUM STANDARDS OF PROPERTY BOUNDARY
SURVEYS. ALL LINEAR AND ANGULAR VALUES
SHOWN ARE BASED UPON DEED OR RECORD
INFORMATION UNLESS OTHERWISE NOTED.

DATE OF PLAT: <u>12/07/2020</u>

NAME: JASON D. LEVANEN CO LICENSE NO. 38159

SURVEY LOGO:

Survey Group, Inc.
Sheridan, WY 82801 (307)751-7543

DRAWN BY: HH

APPROVED BY: JL


DATE DRAWN: 12/07/2020

ATC JOB NO: 302460

AS-BUILT/TITLE & BOUNDARY PLAN

REVISION:

V-101

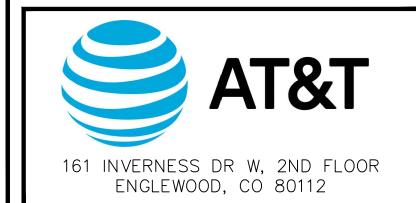



19100 VON KARMAN AVE SUITE 200 IRVINE, CA 92612



AT&T SITE ID: COL02237
AT&T FA CODE: 15312482
AT&T PACE #: MRUTH042457
ATC #: 302460
BLACK FOREST

4590 HODGEN RD COLORADO SPRINGS, CO 80908 (EL PASO COUNTY)

EXISTING 170'-0" W/ 20'
EXTENSION
SELF-SUPPORT TOWER
NSB - LTE - 1C/2C/3C/4C/5G NR
1SR

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В	12-10-20	СВМ	90% CONSTRUCTION	EGG			
С	02-17-21	BCL	90% CONSTRUCTION	EGG			

SEAL:



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SHEET TITLE:


SITE SURVEY I

SHEET NUMBER:

REVISION:

TEP #: 85 | 72.243629

SITE SURVEY

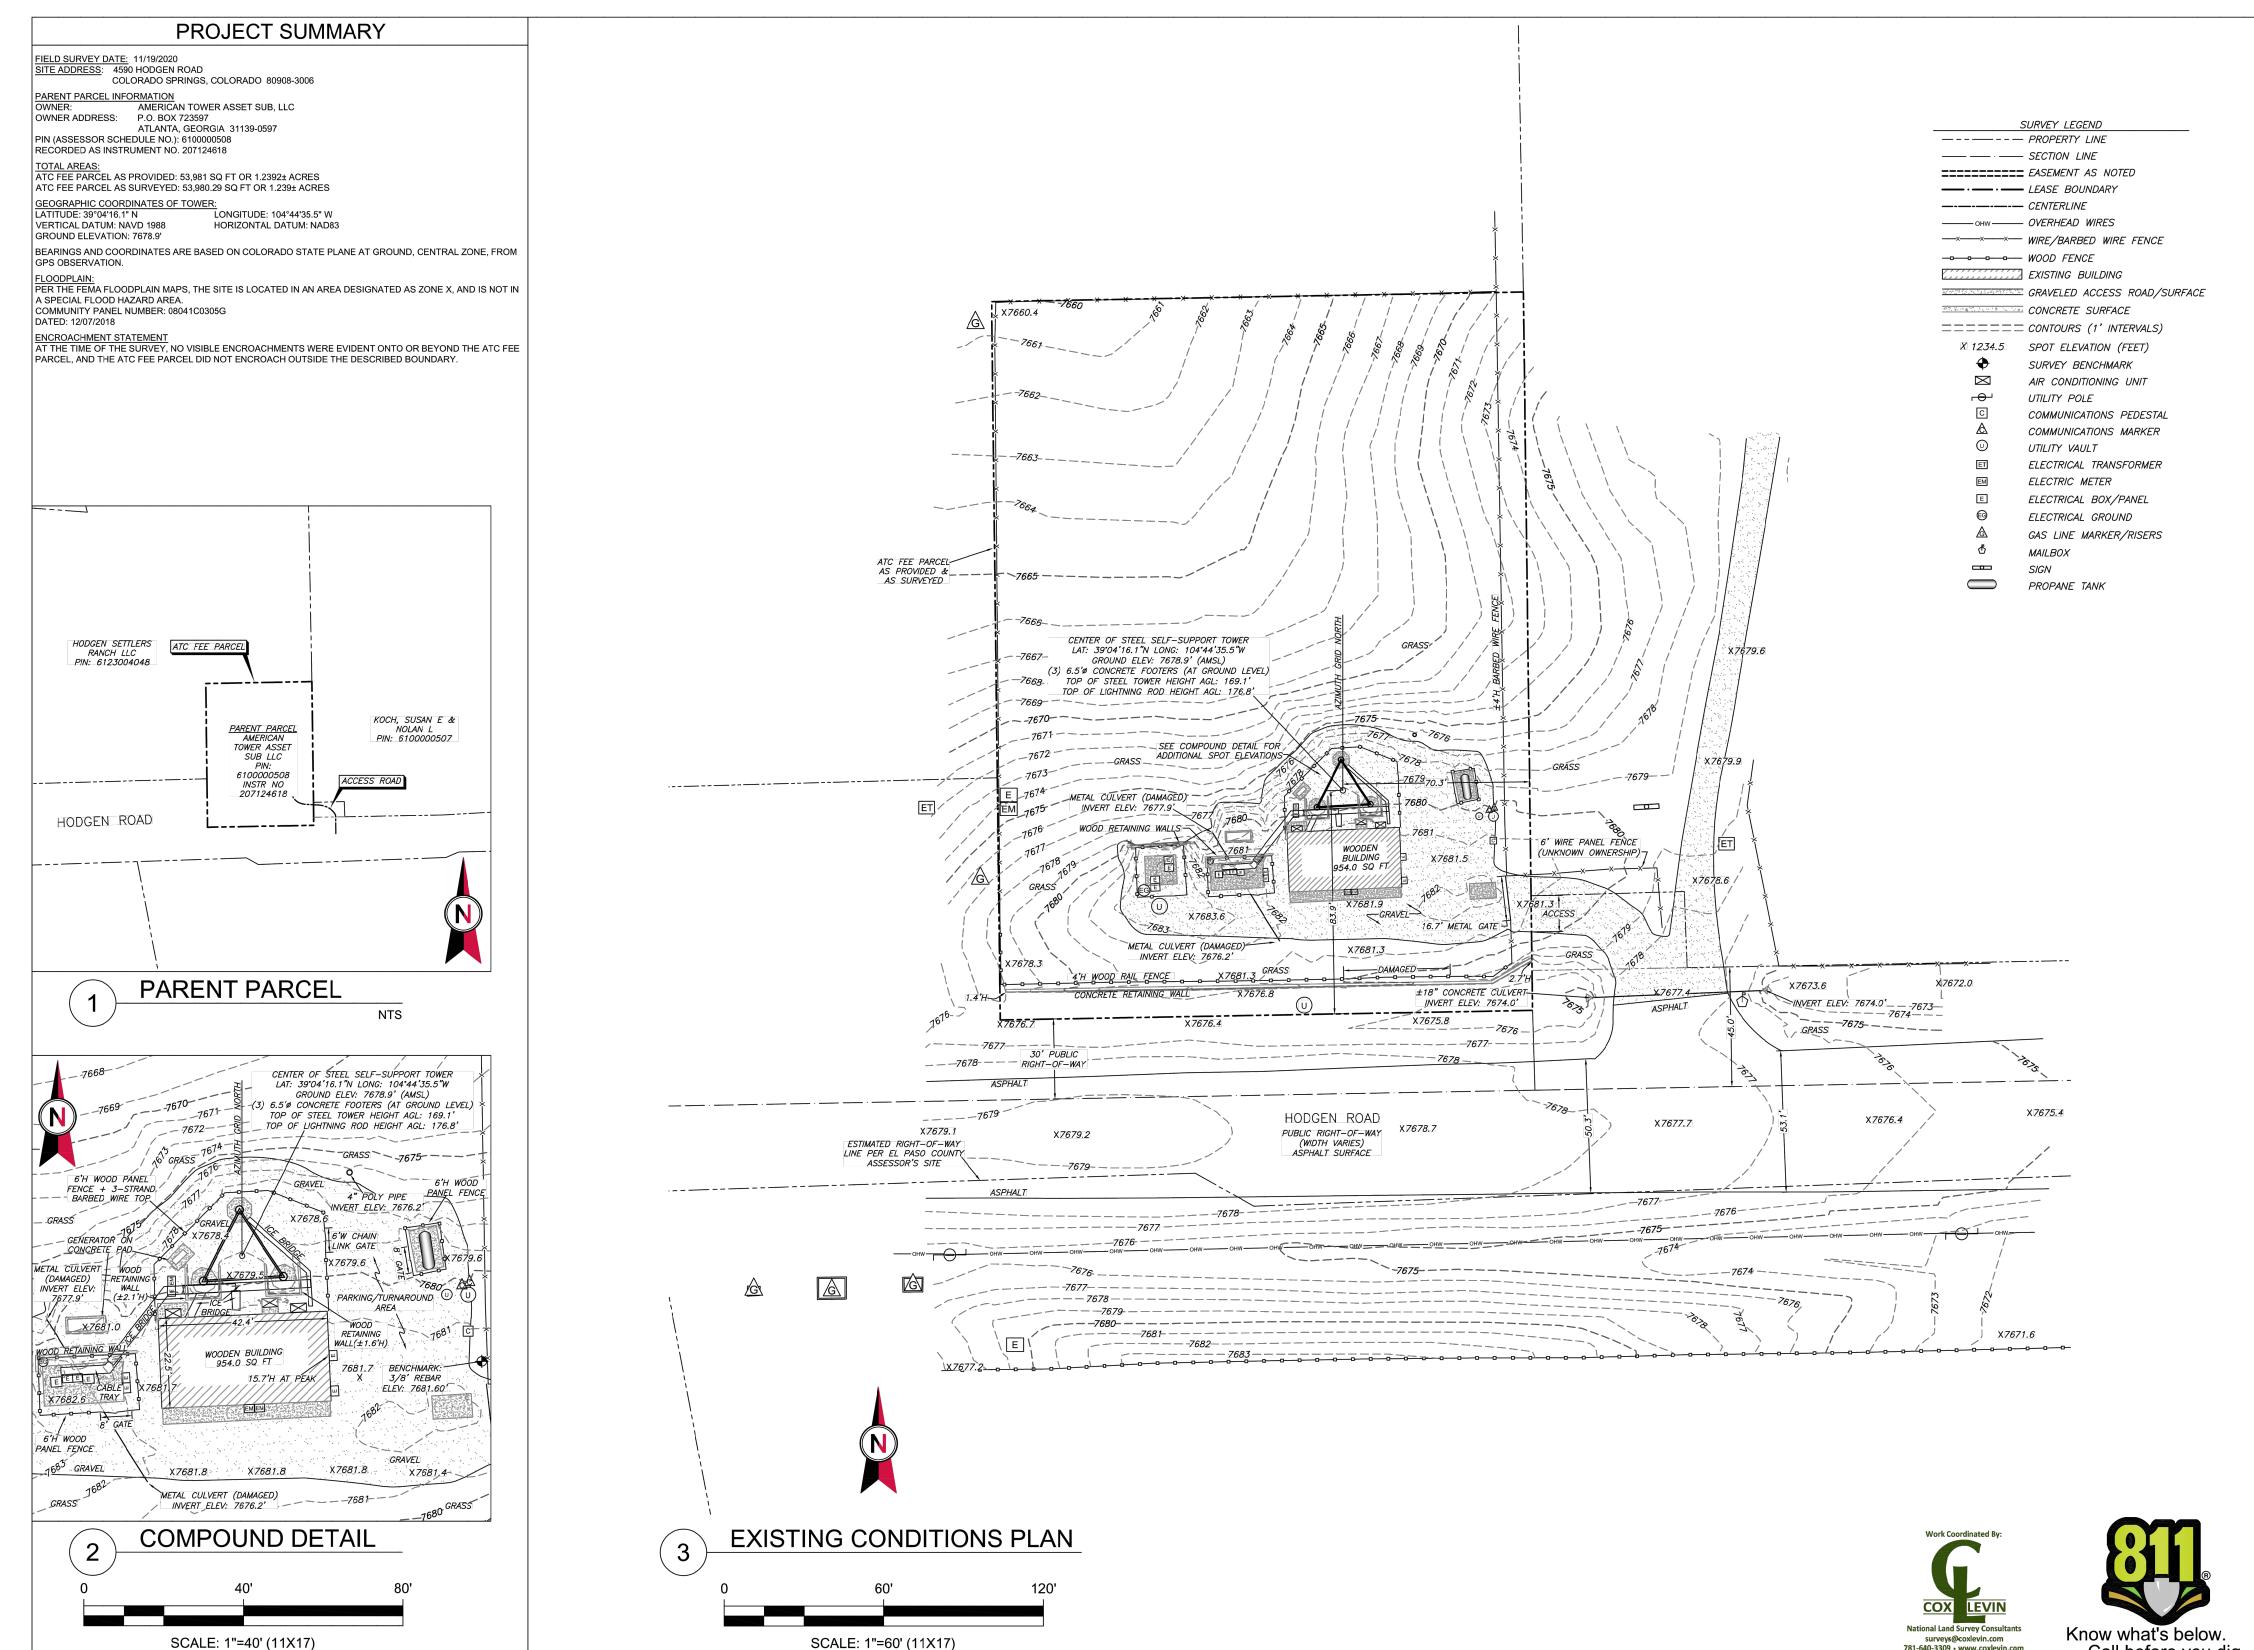

1"=30' (22X34)



AMERICAN TOWER

ATC TOWER SERVICES, INC. 3500 REGENCY PARKWAY SUITE 100 CARY, NC 27518 PHONE: (919) 468-0112 FAX: (919) 466-5415

THESE DRAWINGS AND/OR THE ACCOMPANYING SPECIFICATION AS INSTRUMENTS OR SERVICE ARE THE EXCLUSIVE PROPERTY OF AMERICAN TOWER. THEIR USE AND PUBLICATION SHALL BE RESTRICTED TO THE ORIGINAL SITE FOR WHICH THEY ARE PREPARED. ANY USE OR DISCLOSURE OTHER THAN THAT WHICH RELATES TO AMERICAN TOWER OR THE SPECIFIED CARRIER IS STRICTLY PROHIBITED. TITLE TO THESE DOCUMENTS SHALL REMAIN THE PROPERTY OF AMERICAN TOWER WHETHER OR NOT THE PROJECT IS EXECUTED NEITHER THE ARCHITECT NOR THE ENGINEER WILL BE PROVIDING ON-SITE CONSTRUCTION REVIEW OF THIS PROJECT. CONTRACTOR(S) MUST VERIFY ALL DIMENSIONS AND ADVISE AMERICAN TOWER OF ANY DISCREPANCIES. ANY PRIOR ISSUANCE OF THIS DRAWING IS SUPERSEDED BY THE LATEST VERSION ON FILE WITH AMERICAN TOWER.

PRELIM HH 11/30/2020 CLIENT COMMENTS HH 12/07/2020

> ATC SITE NUMBER: 302460

ATC SITE NAME:

BLACK FOREST

SITE ADDRESS:

4590 HODGEN ROAD COLORADO SPRINGS, COLORADO 80908-3006

SURVEY CERTIFICATE: THIS IS TO CERTIFY THAT ARROW SURVEY GROUP, INC., AT THE REQUEST AND FOR THE EXCLUSIVE USE OF AMERICAN TOWER CORP. AND NAME OF TITLE COMPANY, HAS PERFORMED THIS AS-BUILT SURVEY OF THE ATC LEASE AREA. FROM THE RECORD SOURCES AND ACTUAL FIELD SURVEY ON 11/19/2020 IN ACCORDANCE WITH THE MINIMUM STANDARDS OF PROPERTY BOUNDARY SURVEYS. ALL LINEAR AND ANGULAR VALUES SHOWN ARE BASED UPON DEED OR RECORD INFORMATION UNLESS OTHERWISE NOTED.

DATE OF PLAT: <u>12/07/2020</u>

NAME: JASON D. LEVANEN CO LICENSE NO. 88159

SURVEY LOGO:



Sheridan, WY 82801 (307)751-7543 DRAWN BY: APPROVED BY: | JL DATE DRAWN: | 12/07/2020 ATC JOB NO: 302460

EXISTING CONDITIONS AND TOPOGRAPHIC PLAN

SHEET NUMBER:

Call before you dig.

V-102

REVISION:





AMERICAN TOWER® 19100 VON KARMAN AVE SUITE 200

IRVINE, CA 92612



AT&T SITE ID: COL02237 AT&T FA CODE: 15312482 **AT&T PACE #: MRUTH042457** ATC #: 302460 **BLACK FOREST**

4590 HODGEN RD COLORADO SPRINGS, CO 80908 (EL PASO COUNTY)

EXISTING 170'-0" W/ 20' EXTENSION SELF-SUPPORT TOWER NSB - LTE - 1C/2C/3C/4C/5G NR 1SR

ISSUED FOR:							
REV	DATE	DRWN	DESCRIPTION	QA			
А	11-23-20	RRG	PRELIMINARY	EGG			
В	12-10-20	СВМ	90% CONSTRUCTION	EGG			
С	02-17-21	BCL	90% CONSTRUCTION	EGG			

SEAL:



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SHEET TITLE:

SITE SURVEY II

SHEET NUMBER:

REVISION:

TEP #: 85172.243629


SITE SURVEY


1"=20' (22X34)

NOTES:

1. THIS SITE PLAN REPRESENTS THE BEST PRESENT KNOWLEDGE AVAILABLE TO THE ENGINEER AT THE TIME OF THIS DESIGN. THE CONTRACTOR SHALL VISIT THE SITE PRIOR TO CONSTRUCTION AND VERIFY ALL EXISTING CONDITIONS RELATED TO THE SCOPE OF WORK FOR THIS PROJECT.

- 2. ICE BRIDGE, CABLE LADDER, COAX PORT, AND COAX CABLE ARE SHOWN FOR REFERENCE ONLY. CONTRACTOR SHALL CONFIRM THE EXACT LOCATION OF ALL PROPOSED AND EXISTING EQUIPMENT AND STRUCTURES DEPICTED ON THIS PLAN. BEFORE UTILIZING EXISTING CABLE SUPPORTS, COAX PORTS, INSTALLING NEW PORTS OR ANY OTHER EQUIPMENT, CONTRACTOR SHALL VERIFY ALL ASPECTS OF THE COMPONENTS MEET THE ATC SPECIFICATIONS.
- 3. IT IS THE RESPONSIBILITY OF THE CONTRACTOR TO COORDINATE WITH THE AT&T REPRESENTATIVE AND LOCAL UTILITY COMPANY FOR THE INSTALLATION OF CONDUITS, CONDUCTORS, BREAKERS, DISCONNECTS, OR ANY OTHER EQUIPMENT REQUIRED FOR ELECTRICAL SERVICE. ALL ELECTRICAL WORK SHALL BE PERFORMED IN ACCORDANCE WITH LATEST EDITION OF THE STATE AND NATIONAL CODES, ORDINANCES AND REGULATIONS APPLICABLE TO THIS PROJECT.
- 4. UTILITY COORDINATION PENDING.

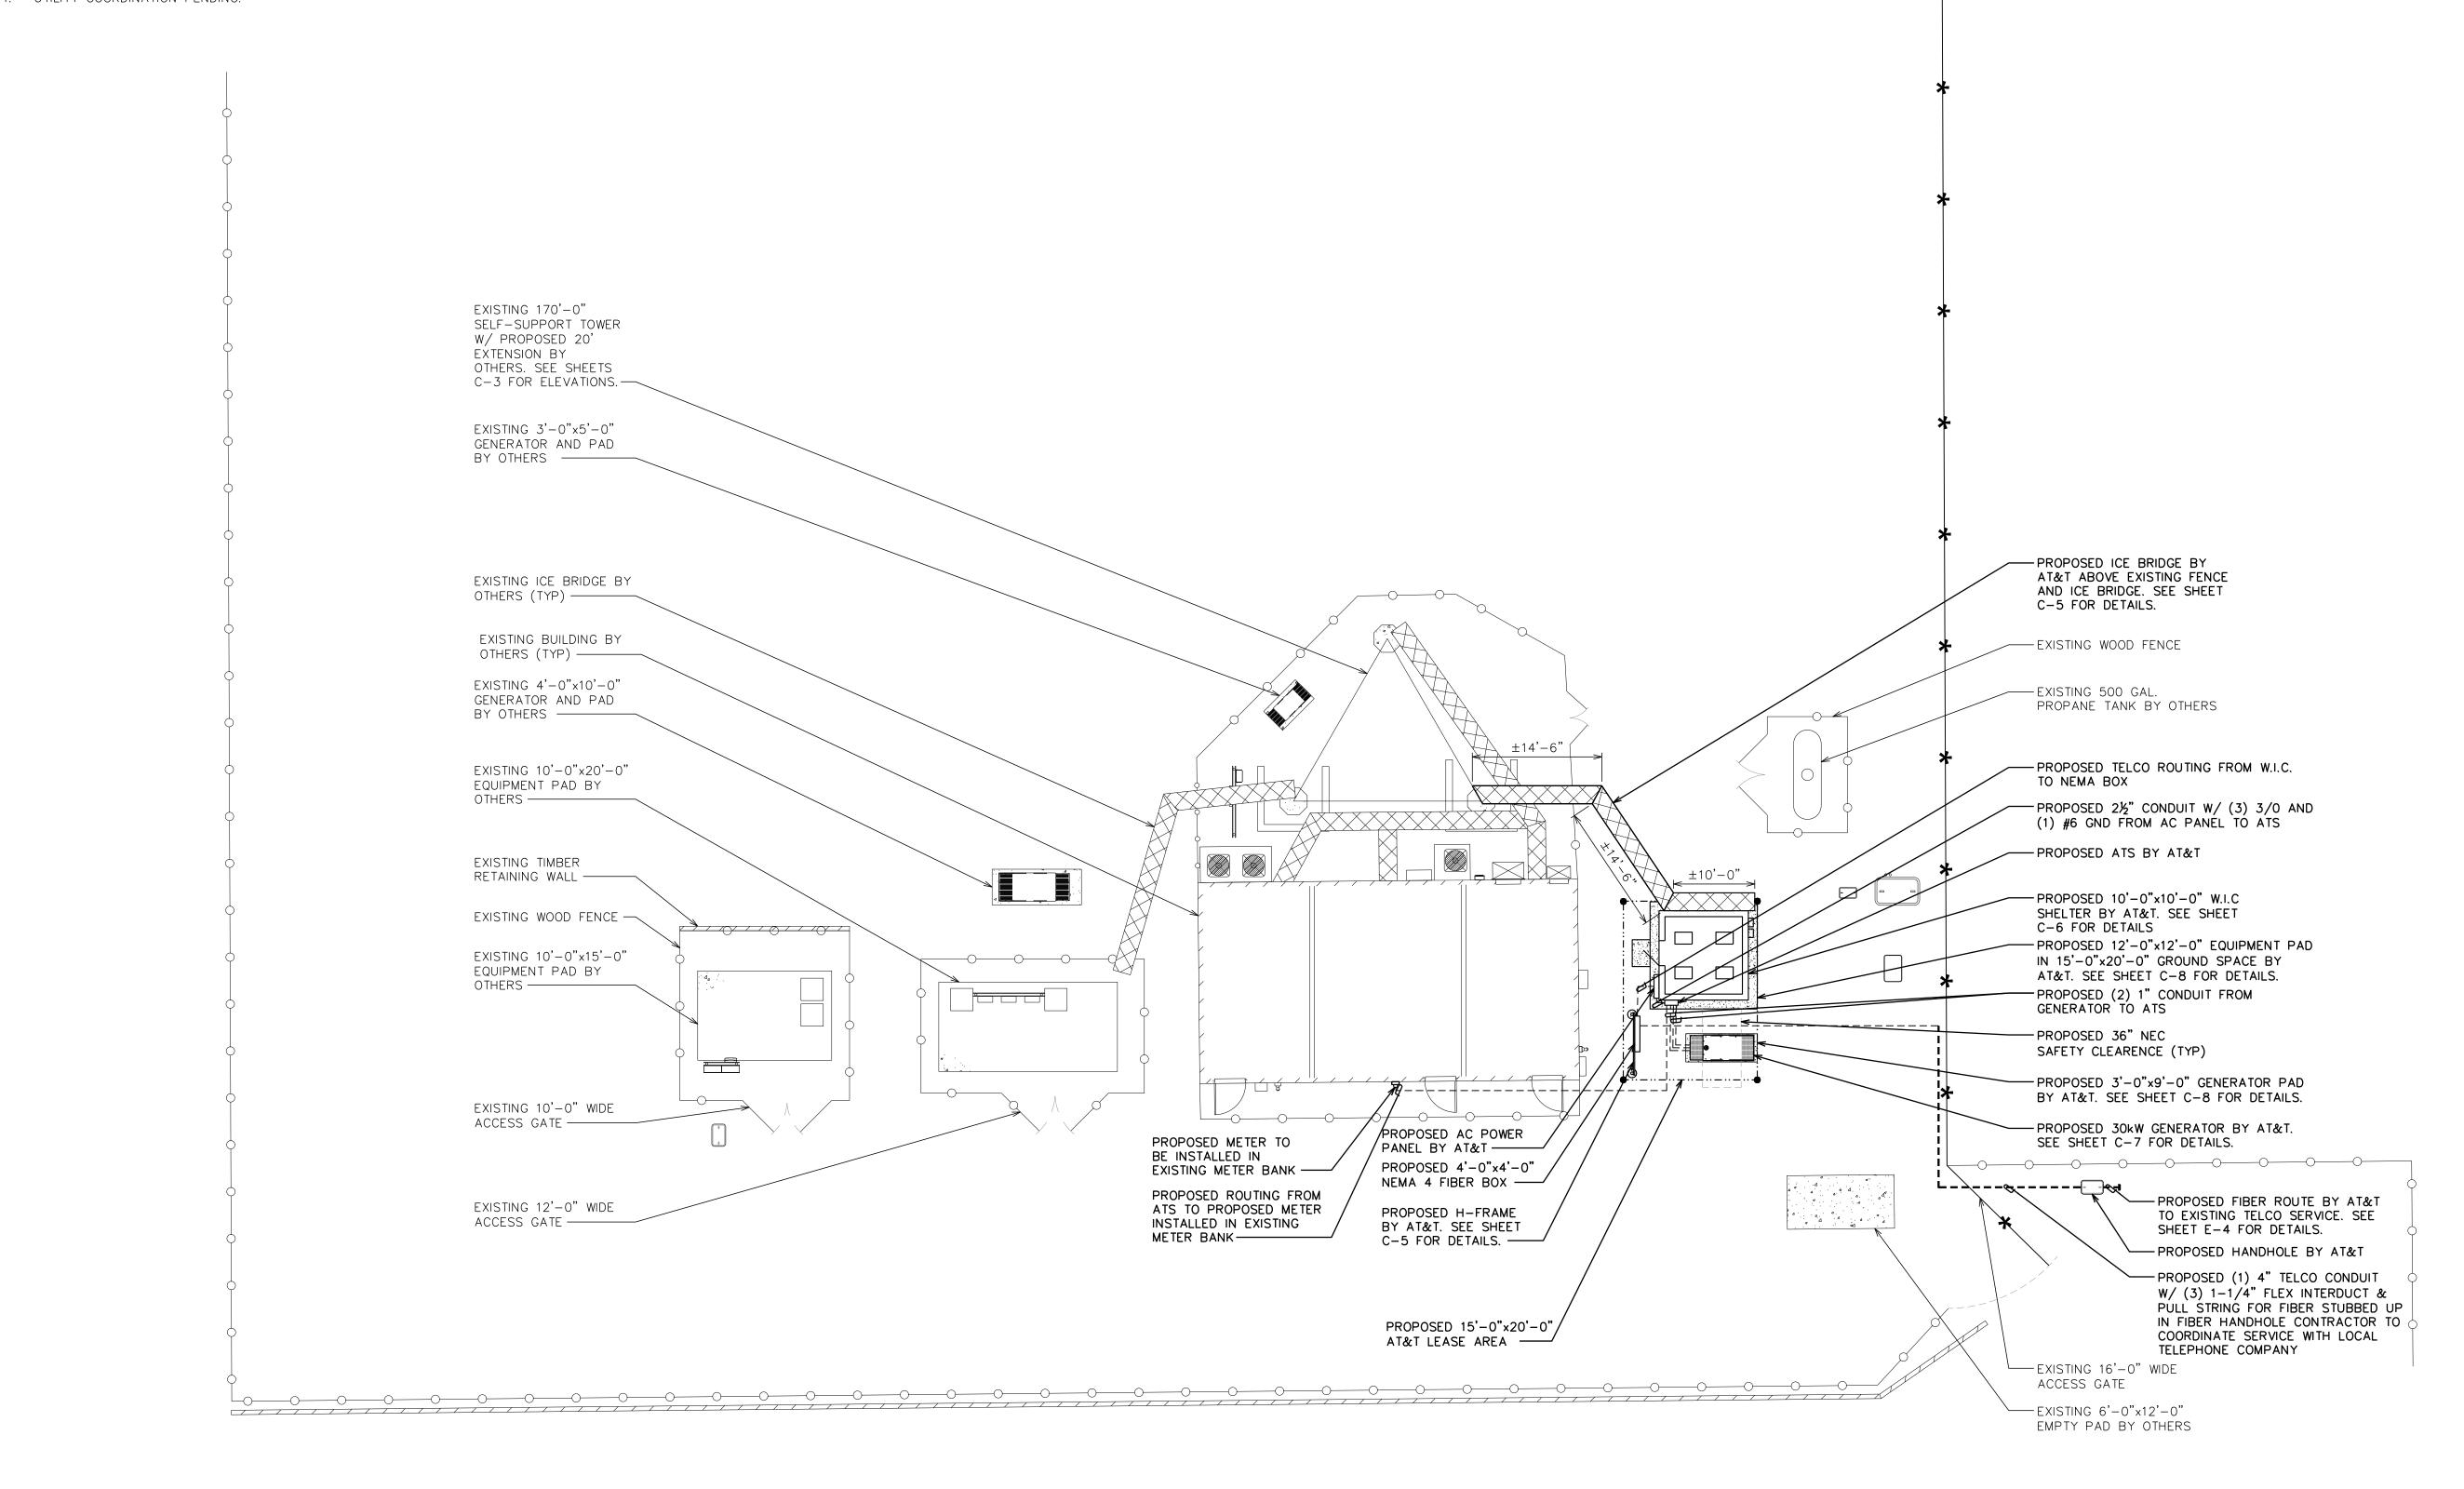

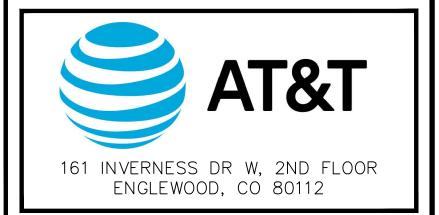



19100 VON KARMAN AVE SUITE 200 IRVINE, CA 92612

TOWER ENGINEERING PROFESSIONALS
4710 E ELWOOD ST, STE 9
PHOENIX, AZ 85040
OFFICE: (480) 285-0036
www.tepgroup.net

AT&T SITE ID: COL02237
AT&T FA CODE: 15312482
AT&T PACE #: MRUTH042457
ATC #: 302460
BLACK FOREST

4590 HODGEN RD COLORADO SPRINGS, CO 80908 (EL PASO COUNTY)

EXISTING 170'-0" W/ 20'
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SELF-SUPPORT TOWER
NSB - LTE - 1C/2C/3C/4C/5G NR
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SEAL:



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SHEET TITLE:

COMPOUND DETAIL

SHEET NUMBER:

REVISION:

TEP #: 85172.243629


 \bigcirc

SCALE: 1" = 10' (24x36)

SCALE: 1" = 20' (11x17)

SCALE IN FEET

 \bigcirc

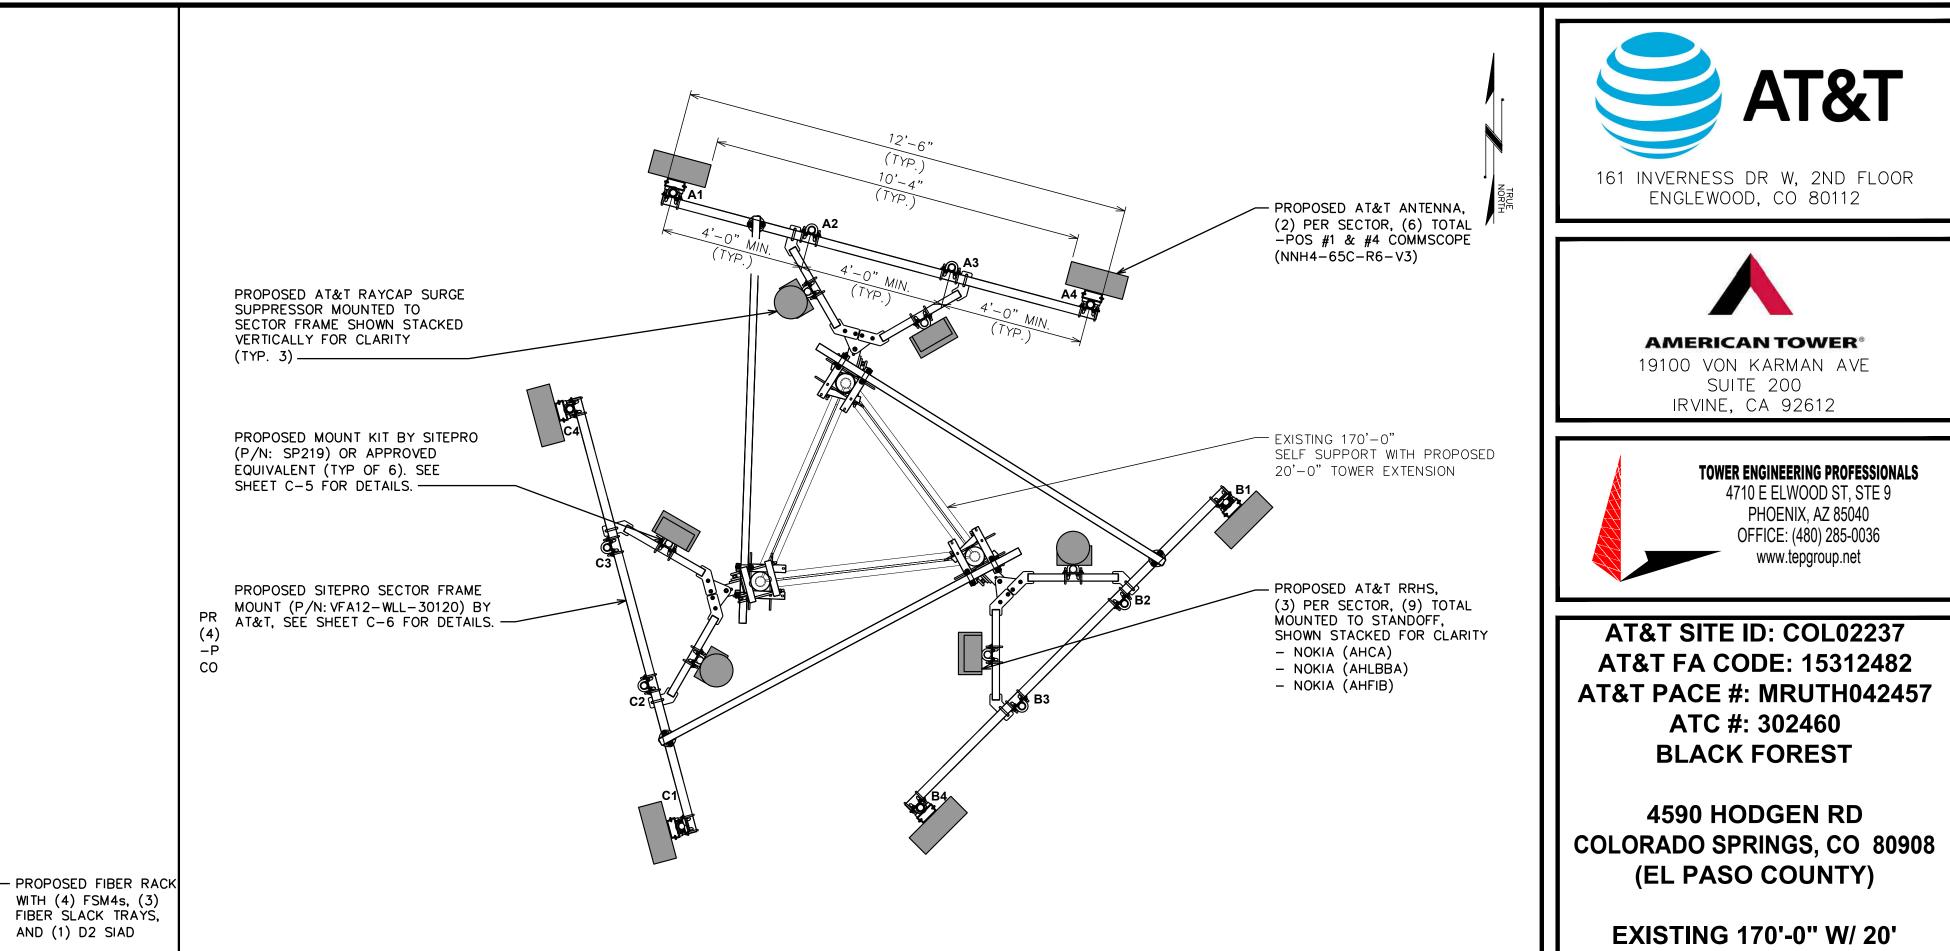

FINAL ANTENNA LAYOUT

SCALE: $\frac{3}{16}$ " = 1'-0" (11x17)

SCALE: $\frac{3}{8}$ " = 1'-0" (24×36)

SCALE IN FEET

EXTENSION SELF-SUPPORT TOWER NSB - LTE - 1C/2C/3C/4C/5G NR 1SR

161 INVERNESS DR W, 2ND FLOOR ENGLEWOOD, CO 80112

> **AMERICAN TOWER®** 19100 VON KARMAN AVE SUITE 200 IRVINE, CA 92612

AT&T SITE ID: COL02237

AT&T FA CODE: 15312482

ATC #: 302460

BLACK FOREST

4590 HODGEN RD

(EL PASO COUNTY)

EXISTING 170'-0" W/ 20'

TOWER ENGINEERING PROFESSIONALS

4710 E ELWOOD ST, STE 9 PHOENIX, AZ 85040

OFFICE: (480) 285-0036 www.tepgroup.net

ISSUED FOR:							
REV	DATE	DRWN	DESCRIPTION	QA			
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SHEET TITLE:

FINAL EQUIPMENT & **ANTENNA LAYOUTS**

SHEET NUMBER: REVISION:

85172.243629

TEP #:

FINAL ANTENNA SCHEDULE

NOTE: SCHEDULE EQUIPMENT SHOULD BE REFERENCED OFF RFDS LISTED ON SHEET T-1.

SECTOR	POS.	MANUFACTURER (MODEL #)	ANTENNA TIP HEIGHT	ANTENNA POSITION SEPARATION	CABLE SIZE	CABLE LENGTH	SQUID/RRH/TMA/DIPLEXER [MODEL #]
ALPHA	1	COMMSCOPE *(NNH4-65C-R6-V3)	190'-0"±				(1) RAYCAP SQUID [DC9-48-60-24-8C-EV]
ALPHA	2	_	_		*(1) NC *(1) N *(1) N *(1) N TRUNKS		*(1) NOKIA RRH [AIRSCALE DUAL RRH 4T4R B25/66 320\ AHFIB] *(1) NOKIA RRH [AIRSCALE TRI RRH 4T4R B12/14 370W
ALPHA	3	-	_			AHLBBA] *(1) NOKIA RRH [AIRSCALE DUAL RRH 4T4R B5 160W	
ALPHA	4	COMMSCOPE *(NNH4-65C-R6-V3)	190'-0"±			AHCA]	
ВЕТА	1	COMMSCOPE *(NNH4-65C-R6-V3)	190'-0"±			285'±	(1) RAYCAP SQUID [DC9-48-60-24-8C-EV]
ВЕТА	2	-	_	4'-0"			*(1) NOKÍA RRH [AIRSCALE DUAL RRH 4T4R B25/66 320 AHFIB] *(1) NOKIA RRH [AIRSCALE TRI RRH 4T4R B12/14 370W
ВЕТА	3	_	_		(6) 6 AWG 6 0.92" DC TRUNKS		AHLBBA] *(1) NOKIA RRH [AIRSCALE DUAL RRH 4T4R B5 160W
ВЕТА	4	COMMSCOPE *(NNH4-65C-R6-V3)	190'-0"±				AHCA]
GAMMA	1	COMMSCOPE *(NNH4-65C-R6-V3)	190'-0"±				(1) RAYCAP SQUID [DC9-48-60-24-8C-EV]
GAMMA	2	_	-				*(1) NOKIA RRH [AIRSCALE DUAL RRH 4T4R B25/66 320 AHFIB] *(1) NOKIA RRH [AIRSCALE TRI RRH 4T4R B13/14 370W
GAMMA	3	-	_				*(1) NOKIA RRH [AIRSCALE TRI RRH 4T4R B12/14 370W AHLBBA] *(1) NOKIA RRH [AIRSCALE DUAL RRH 4T4R B5 160W
GAMMA	4	COMMSCOPE *(NNH4-65C-R6-V3)	190'-0"±				AHCA]

*OR APPROVED EQUIVALENT

**CONTRACTOR TO REFER TO THE RFDS FOR FINAL CONFIGURATION

PROPOSED DC FIF RACK
WITH (3) PROPOSED RACK
MOUNTED DC-12 97-1010WICSTRKT 97-DCGENPORTKIT **EXTERIOR MOUNTED** PANEL WITH 2 STAIR KIT DC GENERATOR PORTS

(1) POWER RACK

97-MICWVPRTKIT

MICROWAVE PORTS

97-9CBLPORTKIT

PANEL WITH 4 9-ENTRY PORTS


(KIT INCLUDES 2 PANELS)

PANEL WITH

FINAL EQUIPMENT LAYOUT

(3) EQUIPMENT

RACKS

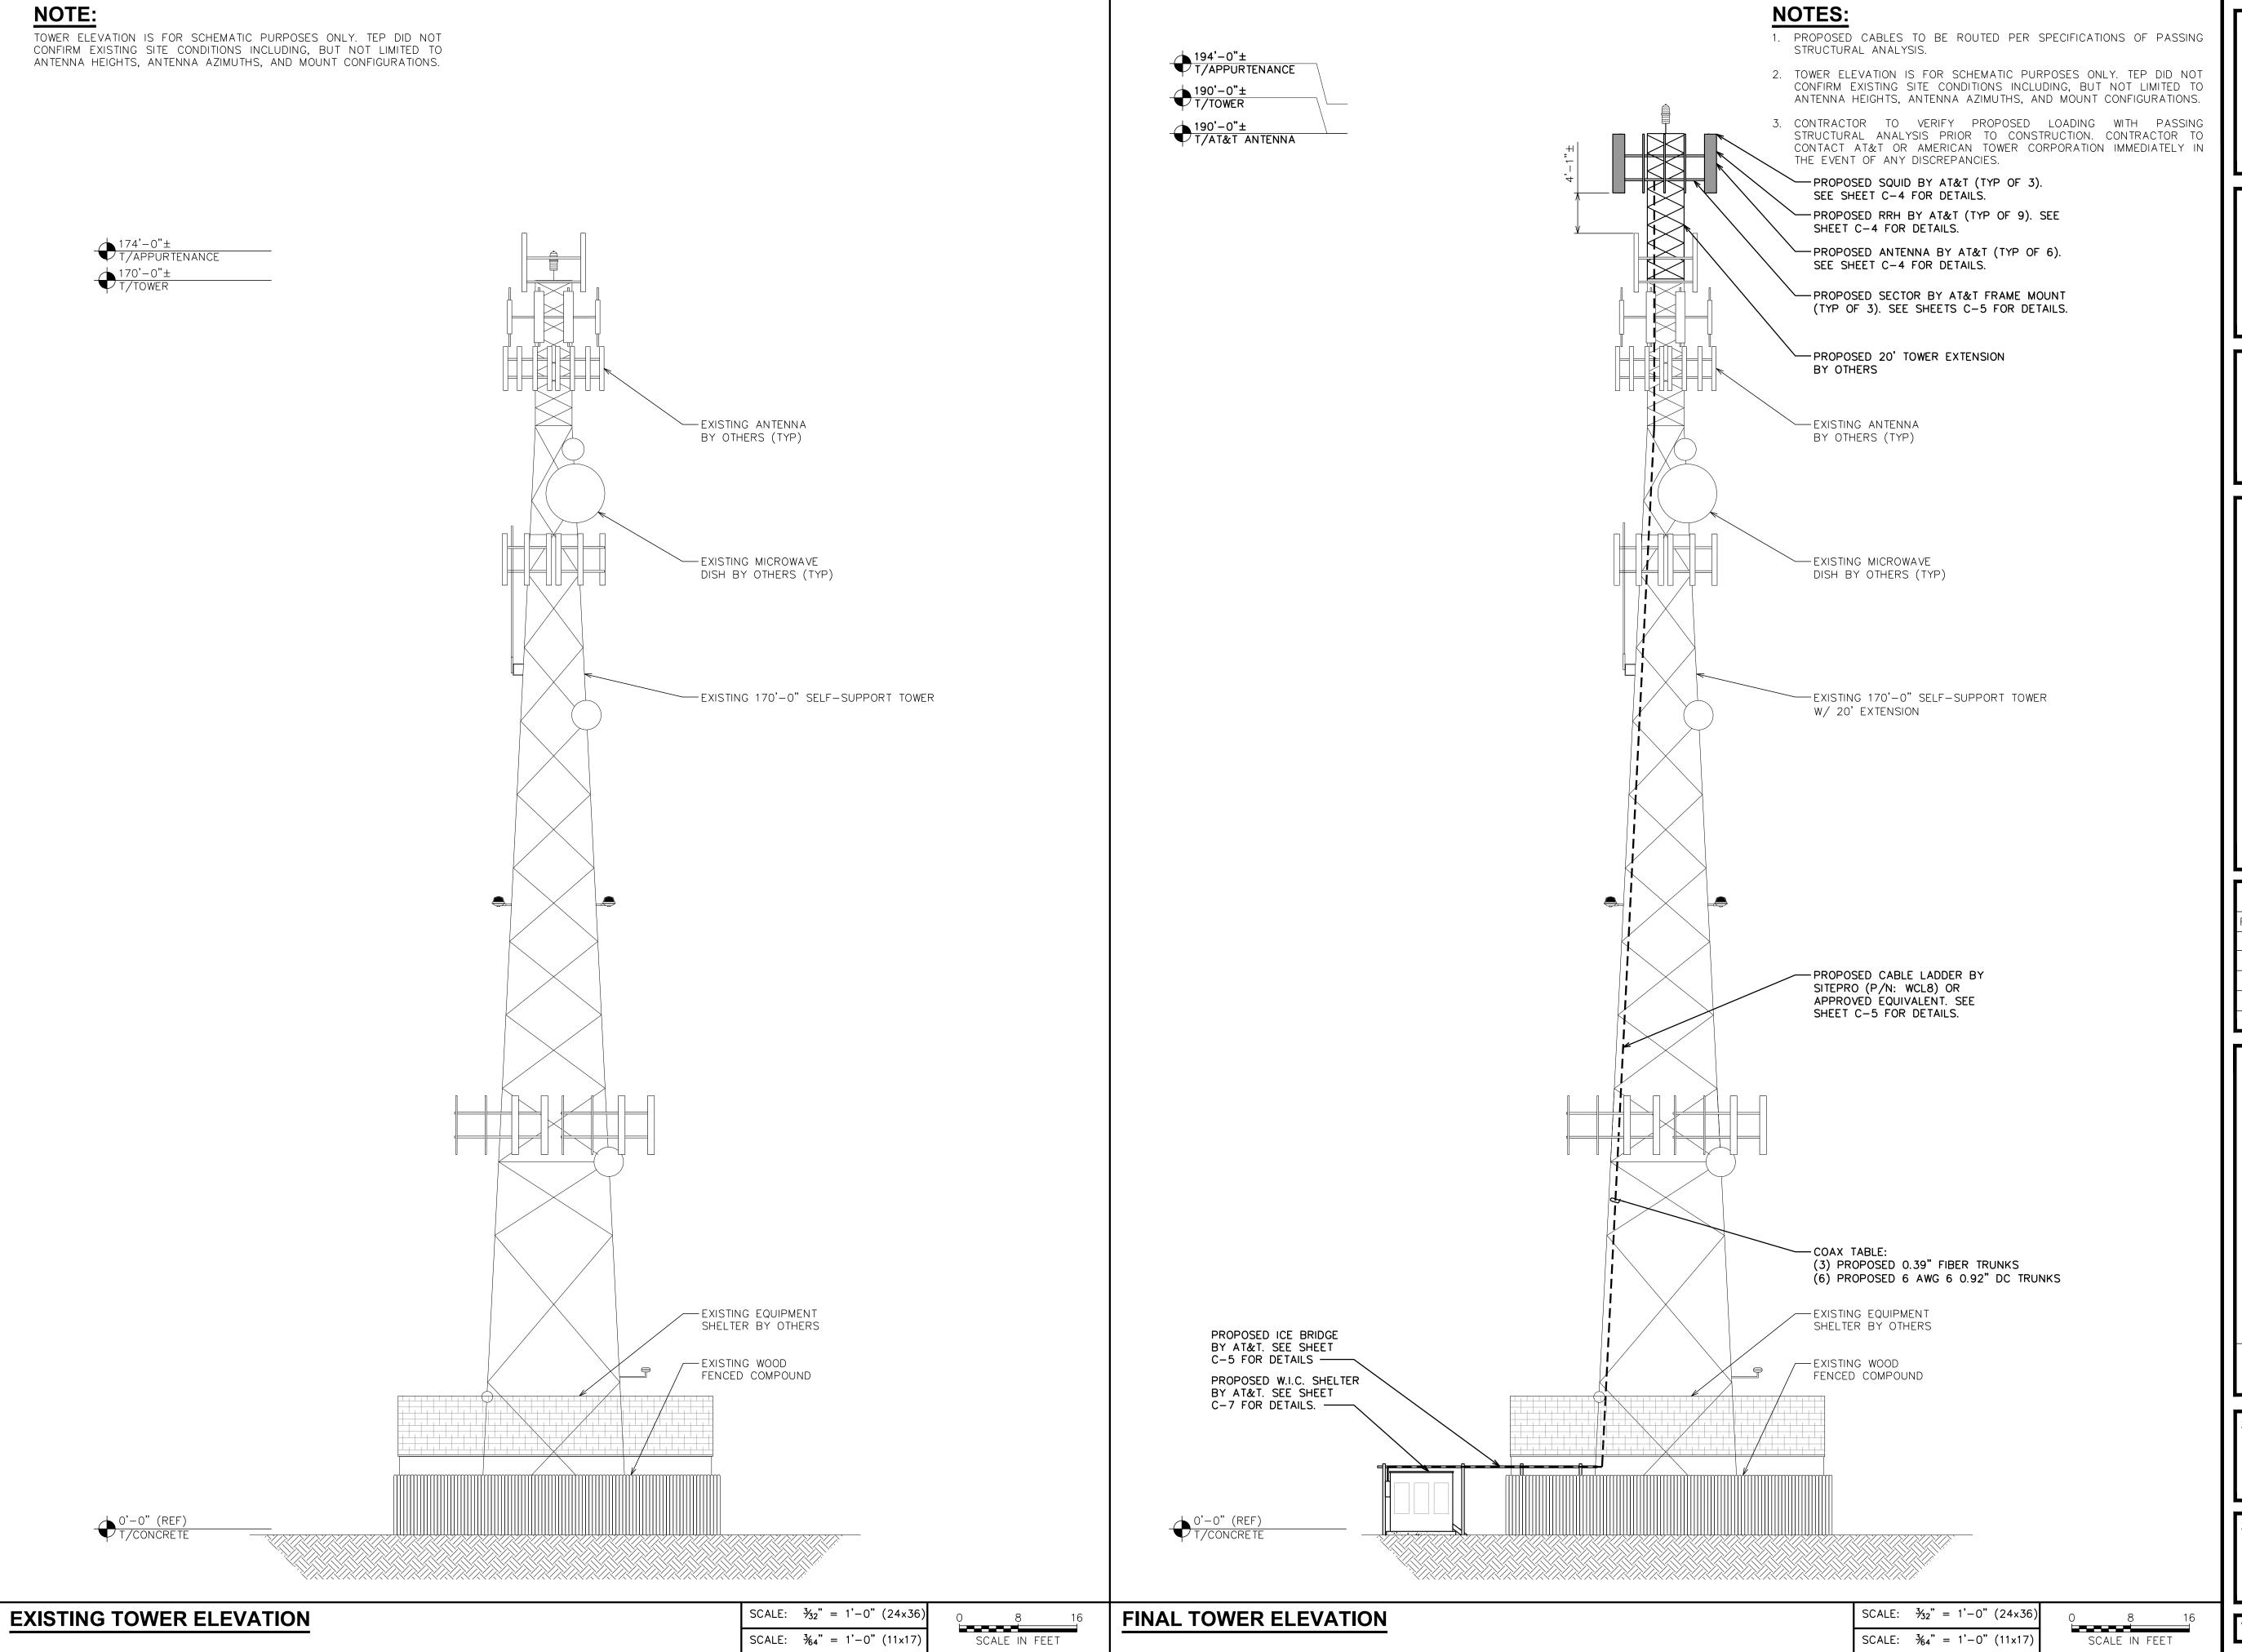





AMERICAN TOWER®

19100 VON KARMAN AVE
SUITE 200

IRVINE, CA 92612

TOWER ENGINEERING PROFESSIONALS

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PHOENIX, AZ 85040
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www.tepgroup.net

AT&T SITE ID: COL02237
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ATC #: 302460
BLACK FOREST

4590 HODGEN RD COLORADO SPRINGS, CO 80908 (EL PASO COUNTY)

EXISTING 170'-0" W/ 20'
EXTENSION
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NSB - LTE - 1C/2C/3C/4C/5G NR
1SR

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SEAL:



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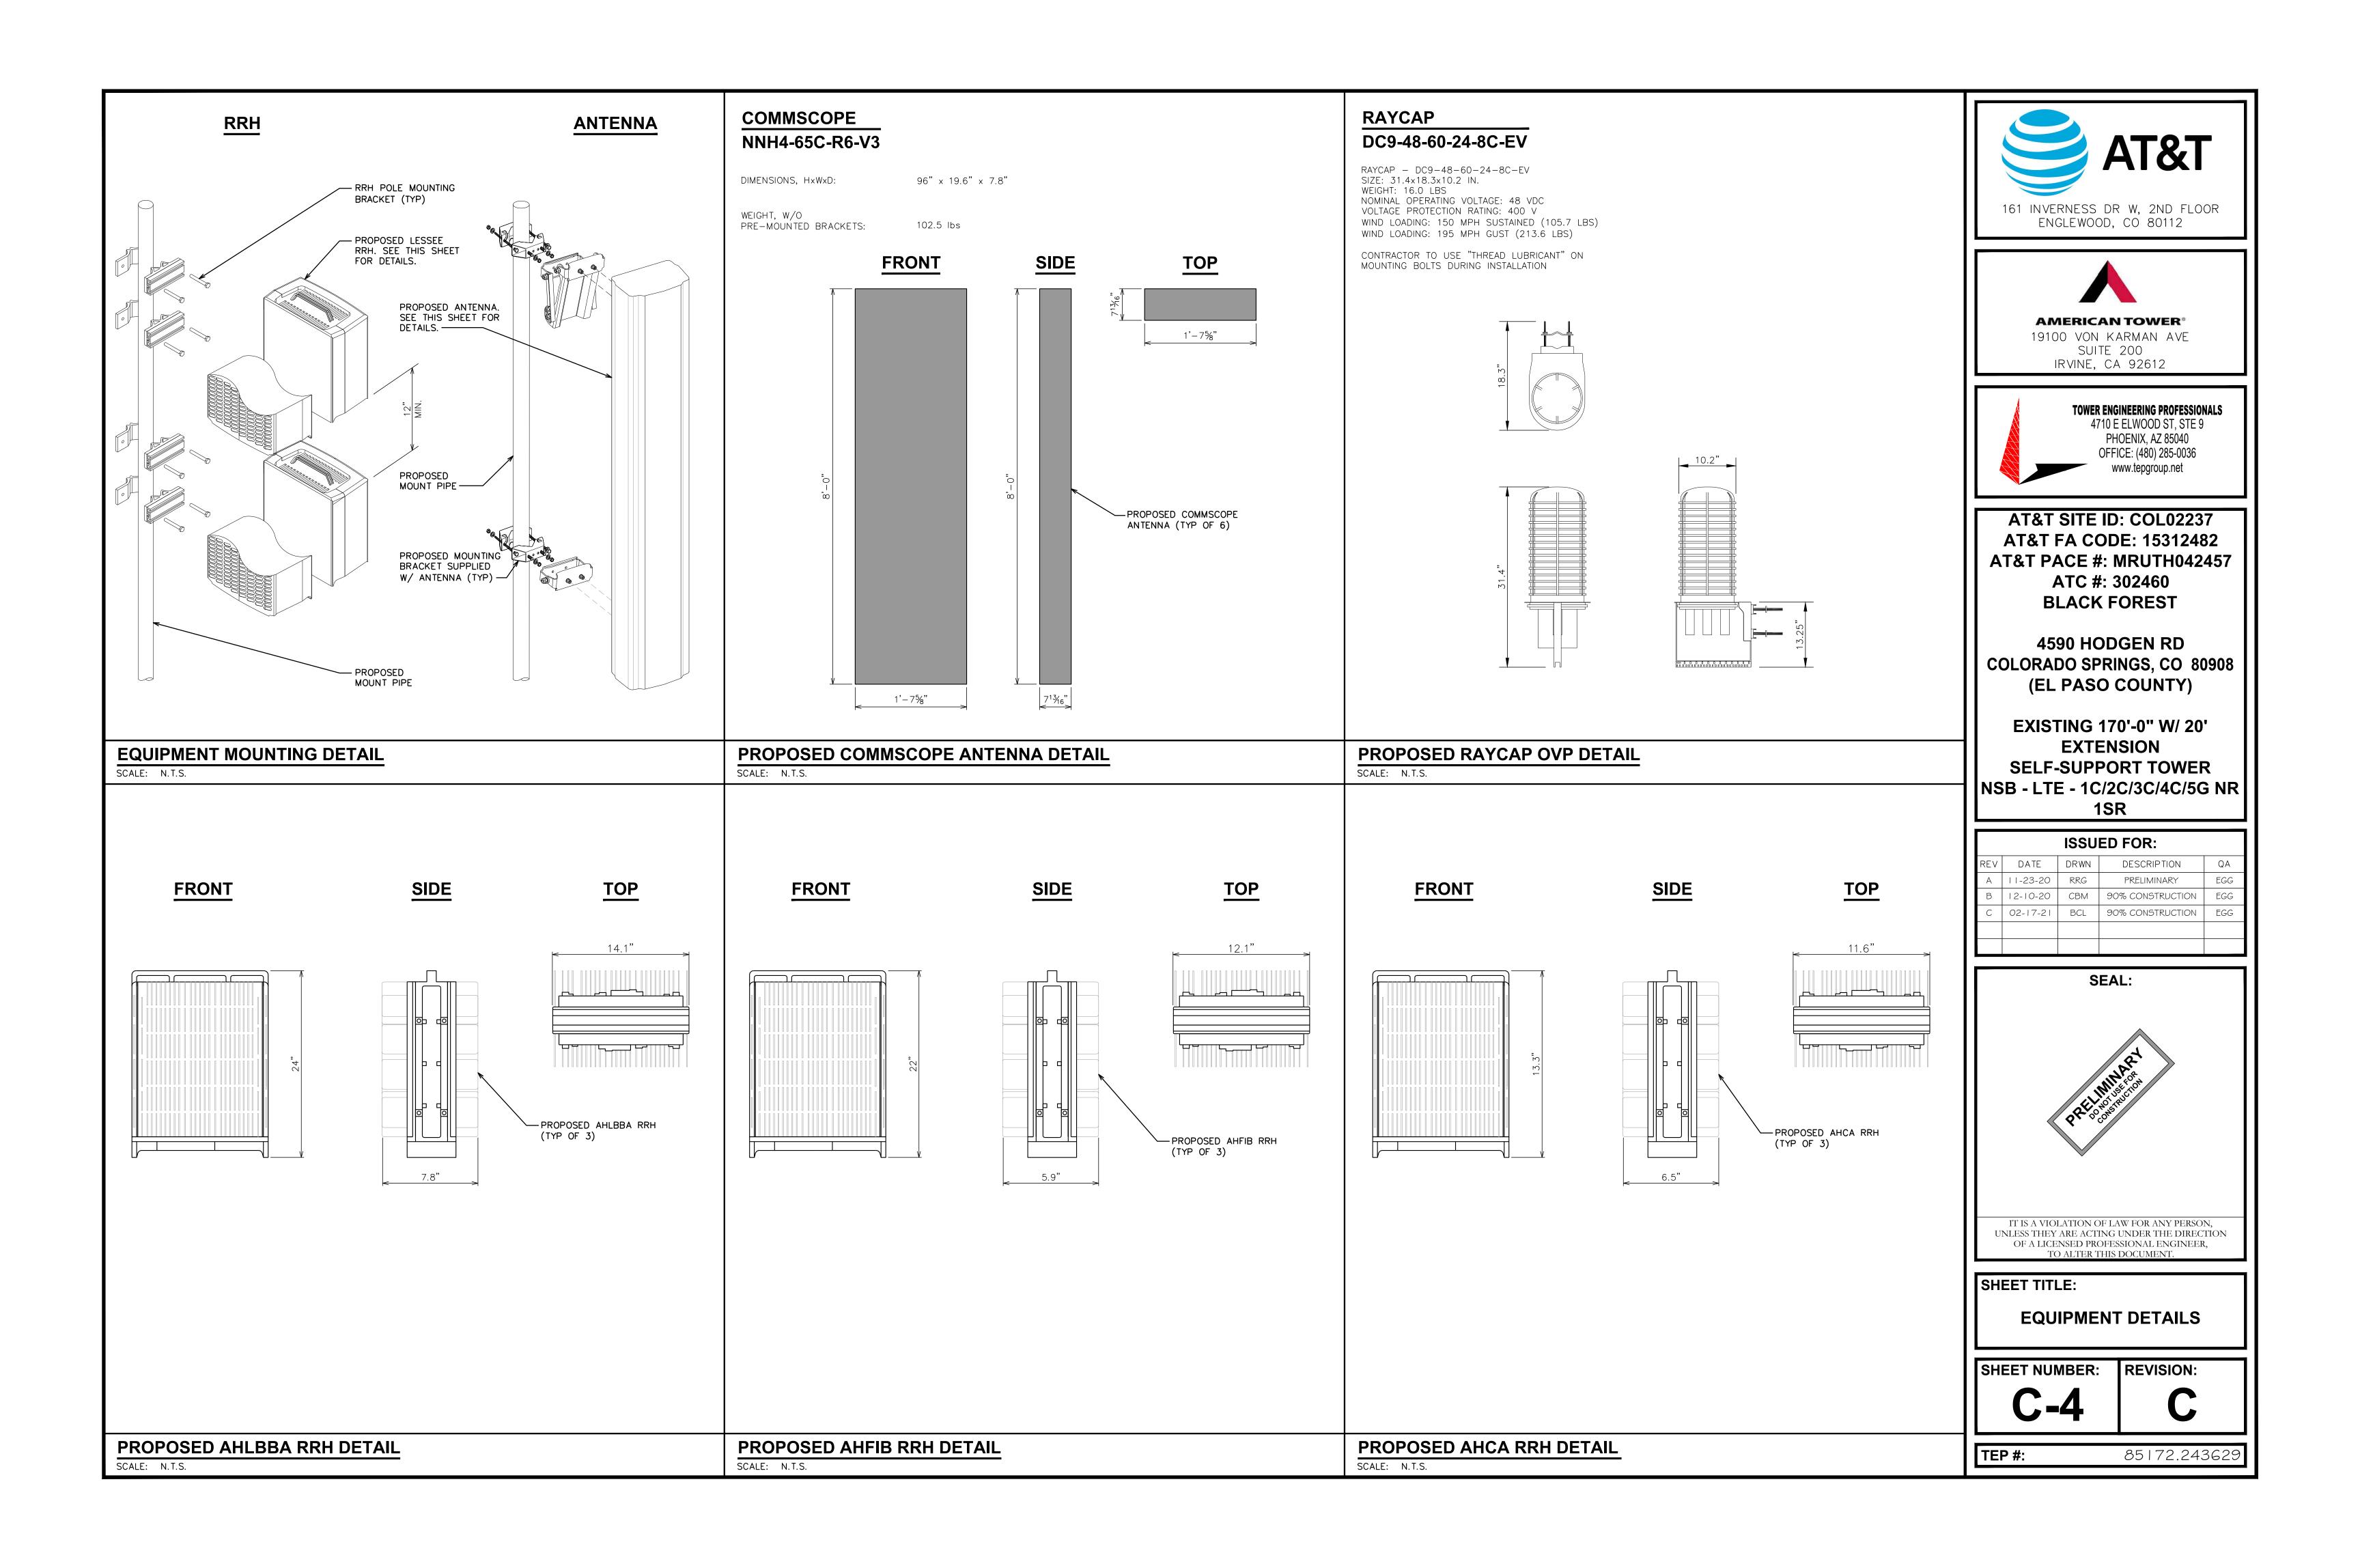
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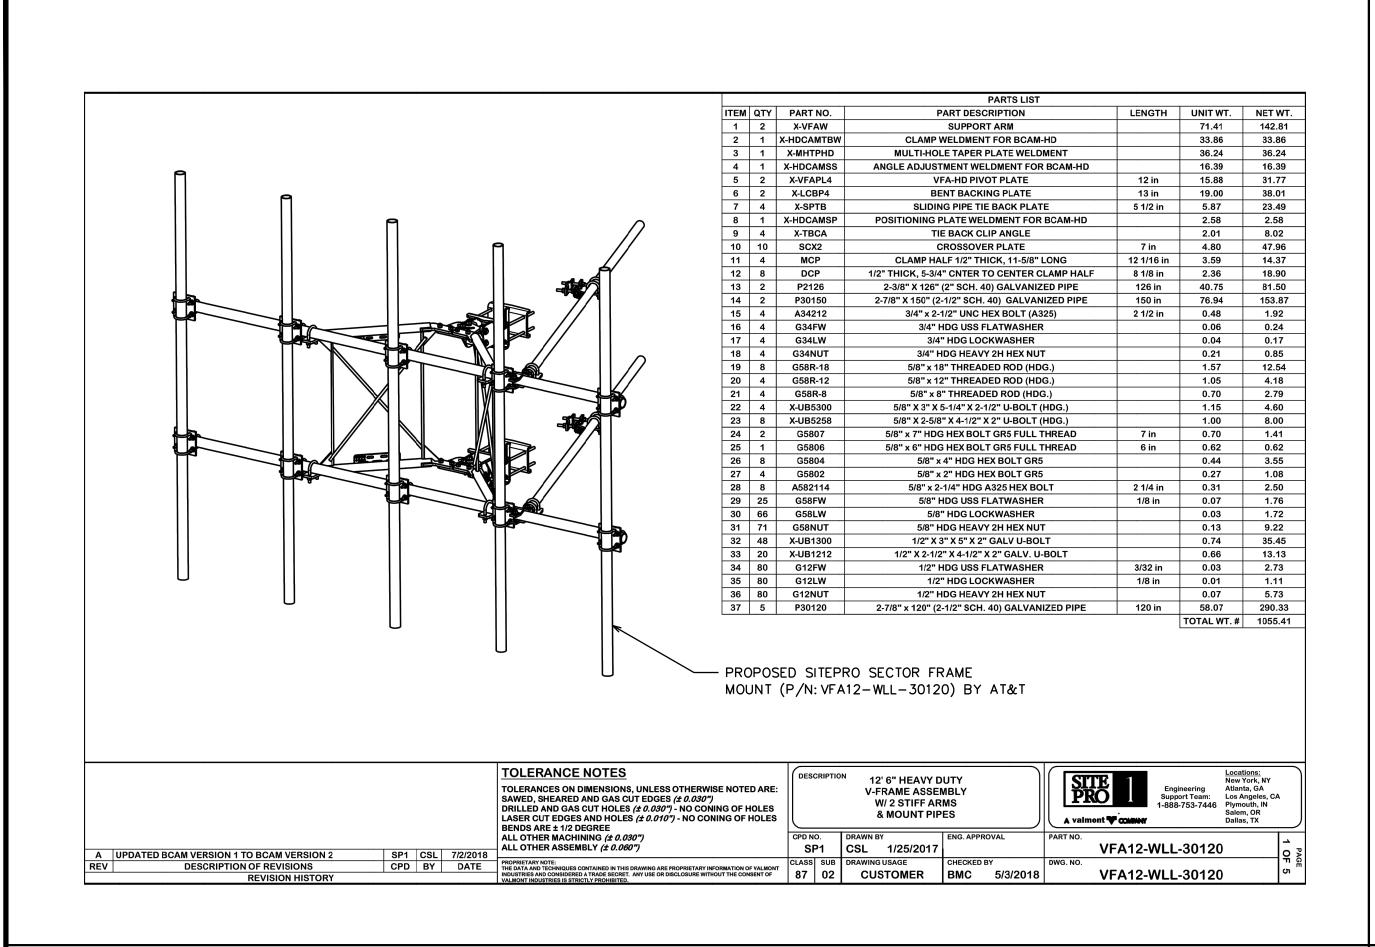
EXISTING AND FINAL ELEVATIONS


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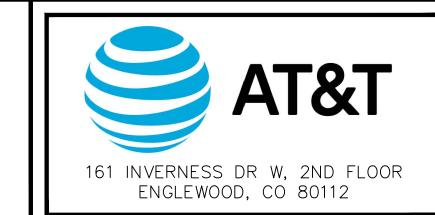
REVISION:

P #:







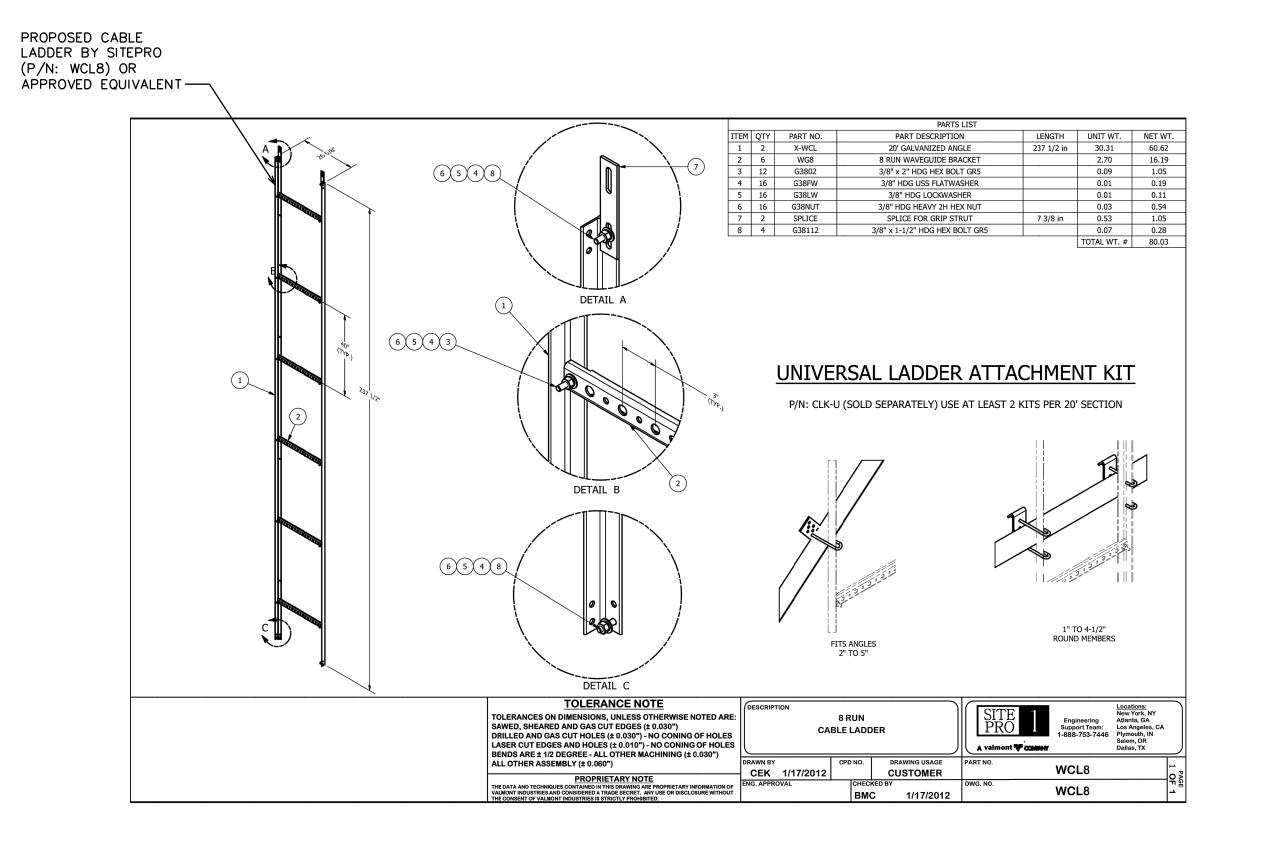



19100 VON KARMAN AVE SUITE 200 IRVINE, CA 92612




AT&T SITE ID: COL02237 AT&T FA CODE: 15312482 **AT&T PACE #: MRUTH042457** ATC #: 302460 **BLACK FOREST**

4590 HODGEN RD COLORADO SPRINGS, CO 80908 (EL PASO COUNTY)

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SHEET TITLE:


EQUIPMENT DETAILS

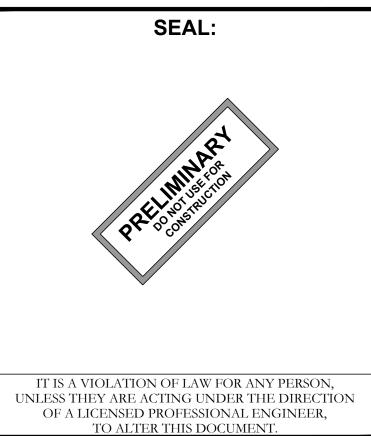SHEET NUMBER:

REVISION:


TEP #: 85172.243629



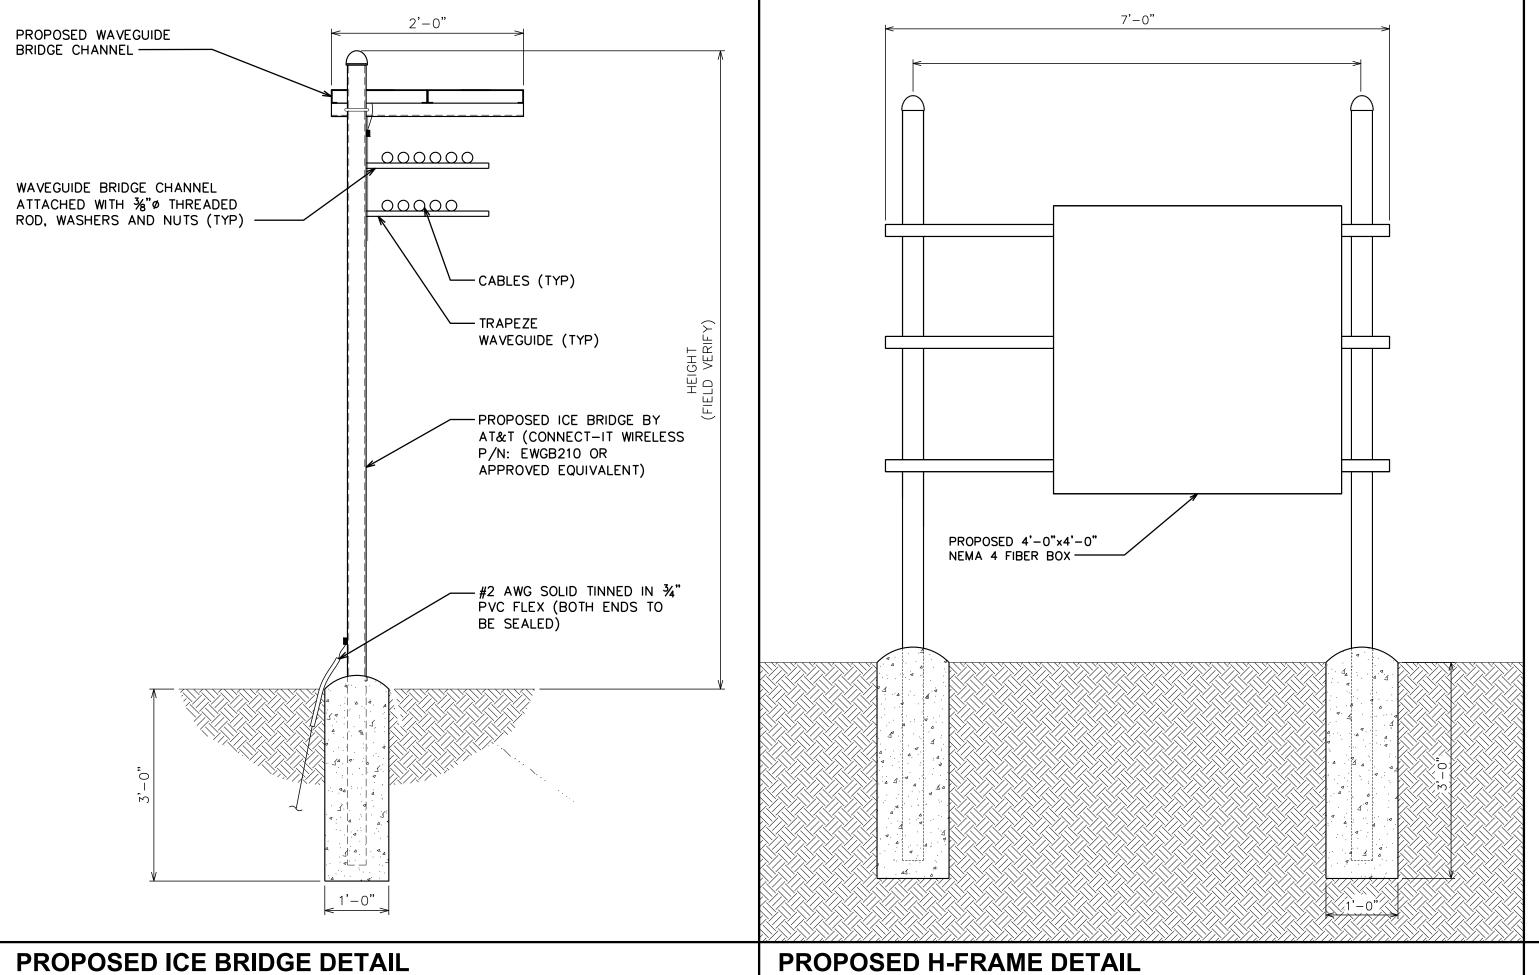


SCALE: N.T.S.

SCALE: N.T.S.

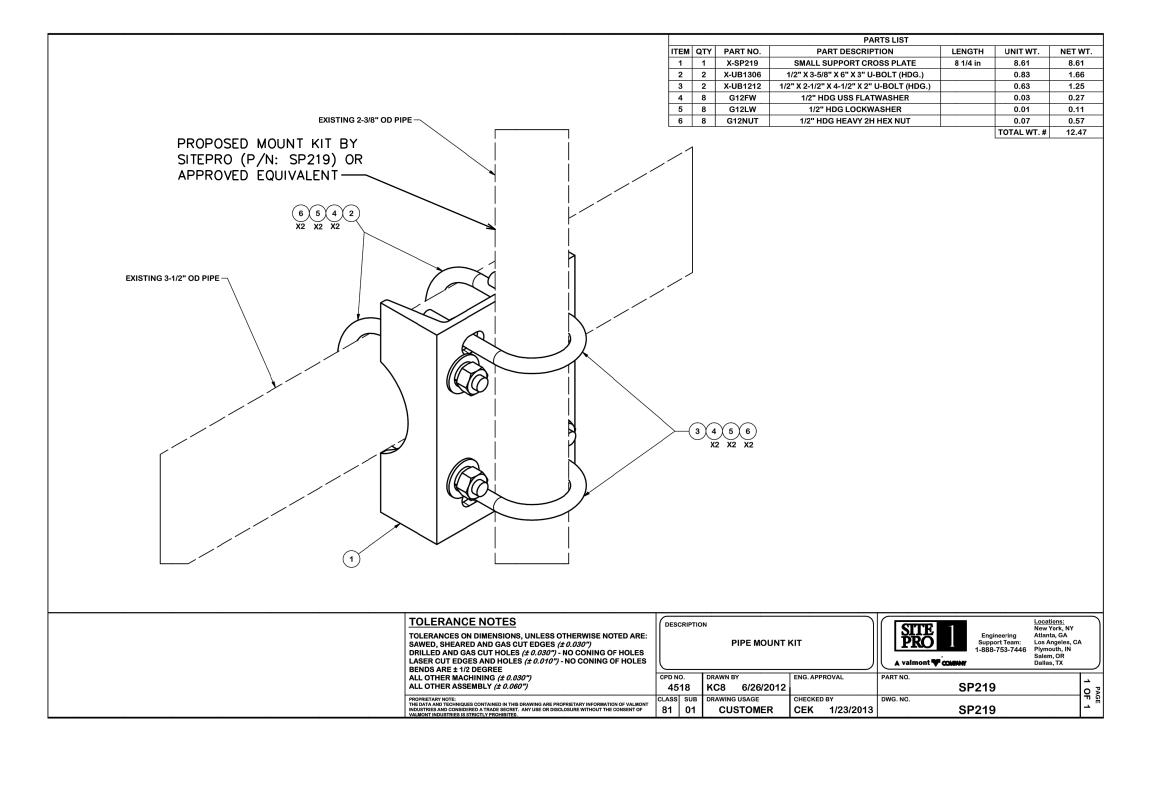

PROPOSED MOUNT KIT DETAIL

SCALE: N.T.S.

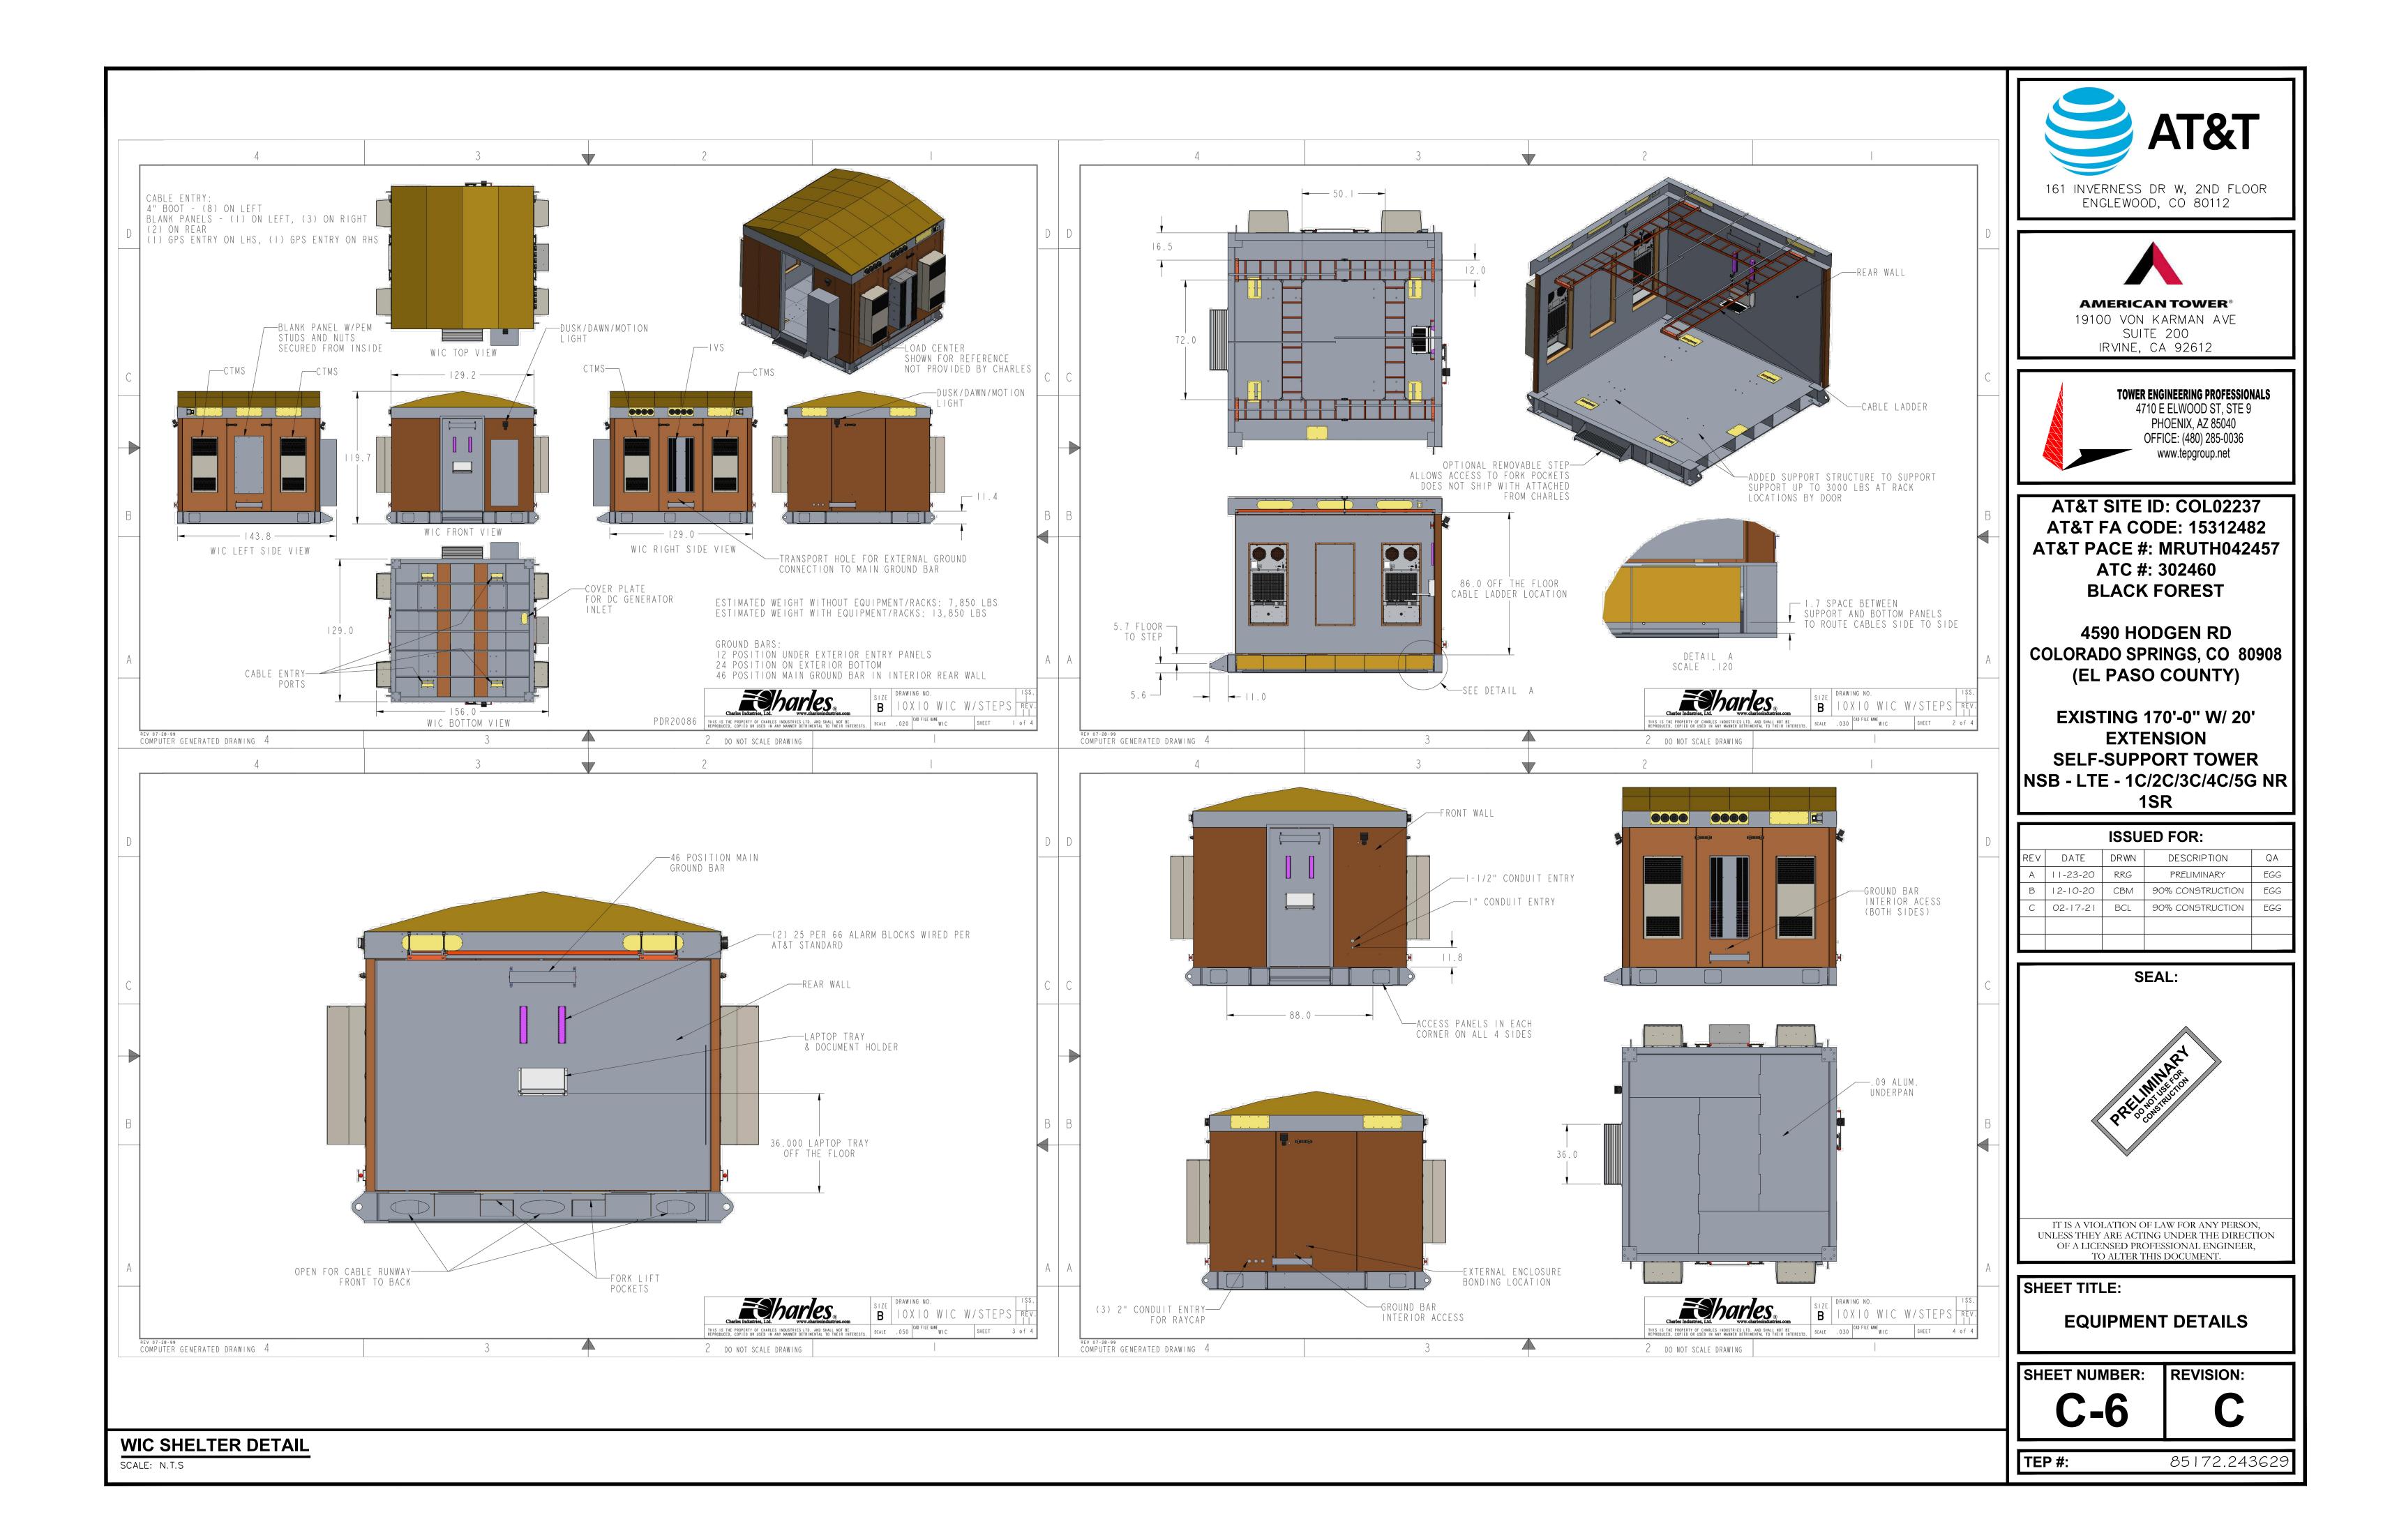

GENERAC INDUSTRIAL

Standby Power Rating 30 kW, 38 kVA, 60 Hz

Prime Power Rating*

27 kW, 34 kVA, 60 Hz

EPA Certified Stationary Emergency



Image used for illustration purposes only

Codes and Standards

USA ENGINEERED & BUILT'

Not all codes and standards apply to all configurations. Contact factory for details.



UL2200, UL508, UL489, UL142




BS5514 and DIN 6271

CSA C22.2



NFPA 37, 70, 99, 110

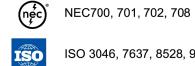

ISO 3046, 7637, 8528, 9001



NEMA ICS10, MG1, 250, ICS6, AB1

ANSI C62.41

Powering Ahead

For over 50 years, Generac has provided innovative design and superior manufacturing.

Generac ensures superior quality by designing and manufacturing most of its generator components, including alternators, enclosures and base tanks, control systems and communications software.

Generac gensets utilize a wide variety of options, configurations and arrangements, allowing us to meet the standby power needs of practically every application.

Generac searched globally to ensure the most reliable engines power our generators. We choose only engines that have already been proven in heavy-duty industrial applications under adverse conditions.

Generac is committed to ensuring our customers' service support continues after their generator purchase.

STANDARD FEATURES

INDUSTRIAL DIESEL GENERATOR SET

SD030 | 2.2L | 30 kW

EPA Certified Stationary Emergency

ENGINE SYSTEM

Oil Drain Extension

 Air Cleaner Fan Guard Stainless Steel Flexible Exhaust Connection Factory Filled Oil and Coolant

 Brushless Excitation Radiator Duct Adapter (Open Set Only) Sealed Bearing Rotor Dynamically Spin Balanced Critical Silencer (Enclosed Unit Only) Engine Coolant Heater Amortisseur Winding (3-Phase Only) Full Load Capacity Alternator

Fuel System Fuel Lockoff Solenoid Primary Fuel Filter

Radiator Drain Extension

Battery Charging Alternator

CONTROL SYSTEM

Program Functions

Programmable Crank Limiter

7-Day Programmable Exerciser

RS-232/485 Communications

• Date/Time Fault History (Event Log)

Isochronous Governor Control

Waterproof/Sealed Connectors

2-Wire Start Capability

COOLING

Standby - See Bulletin 0187500SSB Prime - See Bulletin 0187510SSB

Electrical System

Battery Cables

Battery Tray

• 50/50 Ethylene Glycol Antifreeze

 Rubber-Booted Engine Electrical Connections Solenoid Activated Starter Motor

Digital H Control Panel- Dual 4x20 Display

Special Applications Programmable Logic Controller

All Phase Sensing Digital Voltage Regulator

Cooling System

 Internal Genset Vibration Isolation Separation of Circuits - High/Low Voltage Separation of Circuits - Multiple Breakers Closed Coolant Recovery System UV/Ozone Resistant Hoses Factory-Installed Radiator

 Wrapped Exhaust Piping Standard Factory Testing 2 Year Limited Warranty (Standby Rated Units) 1 Year Limited Warranty (Prime Rated Units) Silencer Mounted in the Discharge Hood (Enclosed Unit Only)

Audible Alarms and Shutdowns

Not in Auto (Flashing Light)

Auto/Off/Manual Switch

Modbus[®] Protocol

Sealed Boards

Single Point Ground

on the Display

Power Output (kW)

All Phase AC Voltage

All Phase Currents

Power Factor

• E-Stop (Red Mushroom-Type)

Predictive Maintenance Algorithm

16 Channel Remote Trending

Full System Status Display

kW Hours, Total, and Last Run

Real/Reactive/Apparent Power

• NFPA110 Level I and II (Programmable)

Customizable Alarms, Warnings, and Events

Password Parameter Adjustment Protection

0.2 msec High Speed Remote Trending

Alarm Information Automatically Annunciated

ALTERNATOR SYSTEM

Class H Insulation Material

Protective Thermal Switch

GENERATOR SET

UL2200 GENprotect[™]

2/3 Pitch

Skewed Stator

ENCLOSURE (If Selected)

 Rust-Proof Fasteners with Nylon Washers to High Performance Sound-Absorbing Material (Sound Attenuation Enclosures)

GENERAC INDUSTRIAL

 Stamped Air-Intake Louvers Upward Facing Discharge Hoods (Radiator and Exhaust) Stainless Steel Lift Off Door Hinges Stainless Steel Lockable Handles

 RhinoCoat[™] - Textured Polyester Powder Coat Paint FUEL TANKS (If Selected)

 UL 142/ULC S601 Double Wall Normal and Emergency Vents Sloped Top Sloped Bottom

Stainless Steel Hardware

Oil Pressure

Coolant Level

Engine Speed

Frequency

Oil Pressure

Coolant Level

Battery Voltage

Alarms and Warnings

Coolant Temperature

Engine Overspeed

Alarms and Warnings

Alarms and Warnings Time and Date Stamped

Snap Shots of Key Operation Parameters During

Alarms and Warnings Spelled Out (No Alarm Codes)

GENERAC INDUSTRIAL

Battery Voltage

Coolant Temperature

 Factory Pressure Tested Rupture Basin Alarm Fuel Level Check Valve In Supply and Return Lines RhinoCoat™ - Textured Polyester Powder Coat Paint

ENGINE SYSTEM Coolant Heater Isolation Ball Valves

Fluid Containment Pan

O Spare Inputs (x4) / Outputs (x4) Battery Disconnect Switch

INDUSTRIAL DIESEL GENERATOR SET EPA Certified Stationary Emergency

SD030 | 2.2L | 30 kW

CIRCUIT BREAKER OPTIONS

ENCLOSURE

Steel Enclosure

Aluminum Enclosure

Door Alarm Switch

Damper Alarm Contacts

Enclosure Heater

O Weather Protected Enclosure

Level 1 Sound Attenuation

AC/DC Enclosure Lighting Kit

2 Year Extended Limited Warranty

Level 2 Sound Attenuation

 Oil Heater O Main Line Circuit Breaker Critical Silencer (Open Set Only) O 2nd Main Line Circuit Breaker Radiator Stone Guard O Shunt Trip and Auxiliary Contact Level 1 Fan and Belt Guards (Open Set Only) Electronic Trip Breakers

FUEL SYSTEM

CONFIGURABLE OPTIONS

ENGINE SYSTEM

 NPT Flexible Fuel Line **ELECTRICAL SYSTEM**

10A UL Listed Battery Charger Battery Warmer

ALTERNATOR SYSTEM Alternator Upsizing Anti-Condensation Heater Tropical Coating

Permanent Magnet Excitation

GENERATOR SET Extended Factory Testing

 5 Year Limited Warranty 8 Position Load Center 5 Year Extended Limited Warranty Pad Vibration Isolation 7 Year Extended Limited Warranty 10 Year Extended Limited Warranty

ENGINEERED OPTIONS

CONTROL SYSTEM

CONTROL SYSTEM

- O NFPA 110 Compliant 21-Light Remote Annunciator Remote Relay Assembly (8 or 16) Oil Temperature Indication and Alarm O Remote E-Stop (Break Glass-Type, Surface Mount)
 - Remote E-Stop (Red Mushroom-Type, Surface Mount) Remote E-Stop (Red Mushroom-Type, Flush Mount)
 - 100 dB Alarm Horn O Ground Fault Annunciation

GENERAC INDUSTRIAL

- 120V GFCI and 240V Outlets
- O Level 2 Sound Attenuation with Motorized Dampers O Remote Communication - Modem

10A Engine Run Relay

- O Up to 200 MPH Wind Load Rating (Contact Factory FUEL TANKS (Size On Last Page) O 8 in (203.2 mm) Fill Extension
 - O 13 in (330.2 mm) Fill Extension O 19 in (482.6 mm) Fill Extension Overfill Protection Valve

5 Gallon Spill Box Return Hose

WARRANTY (Standby Gensets Only) 5 Gallon Spill Box Tank Risers Fuel Level Switch and Alarm

12' Vent System Fire Rated Stainless Steel Fuel Hose

FUEL TANKS

ALTERNATOR SYSTEM O 3rd Breaker System

O UL2085 Tank Stainless Steel Tanks GENERATOR SET Special Fuel Tanks Special Testing Vent Extensions

TOWER ENGINEERING PROFESSIONALS

161 INVERNESS DR W, 2ND FLOOR

ENGLEWOOD, CO 80112

AMERICAN TOWER®

19100 VON KARMAN AVE

SUITE 200

IRVINE, CA 92612



AT&T SITE ID: COL02237 AT&T FA CODE: 15312482 **AT&T PACE #: MRUTH042457** ATC #: 302460 **BLACK FOREST**

4590 HODGEN RD COLORADO SPRINGS, CO 80908 (EL PASO COUNTY)

EXISTING 170'-0" W/ 20' EXTENSION SELF-SUPPORT TOWER NSB - LTE - 1C/2C/3C/4C/5G NR 1SR

	ISSUED FOR:						
REV	DATE	DRWN	DESCRIPTION	QA			
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SEAL:



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SHEET TITLE:

GENERATOR DETAILS

SHEET NUMBER:

REVISION:

85172.243629 TEP #:

GENERAC | INDUSTRIAL SD030 | 2.2L | 30 kW INDUSTRIAL DIESEL GENERATOR SET EPA Certified Stationary Emergency

APPLICATION AND ENGINEERING DATA

General		Cooling System	
Make	Perkins	Cooling System Type	Closed Recovery
EPA Emissions Compliance	Stationary Emergency	Water Pump Type	Pre-Lubed, Self Sealing
EPA Emissions Reference	See Emission Data Sheet	Fan Type	Pusher
Cylinder #	4	Fan Speed - RPM	1,980
Туре	In-Line	Fan Diameter - in (mm)	18 (457)
Displacement - in ³ (L)	135 (2.22)		
Bore - in (mm)	3.3 (84)	Fuel System	
Stroke - in (mm)	3.9 (100)	Fuel Type	Ultra Low Sulfur Diesel Fuel #2
Compression Ratio	23.3:1	Fuel Specifications	ASTM
Intake Air Method	Turbocharged	Fuel Filtering (Microns)	5
Cylinder Head	Cast Iron	Fuel Inject Pump	Distribution Injection Pump
Piston Type	Aluminum	Fuel Pump Type	Engine Driven Gear
Crankshaft Type	Forged Steel	Injector Type	Mechanical
_		Fuel Supply Line - in (mm)	0.31 (7.9) ID
Engine Governing		Fuel Return Line - in (mm)	0.2 (4.8) ID
Governor	Electronic Isochronous		
Frequency Regulation (Steady State)	±0.5%	Engine Electrical System	
		System Voltage	12 VDC
Lubrication System		Battery Charger Alternator	Standard
Oil Pump Type	Gear	Battery Size	See Battery Index 0161970SBY
Oil Filter Type	Full-Flow	Battery Voltage	12 VDC
Crankcase Capacity - qt (L)	11.2 (10.6)	Ground Polarity	Negative

Standard Model	K0035124Y21	Standard Excitation	Brushless
Poles	4	Bearings	Single Sealed
Field Type	Revolving	Coupling	Direct via Flexible Disc
Insulation Class - Rotor	Н	Load Capacity - Standby	100%
Insulation Class - Stator	Н	Prototype Short Circuit Test	Yes
Total Harmonic Distortion	<5% (3-Phase)	Voltage Regulator Type	Digital
Telephone Interference Factor (TIF)	< 50	Number of Sensed Phases	All
. ,		Regulation Accuracy (Steady State)	±0.25%

SD030 | 2.2L | 30 kW INDUSTRIAL DIESEL GENERATOR SET

EPA Certified Stationary Emergency	
OPERATING DATA	
POWER RATINGS	
	Standby

30 kW

30 kW

30 kW

Amps: 45

Single-Phase 120/240 VAC @1.0pf 30 kW

hree-Phase 120/208 VAC @0.8pf

Three-Phase 120/240 VAC @0.8pf

Three-Phase 277/480 VAC @0.8pf

Three-Phase 346/600 VAC @0.8pf 30 kW Amps: 36 MOTOR STARTING CAPABILITIES (skVA) skVA vs. Voltage Dip 277/480 VAC 30% 208/240 VAC 30%

 K0035124Y21
 61
 K0035124Y21
 46

 K0040124Y21
 76
 K0040124Y21
 58
 K0050124Y21 98 K0050124Y21 75 **FUEL CONSUMPTION RATES***


Fuel Pump Lift- ft (m) 3 (1)	Diesel - gph (Lph)			
Fuel Pump Lift- ft (m)	Percent Load	Standby		
3 (1)	25%	1.0 (3.7)		
	50%	1.4 (5.2)		
Total Fuel Pump Flow (Combustion + Return) - gph (Lph)	75%	2.0 (7.5)		
16.6 (63)	100%	2.8 (10.5)		
	* Fuel supply installation mu consumption rates at 100'			

14.9 (56.2) 2.5 (9.5) Coolant System Capacity 128,638 (136) 2.800 (4.757) Maximum Operating Ambient Temperature Maximum Operating Ambient Temperature (Before Derate) See Bulletin No. 0199280SSD

Maximum Radiator Backpressure in H₂O (kPa) **COMBUSTION AIR REQUIREMENTS**


	Flow at Rated Pov	wer scfm (m³/min) 88 (2.5)		
		EXHAUST		
	Standby			Standby
RPM	1,800	Exhaust Flow (Rated Output)	scfm (m³/min)	296.6 (8.4)
hp	49	Max. Allowable Backpressure (Post Turbocharger)	inHg (kPa)	1.5 (5.1)
ft/min (m/min)	1,181 (360)	Exhaust Temp (Rated Output)	°F (°C)	892 (478)
psi (kPa)	159 (1,096)			
	hp ft/min (m/min)	Standby RPM 1,800 hp 49 ft/min (m/min) 1,181 (360)	EXHAUST	EXHAUST Standby RPM 1,800 Exhaust Flow (Rated Output) scfm (m³/min) hp 49 Max. Allowable Backpressure (Post Turbocharger) inHg (kPa) ft/min (m/min) 1,181 (360) Exhaust Temp (Rated Output) °F (°C)

** Refer to "Emissions Data Sheet" for maximum bHP for EPA and SCAQMD permitting purposes. Deration – Operational characteristics consider maximum ambient conditions. Derate factors may apply under atypical site conditions. Please contact a Generac Power Systems Industrial Dealer for additional details. All performance ratings in accordance with ISO3046, BS5514, ISO8528, and DIN6271 standards.

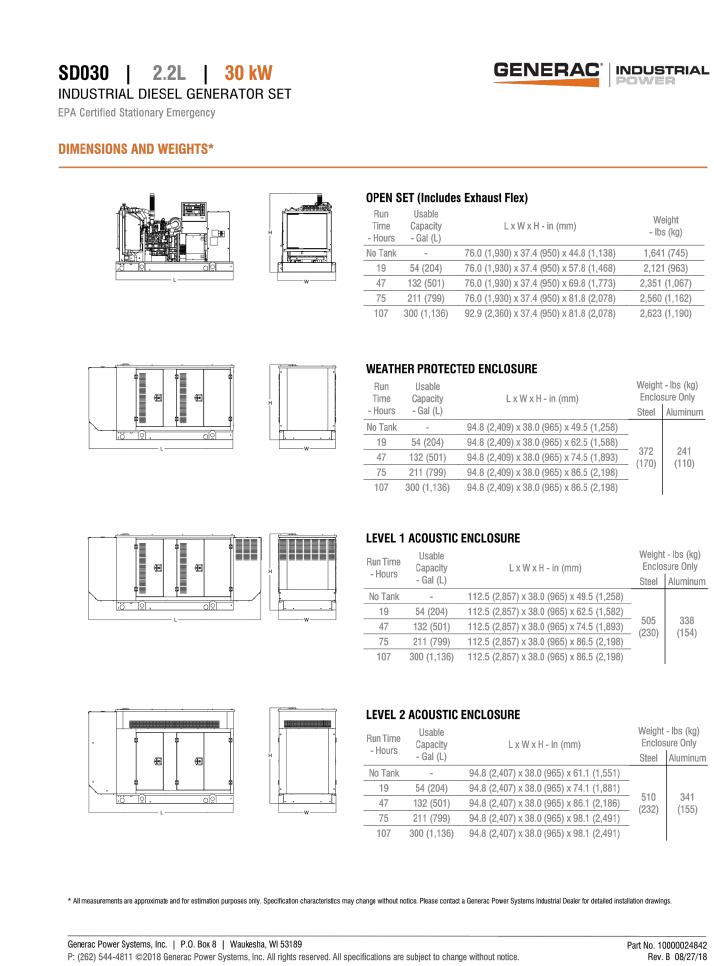


SD030 2.2L 30kW GENERATOR DETAILS


SCALE: N.T.S

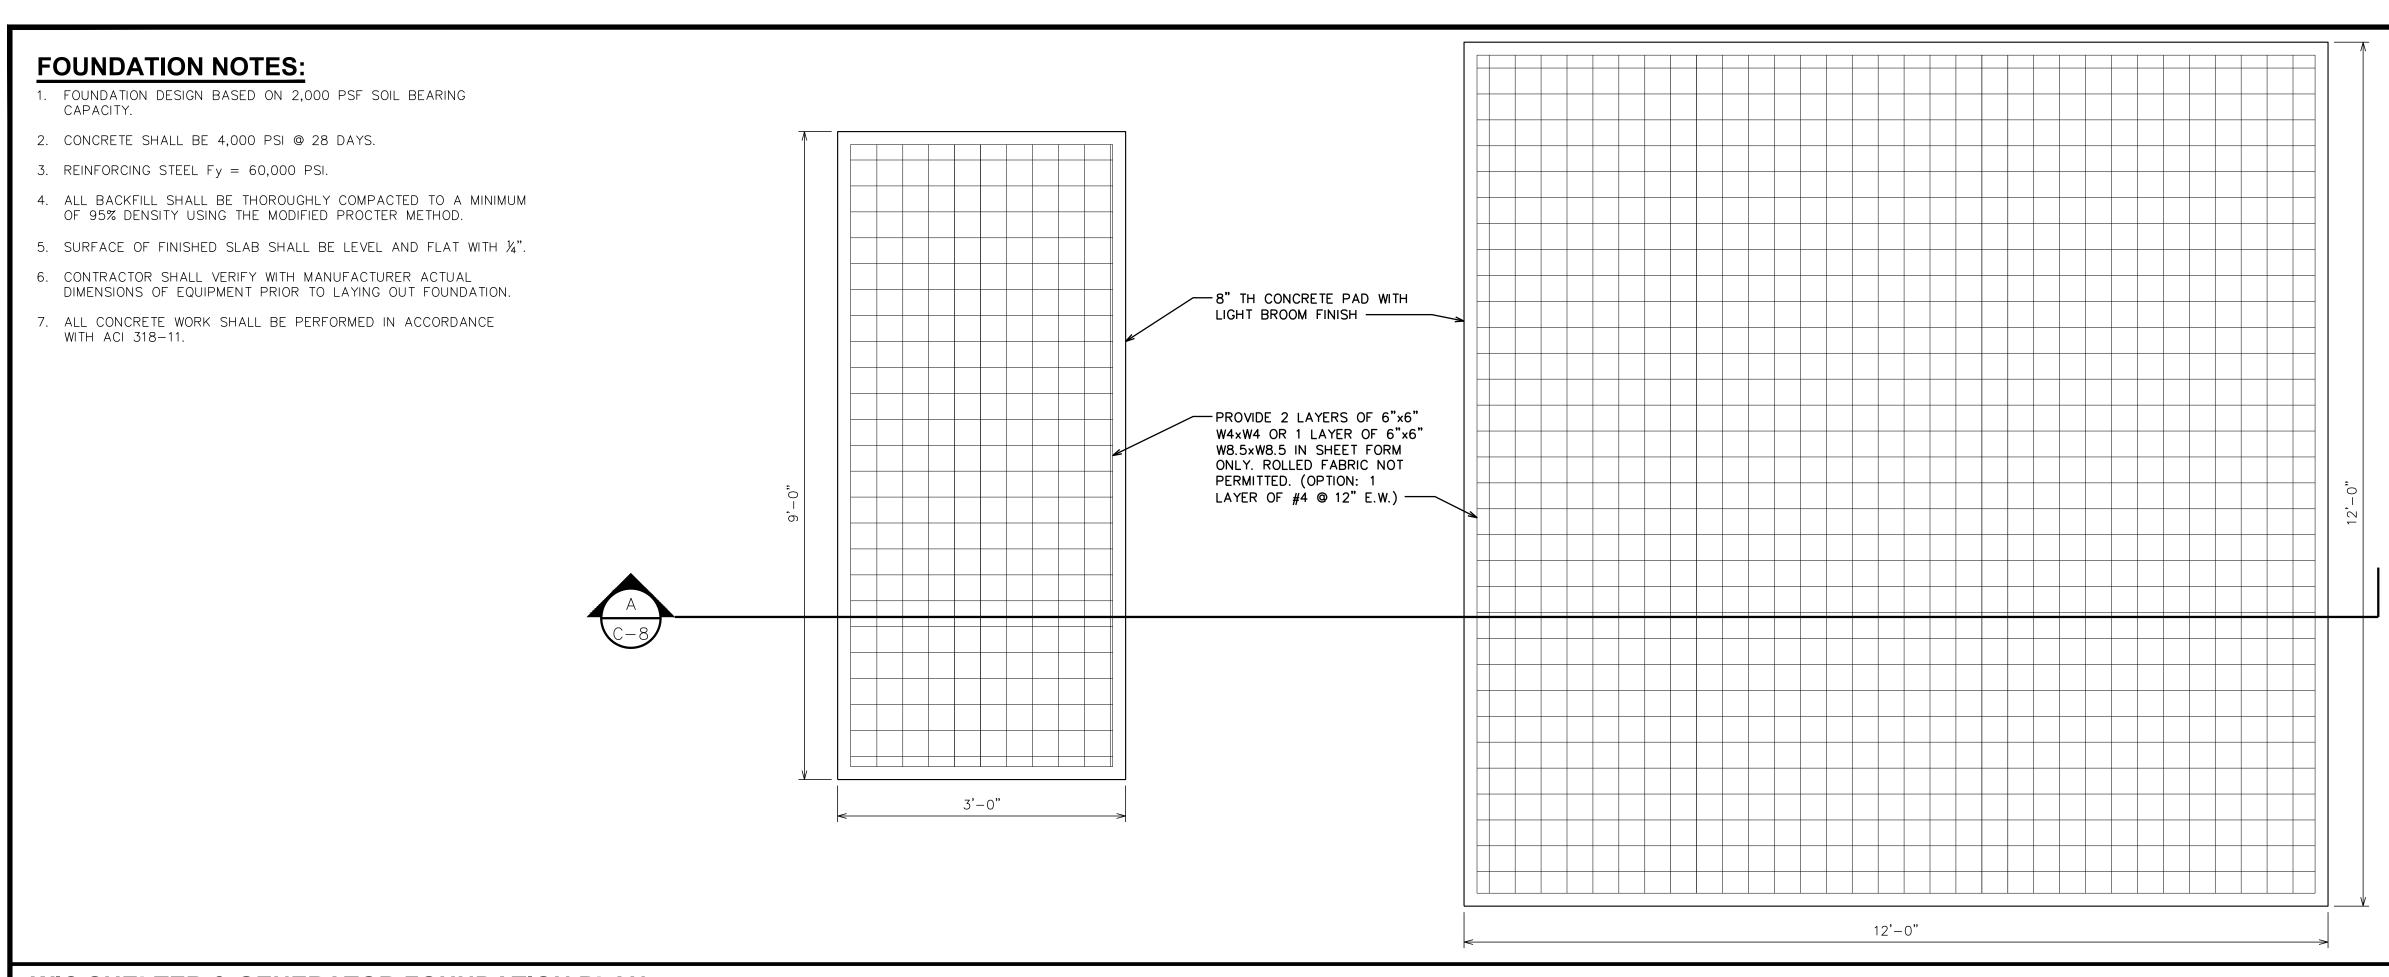

WIC SHELTER & GENERATOR FOUNDATION PLAN

SCALE: N.T.S

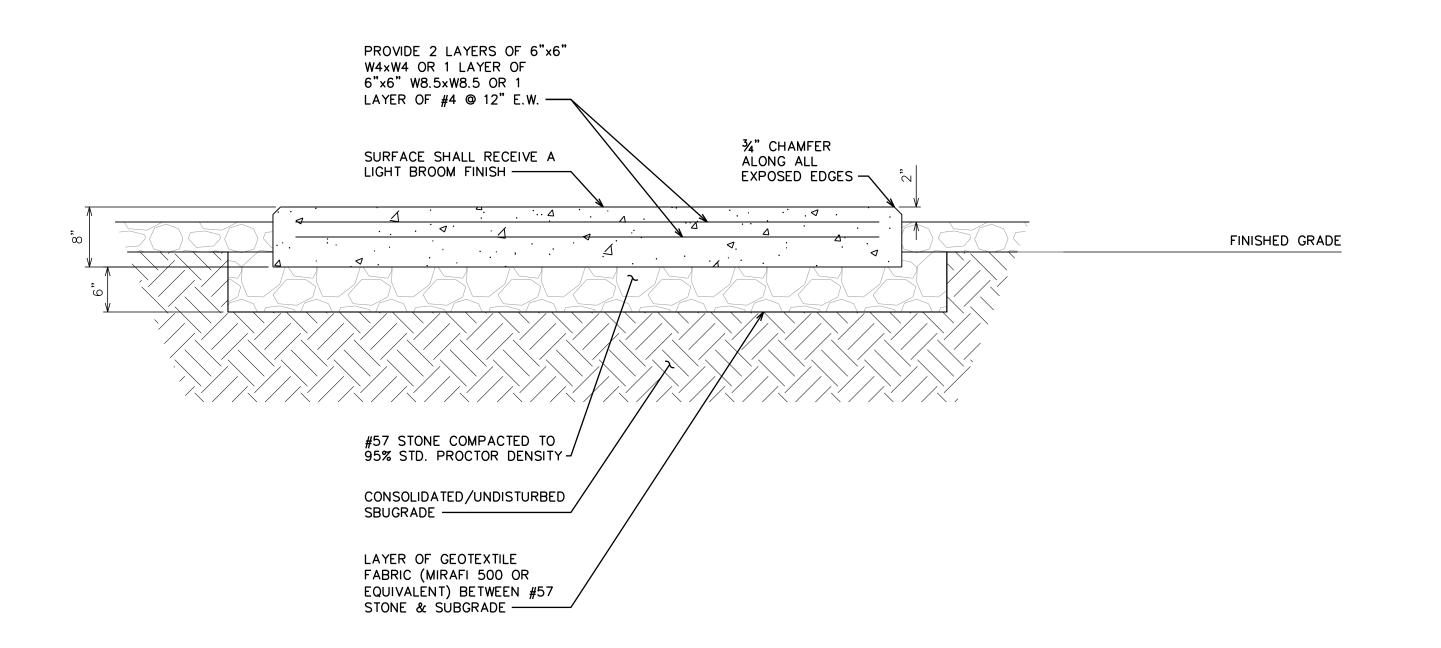

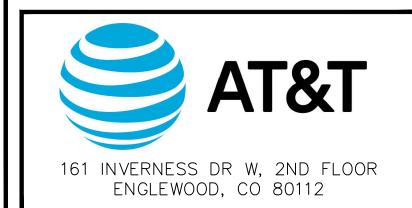



19100 VON KARMAN AVE SUITE 200 IRVINE, CA 92612

TOWER ENGINEERING PROFESSIONALS

4710 E ELWOOD ST, STE 9
PHOENIX, AZ 85040
OFFICE: (480) 285-0036
www.tepgroup.net

AT&T SITE ID: COL02237
AT&T FA CODE: 15312482
AT&T PACE #: MRUTH042457
ATC #: 302460
BLACK FOREST

4590 HODGEN RD COLORADO SPRINGS, CO 80908 (EL PASO COUNTY)

EXISTING 170'-0" W/ 20'
EXTENSION
SELF-SUPPORT TOWER
NSB - LTE - 1C/2C/3C/4C/5G NR
1SR

ISSUED FOR:								
REV	DATE	DRWN	DESCRIPTION	QA				
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SHEET TITLE:

FOUNDATION DETAILS


SHEET NUMBER:

REVISION:

TEP #:

85172.243629

PAD SECTION A
SCALE: N.T.S
C-8

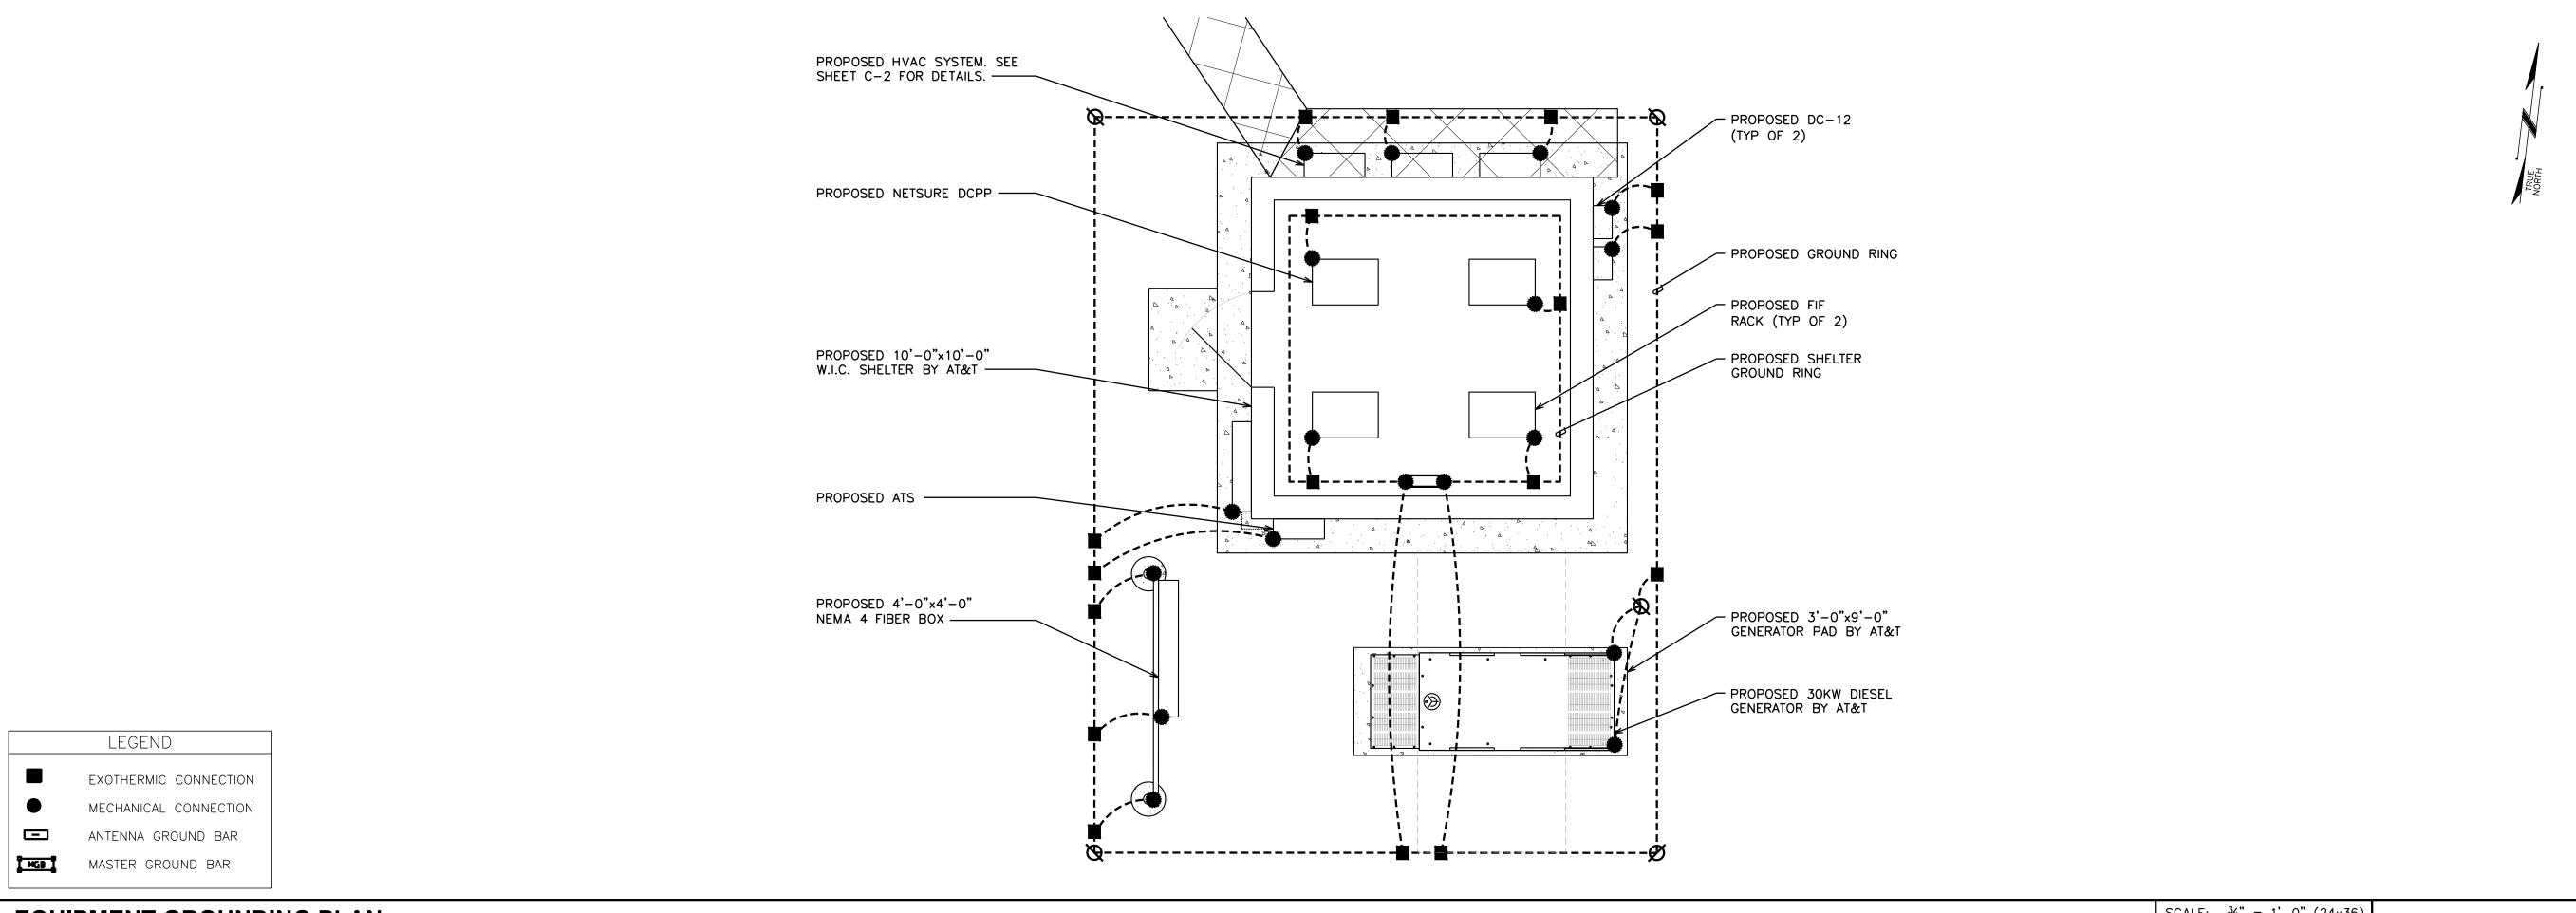


SCALE: $\frac{3}{8}$ " = 1'-0" (24×36) **EQUIPMENT GROUNDING PLAN** SCALE IN FEET SCALE: $\frac{3}{16}$ " = 1'-0" (11x17)

NOTE:

PROPOSED PANEL SCHEDULE VALUES
WERE CALCULATED BASED ON MAXIMUM
PULL FROM EACH CONNECTED BREAKER. ACTUAL VALUES WILL VARY BASED ON SITE CONDITIONS.

PROPOSED PANEL SCHEDULE											
	120/240 VOLTS 1 PHASE			SU	3 WIRE JRFACE MOUNTED					225A, 2 POLE MAIN BREAKER	
NO.	LOAD SERVED	ØA VA	ØB VA	AMP / POLE	L1	L2	AMP / POLE	ØA VA	ØB VA	LOAD SERVED	NO.
1	DECTIFIEDS #1 0. #2	2880	_	70 /0	5760	_	70 /0	2880	_		2
3	RECTIFIERS #1 & #2	_	2880	30/2	_	5760	30/2	_	2880	RECTIFIERS #3 & 4	
5		2880	_	70 /0	2880	_	70 /0	0	-	CDADE (OFF	6
7	RECTIFIERS #5 & 6	_	2880	30/2	_	2880	30/2	_	0	SPARE/OFF	8
9	CDADE /OFF	0	_	70 /2	0	_	70 /2	0	-	CDADE /OFF	10
11	SPARE/OFF	_	0	30/2	_	0	30/2	_	0	SPARE/OFF	12
13	SDADE /OFF	0	_	70 /2	0	_	70 /2	0	-	CDADE /OFF	14
15	SPARE/OFF	SPARE/OFF - 0 30/2 - 0 30/2 - 0		0	SPARE/OFF 1	16					
17	SPARE/OFF	0	_	30/2	0	_	30/2	0	-	- SPARE/OFF	18
19	SPARE/OFF	_	0	30/2	_	0	30/2	_	0		20
21	0 - 30/2 0 - 70/2 0 -		SPARE/OFF	22							
23	SFAILL/ OFF	SPARE/OFF - 0 30/2 - 0		0	SPARL/OFF	24					
25	AC UNIT #1	1920	_	20/1	1920	_	_			BLANK	26
27	BLANK	_	_	_	_	0	_	_	_	BLANK	28
29	BLANK	_	_	_	0	_	_	_	_	BLANK	30
31	BLANK	_	_	_	_	0	_	_	_	BLANK	32
33	BLANK	_	_	_	0	_	_	_	_	BLANK	34
35	BLANK	_	_	_	_	0	_	_	-	BLANK	36
37	BLANK	_	_	_	0	_	_	_	-	BLANK	38
39	BLANK	_	_	_	_	0	_	_	_	BLANK	40
PHASE TOTALS (VA)					10560	8640					
CURRENT PER PHASE (A)					88	72					
	PEAK TOTAL (VA)					88	PEAK TOTAL (A)				
	125% DEMAND (VA)					110	125% DEMAND (A)				

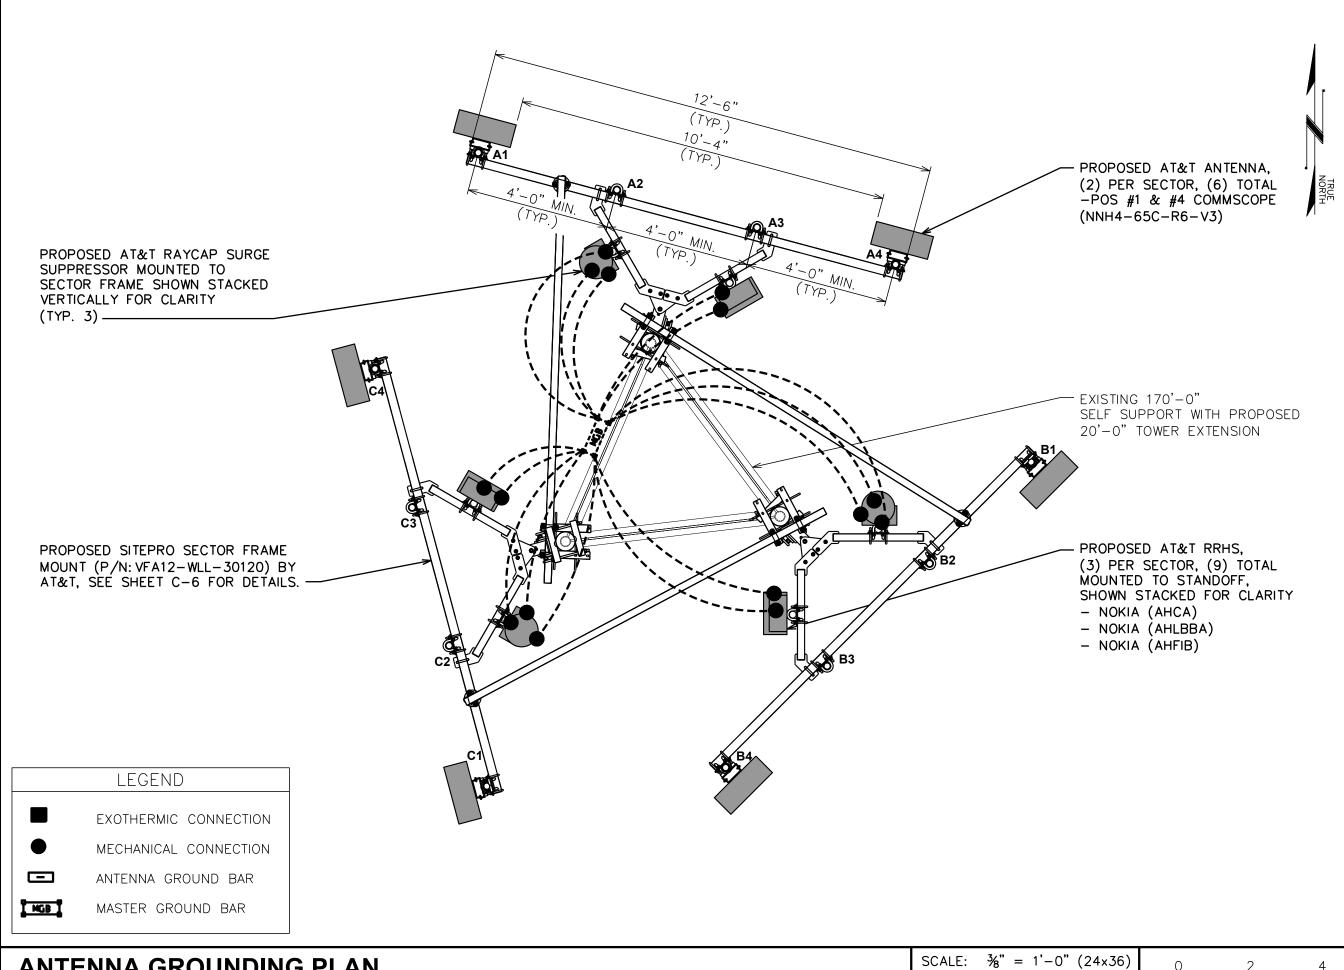

161 INVERNESS DR W, 2ND FLOOR ENGLEWOOD, CO 80112



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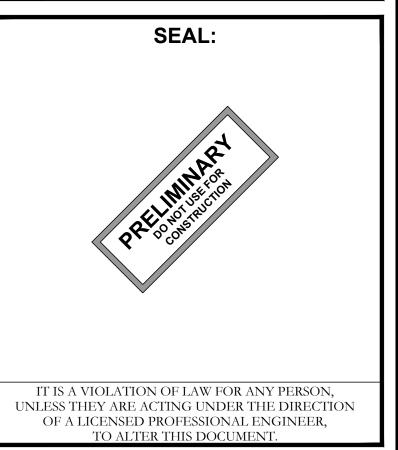


AT&T SITE ID: COL02237 AT&T FA CODE: 15312482 **AT&T PACE #: MRUTH042457** ATC #: 302460 **BLACK FOREST**

4590 HODGEN RD COLORADO SPRINGS, CO 80908 (EL PASO COUNTY)

EXISTING 170'-0" W/ 20' EXTENSION SELF-SUPPORT TOWER NSB - LTE - 1C/2C/3C/4C/5G NR 1SR

		ISSUED FOR:								
	REV	DATE	DRWN	DESCRIPTION	QA					
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ı										
ı										



SHEET TITLE: **ELECTRICAL PANEL & GROUNDING PLANS**

SHEET NUMBER: REVISION:


TEP #: 85172.243629


PROPOSED A/C PANEL SCALE: N.T.S.


ANTENNA GROUNDING PLAN

SCALE: $\frac{3}{16}$ " = 1'-0" (11×17)

SCALE IN FEET

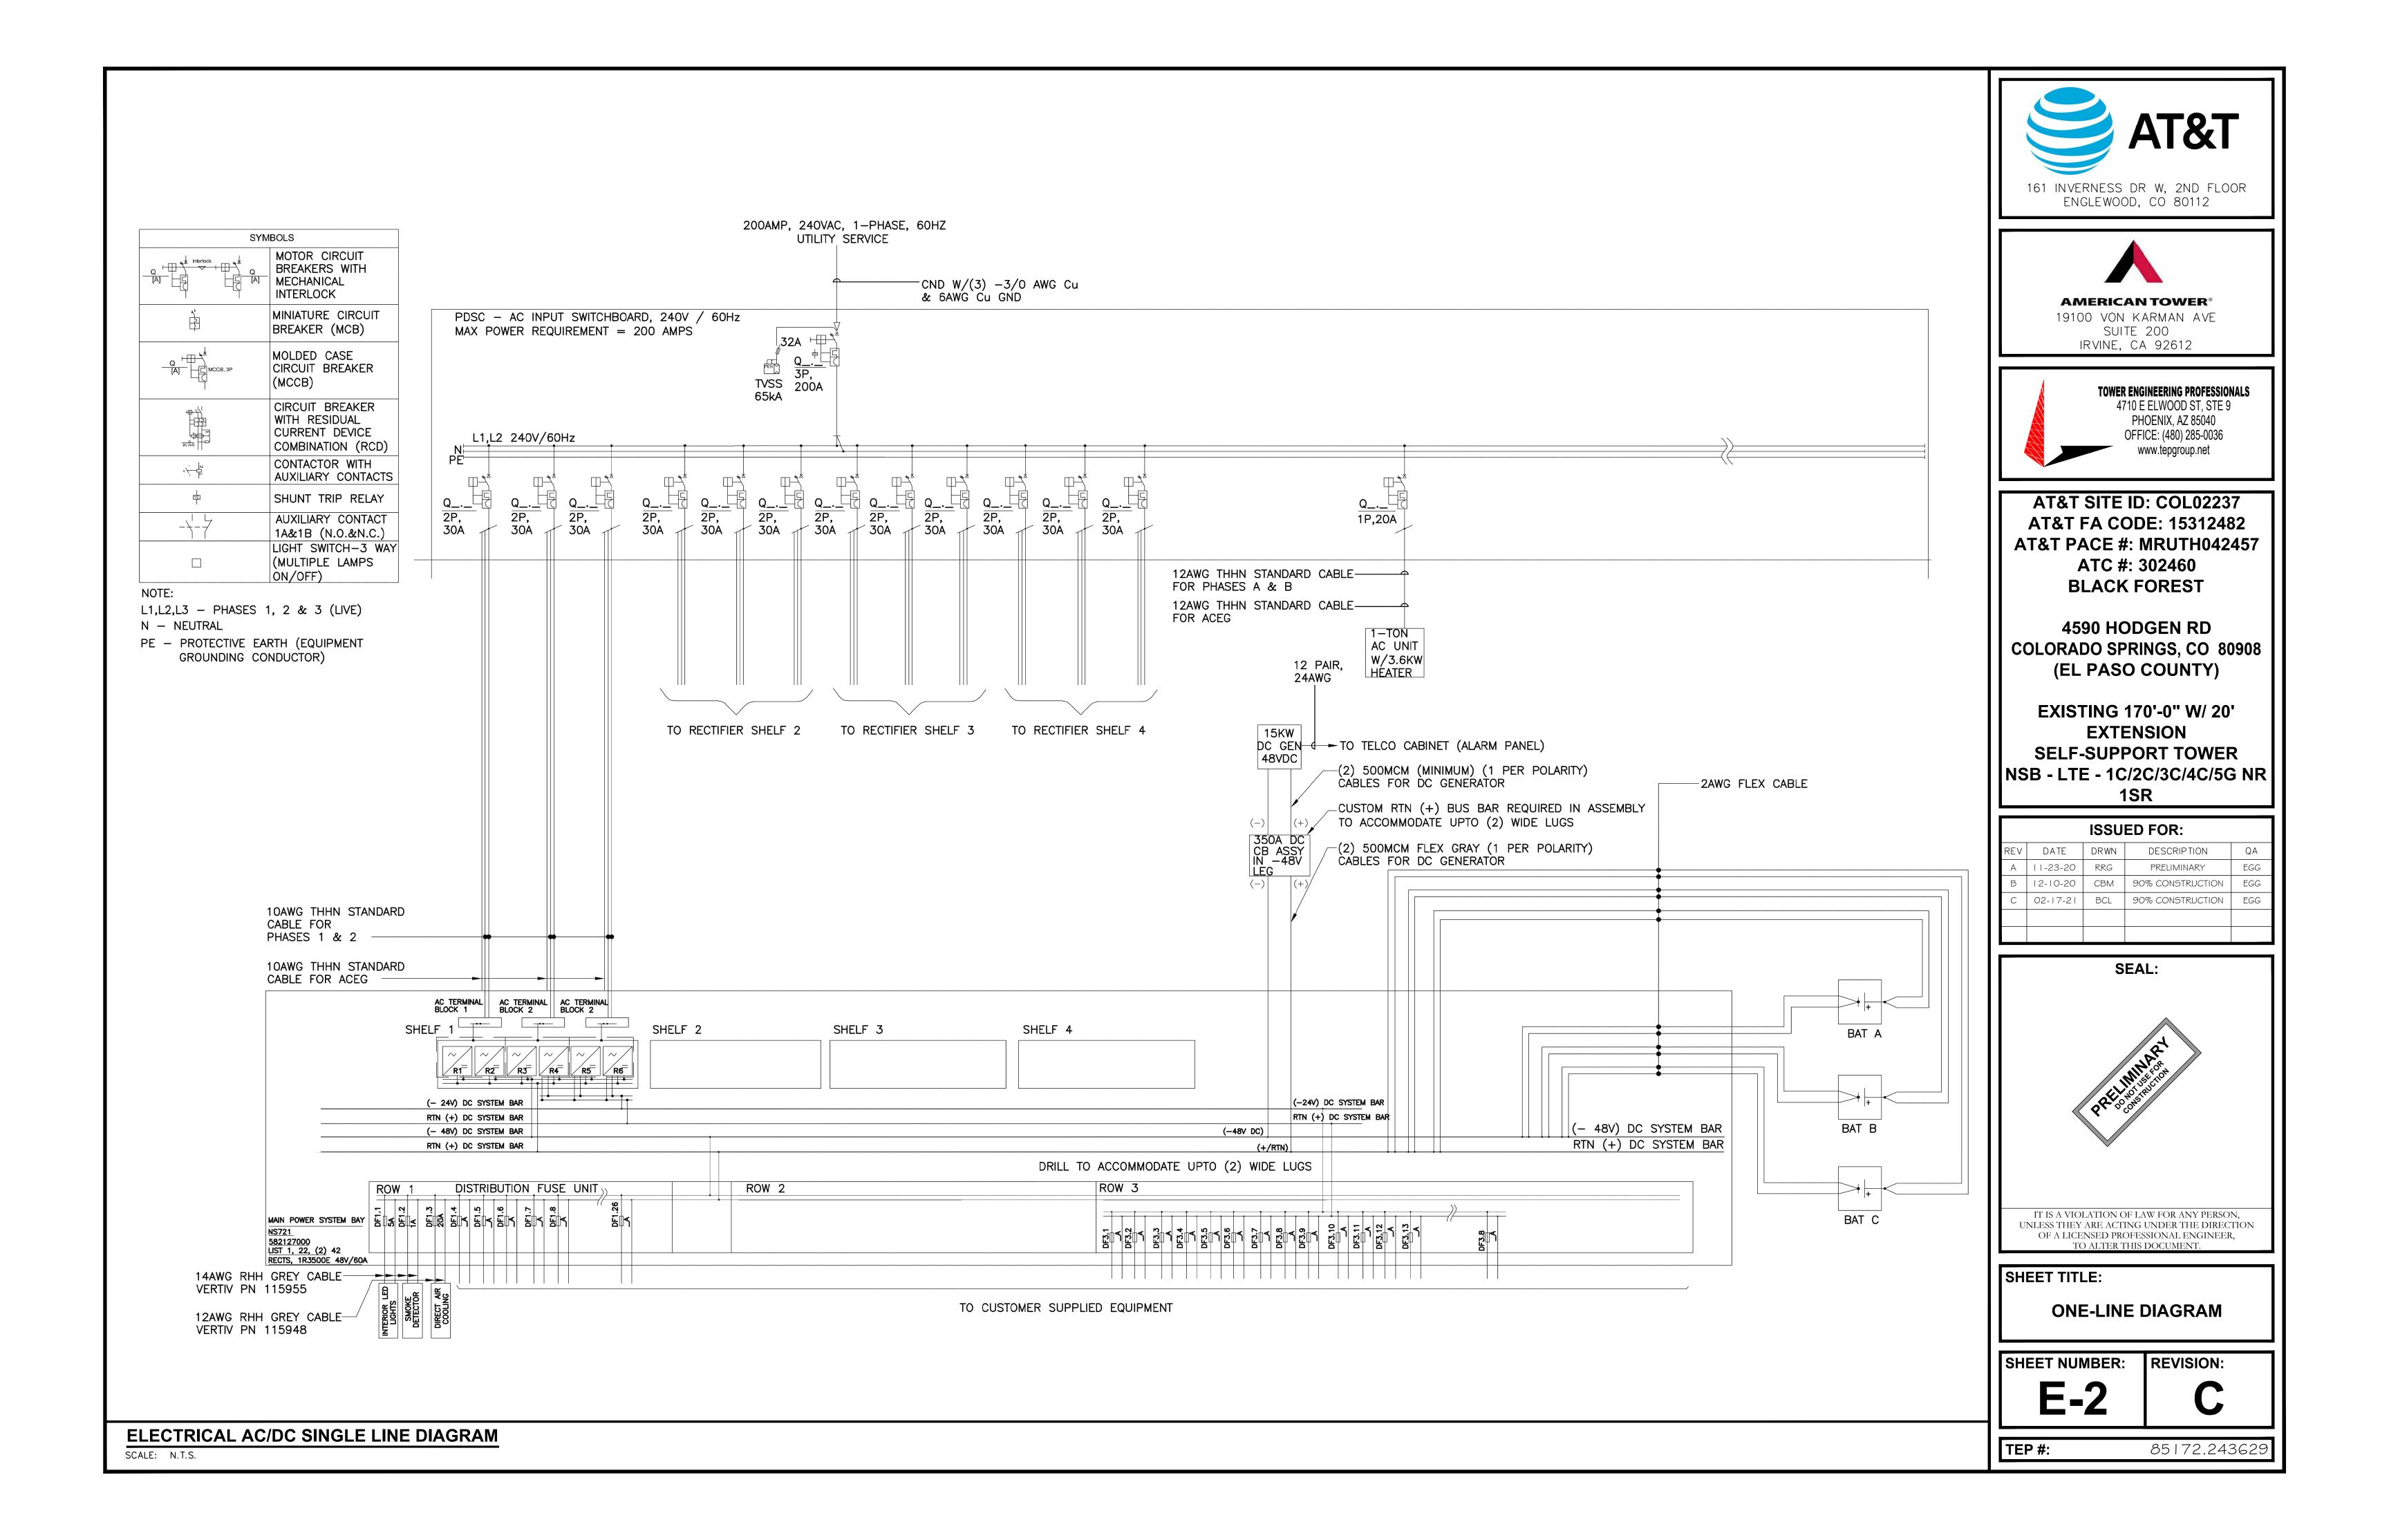


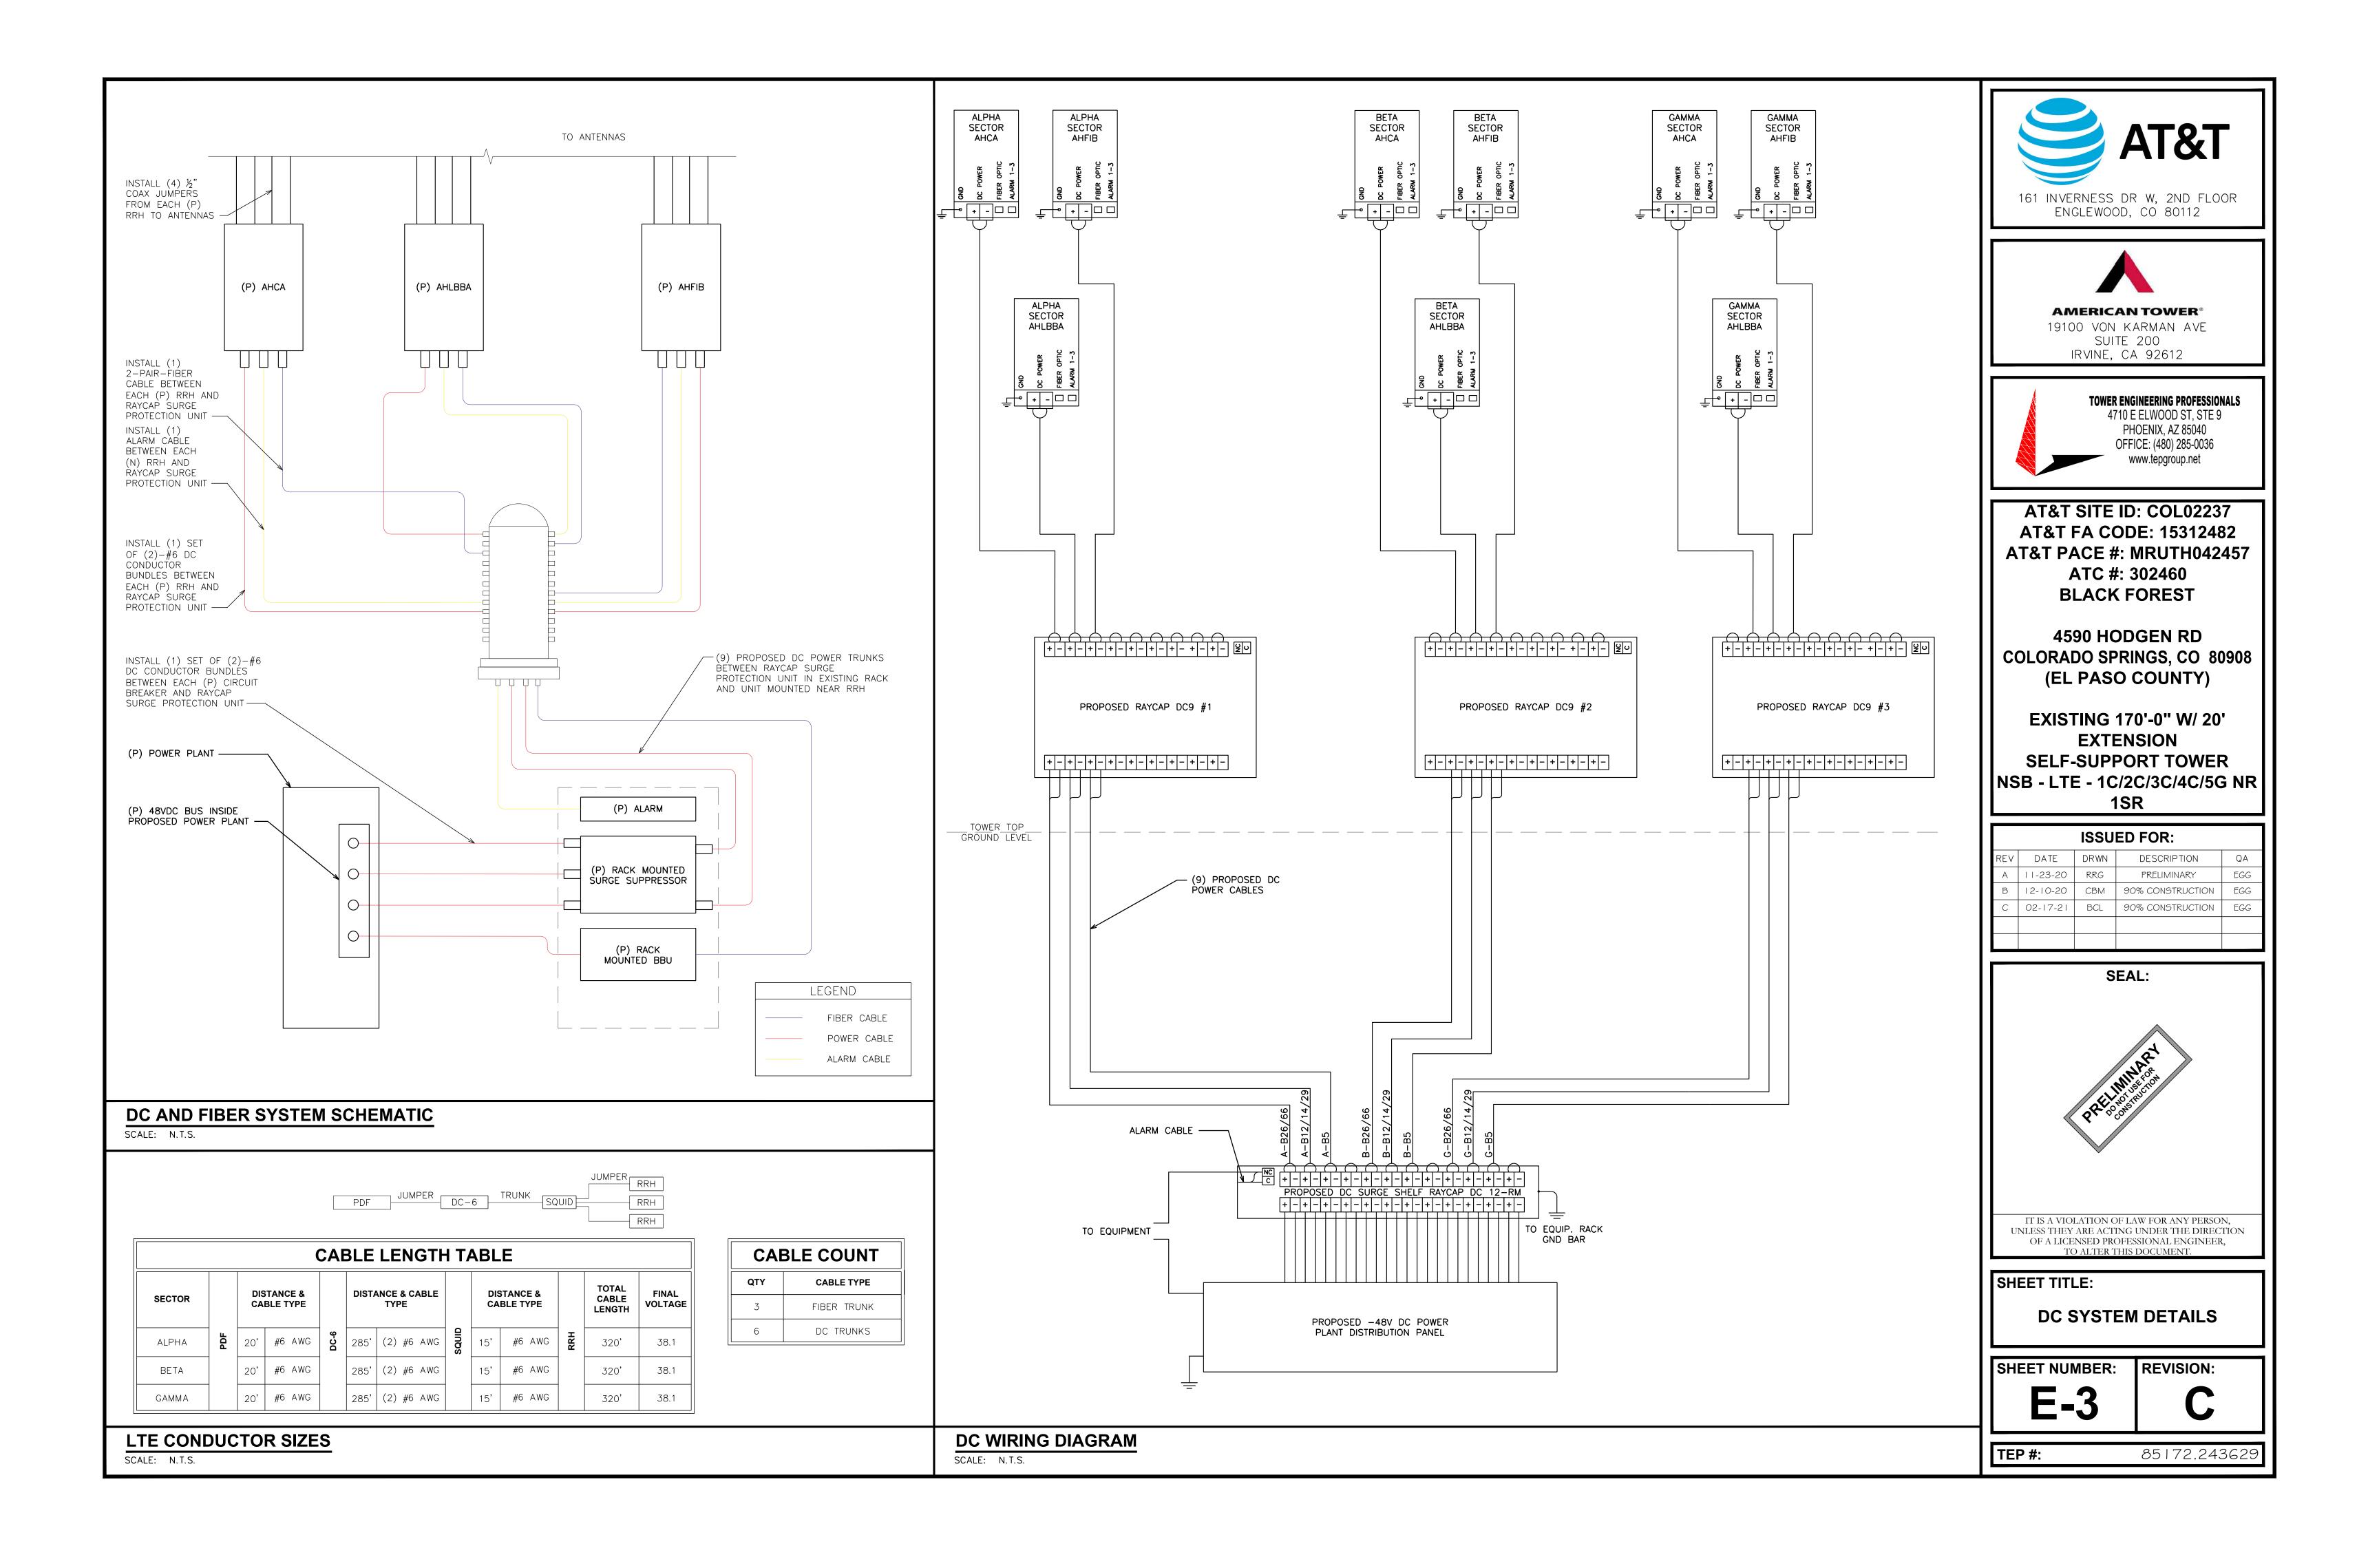

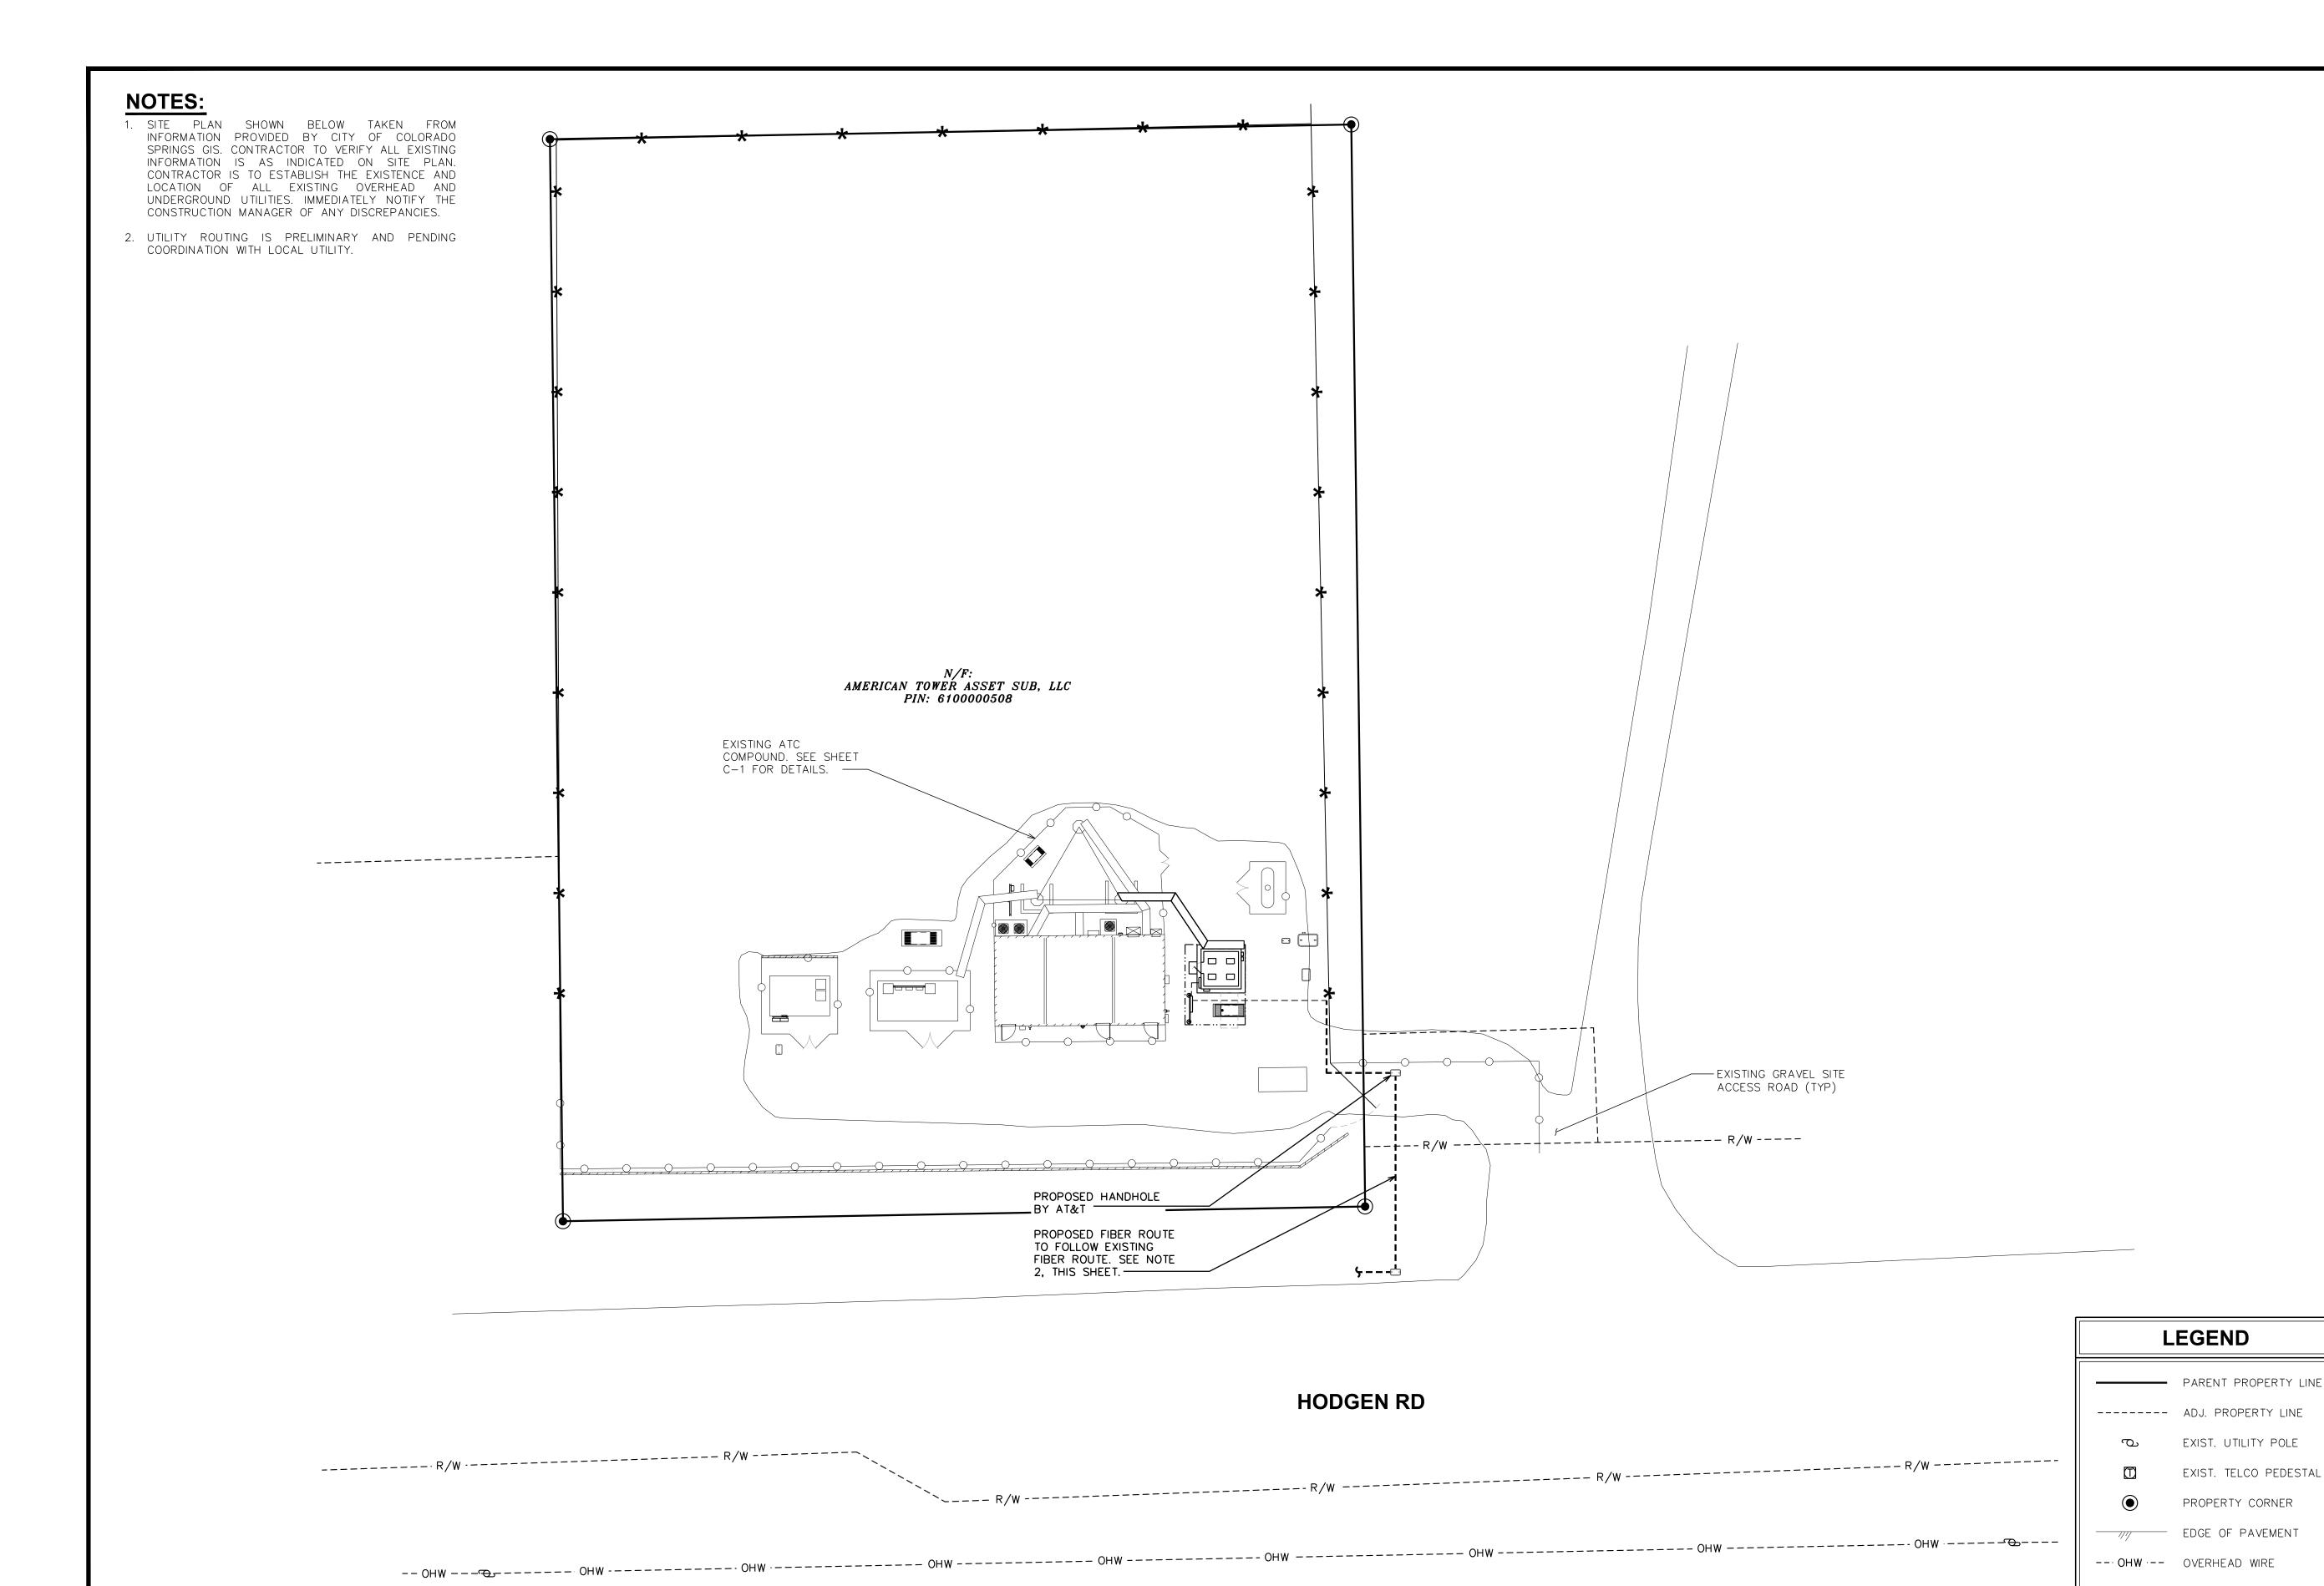

FIBER ROUTING PLAN

SCALE: 1" = 20'

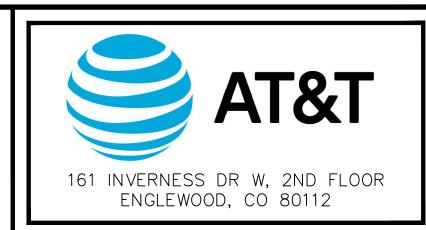



AMERICAN TOWER® 19100 VON KARMAN AVE SUITE 200 IRVINE, CA 92612

TOWER ENGINEERING PROFESSIONALS 4710 E ELWOOD ST, STE 9 PHOENIX, AZ 85040 OFFICE: (480) 285-0036 www.tepgroup.net

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SHEET TITLE:

-- OHW --- OVERHEAD WIRE

--- R/W --- RIGHT-OF-WAY

SCALE: $1" = 20' (24 \times 36)$

SCALE: 1" = 40' (11x17)


---- X ---- CHAIN LINK FENCE

EXISTING TREE LINE

SCALE IN FEET

FIBER ROUTING PLAN

SHEET NUMBER: REVISION:

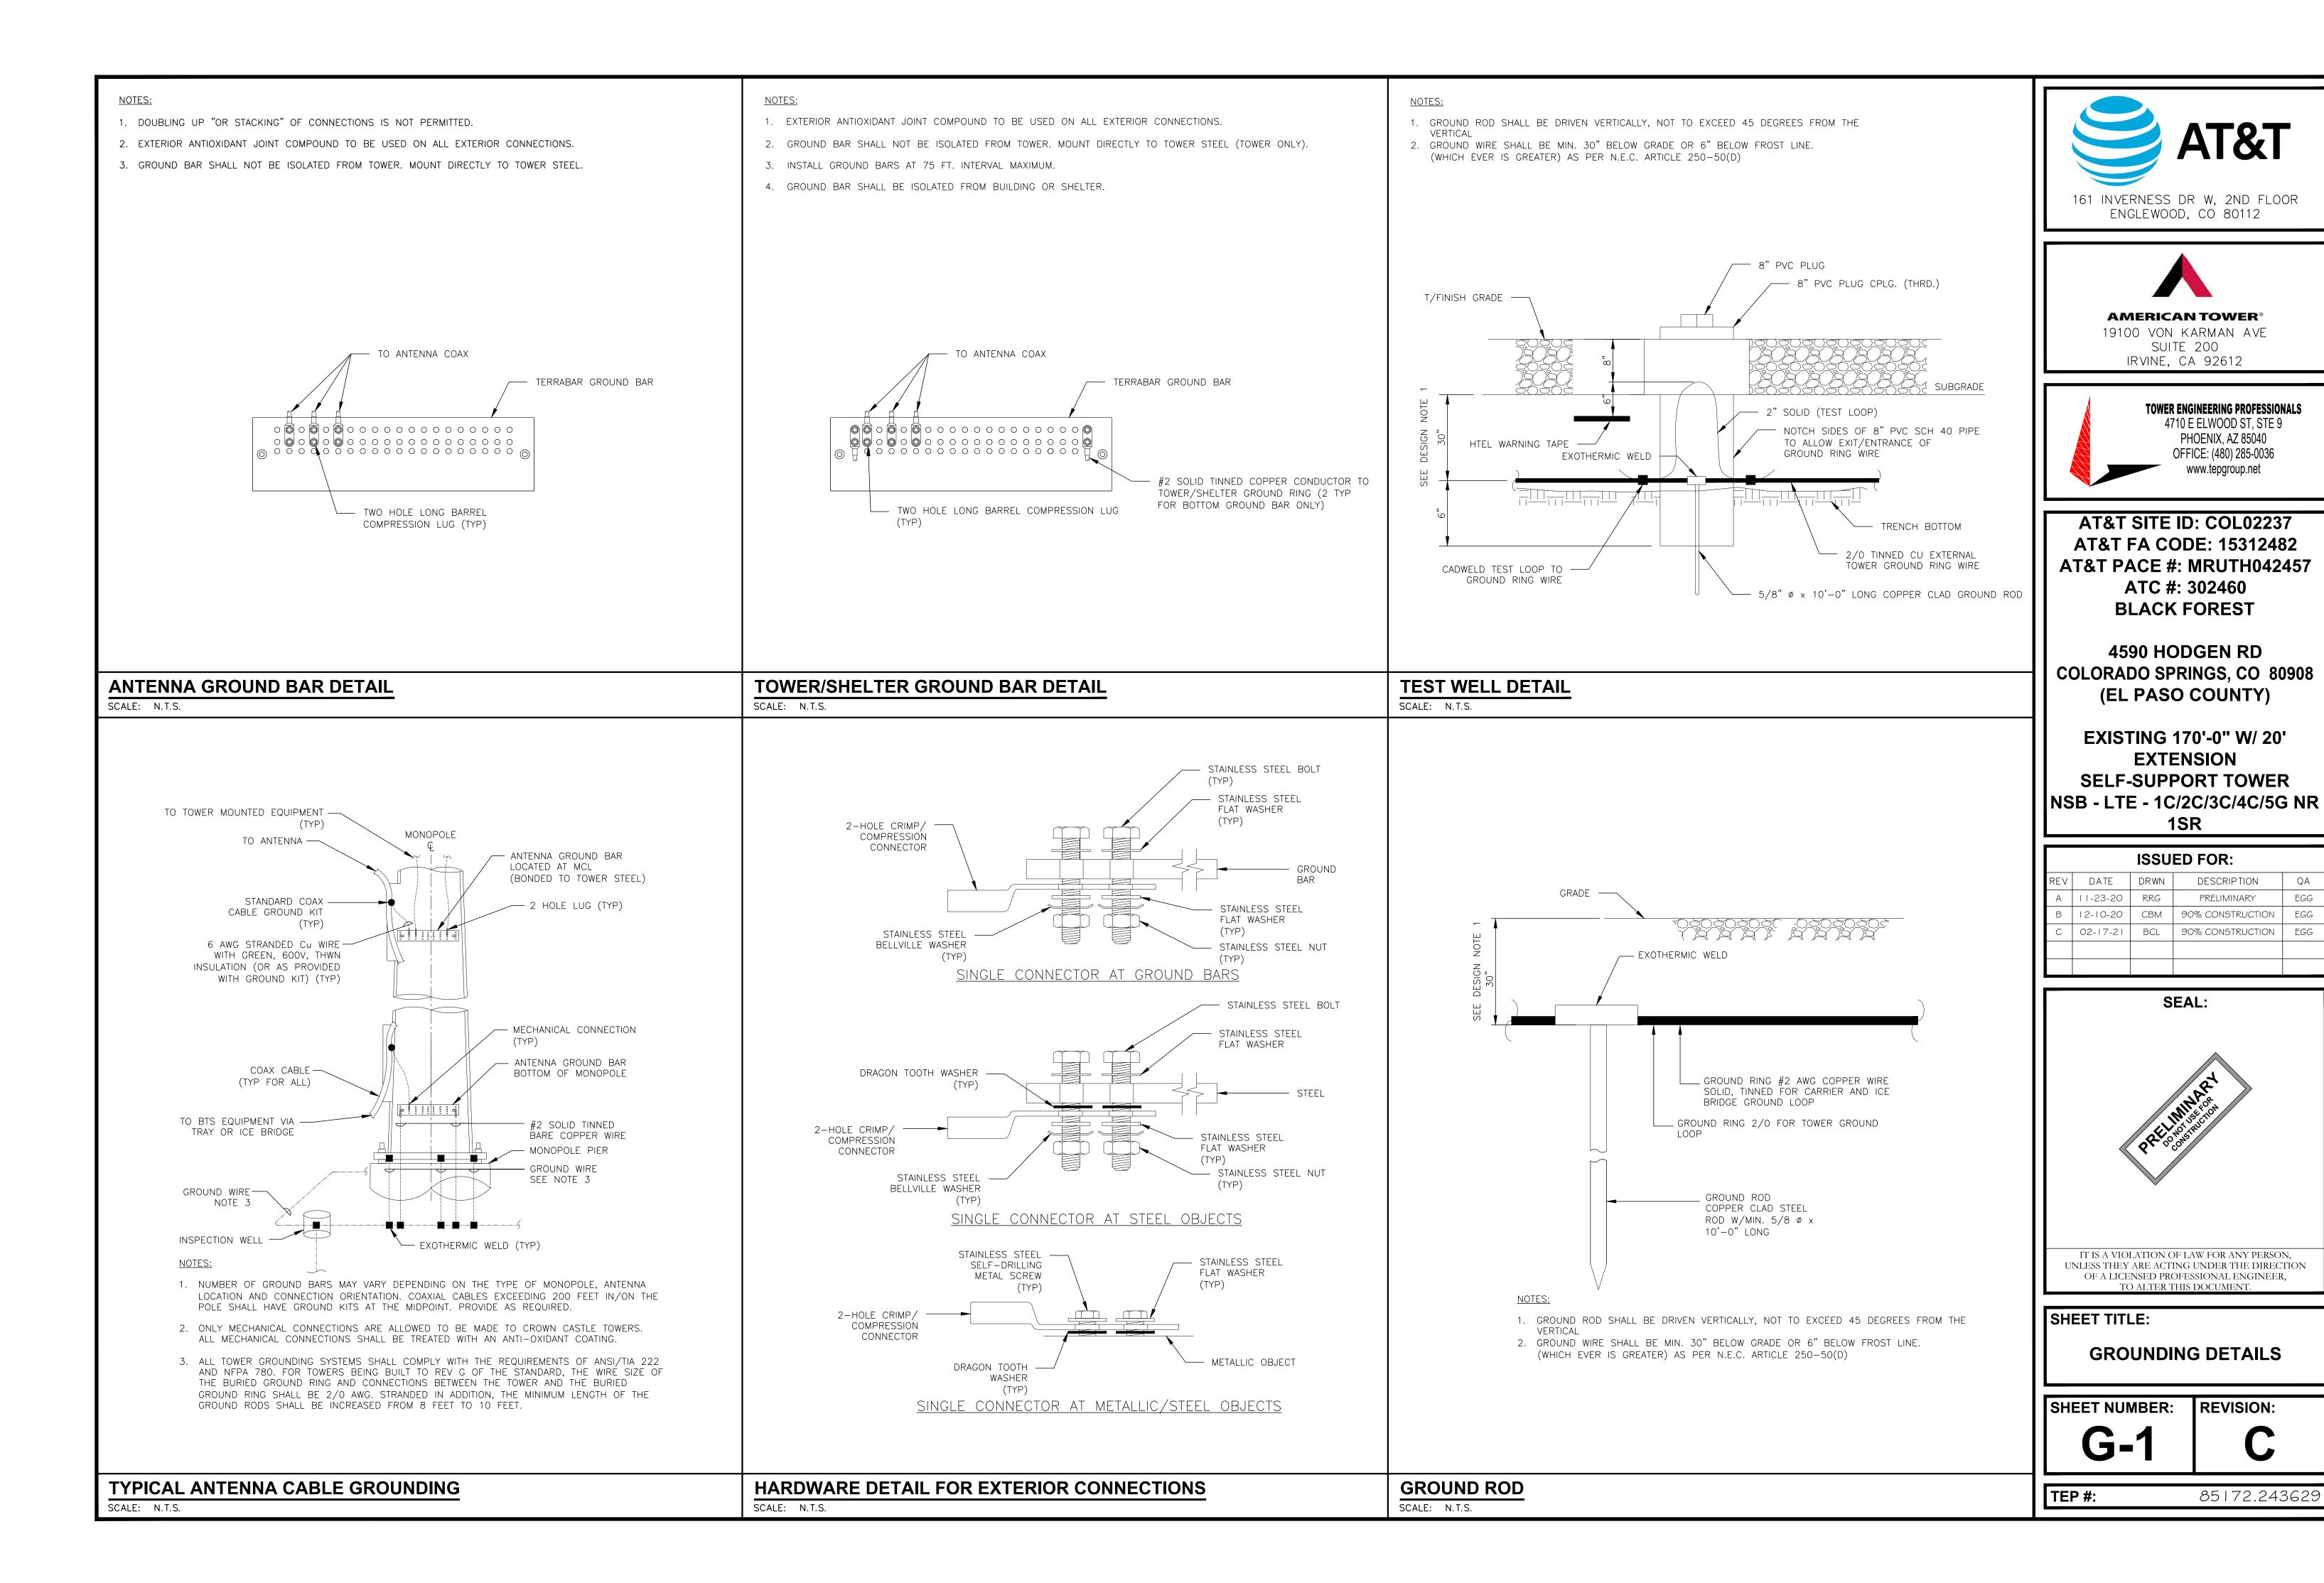

QΑ

EGG

