SHEET INDEX				
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TITLE SHEET	01	TS01		
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PRELIMINARY GRADING PLAN	10-14	GR01-GR05		
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HIGH PLAINS AT REAGAN RANCH

COLORADO SPRINGS, COLORADO DEVELOPMENT PLAN

LEGAL DESCRIPTION (PUD RESIDENTIAL):

A PORTION OF THAT PARCEL DESCRIBED IN BOOK 5562, PAGE 362, RECORDED OCTOBER 5, 1988, OF THE OFFICIAL PUBLIC RECORDS OF EL PASO COUNTY, COLORADO, BEING MORE PARTICULARLY DESCRIBED AS FOLLOWS:

COMMENCING AT THE NORTHWEST CORNER OF SAID PARCEL, BEING A POINT ON THE SOUTH RIGHT-OF-WAY LINE OF HIGHWAY 94, AND A POINT ON THE EAST RIGHT-OF-WAY LINE OF MARKSHEFFEL ROAD; THENCE ALONG SAID SOUTH RIGHT- OF-WAY LINE, S82°07'39"E (BEARINGS ARE BASED ON A MODIFIED COLORADO STATE PLANE CENTRAL ZONE. BASIS OF BEARINGS IS THE SOUTH RIGHT-OF-WAY LINE OF HIGHWAY 94 WITH A RECORD BEARING OF S82°07'53"E, A DISTANCE OF 689.89 FEET, BEING MONUMENTED AT THE WEST BY A 3-1/4" ALUMINUM CAP STAMPED, "PLS 9014," 0.5 FEET BELOW GRADE AND AT THE EAST BY A 3-1/4" ALUMINUM CAP STAMPED, "PLS 9014," FLUSH WITH GRADE, AND MEASURED TO BEAR S82°07'39"E, A DISTANCE OF 689.83 FEET), A DISTANCE OF 529.69 FEET, TO A POINT ON THE AIRPORT OVERLAY ZONING LINE, AND THE POINT OF BEGINNING; THENCE CONTINUING ALONG SAID SOUTH RIGHT-OF- WAY LINE THE FOLLOWING NINE (9) COURSES:

- 1. S82°07'39"E, A DISTANCE OF 160.14 FEET;
- 2. S25°57'26"E, A DISTANCE OF 70.45 FEET;
- 3. S69°31'45"E, A DISTANCE OF 853.71 FEET
- 4. S75°00'32"E, A DISTANCE OF 100.07 FEET;
- 5. S83°32'50"E, A DISTANCE OF 101.04 FEET
- 6. S89°01'45"E, A DISTANCE OF 515.57 FEET
- S67°14'51"E, A DISTANCE OF 343.97 FEET;
 S15°23'33"W, A DISTANCE OF 59.13 FEET;
- 9. S75°19'43"E, A DISTANCE OF 101.94 FEET, TO A POINT ON THE NORTH RIGHT-OF-WAY LINE OF SPACE VILLAGE AVENUE;
- THENCE ALONG SAID NORTH RIGHT-OF-WAY LINE THE FOLLOWING EIGHT (8) COURSES:
- 1. S11°45'54"W, A DISTANCE OF 135.13 FEET;
- 2. S49°02'42"W, A DISTANCE OF 142.67 FEET
- 3. S14°51'08"W, A DISTANCE OF 19.96 FEET;
- 4. N74°00'26"W, A DISTANCE IF 64.31 FEET;
- 5. S67°57'22"W, A DISTANCE OF 1079.89 FEET;
- 6. ALONG THE ARC OF A NON-TANGENT CURVE TO THE RIGHT, WHOSE CENTER BEARS N02°41'04"W, HAVING A RADIUS OF 1860.00 FEET, A CENTRAL ANGLE OF 06°43'20", A DISTANCE OF 218.22 FEET;
- 7. N86°01'20"W, A DISTANCE OF 288.27 FEET;
- 8. ALONG THE ARC OF A CURVE TO THE RIGHT, HAVING A RADIUS OF 2815.00 FEET, A CENTRAL ANGLE OF 07°38'54", A DISTANCE OF 375.77 FEET, TO A POINT ON SAID AIRPORT OVERLAY ZONING LINE;

THENCE LEAVING SAID NORTH RIGHT-OF-WAY LINE, N01°00'21"W, ALONG SAID AIRPORT OVERLAY ZONING LINE, A DISTANCE OF 1204.63 FEET, TO THE **POINT OF BEGINNING**

CONTAINING 1,658,139 SQ. FT. OR 38.066 ACRES, MORE OR LESS.

GENERAL NOTES:

- 1. THIS SITE IS NOT WITHIN A DESIGNATED F.E.M.A. FLOODPLAIN AS DETERMINED BY THE FLOOD INSURANCE RATE MAP NUMBER 08041C0758G, DATED DECEMBER 7, 2018.
- 2. ALL ON-SITE DRIVES, ROAD, AND SURFACE PARKING FACILITIES SHALL BE ASPHALT AND/OR CONCRETE.
- 3. SIGNAGE IS NOT APPROVED WITH THIS PLAN. A SEPARATE SIGN PERMIT IS REQUIRED. PLEASE CONTACT THE CITY'S DEVELOPMENT REVIEW ENTERPRISE AT 2880 INTERNATIONAL CIRCLE FOR A SIGN PLAN APPLICATION AND PERMIT PROCESS.
- 4. ALL "STOP SIGNS" WILL BE INSTALLED BY THE DEVELOPER AT THE LOCATIONS SHOWN ON THE DEVELOPMENT PLAN TO MEET MUTCD STANDARD. CONTACT TRAFFIC ENGINEERING, SIGNS & MARKINGS AT 719-385-6720 FOR ASSISTANCE.
- 5. THE PARTIES RESPONSIBLE FOR THIS PLAN HAVE FAMILIARIZED THEMSELVES WITH ALL CURRENT ACCESSIBILITY CRITERIA AND SPECIFICATIONS AND THE PROPOSED PLAN REFLECTS ALL SITE ELEMENTS REQUIRED BY THE APPLICABLE ADA DESIGN STANDARDS AND GUIDELINES AS PUBLISHED BY THE UNITED STATES DEPARTMENT OF JUSTICE. APPROVAL OF THIS PLAN BY THE CITY OF COLORADO SPRINGS DOES NOT ASSURE COMPLIANCE WITH THE ADA OR ANY OTHER FEDERAL OR STATE ACCESSIBILITY LAWS OR ANY REGULATIONS OR GUIDELINES ENACTED OR PROMULGATED UNDER OR WITH
- OWNER.

 6. ALL FREESTANDING AND BUILDING MOUNTED LIGHTING FIXTURES SHALL BE FULL CUT-OFF OR HAVE SHIELDING TO REDUCE OFF-SITE LIGHTING IMPACTS ONTO ADJACENT PROPERTIES AND ROADWAY.


RESPECT TO SUCH LAWS. SOLE RESPONSIBILITY FOR COMPLIANCE WITH FEDERAL AND STATE ACCESSIBILITY LAWS LIES WITH THE PROPERTY


- 7. ALL PROPOSED EASEMENTS AS PART OF THIS DEVELOPMENT WILL BE RECORDED AT TIME OF APPROVAL EITHER BY PLAT OR BY SEPARATE
- 8. ALL ROADWAYS AND DRIVE AISLES WITHIN THIS DEVELOPMENT ARE TO BE PUBLIC, OWNED AND MAINTAINED BY THE CITY OF COLORADO SPRINGS.
- NO DIRECT VEHICULAR ACCESS SHALL BE PERMITTED TO STATE HIGHWAY 94. ACCESS SHALL BE AFFORDED AS ILLUSTRATED WITHIN THIS PLAN.
 MAIL KIOSKS SHALL BE LOCATED AS SHOWN. FINAL LOCATIONS TO BE DETERMINED IN COORDINATION WITH USPS.
- 11. STORMWATER QUALITY WILL BE PROVIDED ONSITE.
- 12. LIFT STATION TRACT AND FACILITIES AS SHOWN SHALL BE DEDICATED TO COLORADO SPRINGS UTILITIES UPON COMPLETION.
- 13. ALL HOMES, LOTS 1-80, SHALL BE ADDRESSED OFF THE NAMED STREET AT THE REAR OF THE HOME. ALL HOMES, LOTS 81-181, SHALL BE ADDRESSED OFF THE NAMED STREET AT THE FRONT OF THE HOME.
- 14. NO ON STREET PARKING ALLOWED ON ACCESS STREETS.
- 15. DRIVEWAYS SHALL BE MINIMUM 20' LONG AS MEASURED FROM BACK OF CURB TO STRUCTURE. SEE DETAILS ON SHEET DT02 FOR CLARIFICATION.
 16. AN AVIGATION EASEMENT EFFECTING THE SUBJECT PROPERTY AND DEVELOPMENT IS THEREIN ESTABLISHED BY THE HIGH PLAINS AT REAGAN RANCH SUBDIVISION PLAT. THIS EASEMENT IS SUBJECT TO THE TERMS AND CONDITIONS AS SPECIFIED IN THE INSTRUMENT RECORDED UNDER RECEPTION NO. 217069667 OF THE RECORDS OF EL PASO COUNTY, COLORADO. ALL OTHER EASEMENTS OR INTERESTS OF RECORD AFFECTING ANY OF THE PLATTED PROPERTY DEPICTED HEREON SHALL NOT BE AFFECTED AND SHALL REMAIN IN FULL FORCE AND EFFECT.
- 17. ACCESSIBLE PARKING SPACES, ACCESS AISLES, AND SIGNAGE SHALL MEET ALL APPLICABLE CITY CODE REQUIREMENTS INCLUDING:
- PARKING SPACES AND ACCESS AISLES SHALL BE LEVEL WITH SURFACE SLOPES NOT EXCEEDING ONE TO FIFTY (1:50) (2 PERCENT) IN ALL DIRECTIONS
- ACCESSIBLE PARKING SPACES SHALL BE MARKED WITH FOUR INCH (4") LINES
 ACCESSIBLE ALS ESCHALL BE OUT INFO AND DIACONALLY STRIPED AT FORTY
- ACCESSIBLE AISLES SHALL BE OUTLINED AND DIAGONALLY STRIPED AT FORTY FIVE DEGREE (45°) ANGLES IN A CONTRASTING COLOR SUCH AS
 YELLOW, WHITE, OR BLUE.
- THE MINERAL ESTATE OWNER NOTIFICATION CERTIFICATION AFFIDAVIT WAS SUBMITTED AND CAN BE FOUND IN FILE CPC PUD 21-00015. THE APPLICANT (OR PROPERTY OWNER) HAS ATTESTED THERE ARE NO SEPARATE MINERAL ESTATE OWNER(S) IDENTIFIED AND NO FURTHER ACTION WAS TAKEN.
- 18. THE DEVELOPER WILL BE RESPONSIBLE FOR THE ROADWAY IMPROVEMENTS AS IMPACTED BY THIS SUBDIVISION PER THE MASTER TRAFFIC STUDY.

 19. ALL PROPOSED STREET TREES AND STREETSCAPE IMPROVEMENTS WILL BE MAINTAINED BY THE REAGAN RANCH METROPOLITAN DISTRICT.

PARK NOTES:

- 1. ALL PROPOSED PUBLIC PARKS, COMMON AREAS, AND OPEN SPACE WITHIN REAGAN RANCH ARE TO BE BUILT, OWNED AND MAINTAINED BY THE REAGAN RANCH METROPOLITAN DISTRICT.
- 2. THE REAGAN RANCH METROPOLITAN DISTRICT WAS APPROVED BY THE CITY OF COLORADO SPRINGS CITY COUNCIL ON AUGUST 25, 2020.
- 3. PLDO OBLIGATIONS FOR THE HIGH PLAINS AS REAGAN RANCH DEVELOPMENT TO BE PER THE REAGAN RANCH MASTER PLAN AMENDMENT (CPC MP 87-00381-A27MJ20).

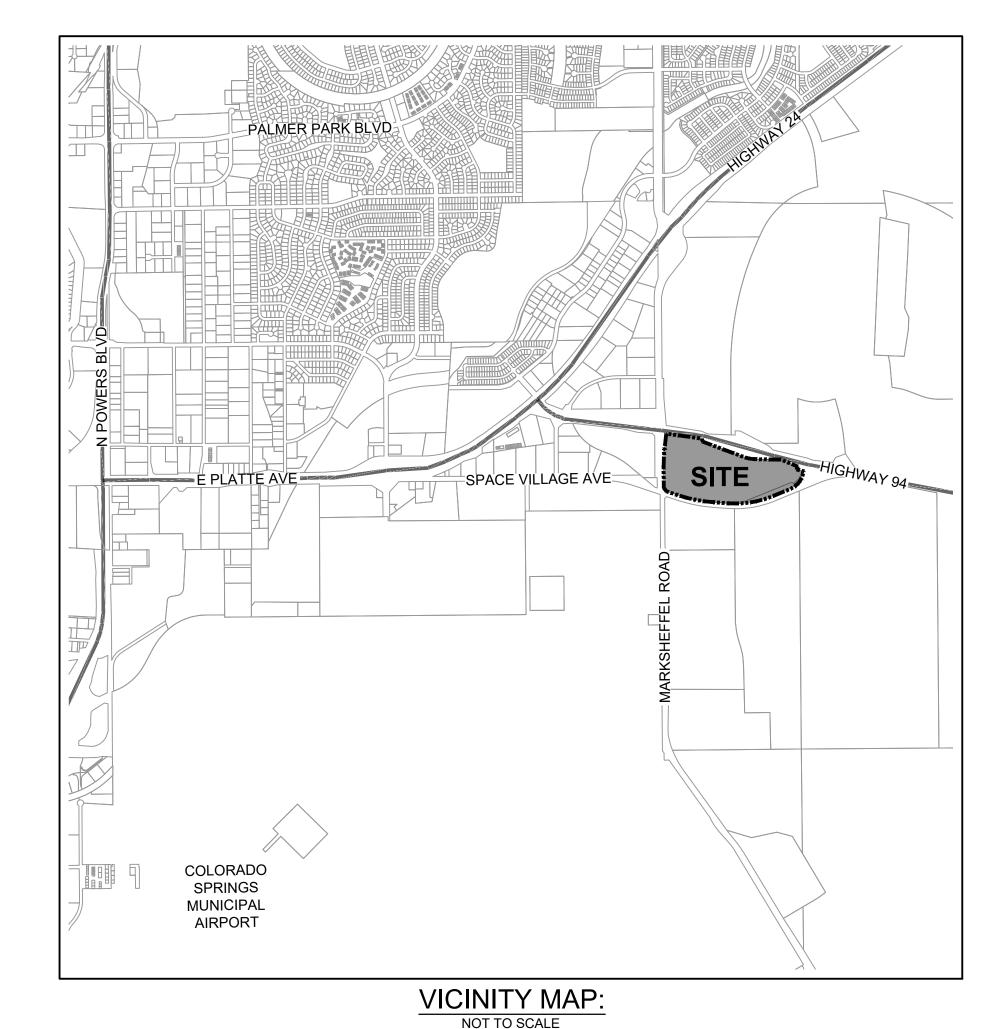

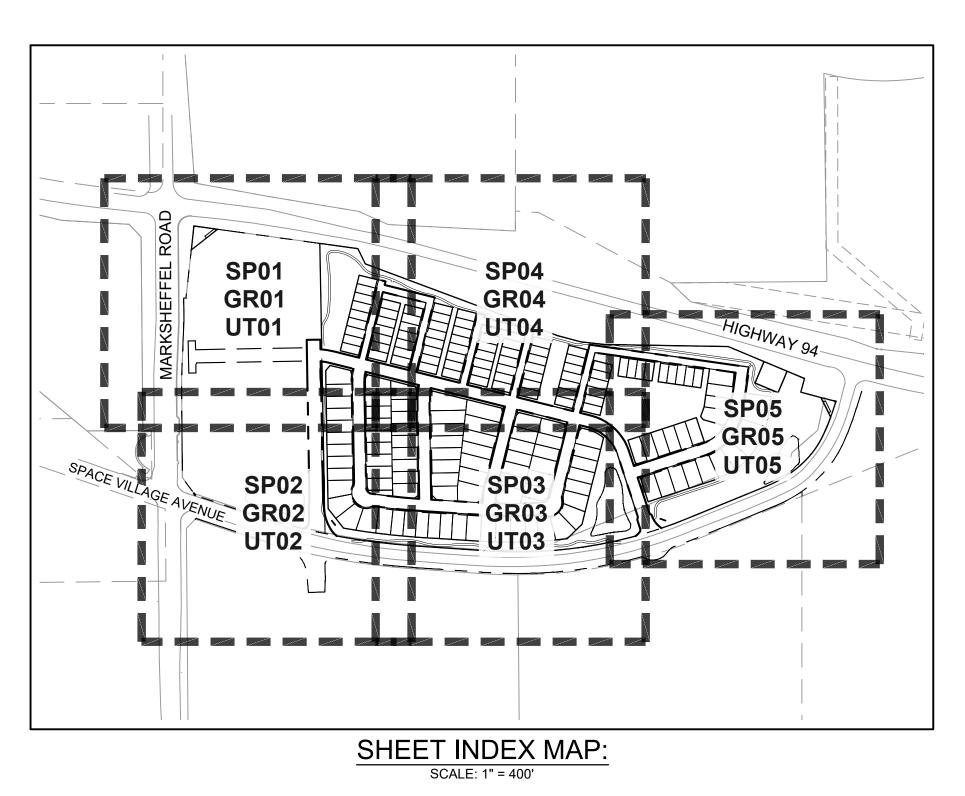

SUMMARY DA	ATA (RESIDENTIAL)
PROPERTY SIZE	40.89 ACRES
TAX SCHEDULE NO.	540000280
MASTER PLAN	BANNING LEWIS RANCH (CPC MP 87-00381-A17MN17)
CONCEPT PLAN	REAGAN RANCH
DRAINAGE BASIN	JIMMY CAMP CREEK
DEVELOPMENT SCHEDULE	2020-2025
PROJECT ADDRESS	TBD/ VACANT LAND
APPROVED MASTER PLAN USE	RESIDENTIAL
EXISTING LAND USE	AG GRAZING LAND/ VACANT
PROPOSED LAND USE	RESIDENTIAL
EXISTING ZONING	PUD/ AO (PENDING)
PROPOSED ZONING	PUD/ AO
BUILDING SETBACKS	PER LOT DETAILS
LANDSCAPE SETBACKS	SEE PLAN
MAX. BUILDING HEIGHT	45'
MIN. LOT SIZE	2,880 SQ. FT.
MAX. LOT COVERAGE PRIMARY STRUCTURE	60% (PRIMARY)
MAX. LOT COVERAGE ACCESSORY STRUCTURE	NO MINIMUM
PROPOSED TOTAL GROSS DENSITY	181 UNITS / 40.89 AC = 4.43 DU/AC

SUMMARY DATA (FUTURE PBC)		
PROPERTY SIZE	15.33 ACRES	
TAX SCHEDULE NO.	540000280	
APPROVED MASTER PLAN USE	COMMERCIAL	
PROPOSED LAND USE	COMMERCIAL/ OFFICE	
PROPOSED ZONING	PBC/ AO	

NOTE: DEVELOPMENT PLAN REVIEW AND APPROVAL IS REQUIRED

FOR ALL COMMERCIAL PARCELS PRIOR TO BUILDING PERMIT.

PARKING SUMMARY	(GREEN COURT ORIENTED)
LOT COUNT (GREEN COURT ORIENTED)	80
REQUIRED GUEST PARKING	0.5 PARKING SPACE PER UNIT

REQUIRED GUEST PARKING

0.5 PARKING SPACE PER UNIT
0.5 X 80 = 40 SPACES

PROVIDED GUEST PARKING
(OFFSTREET)

56

COMMON OPEN S	SPACE (SMALL LOT AREA)
REQUIRED	LOTS 3,999 SF OR LESS = 600 SF/ 1 LOT
TOTAL REQUIRED	80 LOTS X 600 = 48,000 SF
PROVIDED	TRACT E = 11,818 SF
	TRACT F = 11,980 SF
	PORTION OF TRACT D = 139,273 SF
TOTAL PROVIDED	163,071 SF

TRACT	SIZE (SQ. FT.)	LANDSCAPE/ PARK OPEN SPACE/ TRAIL	POCKET PARK	SIGNAGE/ PUBLIC IMPROVEMENTS	DRAINAGE/ DETENTION	PUBLIC UTILITIES	OWNED BY	MAINTAINED BY
Α	4,998	X		X	Х	Х	RRMD	RRMD
В	10,088					Х	RRMD	RRMD
С	2,227	Х		X	Х	Х	PPI	RRMD
D	305,106	Х	Х	X	Х	Х	RRMD	RRMD
E	11,818	Х		Х	Х	Х	RRMD	RRMD
F	11,980	Х		X	Х	Х	RRMD	RRMD
G	99,815	Х	Х	X	Х	Х	RRMD	RRMD
Н	2,005	Х		Х	Х	Х	RRMD	RRMD
	124,120	Х		X	Х	Х	RRMD	RRMD
J	2,200	Х		X	Х	Х	RRMD	RRMD
K	3,189	X		X	Х	Х	RRMD	RRMD
L	2,295	Х		Х	Х	Х	RRMD	RRMD
М	1,733	Х		Х	Х	Х	RRMD	RRMD
	581,576							

RRMD = REAGAN RANCH METROPOLITAN DISTRICT
PPI = PIKES PEAK INVESTMENTS LLC

CONSULTANTS:

PLANNER/ LANDSCAPE ARCHITECT/ CIVIL ENGINEER:

2435 RESEARCH PARKWAY, SUITE 300
COLORADO SPRINGS, CO 80920
PHONE: (719) 575-0100
FAX: (719) 575-0208

OWNER/DEVELOPER:
PIKES PEAK INVESTMENTS LLC

90 SOUTH CASCADE AVE., SUITE 1500 COLORADO SPRINGS, CO 80903



Highway 94

Space Village Ave

PROJECT:

SHEET TITLE:


HIGH PLAINS AT REAGAN RANCH DEVELOPMENT PLAN COLORADO SPRINGS, CO


REV	REVISION HISTORY:					
NO.	DATE	DESCRIPTION	BY			
0	12/23/2020	INITIAL CITY SUBMITTAL	RAF			
1	06/02/2021	SECOND CITY SUBMITTAL	RAF			
DRA	WING INFOR	MATION:				
PRO	DJECT NO:	19.224.008				
DRAWN BY: RAF		RAF				
CHECKED BY:		JRA				
APP	APPROVED BY: JRA					


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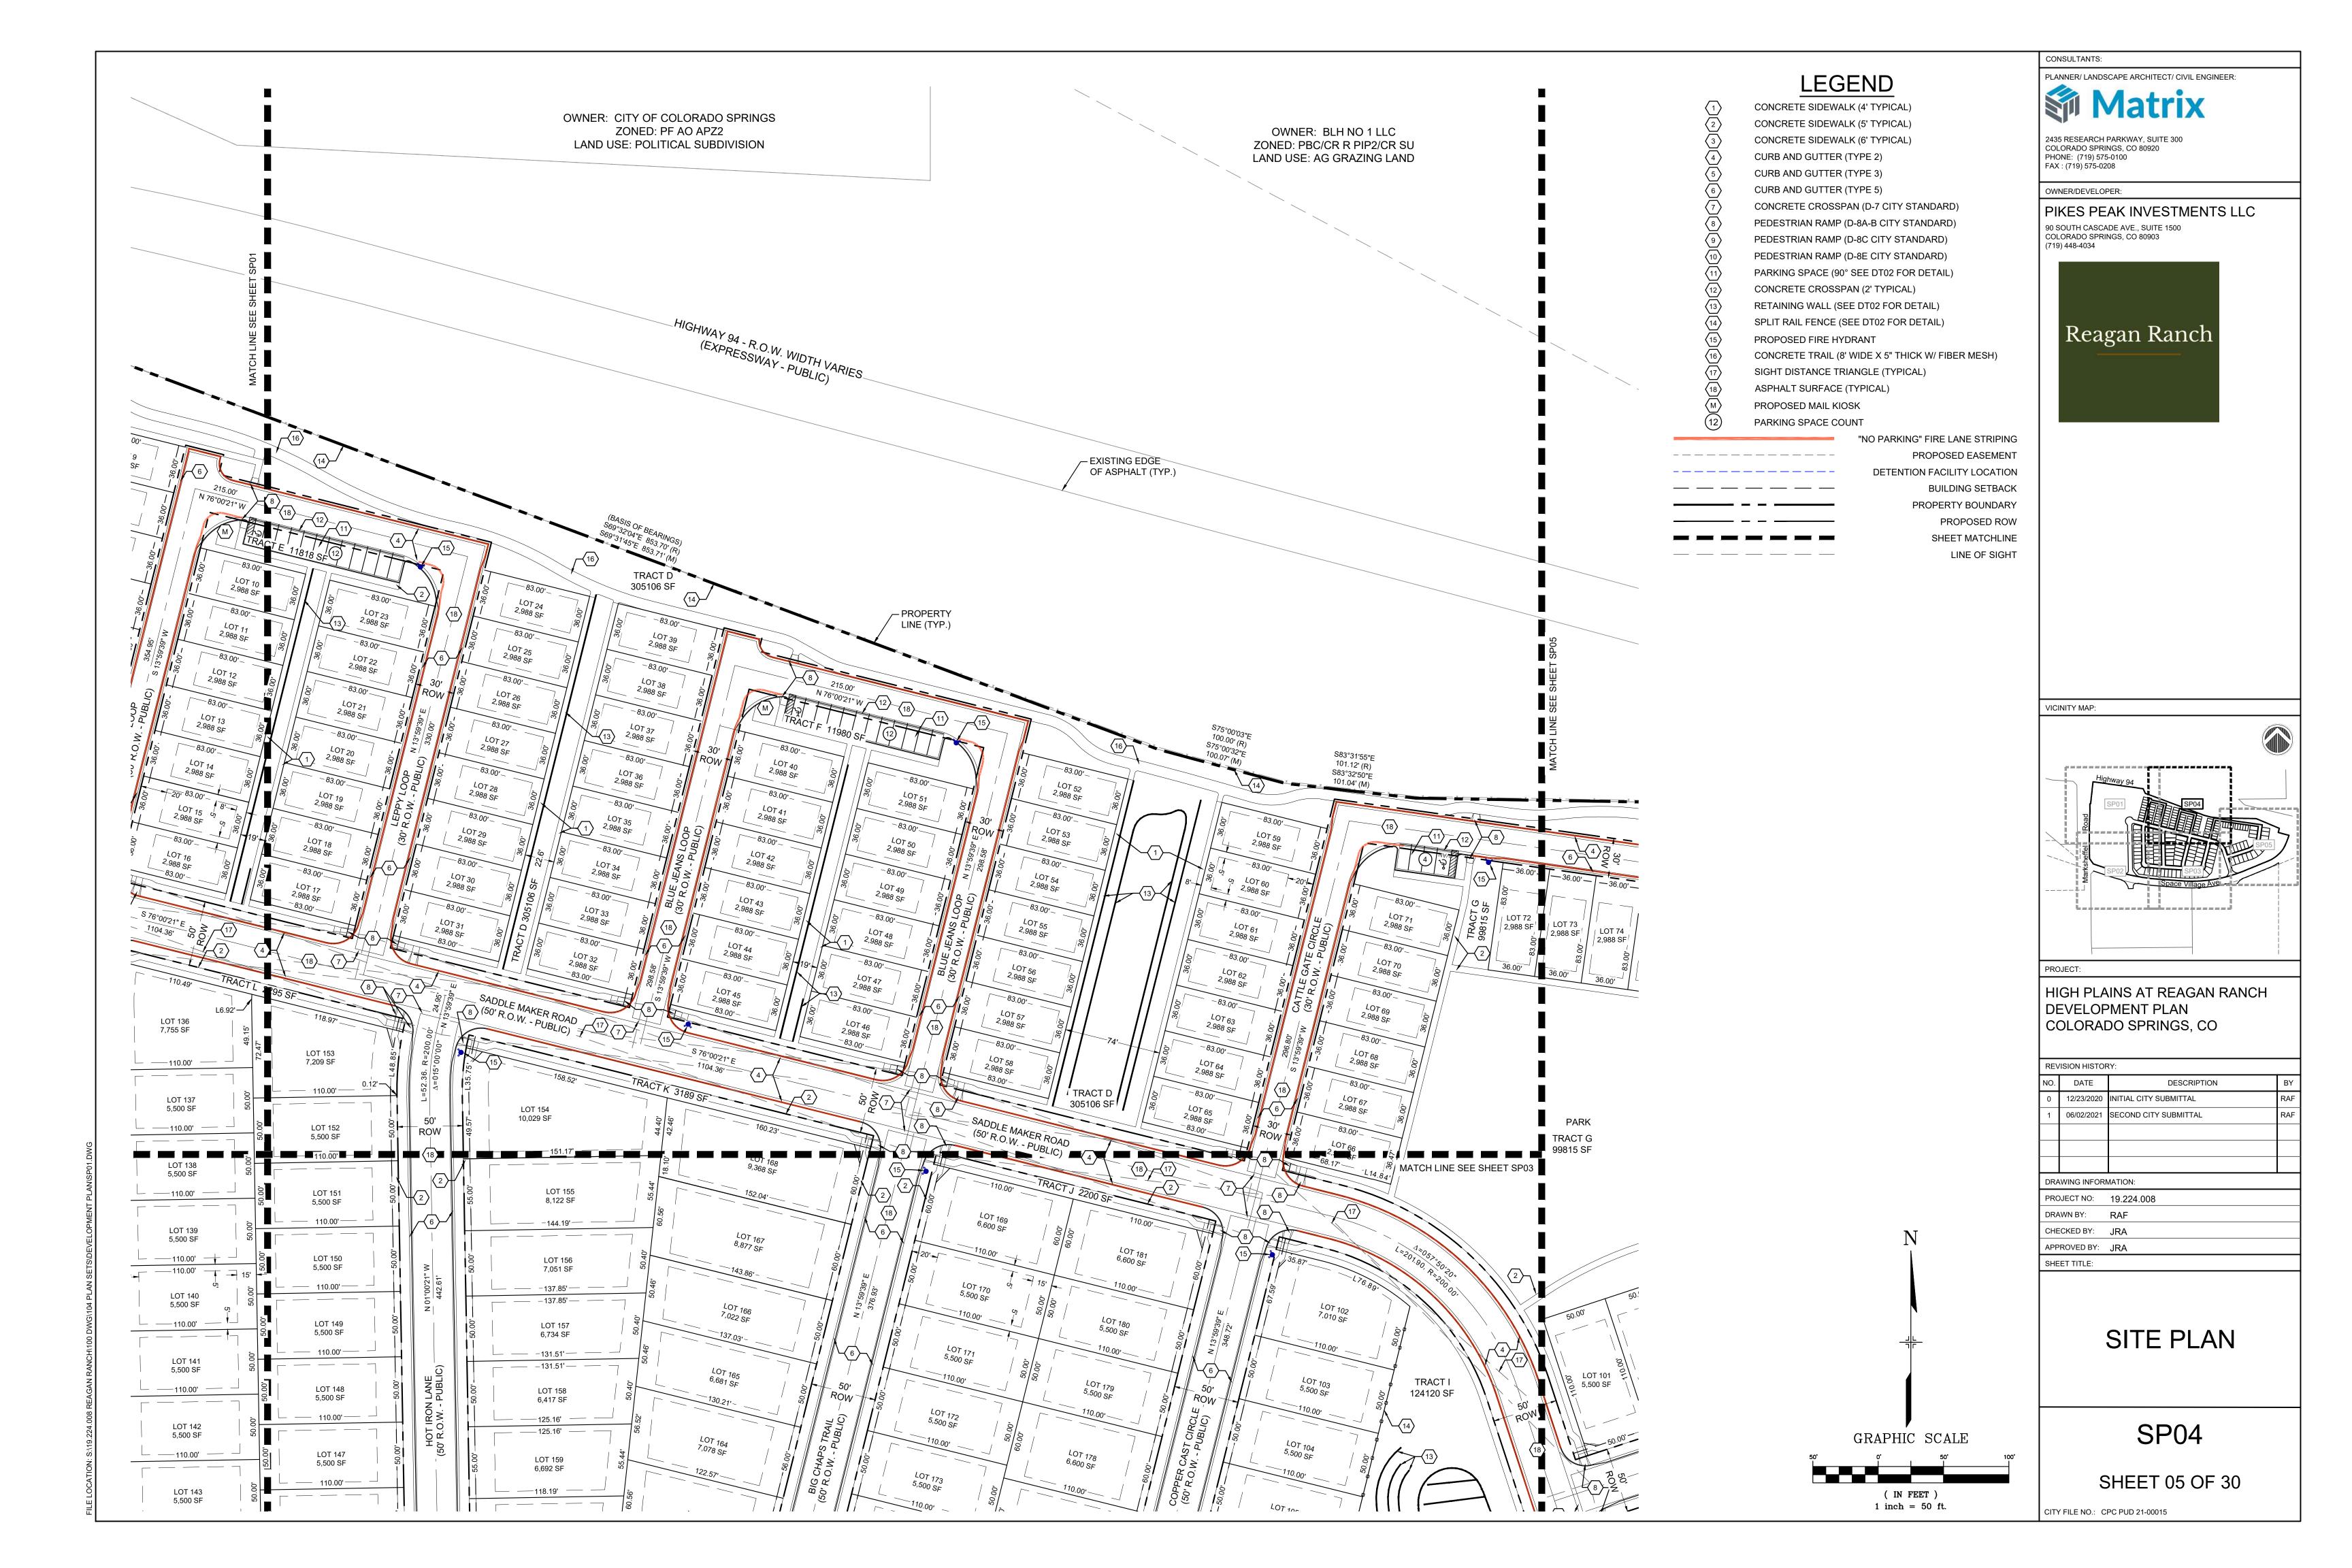
TS01


SHEET 01 OF 30




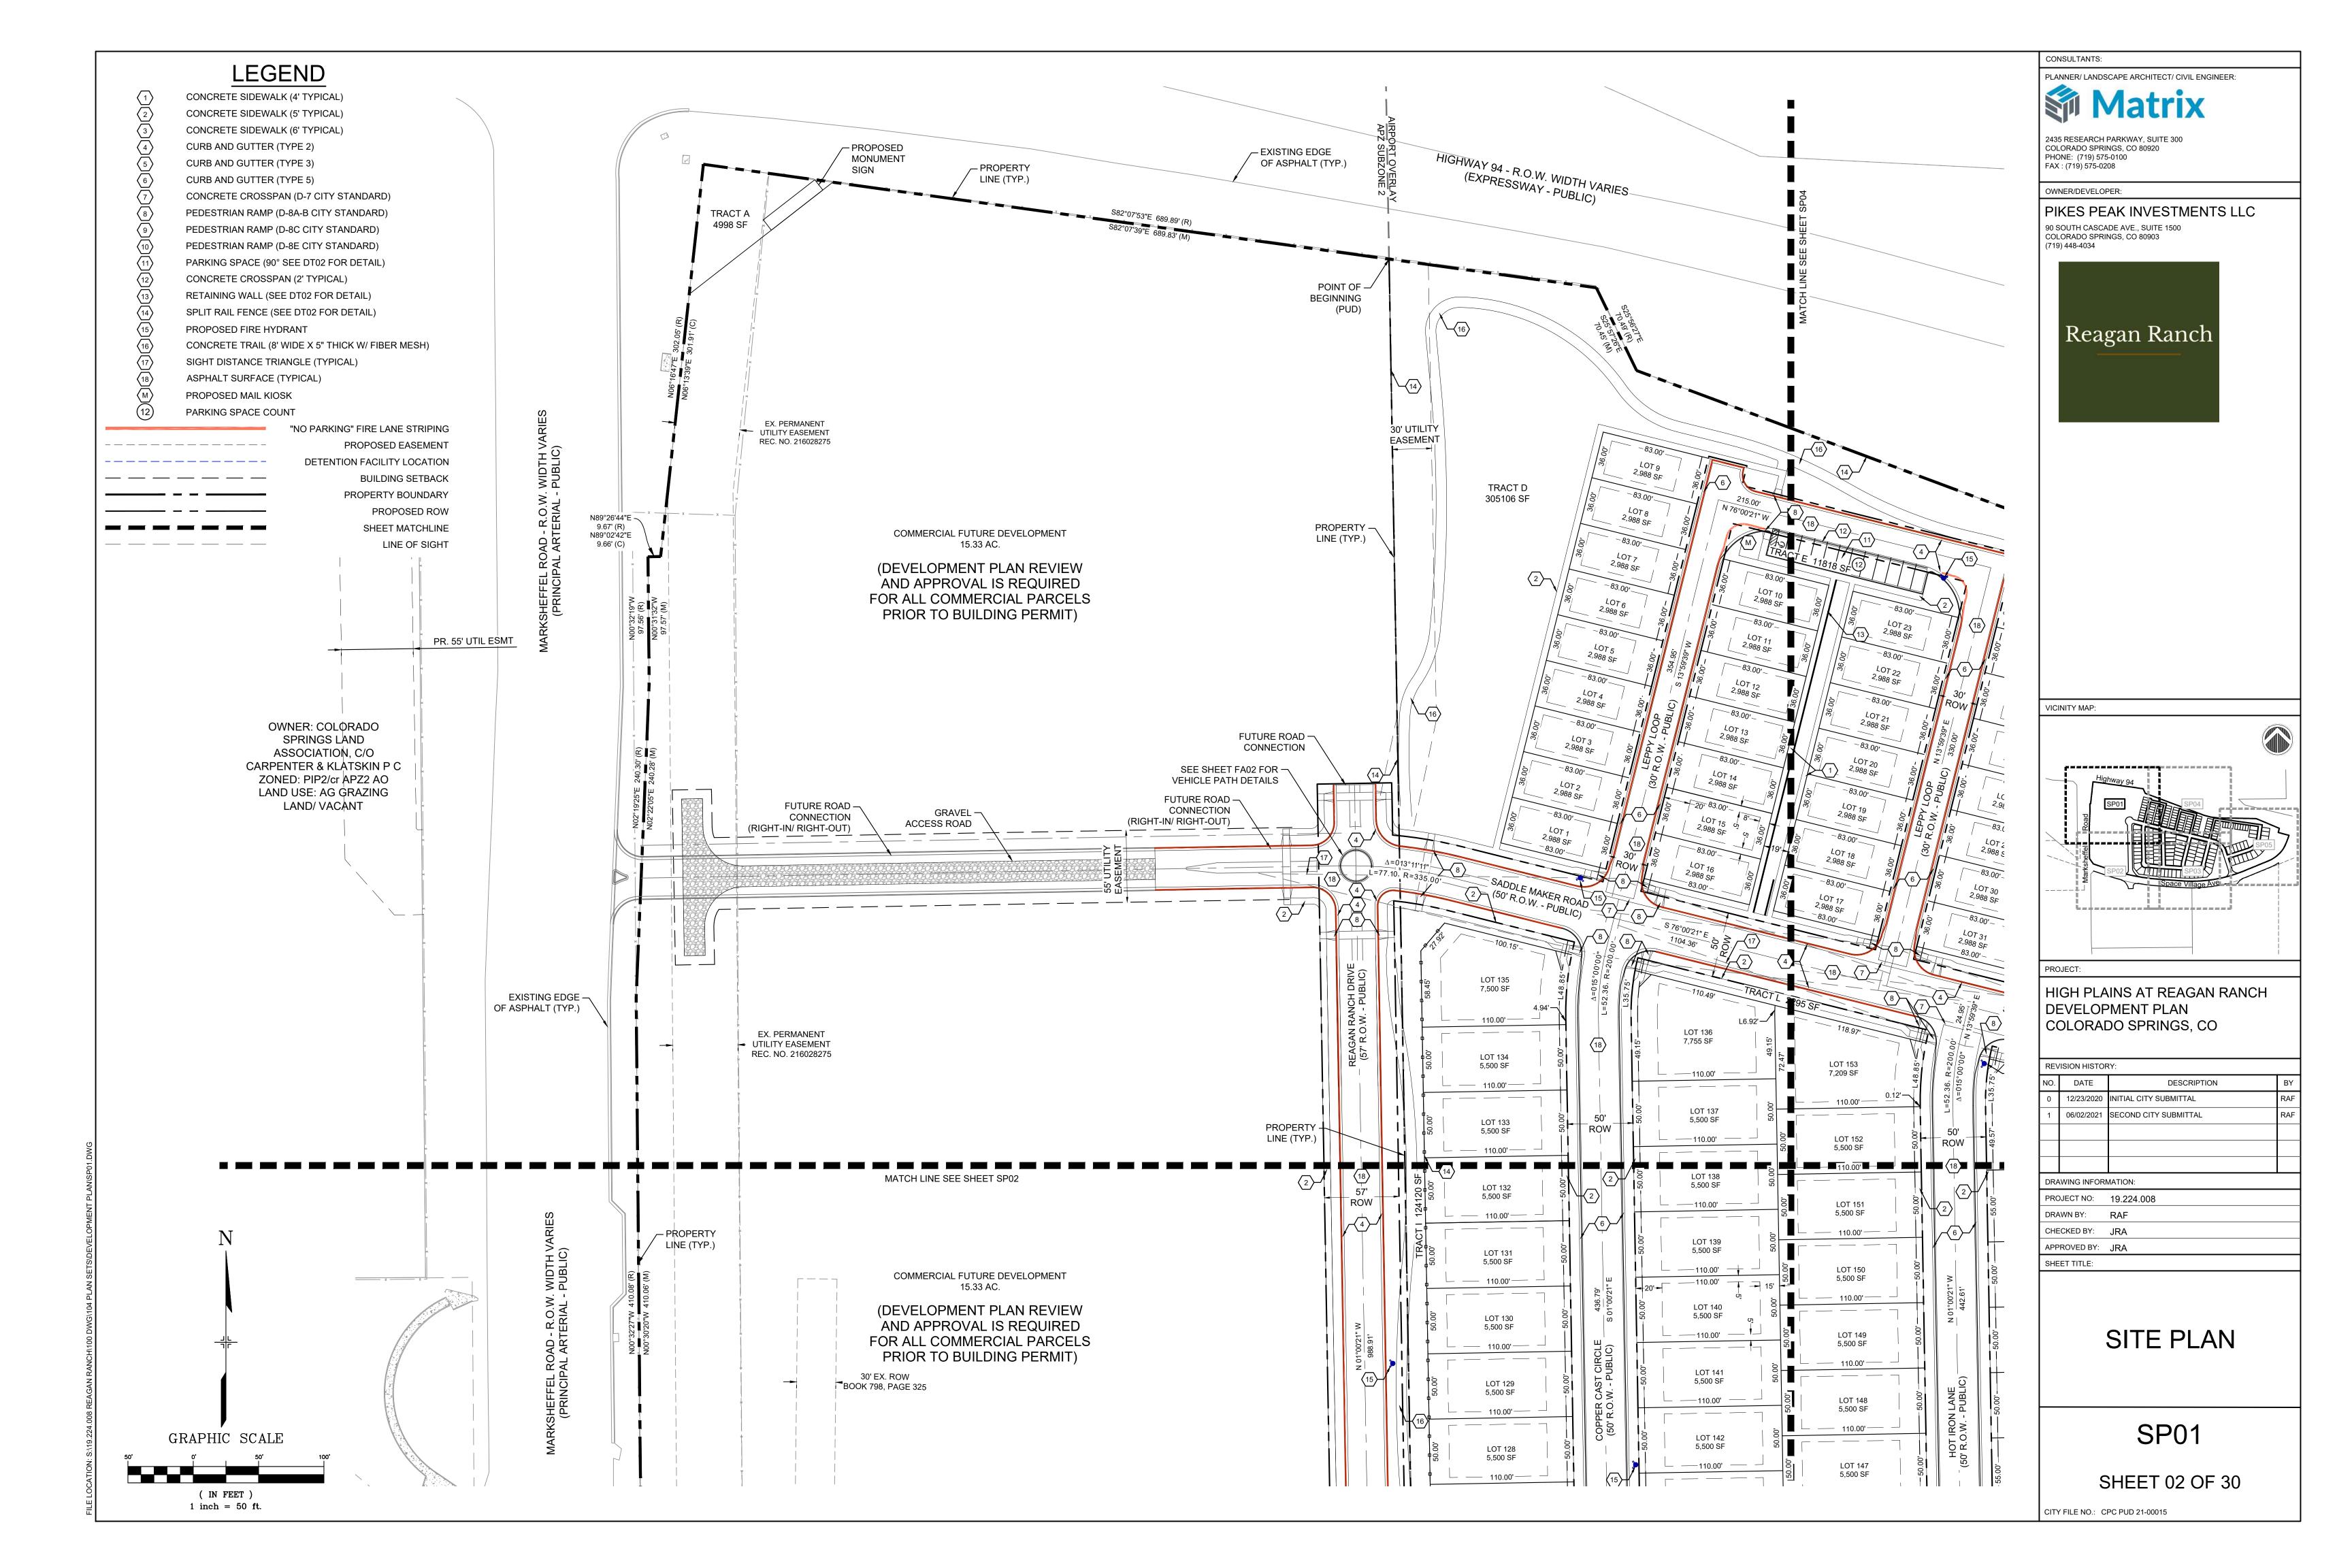


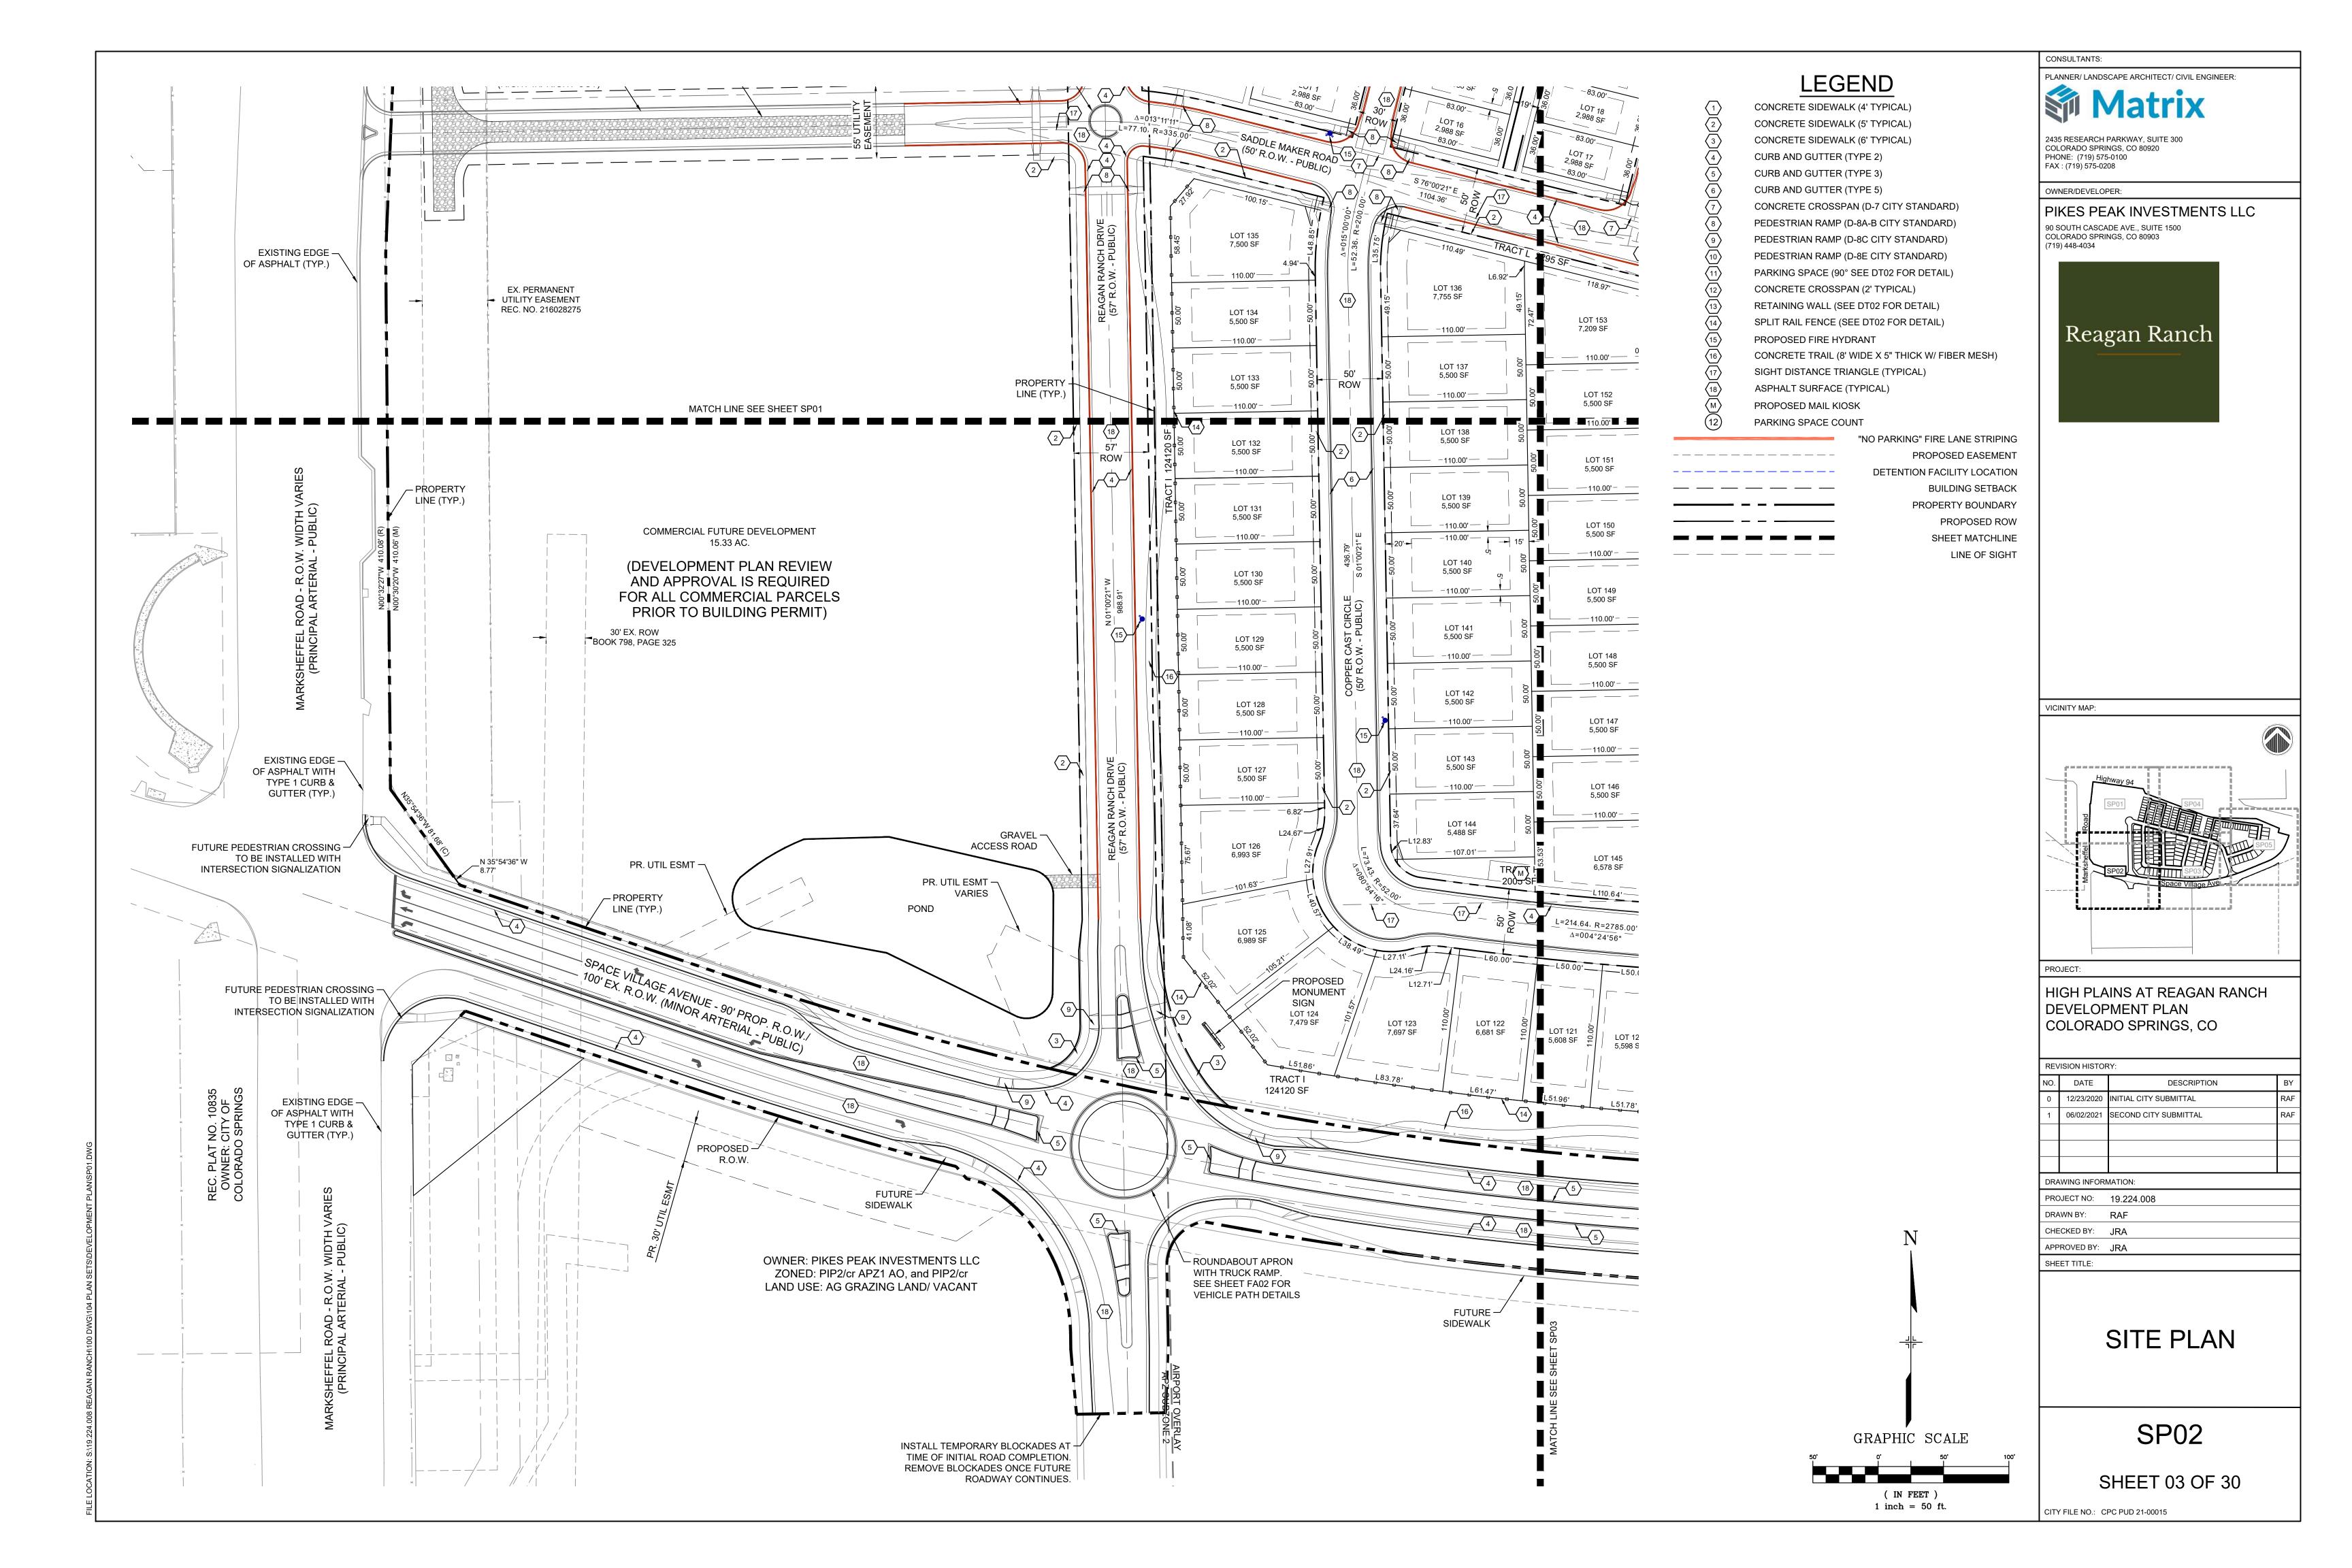

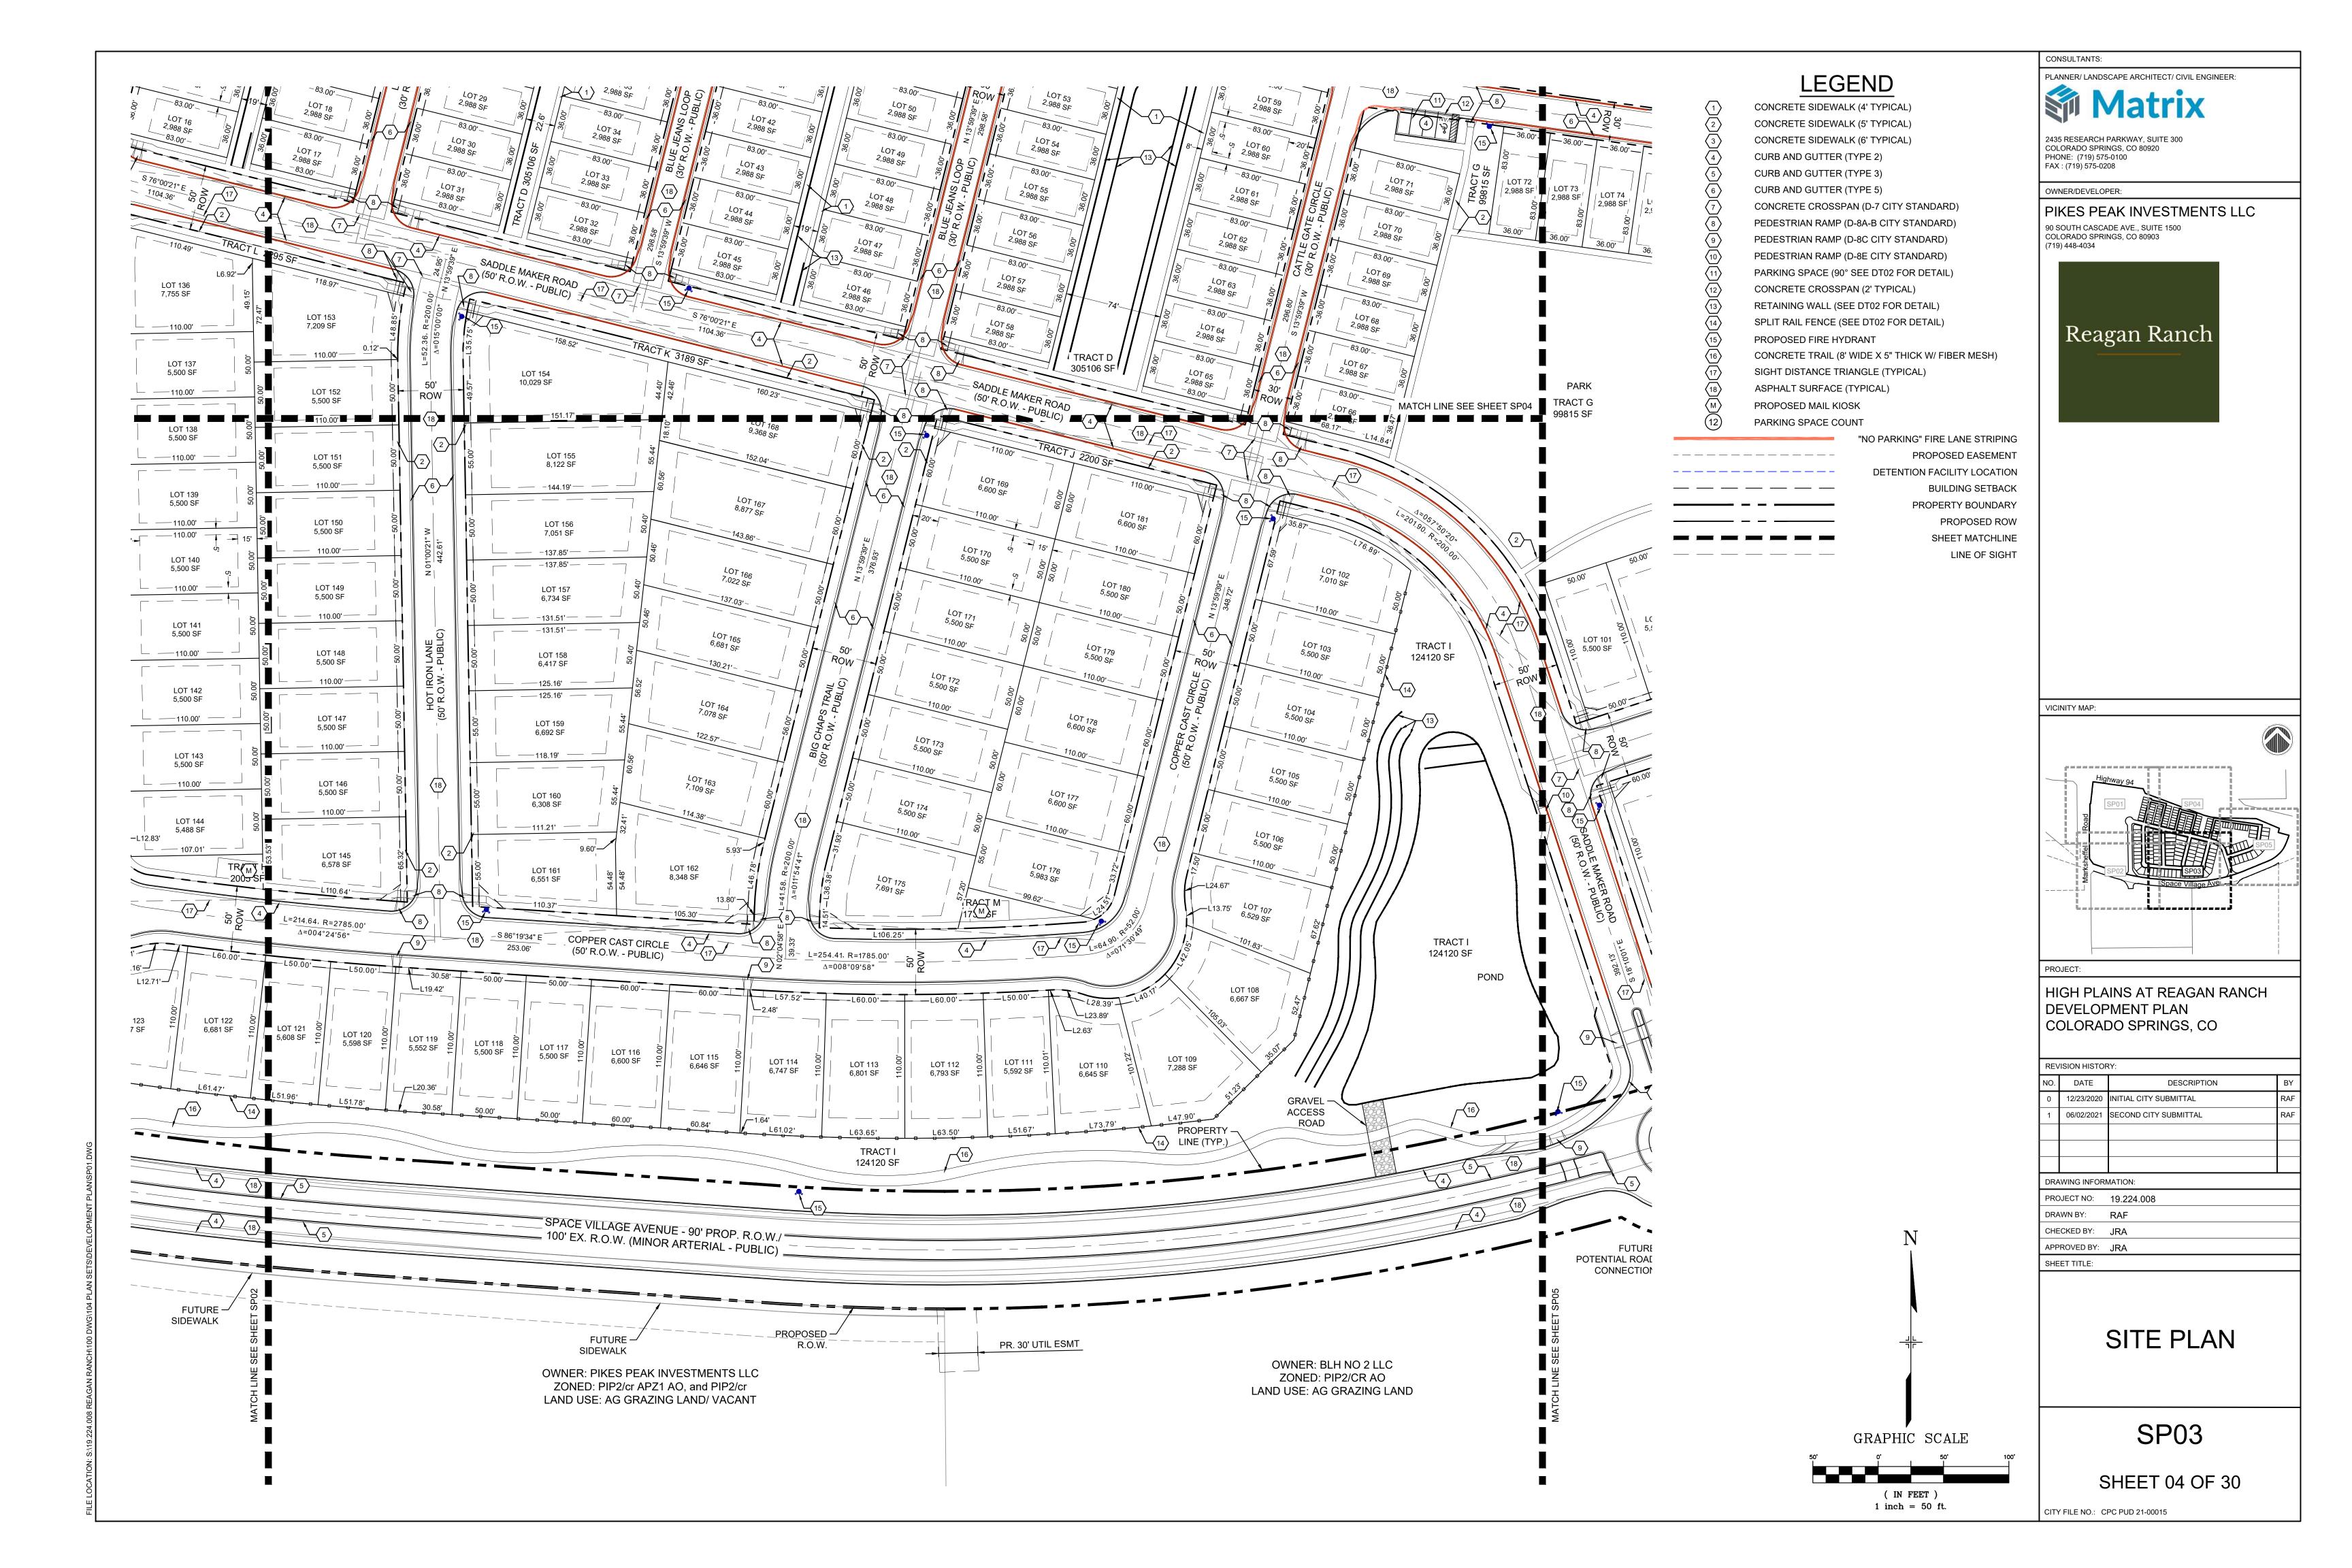

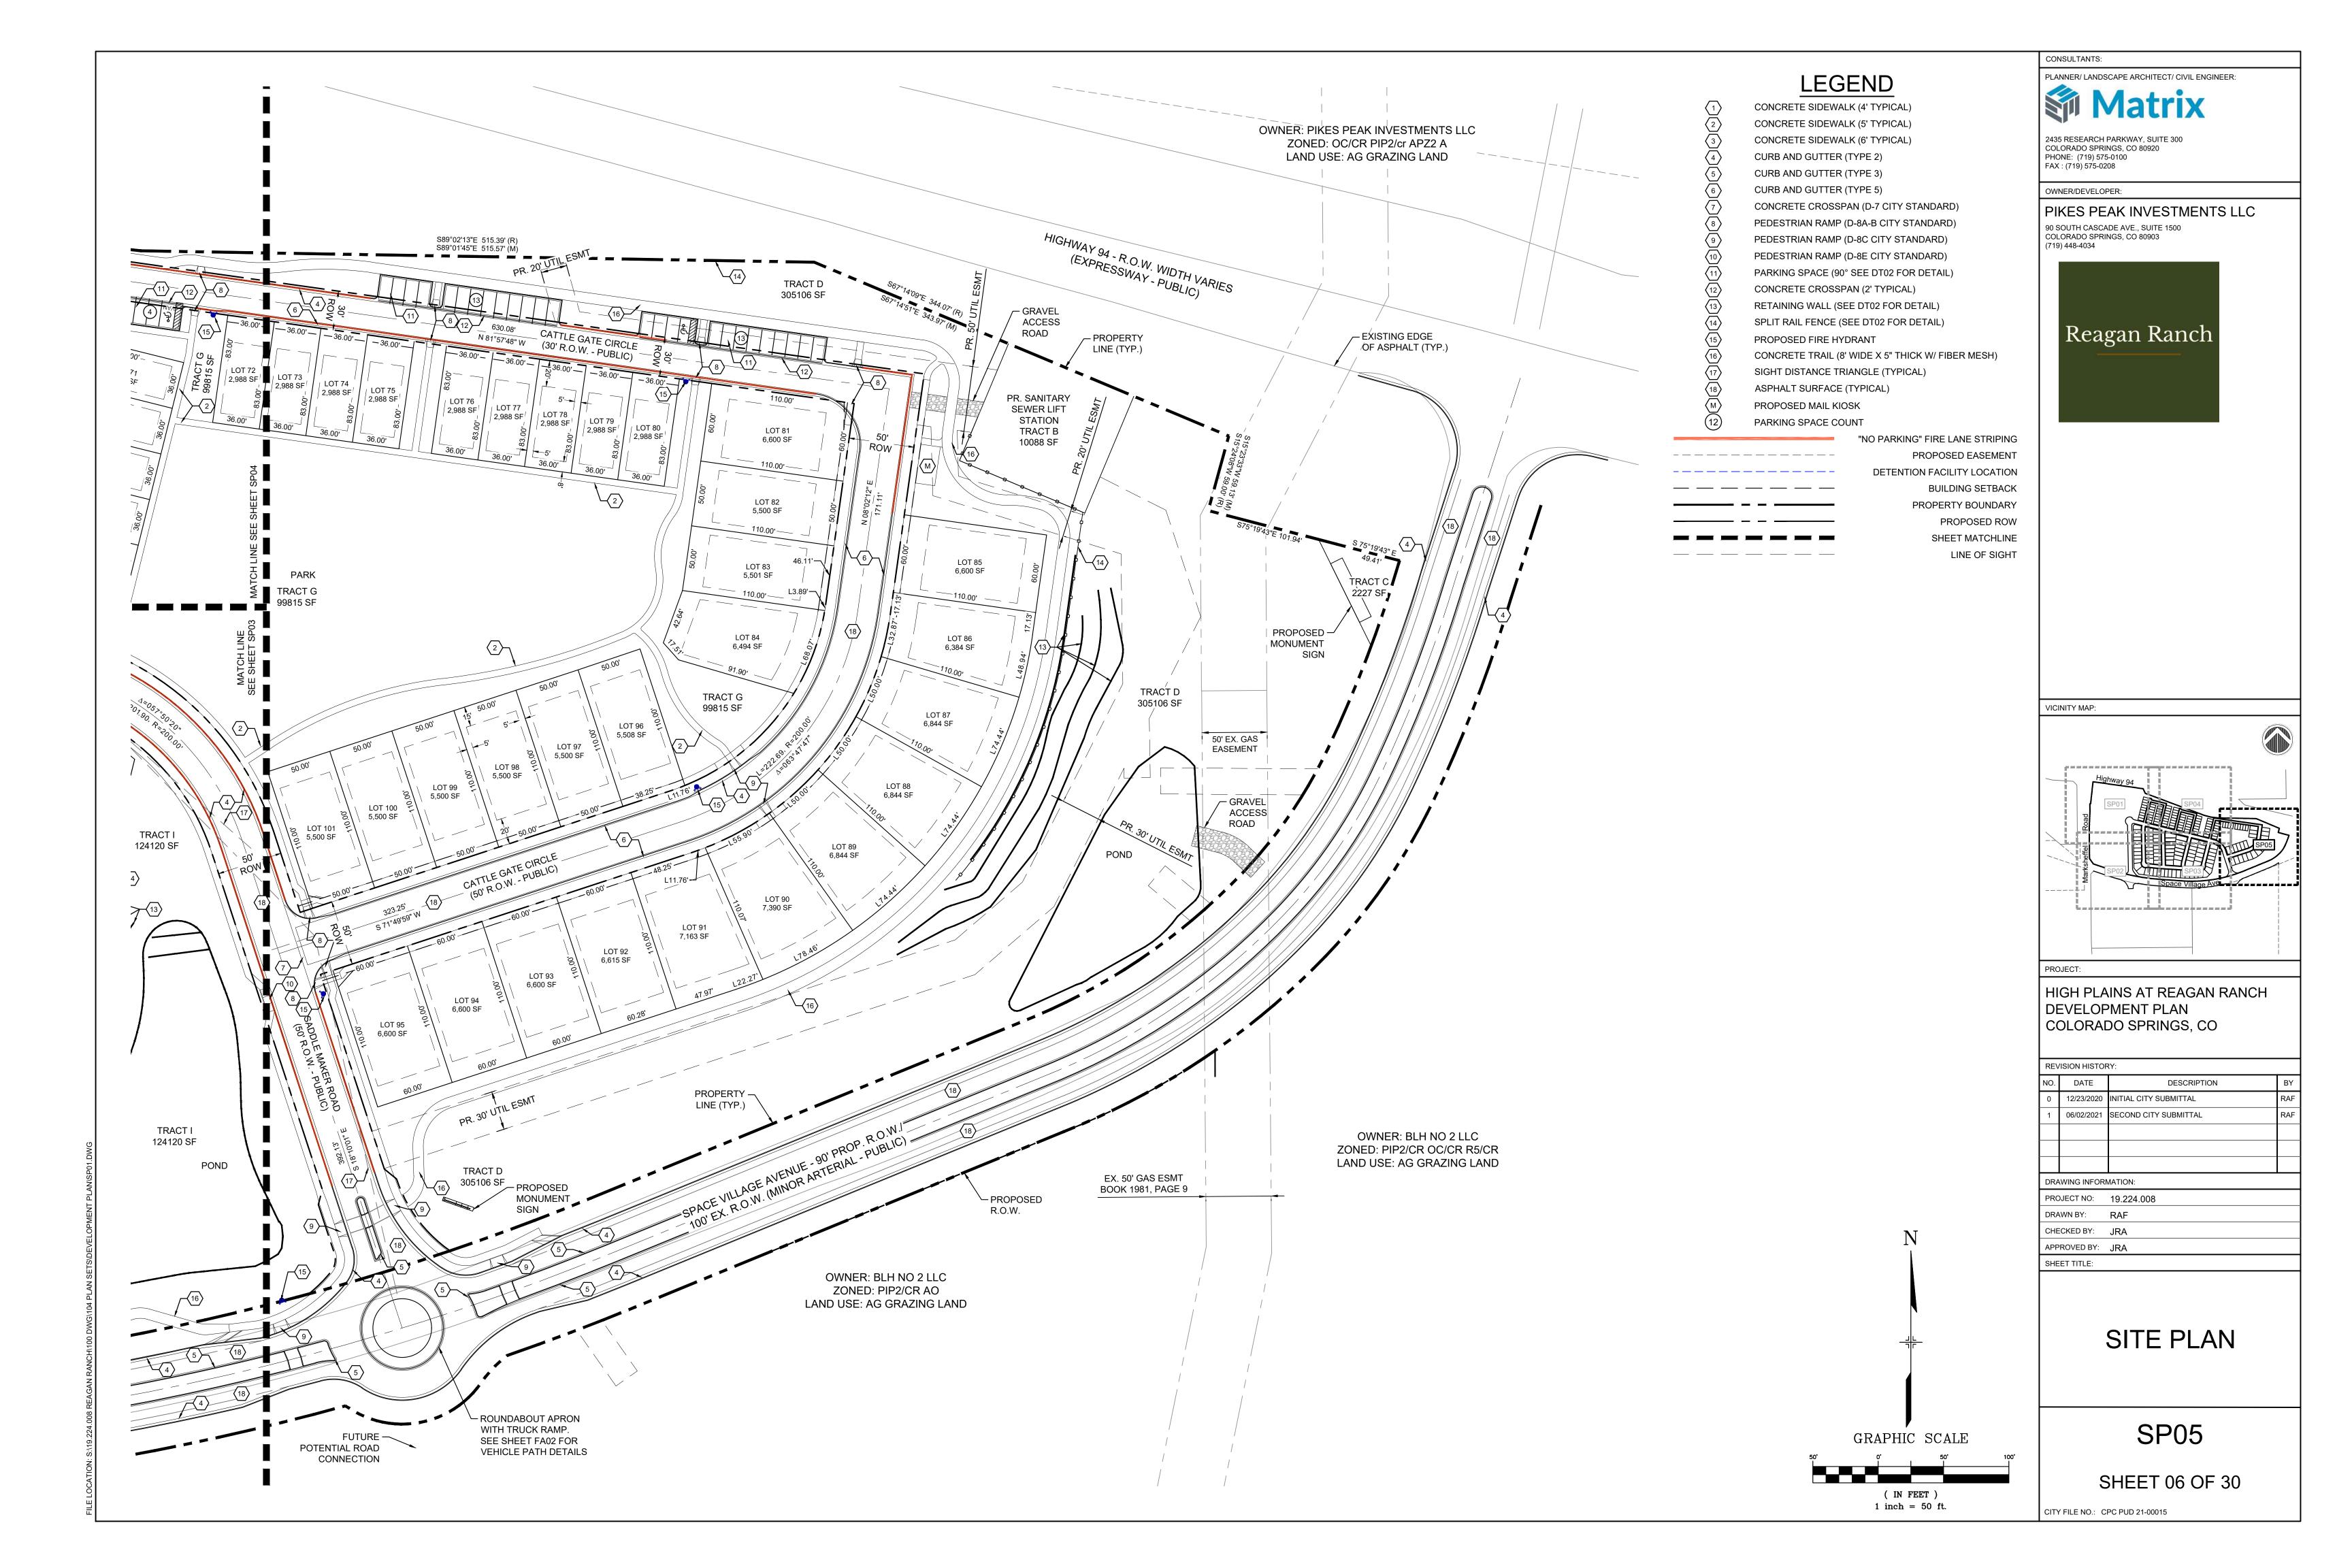

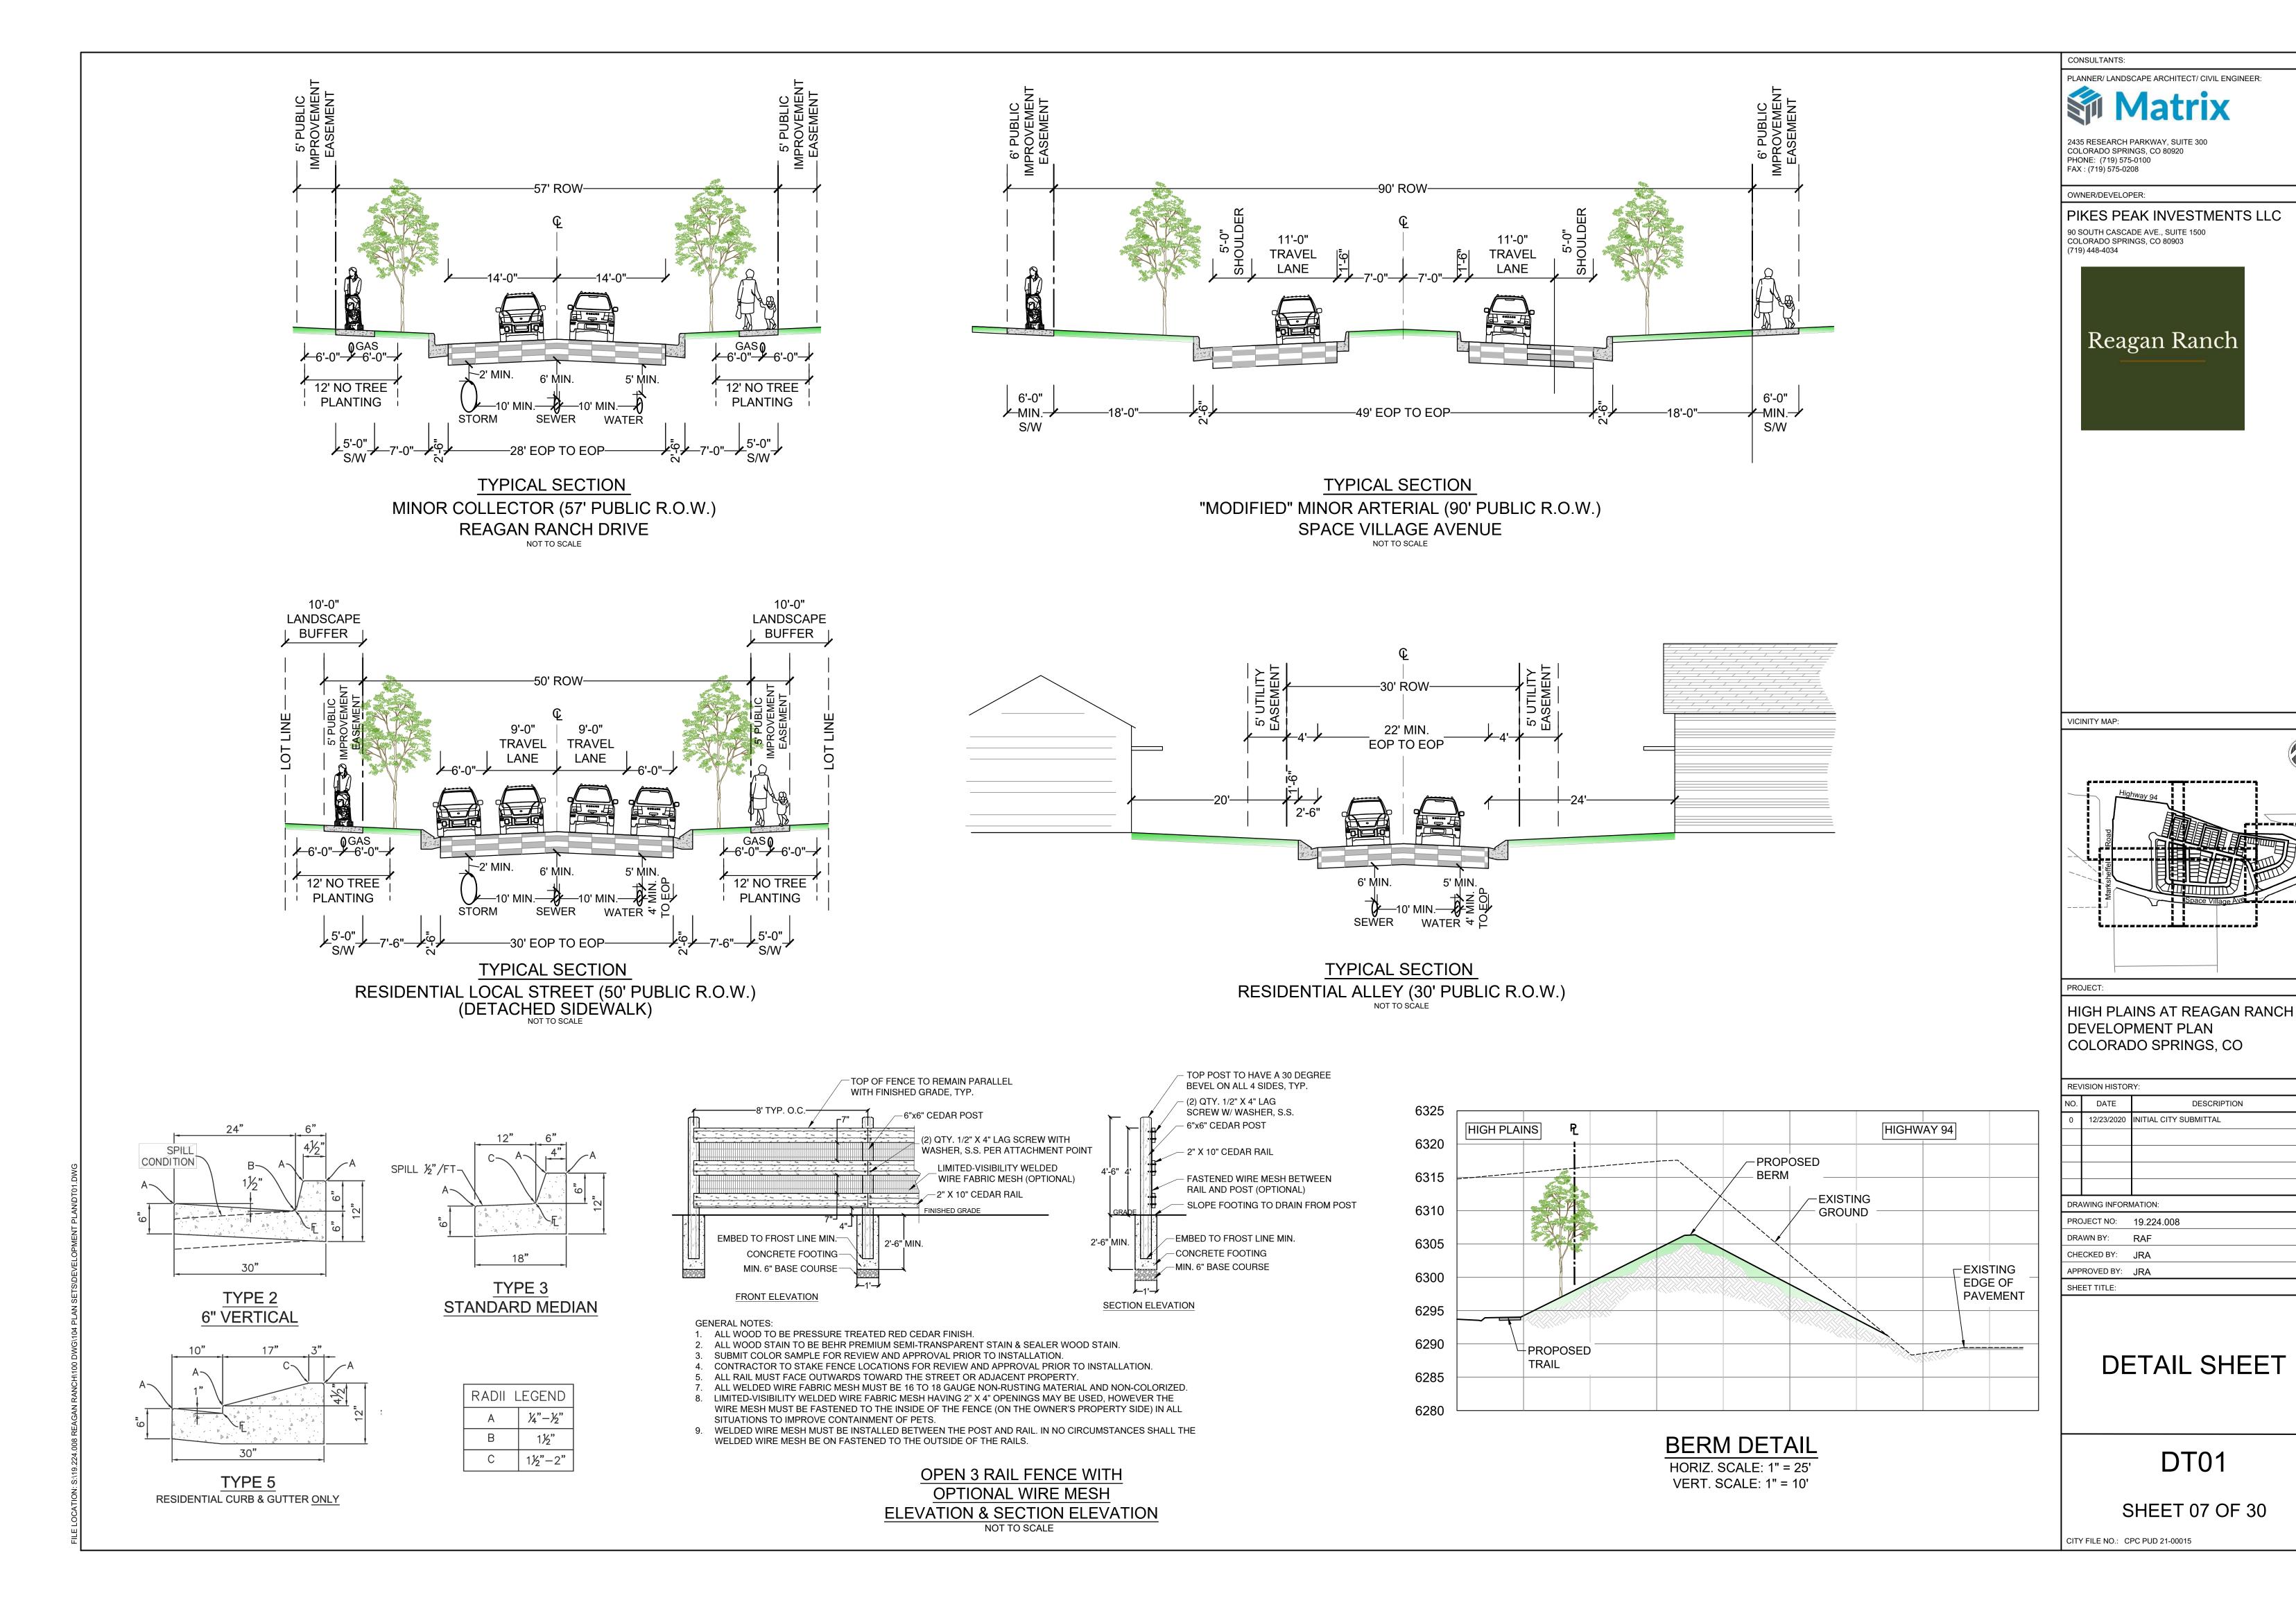

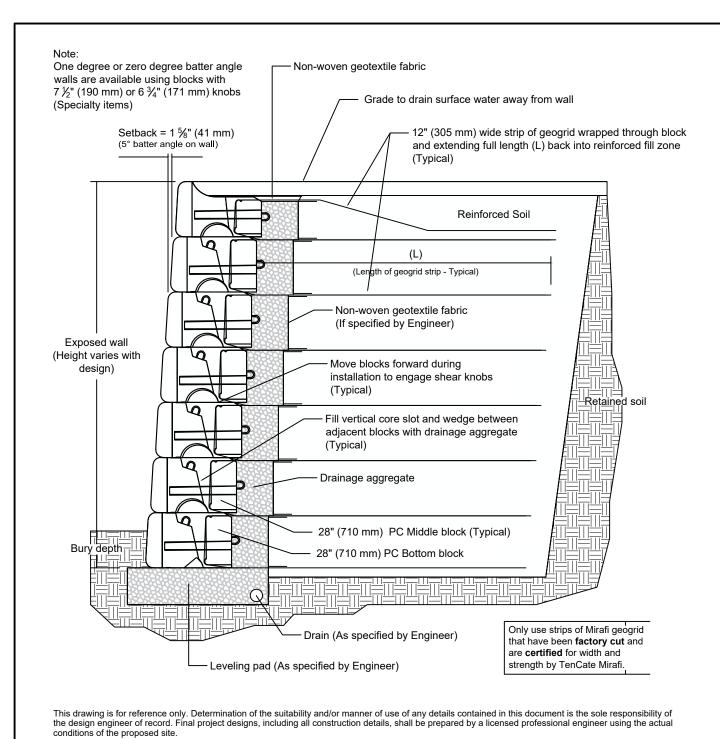



REINFORCED LEDGESTONE

42" Safety Railing along top of retaining walls greater than 3' in height. Distance from top of wall to be detemined by wall manufacturer. Concrete base per Setback = 1 \(\frac{5}{8} \)" (41 mm) (5° batter angle on wall) Grade to drain surface water away from wall Top block -Non-woven geotextile fabric (If specified by Engineer based on site soil conditions) Move blocks forward during installation Exposed wall to engage shear knobs (Typical) (Height varies with Drainstone (AASHTO No. 57 or equivalent) to extend at least 12" (305 mm) behind blocks Fill wedge between adjacent blocks with drainstone (all blocks) Fill vertical core slot with drainstone (PC blocks) Middle block (Typical) Block widths vary with design Solid bottom block Block widths vary with design Drain (As specified by Engineer) Leveling pad (As specified by Engineer)


This drawing is for reference only. Determination of the suitability and/or manner of use of any details contained in this document is the sole responsibility of the design engineer of record. Final project designs, including all construction details, shall be prepared by a licensed professional engineer using the actual conditions of the proposed site.

STANDARD LEDGESTONE WALL SECTION NOT TO SCALE

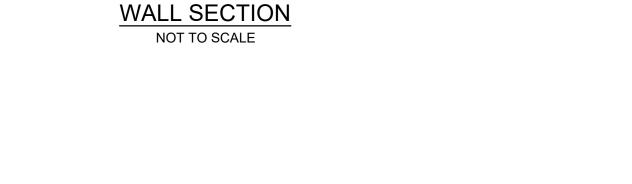


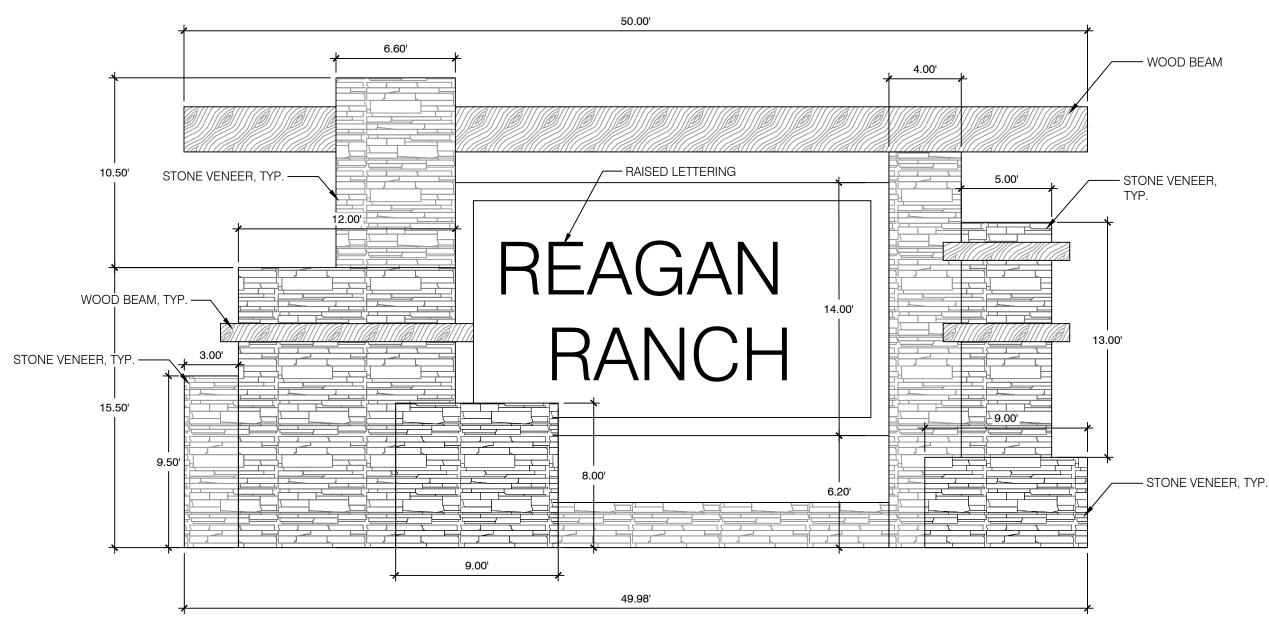

MONUMENT SIGN DETAIL NOT TO SCALE

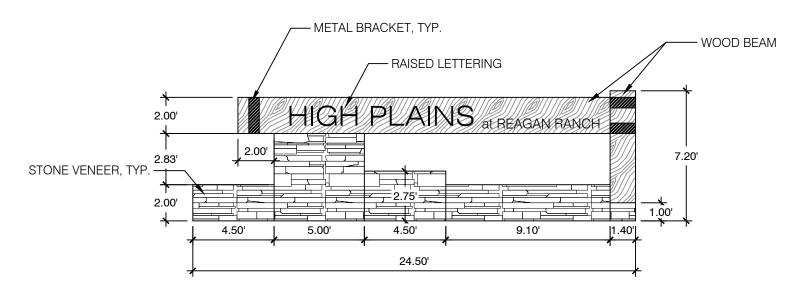

SECONDARY MONUMENT SIGN DETAIL NOT TO SCALE

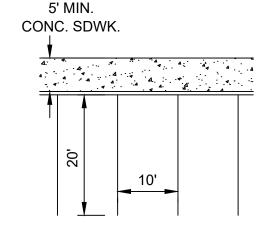

STANDARD 90° PARKING SPACE DETAIL NOT TO SCALE



VAN ACCESSIBLE

R7-8P

GREEN COURT LOT DESIGN GUIDELINES:


8' BUILDING 5' BUILDING

GARAGE: 20' FROM PROPERTY LINE REAR STRUCTURE OVERHANG: 15' FROM PROPERTY LINE


- DRIVEWAY COVERAGE: 75% OF THE REAR SETBACK AS MEASURED PER CITY CODE. ACCESSORY STRUCTURES GOVERNED BY CITY OF COLORADO SPRINGS ZONING CODE.
- WINDOW WELLS ARE PERMITTED PER THE NOTES BELOW. LOCATION OF PRIVATE SIDEWALKS TO FRONT ENTRY TO BE DETERMINED BY INDIVIDUAL
- HOUSE INGRESS/ EGRESS CONFIGURATION. OWNER/ BUILDER TO ENSURE DRIVEWAYS DO NOT CONFLICT WITH PEDESTRIAN RAMP

ARCHITECTURAL FEATURES: CORNICE, EAVES, BELT COURSE, SILL, CANOPY,

- CHIMNEYS AND OTHER SIMILAR ARCHITECTURAL FEATURES MAY EXTEND INTO A REQUIRED FRONT OR REAR BUILDING SETBACK FOUR INCHES (4") FOR EACH FOOT OF WIDTH. THESE ENCROACHMENTS MAY NOT EXTEND OR PROJECT INTO THE REQUIRED SIDE SETBACK MORE THAN A TOTAL OF THIRTY SIX INCHES (36").
- COVERED AND UNCOVERED PATIOS 18 INCHES (18") OR LESS ABOVE GROUND LEVEL ARE PERMITTED TO ENCROACH UP TO 5' INTO A REQUIRED FRONT, SIDE OR REAR BUILDING SETBACK.
- COVERED AND UNCOVERED PATIOS 18 INCHES (18") AND HIGHER ARE PERMITTED TO ENCROACH UP TO 36" INTO A REQUIRED FRONT, SIDE OR REAR
- 4. WINDOW WELLS ARE PERMITTED TO ENCROACH UP TO THIRTY SIX INCHES (36") INTO A REQUIRED SIDE YARD SETBACK. WINDOW WELLS SHALL NOT BE FLUSH TO GROUND AND SHALL SHALL BE HIGHER THAN THE ANTICIPATED DEPTH OF DRAINAGE IN THE SIDE YARD SWALES.
- BAY WINDOWS, BUILDING CANTILEVERS, AND VERTICAL PROJECTIONS UP TO 36' ARE PERMITTED INTO A REQUIRED FRONT, SIDE OR REAR BUILDING SETBACK.

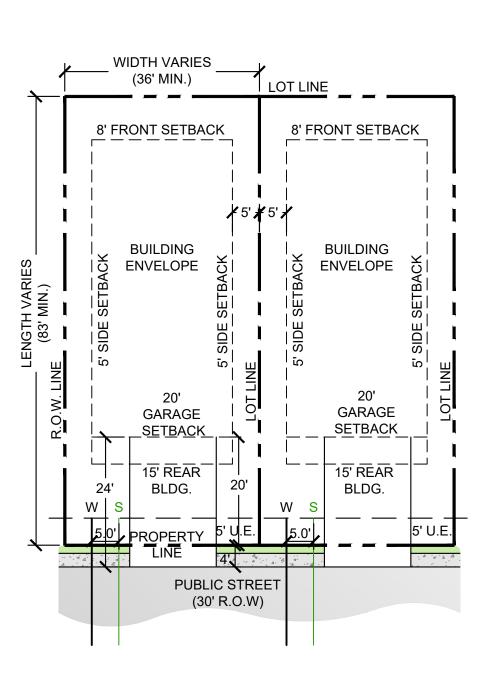

GREENWAY ORIENTED UNITS TYPICAL LOTS 1-80

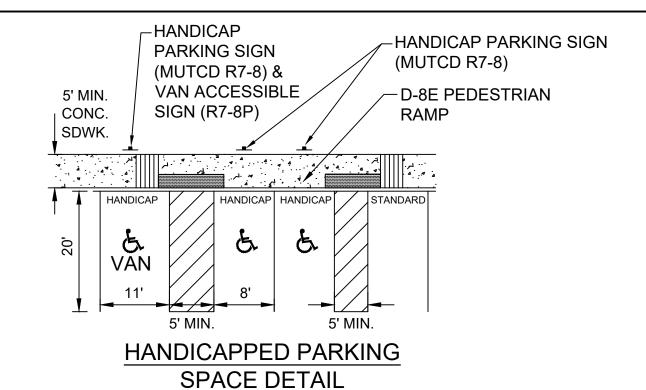

1. EACH ACCESSIBLE PARKING SPACE SHALL BE DESIGNATED AS RESERVED BY A SIGN

NOT TO SCALE

- SHOWING THE INTERNATIONAL SYMBOL OF ACCESSIBILITY. 2. VAN ACCESSIBLE SPACES SHALL HAVE AN ADDITIONAL SIGN CONTAINING THE
- DESIGNATION, "VAN ACCESSIBLE", MOUNTED BELOW THE SYMBOL OF ACCESSIBILITY. 3. EACH ACCESSIBLE PARKING SPACE SIGN SHALL BE NO SMALLER THAN EIGHTEEN
- INCHES (18") TALL BY TWELVE INCHES (12") WIDE. 4. EACH VAN ACCESSIBLE SIGN SHALL BE NO SMALLER THAN SIX INCHES (6") TALL BY
- TWELVE INCHES (12") WIDE. 5. SIGNS SHALL BE LOCATED AT THE HEAD OF THE SPACE WITH THE BOTTOM OF THE SIGN(S) BETWEEN FIVE FEET (5') AND SEVEN FEET (7') ABOVE THE FINISH FLOOR OR
- **GROUND SURFACE** 6. ACCESS AISLES SHOULD POST "WHEELCHAIR ACCESS AISLE ABSOLUTELY NO PARKING" SIGNS WHICH BLOCK NEITHER THE ACCESS AISLE NOR ANY RELATED ACCESSIBLE ROUTE.
- 7. THE SIGNS MAY EITHER BE WALL MOUNTED OR FREESTANDING.

HANDICAPPED PARKING SIGN DETAIL NOT TO SCALE

STREET ORIENTED LOT SETBACKS:

20' FACE OF BUILDING (FROM PROPERTY LINE) 20' FACE OF GARAGE (FROM BACK OF SIDEWALK)


SIDE: 5' BUILDING REAR: 15' BUILDING

CORNER: 10' BUILDING

- DRIVEWAY COVERAGE: 45% OF THE REAR SETBACK AS MEASURED PER CITY CODE.
- ACCESSORY STRUCTURES GOVERNED BY CITY OF COLORADO SPRINGS ZONING CODE.
- WINDOW WELLS ARE PERMITTED PER THE NOTES BELOW. • LOCATION OF PRIVATE SIDEWALKS TO FRONT ENTRY TO BE DETERMINED BY INDIVIDUAL HOUSE INGRESS/ EGRESS
- OWNER/ BUILDER TO ENSURE DRIVEWAYS DO NOT CONFLICT WITH PEDESTRIAN RAMP TRANSITIONS

STREET ORIENTED SETBACK ENCROACHMENT NOTES:

- ARCHITECTURAL FEATURES: CORNICE, EAVES, BELT COURSE, SILL, CANOPY, CHIMNEYS AND OTHER SIMILAR ARCHITECTURAL FEATURES MAY EXTEND INTO A REQUIRED FRONT OR REAR BUILDING SETBACK FOUR INCHES (4") FOR EACH FOOT OF WIDTH. THESE ENCROACHMENTS MAY NOT EXTEND OR PROJECT INTO THE REQUIRED SIDE SETBACK MORE THAN A TOTAL OF THIRTY SIX INCHES (36")
- COVERED AND UNCOVERED PATIOS 18 INCHES (18") OR LESS ABOVE GROUND LEVEL ARE PERMITTED TO ENCROACH UP TO 5'
- INTO A REQUIRED FRONT, SIDE OR REAR BUILDING SETBACK. COVERED AND UNCOVERED PATIOS 18 INCHES (18") AND HIGHER ARE PERMITTED TO ENCROACH UP TO 36" INTO A REQUIRED FRONT. SIDE OR REAR BUILDING SETBACK.
- 4. WINDOW WELLS ARE PERMITTED TO ENCROACH UP TO THIRTY SIX INCHES (36") INTO A REQUIRED SIDE YARD SETBACK. WINDOW WELLS SHALL NOT BE FLUSH TO GROUND AND SHALL SHALL BE HIGHER THAN THE ANTICIPATED DEPTH OF DRAINAGE
- 5. BAY WINDOWS, BUILDING CANTILEVERS, AND VERTICAL PROJECTIONS UP TO 36" ARE PERMITTED INTO A REQUIRED FRONT

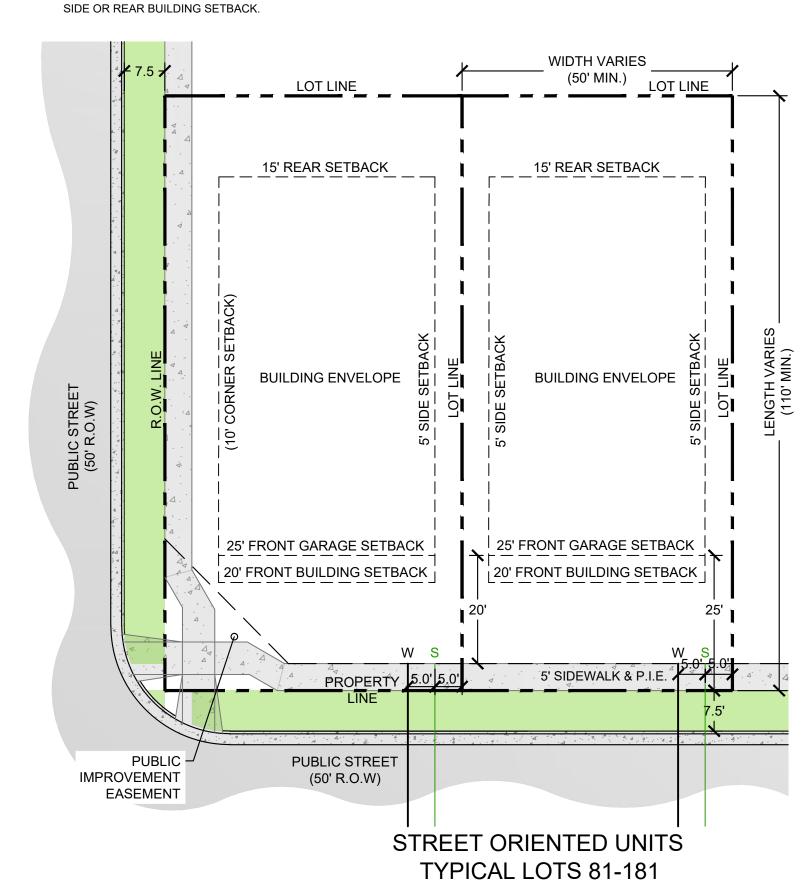

CONSULTANTS: PLANNER/ LANDSCAPE ARCHITECT/ CIVIL ENGINEER: 2435 RESEARCH PARKWAY, SUITE 300 COLORADO SPRINGS, CO 80920 PHONE: (719) 575-0100 FAX: (719) 575-0208 OWNER/DEVELOPER:

PIKES PEAK INVESTMENTS LLC

90 SOUTH CASCADE AVE., SUITE 1500

COLORADO SPRINGS, CO 80903

Reagan Ranch

p-------

VICINITY MAP:


PROJECT: HIGH PLAINS AT REAGAN RANCH **DEVELOPMENT PLAN** COLORADO SPRINGS, CO


REVISION HISTORY: DESCRIPTION 12/23/2020 INITIAL CITY SUBMITTAL RAWING INFORMATION: PROJECT NO: 19.224.008 DRAWN BY: CHECKED BY: JRA APPROVED BY: JRA SHEET TITLE:

DETAIL SHEET


DT02


SHEET 08 OF 30

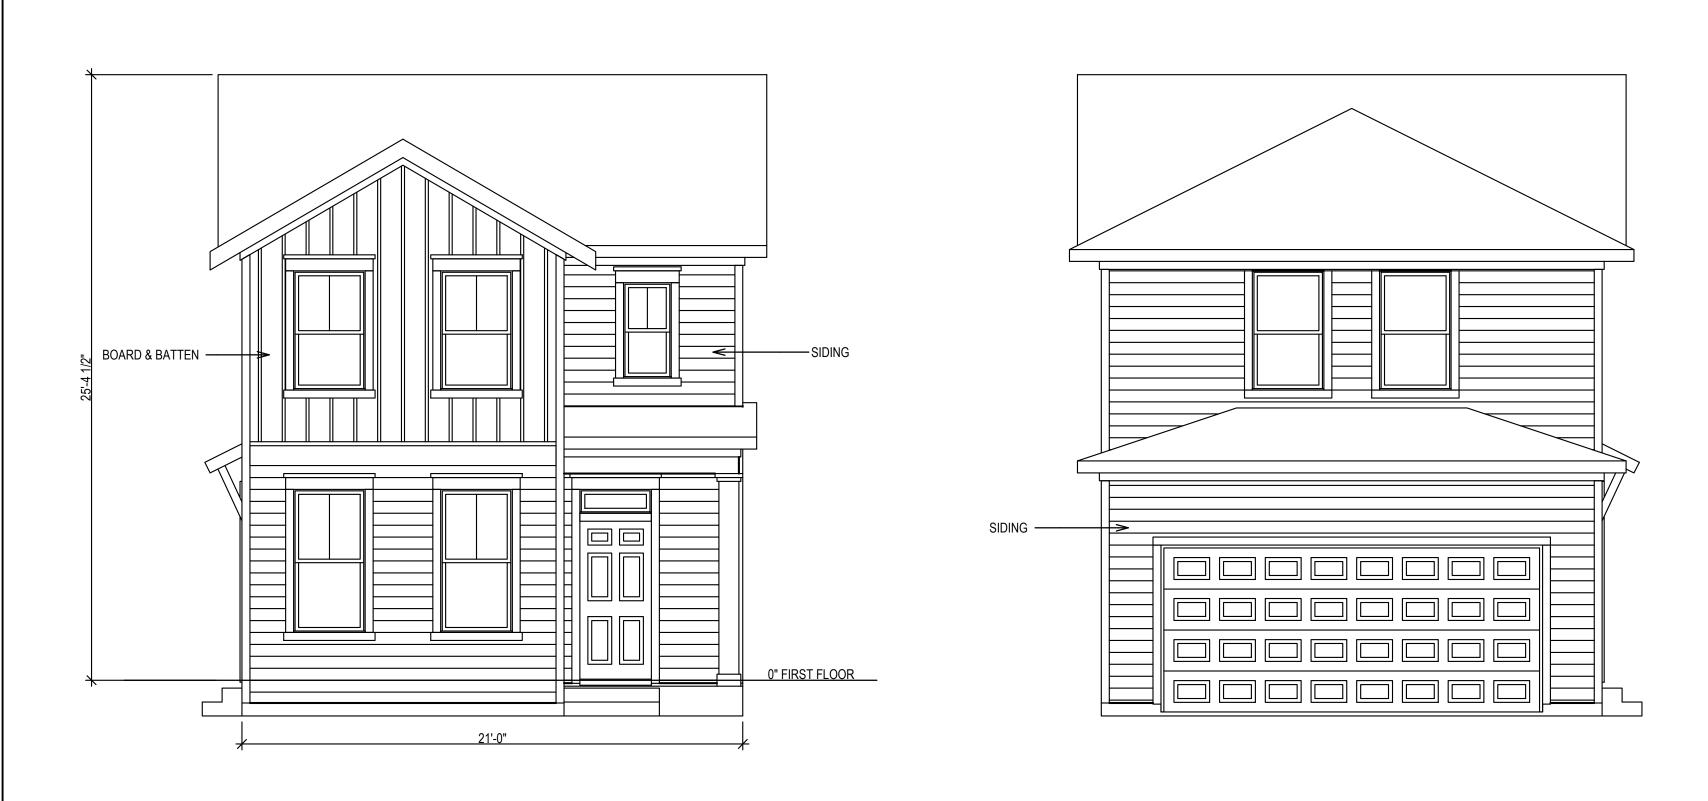

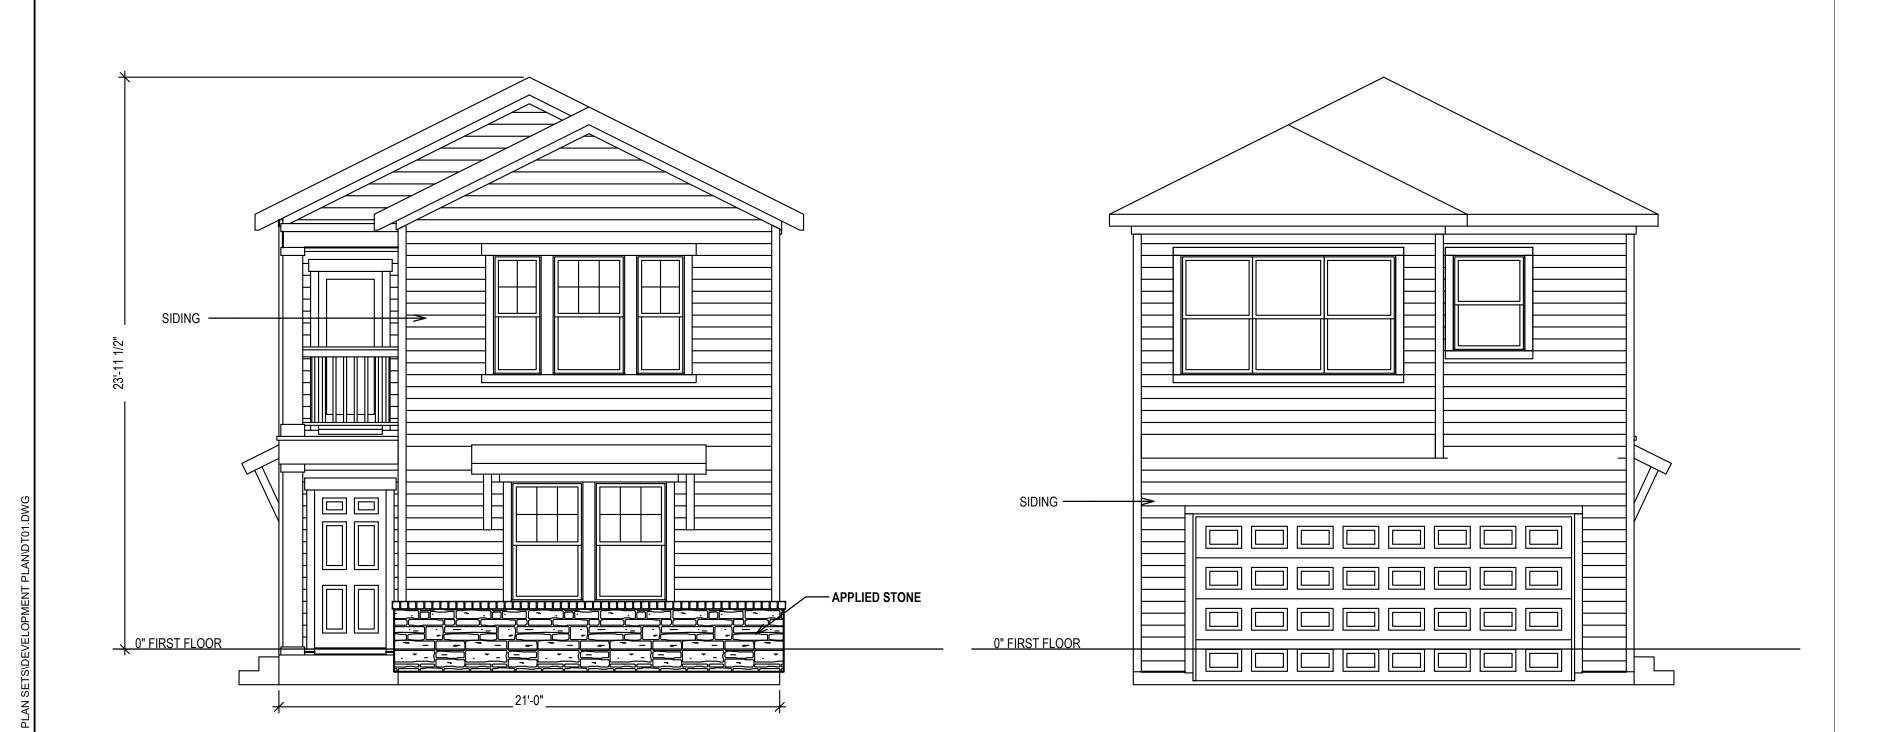

BUILDING ELEVATIONS NOT TO SCALE

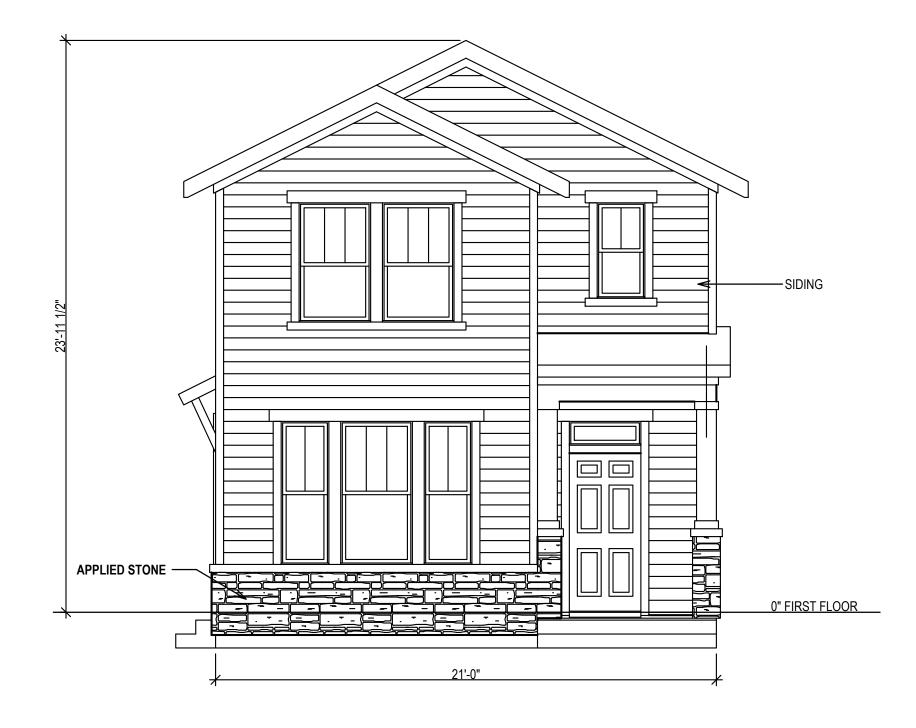

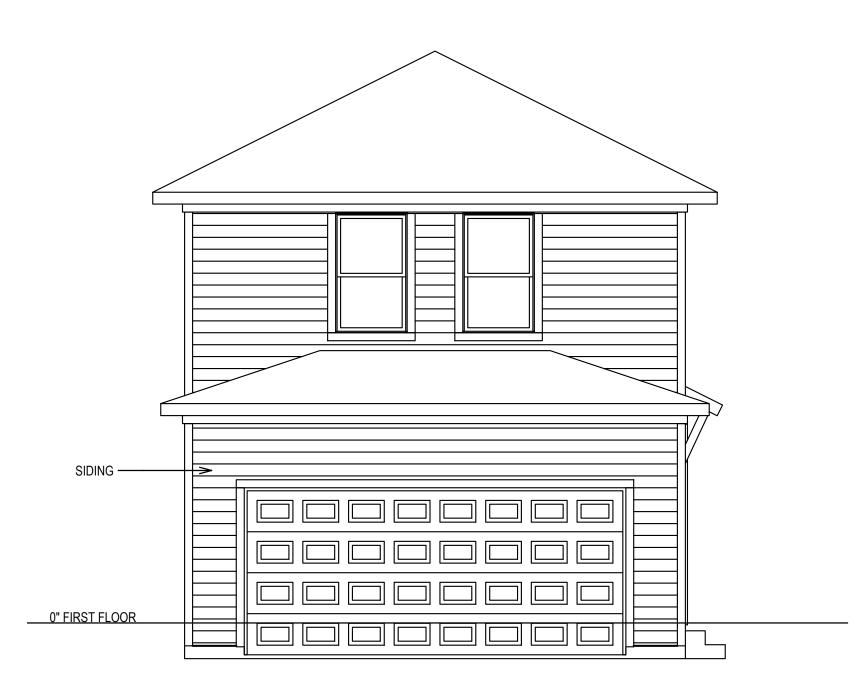

GENERAL ARCHITECTURAL ELEVATION NOTES:

- ELEVATIONS AS SHOWN ARE CONCEPTUAL IN NATURE ONLY AND SUBJECT TO CHANGE PENDING FINAL DESIGN AT TIME OF BUILDING PERMIT. ELEVATIONS PROVIDED TO ILLUSTRATE GENERAL EXTERIOR MATERIALS AS WELL AS BUILDING WIDTH, DEPTH AND HEIGHT.
- 2. BUILDER RESERVES THE RIGHT TO MODIFY THE ELEVATIONS AT TIME OF BUILDING PERMIT WITH RESPECT TO COLORS, MATERIALS, AND ARCHITECTURAL FEATURES WITHOUT THE NEED TO RESUBMIT A DEVELOPMENT PLAN AMENDMENT SO THE LONG THE BUILDING DIMENSIONS ARE WITHIN 20% OF THIS DEVELOPMENT PLAN.
- 3. ARCHITECTURAL FEATURES: CORNICE, EAVES, BELT COURSE, SILL, CANOPY, CHIMNEYS AND OTHER SIMILAR ARCHITECTURAL FEATURES MAY EXTEND INTO A REQUIRED FRONT OR REAR BUILDING SETBACK FOUR INCHES (4") FOR EACH FOOT OF WIDTH. THESE ENCROACHMENTS MAY NOT EXTEND OR PROJECT INTO THE REQUIRED SIDE SETBACK MORE THAN A TOTAL OF THIRTY SIX INCHES (36")
- 4. COVERED AND UNCOVERED PATIOS 18 INCHES (18") OR LESS ABOVE GROUND LEVEL ARE PERMITTED TO ENCROACH UP TO 5' INTO A REQUIRED FRONT, SIDE OR REAR BUILDING SETBACK.
- 5. COVERED AND UNCOVERED PATIOS 18 INCHES (18") AND HIGHER ARE PERMITTED TO ENCROACH UP TO 36" INTO A REQUIRED FRONT, SIDE OR REAR BUILDING SETBACK.
- 6. WINDOW WELLS ARE PERMITTED TO ENCROACH UP TO THIRTY SIX INCHES (36") INTO A REQUIRED SIDE YARD SETBACK. WINDOW WELLS SHALL NOT BE FLUSH TO GROUND AND SHALL SHALL BE HIGHER THAN THE ANTICIPATED DEPTH OF DRAINAGE IN THE SIDE YARD SWALES.
- 7. BAY WINDOWS, BUILDING CANTILEVERS, AND VERTICAL PROJECTIONS UP TO 36" ARE PERMITTED INTO A REQUIRED FRONT, SIDE OR REAR BUILDING SETBACK.

CONSULTANTS:

PLANNER/ LANDSCAPE ARCHITECT/ CIVIL ENGINEER:


2435 RESEARCH PARKWAY, SUITE 300 COLORADO SPRINGS, CO 80920 PHONE: (719) 575-0100 FAX: (719) 575-0208

OWNER/DEVELOPER:

PIKES PEAK INVESTMENTS LLC

90 SOUTH CASCADE AVE., SUITE 1500 COLORADO SPRINGS, CO 80903 (719) 448-4034



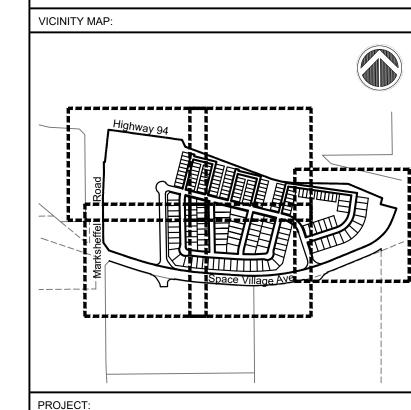


HIGH PLAINS AT REAGAN RANCH DEVELOPMENT PLAN COLORADO SPRINGS, CO


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DRA	WING INFORM	MATION:			
PRO	DJECT NO:	19.224.008			
DRA	AWN BY:	RAF			
CHE	ECKED BY:	JRA			
APP	ROVED BY:	JRA			
SHE	ET TITLE:				


DETAIL SHEET

DT03


SHEET 09 OF 30

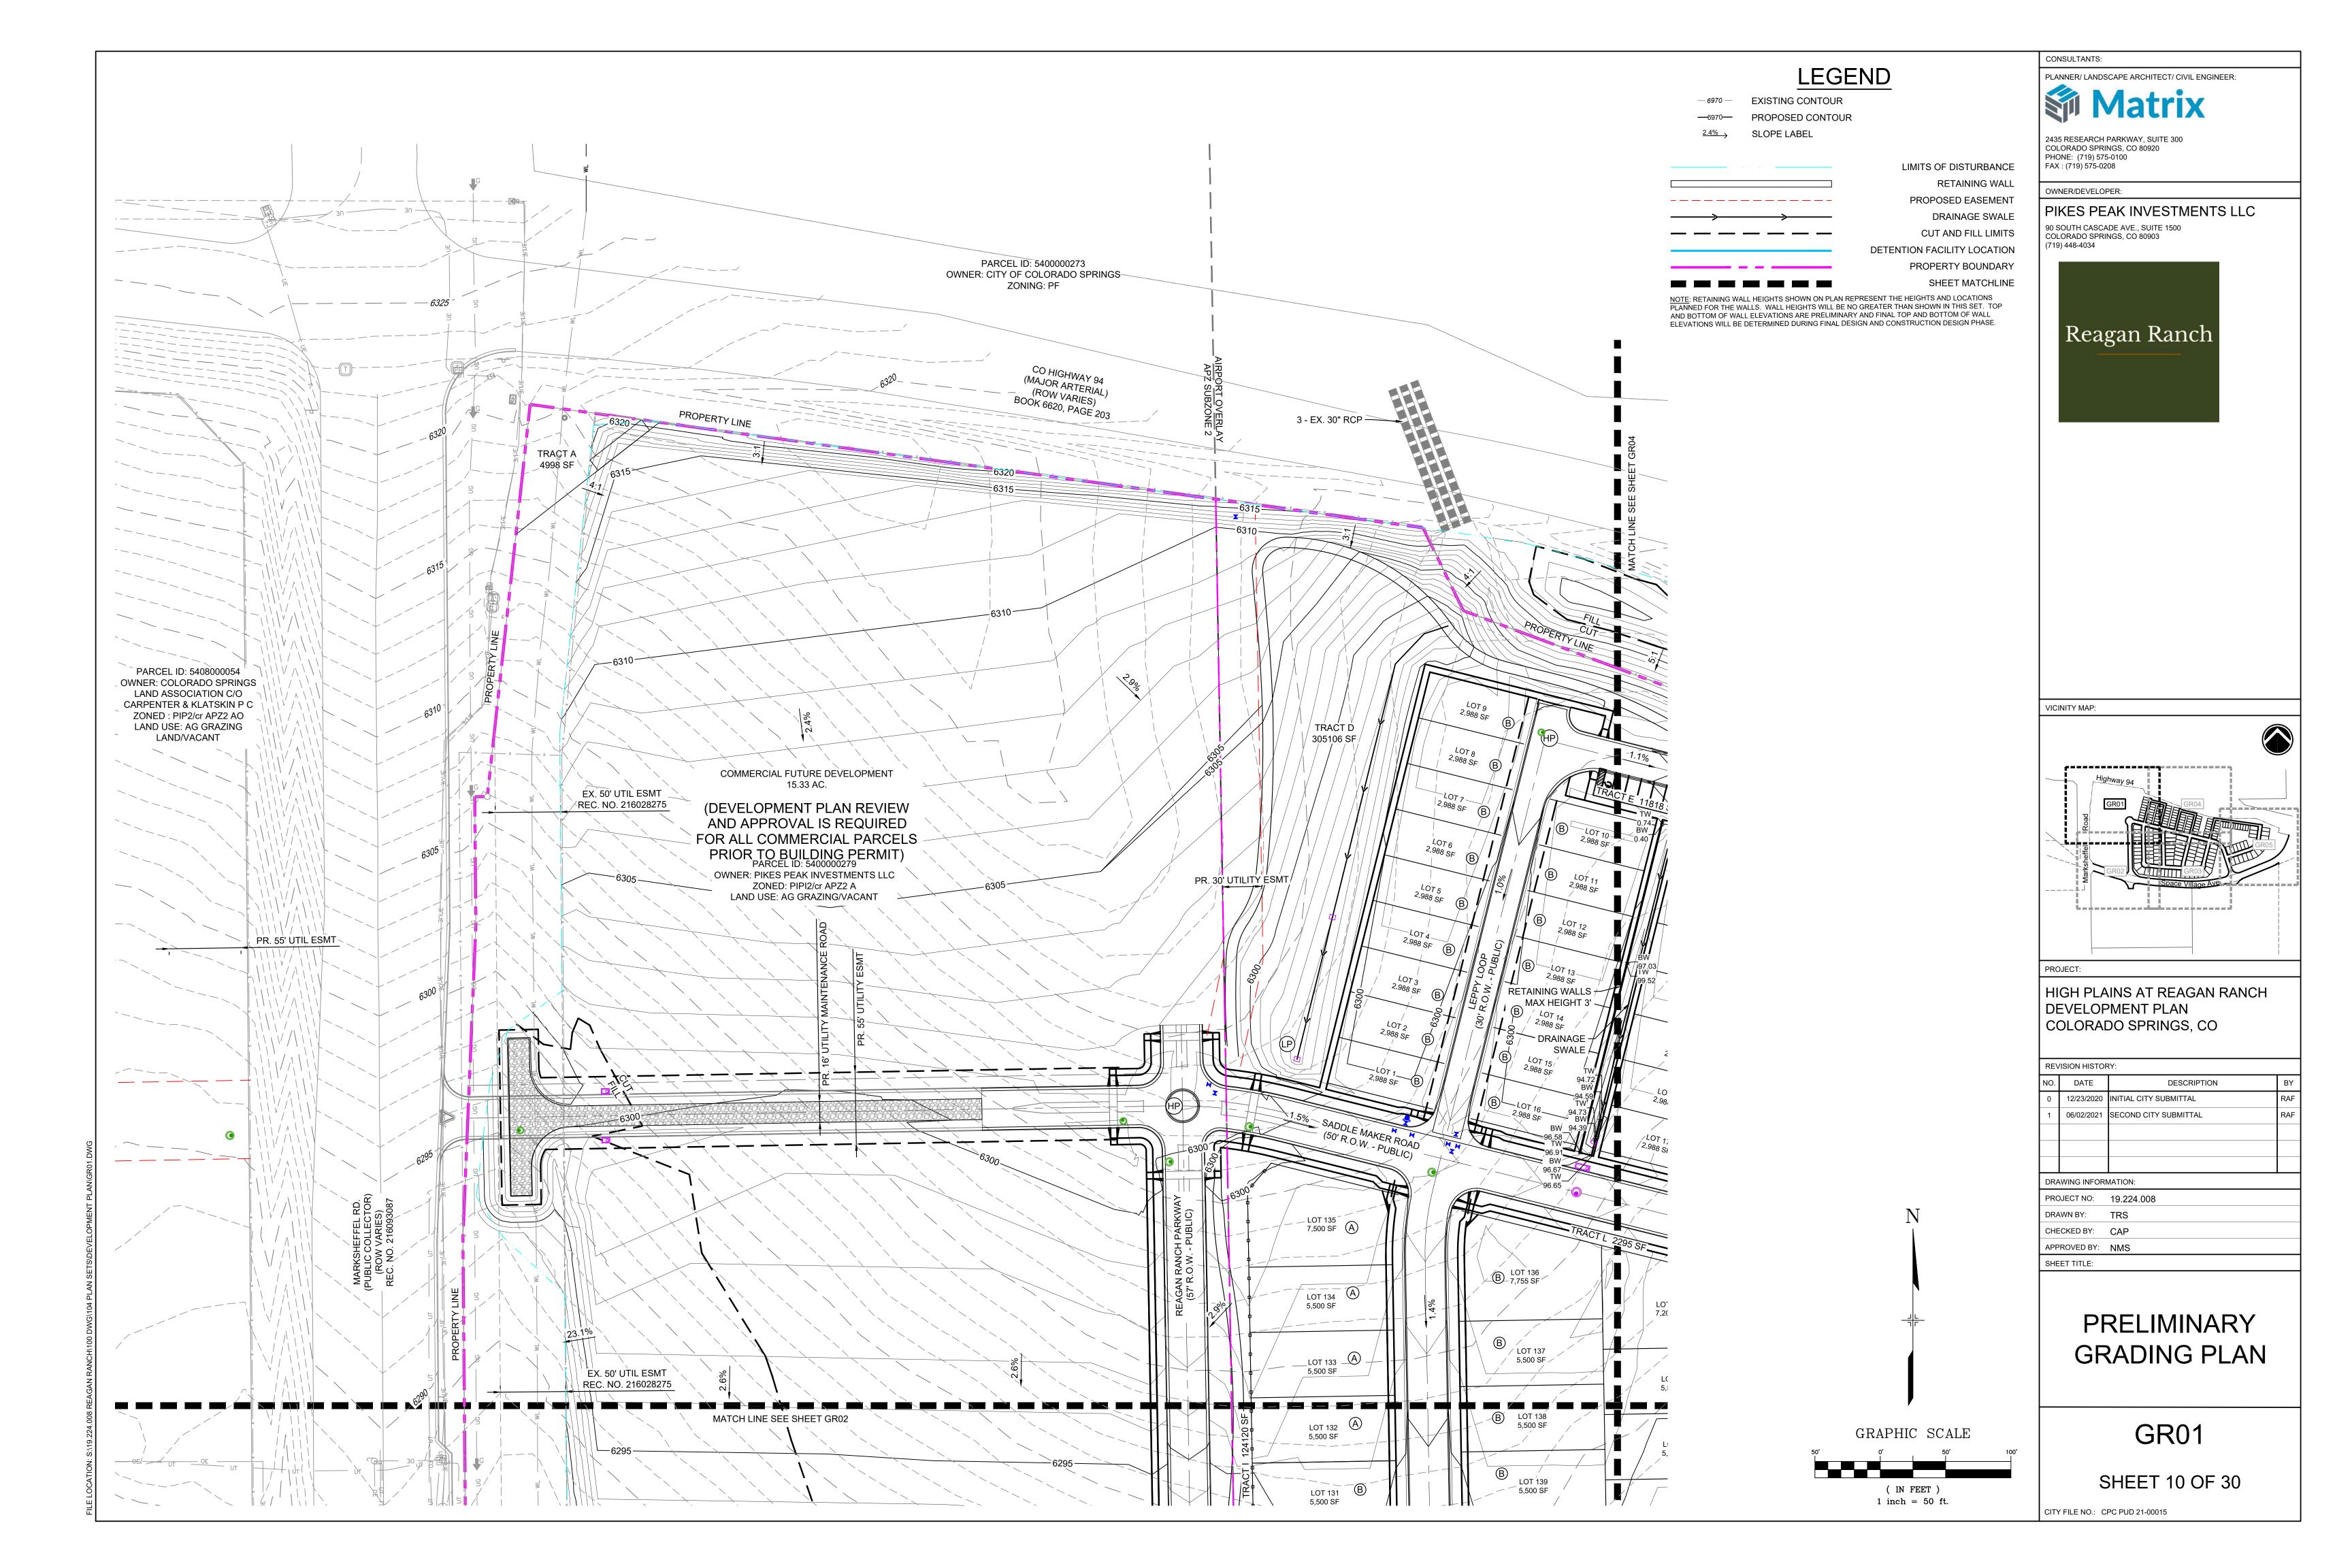

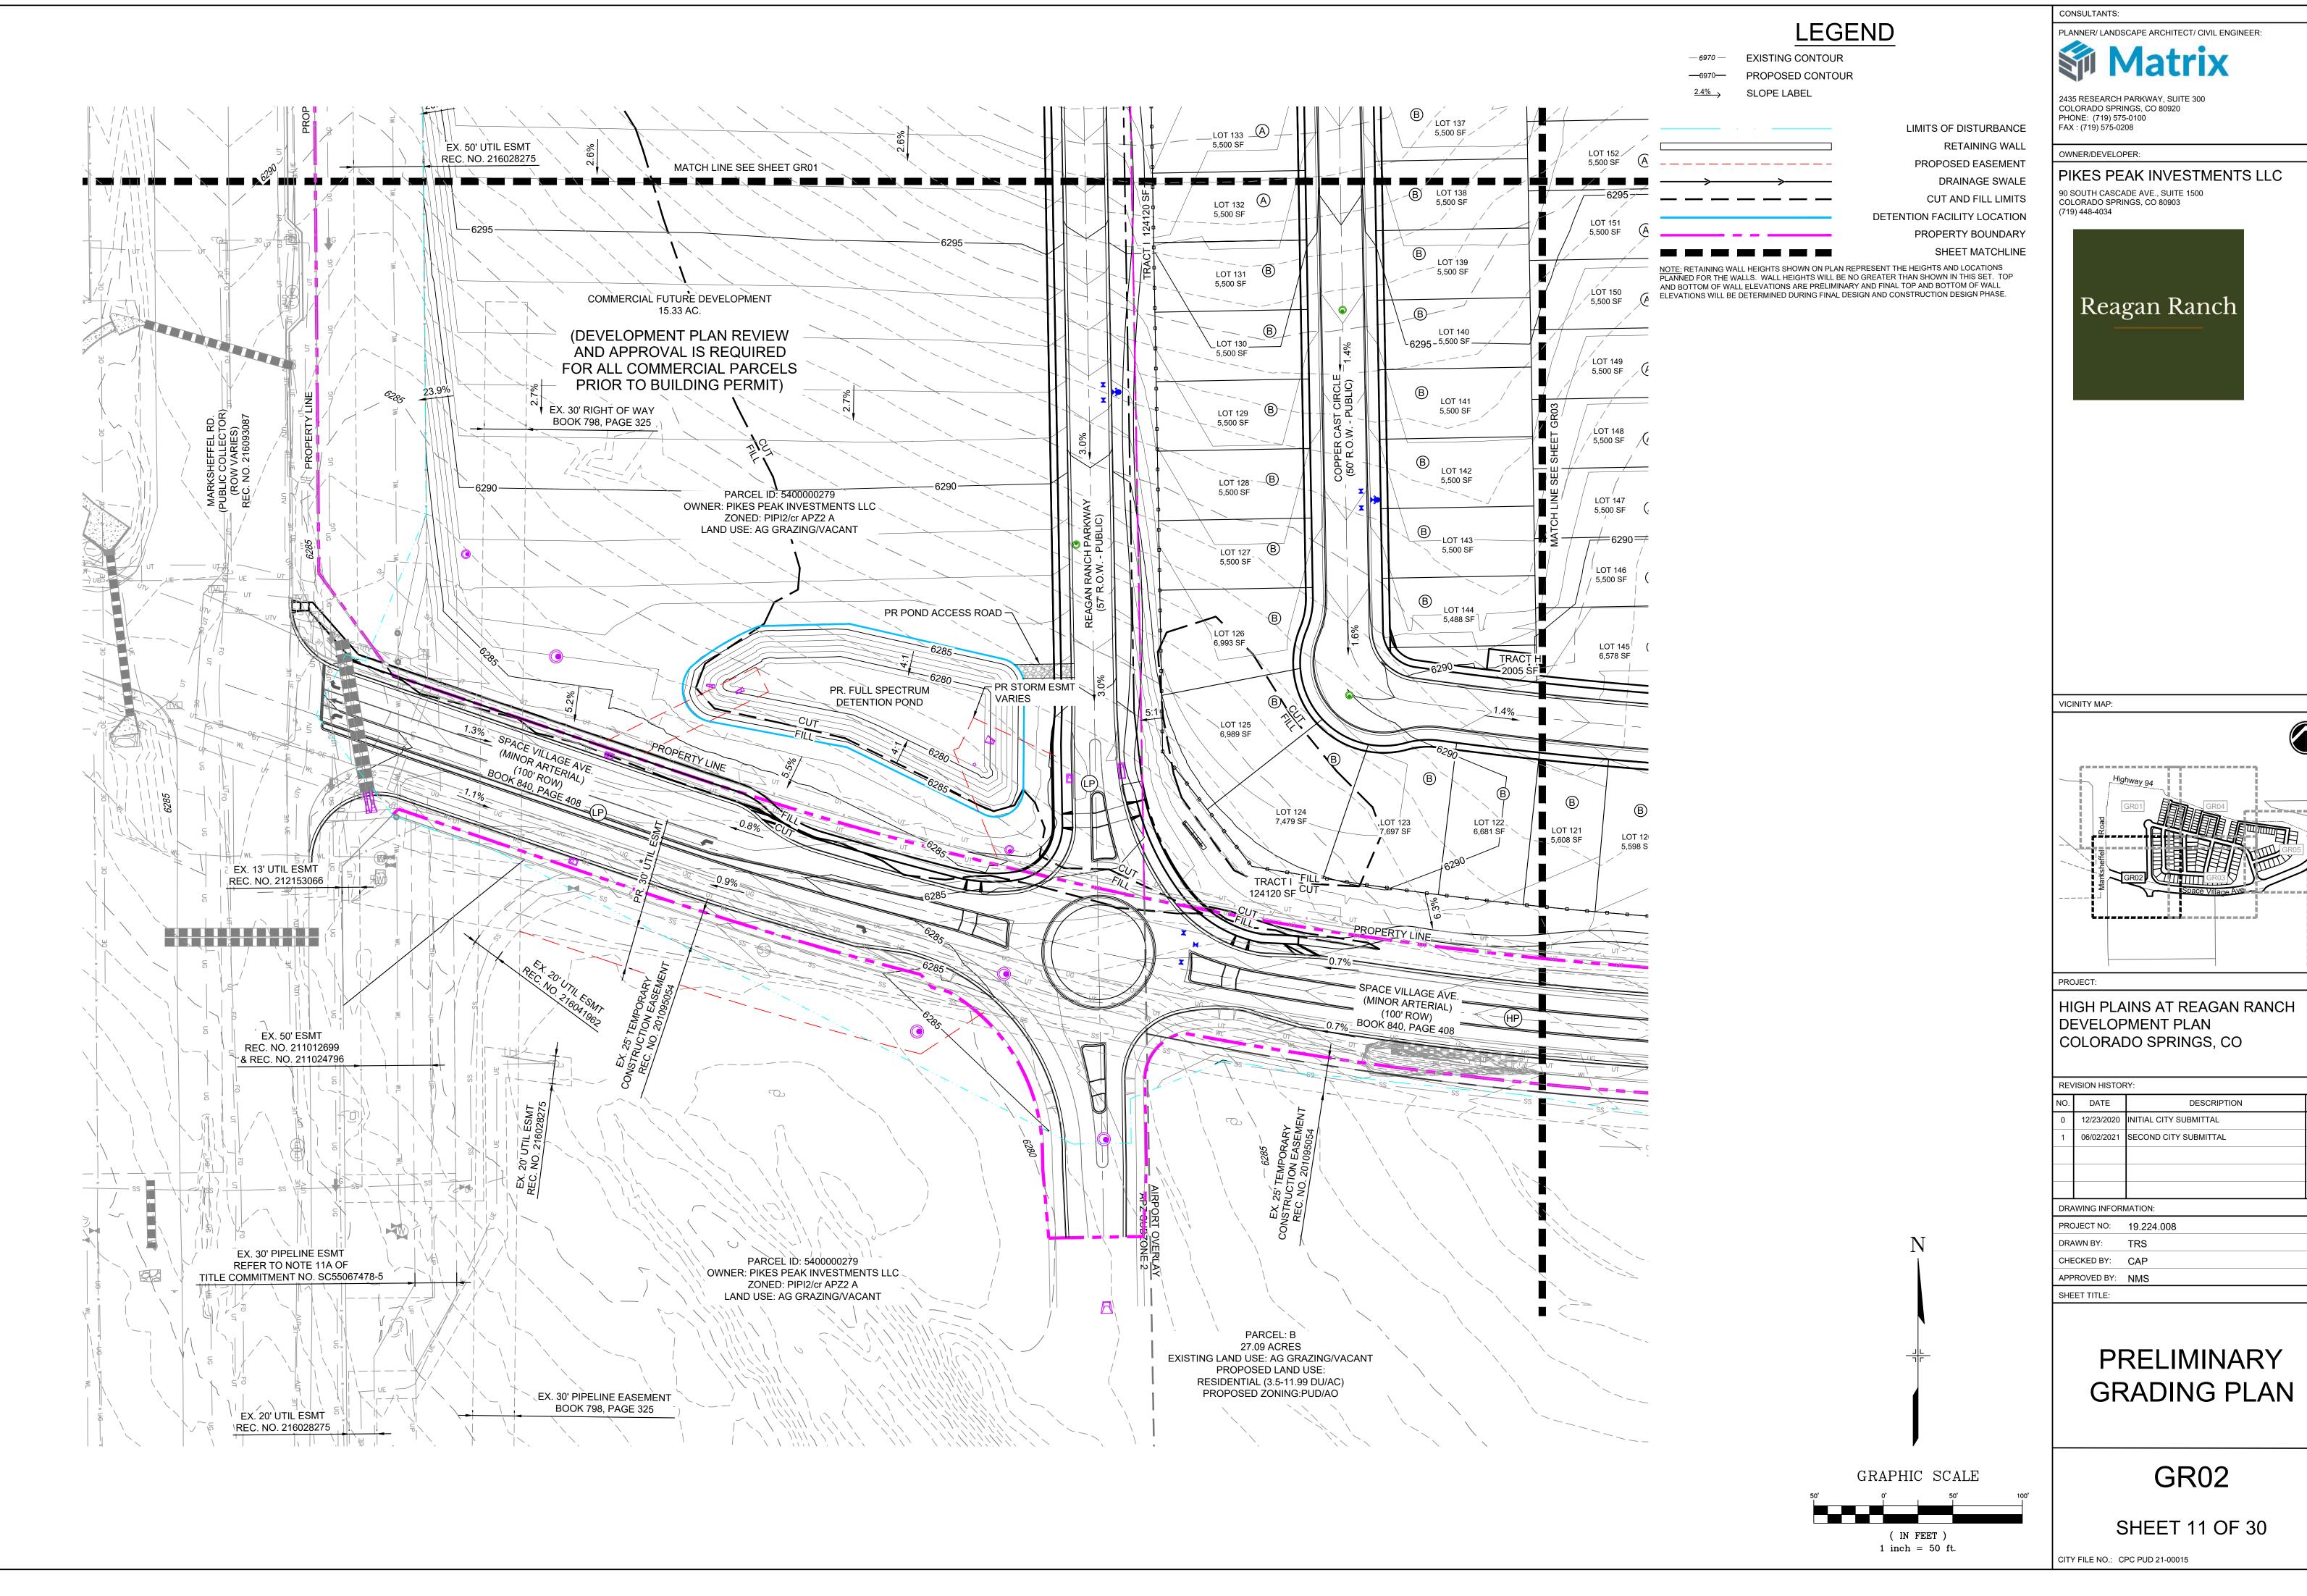

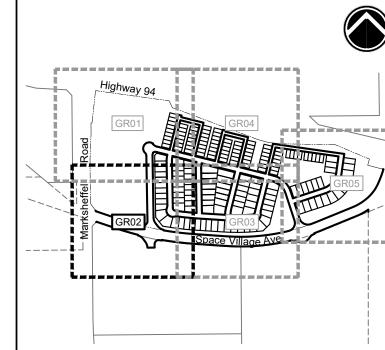

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	12/23/2020	INITIAL CITY SUBMITTAL	RAF			
	06/02/2021	SECOND CITY SUBMITTAL	RAF			
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₹О.	JECT NO:	19.224.008				
RA۱	WN BY:	TRS				
HECKED BY:		CAP				
PPROVED BY:		NMS				
IEI	ET TITLE:					

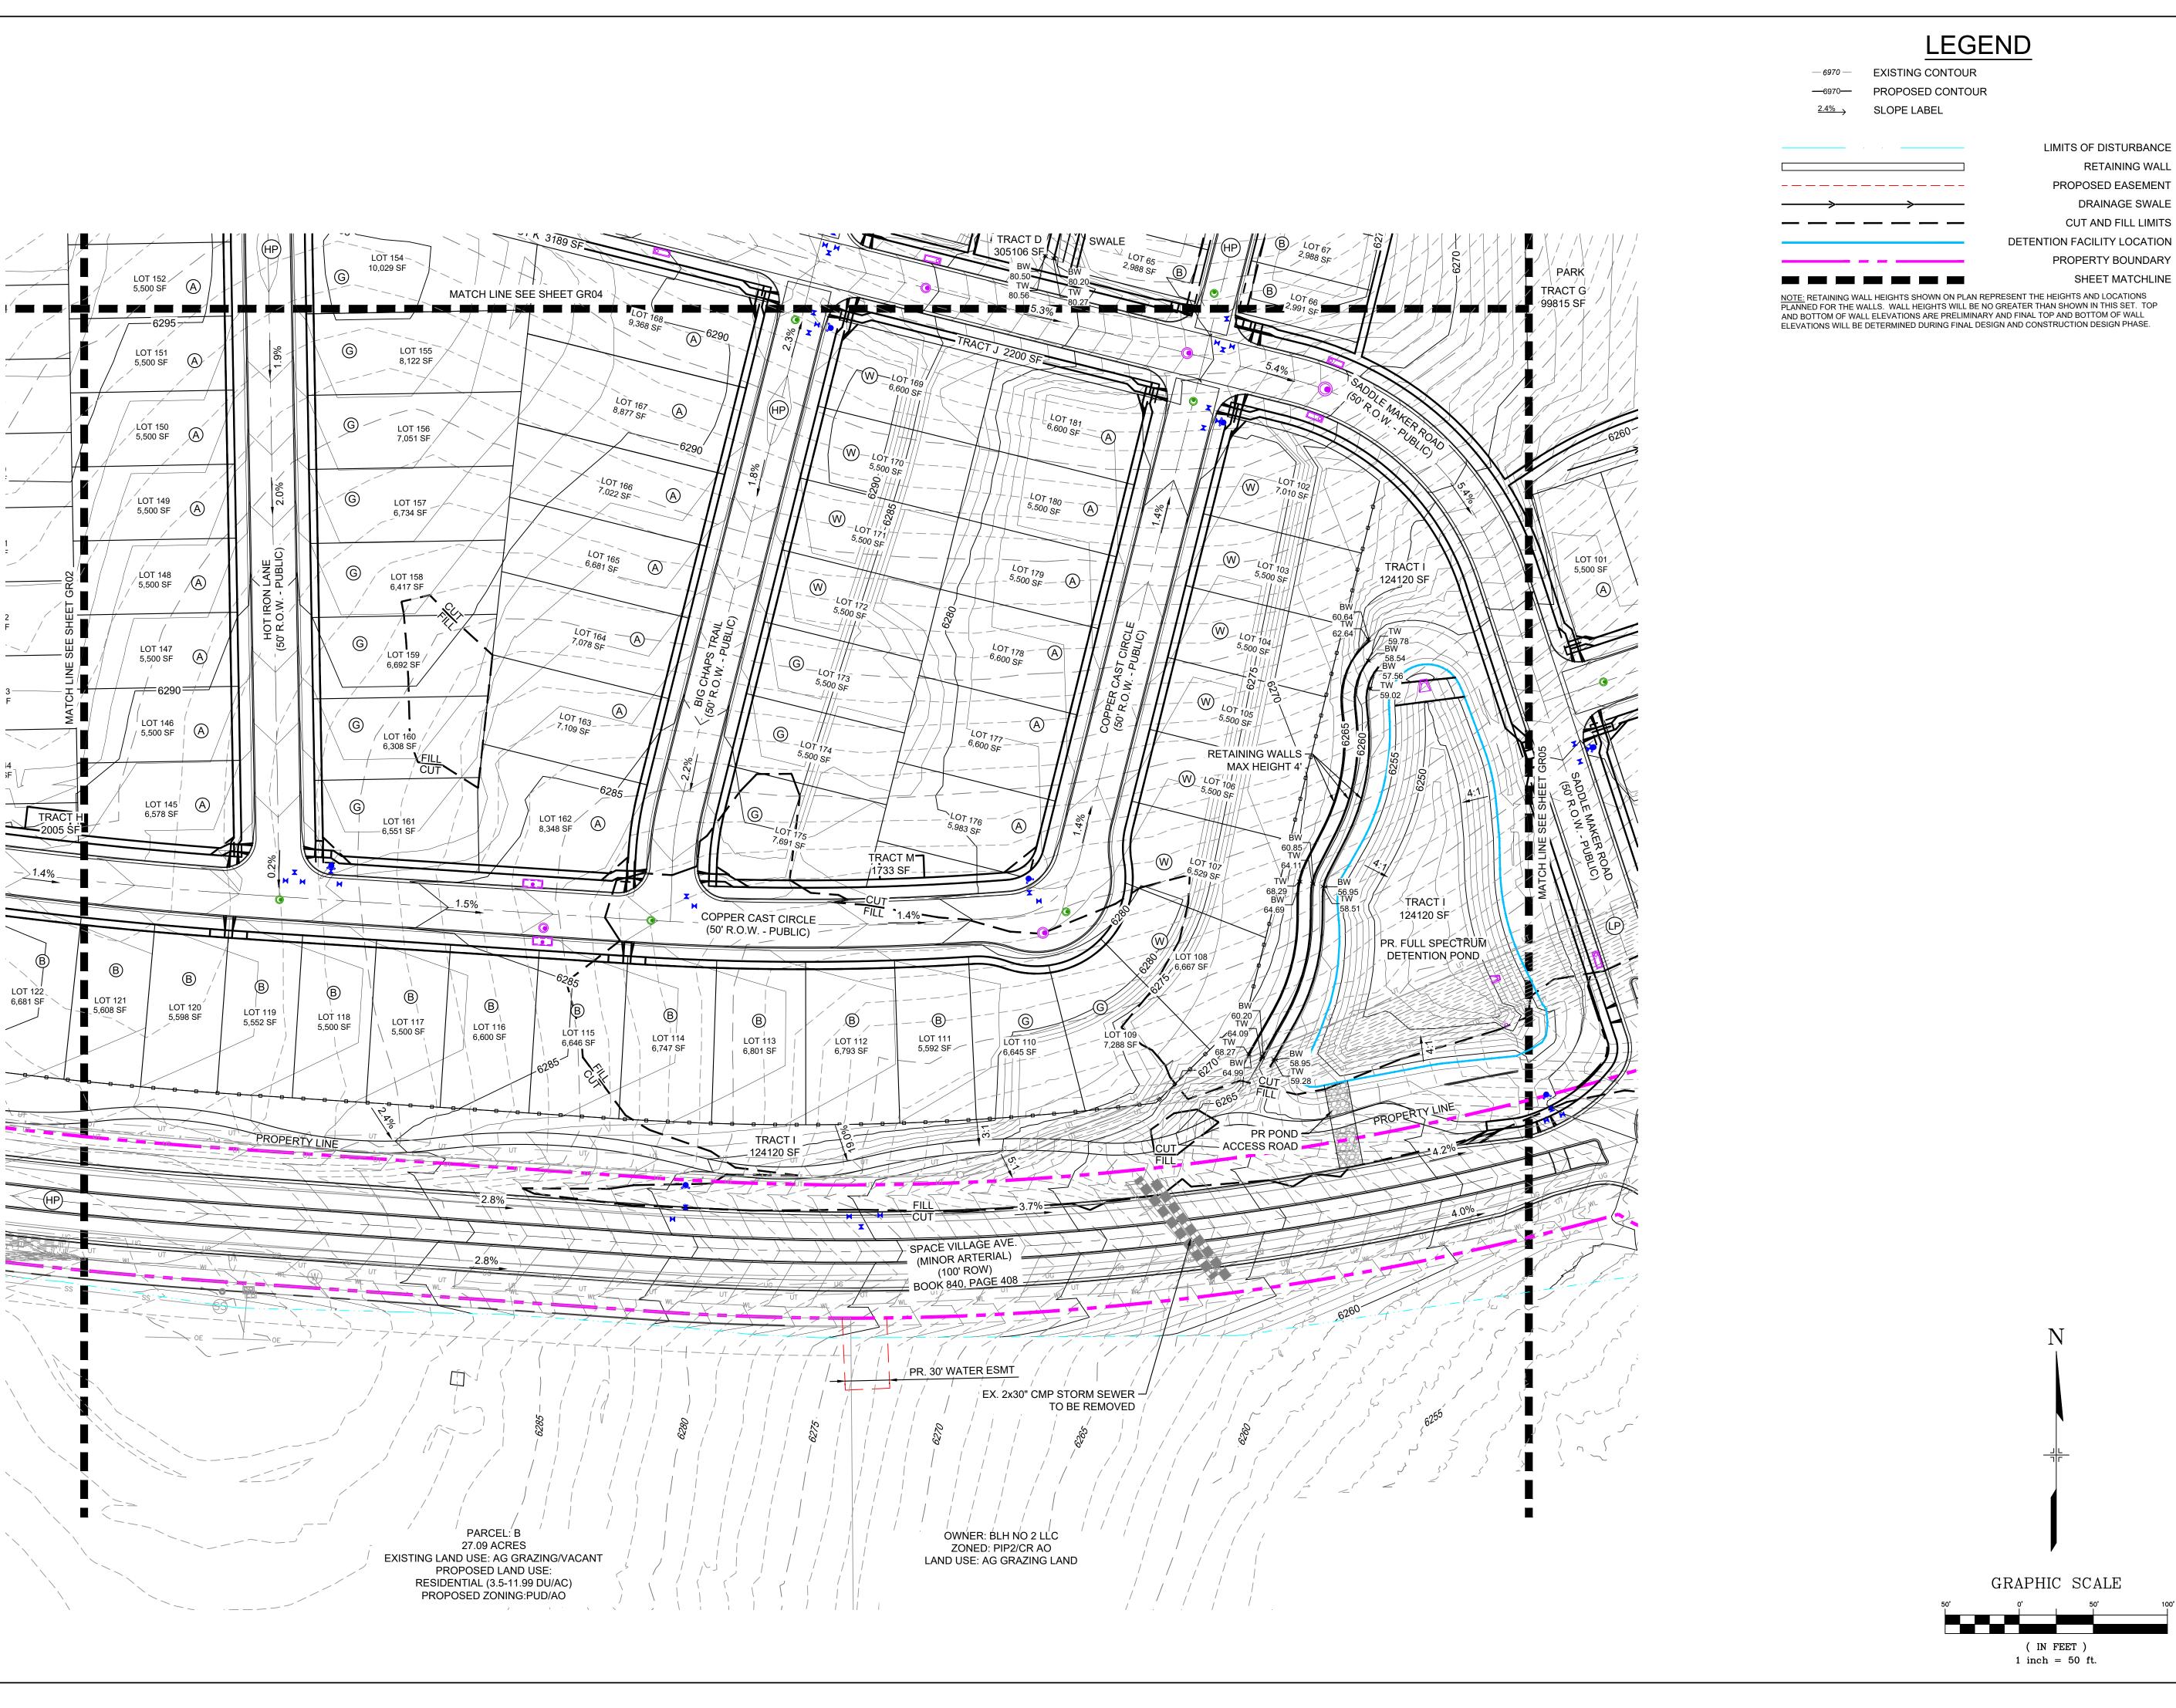

RETAINING WALL PROPOSED EASEMENT DRAINAGE SWALE CUT AND FILL LIMITS DETENTION FACILITY LOCATION PROPERTY BOUNDARY

CONSULTANTS: PLANNER/ LANDSCAPE ARCHITECT/ CIVIL ENGINEER:

2435 RESEARCH PARKWAY, SUITE 300 COLORADO SPRINGS, CO 80920 PHONE: (719) 575-0100 FAX: (719) 575-0208


OWNER/DEVELOPER:

PIKES PEAK INVESTMENTS LLC

90 SOUTH CASCADE AVE., SUITE 1500 COLORADO SPRINGS, CO 80903 (719) 448-4034



VICINITY MAP:

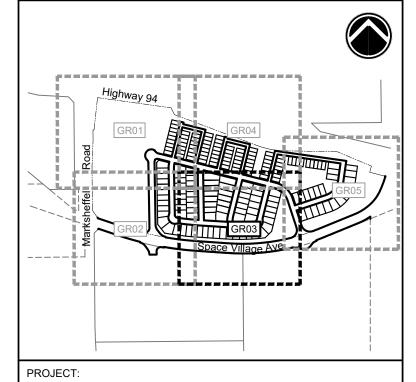


HIGH PLAINS AT REAGAN RANCH DEVELOPMENT PLAN COLORADO SPRINGS, CO


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	06/02/2021	SECOND CITY SUBMITTAL	RAF			
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RC	JECT NO:	19.224.008				
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PPROVED BY: NMS		NMS				
ΗE	EET TITLE:					

PRELIMINARY **GRADING PLAN**


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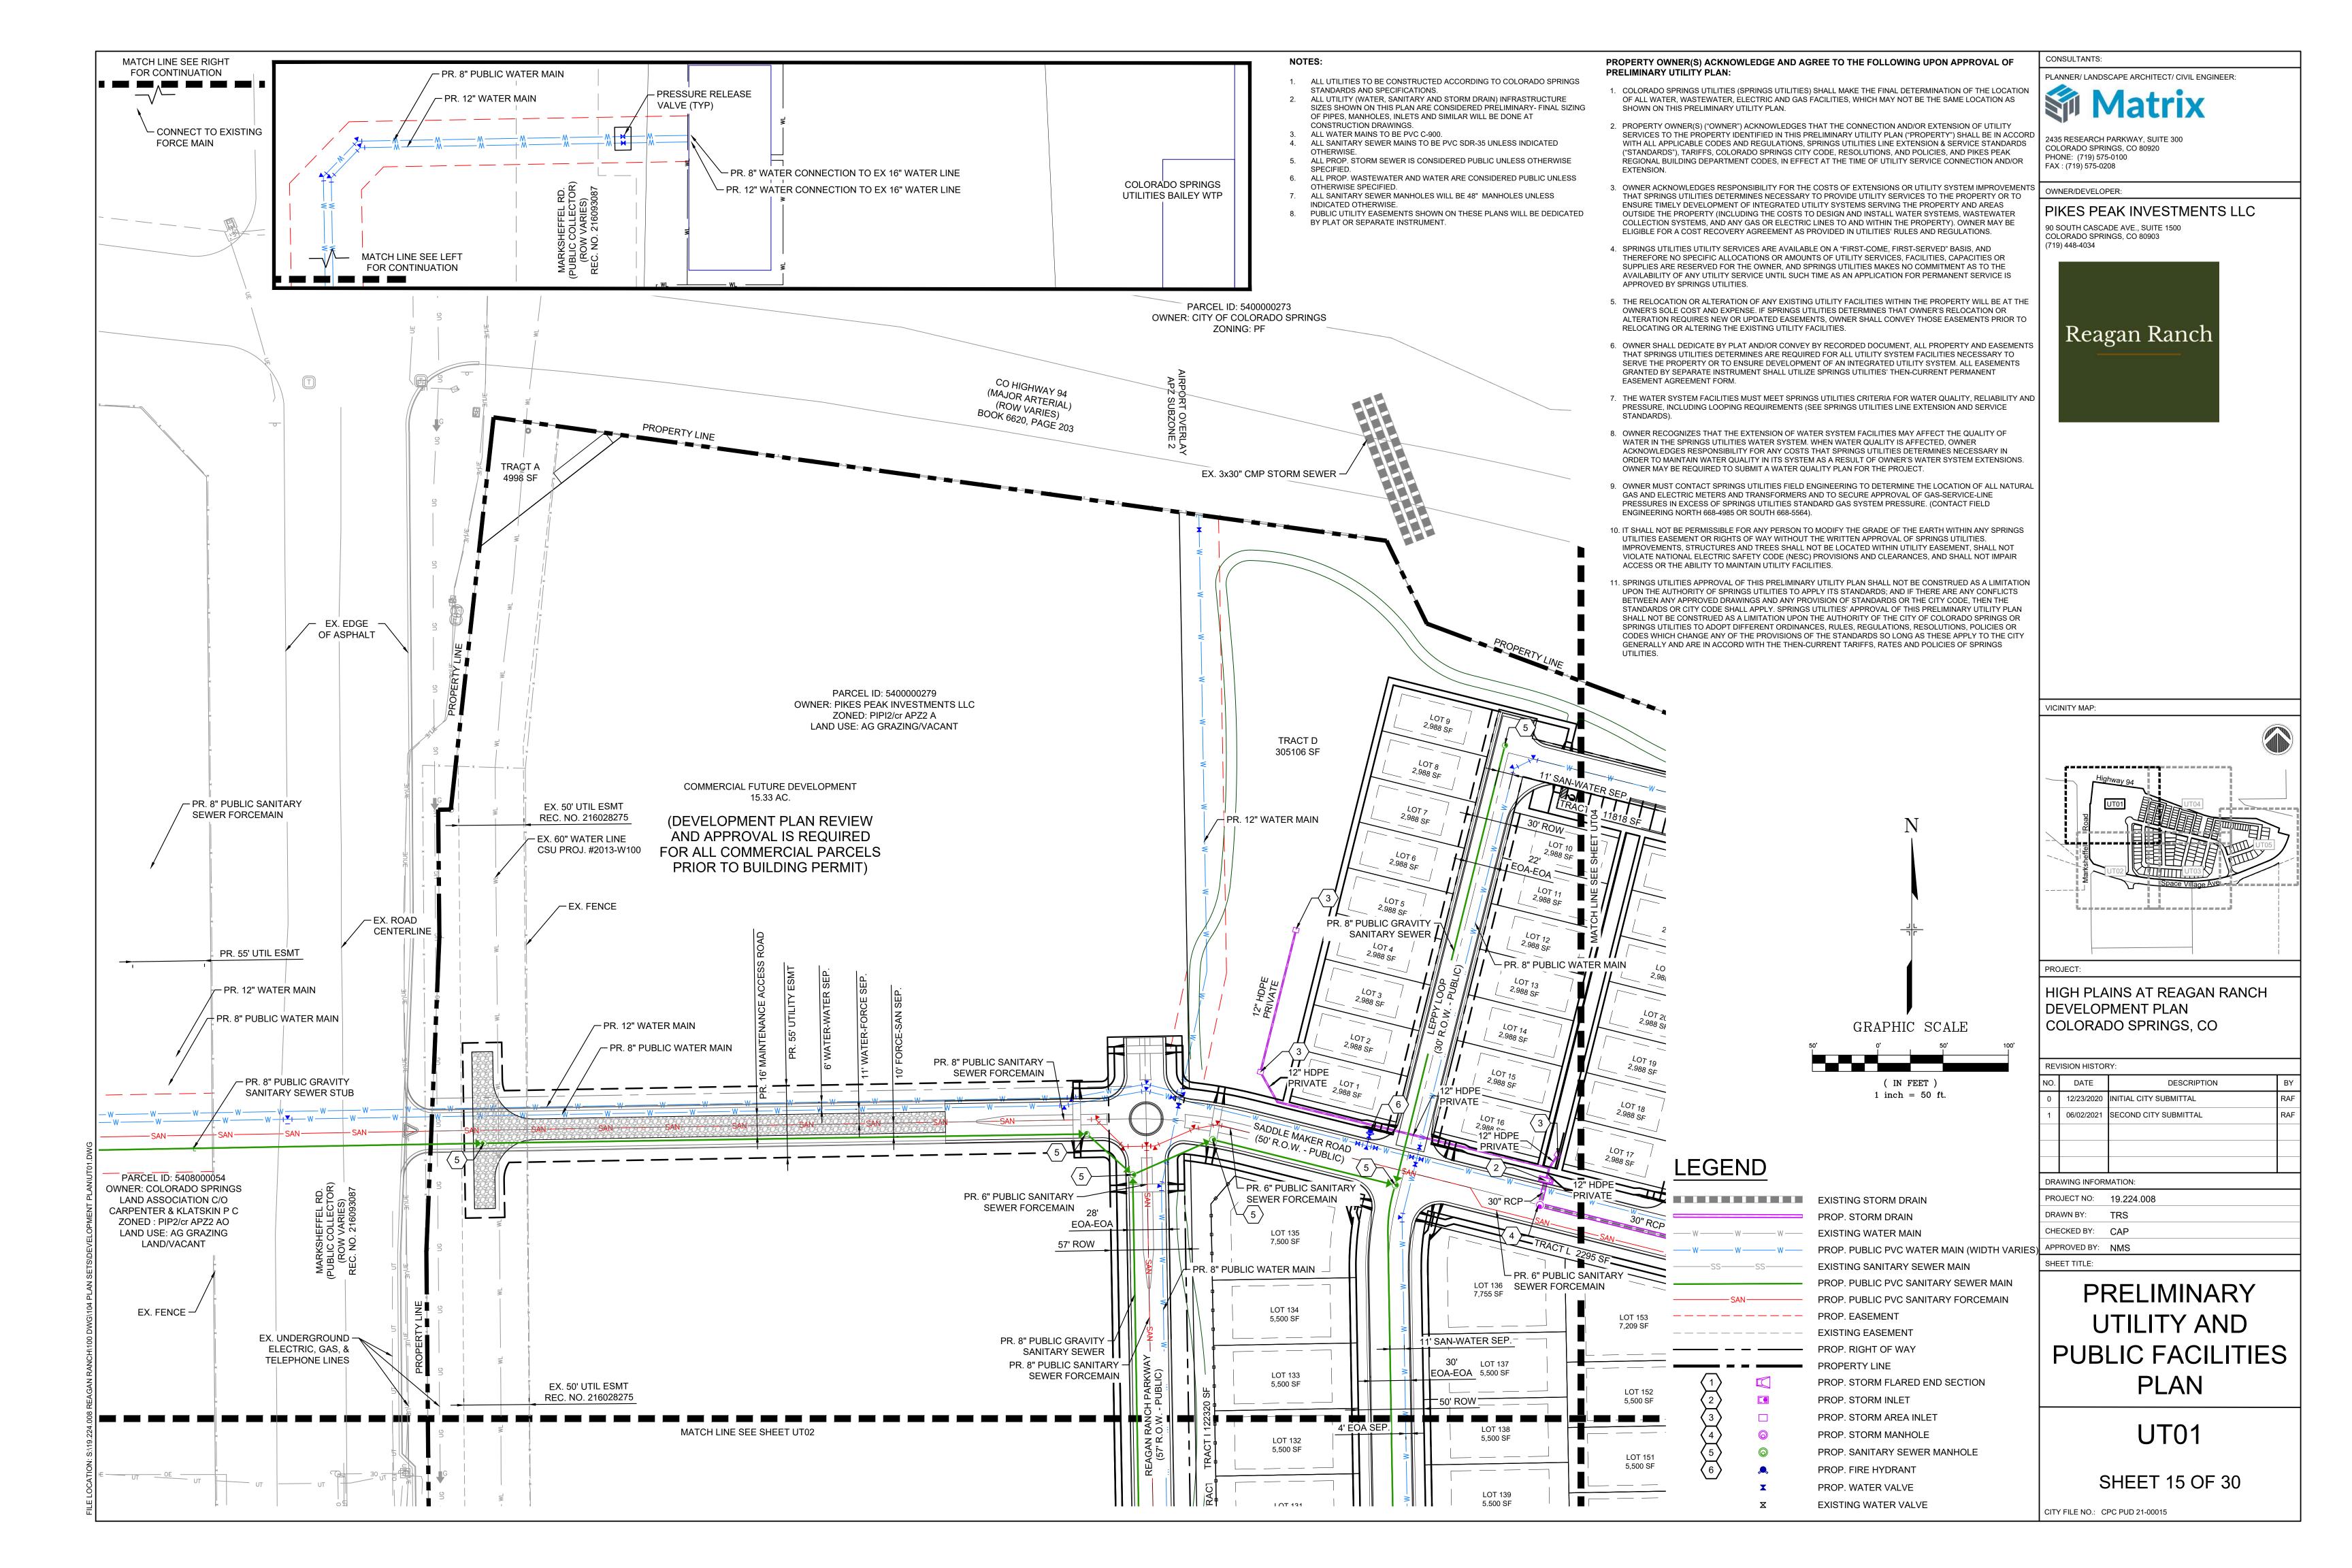
SHEET 12 OF 30




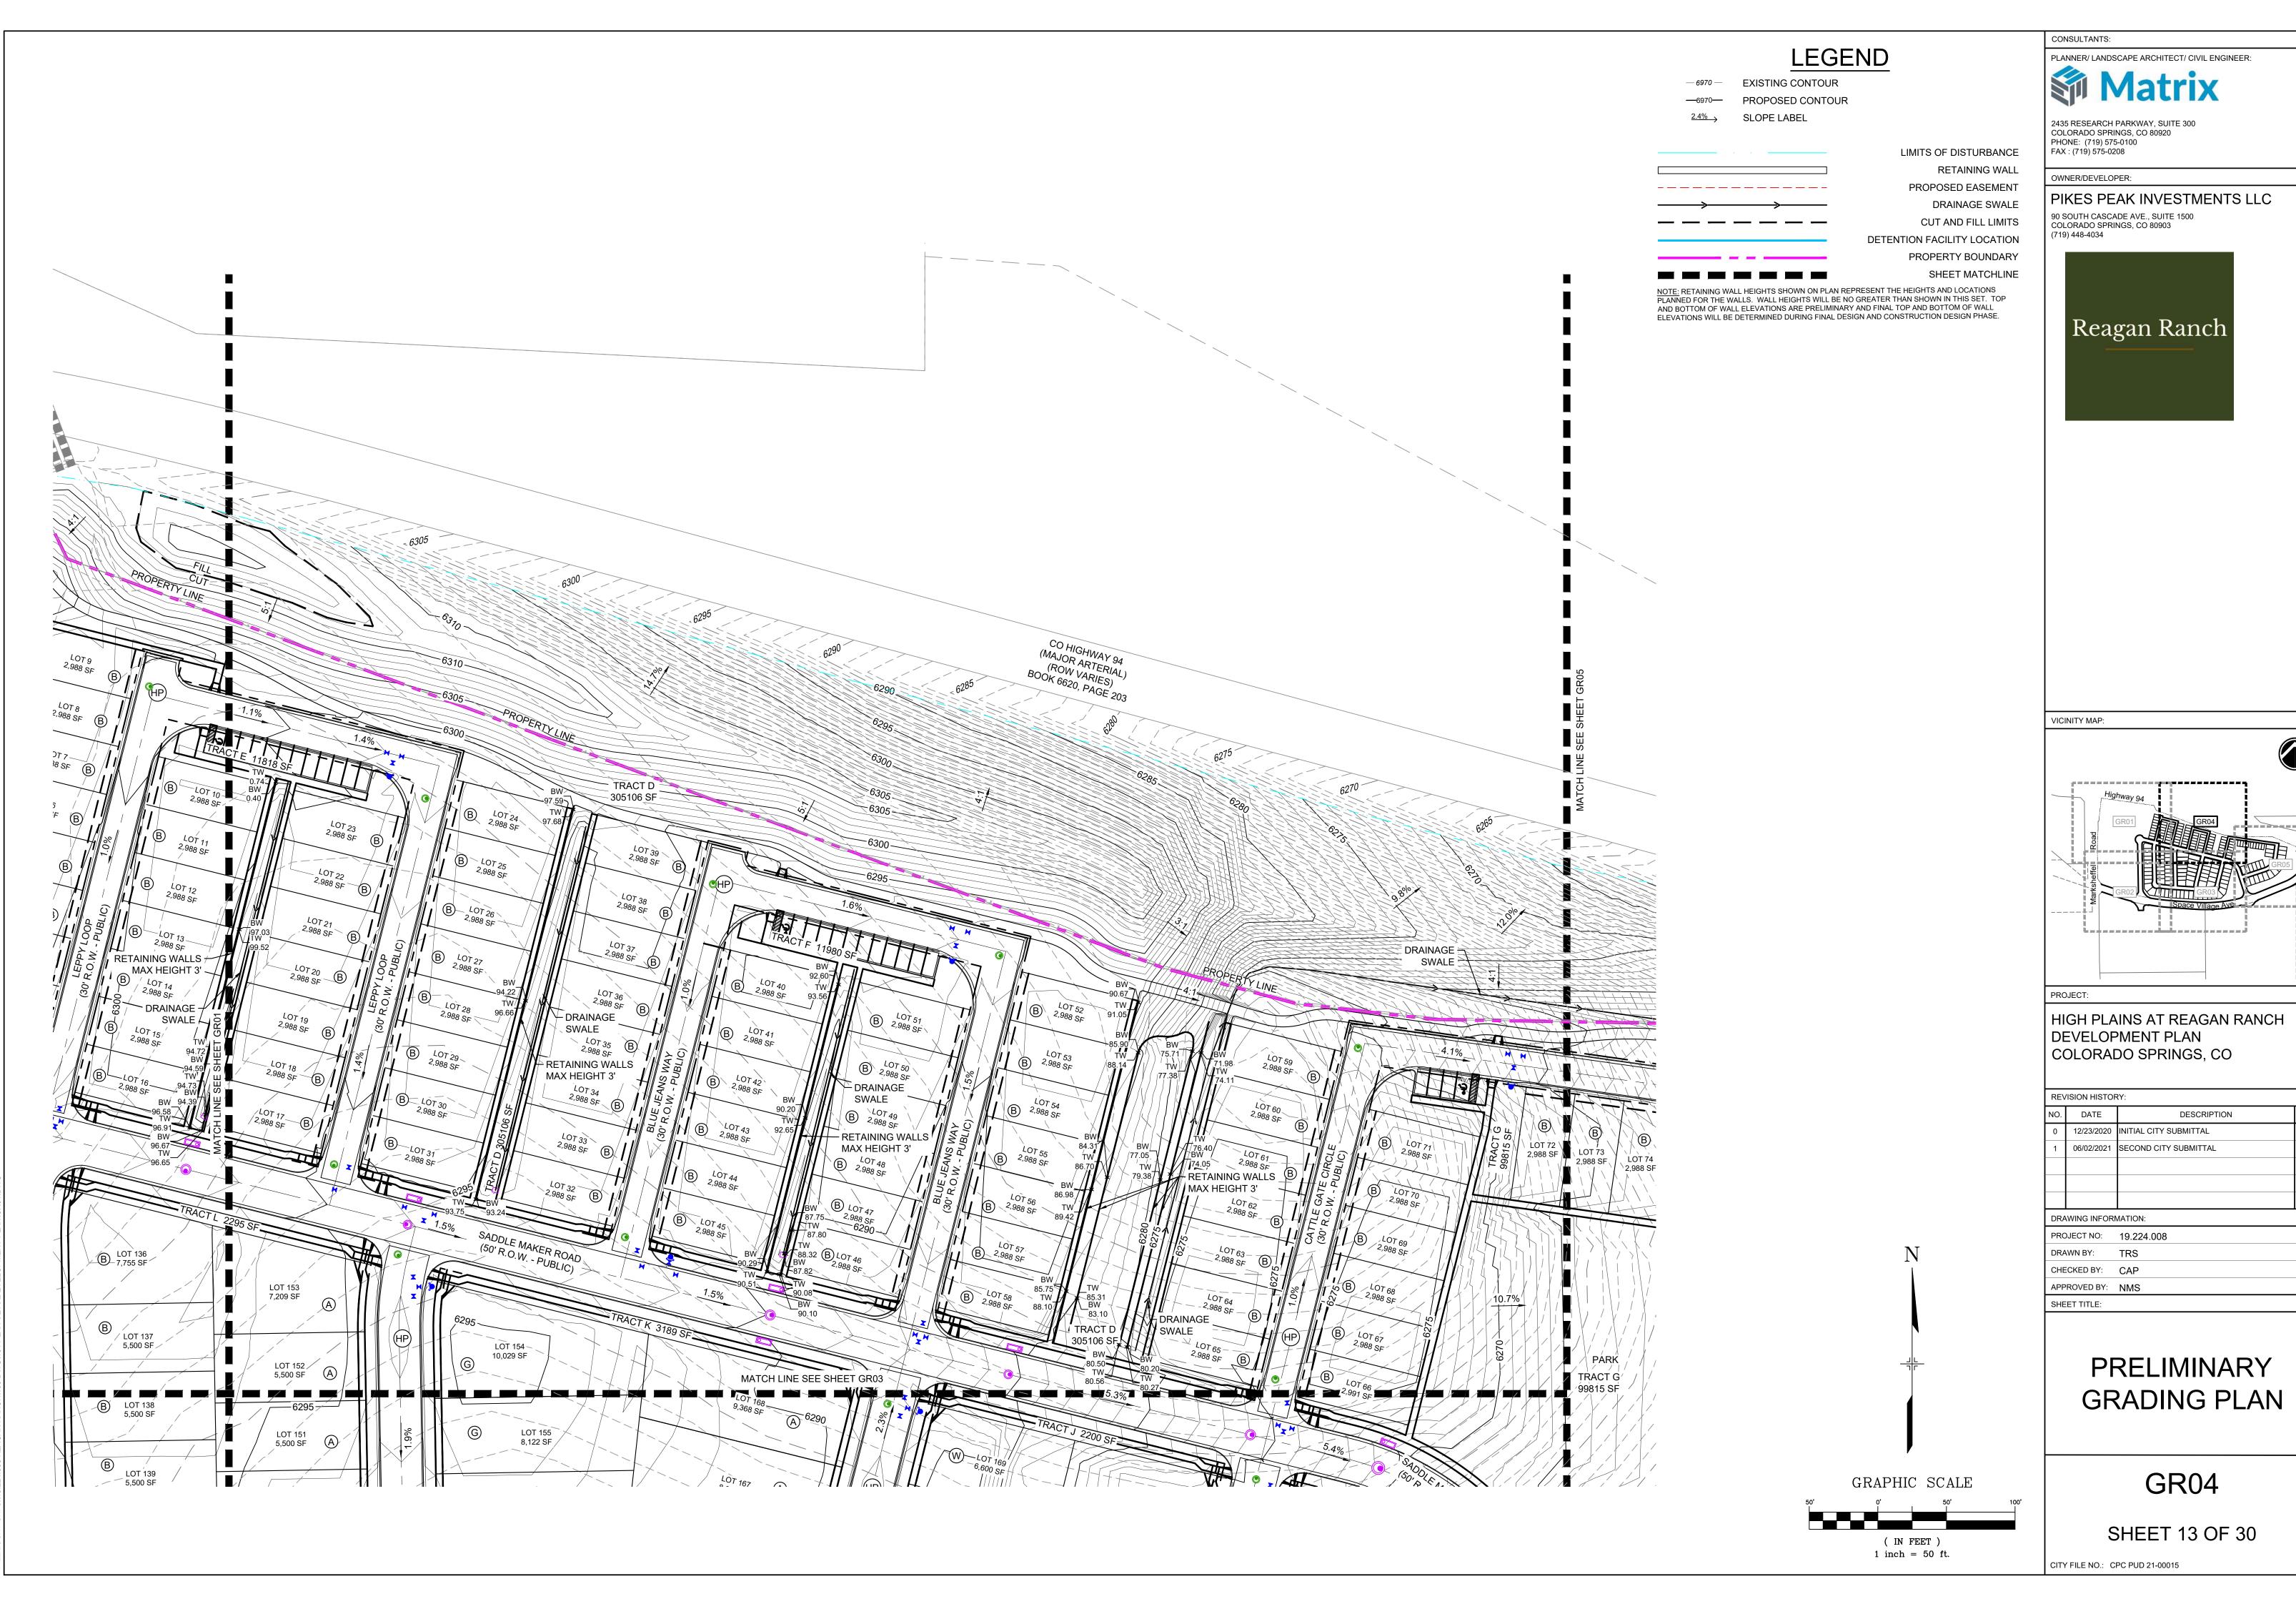

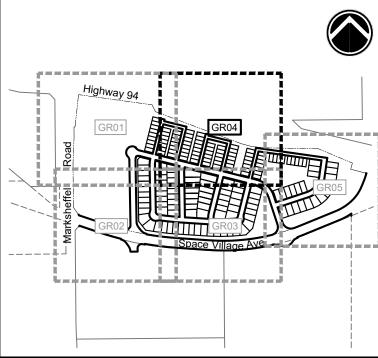
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PRO	DJECT NO:	19.224.008	
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APPROVED BY:		NMS	
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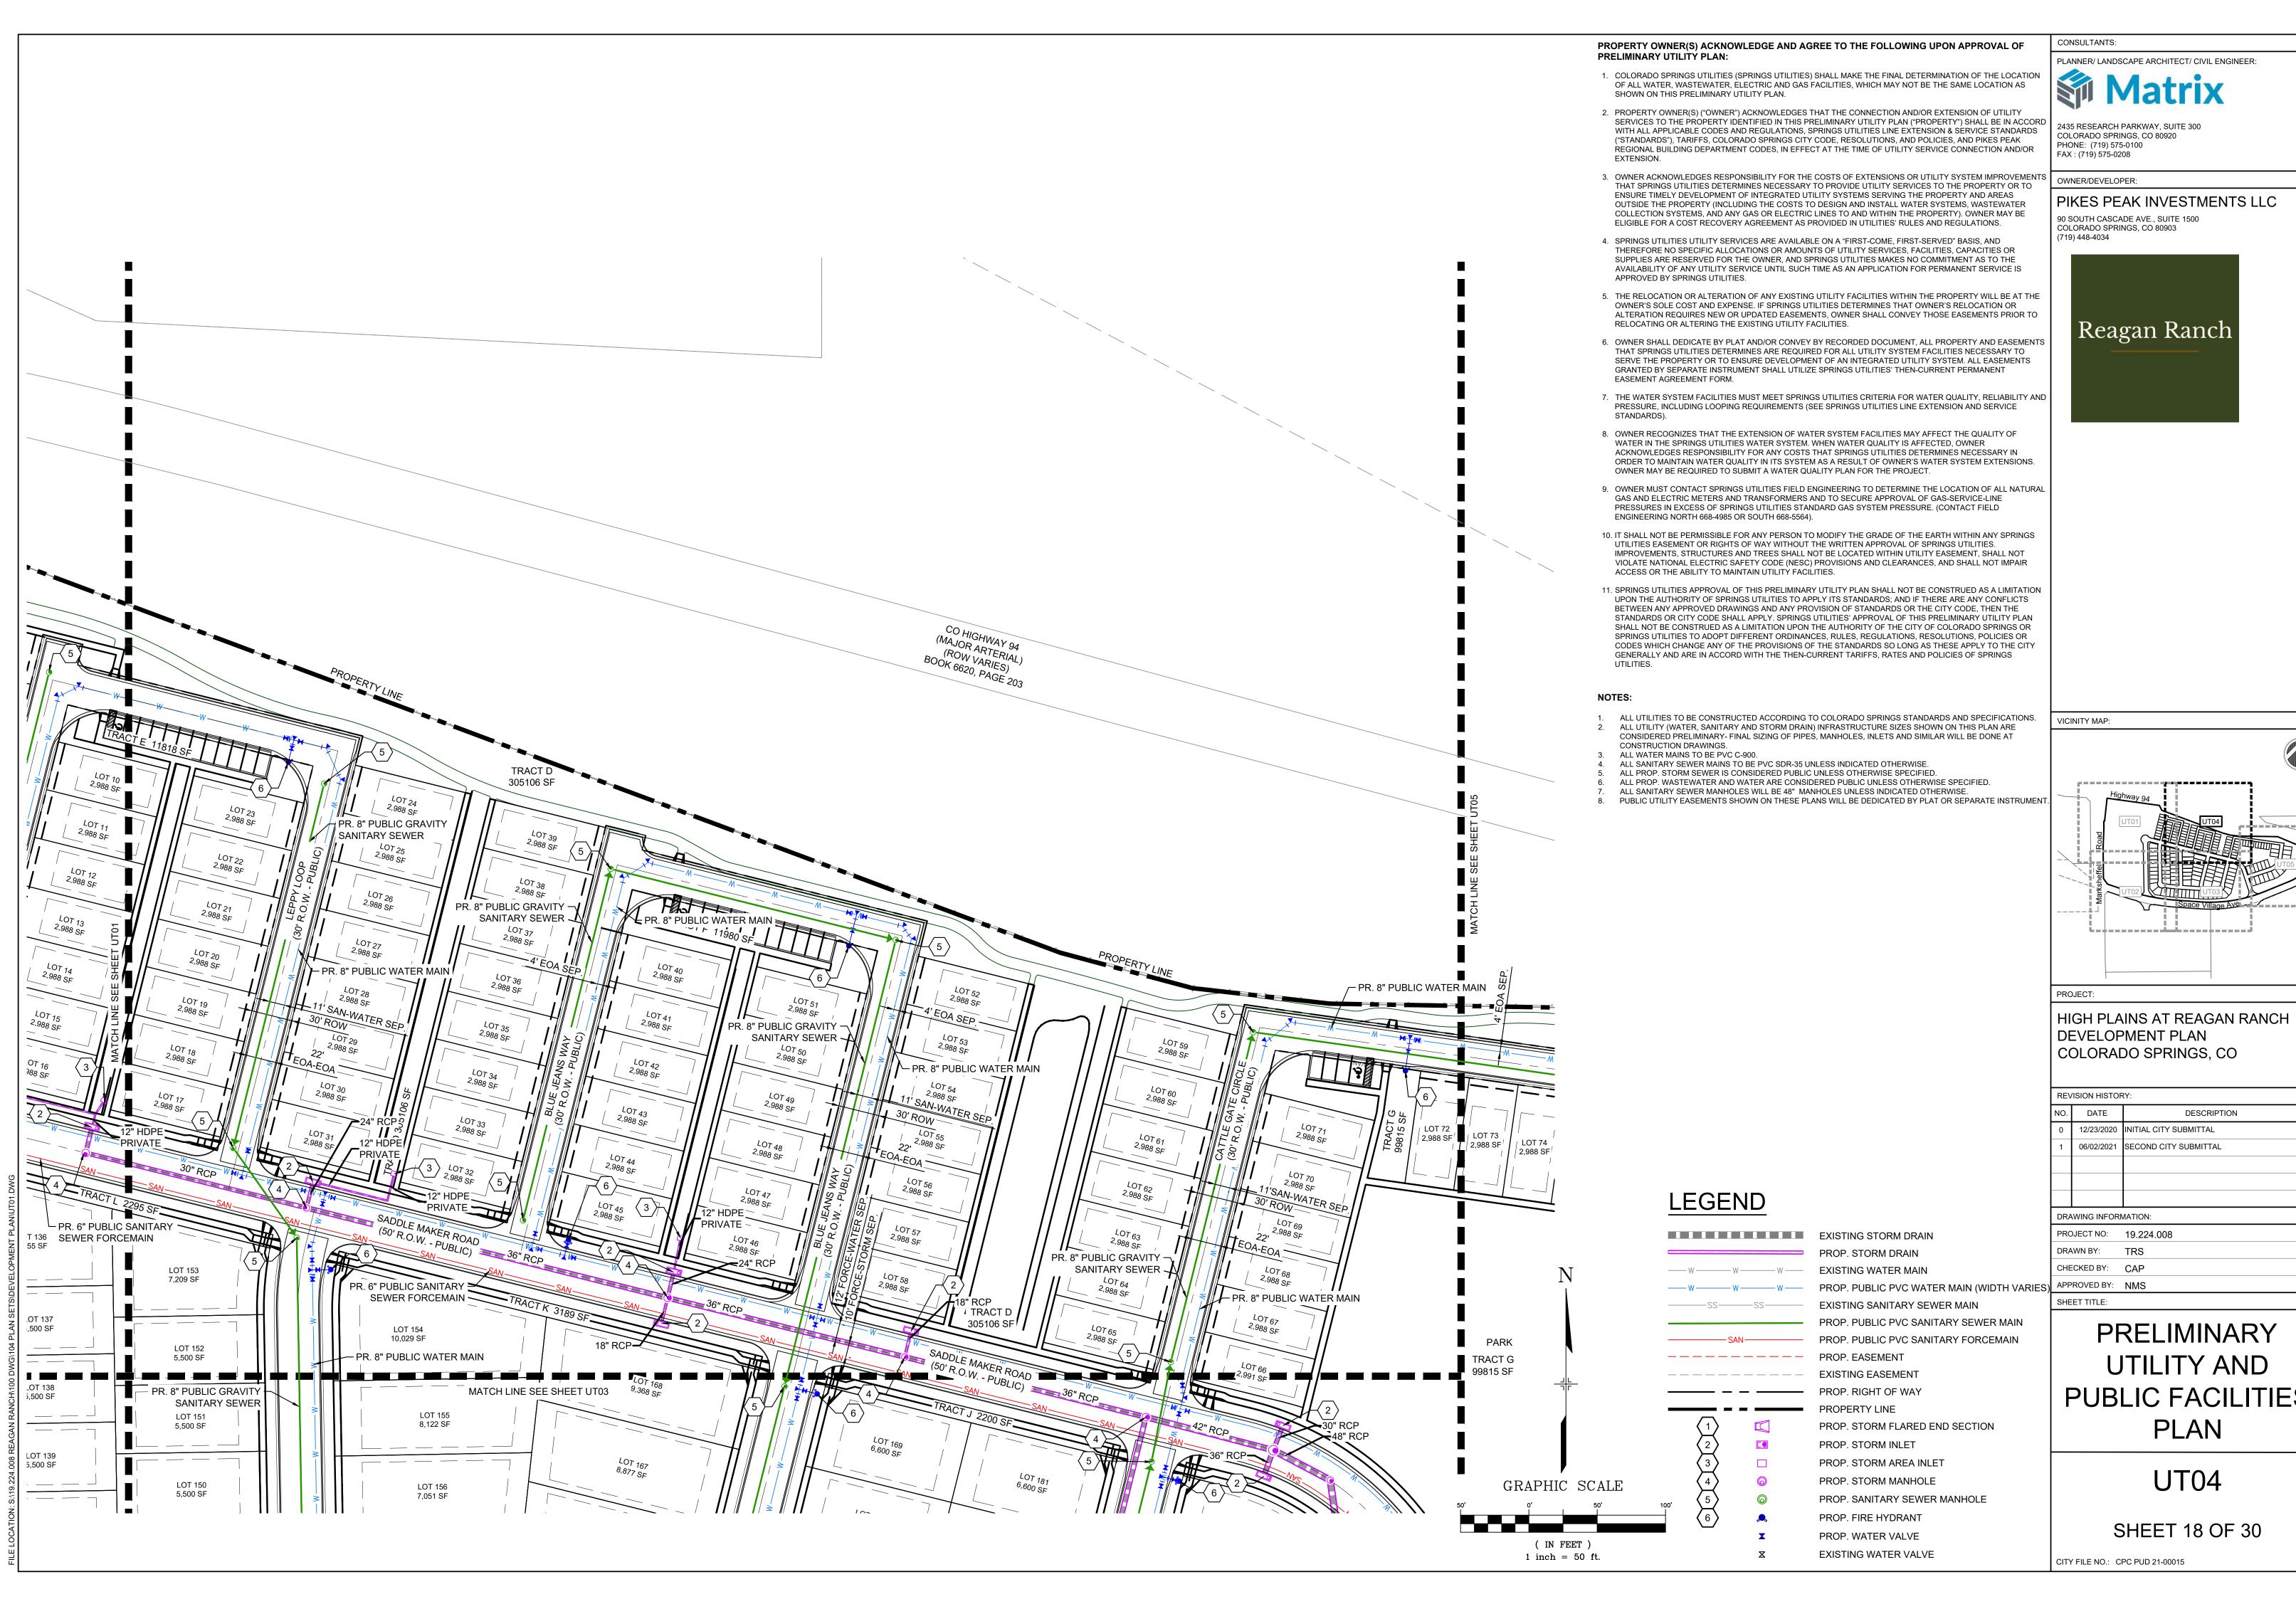


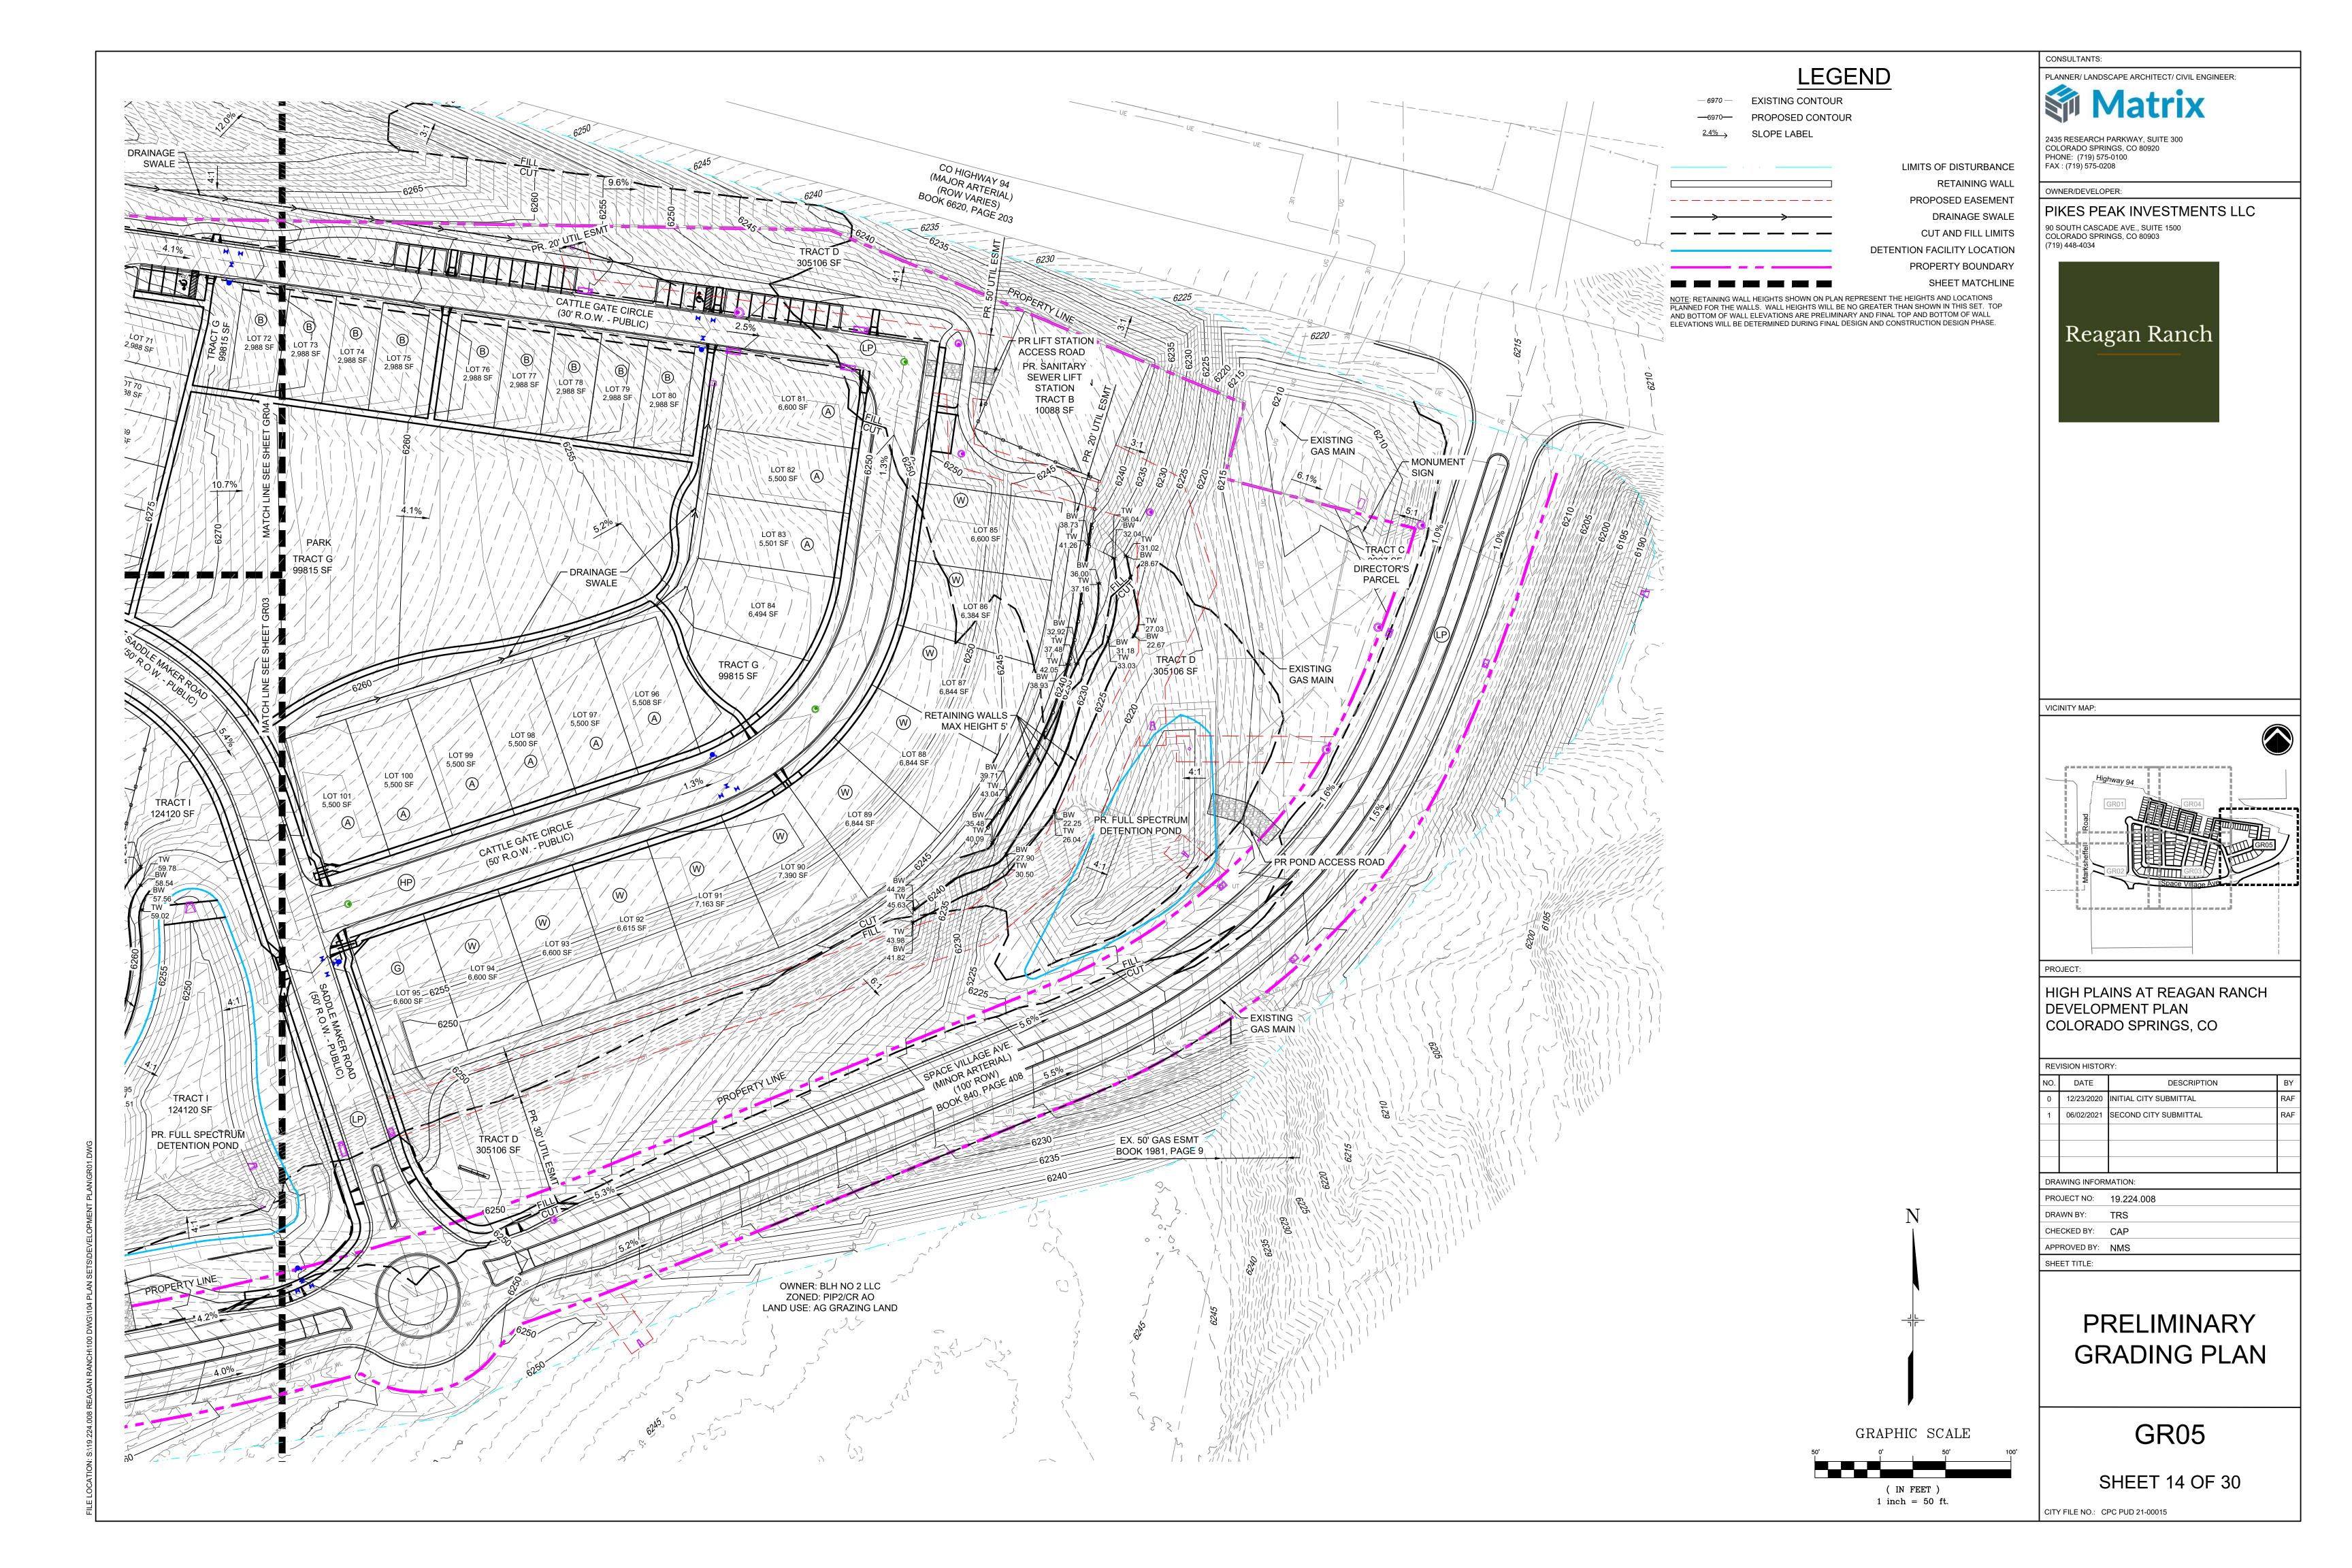


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APPROVED BY:		NMS			
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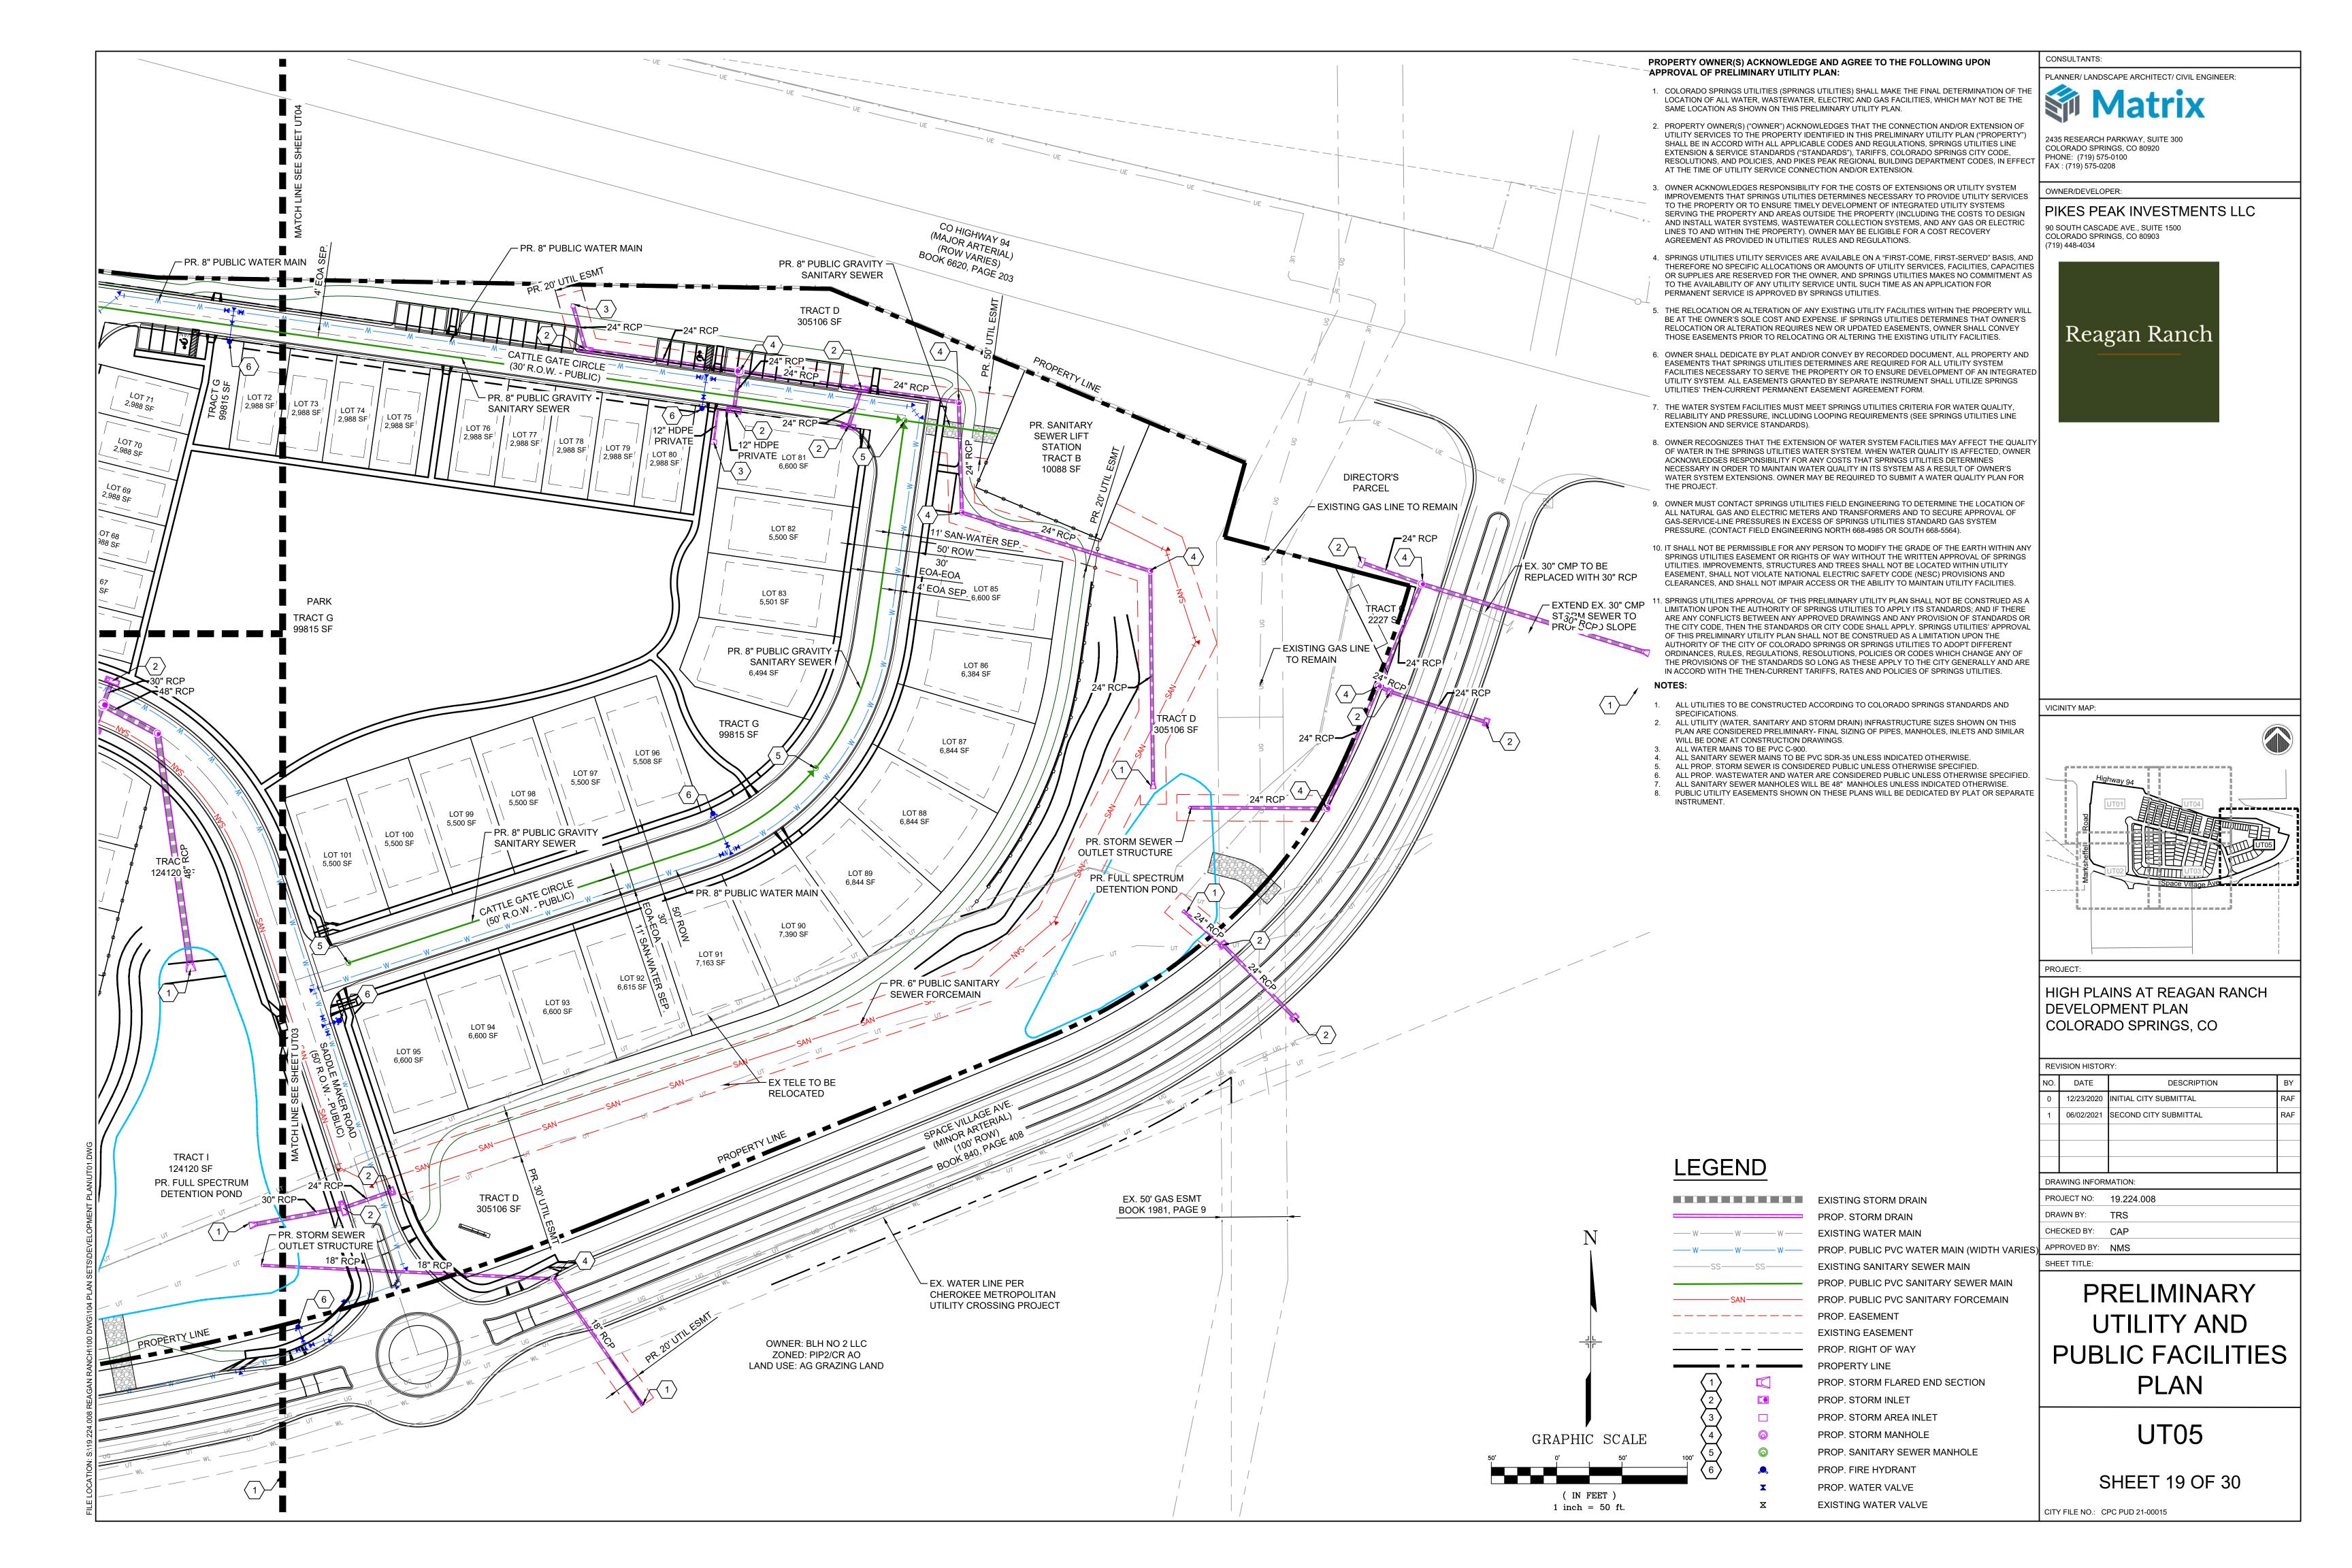
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CHE	ECKED BY:	CAP			
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PUBLIC FACILITIES

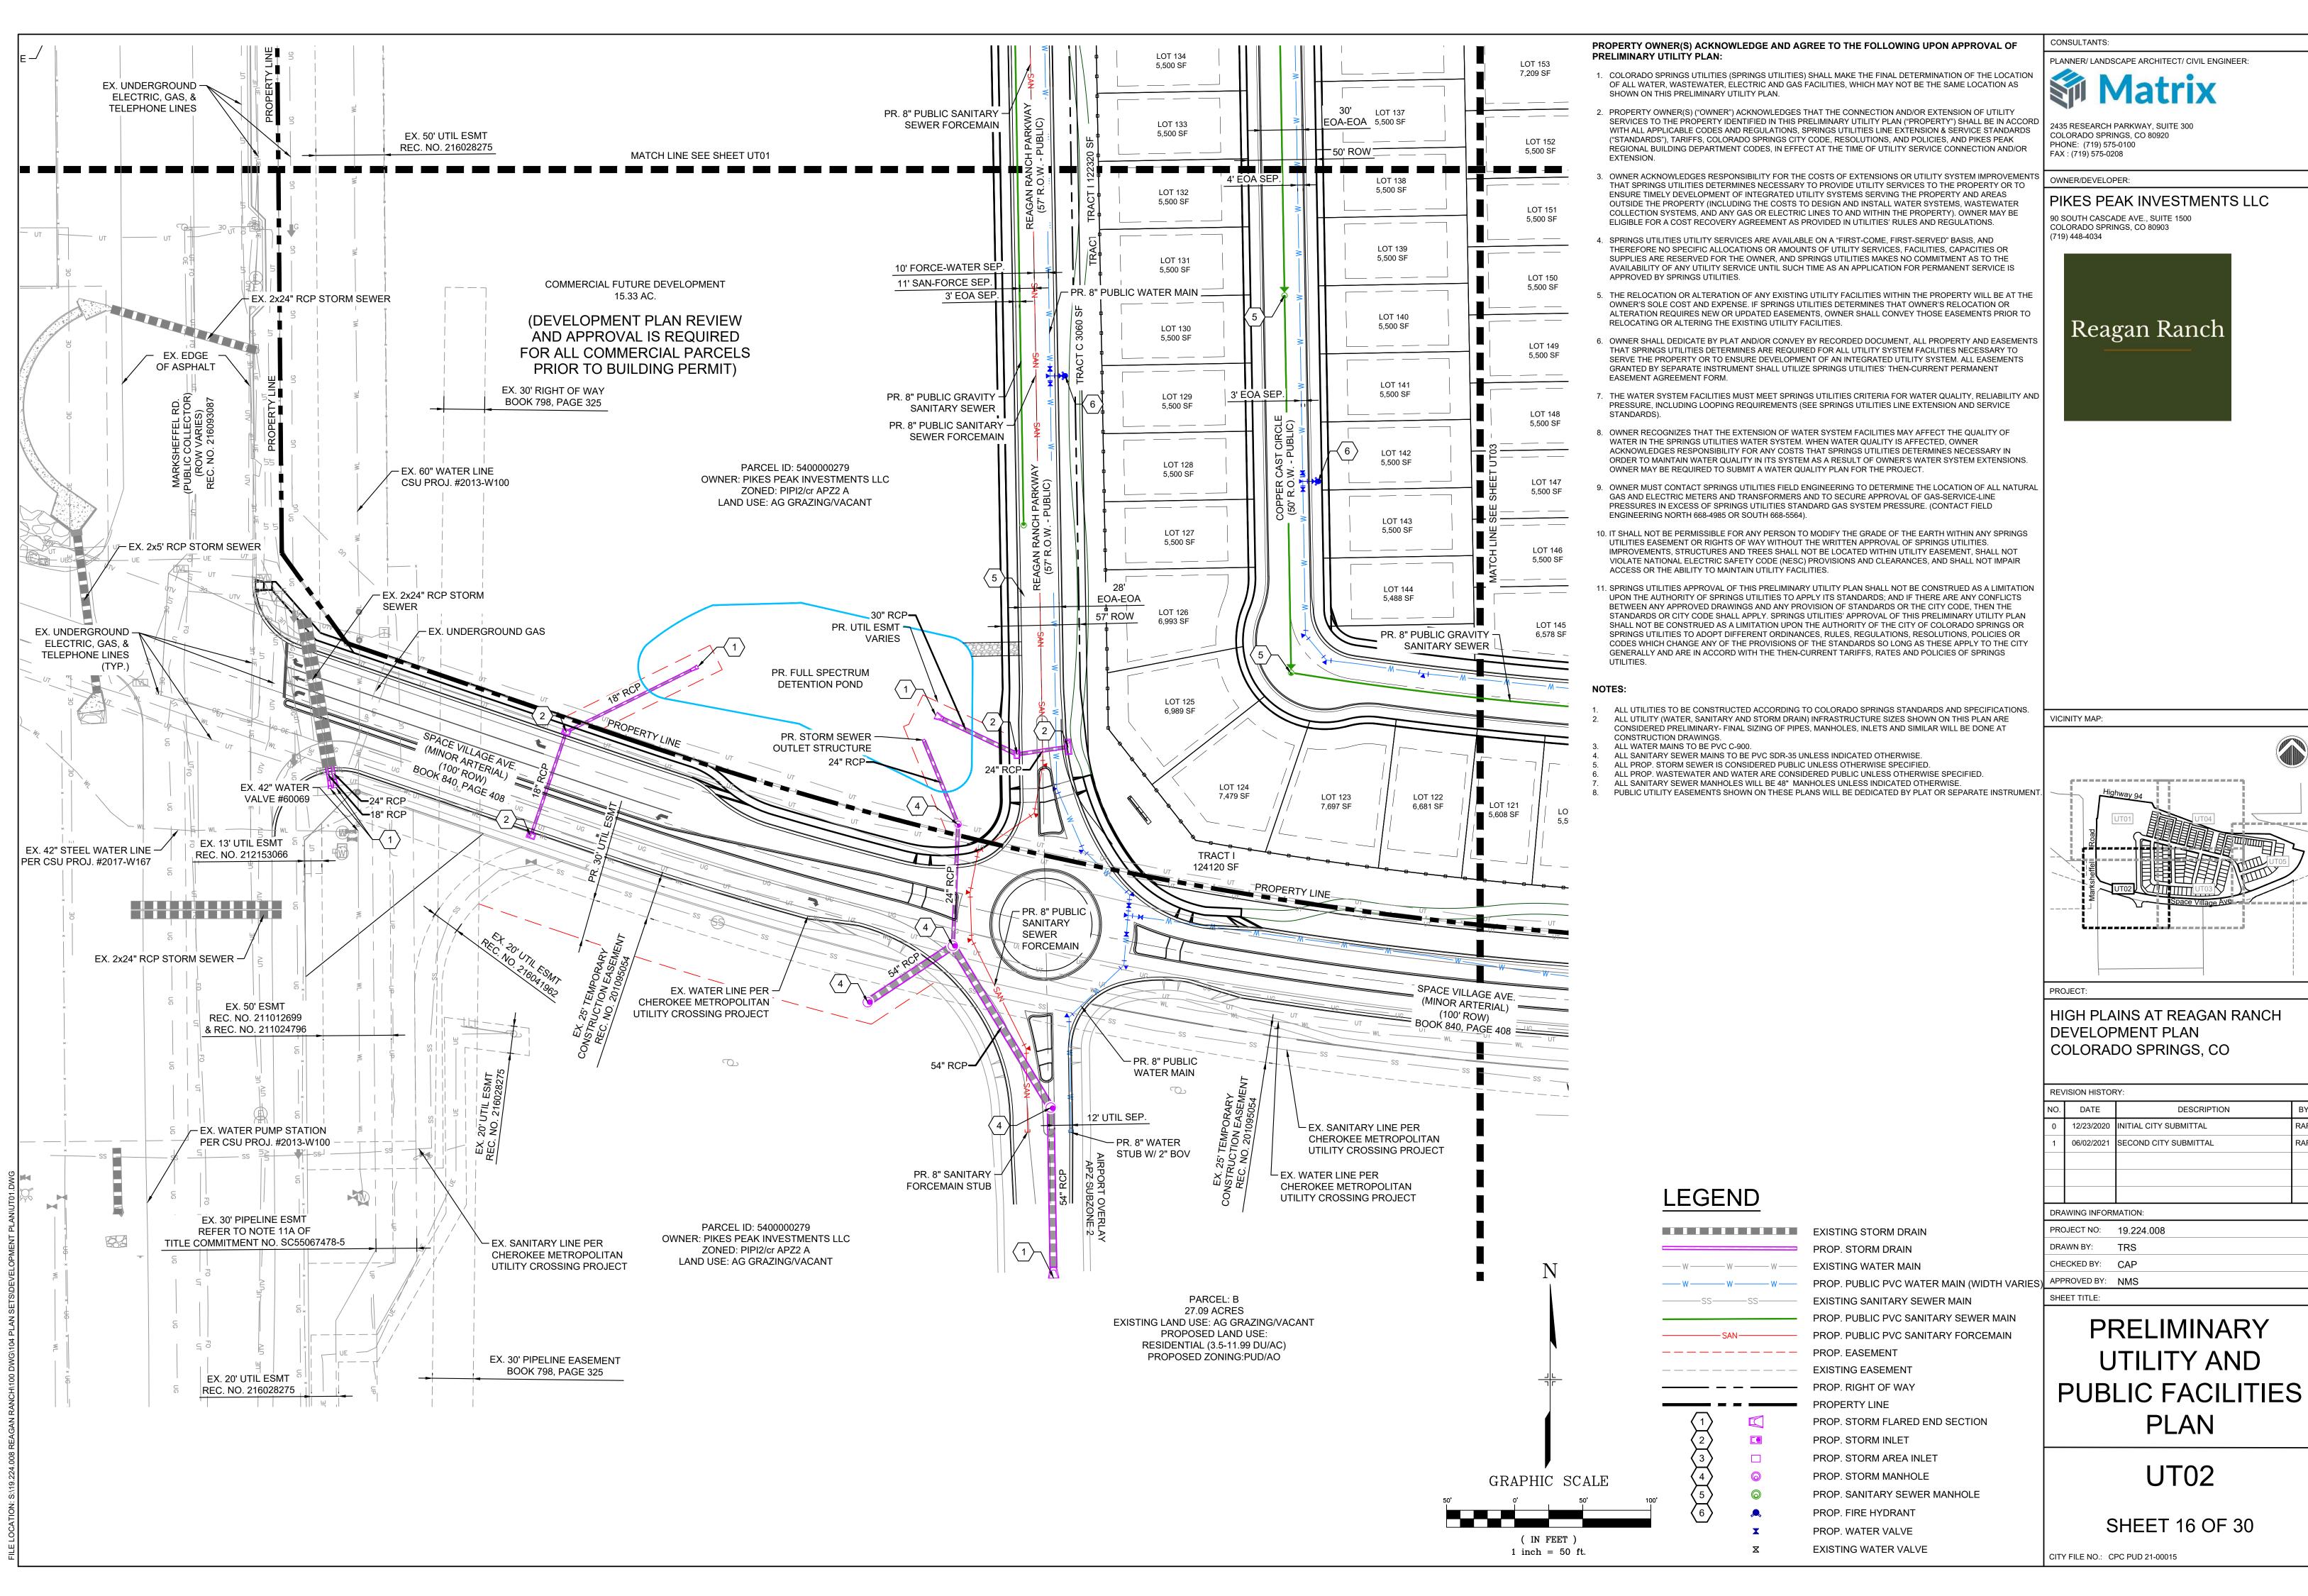

NOTES:

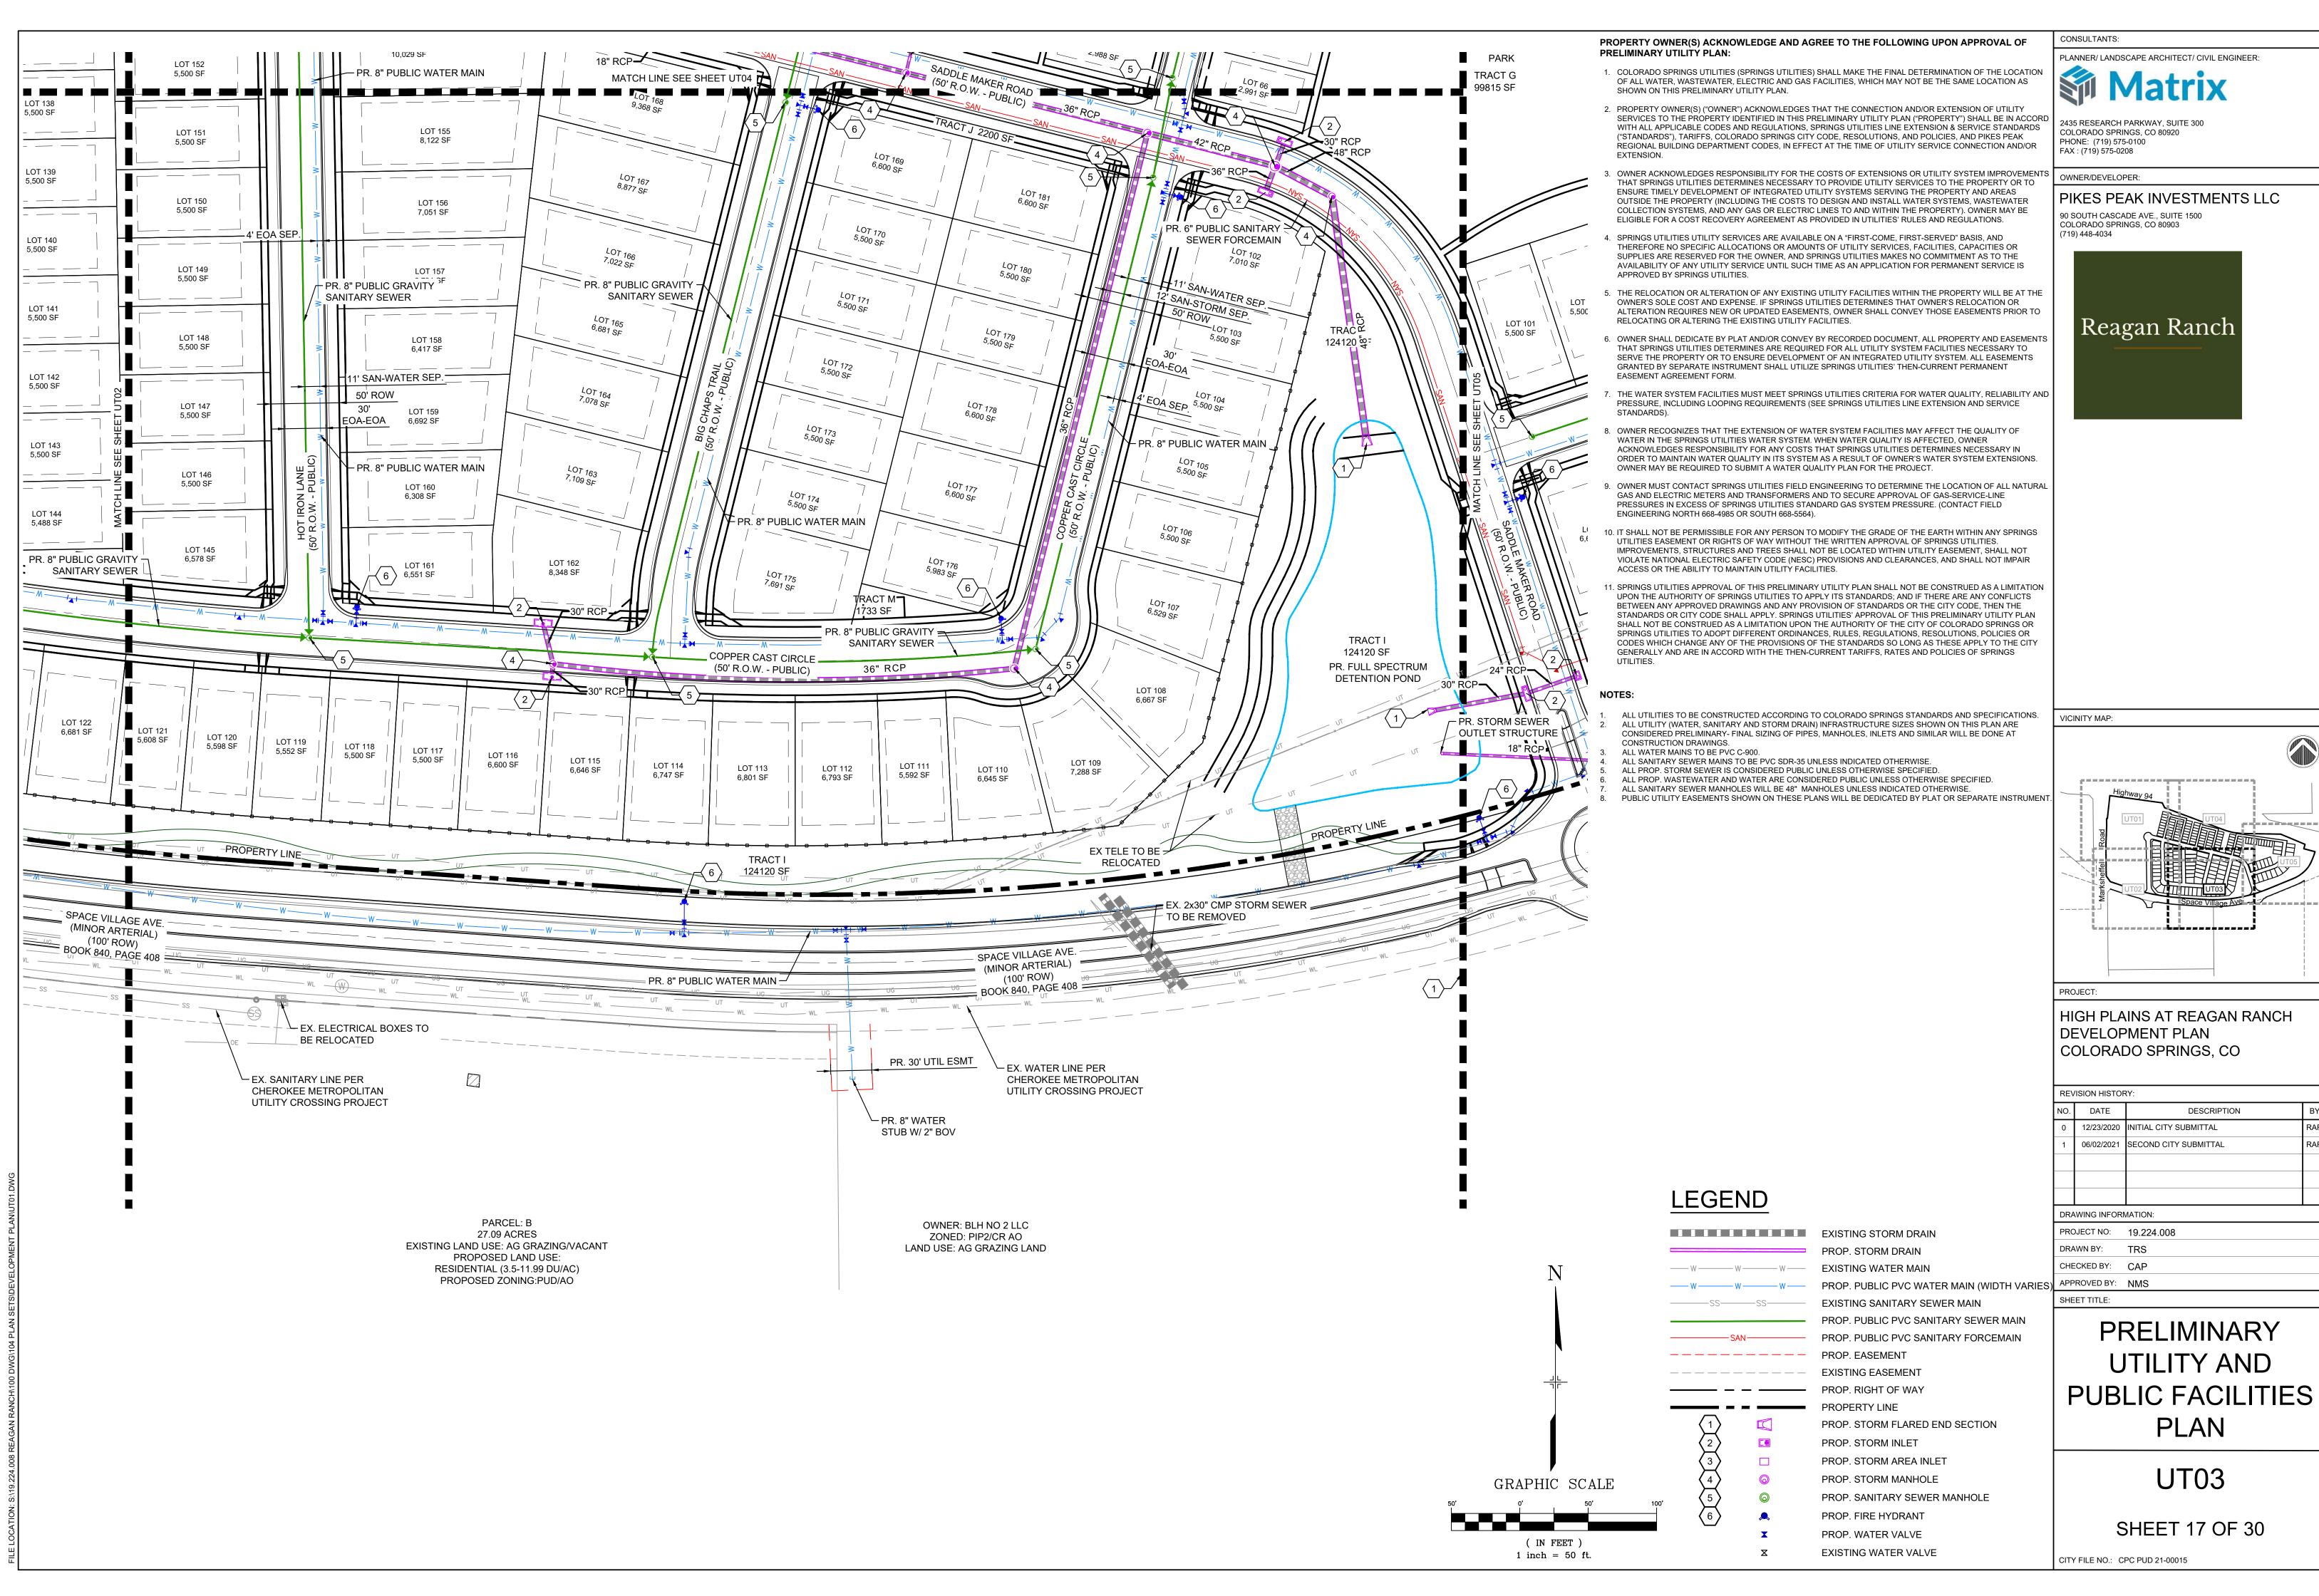- 1. APPROVED VEHICLE ACCESS FOR FIREFIGHTING SHALL BE PROVIDED TO ALL CONSTRUCTION/DEMOLITION SITES. VEHICLE ACCESS SHALL BE PROVIDED BE EITHER TEMPORARY OR PERMANENT ROADS, CAPABLE OF SUPPORTING VEHICLE LOADING UNDER ALL WEATHER CONDITIONS. VEHICLE ACCESS SHALL BE MAINTAINED UNTIL PERMANENT FIRE ACCESS ROADS ARE AVAILABLE.(2009 IFC§1410)
- 2. TEMPORARY ACCESS ROADS SHALL BE AN ALL-WEATHER SURFACE COMPRISED OF EITHER THE FIRST LIFT OF ASPHALT, OR CONCRETE/COMPACTED GRAVEL TO A THICKNESS CAPABLE OF SUPPORTING THE IMPOSED LOADS OF FIRE DEPARTMENT APPARATUS. A 20-FT MINIMUM WIDTH SHALL BE MAINTAINED UNLESS THE PERMANENT ROAD IS DESIGNED LESS THAN 20-FT, IN WHICH CASE THE TEMPORARY ROAD SHALL BE THE INTENDED WIDTH OF THE PERMANENT ROAD. ADEQUATE STREET SIGNS AND FIRE LANE SIGNS SHALL BE INSTALLED WHERE APPLICABLE. TEMPORARY ACCESS ROADS MUST BE MAINTAINED IN ACCORD WITH THIS SECTION AND INSPECTED BY THE FIRE DEPARTMENT. (2009 IFC §1410.1.1)
- 3. FIRE DEPARTMENT ACCESS ROADS SHALL BE MADE SERVICEABLE PRIOR TO AND DURING THE TIME OF CONSTRUCTION EXCEPT WHEN APPROVED ALTERNATIVE METHODS OF PROTECTION ARE PROVIDED. (2009 IFC §501.4)
- 4. AN APPROVED WATER SUPPLY FOR FIRE PROTECTION, EITHER TEMPORARY OR PERMANENT, SHALL BE MADE AVAILABLE AS SOON AS COMBUSTIBLE MATERIAL ARRIVES ON THE SITE (2018 CSFC §3312.1)
- 5. REQUIRED ACCESS DURING CONSTRUCTION. APPROVED VEHICLE ACCESS FOR FIRE FIGHTING SHALL BE PROVIDED TO ALL CONSTRUCTION OR DEMOLITION SITES. VEHICLE ACCESS SHALL BE PROVIDED TO WITHIN 100 FEET OF TEMPORARY OR PERMANENT FIRE DEPARTMENT CONNECTIONS. VEHICLE ACCESS SHALL BE PROVIDED BY EITHER TEMPORARY OR PERMANENT ROADS, CAPABLE OF SUPPORTING VEHICLE LOADING UNDER ALL WEATHER CONDITIONS. VEHICLE ACCESS SHALL BE MAINTAINED UNTIL PERMANENT FIRE APPARATUS ACCESS ROADS ARE AVAILABLE. (2018 CSFC §3310.1)
- 6. WHEN REQUIRED- WATER SUPPLY. AN APPROVED WATER SUPPLY FOR FIRE PROTECTION, EITHER TEMPORARY OR PERMANENT, SHALL BE MADE AVAILABLE AS SOON AS COMBUSTIBLE MATERIAL ARRIVES ON THE SITE. (2018 CSFC §3312.1)
- 7. AT FINAL LANDSCAPE PLAN, CLEAR ACCESS PATHS AND FINAL TREE AND SHRUB LOCATIONS WILL BE COORDINATED WITH COLORADO SPRINGS FIRE DEPARTMENT
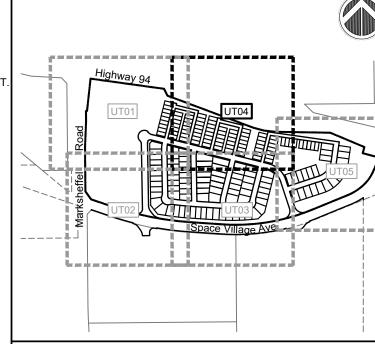
<u>LEGEND</u>

BOUNDARY LINE PROPOSED EASEMENT

> PROPOSED FIRE HYDRANT FIRE LANE WITH FIRE LANE SIGNAGE

WHEEL PATH

CSFD Apparatus Data Used Within AutoTurn

COLORADO SPRINGS

42.5' (509")

7.58' (91") 13' (166") 21' (252")

8.42' (101") Width 8.17' (98") Track 5.00 seconds Lock to Lock Time Steering Angle 44 degrees

Other Useful Apparatus Data

Other Oscial A	
Angle of Approach	Less than 8° degrees (not % percent)
Angle of Departure	Less than 8° degrees (not % percent)
Undercarriage Clearance	.66' (8")
Rear Overhang (CL of rear axle to rear bumper)	10' (120")
Wheelbase (CL of front axle to CL of forward rear axle)	20' (240")
Inside Turning Radii	33' (396")
Outside Turning Radii	53' (636")

1 inch = 60 ft.

CONSULTANTS:

PLANNER/ LANDSCAPE ARCHITECT/ CIVIL ENGINEER:

2435 RESEARCH PARKWAY, SUITE 300 COLORADO SPRINGS, CO 80920 PHONE: (719) 575-0100 FAX: (719) 575-0208


OWNER/DEVELOPER:

PIKES PEAK INVESTMENTS LLC

90 SOUTH CASCADE AVE., SUITE 1500 COLORADO SPRINGS, CO 80903



VICINITY MAP:

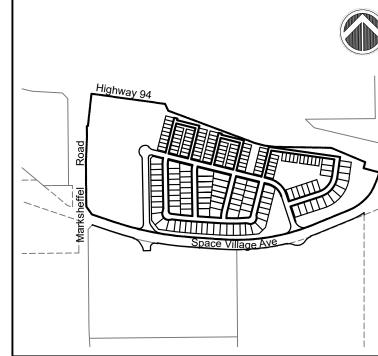

HIGH PLAINS AT REAGAN RANCH DEVELOPMENT PLAN COLORADO SPRINGS, CO


NO.	DATE	DESCRIPTION	BY
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DRA	WING INFORM	MATION:	
PROJECT NO:		19.224.008	
DRAWN BY:		RAF	
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APP	ROVED BY:	JRA	
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FIRE ACCESS PLAN


FA01

SHEET 20 OF 30



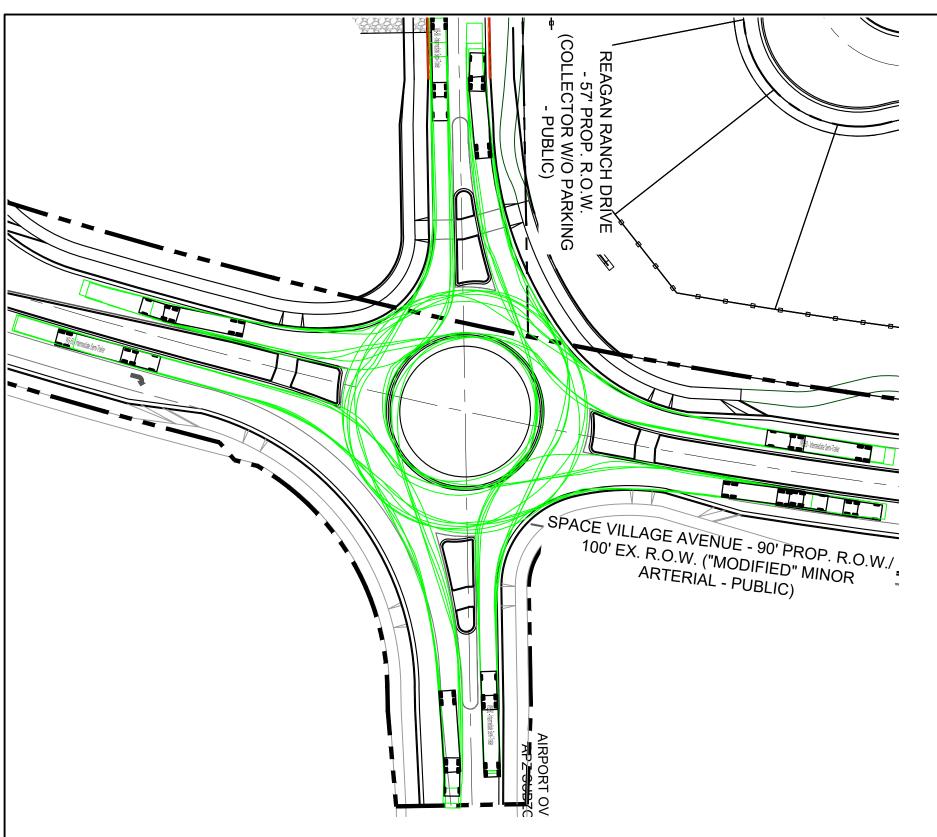

REAGAN RANCH DRIVE & SPACE VILLAGE AVENUE WB-50 VEHICLE PATHS

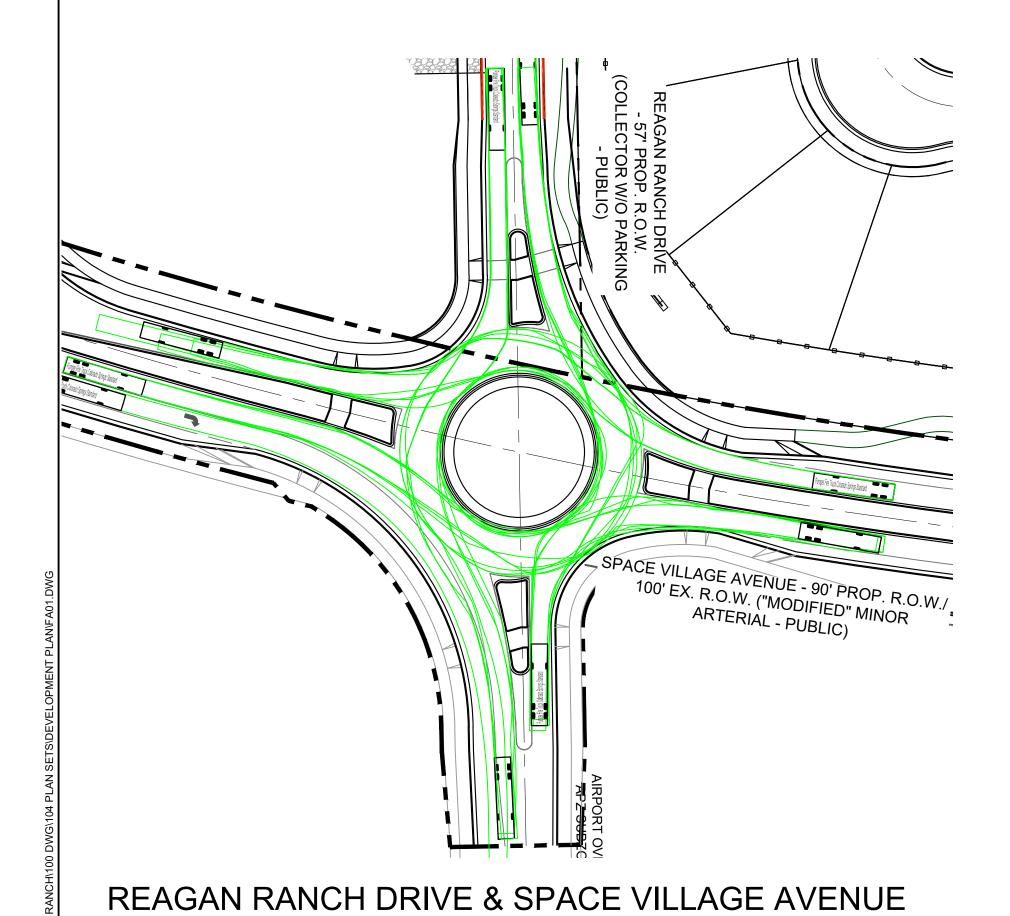

FIRE TRUCK VEHICLE PATHS


SOUTH MANAGER ROLL
SOUTH MANAGER ROLL
SOUTH MANAGER ROLL
SPACE VILLAGE AVERUE
SPACE VILLAGE AVERUE
SPACE VILLAGE AVERUE

SPACE VILLAGE AVERUE


SPACE VILLAGE AVERUE

ARTERIAL - PUBLIC


SADDLE MAKER ROAD & SPACE VILLAGE AVENUE WB-50 VEHICLE PATHS

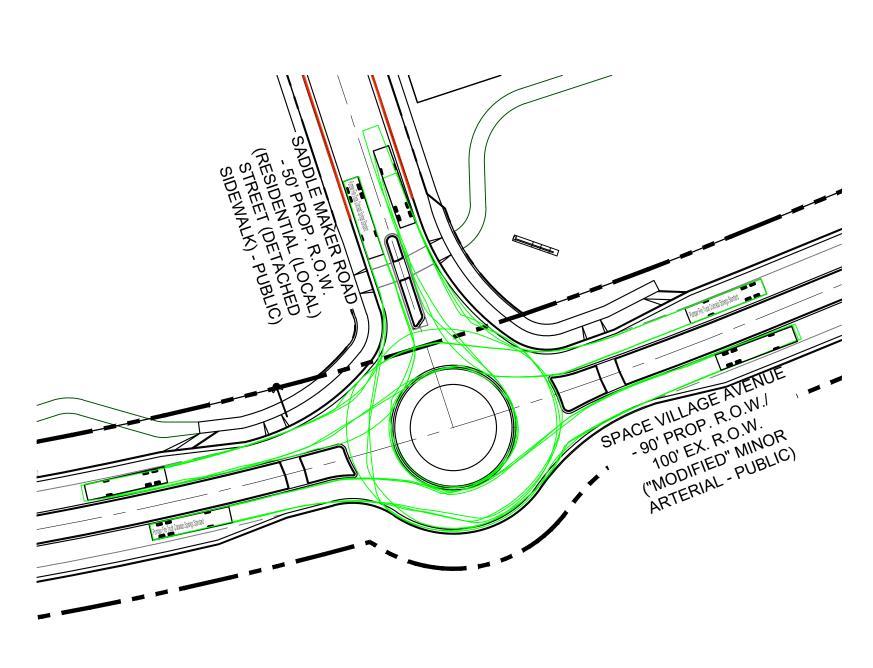

SADDLE MAKER ROAD & SPACE VILLAGE AVENUE FIRE TRUCK VEHICLE PATHS

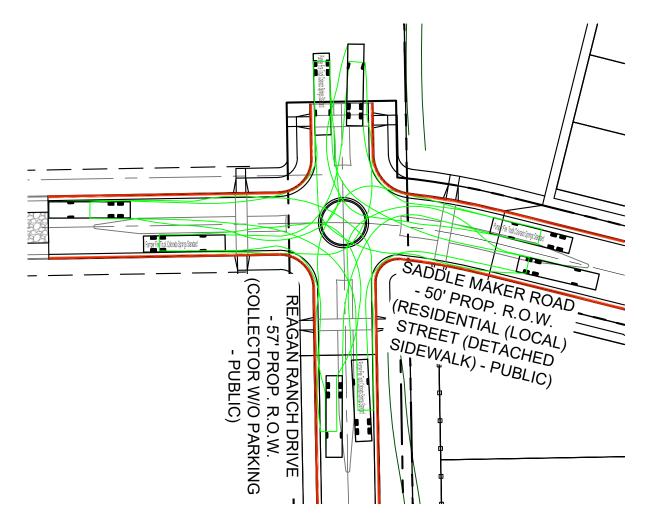

REAGAN RANCH DRIVE & SADDLE MAKER ROAD FIRE TRUCK VEHICLE PATHS

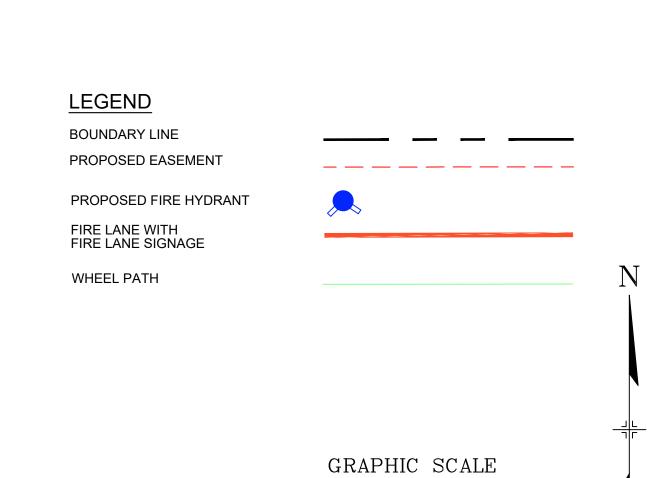

1 inch = 50 ft.




OWNER/DEVELOPER:

PIKES PEAK INVESTMENTS LLC

90 SOUTH CASCADE AVE., SUITE 1500
COLORADO SPRINGS, CO 80903



VICINITY MAP:

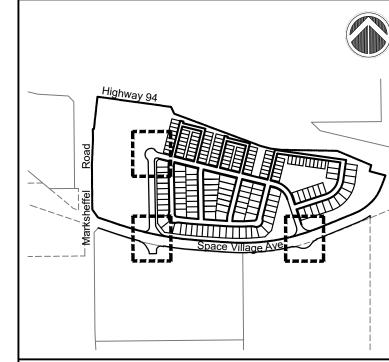

JECT:

HIGH PLAINS AT REAGAN RANCH DEVELOPMENT PLAN COLORADO SPRINGS, CO

REV	ISION HISTOR	RY:	
NO.	DATE	DESCRIPTION	BY
0	12/23/2020	INITIAL CITY SUBMITTAL	RAF
1	06/02/2021	SECOND CITY SUBMITTAL	RAF
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PRC	DJECT NO:	19.224.008	
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CHE	CKED BY:	JRA	
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FIRE ACCESS PLAN

FA02


SHEET 21 OF 30

LANDSCAPE LEGEND:

SYMBOL	QUANTITY	DESCRIPTION
SOD	141,711 SF	SOD; TO BE 3-WAY BLUEGRASS BLEND OR APPROVED EQUAL. SUBMIT CUT SHEET FOR REVIEW AND APPROVAL PRIOR TO INSTALLATION.
NATIVE SEED A	113,143 SF	EL PASO COUNTY ALL PURPOSE LOW GROW MIX
NATIVE SEED B	166,399 SF	IRRIGATED NATIVE SEED TO BE DETERMINED
POND MIX	62,354 SF	EL PASO COUNTY CONSERVATION DISTRICT ALL PURPOSE MIX
COBBLE A	124,090 SF	3/4" TBD COBBLE, 3" DEPTH OVER WEED BARRIER FABRIC
COBBLE B	X SF	1" - 3" TBD COBBLE, 3" DEPTH OVER WEED BARRIER FABRIC
COBBLE C	X SF	4"- 6" TBD COBBLE, 3" DEPTH OVER WEED BARRIER FABRIC
WOOD MULCH	X SF	WOOD MULCH
		STEEL LANDSCAPE EDGER: TO BE INSTALLED BETWEEN ALL SEED OR SOD AREAS AND PLANTING BEDS; TO BE DURAEDGE 1/4" THICK X 5" WIDE ROLLED TOP STEEL EDGE. COLOR TO BE 'BLACK'. INSTALL PER MANUFACTURER'S SPECIFICATIONS.
		BOULDER: INSTALL PER DETAIL SHEET APPROX. SIZES: 1/3 TO BE 2'X3' 1/3 TO BE 3'X4' 1/3 TO BE 3.5'X5'

HIGH PLAINS AT REAGAN RANCH

COLORADO SPRINGS, CO PRELIMINARY LANDSCAPE PLAN

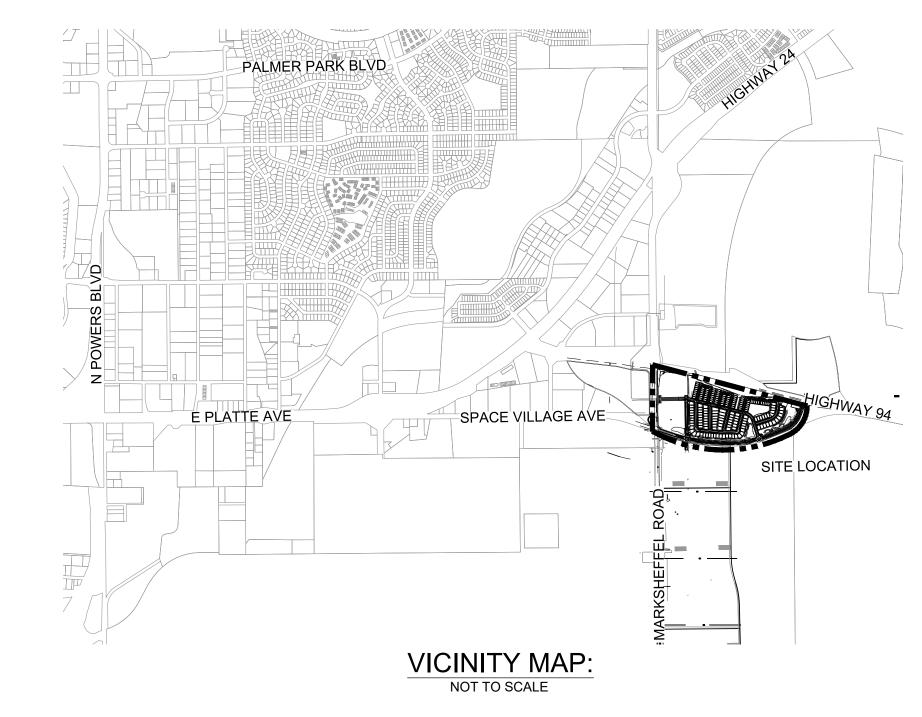

SHEET INDEX:

LS.01	COVER SHEET
LS.02	LANDSCAPE PLAN
LS.03	LANDSCAPE PLAN & PLANT SCHEDULE
LS.04 - LS.08	LANDSCAPE PLAN
LS.09	LANDSCAPE NOTES & LANDSCAPE DETAILS

Schematic Landscape Diagram Climate Zone (From Figure 4 of Landscape Policy Manual) - Circle One: Plains Foothills & Plains Foothills **Plant Communities** -to be labeled by number(s) on diagram: 1 - Semiarid Shrublands 2 - Pinon-juniper woodlands 3 - Prairie4 - Lower Elevation Riparian **5** - Foothill Shrublands 6 - Ponderosa Pine Forest 7 - Upper Elevation Riparian 8 - Douglas-fir Forest **Hydrozones (supplemental** water) -to be labeled by letter(s) on diagram: V - Very Low (0 to 7 inches per year) L - Low (7 to 15 inches per year) M - Moderate (15 to 25 inches per year) H - High (more than 25 inches per year)

SMALL LOT PUD GUIDELINES:

COMMON OPEN SPACE (SEE PG 14-15):

#OF UNITS:	600 SF PER UNIT REQ./ PROV.	1 TREE PER 500 SF REQ./ PROV.:	
80	48,000 SF/ 163,071 SF	96/ 83	
SHRUB SUBSTITUTES REQ. / PROV.: (10 = 1 TREE)	ORNAMENTAL GRASS SUBSTITUTES REQ./ PROV.	COMMON OPEN SPACE PLANT ABBR. ON PLAN	
130/ 130	X/ X	СО	

LANDSCAPE SITE REQUIREMENTS

FIRE HYDRANT, TYP; REF. CIVIL

UTILITY EASEMENT, TYP; REF. CIVIL

LANDSCAPE BUFFER / SETBACK LINE

CONCRETE SIDEWALK; REF. CIVIL

LANDSCAPE SETBACKS: (SEE CODE SECTION 320 & 317):

STREET NAME OR ZONE BOUNDARY:	STREET CLASSIFICATION:	SETBACK DEPTH REQUIRED/PROVIDED:	LINEAR FOOTAGE:	TREE/FEET REQUIRED:	NO. OF TREES REQ./ PROV.:
HWY. 94 * (*SEE REQUEST FOR ADMIN. RELIEF)	EXPRESSWAY	25'/ 10'	2,355.43	1/ 20	118/ 118
SPACE VILLAGE AVE.	MINOR ARTERIAL	20'/ 20'	2,361.82	1/ 25	94/ 95
SHRUB SUBSTITUTES REQ. /PROV.:	ORNAMENTAL GRASS SUBSTITUTES REQ./PR	SETBACK PLANT OV. ABBR. ON PLAN		ENT GROUND P EG. REQ/ PROV	
0 / 75	0 / 50	HW		75%/ 75%	
0 / 50	0 / 360	SV		75%/ 75%	

LANDSCAPE BUFFERS AND SCREENS: (SEE CODE SECTION 323 & 317):

STREET NAME OR PROPERTY LINE:	BUFFER DEPTH REQUIRED/PROVIDED:	LINEAR FOOTAGE:	BUFFER TREES (1/20') REQ./ PROV.:	EVERGREEN TREES 50% REQ./ PROV.:
REAGAN RANCH PARKWA' (WEST BOUNDARY)	Y 15' / 15'	1,129.61'	57/ 57	29/ 29
LENGTH OF 6' OPAQUE SCREEN REQ./ PROV.:	BUFFER TREE ABBR. ON PLAN		GROUND PLANE REQ/ PROV.:	
1,179.61'/ 0 * (*SEE REQUEST FOR ADMIN	WB I. RELIEF)	75	%/ 75%	

NET SITE AREA:	PERCENT MIN.	INTERNAL AREA (SF)	INTERNAL TREES (1/500 SF)
	INTERNAL AREA:	REQ./ PROV.:	REQ./ PROV.:
NA	NA	NA	NA
SHRUB SUBSTITUTES	ORNAMENTAL GRASS	INTERNAL PLANT	PERCENT GROUND PLANE
REQ. /PROV.:	SUBSTITUTES REQ./PRO\	/. ABBR. ON PLAN	VEG. REQ/ PROV.:

MOTOR VEHICLE LOTS: (SEE CODE SECTION 321 & 317):

NO. OF VEHICLE SPACES PROVIDED:	SHADE TREES 1 PER 15 SPACES REQ./ PROV.	VEHICLE LOT FRONTAGES:		GTH OF FRONTAGE CLUDING DRIVEWAYS):	2/3 LENGTH OF FRONTAGE (FT.):
54	4	NA	NA		NA
LENGTH OF SCREEN WALL OR BERM PROV	MIN. 3' SCREENING '.: PLANTS REQ/. PROV.:	EVERGREEN PLA 50% REQ./ PROV		VEHICLE LOT PLANT ABBR. ON PLAN	PERCENT GROUND PLANE VEG. REQ/ PROV.:
NA	NA	NA		NA	NA

CONSULTANTS:

PLANNER/ LANDSCAPE ARCHITECT/ CIVIL ENGINEER:

Matrix


2435 RESEARCH PARKWAY, SUITE 3 COLORADO SPRINGS, CO 80920 PHONE: (719) 575-0100 FAX: (719) 575-0208

OWNER/DEVELOPER:

PIKES PEAK INVESTMENTS LLC
90 SOUTH CASCADE AVE., SUITE 1500
COLORADO SPRINGS, CO 80903



VICINITY MA

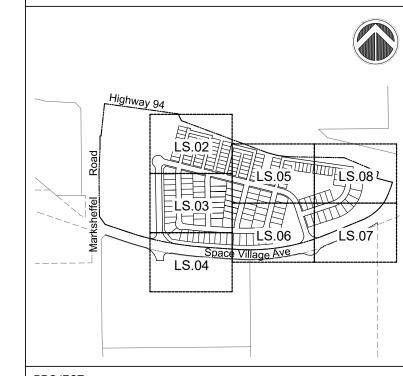

HIGH PLAINS AT REAGAN RANCH PRELIMINARY LANDSCAPE PLAN COLORADO SPRINGS. CO

COLORADO SPRINGS, CO						
DE	CEMBER 23	3, 2020				
REV	ISION HISTOR	RY:				
NO.	DATE	DESCRIPTION	BY			
l	JUNE 2021	RESPONSE TO COMMENTS FROM COS	SJC			
DRA	WING INFORI	MATION:				
PROJECT NO:		19.224.008				
DRAWN BY:		SJC				
CHECKED BY:		JA				
APPROVED BY:		JA				

TITLE SHEET

LS.01

SHEET 22 OF 30



PLANTING PLAN / SITE PLAN

SCALE: 1" = 30'


CONSULTANTS: PLANNER/ LANDSCAPE ARCHITECT/ CIVIL ENGINEER: COLORADO SPRINGS, CO 80920 PHONE: (719) 575-0100 FAX: (719) 575-0208

OWNER/DEVELOPER:

PIKES PEAK INVESTMENTS LLC 90 SOUTH CASCADE AVE., SUITE 1500 COLORADO SPRINGS, CO 80903



VICINITY MAP:

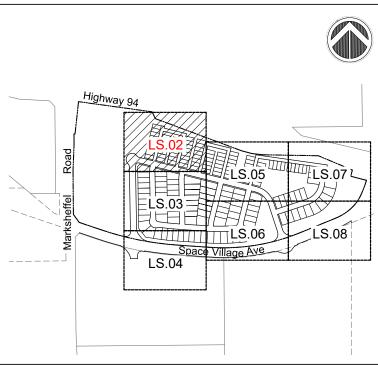

HIGH PLAINS AT REAGAN RANCH PRELIMINARY LANDSCAPE PLAN COLORADO SPRINGS, CO

DECEMBER 23, 2020

RE\	/ISION HISTO	RY:	
NO.	DATE	DESCRIPTION	BY
1	JUNE 2021	RESPONSE TO COMMENTS FROM COS	SJC
DRA	AWING INFOR	MATION:	
PRO	DJECT NO:	19.224.008	
DRAWN BY:		SJC	
CHECKED BY:		JA	
APF	PROVED BY:	JA	
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PRELIMINARY LANDSCAPE PLAN


LS.02

SHEET 23 OF 30

CITY FILE NO.: CPC PUD 21-00015

(IN FEET)

1 inch = 30 ft.

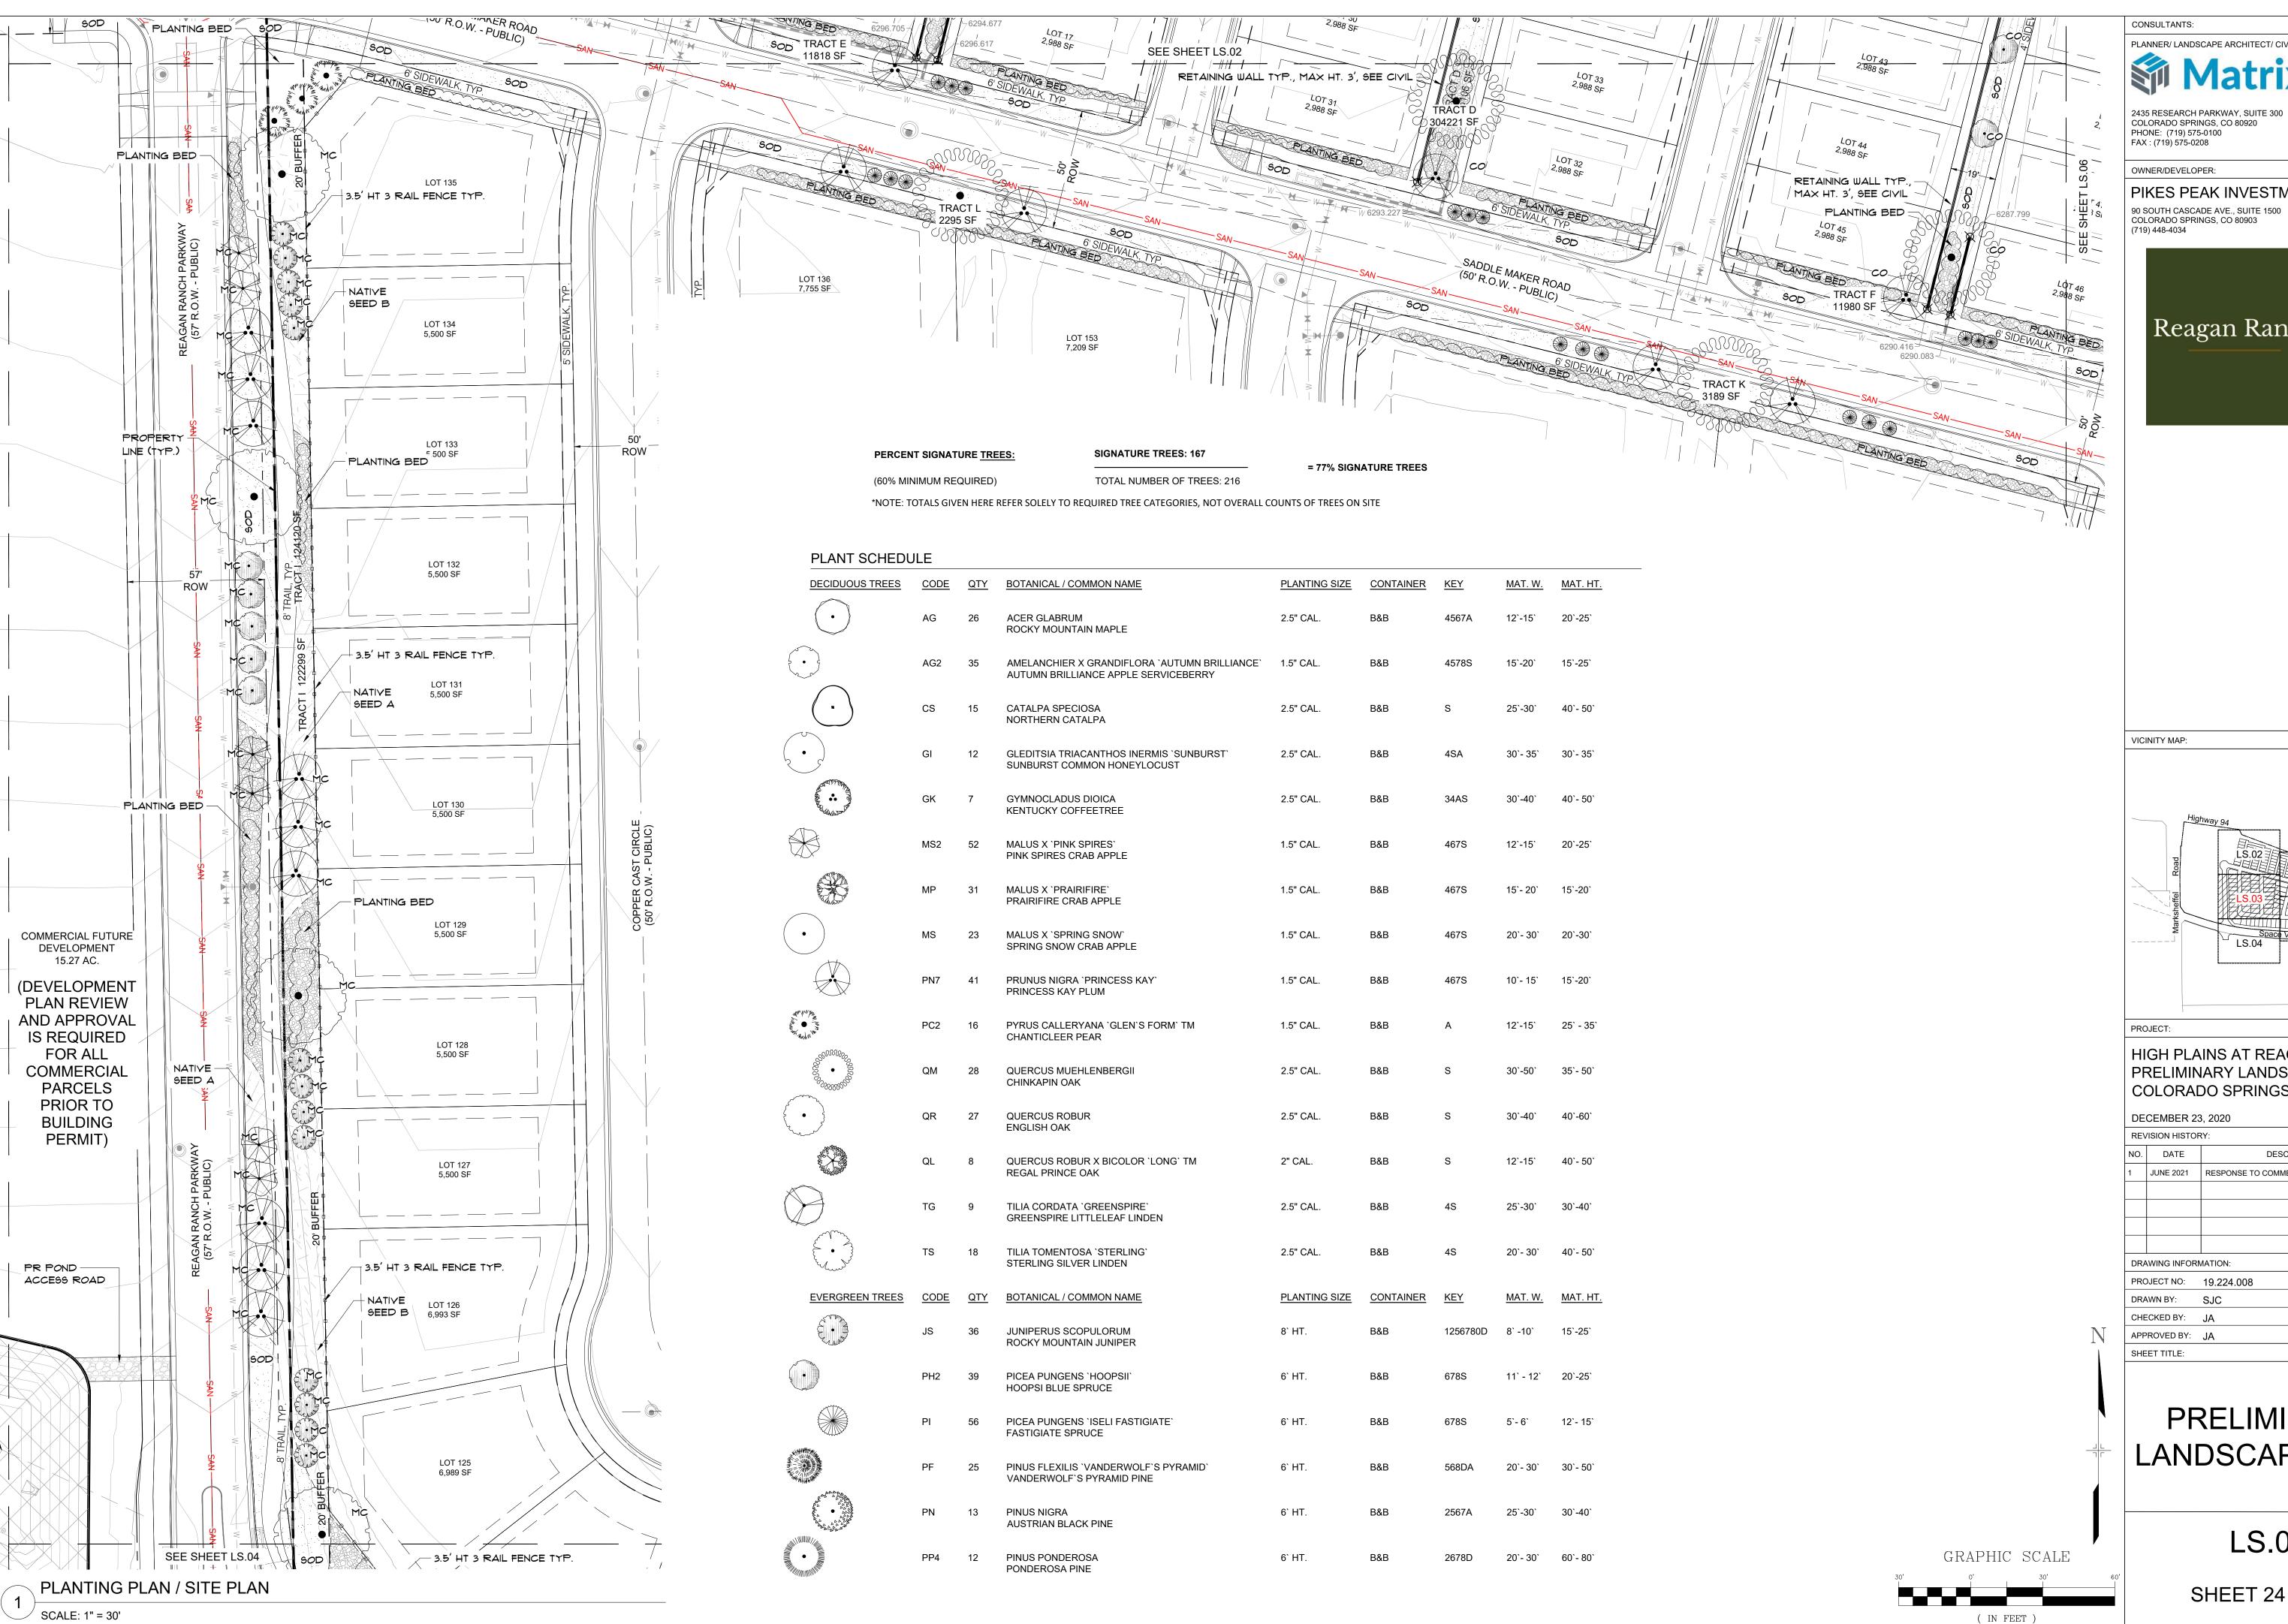


PLANNER/ LANDSCAPE ARCHITECT/ CIVIL ENGINEER:

COLORADO SPRINGS, CO 80920

PIKES PEAK INVESTMENTS LLC 90 SOUTH CASCADE AVE., SUITE 1500



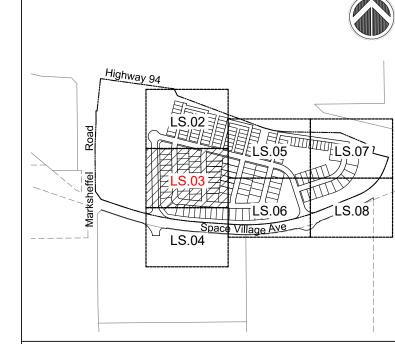

HIGH PLAINS AT REAGAN RANCH PRELIMINARY LANDSCAPE PLAN COLORADO SPRINGS, CO

ΚΕV	/ISION HISTO	XI.	
NO.	DATE	DESCRIPTION	В
1	JUNE 2021	RESPONSE TO COMMENTS FROM COS	SJ
DRA	AWING INFOR	MATION:	
PRO	DJECT NO:	19.224.008	
DRAWN BY:		SJC	
CHECKED BY:		JA	
APPROVED BY:		JA	
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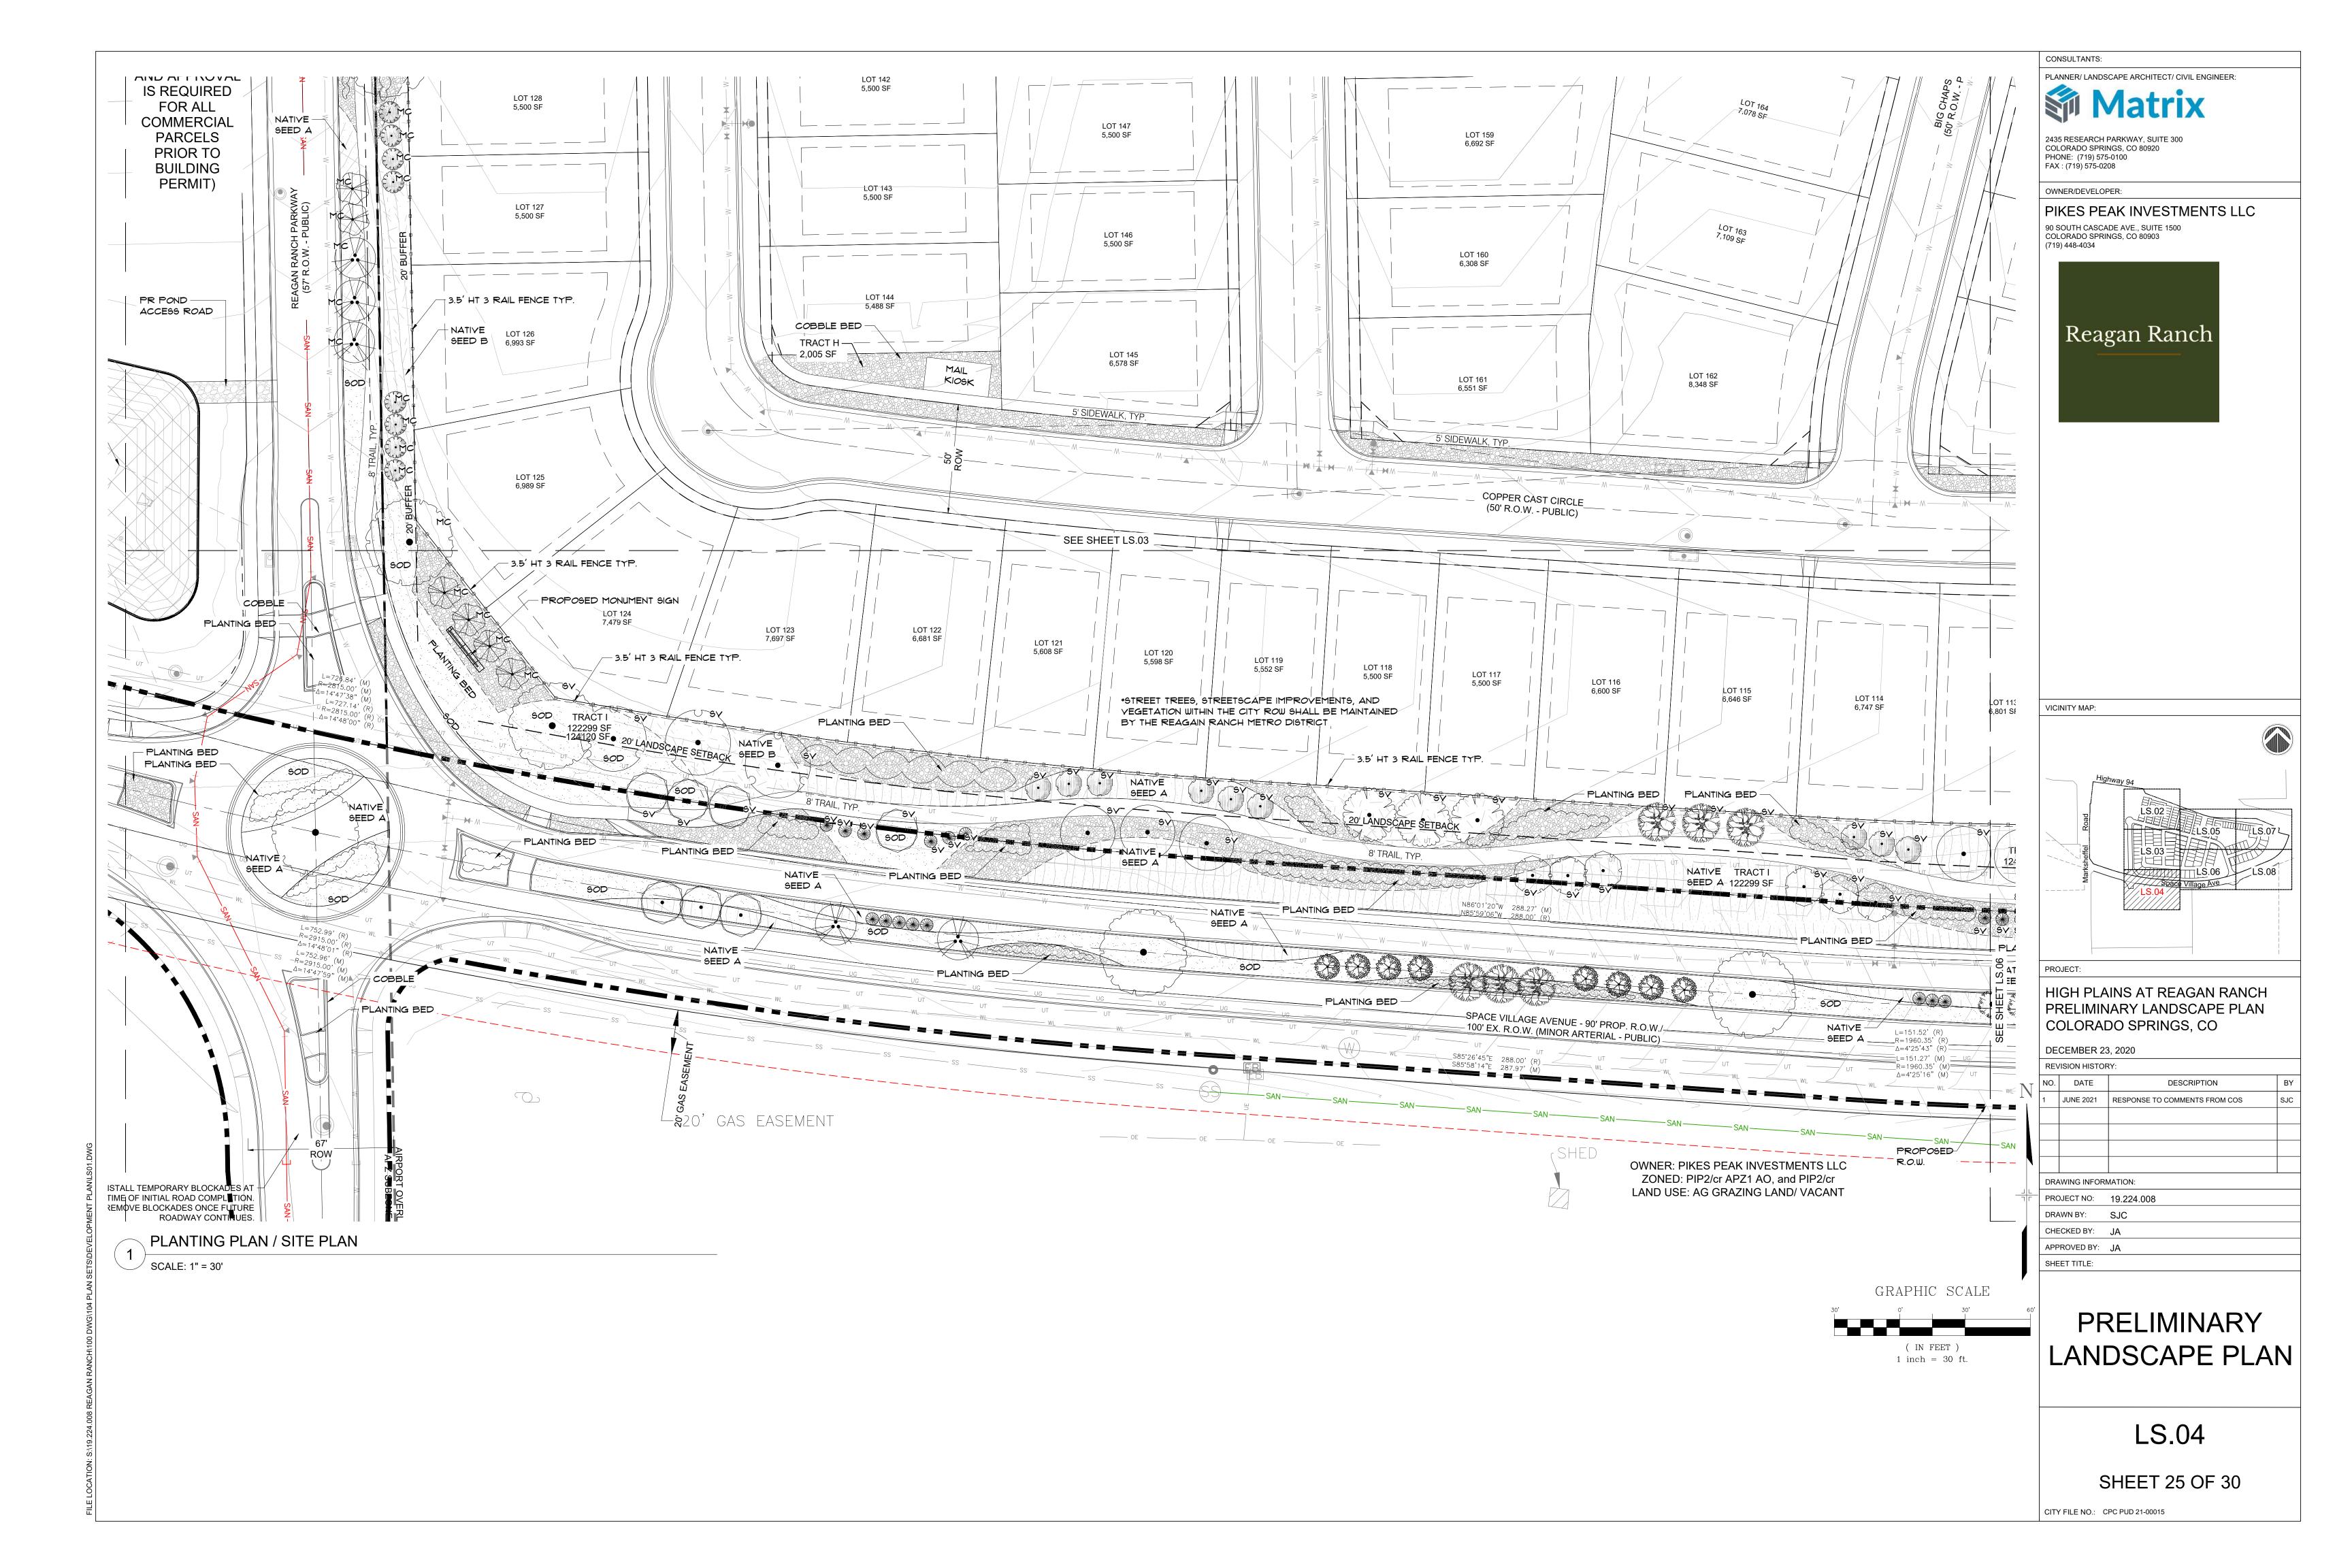
PRELIMINARY LANDSCAPE PLAN


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SHEET 24 OF 30

CITY FILE NO.: CPC PUD 21-00015

1 inch = 30 ft.



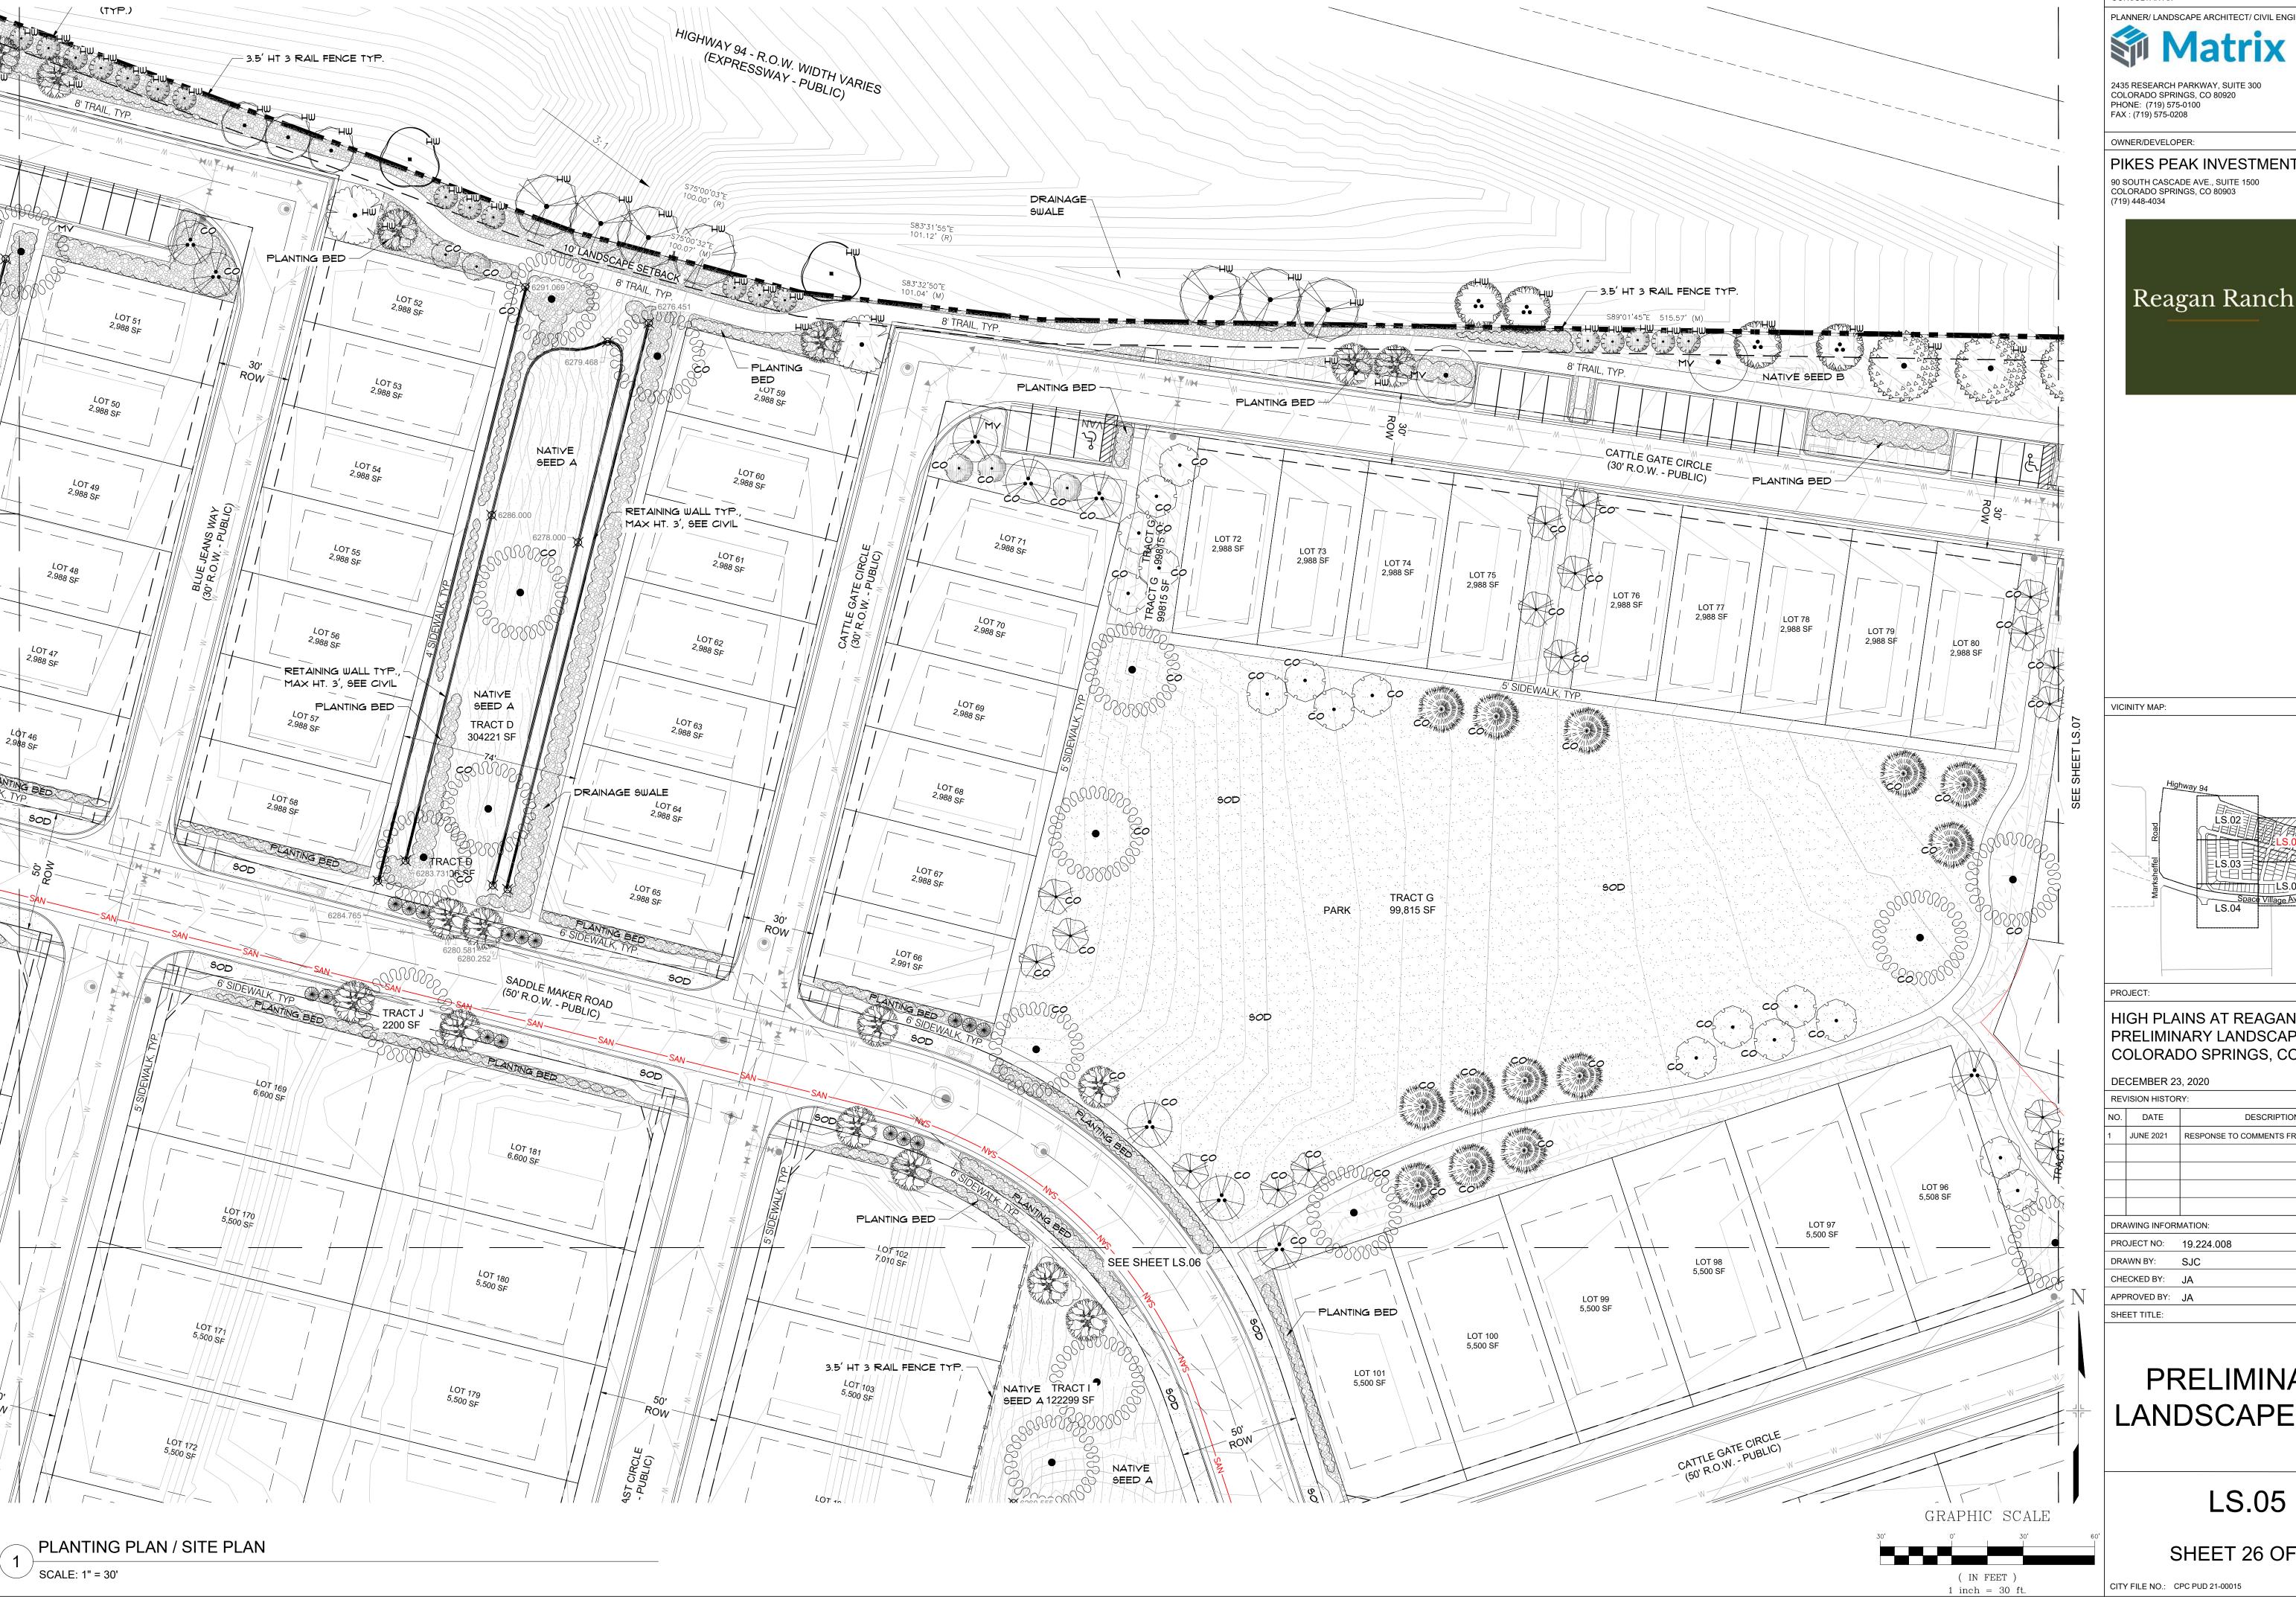

CONSULTANTS: PLANNER/ LANDSCAPE ARCHITECT/ CIVIL ENGINEER:

PIKES PEAK INVESTMENTS LLC





HIGH PLAINS AT REAGAN RANCH PRELIMINARY LANDSCAPE PLAN COLORADO SPRINGS, CO

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1	JUNE 2021	RESPONSE TO COMMENTS FROM COS	SJC
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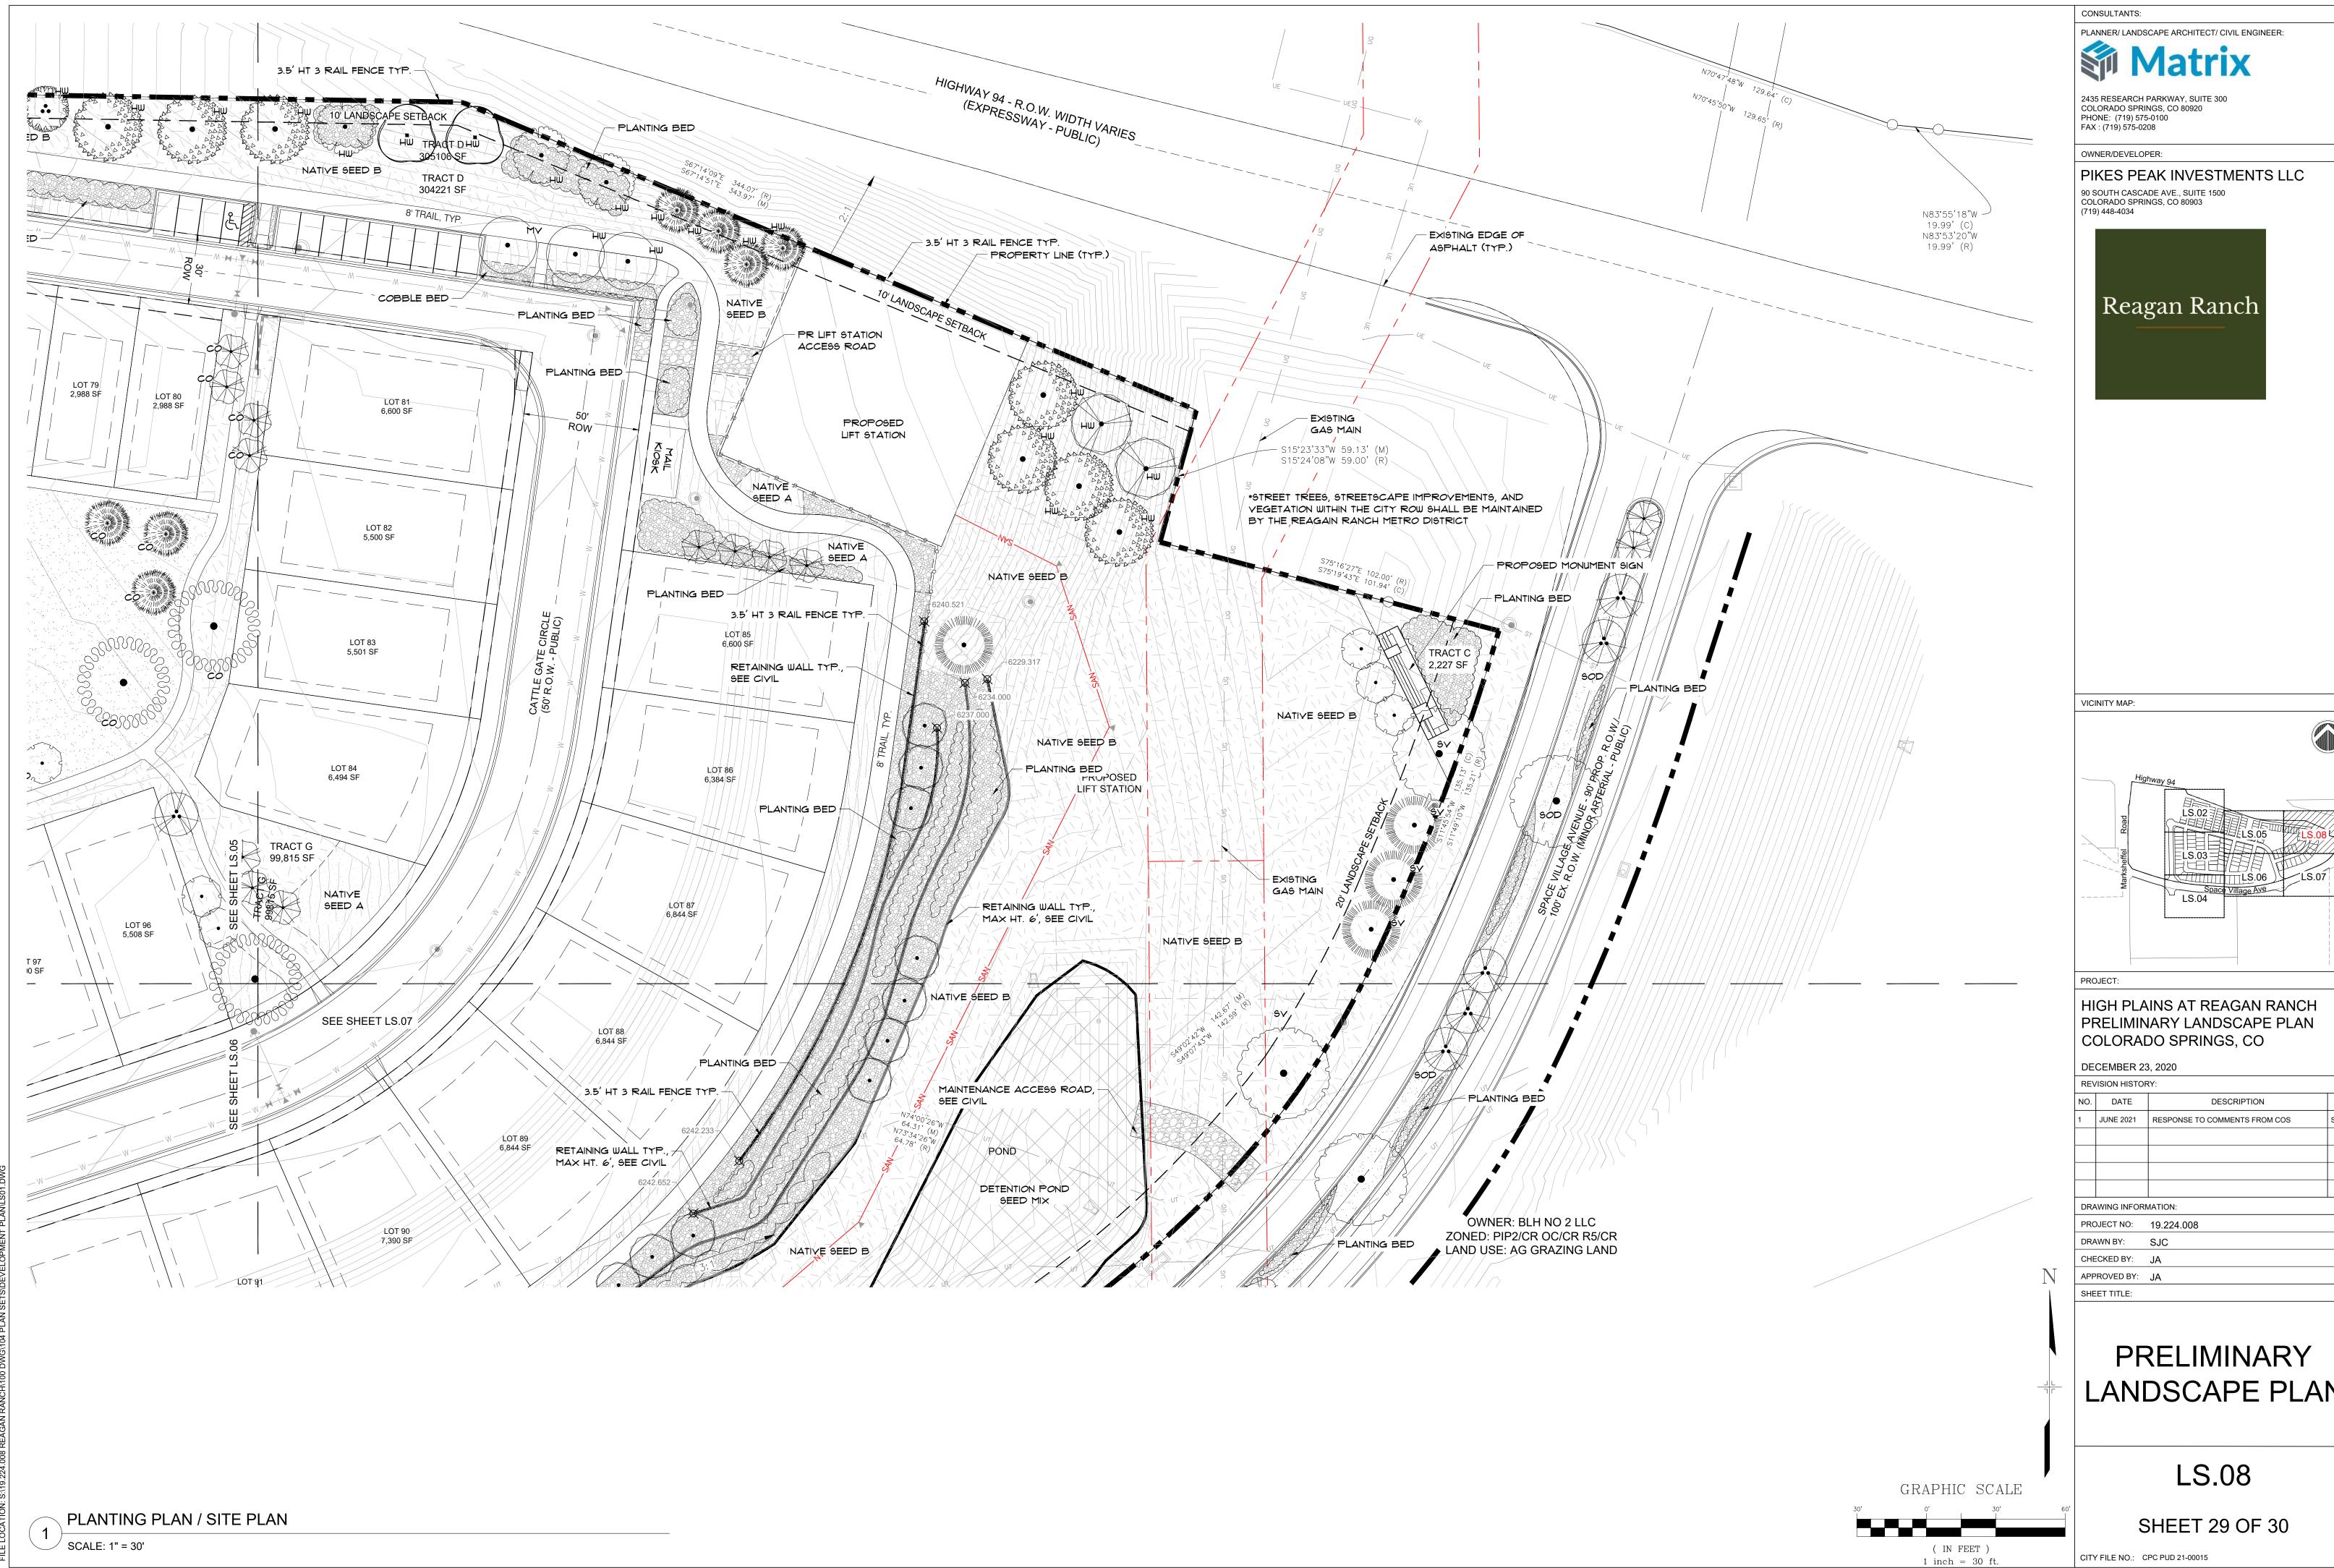
PRELIMINARY LANDSCAPE PLAN


SHEET 26 OF 30



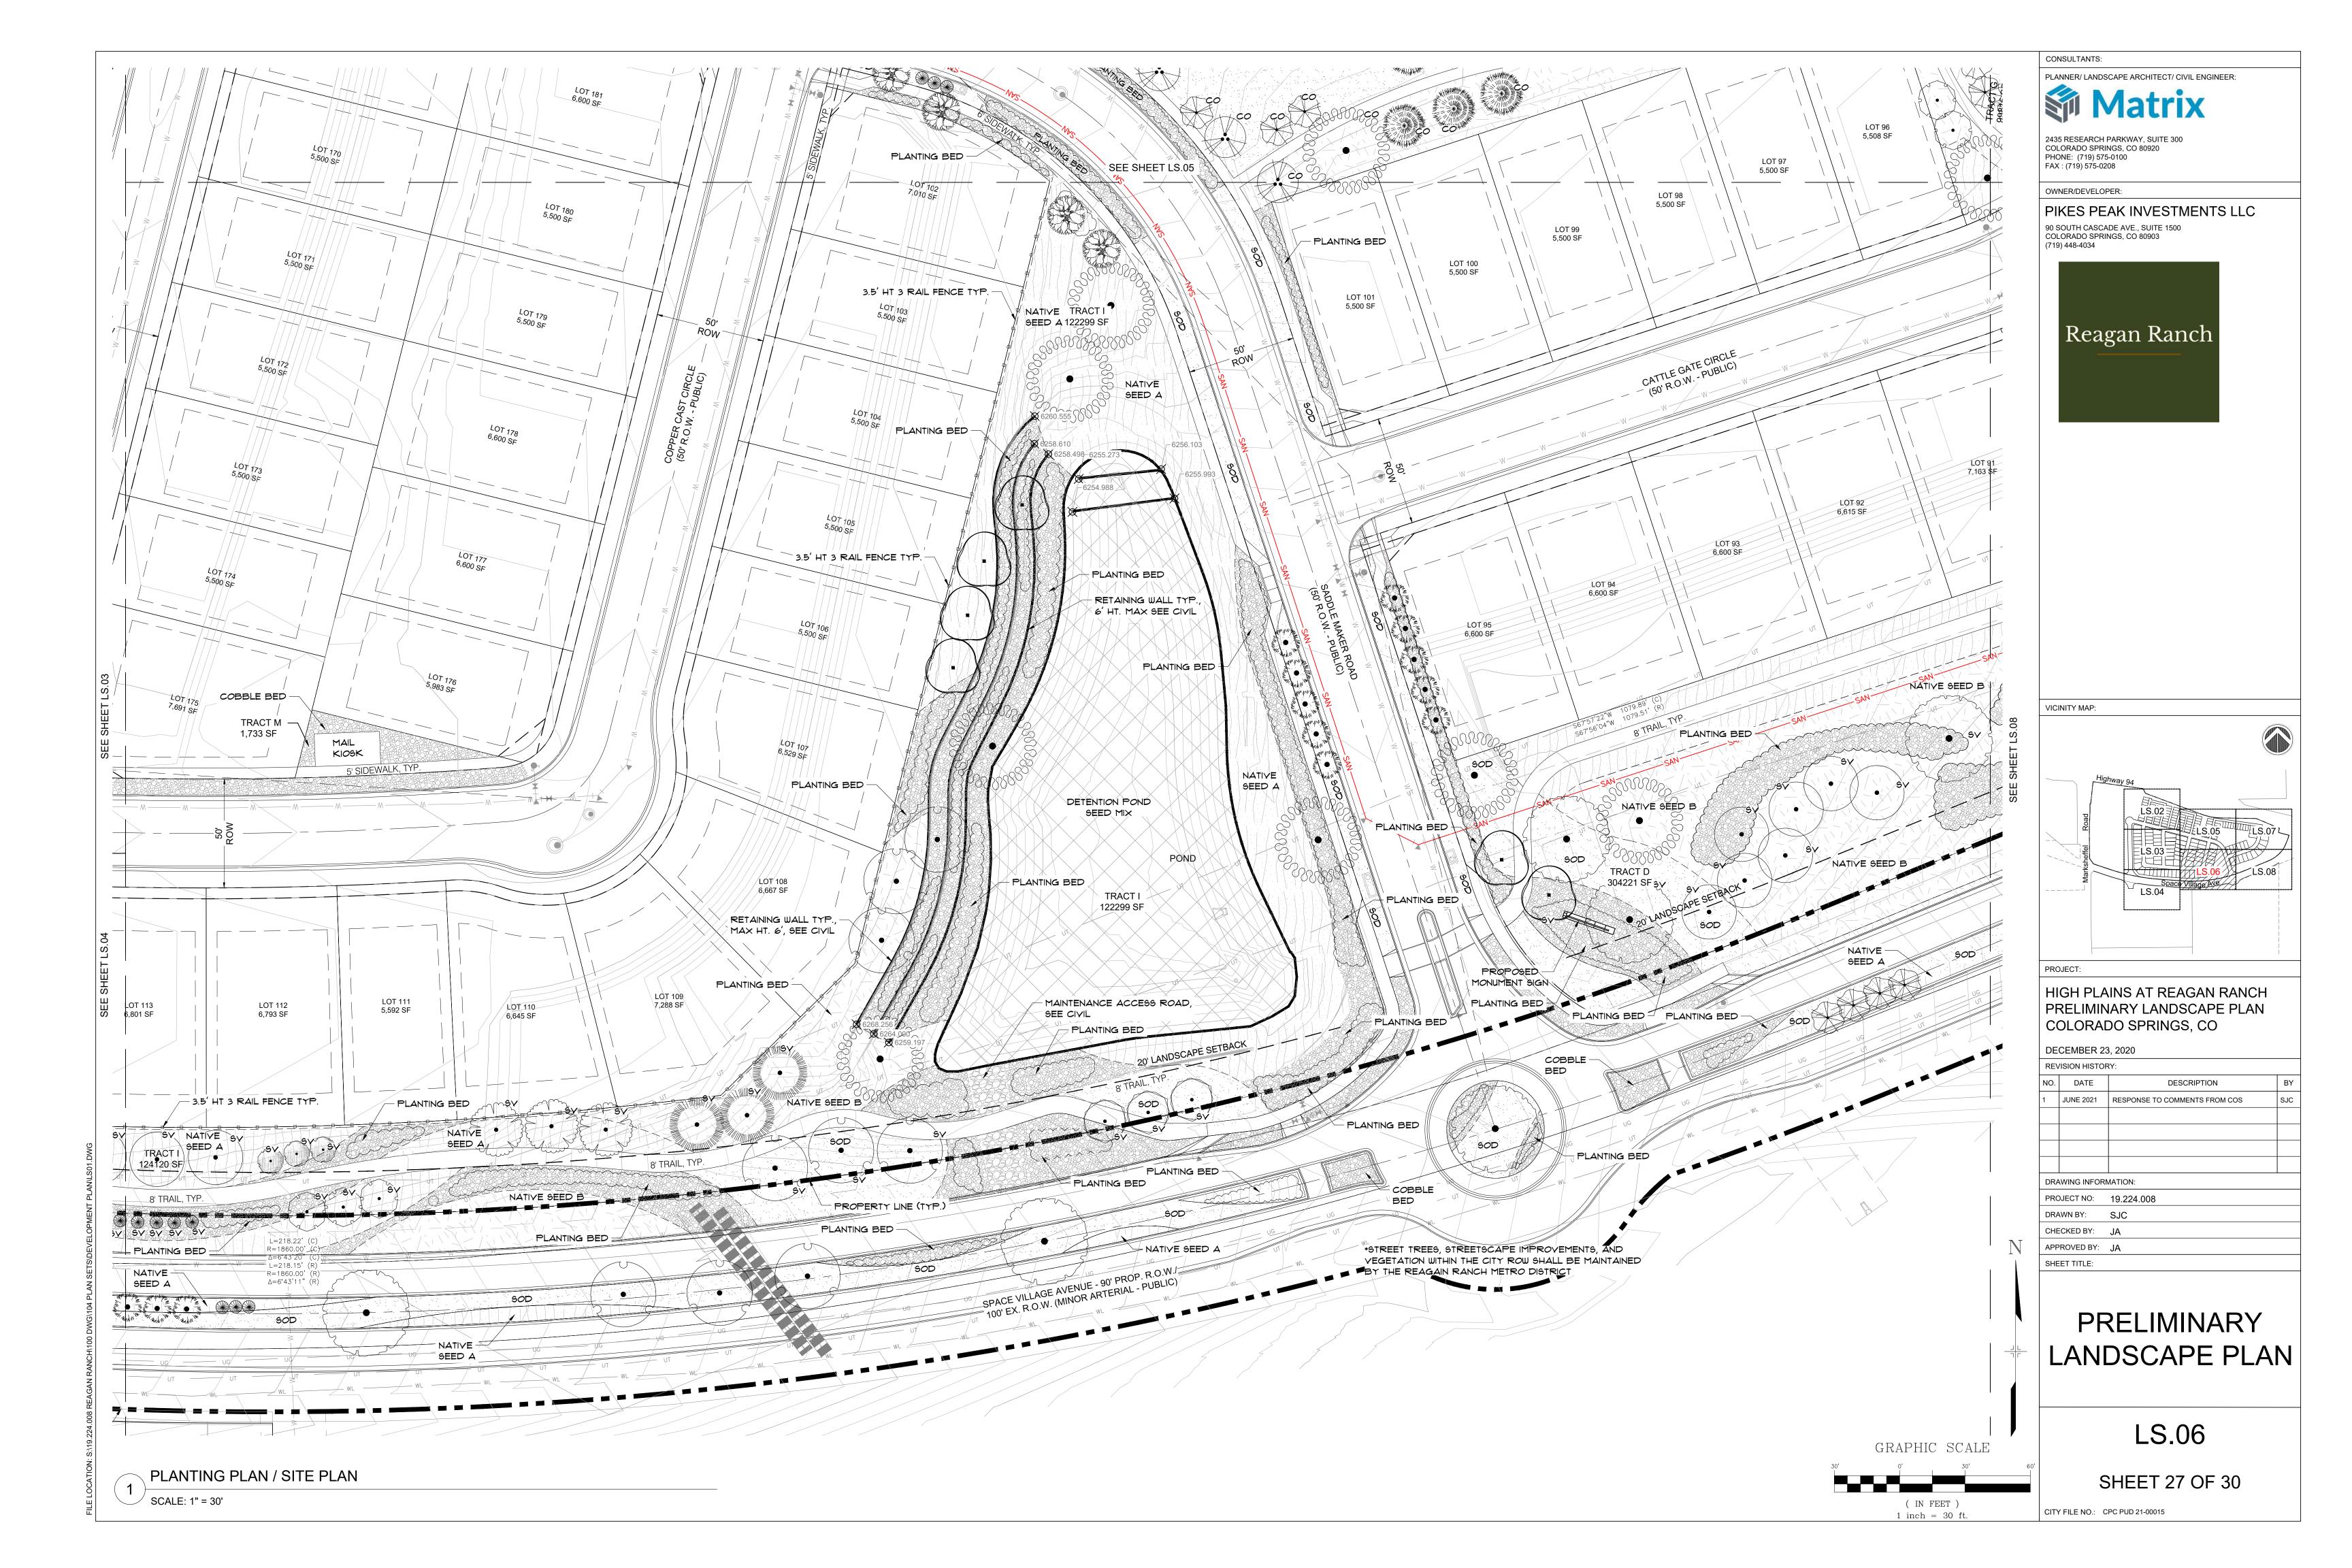
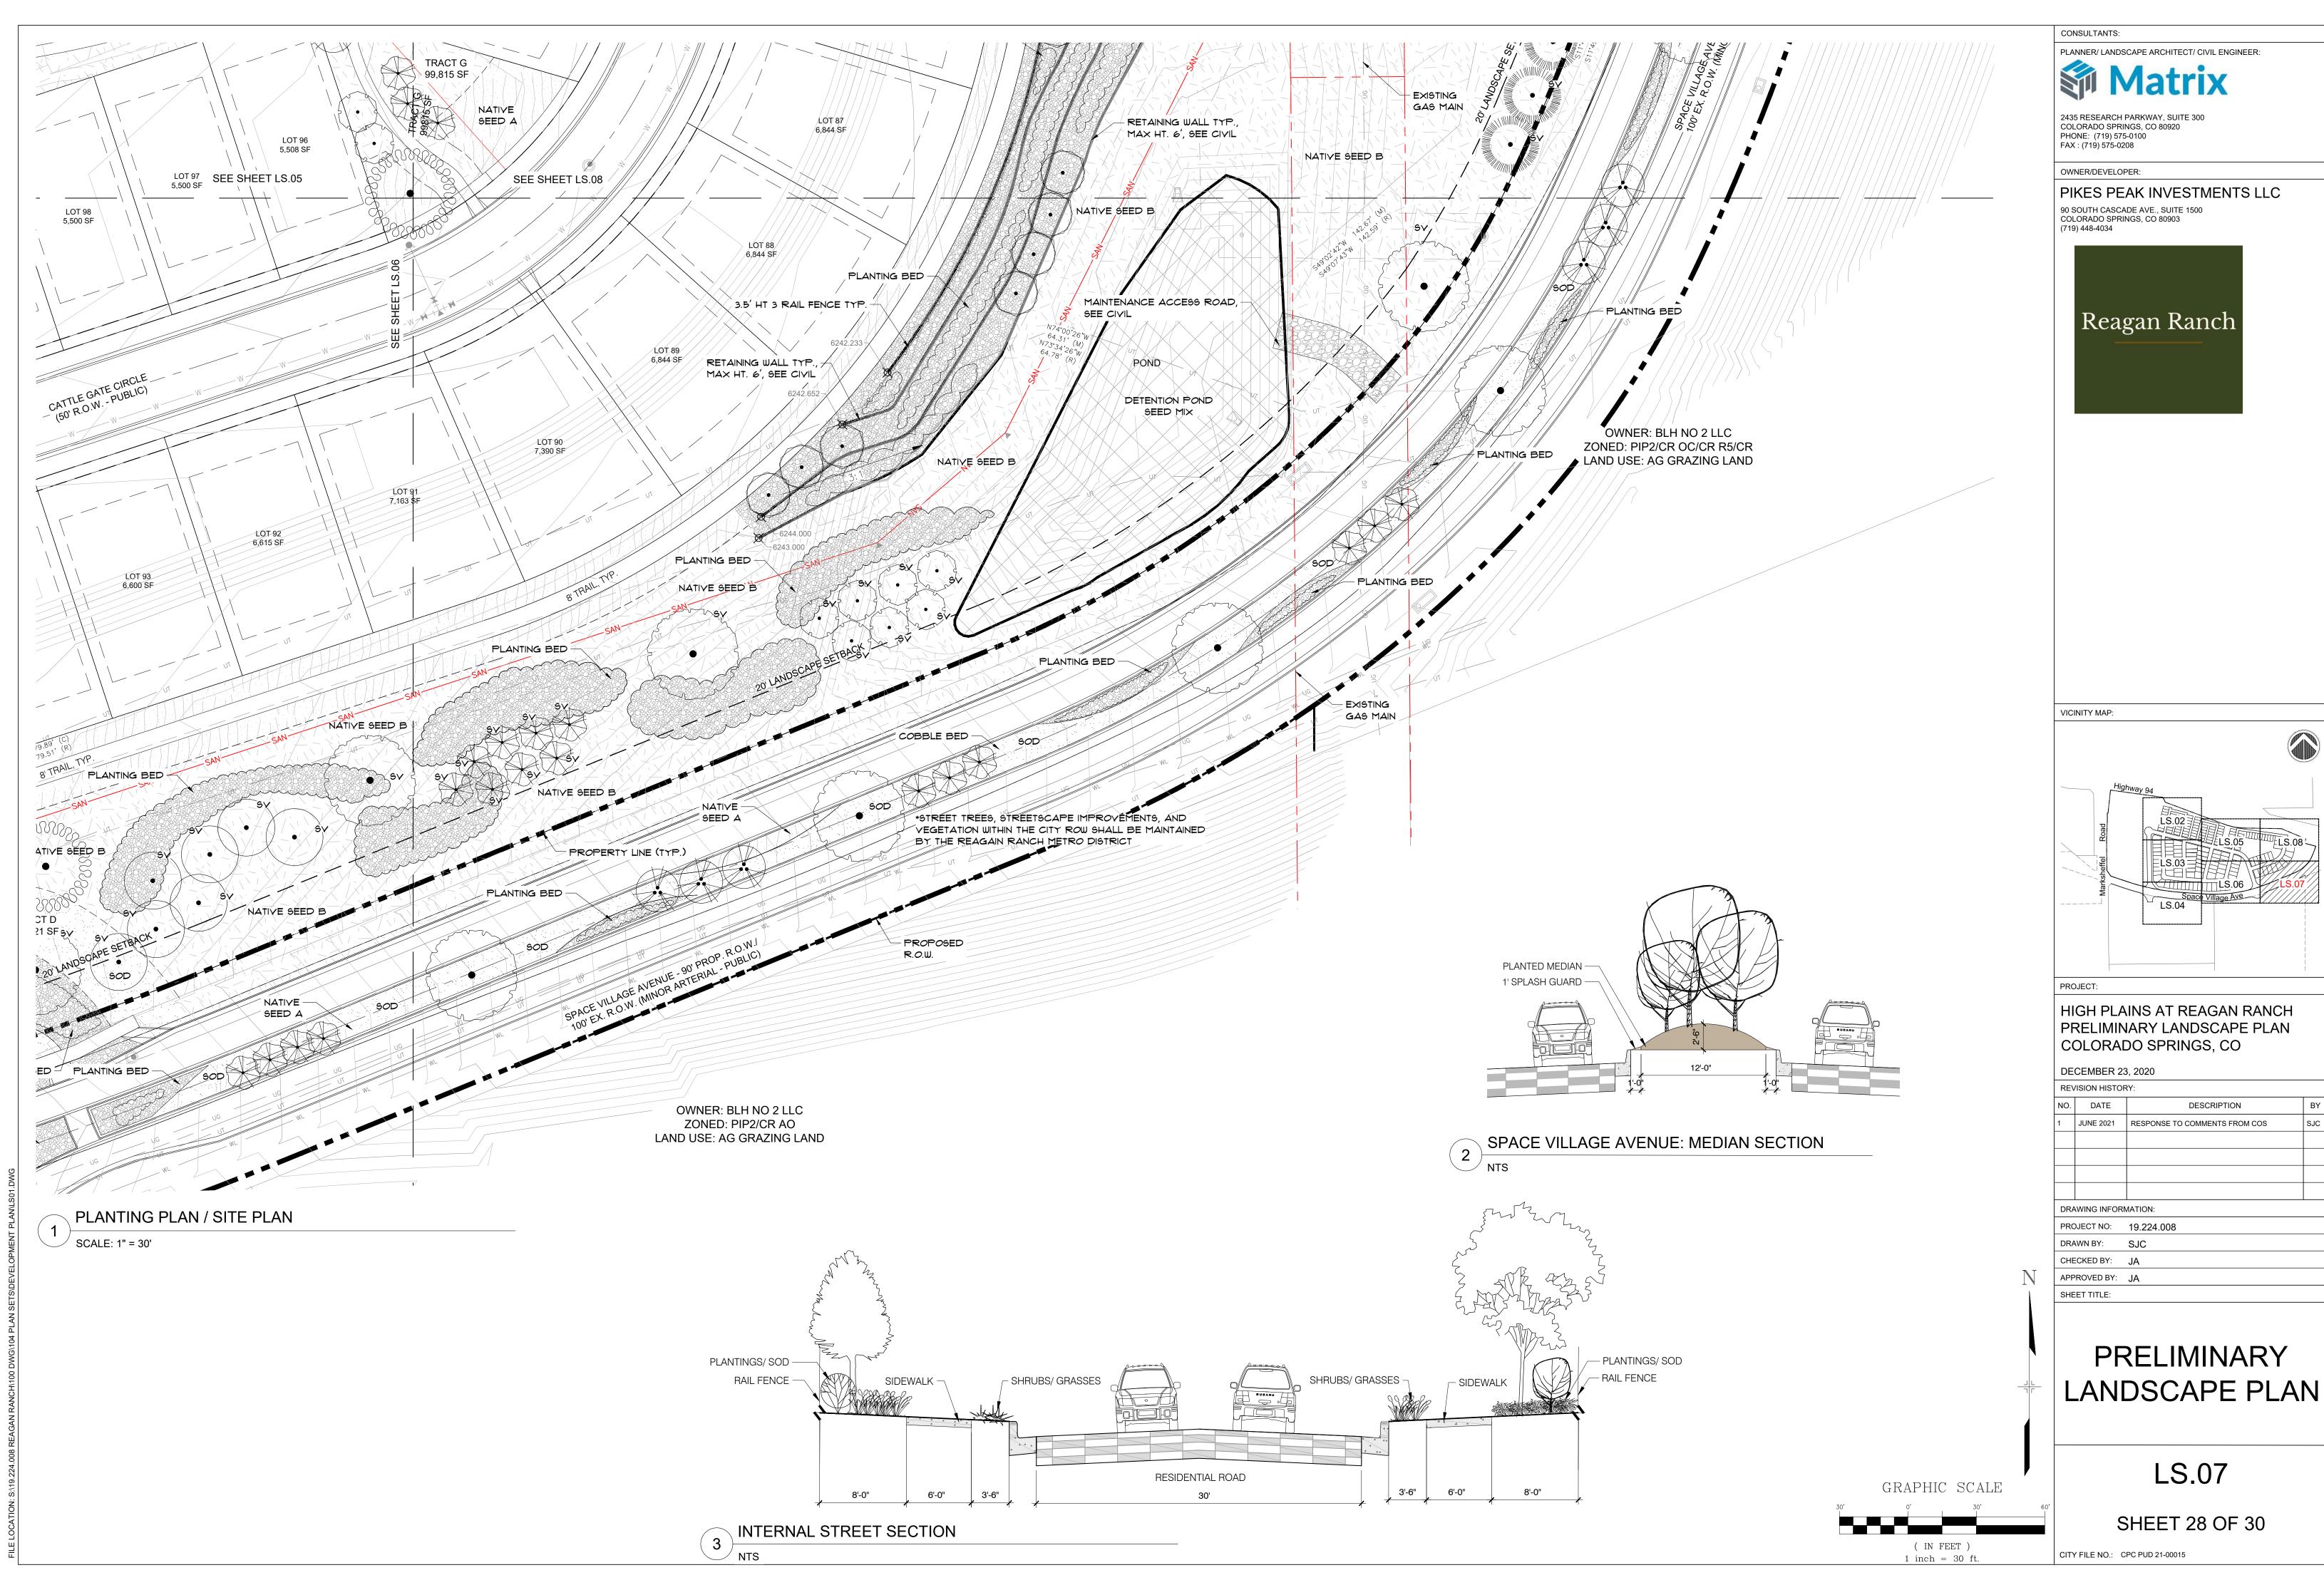
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PROJECT NO: 19.224.008		19.224.008			
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CHECKED BY:		JA			
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1	JUNE 2021	RESPONSE TO COMMENTS FROM COS	SJC
DRA	AWING INFOR	MATION:	
PRO	DJECT NO:	19.224.008	
DRAWN BY: CHECKED BY: APPROVED BY:		SJC	
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		JA	
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LANDSCAPE PLAN

SHRUB/ TREE PLANTING NOTES:

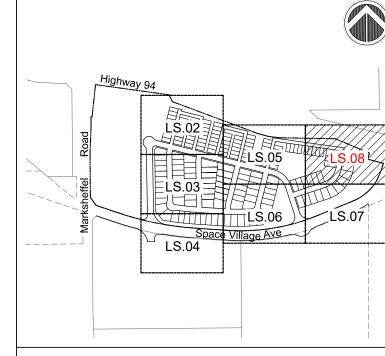- 1. ALL TREE AND SHRUB LOCATIONS ARE APPROXIMATE; ADJUST AS NECESSARY TO AVOID CONFLICTS. PLANTING LOCATIONS OF SHRUBS, GRASSES, AND PERENNIALS AS SPECIFIED. OBTAIN OWNER'S REPRESENTATIVE'S APPROVAL OF LOCATIONS PRIOR TO PLANTING TREES AND SHRUBS.
- 2. ALL PLANT MATERIAL SHALL BE WELL-FORMED AND DEVELOPED IN GOOD CONDITION, HEALTHY AND DISEASE-FREE, AND BE TYPICAL OF THE SPECIES. PLANTS SHALL COMPLY IN ALL APPLICABLE RESPECTS WITH ACCEPTABLE STANDARDS AS SET FORTH IN THE COLORADO NURSERY ACT OF 1965 - TITLE 35, ARTICLE 25, CRS 1974 (SEE LANDSCAPE THE NURSERY ACT).
- 3. OWNER AND OWNER'S REPRESENTATIVE RESERVES THE RIGHT TO REJECT AT ANY TIME OR PLACE PRIOR TO FINAL ACCEPTANCE OF WORK, ANY AND ALL PLANTS WHICH, IN THEIR OPINION, FAIL TO MEET THE REQUIREMENTS OF THE SPECIFICATIONS.
- 4. AT THE COMPLETION OF PLANTING OPERATIONS ALL PLANTS SHALL BE INSPECTED BY THE OWNER AND OWNER'S REPRESENTATIVE. CONTRACTOR SHALL REPLACE IMMEDIATELY ANY PLANTS NOT IN HEALTHY AND VIGOROUS CONDITION AT THAT TIME AT NO EXPENSE TO THE OWNER. ANY PLANT NOT IN HEALTHY CONDITION DURING THE WARRANTY PERIOD SHALL BE REPLACED AS PER THE ORIGINAL SPECIFICATIONS, AT NO CHARGE TO THE OWNER.
- 5. PLANTING BEDS RECEIVING MULCH ARE TO BE FREE OF WEEDS AND GRASS. POROUS WEED BARRIER FABRIC, AS NOTED IN THE SPECIFICATIONS, SHALL BE INSTALLED WHERE NOTED IN THE DETAILS.
- 6. PLANT GROUND COVER WITHIN ONE FOOT (1') OF TRUNK OF TREES OR SHRUBS PLANTED WITHIN AREA. PLANTING ARRANGEMENT SHALL BE PER DRAWINGS, WITH PROPER ON-CENTER SPACING BETWEEN PLANTS.
- 7. ALL PLANT MATERIALS SHALL HAVE BACKFILL CAREFULLY PLACED AROUND BASE AND SIDES OF BALL TO TWO-THIRDS (2/3) DEPTH OF BALL, THEN THOROUGHLY SOAKED WITH WATER TO ALLOW SETTLEMENT. ALL WIRE, BURLAP FASTENERS AND LOOSE BURLAP AROUND BASE OF TRUNK SHALL BE REMOVED AT THIS TIME. REMAINDER OF PIT SHALL THEN BE BACKFILLED, ALLOWING FOR DEPTH OF MULCH, SAUCER AND SETTLEMENT OF BACKFILL. BACKFILL SHALL THEN BE THOROUGHLY WATERED AGAIN.
- 8. LANDSCAPE CONTRACTOR TO REMOVE TREE STAKES, TREE WRAP, AND ALL DEAD WOOD ON TREES AND SHRUBS ONE YEAR AFTER PROVISIONAL ACCEPTANCE.
- 9. ALL WORK ON TREES TO REMAIN, INCLUDING CROWN AND ROOT PRUNING SHALL BE PERFORMED BY A TREE SERVICE LICENSED BY THE CITY FORESTER.
- 10. THE CONTRACTOR SHALL PROVIDE ALL WATER, WATERING DEVICES AND LABOR NEEDED TO IRRIGATE PLANT MATERIALS UNTIL AUTOMATIC IRRIGATION SYSTEMS ARE OPERATIONAL AND ACCEPTED. THE CONTRACTOR SHALL SUPPLY ENOUGH WATER TO MAINTAIN THE PLANT'S HEALTHY CONDITION BASED ON SEASONAL CONSIDERATIONS.
- 11. ALL PLANT MATERIALS SHALL BE PROTECTED FROM THE DRYING ACTION OF THE SUN AND WIND AFTER BEING DUG. WHILE BEING TRANSPORTED, AND WHILE AWAITING PLANTING. BALLS OF PLANTS THAT CANNOT BE PLANTED IMMEDIATELY SHALL BE PROTECTED FROM DRYING ACTION BY COVERING THEM WITH MOIST MULCH. PERIODICALLY, APPLY WATER TO MULCH-COVERED BALLS TO KEEP MOIST. IF PLANTING SHOULD OCCUR DURING GROWING SEASON, APPLY ANTI-DESSICANT TO LEAVES BEFORE TRANSPORT TO REDUCE LIKELIHOOD OF WINDBURN. REAPPLY ANTI-DESSICANT AFTER PLANTING TO REDUCE TRANSPIRATION.
- 12. AFTER PLANTING IS COMPLETED, REPAIR INJURIES TO ALL PLANTS AS REQUIRED. LIMIT AMOUNT OF PRUNING TO A MINIMUM NECESSARY TO REMOVE DEAD OR INJURED TWIGS AND BRANCHES. PRUNE IN SUCH A MANNER AS NOT TO CHANGE NATURAL HABIT OR SHAPE OF PLANT. CENTRAL LEADERS SHALL NOT BE REMOVED.

SODDING & SEEDING:

- 1. CONTRACTOR IS RESPONSIBLE FOR MAINTAINING EXISTING EROSION CONTROL MEASURES DURING THE DURATION OF WORK ON-SITE.
- 2. GENERAL CONTRACTOR SHALL PROVIDE 4" OF TOPSOIL AT ALL SOD AND PLANTING AREAS. GRADE SHALL BE ADJUSTED FOR SOD THICKNESS. ALL FINISH GRADING SHALL BE PERFORMED BY LANDSCAPE CONTRACTOR.
- 3. FINE GRADE SOD AREAS TO ELIMINATE IRREGULARITIES ON THE SURFACE. ROLL OR PERFORM ADDITIONAL FINE GRADING.
- 4. ALL AREAS TO BE SEEDED SHALL BE TILLED AS SPECIFIED AND THEN HARROWED, RAKED OR ROLLED TO PRODUCE A FIRM SEED BED FOR PLANTING. IMPORTED TOPSOIL MAY BE REQUIRED TO PROVIDE AN ACCEPTABLE PLANTING MEDIUM. LARGE ROCKS (1 INCH DIAMETER) AND DEBRIS THAT MAY IMPEDE SEEDING SHALL BE CLEARED FROM THE SITE. ANY REQUIRED EROSION CONTROL FEATURES (E.G., WATER BARS, BERMS, BASINS, TURNOUTS) SHALL BE CONSTRUCTED PRIOR TO SEEDING. SITES THAT ARE NOT ADEQUATELY PREPARED PRIOR TO SEEDING (E.G., COMPACTED SOIL, INSUFFICIENT TOPSOIL, ROCKY, ERODED SURFACE, ETC.) SHALL BE REJECTED.
- ALL SPECIFIED SEED MIXES SHALL CONSIST OF CERTIFIED SEED VARIETIES THAT ARE FREE OF NOXIOUS WEEDS AND HAVE BEEN TESTED FOR PURITY AND GERMINATION WITHIN SIX MONTHS OF THE PLANTING DATE. CERTIFICATION LABELS WHICH INDICATE THE SPECIES, PURITY, GERMINATION, WEED CONTENT, ORIGIN, AND TEST DATE SHALL BE SUBMITTED FOR ALL SEED MATERIALS
- 6. SEEDING SHALL OCCUR DEPENDING ON THE PROJECT SCHEDULE, IT IS PREFERABLE THAT SEEDING OCCUR DURING THE FALL (SEPTEMBER-NOVEMBER) OR SPRING (MARCH-MAY) TO MAXIMIZE PLANTING SUCCESS. IF THE PROJECT SCHEDULE DOES NOT COINCIDE WITH THE PREFERRED SEEDING PERIODS, OR THERE ARE UNSUITABLE SITE CONDITIONS (I.E. FROZEN GROUND), THEN SOIL STABILIZATION AND/OR STORM WATER BEST MANAGEMENT PRACTICES SHALL BE IMPLEMENTED TO STABILIZE THE AREA UNTIL THE NEXT APPROPRIATE SEEDING DATE. ANY SEEDING CONDUCTED OUTSIDE THE PREFERRED MONTHS SHALL BE APPROVED BY THE OWNER.
- SEEDING METHOD: DRILL SEEDING OR BROADCAST SEEDING SHALL BE USED FOR REVEGETATION. AS OUTLINED BELOW, THE SIZE AND SLOPE OF THE DISTURBED AREA SHALL DETERMINE WHICH SEEDING METHOD(S) IS APPROPRIATE AND ACCEPTABLE. WHERE FEASIBLE, RANGELAND DRILL SEEDING COMBINED WITH A COVER OF CRIMPED HAY MULCH OR HYDRO-MULCH IS THE REQUIRED METHOD
- 7.1. SLOPES LESS THAN 3:1 SEED SHALL BE PLANTED USING A RANGELAND DRILL. SEEDING SHALL BE ACCOMPLISHED USING BI-DIRECTIONAL DRILLING AND FOLLOWING THE SLOPE CONTOUR. THE DRILL EQUIPMENT SHALL BE CALIBRATED EACH DAY OR WHENEVER THERE IS A CHANGE IN THE SEED MIX TO ENSURE PROPER SEED DISTRIBUTION AND RATE.
- 7.2. SLOPES GREATER THAN 3:1 OR AREAS LESS THAN 0.10 ACRE SEED SHALL BE BROADCAST BY HAND. MECHANICAL SPREADER, OR HYDRO-SEEDING EQUIPMENT. BROADCAST SEEDED AREAS SHALL BE RAKED OR HARROWED TO INCORPORATE THE SEED INTO THE SOIL AT A DEPTH NOT EXCEEDING 0.75 INCHES.
- FOR AREAS LARGER THAN 0.1 ACRE- HYDRO-SEEDING SHALL BE USED. THE SEED SHALL NOT BE TANK MIXED WITH THE HYDRO-MULCH AND BROADCAST.
- BROADCAST SEEDING SHALL BE AVOIDED WHEN WIND SPEED EXCEEDS 15 MILES PER HOUR.
- 8. MULCHING: WEED-FREE NATIVE HAY, WEED-FREE STRAW, OR VIRGIN WOOD FIBER HYDRO-MULCH SHALL BE USED TO CONTROL EROSION AND PROMOTE SEED GERMINATION AND PLANT ESTABLISHMENT. NATIVE HAY, STRAW, OR HYDRO-MULCH SHALL BE APPLIED AT 2,000 POUNDS/ACRE ON SLOPES LESS THAN 3:1. ON STEEPER SLOPES, A MULCHING RATE OF 2,500 POUNDS/ACRE SHALL BE USED.
- 9. NATIVE HAY OR STRAW SHALL BE CRIMPED INTO THE SOIL TO A DEPTH OF AT LEAST 3 INCHES, AND SHALL PROTRUDE ABOVE THE GROUND AT LEAST 3 INCHES. AN ORGANIC TACKIFIER SHALL BE USED TO HOLD THE HAY OR STRAW IN PLACE IF THE CRIMPING RESULTS ARE INSUFFICIENT. HYDRO-MULCH SHALL BE APPLIED USING A COLOR DYE AND THE MANUFACTURER RECOMMENDED RATE OF AN ORGANIC TACKIFIER.
- 10. FINE GRADE SEED TO ELIMINATE IRREGULARITIES ON THE SURFACE. ROLL OR PERFORM ADDITIONAL FINE GRADING. SEED AREAS BY MEANS OF APPROVED BROADCAST OR HYDRAULIC-TYPE SPREADERS. DO NOT SEED DURING WINDY WEATHER. MULCH SEEDED AREAS WITH WOOD CELLULOSE FIBER MULCH WITHIN 24 HOURS OF SEEDING. APPLY MULCH TACKIFIER AT RATE RECOMMENDED BY MANUFACTURER'S RECOMMENDATIONS.
- 11. IF A WATER HOOK-UP IS AVAILABLE A SPRINKLER SYSTEM MAY BE USED TO PROMOTE RAPID PLANT ESTABLISHMENT. GENERALLY, WATERING AT 0.75-1.0 INCHES/WEEK IS RECOMMENDED DURING THE APRIL-OCTOBER GROWING SEASON DEPENDING ON NATURAL RAINFALL. THE USE OF WATER TRUCKS FOR IRRIGATION IS PROHIBITED DUE TO TRAFFIC IMPACTS ON THE SEEDED AREAS AND TYPICAL POOR WATER DISTRIBUTION OBSERVED WITH THIS TYPE OF WATERING.
- 12. APPROVAL OF SEEDED TURF AREAS SHALL BE BASED UPON THE SEED PRODUCERS GUARANTEED SEEDING GERMINATION RATE FOR A ONE SQUARE FOOT AREA. IF GUARANTEED GERMINATION RATE IS NOT ACHIEVED, THE CONTRACTOR SHALL OVERSEED UNTIL THE GERMINATION RATE IS ACHIEVED. REVEGETATION SHALL HAVE AT LEAST 3 NATIVE GRASS SEEDLINGS/SQUARE FOOT AND NO BARE AREAS EXCEEDING ONE SQUARE METER AFTER THE SECOND GROWING SEASON. FOR DRILL SEEDED AREAS, PLANTING ROWS SHALL BE NOTICEABLE BY THE END OF THE FIRST FULL GROWING SEASON. IF A PARTIAL OR TOTAL SEEDING FAILURE IS APPARENT AFTER THE SECOND GROWING SEASON, POORLY VEGETATED AREAS SHALL BE RESEEDED IN THE SAME MANNER DESCRIBED ABOVE. APPROPRIATE SITE PREPARATION PRACTICES SHALL BE USED TO CREATE A SUITABLE SEEDBED FOR PLANTING, BUT ANY ESTABLISHED NATIVE VEGETATION SHALL BE UNDISTURBED TO THE EXTENT POSSIBLE. AREAS THAT ERODE BEFORE GERMINATION AND ESTABLISHMENT CAN OCCUR SHALL BE REPAIRED AND IMMEDIATELY RESEEDED DURING THE SAME SEASON.
- 13. ALL BARE AREAS TO BE RESEEDED WITH PROPER REMOVAL OF WEEDS. ALL NATIVE SEED AREAS ARE TO MEET STANDARD CITY REQUIREMENTS FOR GERMINATION AND ESTABLISHMENT.


GENERAL NOTES:

- 1. PRIOR TO BEGINNING ANY WORK ON THE SITE, THE CONTRACTOR SHALL CONTACT THE OFFICE OF THE OWNER'S
- REPRESENTATIVE FOR SPECIFIC INSTRUCTIONS RELEVANT TO THE SEQUENCING OF WORK. 2. READ THOROUGHLY AND BECOME FAMILIAR WITH THE DRAWINGS, NOTATIONS, DETAILS AND SPECIFICATIONS FOR THIS AND RELATED WORK PRIOR TO CONSTRUCTION
- LANDSCAPE CONTRACTOR SHALL PROVIDE ALL LABOR, MATERIALS AND SERVICES NECESSARY TO FURNISH AND INSTALL LANDSCAPE ELEMENTS AND PLANTINGS AS SPECIFIED HEREIN AND AS SHOWN ON THESE PLANS.
- NO MATERIAL SUBSTITUTIONS SHALL BE MADE WITHOUT LANDSCAPE ARCHITECT'S APPROVAL. ALTERNATE MATERIALS OF SIMILAR SIZE AND CHARACTER MAY BE CONSIDERED IF SPECIFIED PLANT MATERIALS CANNOT BE OBTAINED. OWNER'S REPRESENTATIVE RESERVES THE RIGHT TO REVISE PLANT LIST AS DEEMED NECESSARY ALL PLANT LOCATIONS ARE APPROXIMATE, ADJUST AS NECESSARY TO AVOID CONFLICTS


REPORT ANY DISCREPANCIES IN THE LANDSCAPE PLANS IMMEDIATELY TO THE OWNER/ OWNER'S REPRESENTATIVE.

- QUANTITIES OF MATERIALS SHOWN ON THE PLANTING PLAN TAKE PRECEDENCE OVER QUANTITIES SHOWN ON THE PLANT MATERIAL SCHEDULE. LANDSCAPE CONTRACTOR SHALL BE RESPONSIBLE FOR VERIFYING ALL QUANTITIES ON THE PLANTING
- 8. CONTRACTOR SHALL LOCATE ALL UTILITIES BEFORE WORK. UTILITIES HAVE BEEN SHOWN ON PLAN FOR ROUGH LOCATION OF SERVICES. LOCATE EXACT UTILITY LOCATIONS BY CONTACTING "CALL BEFORE YOU DIG" AT (800) 922-1987 OR 811. CONTRACTOR WILL BE RESPONSIBLE FOR THE REPAIR OF ANY DAMAGE HE MAY CAUSE TO UTILITIES.
- REMOVE ALL RUBBISH, EQUIPMENT AND MATERIAL AND LEAVE THE AREA IN A NEAT, CLEAN CONDITION EACH DAY. MAINTAIN PAVED AREAS UTILIZED FOR HAULING EQUIPMENT AND MATERIALS BY OTHER TRADES IN A CLEAN AND UNOBSTRUCTED CONDITION AT ALL TIMES.
- 10. STORAGE OF ANY MATERIALS, BUILDINGS, VEHICLES OR EQUIPMENT, FENCING AND WARNING SIGNS SHALL BE MAINTAINED THROUGHOUT THE SITE WORK AND CONSTRUCTION PERIODS BY THE CONTRACTOR
- 11. ALL COMMON LANDSCAPE AND STREETSCAPE PLANTINGS WITHIN THIS DEVELOPMENT SHALL BE OWNED AND MAINTAINED BY THE PROPERTY OWNER.
- 12. CONTRACTOR TO UTILIZE STOCKPILED TOPSOIL FROM GRADING OPERATION AS AVAILABLE. TILL INTO TOP 6" OF SOIL. FOR
- GRADING SEE CIVIL ENGINEER DRAWINGS. 13. A 3' DIAMETER CLEAR SPACE SPACE SHALL BE MAINTAINED AROUND ALL FIRE HYDRANTS.
- 14. ANY FIELD CHANGES OR DEVIATIONS TO THESE PLANS WITHOUT PRIOR CITY APPROVAL OF AN AMENDED DEVELOPMENT PLAN MAY RESULT IN A DELAY OF FINAL APPROVAL AND ISSUANCE OF A CERTIFICATE OF OCCUPANCY.
- 15. A FINAL LANDSCAPE AND IRRIGATION PLAN SHALL BE SUBMITTED AND REVIEWED CONCURRENT WITH BUILDING PERMIT SUBMITTAL AND APPROVED PRIOR TO ISSUANCE OF A BUILDING PERMIT.

- PER THE COLORADO SPRINGS GENERAL VEGETATION AND SOIL ASSOCIATION MAP, THE SITE CONSISTS OF SANDY PLAINS. 2. A SOILS ANALYSIS WILL BE PROVIDED BY COLORADO STATE UNIVERSITY EXTENSION OFFICE ILLUSTRATING SOIL
- AMENDMENT RECOMMENDATIONS FOR TURF GRASS, TREES, SHRUBS, AND PERENNIAL AREAS AT THE TIME OF FINAL LANDSCAPE PLAN SUBMITTAL.
- 3. CONTRACT TO APPLY TO ALL AREAS 3 CY/ 1,000 SF ORGANIC MATTER COMPOST. TILL INTO TOP 6-8" OF SOIL. COMPOST TO CONSIST OF 1-YEAR OLD ORGANIC MATERIAL AND SHALL NOT INCLUDE CHICKEN MANURE.

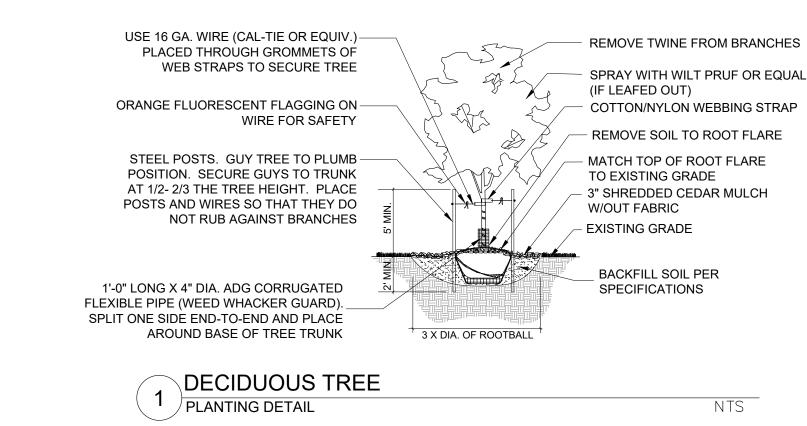


* NOTE: ALL TREE PLANTINGS TO HAVE A 36" DIAMETER TREE RING WITH WOOD MULCH

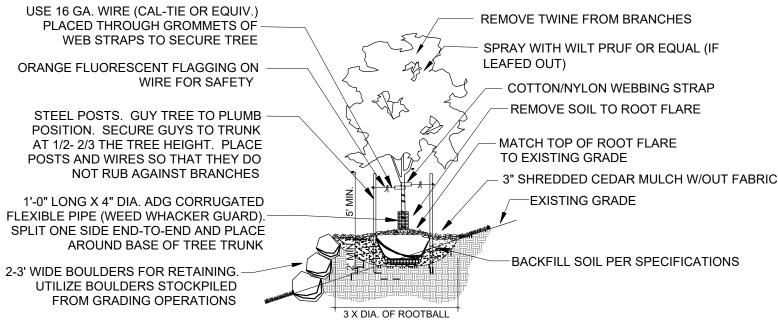

- 1. DIG PIT SO THAT TOP OF THE ROOT FLARE IS LEVEL WITH SURROUNDING GRADE. THE ROOT FLARE SHOULD DETERMINE THE DEPTH OF THE PIT, NOT THE TOP OF THE ROOT BALL
- 2. THE BALL OF TREE SHOULD SIT ON UNDISTURBED SOIL 3. CUT BOTTOM OF BASKET. REMOVE ALL SOIL FROM ROOT BALL TO TOP OF ROOT FLARE. SET TREE AND REMOVE ENTIRE BASKET AFTER CORRECT PLACEMENT. REMOVE BURLAP FROM THE SIDE OF THE ROOT BALL. REMOVE
- ALL TWINE FROM AROUND THE TRUNK AND BACKFILL. SOAK BACKFILL IMMEDIATELY AFTER PLANTING. 4. PREPARE BACKFILL: 1/3 COMPOST-TYPE MIX WITH 2/3 TOPSOIL. REMOVE ANY DEBRIS FROM TOPSOIL BACKFILL AND

DECIDUOUS TREE SLOPE (3:1 OR STEEPER) DETAIL PLANTING DETAIL


* NOTE: ALL TREE PLANTINGS TO HAVE A 36" DIAMETER TREE RING WITH WOOD MULCH

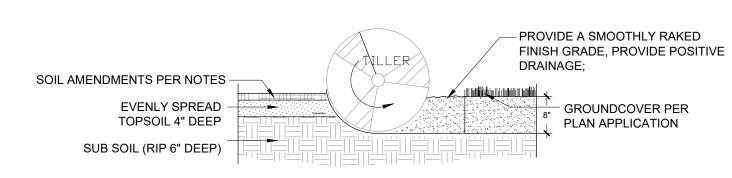

. TOPSOIL TO CONSIST OF DARK, LIGHT LOAM SOIL FREE OF ROCKS, ROOTS, AND FOREIGN MATERIALS. 2. COMPOST TO CONSIST OF 1-YEAR OLD ORGANIC MATERIAL AND SHOULD NOT INCLUDE CHICKEN MANURE. 3. FROZEN MATERIALS OR MATERIALS GREATER THAN 1" DIA. SHOULD BE REMOVED.

SOIL PREP FOR ALL AREAS PLANTING DETAIL


NTS

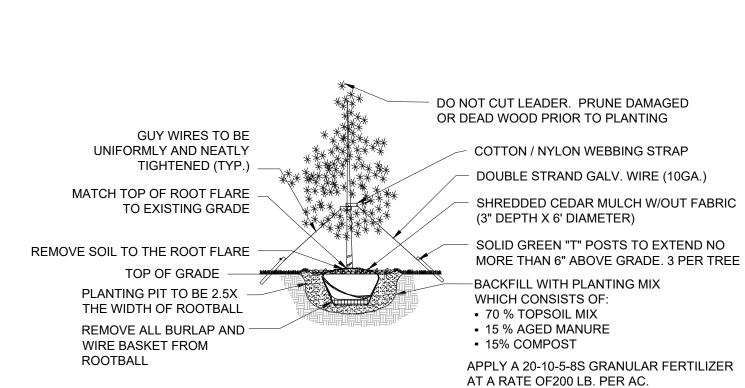

PLANTING DETAIL

EVERGREEN TREE

* NOTE: ALL TREE PLANTINGS TO HAVE A 36" DIAMETER TREE RING WITH WOOD MULCH

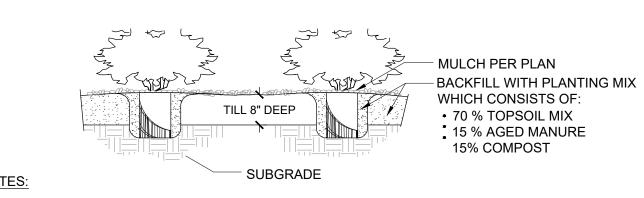


NTS

1. CONTRACTOR TO WATER PLANT MATERIAL DAILY UNTIL AN AUTOMATIC IRRIGATION SYSTEM IS OPERATIONAL OR OTHER IRRIGATION PROVISIONS ARE PROVIDED.


2. THE FINISH GRADES SHALL PROVIDE POSITIVE DRAINAGE AWAY FROM WALLS AND BUILDINGS. 3. THE TILLING OF PLANTING BEDS AND PLACEMENT OF BACKFILL IS TO OCCUR JUST PRIOR TO PLANTING; THEREAFTER, PROTECTION FROM COMPACTION AND CONSTRUCTION TRAFFIC SHOULD BE PROVIDED.

SHRUBS NTS PLANTING DETAIL

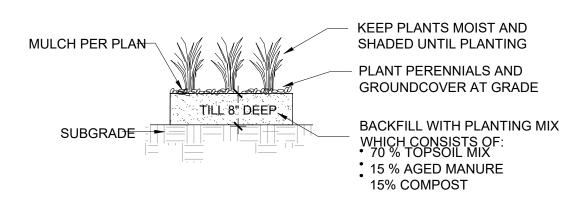

- 1. CONTRACTOR TO WATER PLANT MATERIAL DAILY UNTIL AN AUTOMATIC IRRIGATION SYSTEM IS OPERATIONAL
- 2. THE FINISH GRADES SHALL PROVIDE POSITIVE DRAINAGE AWAY
- FROM WALLS AND BUILDINGS. 3. THE TILLING OF PLANTING BEDS AND PLACEMENT OF BACKFILL IS TO OCCUR JUST PRIOR TO PLANTING; THEREAFTER, PROTECTION FROM COMPACTION AND CONSTRUCTION TRAFFIC SHOULD BE PROVIDED.

GRASSES AND PERENNIALS NTS PLANTING DETAIL

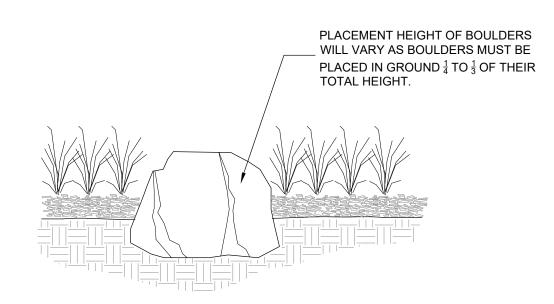

BOULDERS PLANTING DETAIL NTS

CONSULTANTS PLANNER/ LANDSCAPE ARCHITECT/ CIVIL ENGINEER: 2435 RESEARCH PARKWAY, SUITE 300 COLORADO SPRINGS, CO 80920 PHONE: (719) 575-0100 FAX: (719) 575-0208

OWNER/DEVELOPER: PIKES PEAK INVESTMENTS LLC 90 SOUTH CASCADE AVE., SUITE 1500 COLORADO SPRINGS, CO 80903



VICINITY MAP

HIGH PLAINS AT REAGAN RANCH PRELIMINARY LANDSCAPE PLAN COLORADO SPRINGS, CO

DECEMBER 23, 2020 REVISION HISTORY DESCRIPTION JUNE 2021 RESPONSE TO COMMENTS FROM COS DRAWING INFORMATION PROJECT NO: 19.224.008 DRAWN BY: CHECKED BY: JA APPROVED BY: JA SHEET TITLE:

LANDSCAPE **NOTES & DETAILS**

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SHEET 30 OF 30